GENERAL NOTES

1. THE CONTRACTOR SHALL EXAMINE AND BECOME FAMILIAR WITH ALL CONTRACT DOCUMENTS IN THEIR ENTIRETY, SURVEY THE PROJECT AND BECOME FAMILIAR WITH THE EXISTING CONDITIONS AND SCOPE OF WORK. ALL COSTS SUBMITTED SHALL BE BASED ON THOROUGH KNOWLEDGE OF ALL WORK AND MATERIALS REQUIRED. ANY DISCREPANCY AND/OR UNCERTAINTY AS TO WHAT MATERIAL OR PRODUCT IS TO BE USED SHOULD BE VERIFIED WITH THE OWNER OR ARCHITECT.

2. ALL CONSTRUCTION SHALL COMPLY WITH THE 2021 IRC AND ALL APPLICABLE STATE, FEDERAL, & LOCAL CODES & AMENDMENTS.

3. THE CONTRACTOR SHALL BE SOLELY RESPONSIBLE FOR CONSTRUCTION MEANS, METHODS, TECHNIQUES, SEQUENCES, AND PROCEDURES REQUIRED FOR SAFE EXECUTION AND COMPLETION OF WORK, AND FOR INITIATING, MAINTAINING, AND SUPERVISING ALL SAFETY PRECAUTIONS AND PROGRAMS IN CONNECTION WITH THE WORK.

4. ANY ERRORS, OMISSIONS, OR INCONSISTENCIES ON THESE DRAWINGS OR ANY VARIATIONS OR AMBIGUITIES BETWEEN THESE DRAWINGS AND ACTUAL SITE AND CONSTRUCTION CONDITIONS AND/OR REQUIREMENTS SHALL BE BROUGHT TO THE ATTENTION OF THE OWNER.

5. IN THE EVENT A DISCREPANCY IS FOUND IN THE CONTRACT DOCUMENTS, THE OWNER SHALL BE NOTIFIED IMMEDIATELY.

6. CONTRACTOR SHALL VERIFY ALL DIMENSIONS IN THE FIELD AND NOTIFY THE OWNER OF ANY DISCREPANCIES PRIOR TO CONSTRUCTION.

7. CONTRACTOR SHALL VERIFY ALL MEASUREMENTS AT THE SITE AND BE RESPONSIBLE FOR ACCURACY AND CORRECTNESS OF SAME.

8. CONTRACTOR SHALL COORDINATE HIS WORK WITH ALL OTHER TRADES. NOTIFY OWNER & ENGINEER OF ANY DISCREPANCIES PRIOR TO CONSTRUCTION.

9. STORE MATERIALS IN SPACES DESIGNATED BY OWNER.

10. REMOVE RUBBISH FROM PREMISES AS OFTEN AS NECESSARY OR AS DIRECTED.

11. ALL WORK AND EQUIPMENT SHALL BE CLEANED TO THE SATISFACTION OF THE OWNER BEFORE TURNING SAME OVER TO THE OWNER.

12. SHOP DRAWINGS SHALL BE SUBMITTED TO THE OWNER FOR APPROVAL PRIOR TO ORDERING AND INSTALLATION OF ANY EQUIPMENT.

13. THE CONTRACTOR SHALL PAY ALL FEES, GIVE ALL NOTICES, FILE ALL NECESSARY DRAWINGS AND OBTAIN ALL PERMITS AND CERTIFICATES OR APPROVAL REQUIRED CONNECTION WITH ALL WORK UNDER THESE CONTRACT DOCUMENTS. HE OR SHE SHALL COMPLY WITH ALL LAWS, ORDINANCES, RULES, AND REGULATIONS OF ALL AUTHORITIES HAVING JURISDICTION.


14. THERE SHALL BE NO DEVIATION FROM SPECIFICATIONS WITHOUT THE WRITTEN APPROVAL OF THE OWNER AND/OR ENGINEER.

15. DRYWALL INSTALLATION SHALL BE IN CONFORMANCE WITH THE GYPSUM ASSOCIATIONS RECOMMENDED PRACTICES FOR THICKNESS, NAILING, TAPING, AN CORRECT STUD SPACING.

16. MECHANICAL CONTRACTOR TO VERIFY ANY CHASE AREA NOT SHOWN ON DRAW ALL SHOP DRAWINGS TO BE SUBMITTED FOR APPROVAL PRIOR TO ORDERING ANY EQUIPMENT.

17. CONTRACT DRAWINGS AND SPECIFICATIONS REPRESENT FINISHED STRUCTURE DO NOT INDICATE METHOD OF CONSTRUCTION. CONTRACTOR SHALL PROVIDE ALI MEASURES NECESSARY TO PROTECT STRUCTURE AND PERSONNEL DURING CONSTRUCTION. SUCH MEASURES SHALL INCLUDE, BUT NOT BE LIMITED TO, BRACING, SHORING OF LOADS DUE TO CONSTRUCTION EQUIPMENT, EXCAVATION PROTECTION, SCAFFOLDING, JOB SITE SAFETY, ETC. OBSERVATION VISITS TO THE BY THE OWNER OR ENGINEER SHALL NOT INCLUDE INSPECTION OF ABOVE ITEMS.

W. MARBLE STREET

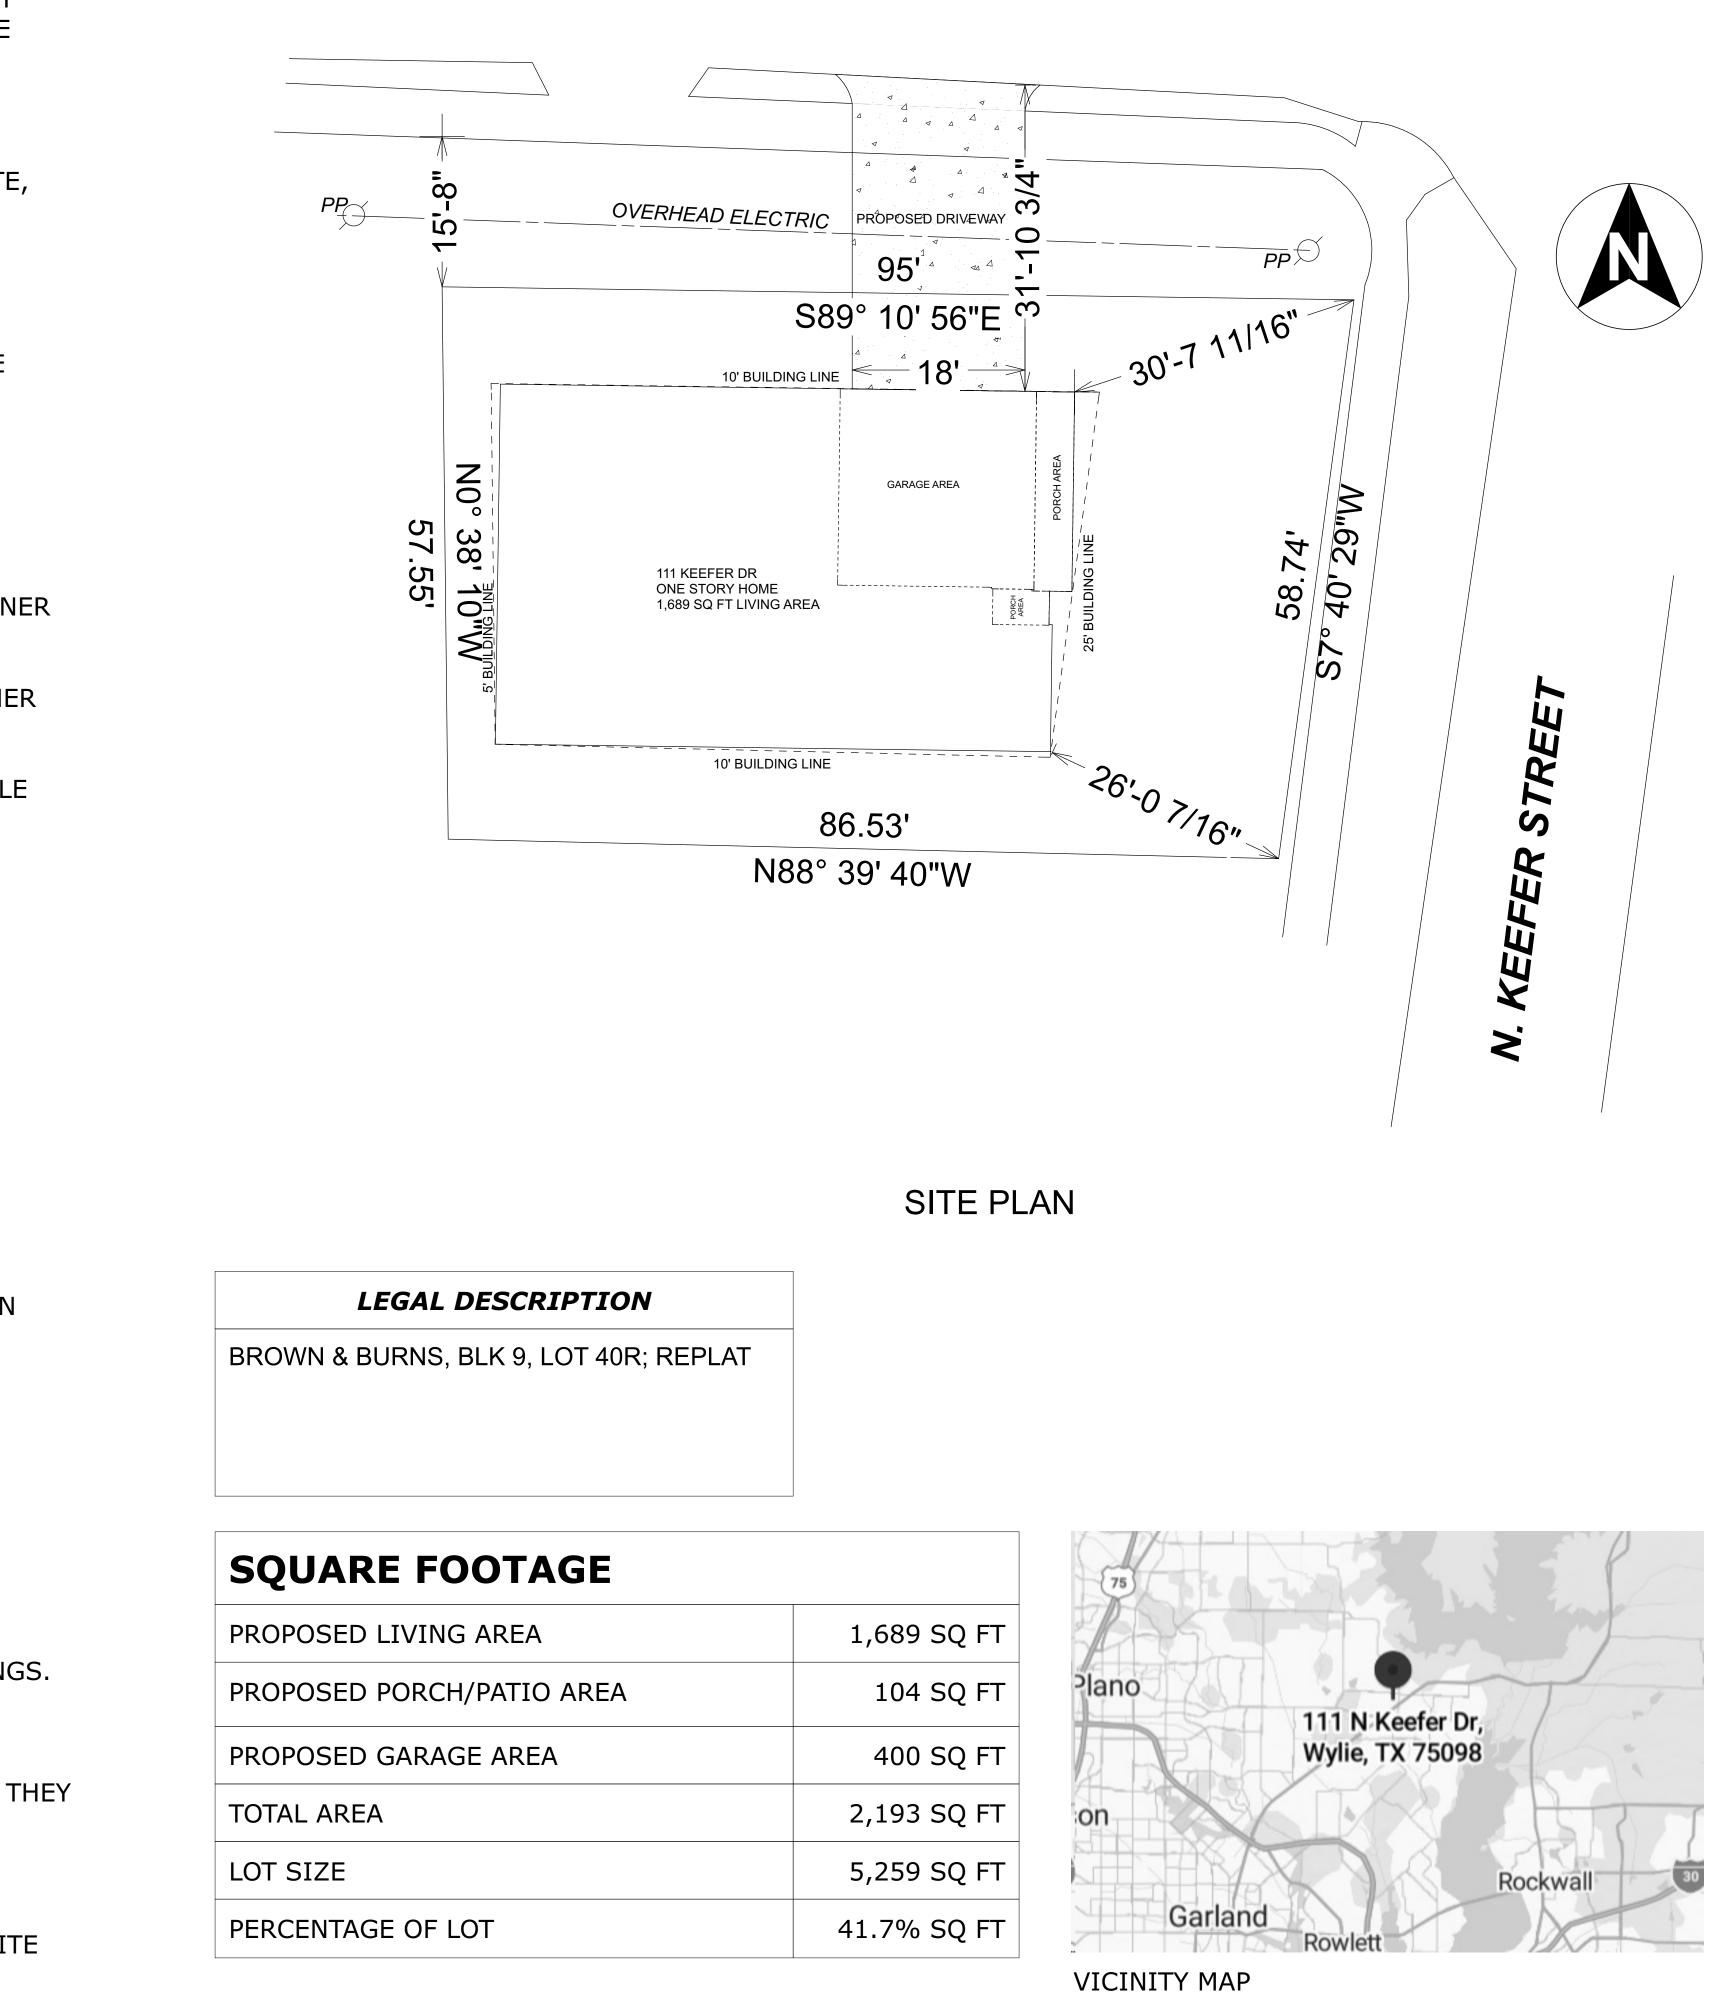

1		
, IN	LEGAL DESCRIPTION	
	BROWN & BURNS, BLK 9, LOT 40R; REPLAT	
	SQUARE FOOTAGE	
	PROPOSED LIVING AREA	1,689 SQ FT
IGS.	PROPOSED PORCH/PATIO AREA	104 SQ FT
	PROPOSED GARAGE AREA	400 SQ FT
THEY	TOTAL AREA	2,193 SQ FT
	LOT SIZE	5,259 SQ FT
ITE	PERCENTAGE OF LOT	41.7% SQ FT





completion of these construction drawings However the designer, have not been contracted personal consultation, site supervision or field inspection services and have no control over the construction materials, methods or sequencing used by the builder. For these reasons, as well as the gross variations in local building codes, the designer assume no responsibility for any damages, including structural failures resulting from errors or omission in these construction drawings. We strongly recommend that you, the homeowner have these drawings thoroughly reviewed by a licensed architect, professional engineer, certified residential designer or general contractor licensed to practice in your area, in addition to your local building officials, prior to beginning construction.

SEAL:

ADDRESS: 111 KEEFER DR WYLIE, TX 75098

DATE:

9/15/2023

DRAWN BY:

ATOR

DESCRIPTION:

CRAFTSMAN STYLE SINGLE FAMILY RESIDENCE ONE STORY | 4 BEDROOM, 2 BATH


SCALE:

1' = 10'

SHEET TITLE:

SITE PLAN

A-1

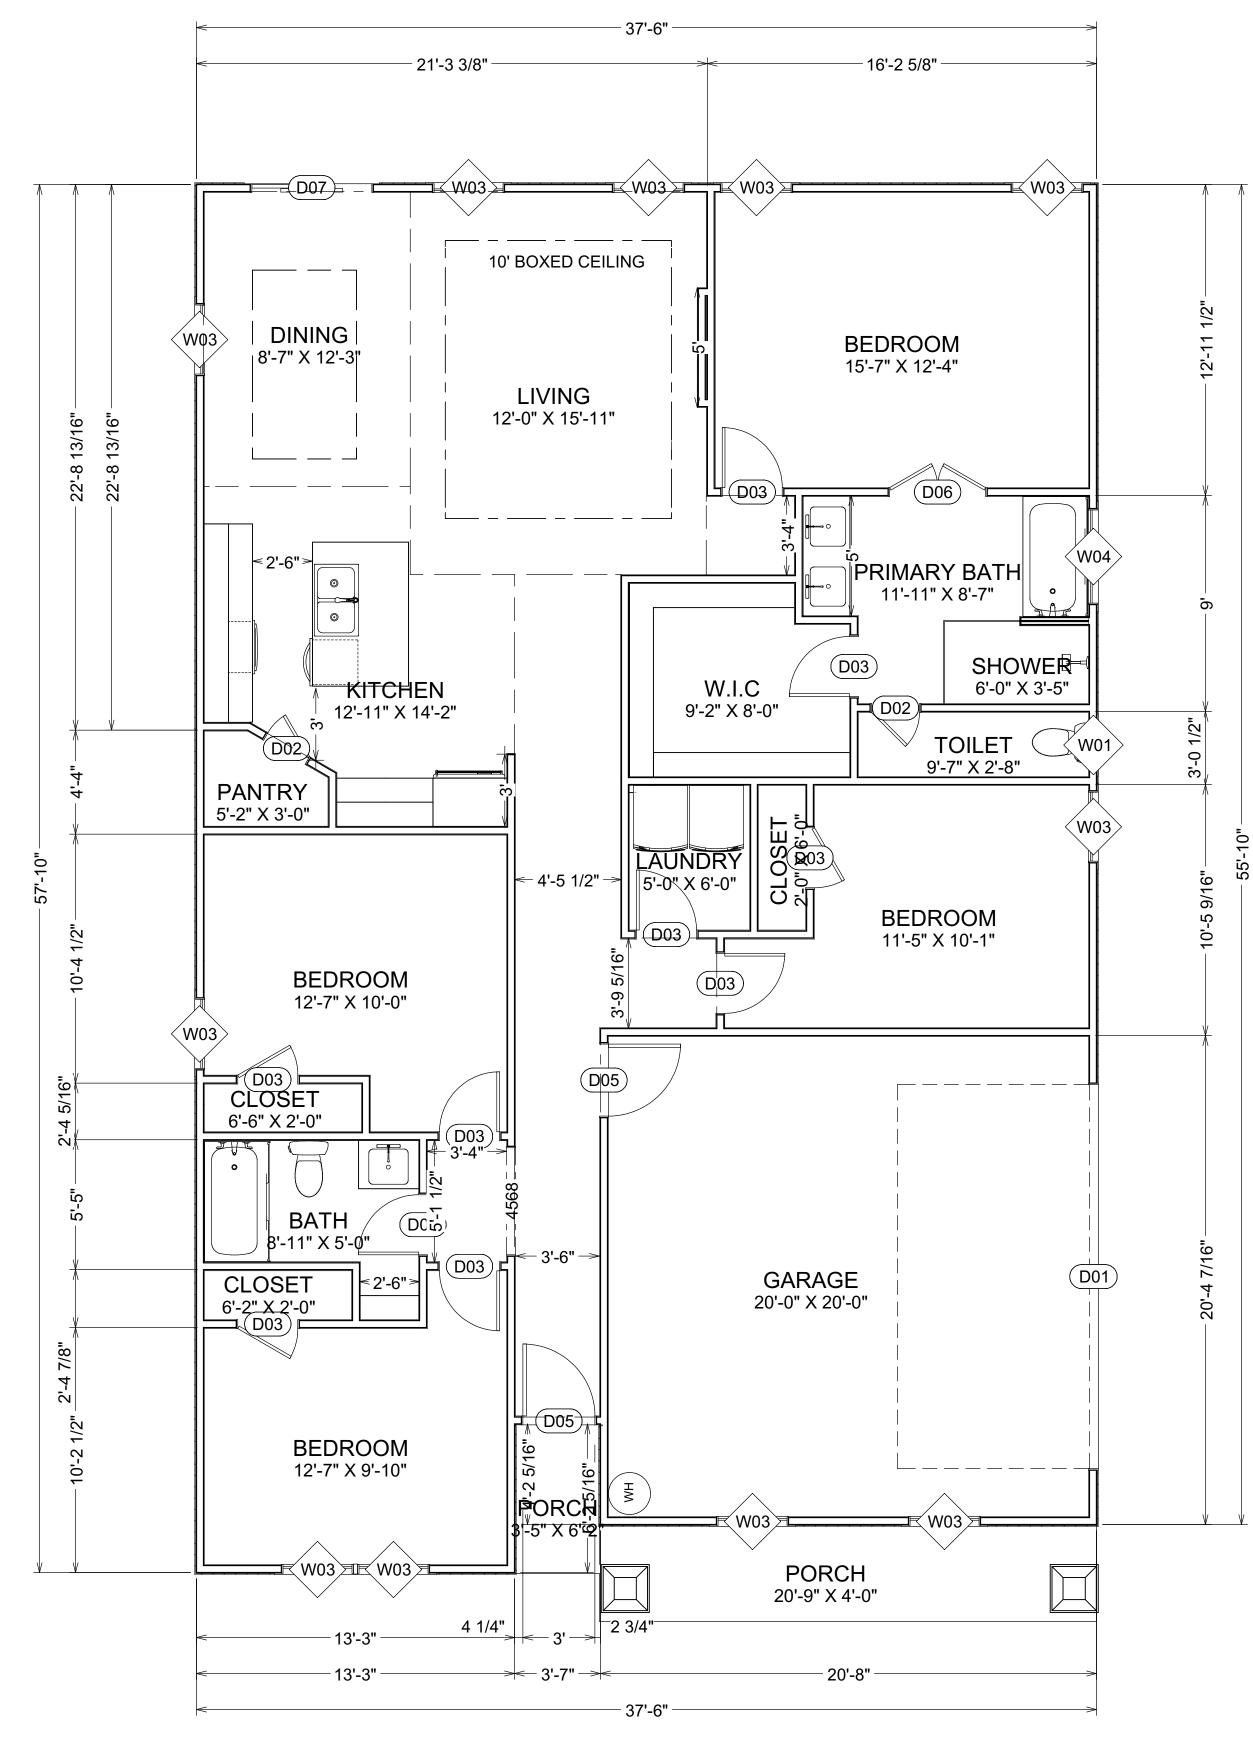

LIVING AREA 1689 SQ FT

CURRENT ADOPTED CODES: 2021 INTERNATIONAL RESIDENTIAL CODE 2020 NATIONAL ELECTRIC CODE 2021 INTERNATIONAL ENERGY CONSERVATION CODE

WINDOW SCHEDULE				
NUMBER	QTY	HEIGHT	WIDTH	DESC
W01	1	24"	24"	SING
W02	1	36"	24"	FIXED
W03	11	72"	36"	SING
W04	1	24"	48"	SING

	DOOR SCHEDULE				
NUMBER	QTY	HEIGHT	WIDTH	DESCRIPTION	
D01	1	96"	192"	GARAGE-GARAGE DOOR CHD05	
D02	2	80"	24"	HINGED-DOOR P04	
D03	10	80"	30"	HINGED-DOOR P04	
D05	2	80"	36"	EXT. HINGED-DOOR E21	
D06	1	80"	48"	DOUBLE HINGED-DOOR P04	
D07	1	80"	60"	EXT. SLIDER-GLASS PANEL	

SQUARE FOOTA

PROPOSED LIVING AREA

PROPOSED PORCH/PATIC

PROPOSED GARAGE AREA

TOTAL AREA

RIPTION
E HUNG
GLASS
E HUNG
E HUNG

AGE	
A	1,689 SQ FT
O AREA	104 SQ FT
A	400 SQ FT
	2,193 SQ FT



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CRAFTSMAN STYLE SINGLE FAMILY RESIDENCE ONE STORY | 4 BEDROOM, 2 BATH

SCALE:

1/4'' = 1'

SHEET TITLE:

A-2

FLOOR PLAN





- HIGHEST RIDGE TOP OF PLATE
- TOP OF SUBFLOOR FOUNDATION 0' BOTTOM OF FOOTING -1'

REAR ELEVATION

SIDING: ROYCROFT VELLUM (SW 2833) TRIMS: CLASSICAL WHITE (SW 2829)

FRONT ELEVATION

SIDING: ROYCROFT VELLUM (SW 2833) TRIMS & DECORATIVE MILLWORK: CLASSICAL WHITE (SW 2829)

-AMERICAN CRAFTSMAN STANDARD GLASS WINDOWS

-HARDIE BOARD SIDING

-AMERICAN CRAFTSMAN STANDARD GLASS WINDOWS W/LITES

-HARDIE BOARD SIDING



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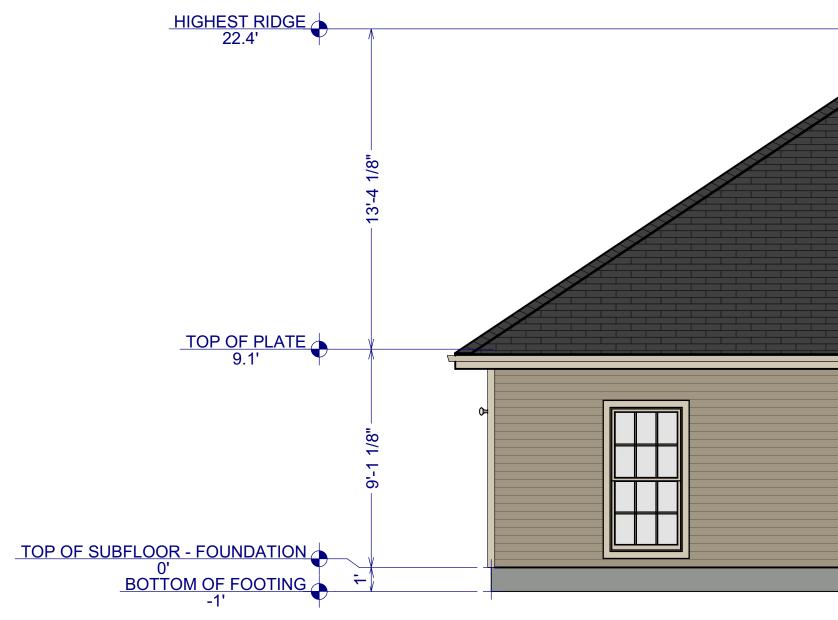
SCALE:

1/4" = 1'

SHEET TITLE:

FRONT & REAR ELEVATIONS








GARAGE DOOR: CRAFTSMAN BROWN (SW 2835) ROOF: GREY SIDING: ROYCROFT VELLUM (SW 2833) TRIMS: CLASSICAL WHITE (SW 2829)

RIGHT ELEVATION


-ROOF: ASPHALT SHINGLES -HARDIE BOARD SIDING -WALL CORNER BOARDS



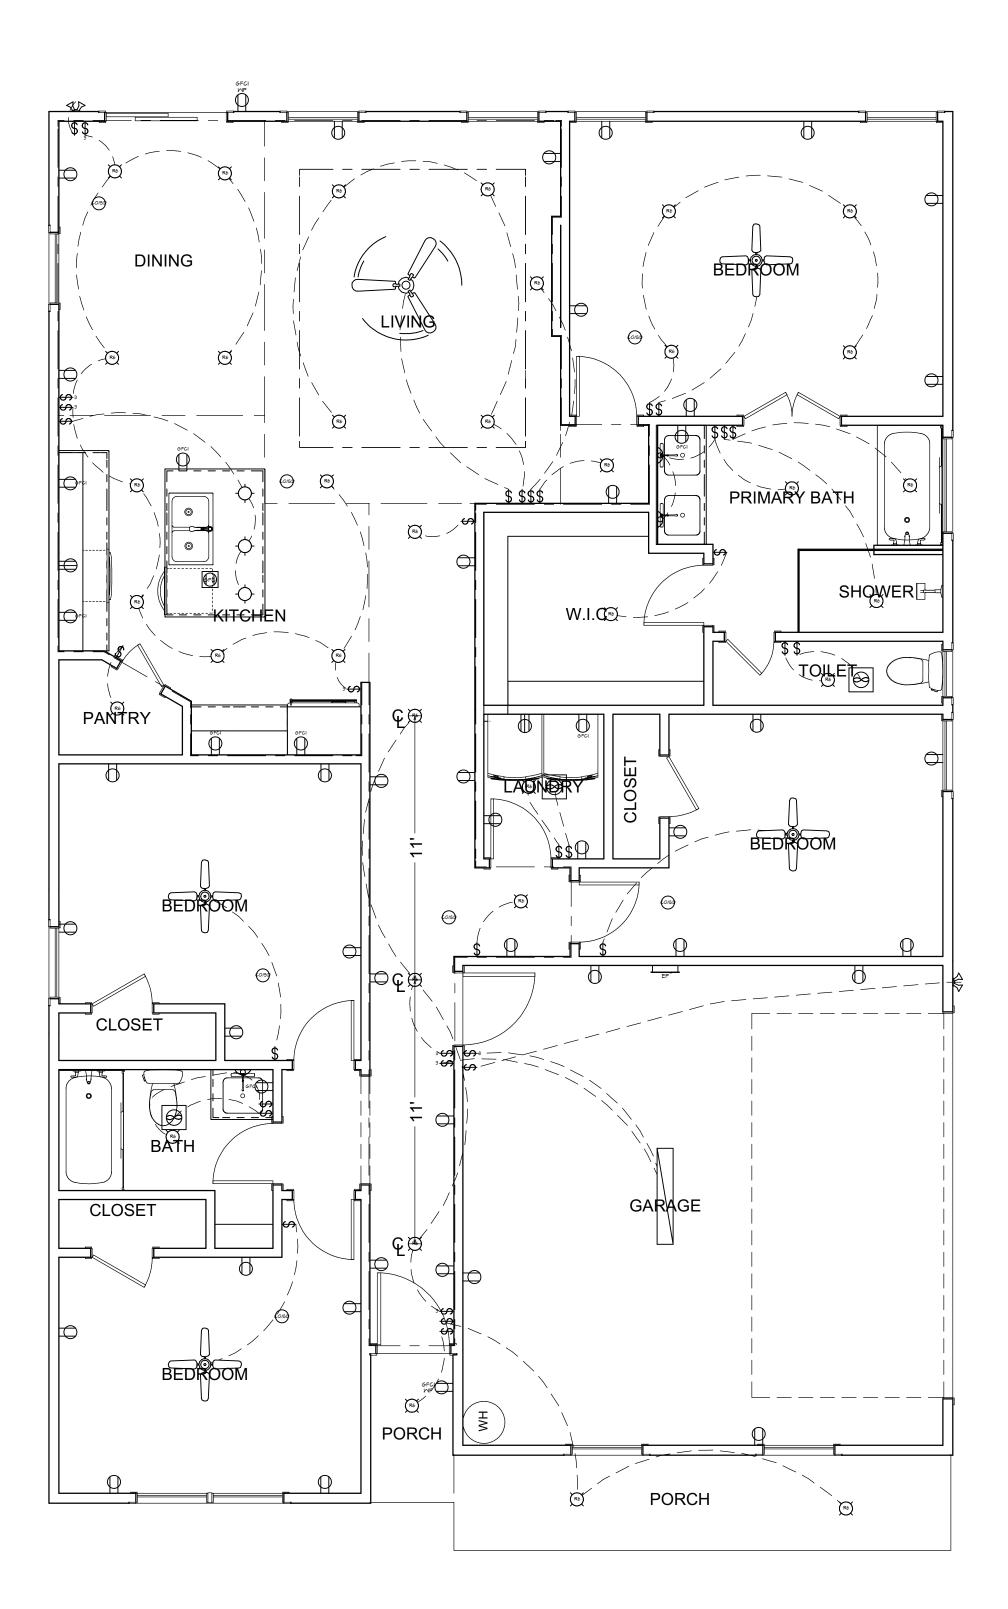

LIVING AREA 1689 SQ FT

ELECTRICAL SCHEDULE						
2D SYMBOL	DESCRIPTION	QTY				
	3 BLADE CEILING FAN	1				
	CEILING FAN (LIGHTS)	4				
	220V	2				
	DUPLEX	40				
GFCI	GFCI	8				
GFC	GFCI DUPLEX FLOOR RECEPTACLE	1				
R6	RECESSED DOWN LIGHT 6	35				
\heartsuit	GRAN TENOS	3				
	PENDANT	3				
COISD	CO/SMOKE DETECTOR	7				
\bigotimes	EXHAUST FAN	3				
	MEDIUM RECESSED TUBE LIGHT [48W6D]	1				
	DUAL SPOTLIGHT	2				
GFCI MP	GFCI WEATHERPROOF RECEPTACLE	2				
EP	ELECTRICAL PANEL - SURFACE MOUNTED	1				
\mathbb{S}	SINGLE POLE SWITCH	27				
S ⇒	3-WAY SWITCH	8				

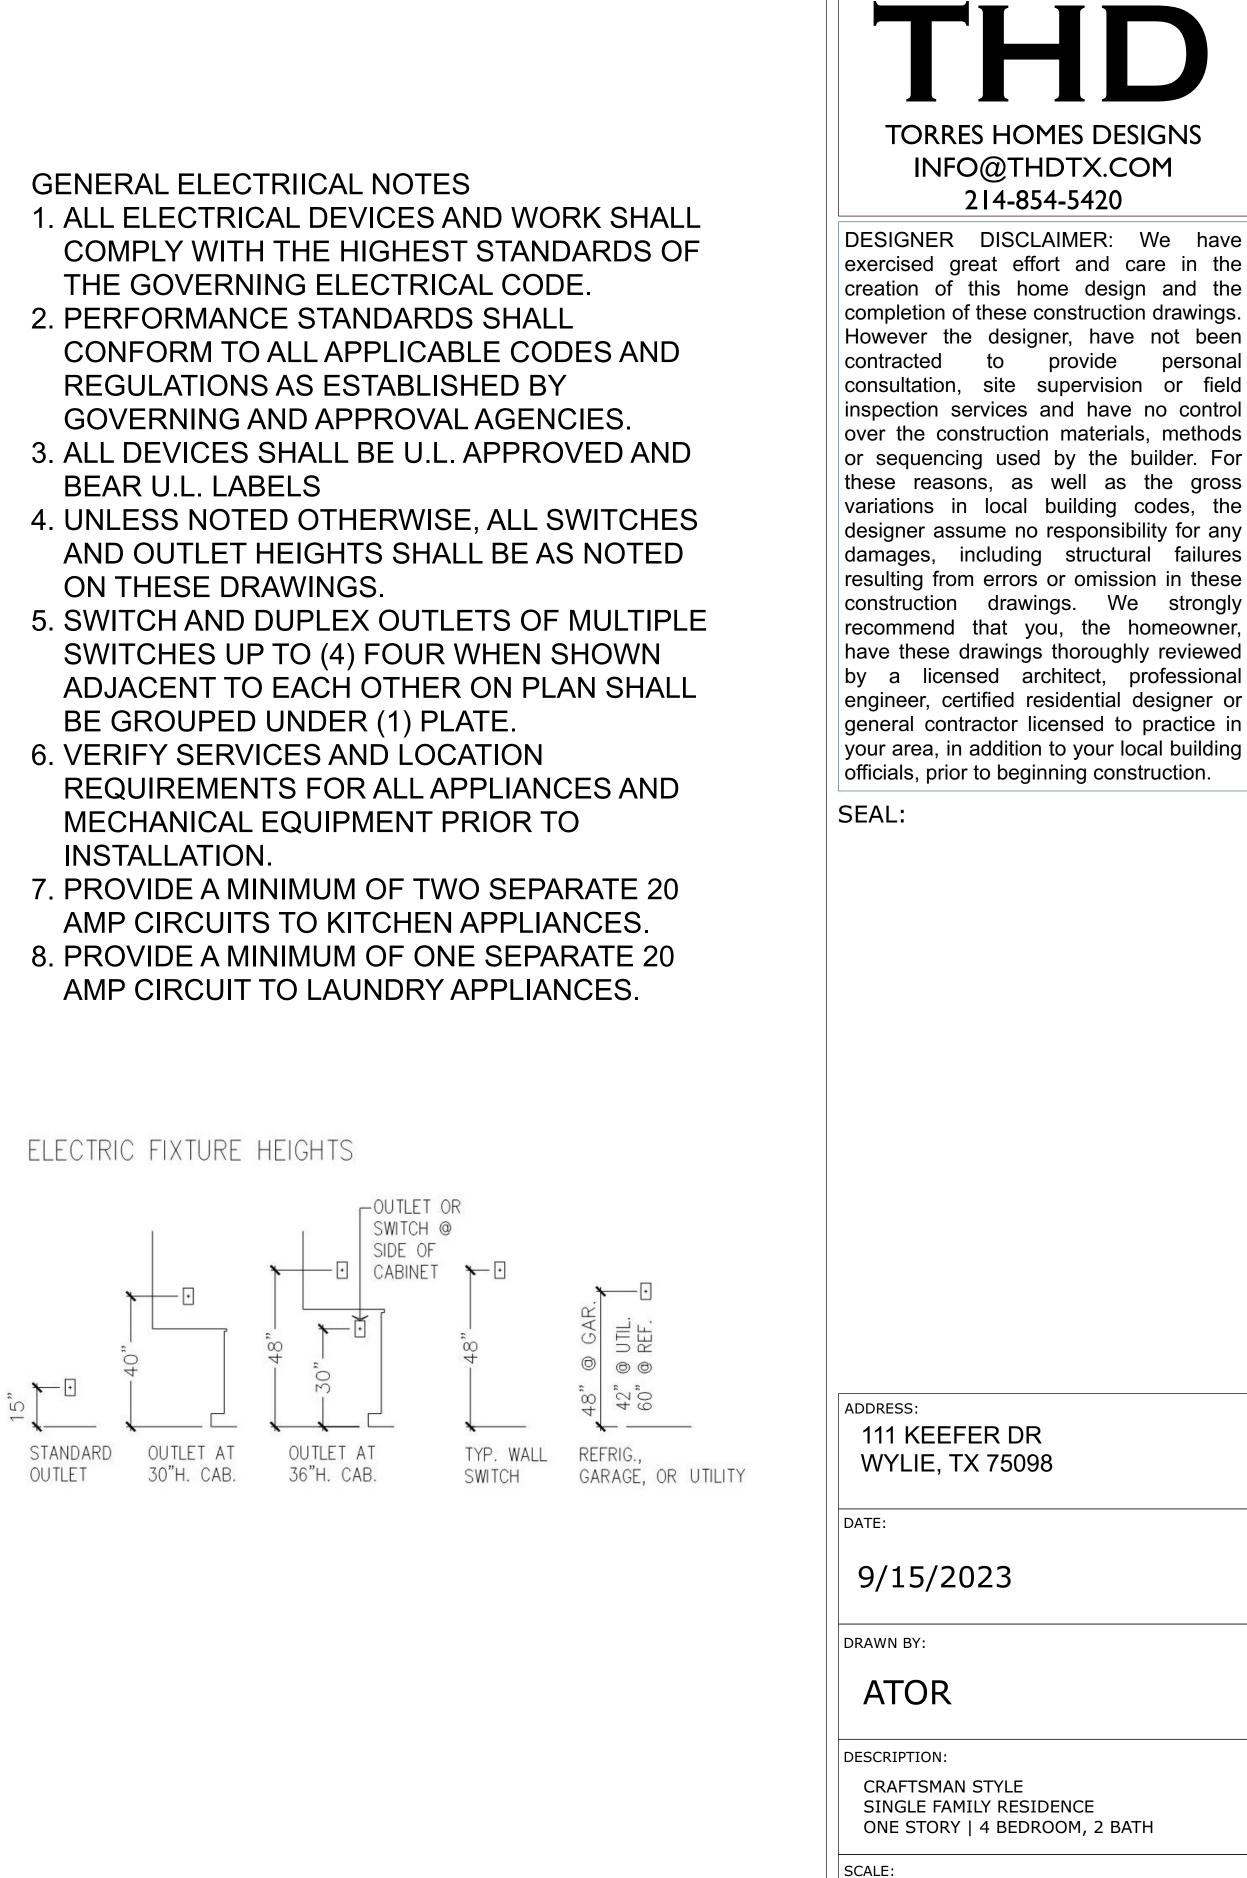


1/4" = 1'

SHEET TITLE:


A-5

ELECTRICAL & LIGHTING PLAN

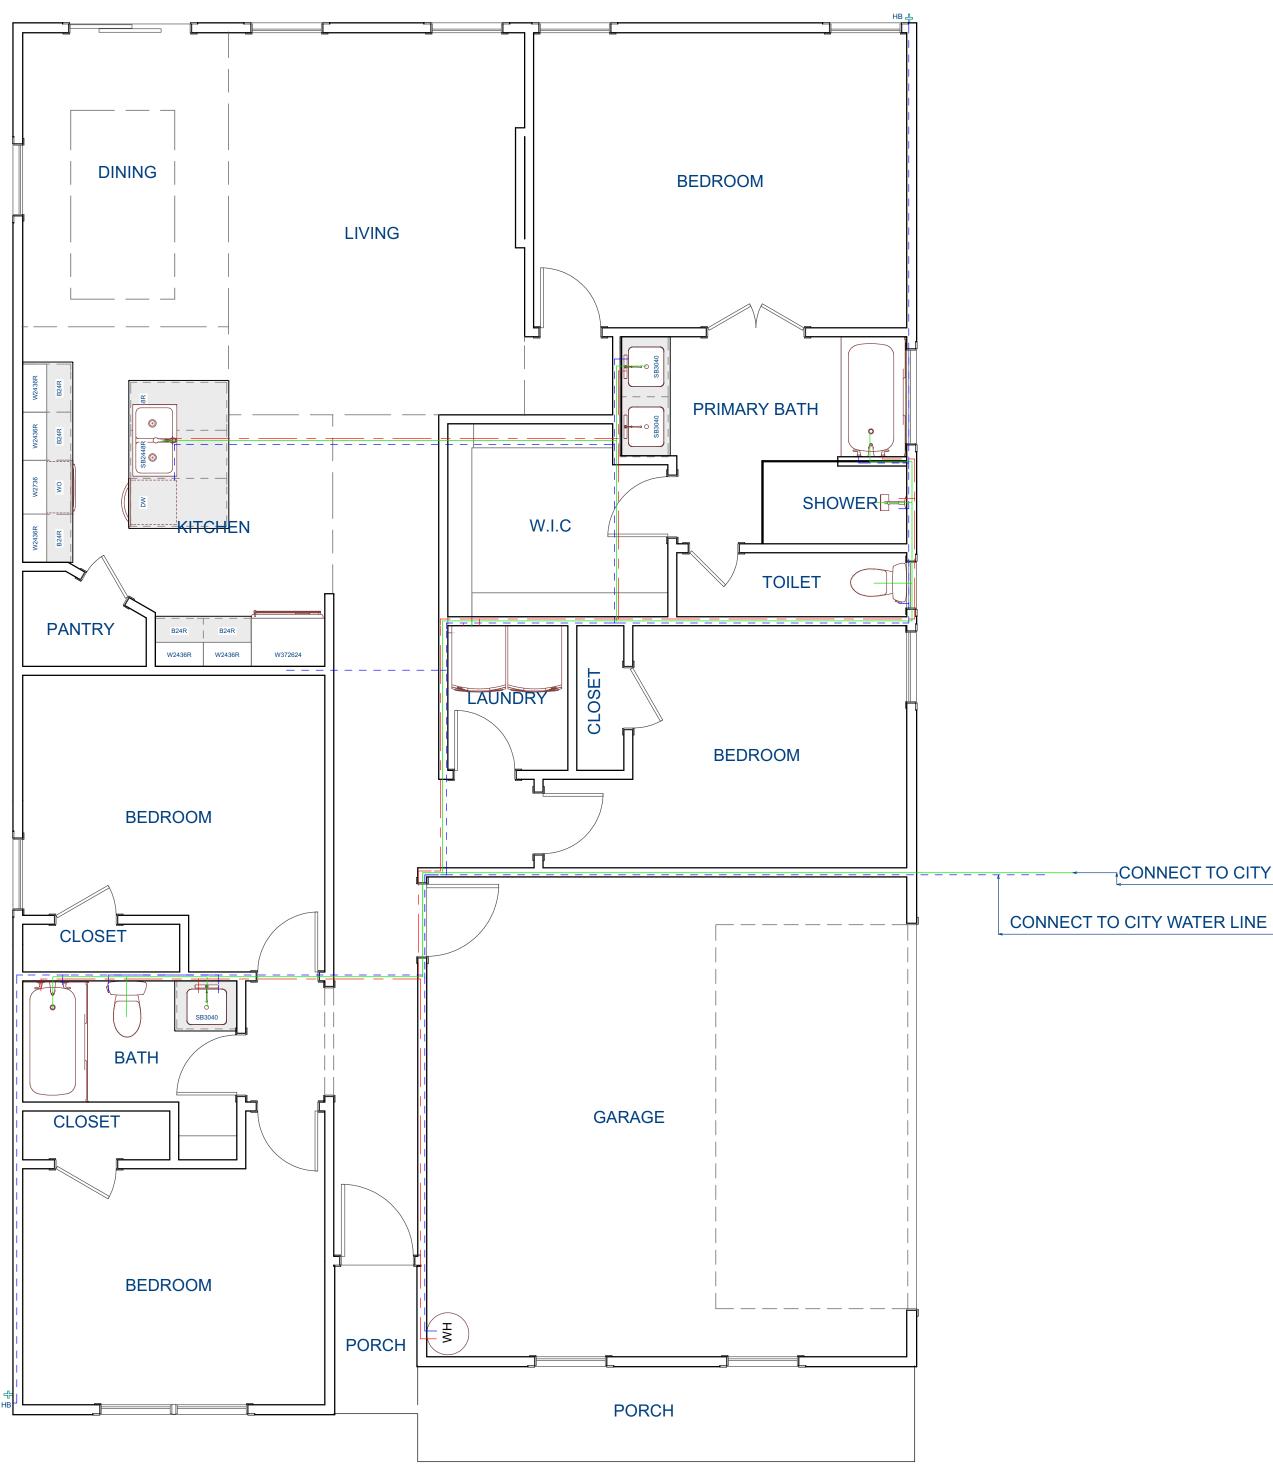


LIVING AREA 1689 SQ FT

NOTE: (N.T.S) WATER HEATERS TO BE INSTALLED IN ACCORDANCE WITH THE MANUFACTURE'S INSTRUCTIONS

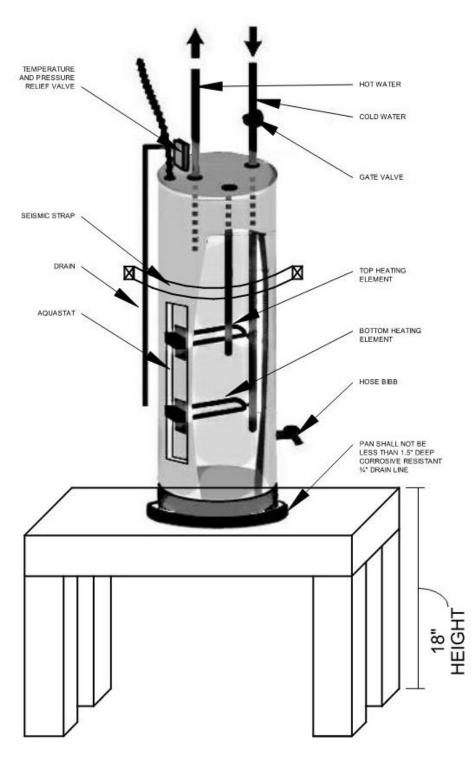

CONNECT TO CITY SEWER LINE

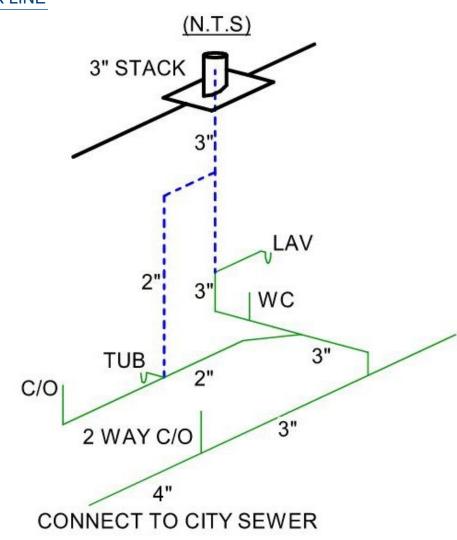


PLUMBING

NOTE: WATER HEATER OPTION TO BE DECIDED BY OWNER/GENERAL CONTRACTOR

	COLD WATER LINE
	HOT WATER LINE
	SEWER LINE
WH	WATER HEATER

PLUMBING GENERAL NOTES

- WITH DISABILITIES, SHALL BE IN ACCORDANCE WITH ADA REQUIREMENTS.
- INSTALLATION.
- WITH THE PLUMBING AND DRAINAGE INSTITUTE STANDARD.
- DRAWINGS.
- PLUMBING EQUIPMENT AND FIXTURES.
- OTHER TRADES TO PROVIDE THIS ACCESS AND CLEARANCE.
- THE SPACE ALLOTTED FOR ADEQUACY AND CLEARANCE REQUIREMENTS.
- RATED WALL, CEILING, ROOF AND FLOOR PENETRATIONS
- THROUGH LAY INSUSPENDED CEILING.
- FULL LIMITS OF OPERATION.
- INSTALLED.
- SYSTEMS INSTALLED BY OTHER TRADES OR BUILDING CONSTRUCTION.
- STRUCTURE TO ALLOW PROPER PITCH AND MAXIMIZE CEILING HEIGHT.
- WITH A CHROME PLATED ESCUTCHEON AT EACH FINISHED ENTRY/EXIT.
- ROUTED AS HIGH AS POSSIBLE AND TO THE UNDERSIDE OF STRUCTURE.

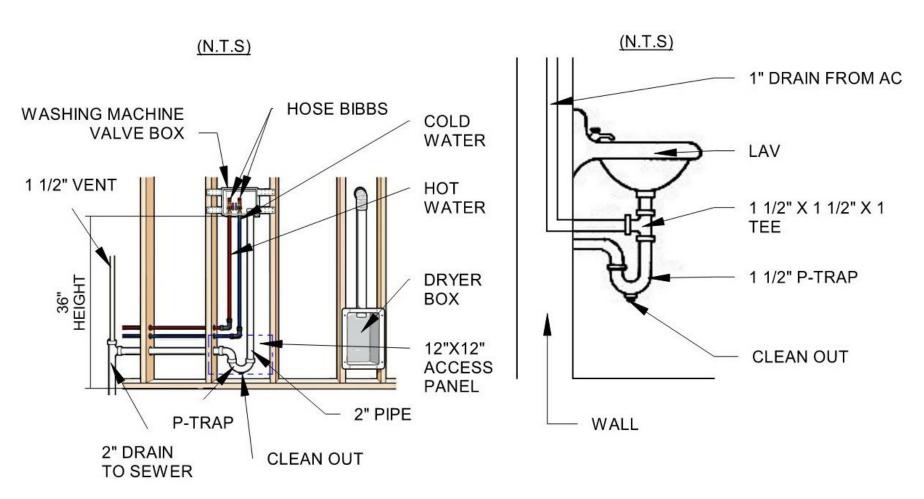

1. ALL PLUMBING WORK SHALL BE IN CONFORMANCE WITH THE TEXAS PLUMBING CODE, LATEST EDITION ADOPTED BY THE STATE OF TEXAS WITH TEXAS AMENDMENTS, MUNICIPAL OR CITY CODES, AND THE AUTHORITY HAVING JURISDICTION. INSTALLATION OF PLUMBING FIXTURES AND ACCESSORIES, INCLUDING FLUSH CONTROL VALVES INTENDED FOR PEOPLE

2. INSTALLATION OF PLUMBING PIPING SHALL BE FULLY COORDINATED WITH STRUCTURAL, ARCHITECTURAL, ELECTRICAL, AND HVAC DRAWINGS TO AVOID CONFLICT. NO PLUMBING (WATER, DRAINS, VENT, OR GAS PIPING) SHALL BE INSTALLED DIRECTLY ABOVE ANY ELECTRICAL PANELS. COORDINATE WITH OTHER DIVISIONS BEFORE PROCEEDING WITH

3. PROVIDE WATER HAMMER ARRESTERS AT PLUMBING FIXTURES AND GROUPS OF PLUMBING FIXTURES THAT ARE SUBJECT TO WATER HAMMER. SELECT ARRESTERS IN ACCORDANCE

4. ALL PLUMBING SERVICES GOING INTO THE BUILDING AND LEAVING THE BUILDING SHALL BE CONNECTED TO THE SITE UTILITIES, COORDINATE WITH SITE UTILITIES. COORDINATE ALL EXTERIOR UNDERGROUND PLUMBING WORK WITH THE SITE UTILITIES BEFORE COMMENCING WORK. COORDINATE ALL UNDERGROUND PIPING WITH FOUNDATION

5. INSTALL BALL VALVE CLOSE TO WATER MAIN ON EACH BRANCH AND RISER SERVING

6. ALL EQUIPMENT, FIXTURES, AND SERVICEABLE DEVICES SHALL BE INSTALLED WITH ACCESS AND CLEARANCE FOR MAINTENANCE. COORDINATE WITH THE GENERAL CONTRACTOR AND

7. INSTALL ALL EQUIPMENT AND MATERIALS PER MANUFACTURER'S INSTRUCTIONS.

8. IF EQUIPMENT, FIXTURES, AND MATERIAL, OTHER THAN THAT SCHEDULEDOR SPECIFIED, IS APPROVED AND PROVIDED, IT IS THE RESPONSIBILITY OF THE CONTRACTOR TO COORDINATE AND PROVIDE REVISED UTILITIES AND SERVICE CONNECTIONS AND VERIFY

9. COORDINATE ALL LOCATIONS AND SIZES OF STRUCTURAL FLOOR AND WALL PENETRATIONS WITH THE GENERAL CONTRACTOR AND PROVIDE CODE REQUIRED SEALS AT ALL FIRE

10. ACCESS DOORS AND/OR PANELS SHALL BE PROVIDED AT ALL MAINTENANCE AND SERVICE LOCATIONS FOR CONCEALED CONTROL DEVICES, VALVES AND PLUMBING EQUIPMENT/ DEVICES. UNLESS A SIZE IS SPECIFICALLY NOTED, PANELS SHALL BE SIZED TO SERVICE EQUIPMENT/DEVICE. DOORS AND PANELS SHALL HAVE THE SAME FIRE RATING AS THE WALL OR CEILING IN WHICH THEY ARE INSTALLED. ACCESS DOORS AND/OR PANELS ARE NOT REQUIRED WHERE ADJUSTMENT, MAINTENANCE AND REPLACEMENT ARE POSSIBLE

11. INSTALL SHUT OFF VALVES AT EACH FIXTURE. INSTALL BRANCH SHUTOFF VALVES WHERE INDICATED ON PLANS. LOCATE AND ORIENT VALVE OPERATORS FOR EASE OF ACCESS AND

12. OPENINGS DUE TO INSTALLATION OF DRAINAGE AND VENT SYSTEMS SHALL BE PROTECTED WITH A TEST PLUG SECURED AND LOCKED IN PLACE UNTIL FINAL CONNECTIONS ARE

13. INSULATION AND VAPOR BARRIER SHALL BE PROVIDED ON ALL PIPING AND/OR EQUIPMENT SUBJECT TO HEAT LOSS, CONDENSATION, OR CONSTITUTING A POTENTIAL BURN HAZARD. INSULATION SHALL NOT BE CRUSHED OR COMPRESSED THROUGH INTERFERENCE WITH

14. INSTALL PLUMBING AND PIPING HIGH POINTS AS TIGHT AS POSSIBLE TO THE BUILDING

15. ALL PIPING SHALL BE CONCEALED IN WALLS AND BEHIND FIXED FURNISHINGS UNLESS OTHERWISE INDICATED. EXPOSED PIPING IN FINISHED AREAS SHALL BE CHROME PLATED

16. ALL PIPING SHALL BE RUN PARALLEL TO BUILDING LINES AND BE SUPPORTED AND ANCHORED AS REQUIRED TO FACILITATE EXPANSION AND CONTRACTION. ALL PIPING SHALL BE CONCEALED EXCEPT IN UNFINISHED SPACES. INSTALL AS REQUIRED TO MEET ALL CONSTRUCTION CONDITIONS AND TO ALLOW FOR INSTALLATION OF OTHER WORK INCLUDING DUCTS AND ELECTRICAL CONDUIT. ALL PIPING EXPOSED TO VIEW SHALL BE



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9/15/2023

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ATOR

DESCRIPTION:

CRAFTSMAN STYLE SINGLE FAMILY RESIDENCE ONE STORY | 4 BEDROOM, 2 BATH


SCALE:


1/4'' = 1'

SHEET TITLE:

PLUMBING PLAN



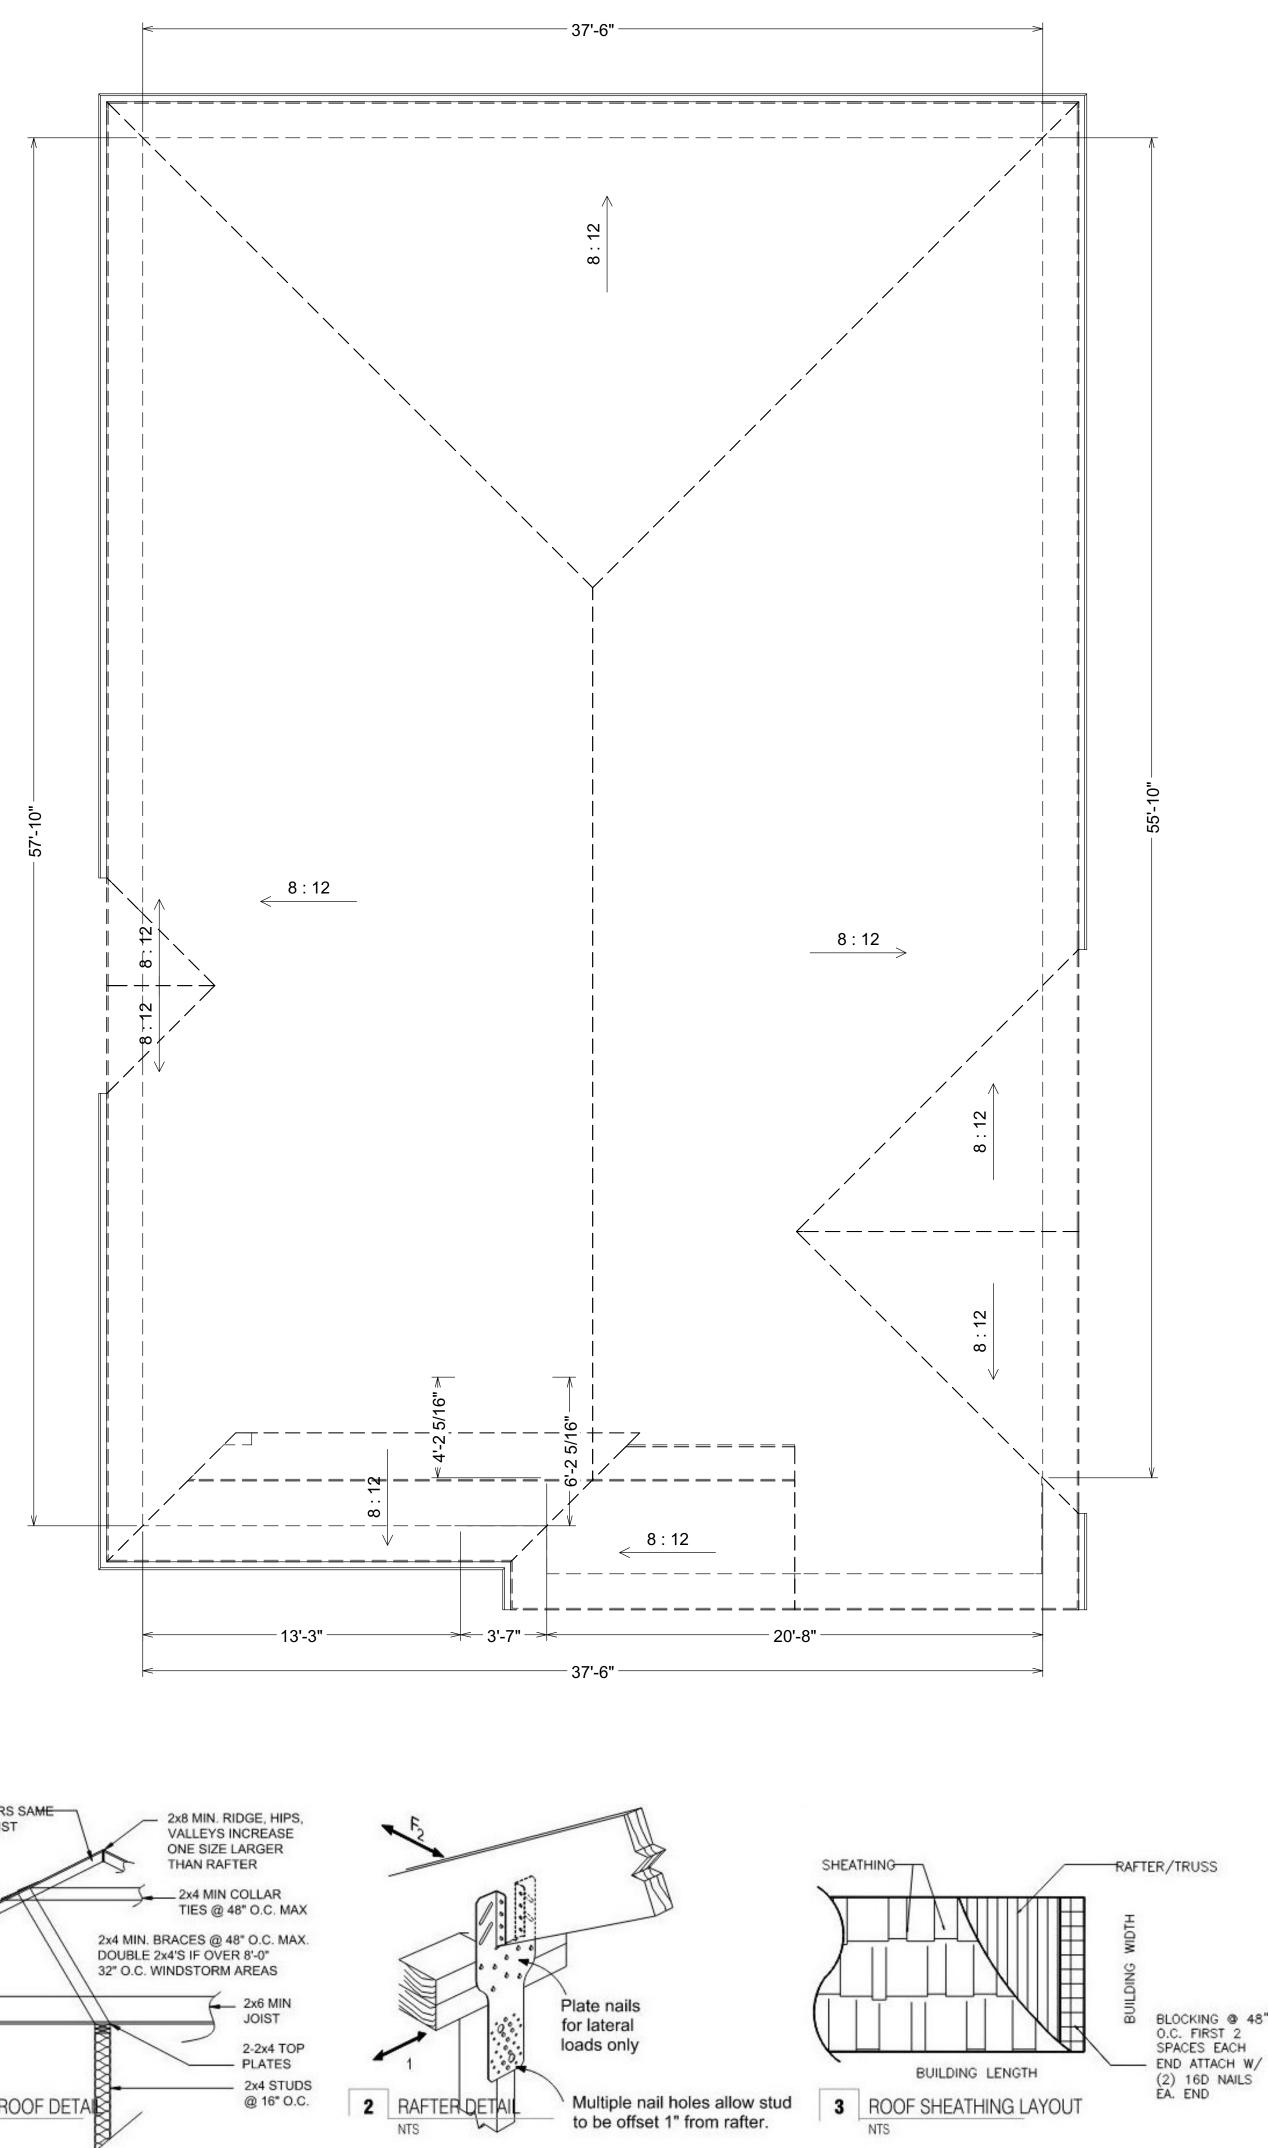

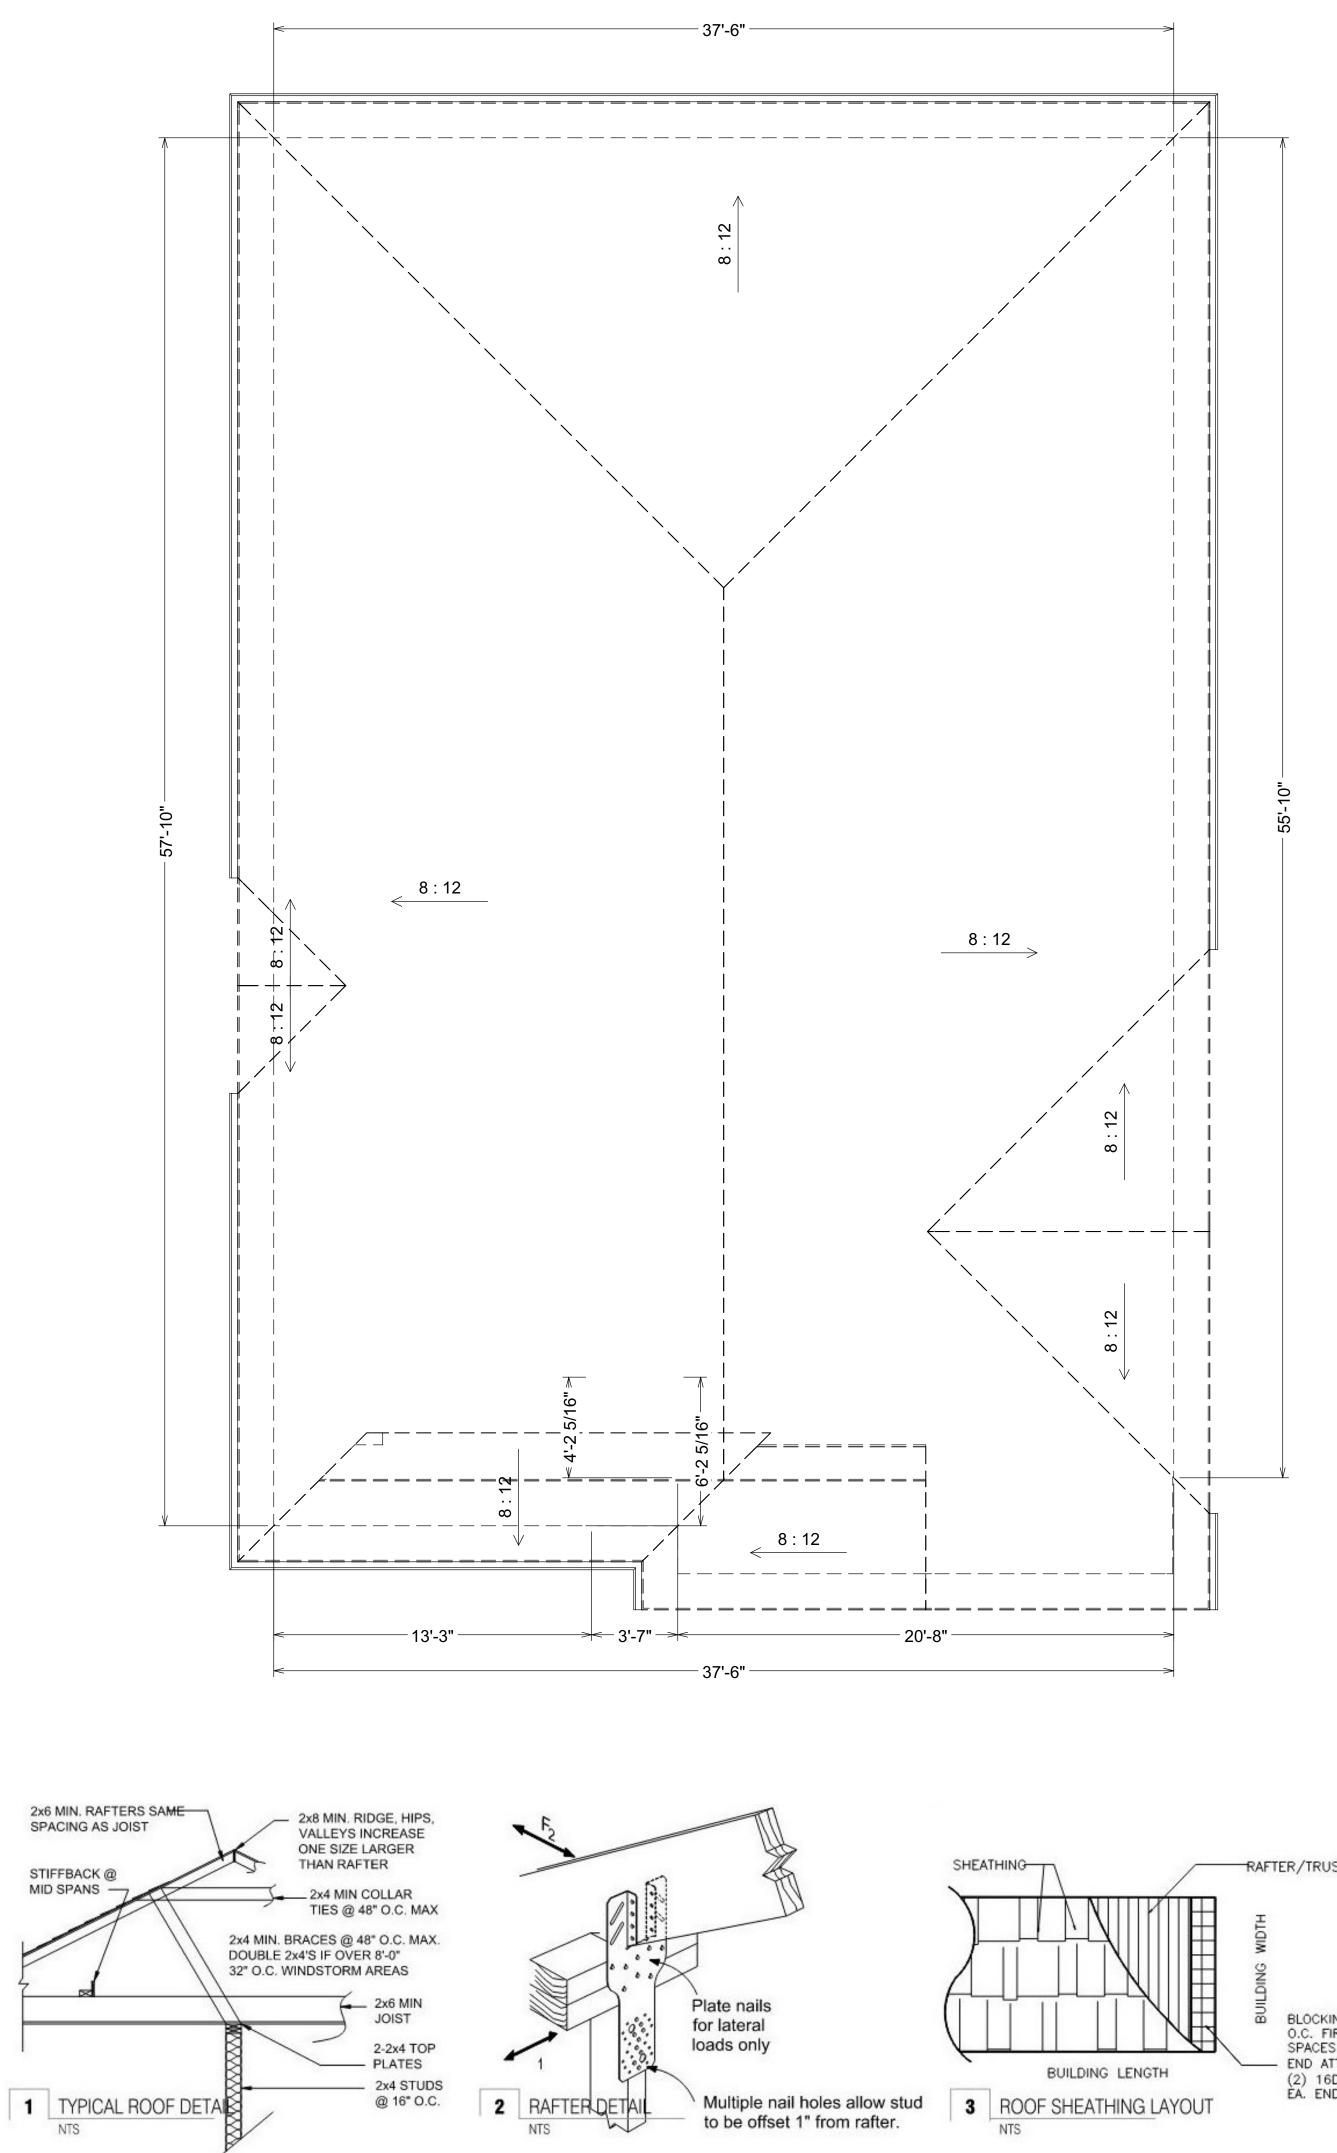

ROOF VENTING NOTES: PROVIDE ADEQUATE VENTING FOR ATTIC USING A COMBINATION OF CONTINUOUS SOFFIT VENTING AND EITHER CONTINUOUS RIDGE VENTS AT ALL ROOF RIDGES OR VENT TILES TO COORDINATE WITH ROOF TILES. OWNER TO MAKE FINAL DECISION. IF VENT TILES ARE SELECTED, THEY SHALL BE LOCATED ON THE UPPER 1/3 OF THE ROOF AND INSTALLED ON THE ROOF PLANES NOT VISIBLE FROM THE MAIN ENTRY DRIVE. REFER TO ROOF TILE MANUFACTURER SPECIFICATIONS FOR ANY ADDITIONAL VENTING NOTES OR REQUIREMENTS.

ROOF PLAN SCALE = 1/4" = 1'-0" -ROOF AS SPECIFIED @ 8/12 PITCH UNLESS NOTED OTHERWISE -ALL OVERHANGS @ 18 UNLESS NOTED OTHERWISE

FRAMING GENERAL NOTES:

- 1. ALL LUMBER TO BE NO.2 SYP OR DOUGLAS FUR, 19% M.C. U.O.N. 2. USE BLOCKING WHERE REQUIRED BY 2021 IBC.
- 3. CONNECTIONS TO BE PROPERLY INSTALLED WHERE REQUIRED PER 2018 IBC. 4. NAILS IN CONTACT WITH TREATED WOOD ARE TO BE STAINLESS STEEL OR A MIN. G185
- HDS HOT DIP GALVANIZED SUCH AS: SIMPSON (AMAX G185). 5. TRANSFER ALL LOAD BEARING POINTS TO FOUNDATION.
- 6. SILL PLATES FOR ALL EXTERIOR WALLS SHALL BE OF PRESSURE TREATED LUMBER, OR SHALL BE PROVIDED WITH AN APPROVED VAPOR BARRIER BENEATH THEM. 7. ALL STUD WALLS SHALL BE S.P.F. #2 OR BETTER, KD (19% M.C.) OR #2 SOUTHERN PINE (U.O.N)
- 8. ALL EXT. AND LOAD BEARING STUD WALLS: STUD SPACING SHALL NOT EXCEED 16"
- O.C. FOR 2X4 STUDS AND 24" O.C FOR 2X6 STUDS U.N.O. 9. EXT. JOINTS IN DOUBLE TOP PLATES SHALL BE OFFSET AT LEAST 48 INCHES AND SHALL BE NAILED WITH NOT LESS THAN EIGHT 16d FACE NAILS ON EACH SIDE OF THE JOINT. PLATES SHALL BE NOMINAL 2 INCHES IN DEPTH AND HAVE A WIDTH AT LEAST
- EQUAL TO THE WIDTH OF THE STUDS. 10. AT GABLE ENDS, AT LEAST EVERY OTHER GABLE STUD SHALL BE ATTACHED TO THE
- DOUBLED TOP PLATE AND THE RAFTER WITH A SIMPSON H2.5. 1. BUILDER SHALL TAKE EXTRA CARE TO ENSURE THAT UPPER LEVEL LOAD BEARING
- WALLS AND POSTS CAN TRANSFER THEIR LOADS TO THE SUPPORTS DIRECTLY BELOW THEM. INSTALL BLOCKING OR STUB COLUMNS BELOW FLOOR DECKING.
- 12. ALL ROOF FRAMING DETAILS AND CONNECTIONS SHALL BE IN ACCORDANCE WITH THE 2021 INTERNATIONAL RESIDENTIAL CODE.

ROOF FRAMING NOTES:

1. DESIGN LOADS: ROOF LIVE LOADS 20 PSF

- 2. ALL ROOFS SHALL BE FRAMED 2X6 #2 SYP RAFTERS SPACED @ 16" O.C. WITH A MAX SPAN OF 17"-11". ALL RAFTER SPLICES SHALL BE BRACED W/PLYWOOD GUSSETS BOTH SIDES.
- 3. PURLINS ARE TO BE SAME DEPTH AS RAFTERS THEY ARE SUPPORTING. 4. ALL HIPS, RIDGES AND VALLEYS TO BE AT LEAST ONE
- MILL SIZE LARGER THAN RAFTERS THEY ARE SUPPORTING. 5. PROVIDE COLLAR TIES AR 4'-0" O.C. ON ALL RIDGES.
- 6. ROOF SYSTEM SHALL BE COMPOSITE SHINGLES OVER 30# ROOFING FELT OVER 1/2" CDX PLYWOOD OR OSB STRUCTURAL PANELS. EXPOSURE I.
- 7. CONTRACTOR SHALL FIELD VERIFY ALL ARCHITECTURAL FEATURES AND IS RESPONSIBLE FOR FIT AND FINISH.



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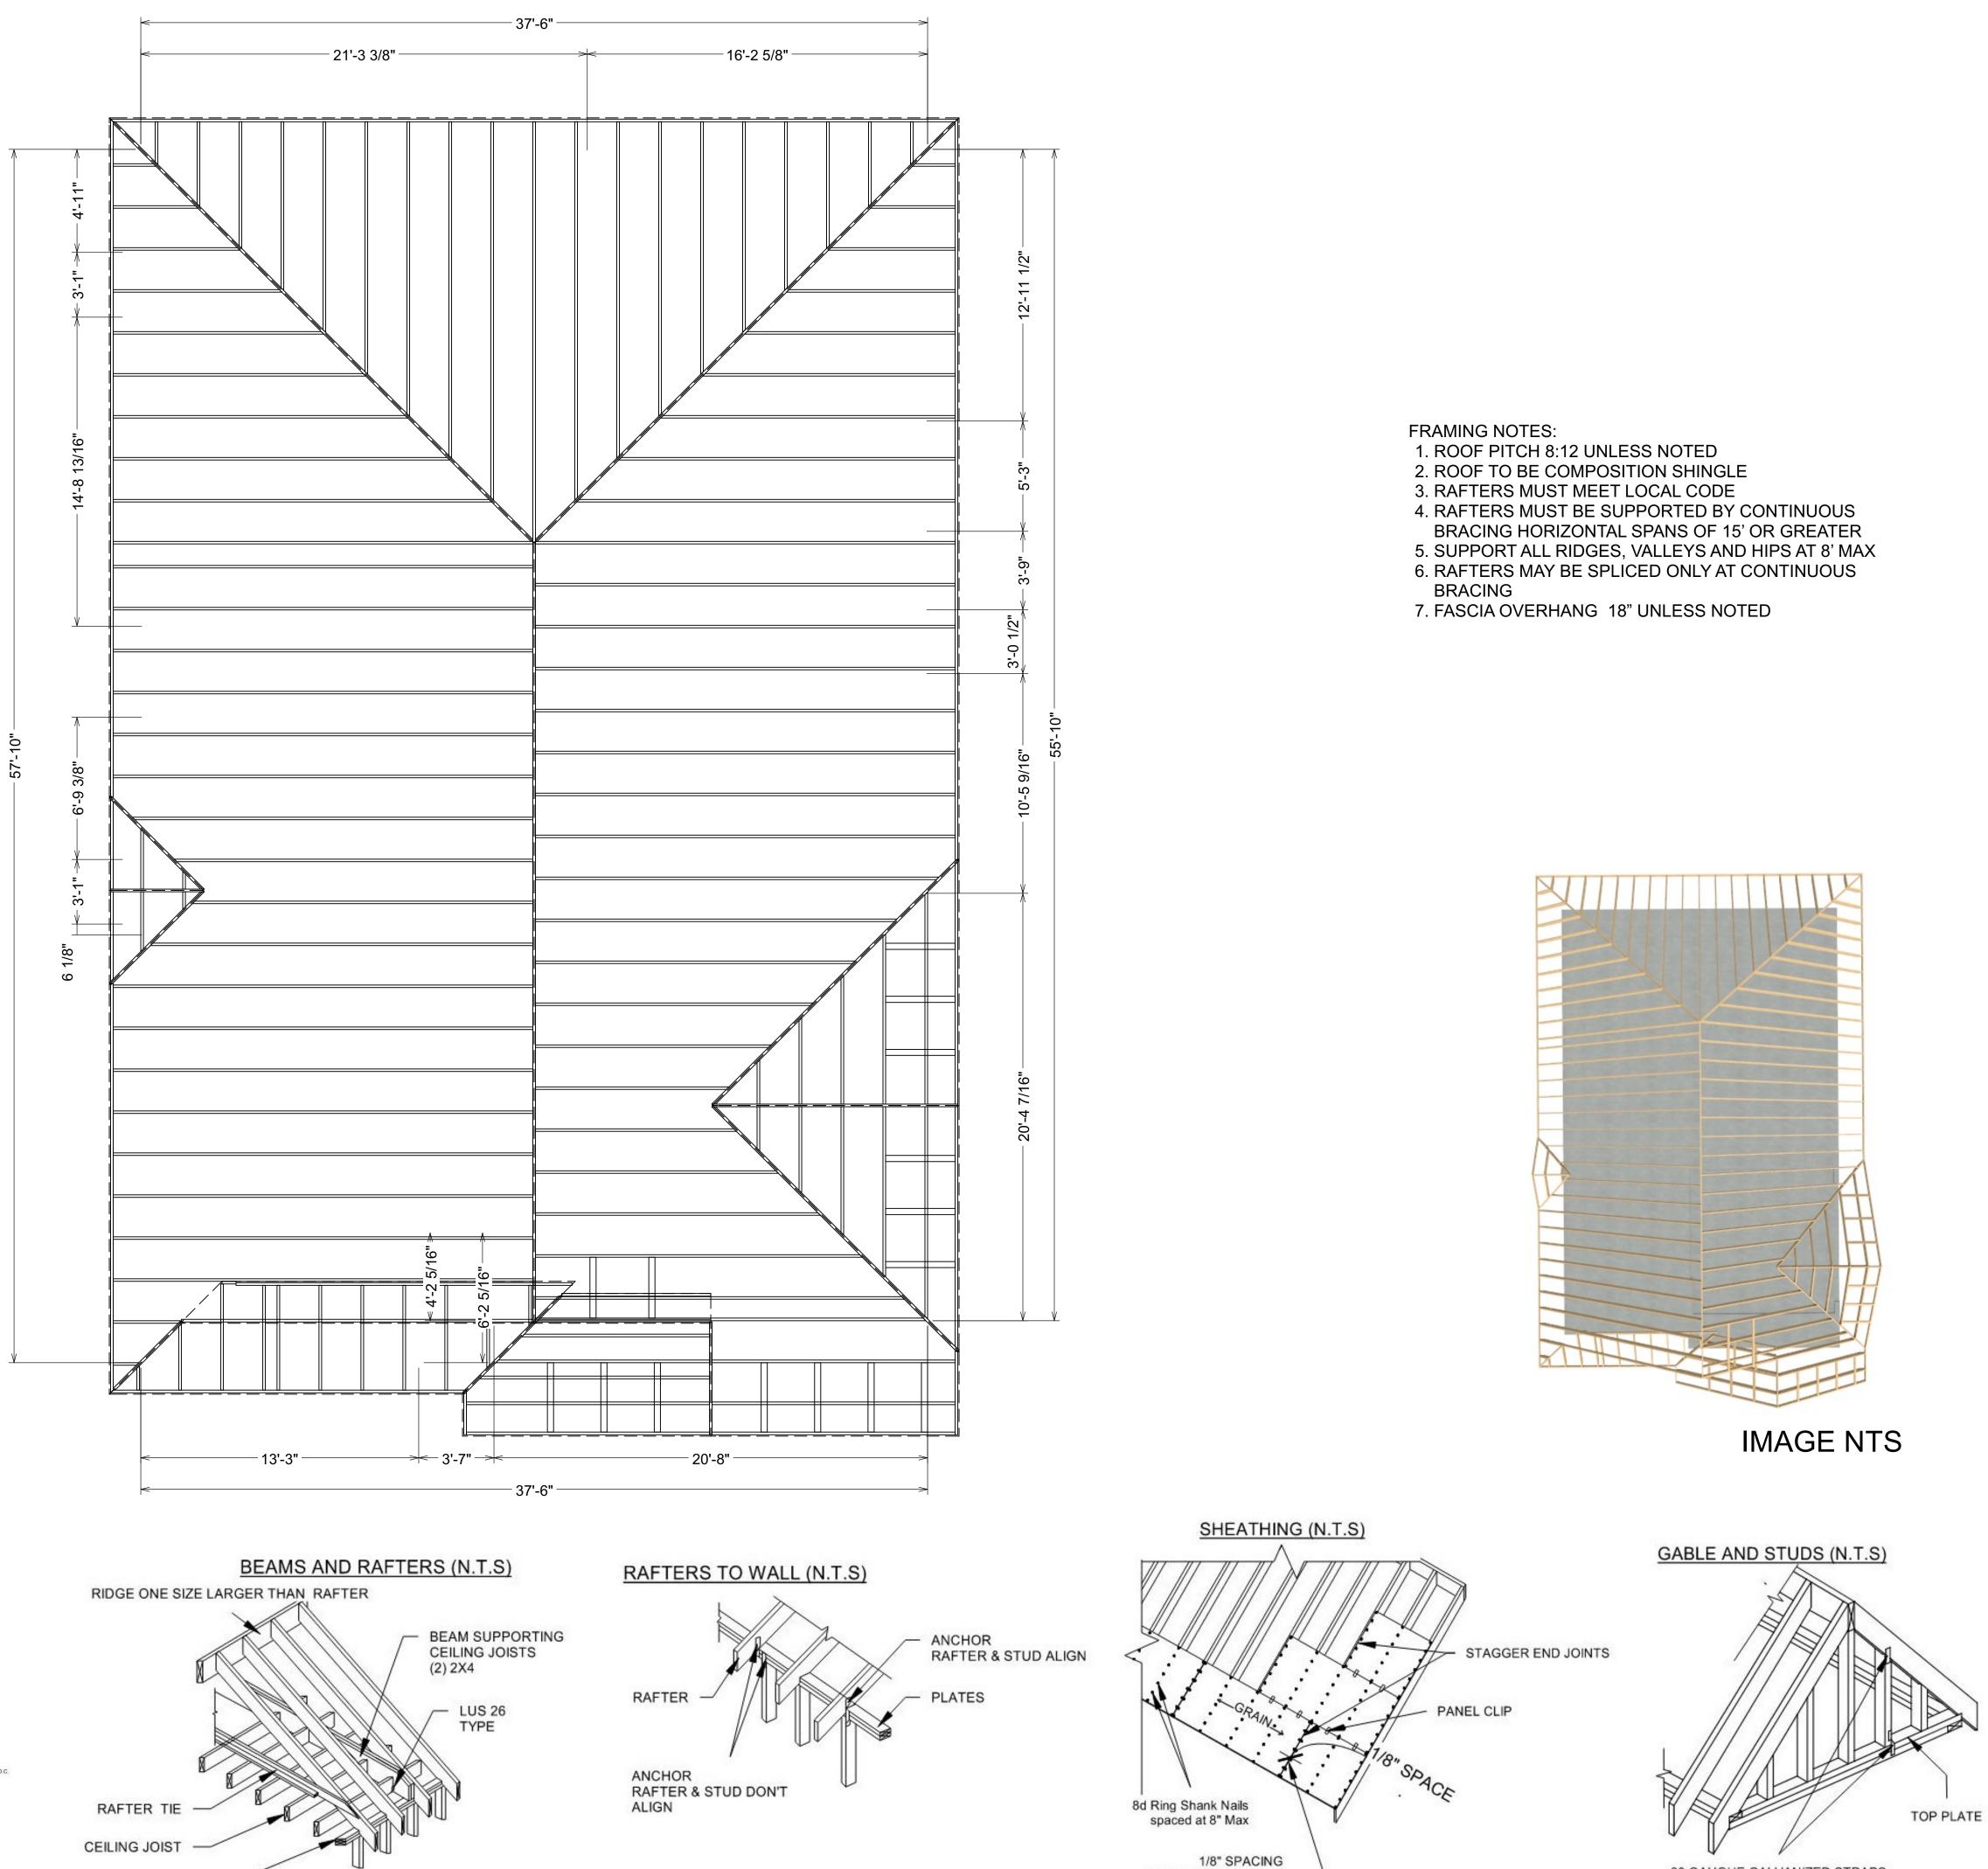
SCALE:


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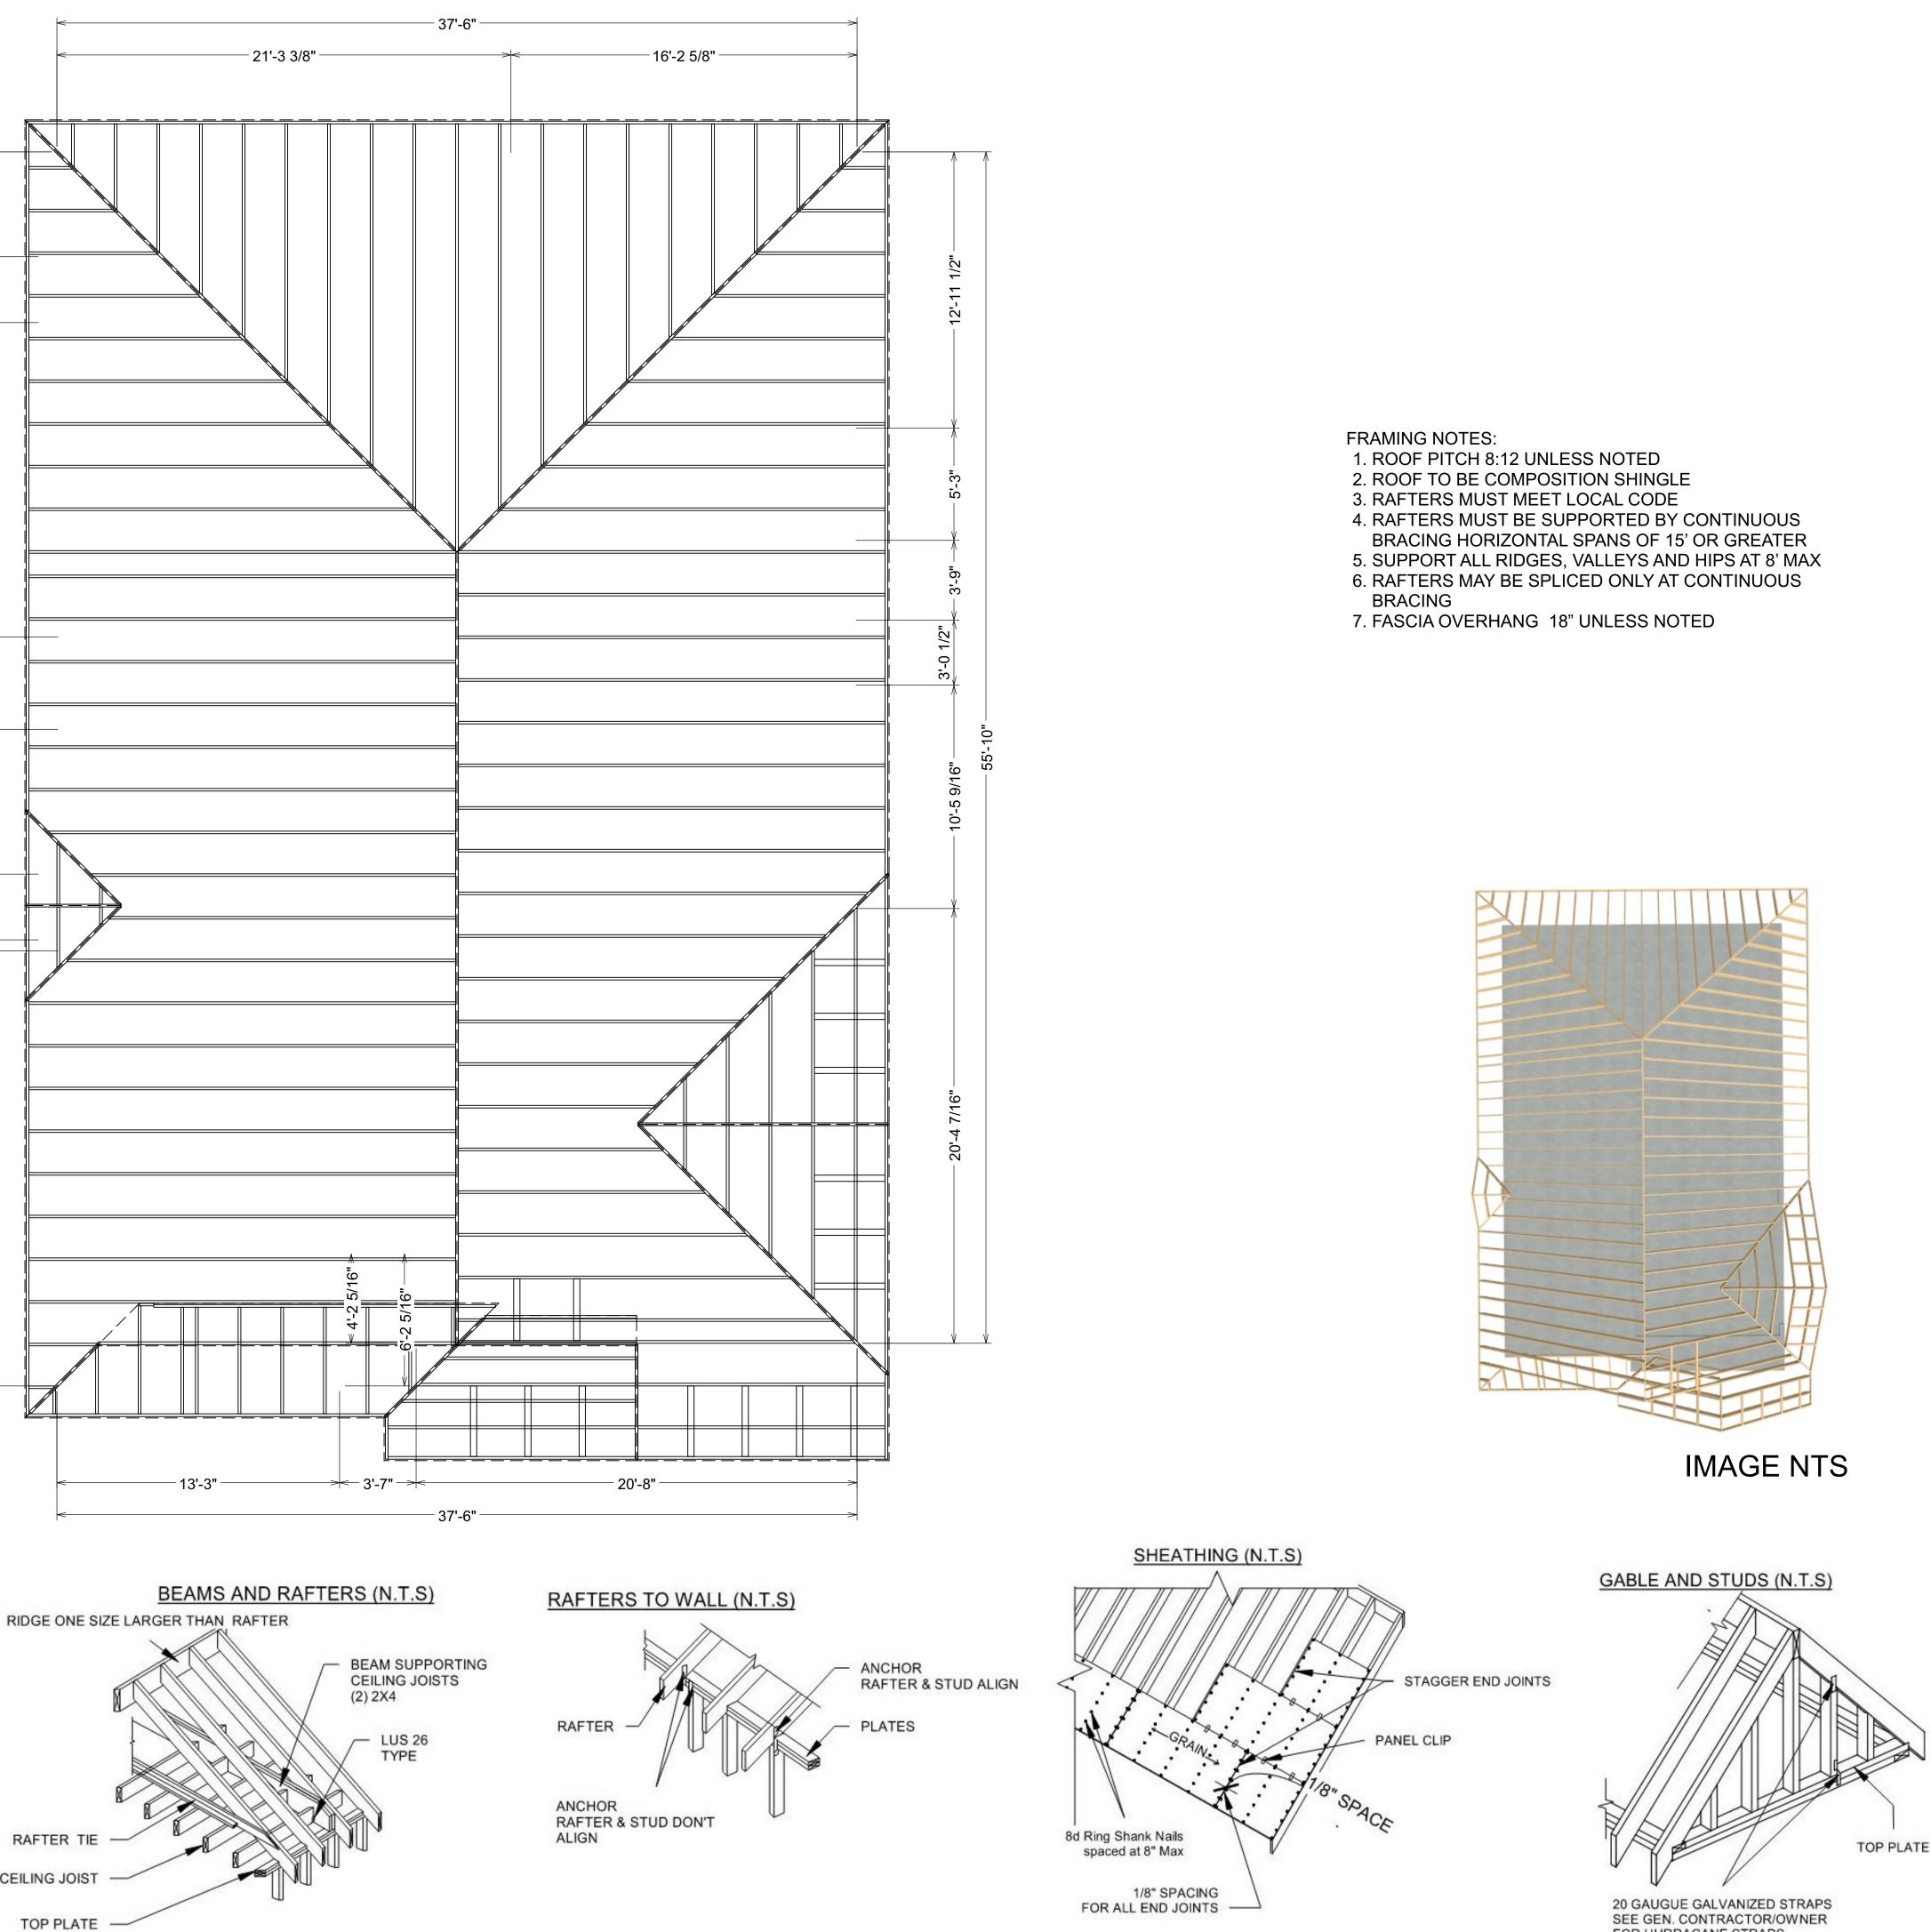
SHEET TITLE:


ROOF PLAN







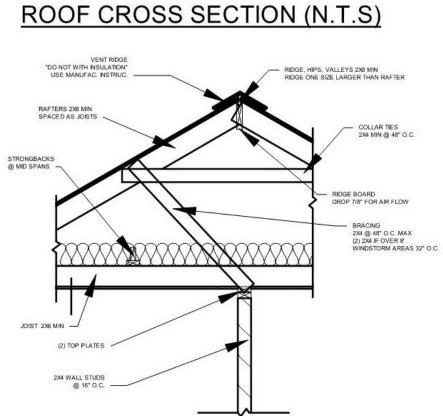

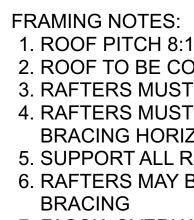



FOR HURRACANE STRAPS



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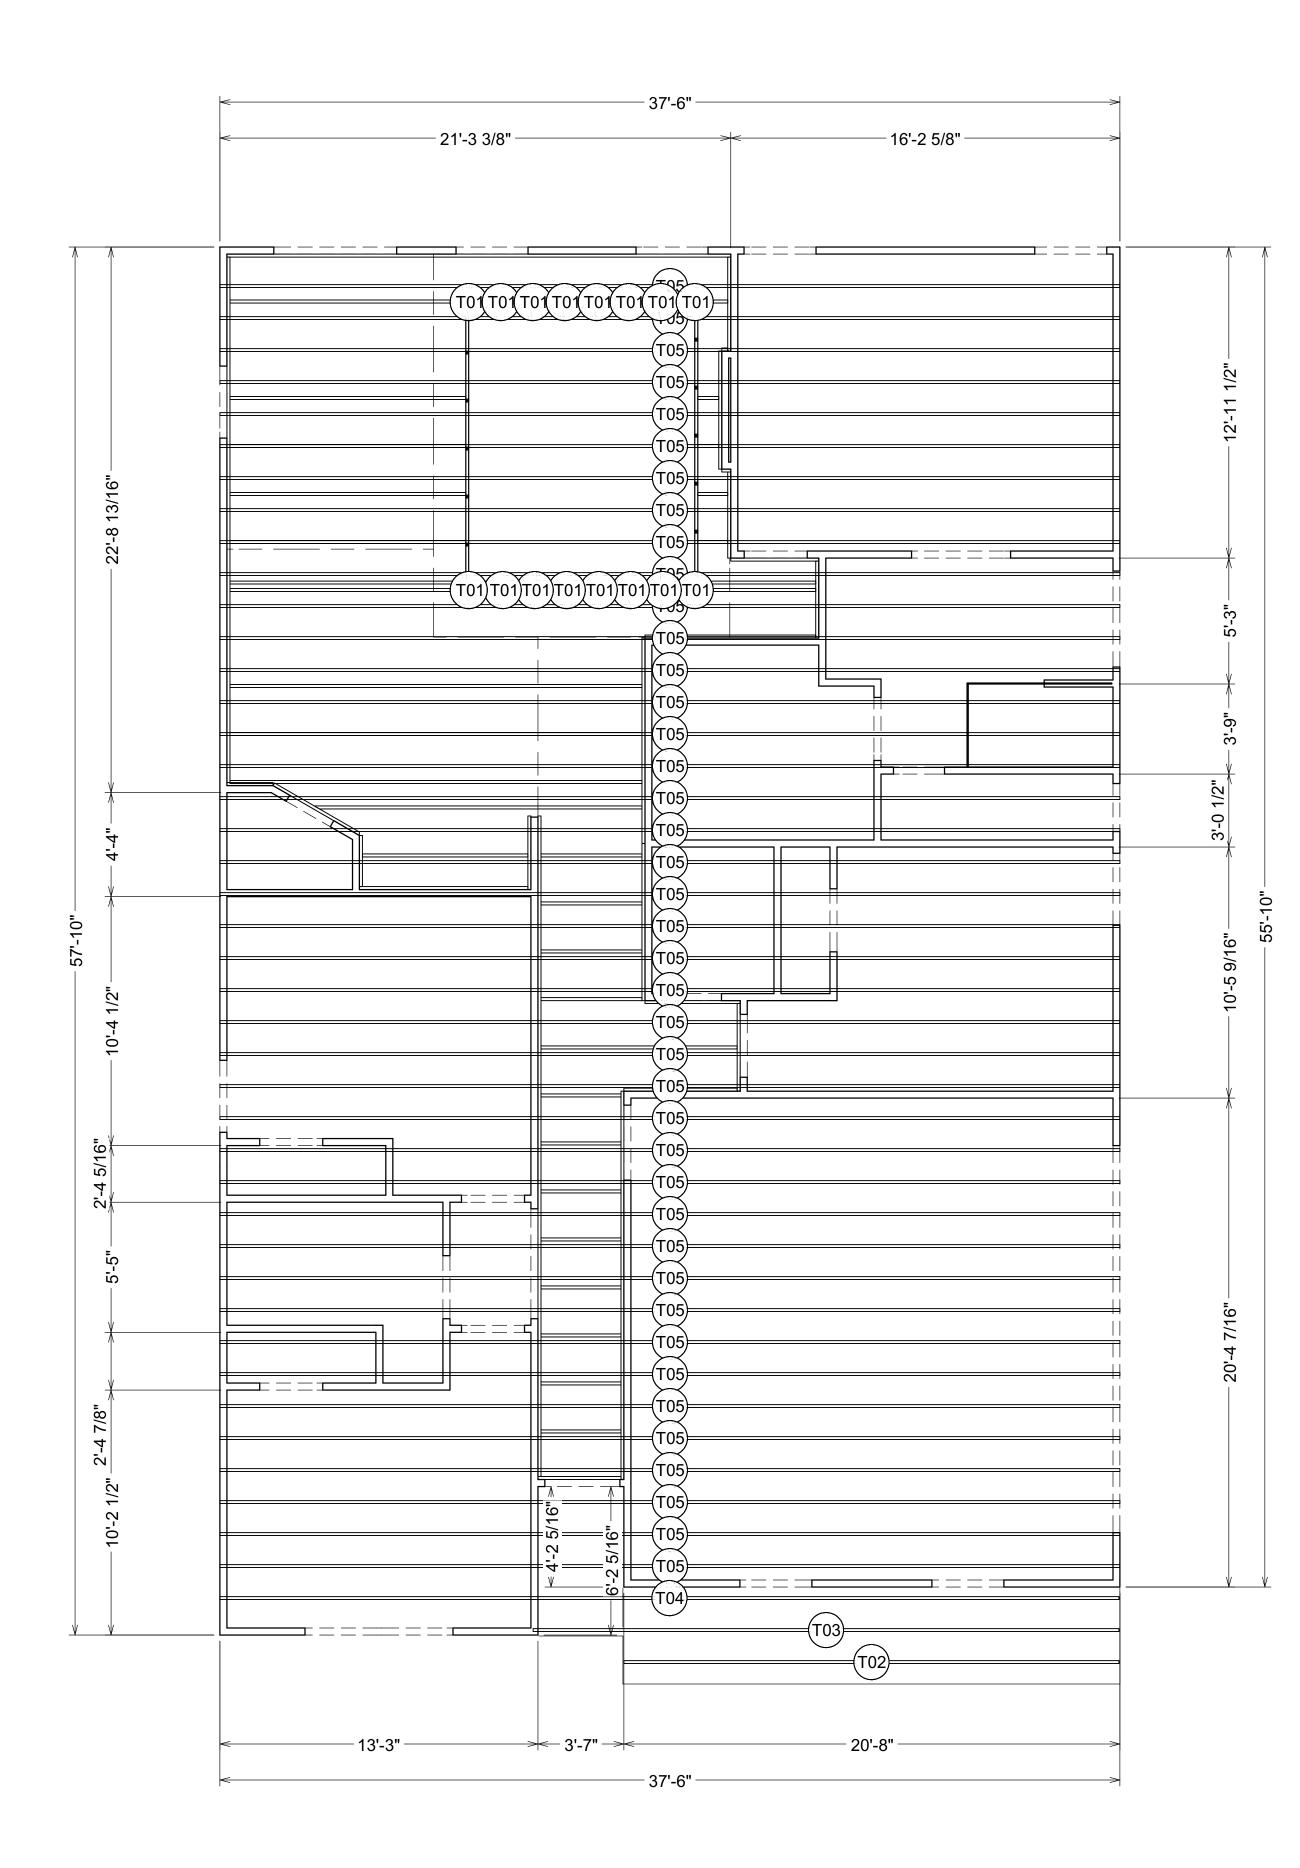
SCALE:

1/4" = 1'

SHEET TITLE:

ROOF FRAMING PLAN





NOTES:

- 1. CONTRACTOR TO BE RESPONSIBLE TO SEE THAT ALL STRUCTURES COMPLIES TO ALL CODES.
- 2. LAMINATED BEAMS TO BE SIZED BY MANUFACTURES ENGINEER.
- FOR STRUCTURAL PURPOSES.
- FOR STRUCTURAL PURPOSES.
- COMMENCING CONSTRUCTION.

FRAMING SCHEDULE						
NUMBER	NAME	QTY	NOMINAL	LENGTH	MATERIAL	TYPE
T01	CEILING JOIST	16	2X6	14 1/2"	FIR FRAMING 1	LUMBER
T02	CEILING JOIST	1	2X6	247 1/2"	FIR FRAMING 1	LUMBER
T03	CEILING JOIST	1	2X6	292 7/8"	FIR FRAMING 1	LUMBER
T04	CEILING JOIST	1	2X6	449 1/2"	FIR FRAMING 1	LUMBER
T05	CEILING JOIST	41	2X6	450"	FIR FRAMING 1	LUMBER

3. ALL RAFTERS TO BE 2" X 6" @ 24" O.C. UNLESS INCREASED 4. CEILING JOIST TO BE 2" X 6" @ 16" O.C. UNLESS INCREASED 5. CONTRACTOR TO VERIFY ALL DIMENSIONS PRIOR TO



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SCALE:

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SHEET TITLE:

A-9


CEILING FRAMING PLAN

<u>(N.T.S)</u>

LP SMARTSIDE SIDDING

30# FELT BTW SIDING AND SHEATHING

ZIP SYSTEM

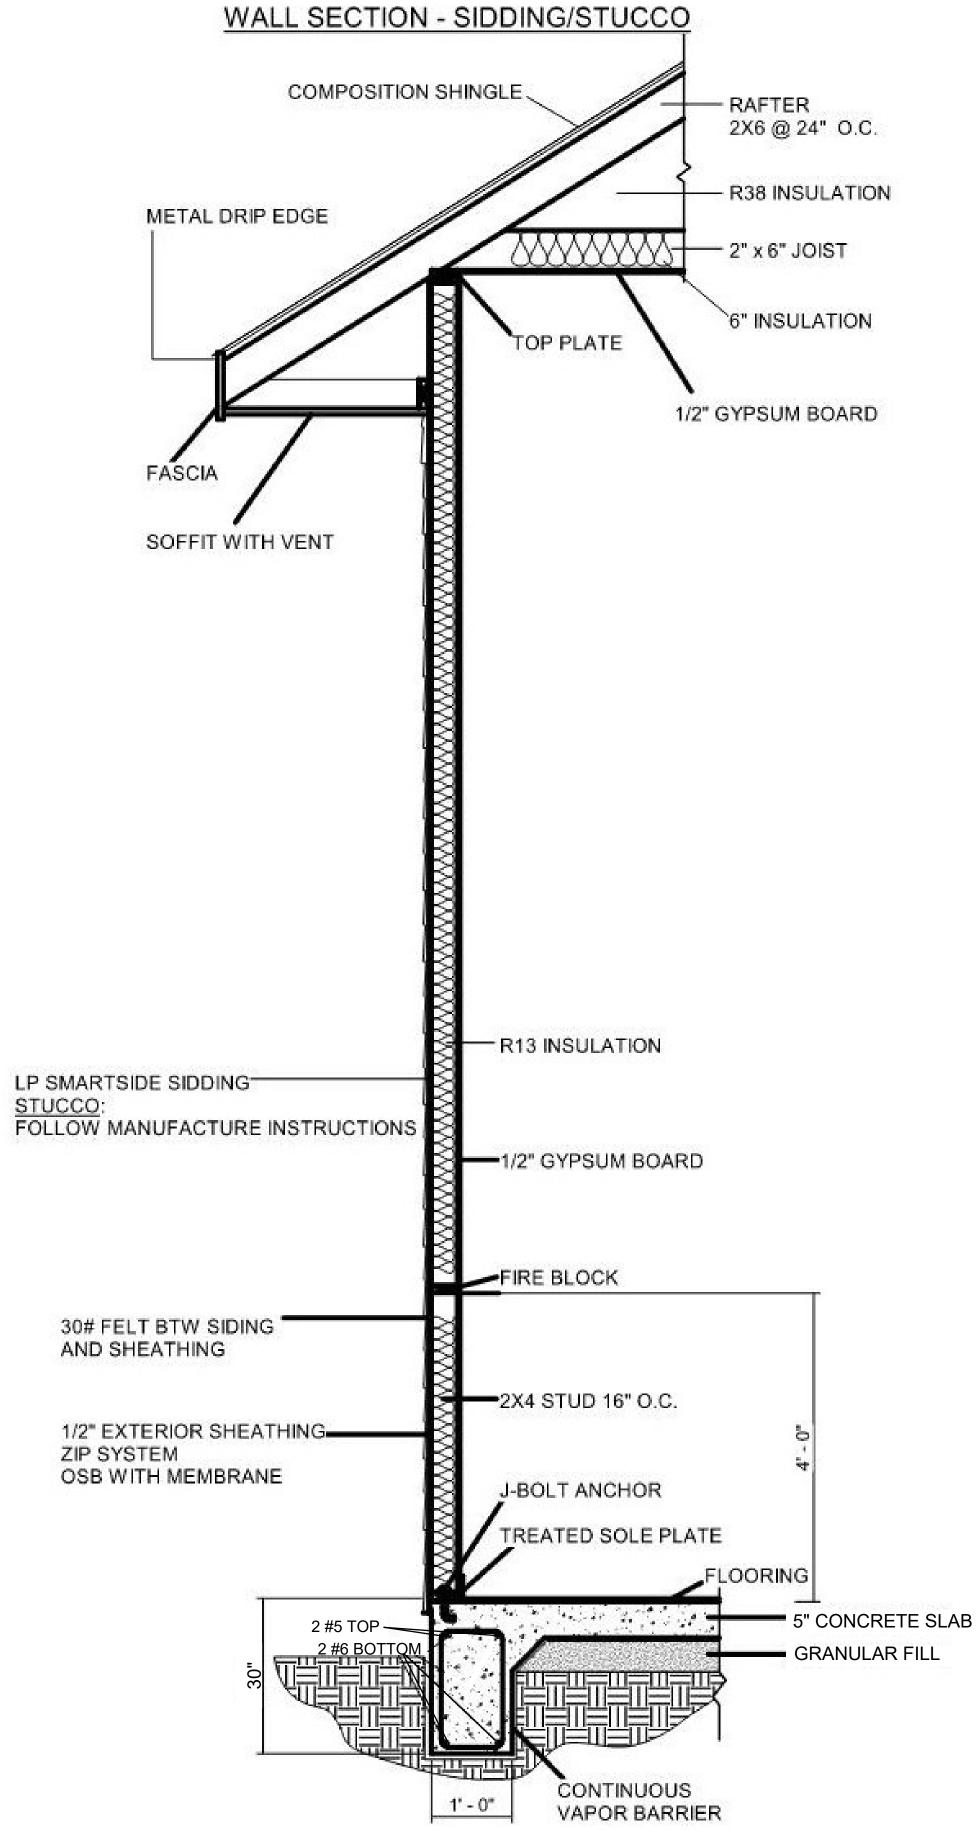



DESIGNER DISCLAIMER: We have exercised great effort and care in the creation of this home design and the completion of these construction drawings. However the designer, have not been contracted to provide personal consultation, site supervision or field inspection services and have no control over the construction materials, methods or sequencing used by the builder. For these reasons, as well as the gross variations in local building codes, the designer assume no responsibility for any damages, including structural failures resulting from errors or omission in these construction drawings. We strongly recommend that you, the homeowner, have these drawings thoroughly reviewed by a licensed architect, professional engineer, certified residential designer or general contractor licensed to practice in your area, in addition to your local building officials, prior to beginning construction.

SEAL:

ADDRESS:

111 KEEFER DR WYLIE, TX 75098

DATE:

9/15/2023

DRAWN BY:

ATOR

DESCRIPTION:

CRAFTSMAN STYLE SINGLE FAMILY RESIDENCE ONE STORY | 4 BEDROOM, 2 BATH


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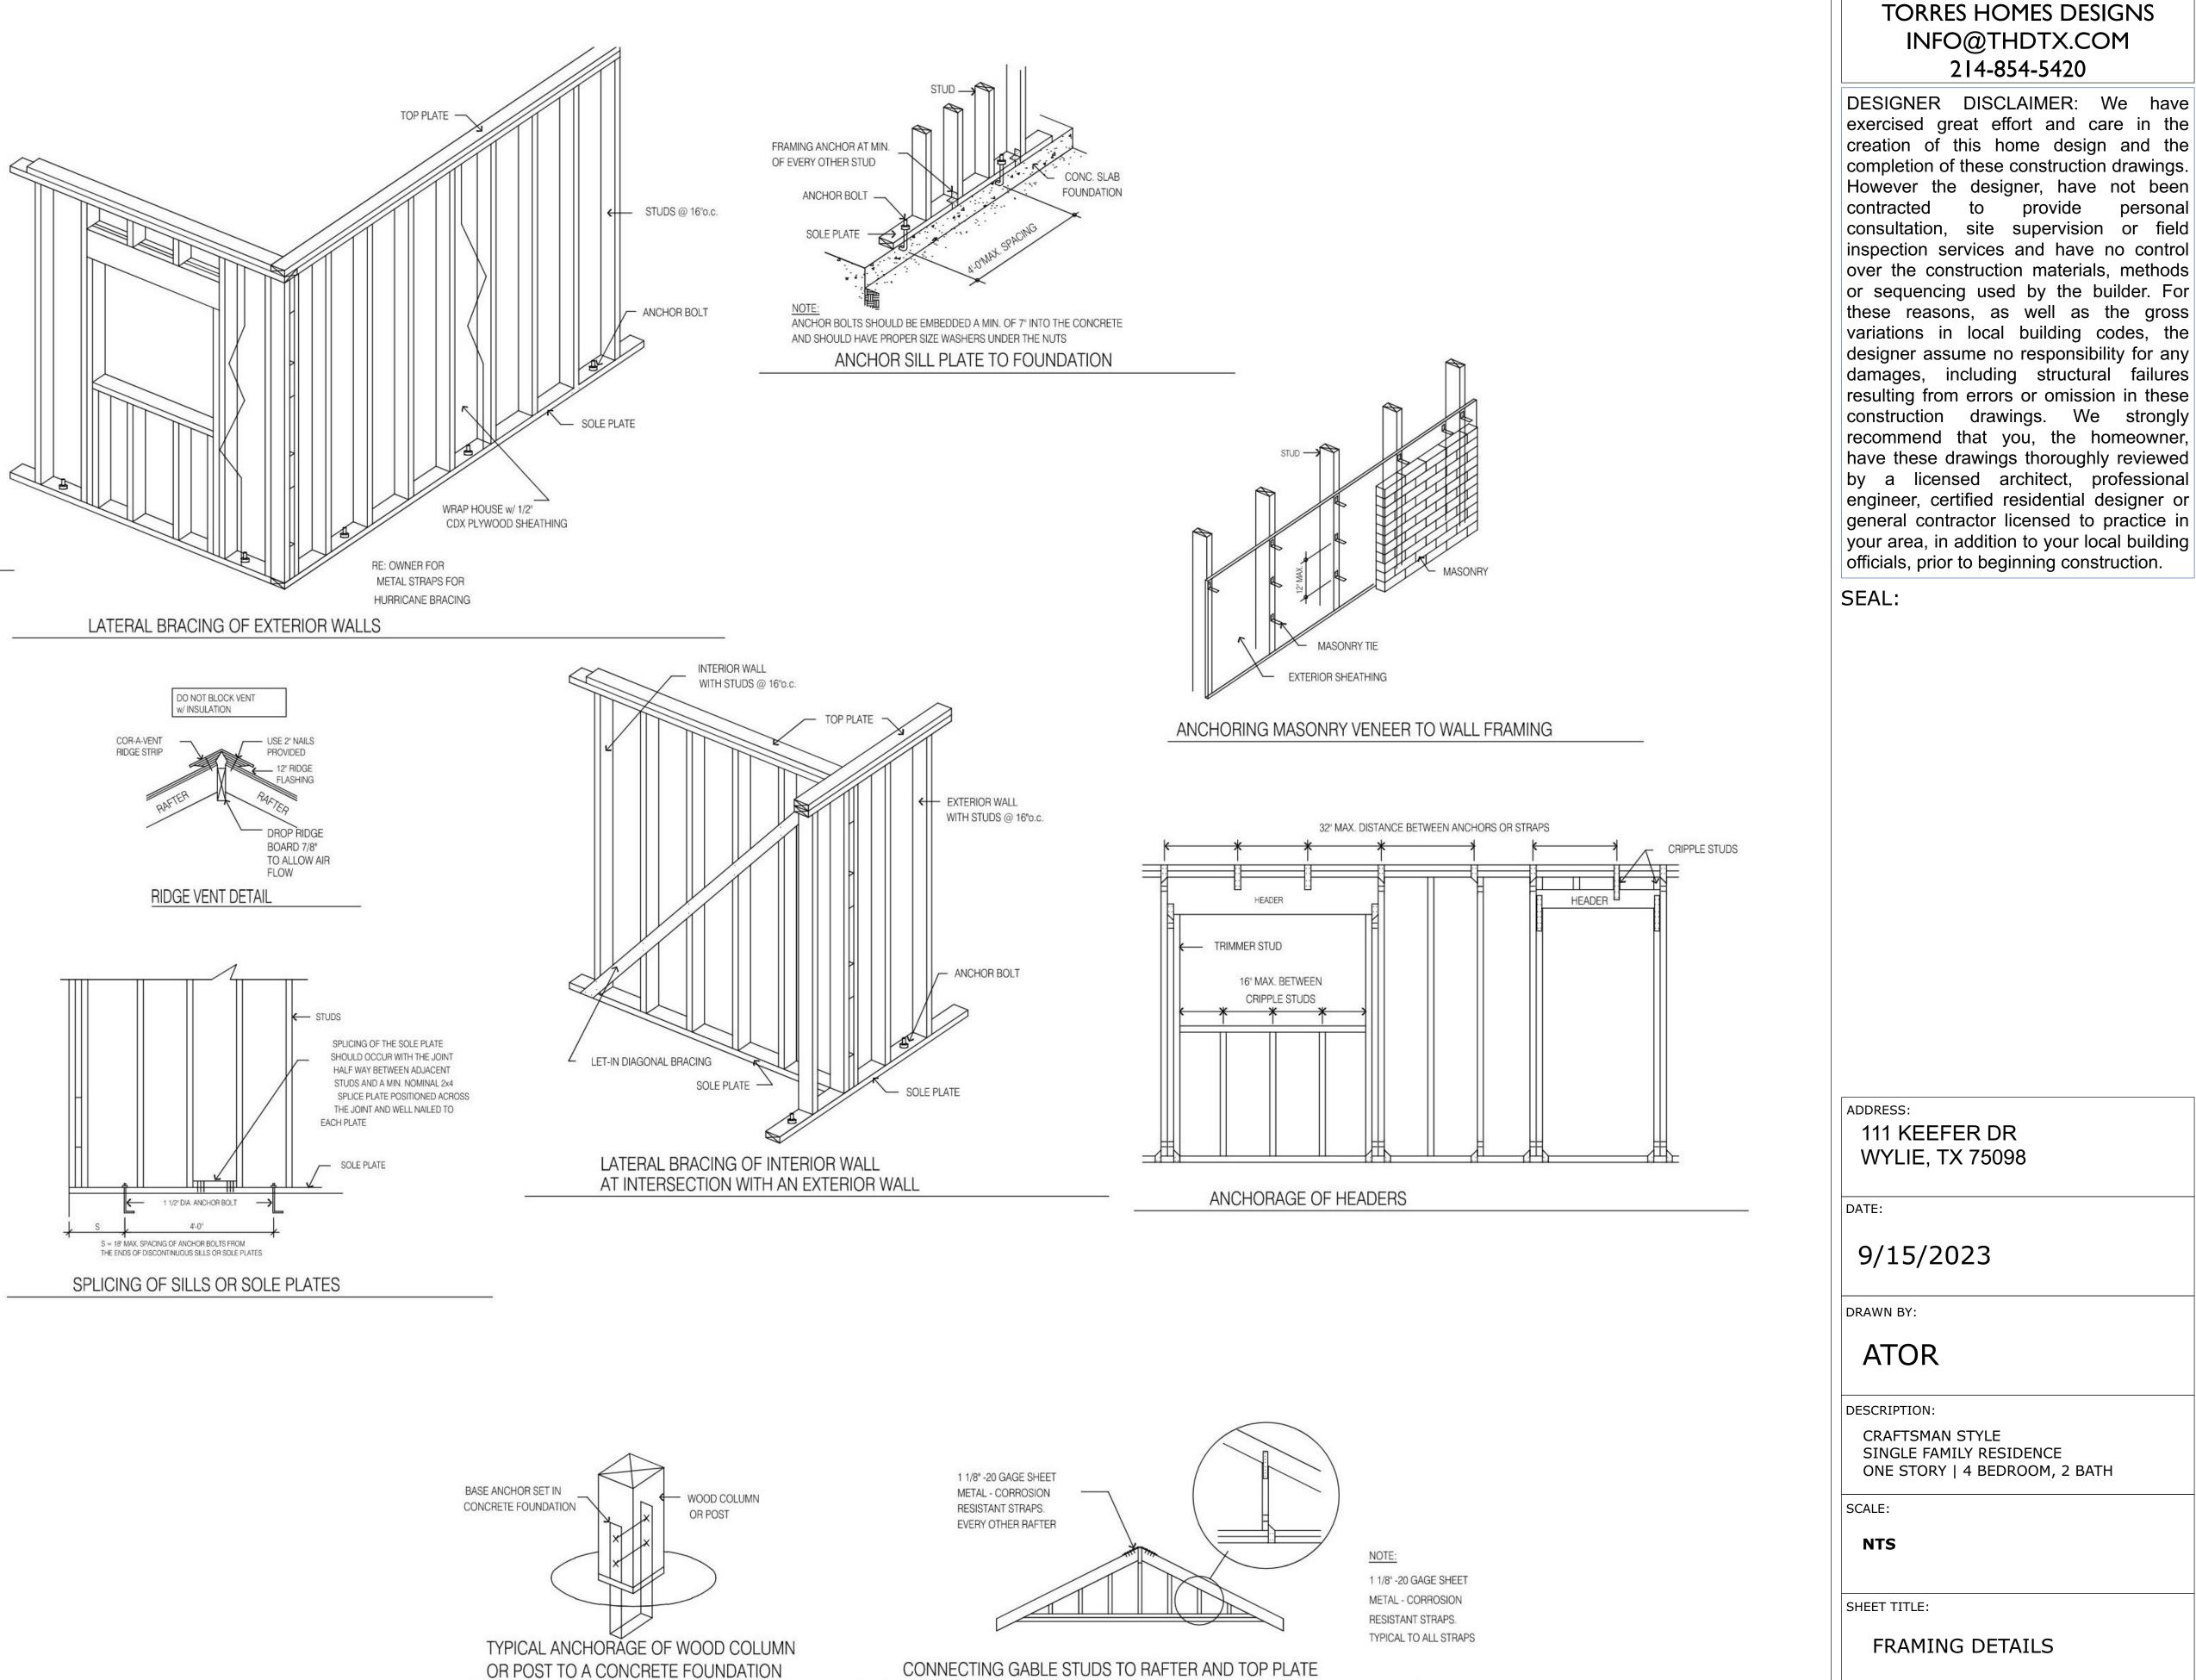
NTS


SHEET TITLE:

WALL SECTION DETAILS






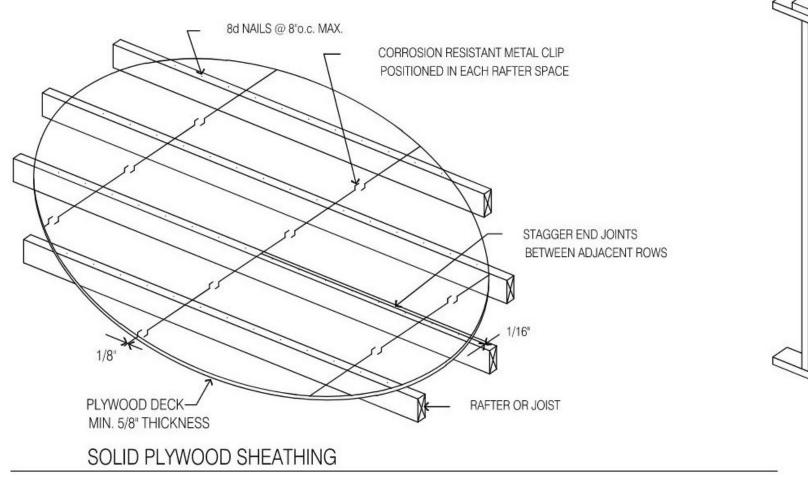

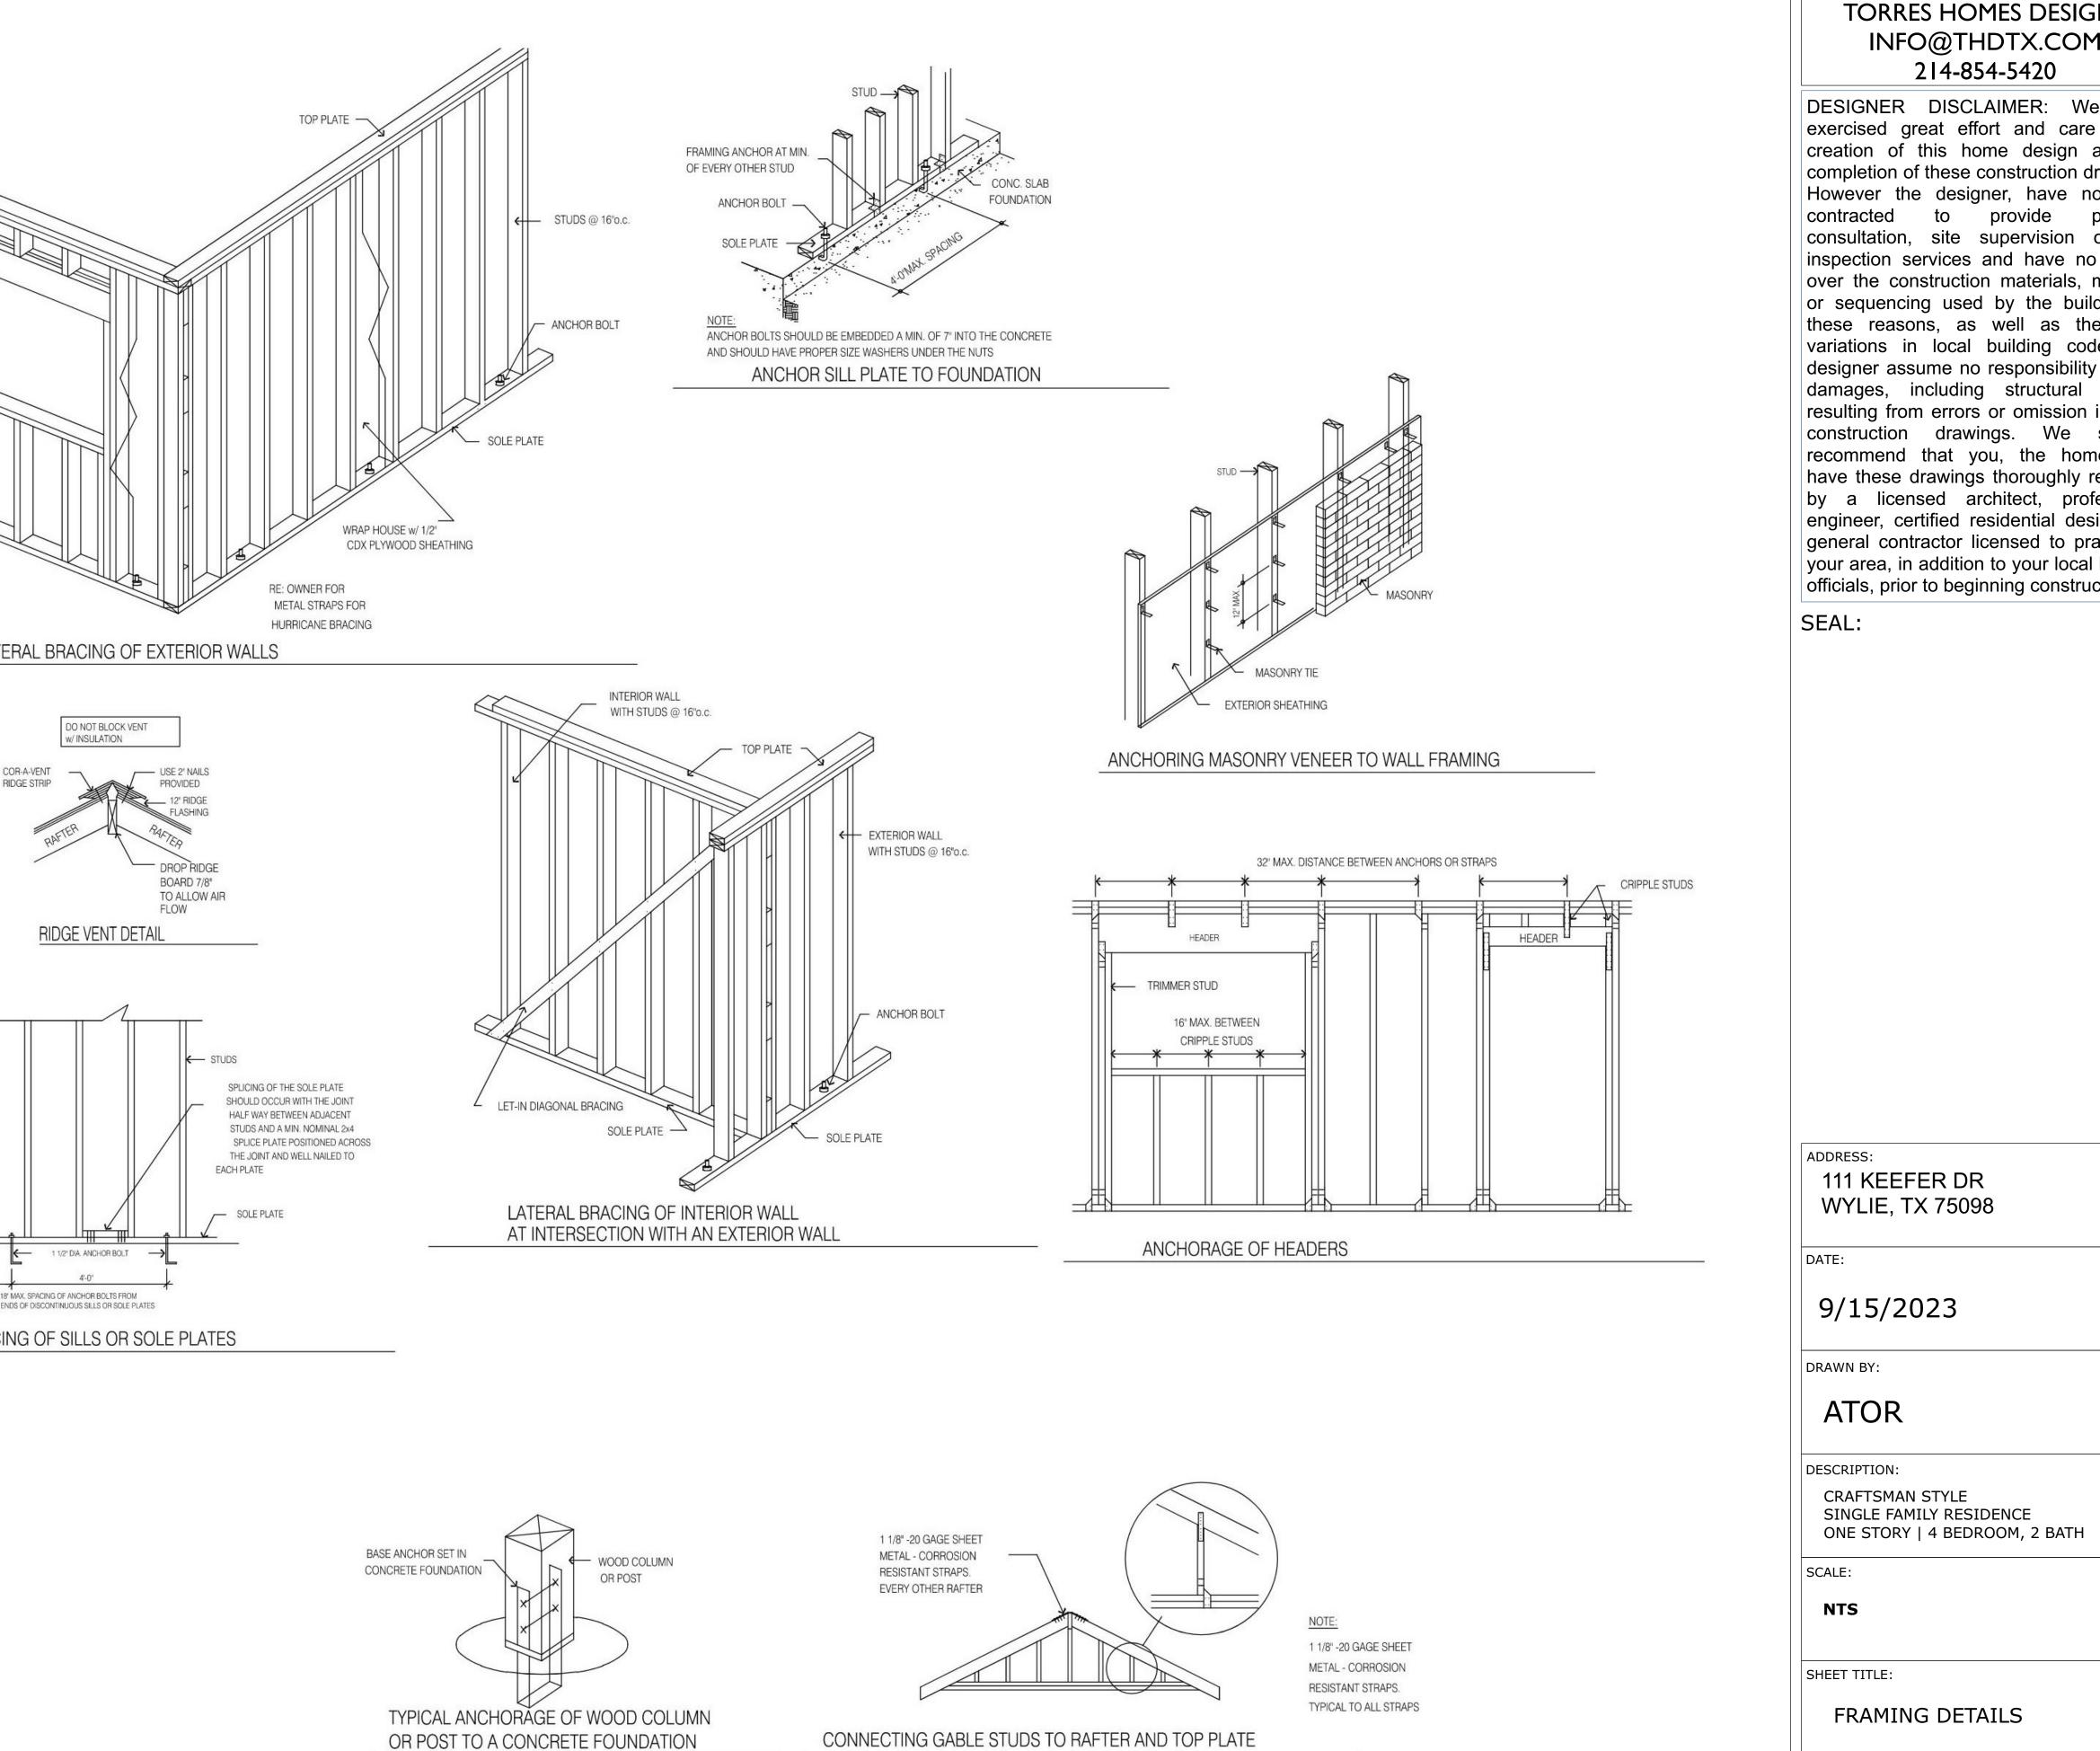

NOTE

- 1. ALL CEILINGS TO BE 9' UNLESS NOTED.
- 2. BUILDER TO APPROVE & VERIFY ALL PLANS **BEFORE CONSTRUCTION.**
- 3. VERIFY ALL PLANS W/ LOCAL BUILDING CODES.
- 4. W.H. & HVAC TO BE IN ATTIC UNLESS OTHERWISE NOTED.
- 5. PROVIDE SHUT-OFF VALVE FOR ALL GAS APPLIANCES REFERENCE IRC SECTION G2419.
- 6. ALL GLASS LOCATED WITHIN 18" OF FLOOR, 12" OF A DOOR OR LOCATED WITHIN 60" OF FLOOR AT BATHTUBS, WHIRLPOOLS, SHOWERS, SAUNAS, STEAM ROOM OR HOT TUBS SHALL BE TEMPERED. TO COMELY W/ IRC SECTION R308.4.8.

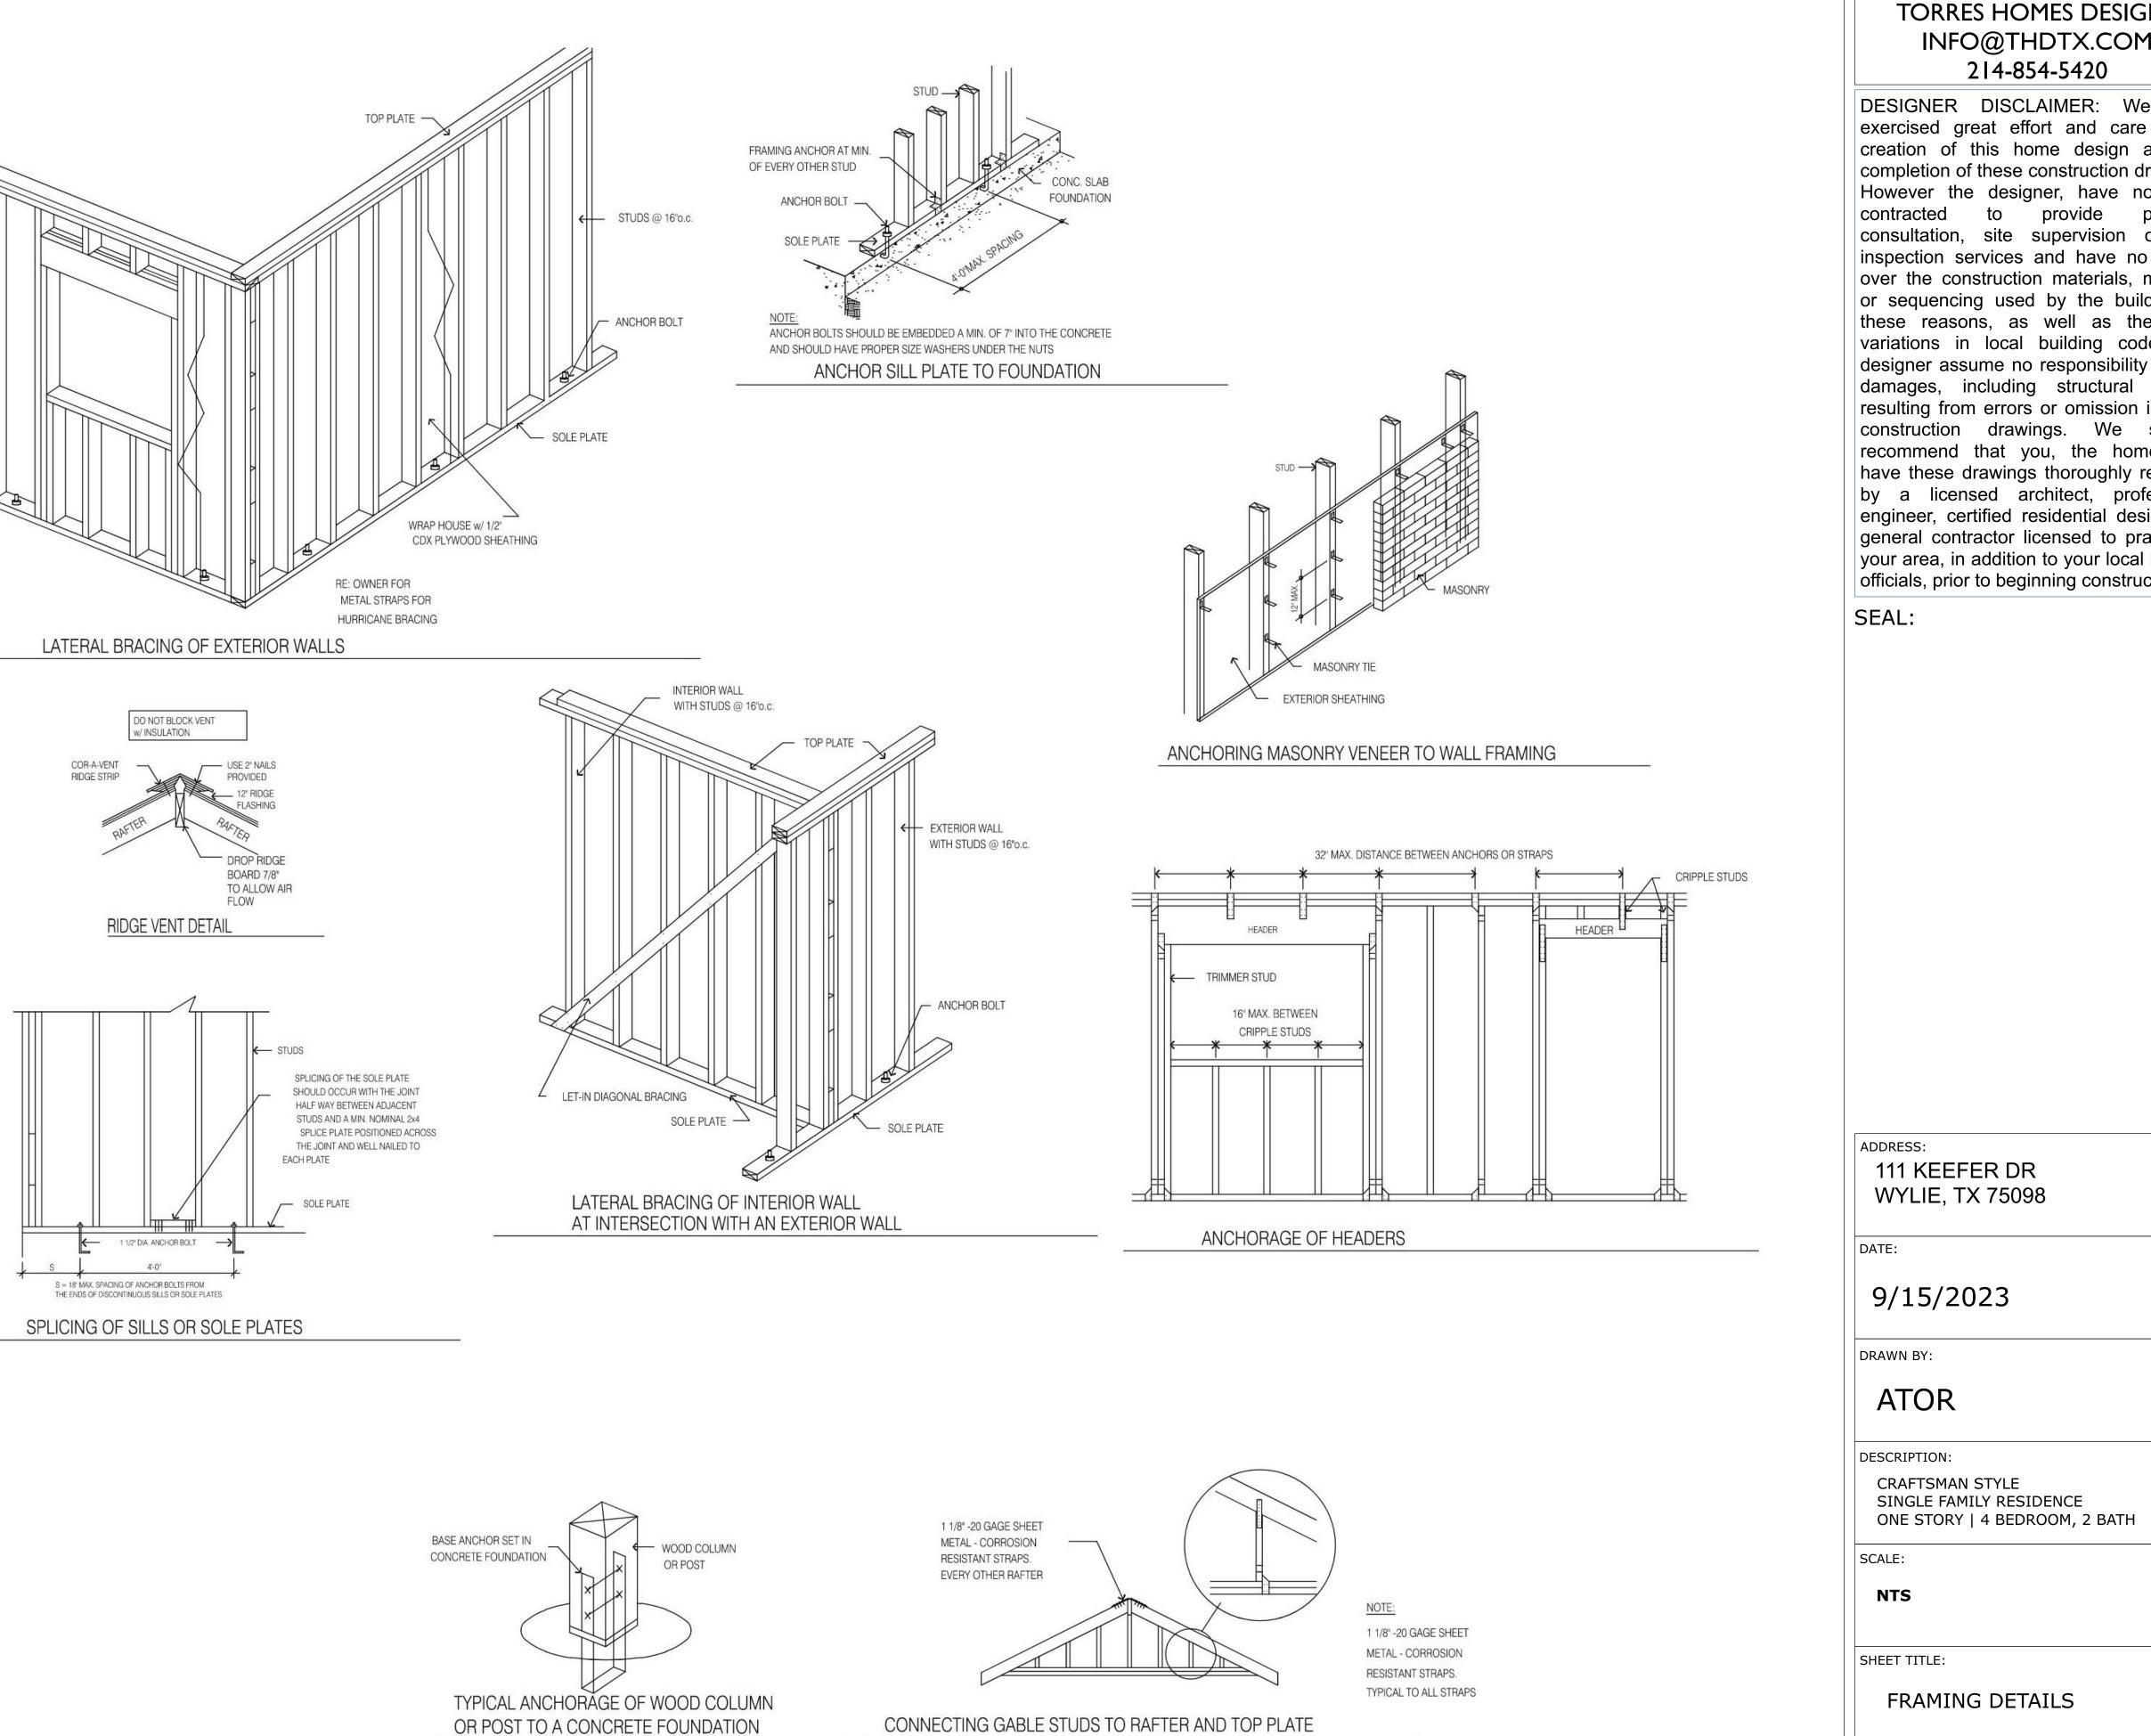

A-11

THD