CBCP RIM 457.09 INV 454.3 MARTHA ROAD /50'_WIDE R=462.83' L=20.34 RIM 459.38 INV 440.7 CBCP RIM 458.39 RIM 458.79 INV 453.8 DROP INV 454.9 INV 441.8 RIM 457.18 RIM 457.91 INV 454.2 INV 441.1 INV 453.9 N/F KATZ 41.14 - 1 - 69 N/F ROZENBERG 41.14 - 1 - 63 N 17°40'20" Ê 201.78' N 17°40'20" E \ 159.58' DEER FENCE 41.14 - 1 - 62 80,253 Sq. Feet 1.8424 Acres N/F CHEROFSKY 41.14 - 1 - 1 N/F LITOWSKI 41.14 - 1 - 70 12 " CLUSTER 8 " CLUSTER STONE WALL STONE WALL S 17°40'20" W 209.89' S 16°10'50" W GRAPHIC SCALE N/F RETTER 41.14 - 1 - 61 (IN FEET) 1 inch = 20 ft.

SURVEY NOTES:

- 1. IT IS A VIOLATION OF THE STATE EDUCATION LAW SECT 7209 (2) FOR ANY PERSON, UNLESS ACTING UNDER THE DIRECTION OF A LICENSED LAND SURVEYOR, TO ALTER AN ITEM IN ANY WAY ONLY COPIES OF THIS SURVEY MARKED WITH THE LAND SURVEYOR'S SIGNATURE AND AN ORIGINAL EMBOSSED SEAL ARE A VALID ORIGINAL PRODUCT OF THE LAND SURVEYOR. THIS SURVEY IS PREPARED ONLY FOR THE PARTIES AND PURPOSE INDICATED HEREON ANY CLAIM FOR LIABILTY SHALL NOT EXCEED THE AMOUNT OF THE AGREEMENT ANY EXTENSION OF USE BEYOND THE PURPOSE AGREED TO BETWEEN THE CLIENT AND THE SURVEYOR EXCEEDS THE SCOPE OF THE ENGAGEMENT HOLDS THE SURVEYOR HARMLESS FOR UNAUTHORIZED USE BY OTHER PARTIES PERSONS OR GOVERNMENTAL APPROVALS AND RENDERS THIS SURVEY MAP NULL & VOID. THIS SURVEY MAP IS SUBJECT TO AN ACCURATE ABSTRACT OF TITLE.
- 2. THIS SURVEY MAP IS BASED ON AN ACTUAL FIELD SURVEY CONDUCTED FOR A SPECIFIC PURPOSE AND IS BASED ON SPECIFIC CONTRACTUAL REQUIREMENTS FOR THIS TRANSACTION. USE OF THIS MAP FOR SURVEY INSPECTION UPDATES IS STRICTLY PROHIBITED. THIS MAP MAY NOT BE COPIED IN WHOLE OR IN PART. THIS MAP MAY NOT BE USED FOR OTHER PURPOSES OR TRANSACTIONS. THIS MAP MAY NOT BE SOLD, RENTED, LEASED, PHOTOCOPIED, ENLARGED, REDUCED, TRACED OR TRANSFERED IN ANY OTHER WAY WITHOUT THE PRIOR WRITTEN CONSENT OF A CIVIL TEC ENGINEERING & SURVEYING PC REPRESENTATIVE WHO'S SIGNATURE & SEAL APPEAR HEREON.
- 3. PROPERTY CORNER MARKERS WERE NOT INSTALLED AS PART OF THIS SURVEY.
- 4. VERTICAL DATUM IS NAVD88.

REFERENCES

BEING SECTION 41.14, BLOCK 1, LOT 62 OF THE VILLAGE OF WESLEY HILLS AND TOWN OF RAMAPO TAX MAPPING.
 LOT DESCRIBED BY DEED IN INSTRUMENT NO. 2020 AT PAGE 1027 AT THE ROCKLAND COUNTY CLERKS OFFICE.
 BEING LOT 1 ON A MAP ENTITLED "ARNOLD C. GILBERT", FILED IN THE ROCKLAND COUNTY CLERKS OFFICE ON OCTOBER 12, 1973 IN BOOK 86 ON PAGE 42 AS MAP NUMBER

4. TOTAL AREA = 80,253 SQUARE FEET OR 1.8424 ACRES.

S.B.L. 41.14 - 1 - 62

SURVEY MAP

FOR

12A MARTHA ROAD

VILLAGE OF WESLEY HILLS - ROCKLAND COUNTY - NEW YORK

CIVIL TEC Engineering & Surveying PC

139 Lafayette Avenue, 2nd FI. 111 Main Street
Suffern, NY 10901 Chester, NY 10918
P 845.547.2241 - F 845.547.2243 845.610.3621


Civil Engineering & Land Surveying Services that Build Communities
www.Civil-Tec.com

CHKD BY: SPD

JOB No. 3814
SCALE: 1"=20'

STEPHEN P. DOLSON, P.L.S.
N.Y. Lic. No. 50554

DESCRIPTION

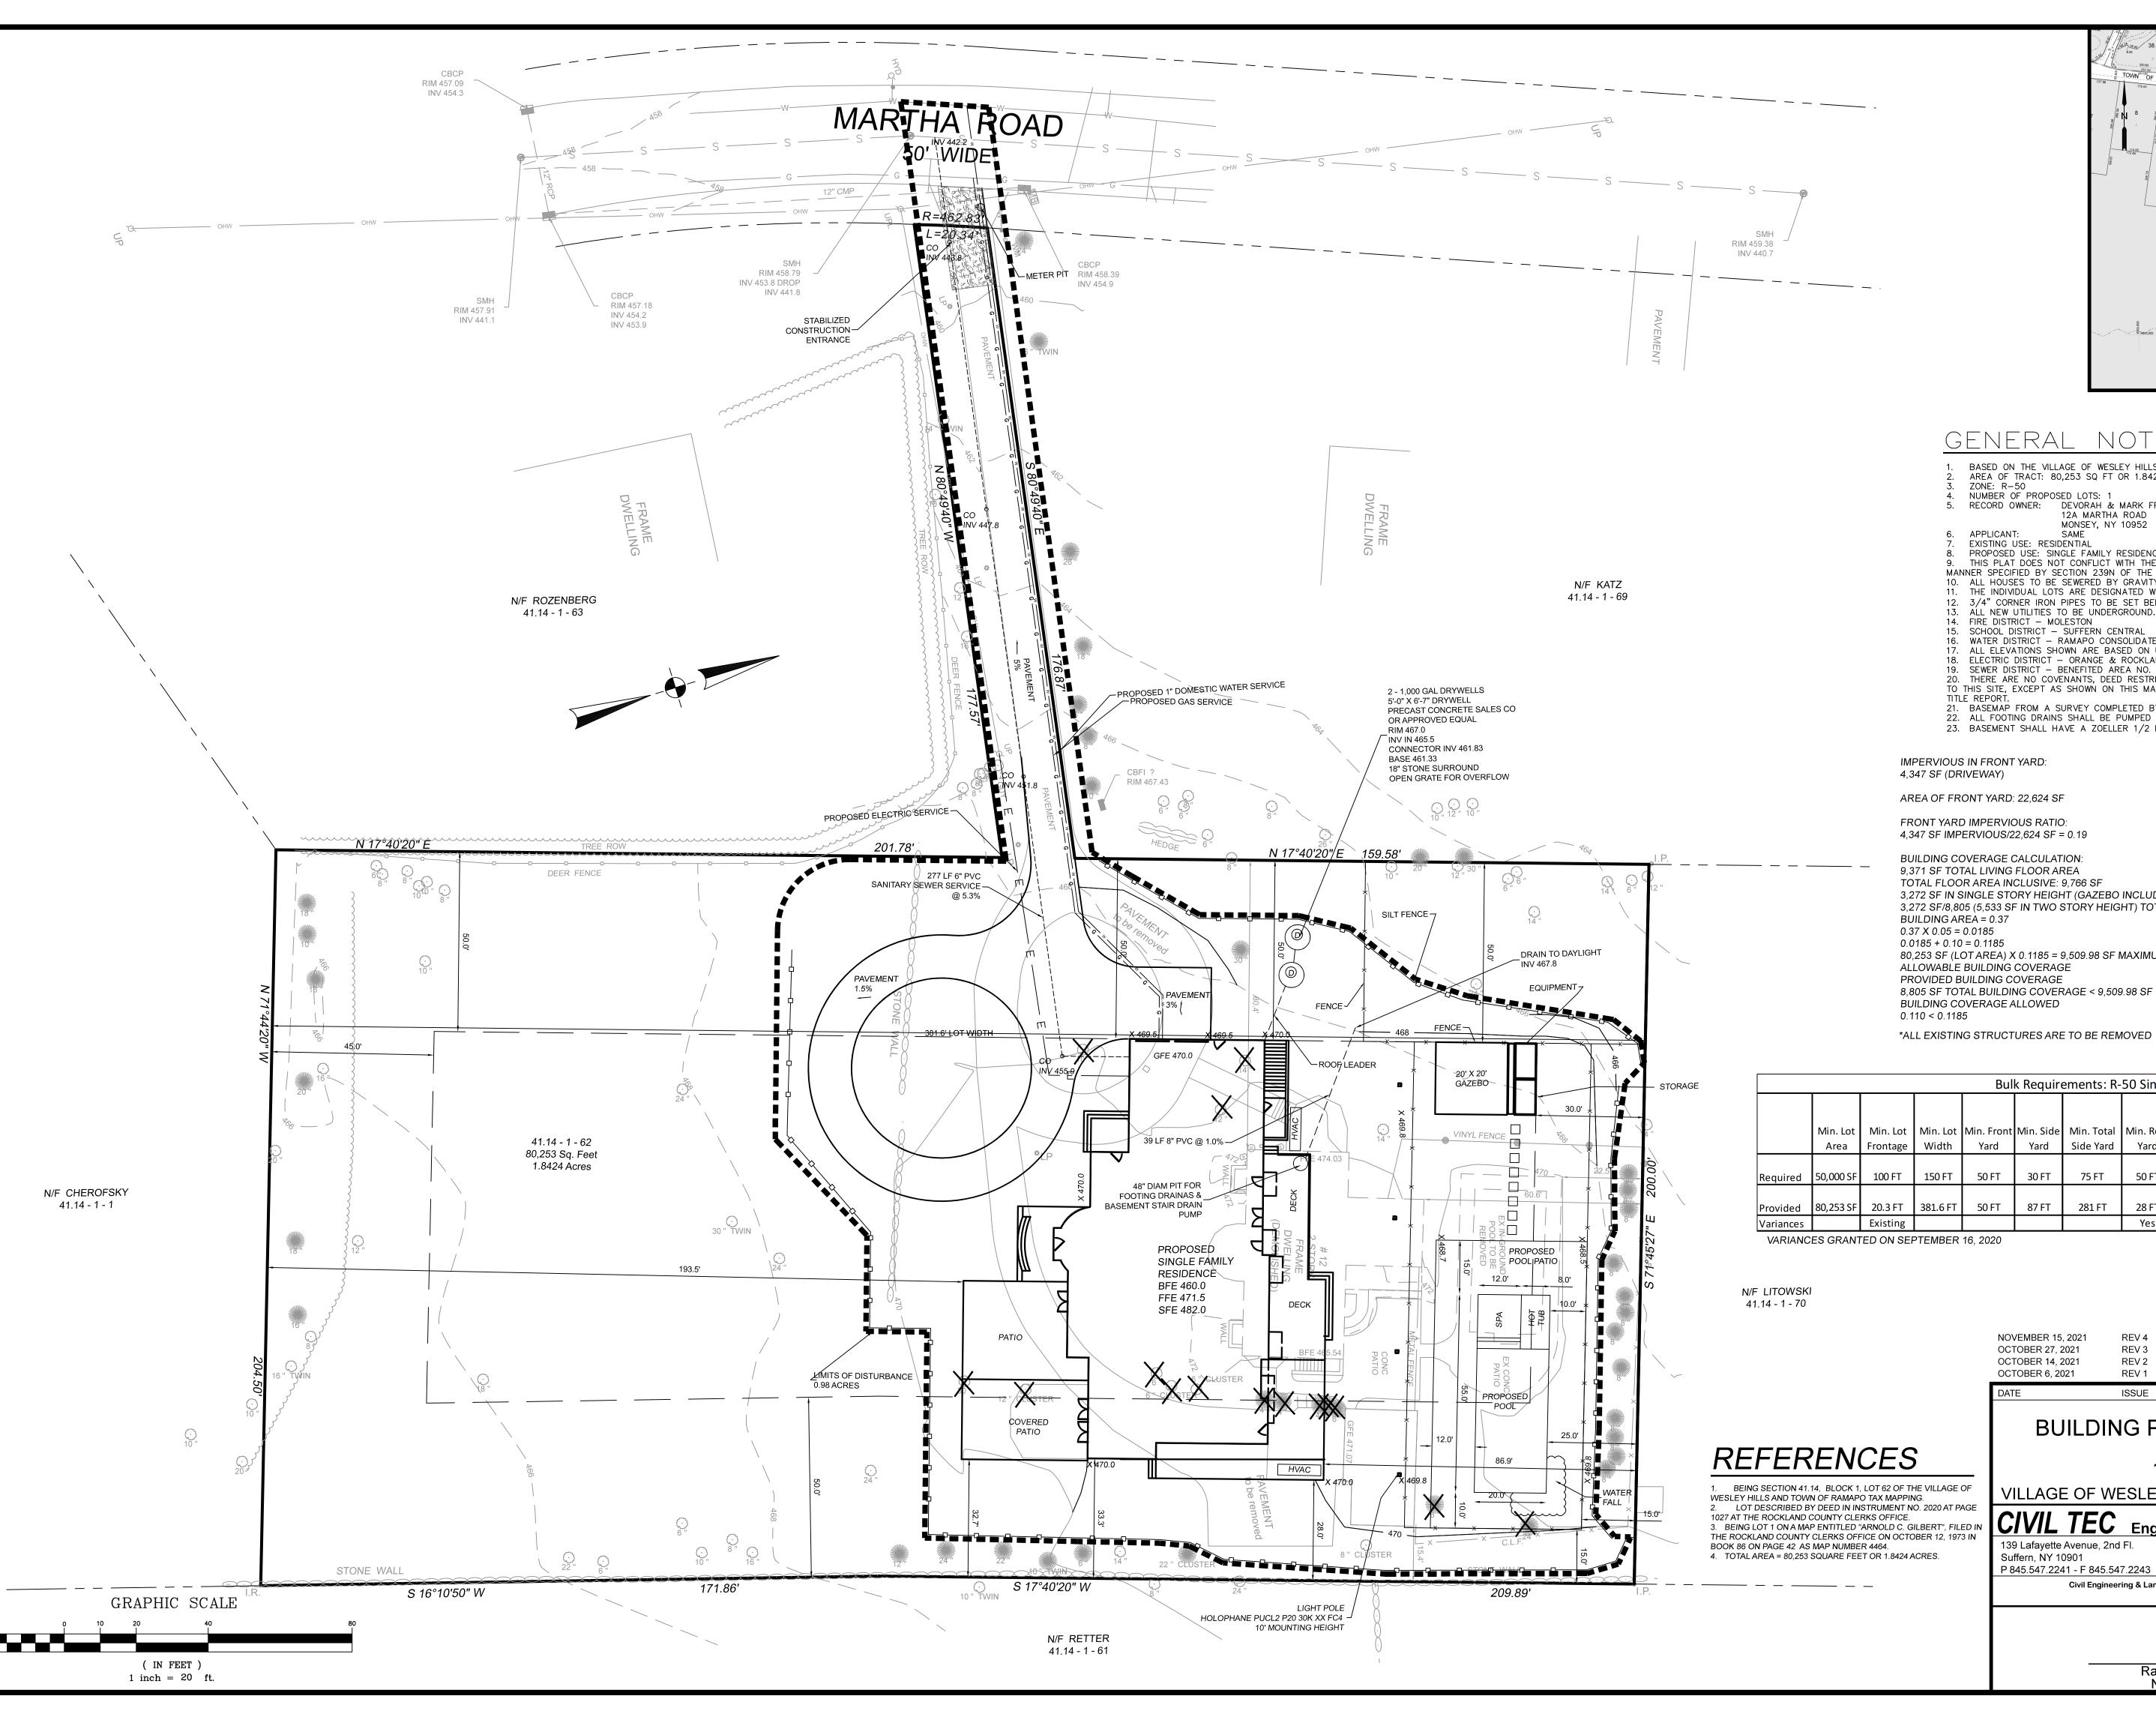



VICINITY MAP

1'' = 300'

BASED ON THE VILLAGE OF WESLEY HILLS TAX MAP, THIS LOT IS 62 ON MAP 41.14 BLOCK 1. AREA OF TRACT: 80,253 SQ FT OR 1.8424 AC

NUMBER OF PROPOSED LOTS: 1
RECORD OWNER: DEVORAH & MARK FRIEDMAN
12A MARTHA ROAD

MONSEY, NY 10952 EXISTING USE: RESIDENTIAL

8. PROPOSED USE: SINGLE FAMILY RESIDENCE
9. THIS PLAT DOES NOT CONFLICT WITH THE OFFICIAL COUNTY MAP AND HAS BEEN APPROVED IN THE MANNER SPECIFIED BY SECTION 239N OF THE GENERAL MUNICIPAL LAW.

10. ALL HOUSES TO BE SEWERED BY GRAVITY WITH A MIN. SLOPE OF 2%. 11. THE INDIVIDUAL LOTS ARE DESIGNATED WITH THE TAX LOT NUMBER SHOWN THUS

12. 3/4" CORNER IRON PIPES TO BE SET BEFORE C.O. IS ISSUED.

13. ALL NEW UTILITIES TO BE UNDERGROUND.

14. FIRE DISTRICT - MOLESTON
15. SCHOOL DISTRICT - SUFFERN CENTRAL

16. WATER DISTRICT - RAMAPO CONSOLIDATED WATER DISTRICT. WATER SUPPLY BY SUEZ WATER

17. ALL ELEVATIONS SHOWN ARE BASED ON U.S.C. & G.S. DATUM. 18. ELECTRIC DISTRICT - ORANGE & ROCKLAND

19. SEWER DISTRICT — BENEFITED AREA NO. 5
20. THERE ARE NO COVENANTS, DEED RESTRICTIONS, EASEMENTS, OR OTHER RESERVATIONS OF LAND RELATIVE
TO THIS SITE, EXCEPT AS SHOWN ON THIS MAP, SUBJECT TO THE FINDINGS OF A COMPLETE AND UP TO DATE

21. BASEMAP FROM A SURVEY COMPLETED BY CIVIL TEC ENGINEERING & SURVEYING PC DATED JULY 6, 2020. 22. ALL FOOTING DRAINS SHALL BE PUMPED AND DAYLIGHTED.

23. BASEMENT SHALL HAVE A ZOELLER 1/2 HP SUBMERSIBLE SUMP PUMP OR APPROVED EQUAL.

IMPERVIOUS IN FRONT YARD:

4,347 SF IMPERVIOUS/22,624 SF = 0.19

BUILDING COVERAGE CALCULATION:

TOTAL FLOOR AREA INCLUSIVE: 9,766 SF 3,272 SF IN SINGLE STORY HEIGHT (GAZEBO INCLUDED) 3,272 SF/8,805 (5,533 SF IN TWO STORY HEIGHT) TOTAL

80,253 SF (LOTAREA) X 0.1185 = 9,509.98 SF MAXIMUM ALLOWABLE BUILDING COVERAGE

8,805 SF TOTAL BUILDING COVERAGE < 9,509.98 SF MAXIMUM BUILDING COVERAGE ALLOWED

LOT COVERAGE:

TERRACES, ETC.

DRIVEWAY 5,446 SF 5,275 SF DWELLING GAZEBO, POOL EQUIPMENT 560 SF POOL, SPA, HOT TUB 1,100 SF POOL PATIO 2,260 SF WALKWAYS, WINDOW WELLS, STAIRS,

2,558 SF

REVISIONS

TOTAL IMPERVIOUS COVERAGE:

17,199 SF/80,253 SF = 0.21

NO STEEP SLOPES

PARKING CALCULATION: SINGLE FAMILY HOME REQUIRES 2 SPACES

2 GARAGE SPACES PROVIDED

| Bulk Requirements: R-50 Single Family Residence | | | | | | | | | | | | |
|---|------------------|----------------------|-------------------|--------------------|-------------------|-------------------------|-------------------|-------------------------------------|--|------------------------------|----------------------------|------------------------------------|
| | Min. Lot Area | Min. Lot Frontage | Min. Lot Width | Min. Front Yard | Min. Side Yard | Min. Total Side Yard | Min. Rear Yard | Max. Impervious Surface Ratio | Max. Front Yard Impervious Surface Ratio | Max. Building Coverage | Max. Building Height | Max. Exposed Building Height |
| Required | 50,000 SF | 100 FT | 150 FT | 50 FT | 30 FT | 75 FT | 50 FT | 0.2 | 0.15 | 0.1185 | 2.5 stories/ 25 FT | 40 FT |
| Provided | 80,253 SF | 20.3 FT | 381.6 FT | 50 FT | 87 FT | 281 FT | 28 FT | 0.21 | 0.19 | 0.11 | 2 stories/ 23 FT | 40 FT |

NOVEMBER 15, 2021 OCTOBER 27, 2021 REV 3 OCTOBER 14, 2021 REV 2 REV 1 REV PER VILLAGE ENGINEER'S COMMENTS REV PER VILLAGE ENGINEER'S COMMENTS REV PER SOIL TESTING REV PER VILLAGE ENGINEER'S COMMENTS


DESCRIPTION


S.B.L. 41.14 - 1 - 62 **BUILDING PERMIT PLAN APPROVED 2021**

12A MARTHA ROAD

VILLAGE OF WESLEY HILLS - ROCKLAND COUNTY - NEW YORK

CIVIL TEC Engineering & Surveying PC DATE: 139 Lafayette Avenue, 2nd Fl. 111 Main Street Suffern, NY 10901 Chester, NY 10918 DRAWN BY: RB/LT P 845.547.2241 - F 845.547.2243 845.610.3621 Civil Engineering & Land Surveying Services that Build Communities CHKD BY: www.Civil-Tec.com JOB No. SCALE: Rachel B. Barese, P.E. N.Y. Lic. No. 90143 DWG No.

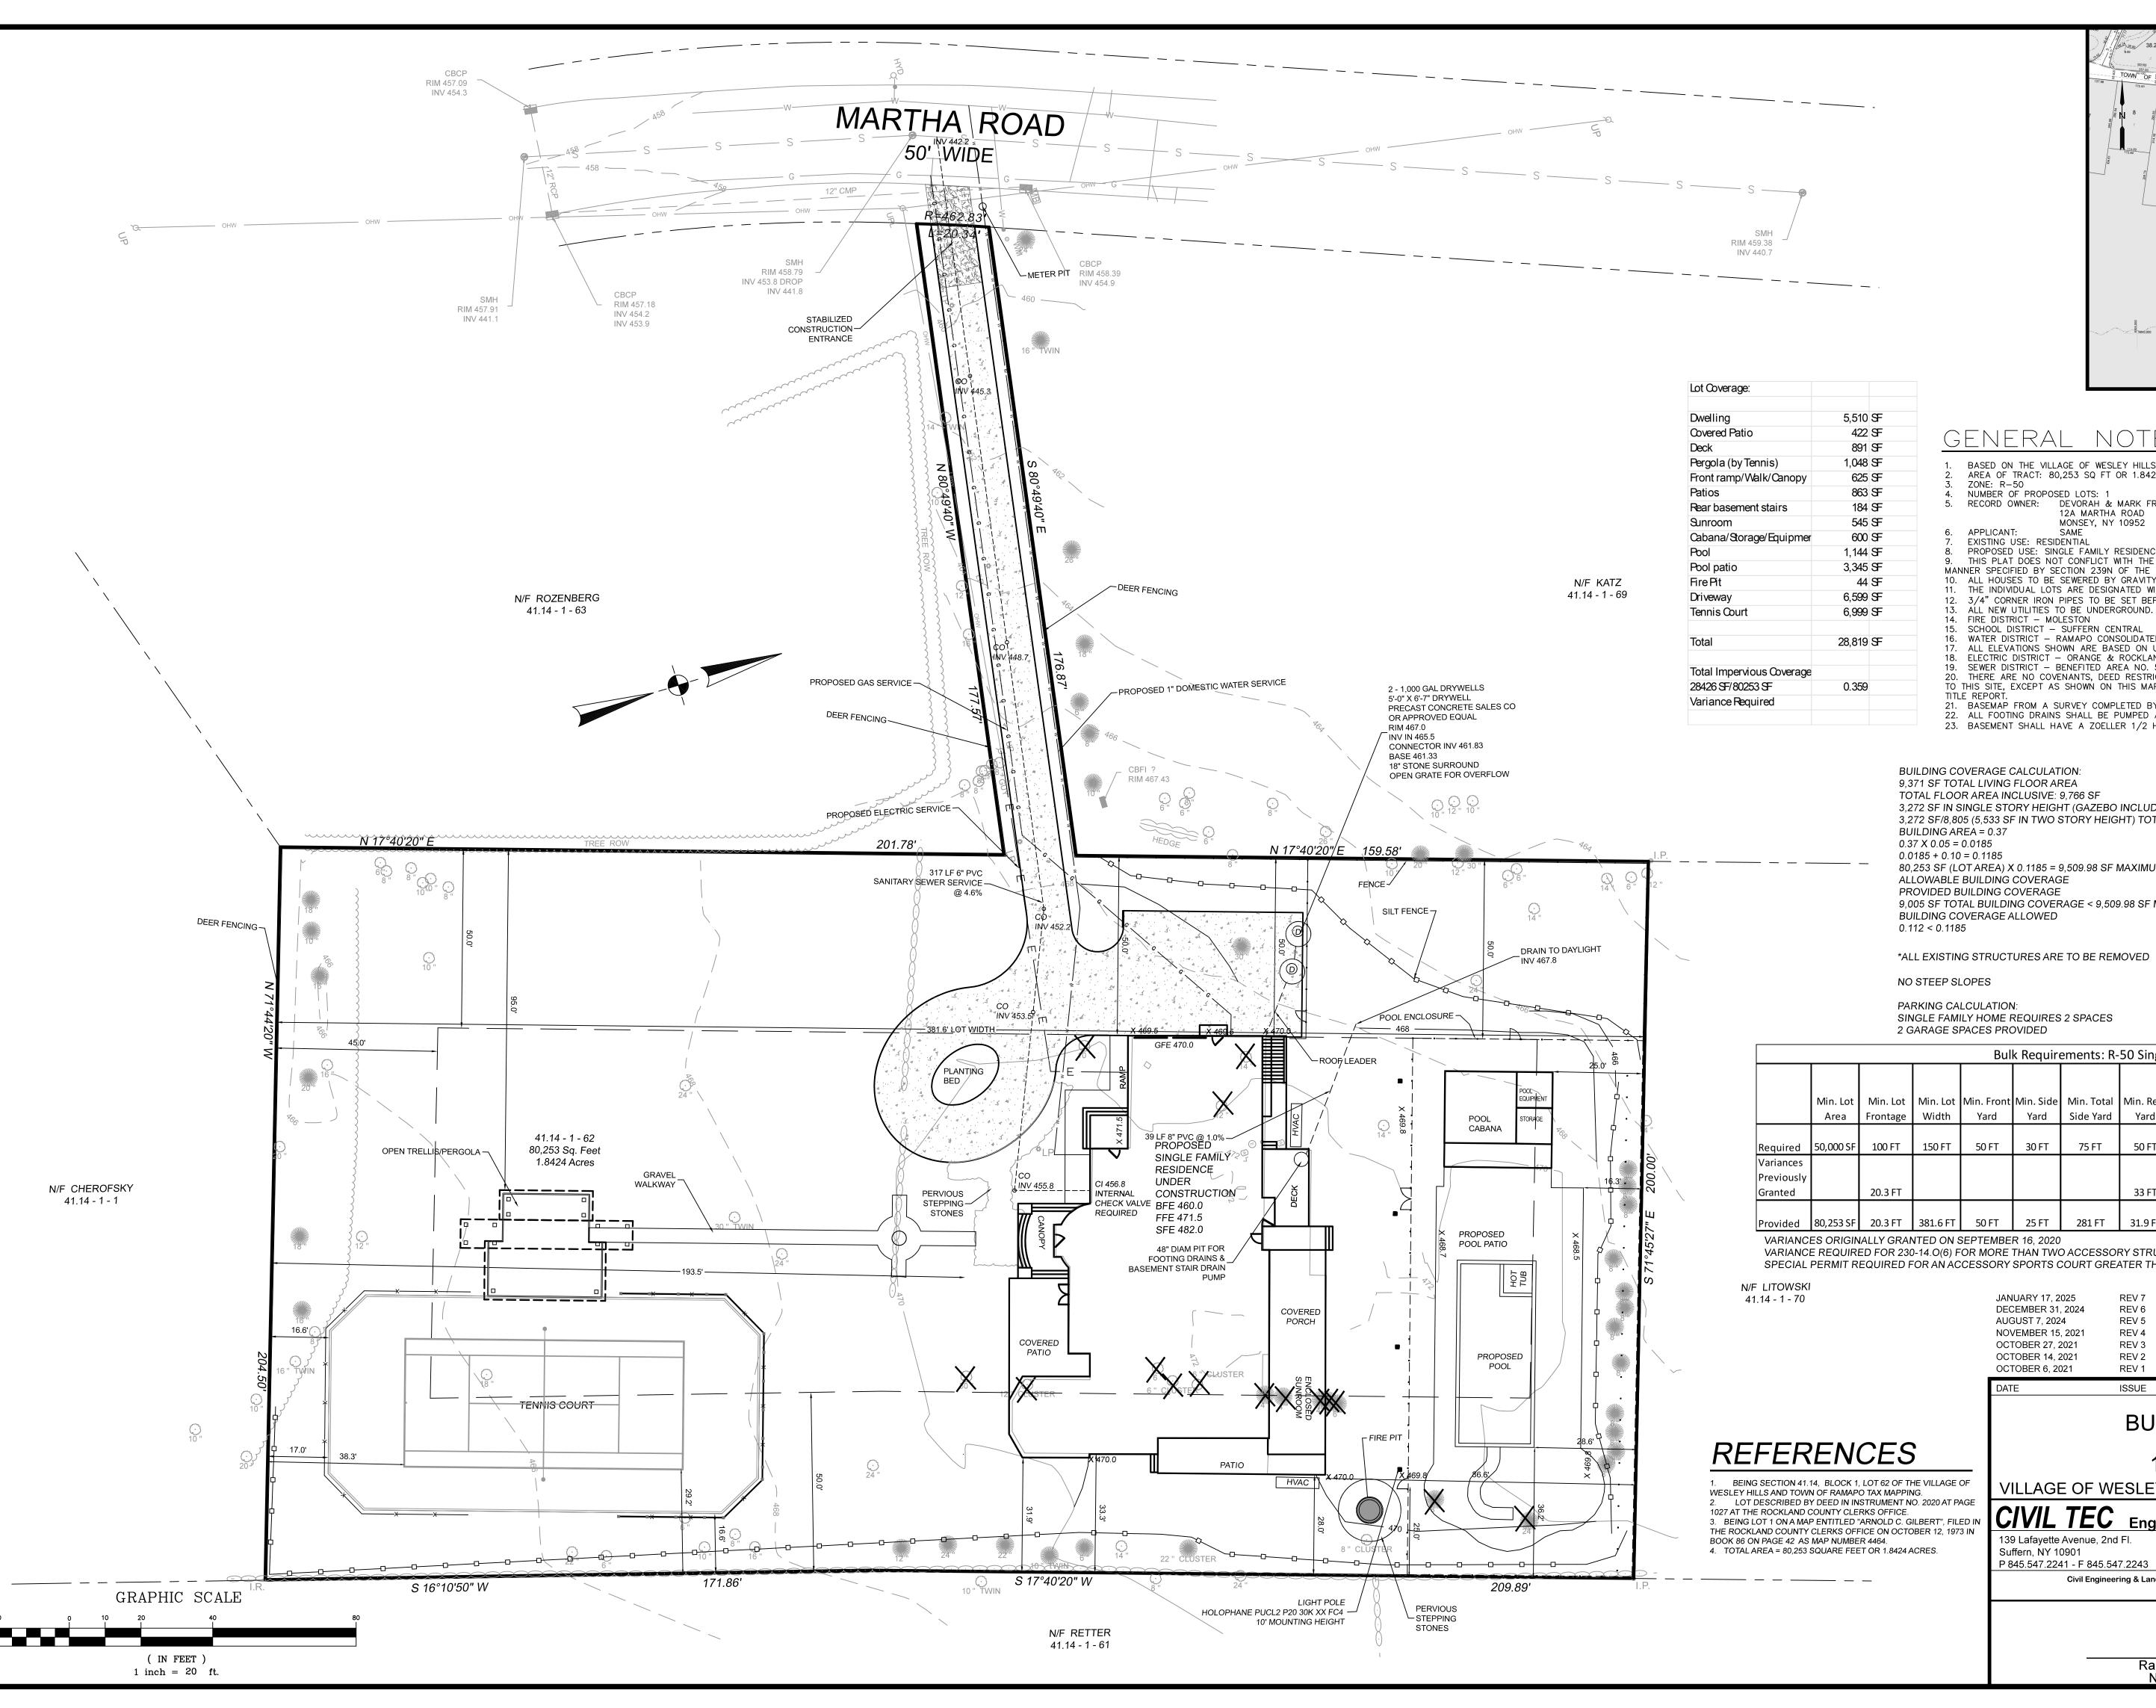

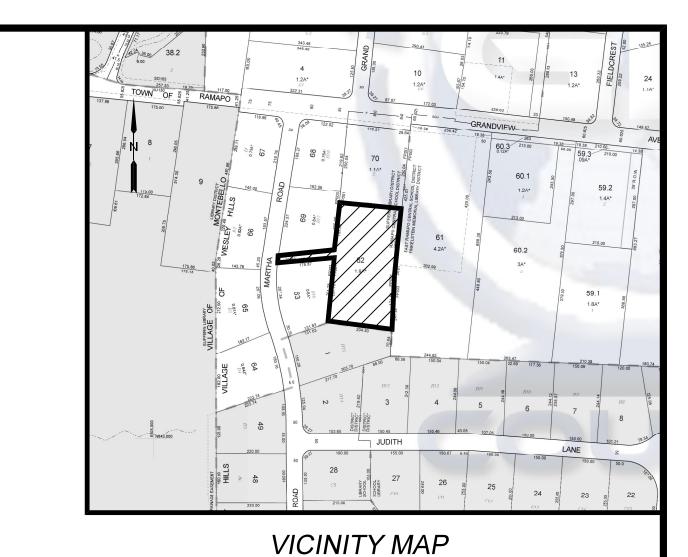

1'' = 300'

BASED ON THE VILLAGE OF WESLEY HILLS TAX MAP, THIS LOT IS 62 ON MAP 41.14 BLOCK 1. AREA OF TRACT: 80,253 SQ FT OR 1.8424 AC

NUMBER OF PROPOSED LOTS: 1
RECORD OWNER: DEVORAH & MARK FRIEDMAN
12A MARTHA ROAD

MONSEY, NY 10952

APPLICANT: EXISTING USE: RESIDENTIAL

8. PROPOSED USE: SINGLE FAMILY RESIDENCE
9. THIS PLAT DOES NOT CONFLICT WITH THE OFFICIAL COUNTY MAP AND HAS BEEN APPROVED IN THE MANNER SPECIFIED BY SECTION 239N OF THE GENERAL MUNICIPAL LAW.

10. ALL HOUSES TO BE SEWERED BY GRAVITY WITH A MIN. SLOPE OF 2%. THE INDIVIDUAL LOTS ARE DESIGNATED WITH THE TAX LOT NUMBER SHOWN THUS

12. 3/4" CORNER IRON PIPES TO BE SET BEFORE C.O. IS ISSUED.

13. ALL NEW UTILITIES TO BE UNDERGROUND.

14. FIRE DISTRICT - MOLESTON
15. SCHOOL DISTRICT - SUFFERN CENTRAL

16. WATER DISTRICT - RAMAPO CONSOLIDATED WATER DISTRICT. WATER SUPPLY BY SUEZ WATER

ALL ELEVATIONS SHOWN ARE BASED ON U.S.C. & G.S. DATUM. ELECTRIC DISTRICT - ORANGE & ROCKLAND

SEWER DISTRICT - BENEFITED AREA NO. 5

20. THERE ARE NO COVENANTS, DEED RESTRICTIONS, EASEMENTS, OR OTHER RESERVATIONS OF LAND RELATIVE TO THIS SITE, EXCEPT AS SHOWN ON THIS MAP, SUBJECT TO THE FINDINGS OF A COMPLETE AND UP TO DATE

21. BASEMAP FROM A SURVEY COMPLETED BY CIVIL TEC ENGINEERING & SURVEYING PC DATED JULY 6, 2020.

ALL FOOTING DRAINS SHALL BE PUMPED AND DAYLIGHTED. 23. BASEMENT SHALL HAVE A ZOELLER 1/2 HP SUBMERSIBLE SUMP PUMP OR APPROVED EQUAL.

BUILDING COVERAGE CALCULATION: 9,371 SF TOTAL LIVING FLOOR AREA TOTAL FLOOR AREA INCLUSIVE: 9,766 SF 3,272 SF IN SINGLE STORY HEIGHT (GAZEBO INCLUDED) 3,272 SF/8,805 (5,533 SF IN TWO STORY HEIGHT) TOTAL BUILDING AREA = 0.37 $0.37 \times 0.05 = 0.0185$ 0.0185 + 0.10 = 0.118580,253 SF (LOTAREA) X 0.1185 = 9,509.98 SF MAXIMUM ALLOWABLE BUILDING COVERAGE PROVIDED BUILDING COVERAGE 9,005 SF TOTAL BUILDING COVERAGE < 9,509.98 SF MAXIMUM

0.112 < 0.1185

NO STEEP SLOPES

PARKING CALCULATION: SINGLE FAMILY HOME REQUIRES 2 SPACES 2 GARAGE SPACES PROVIDED

FRONT YARD IMPERVIOUS DRIVEWAY 5,300 SF

5,300 SF IMPERVIOUS/22,624 SF FRONT YARD = 0.23

| | Bulk Requirements: R-50 Single Family Residence | | | | | | | | | | | |
|--|---|----------|----------|------------|-----------|------------|-----------|---------------|-----------------|----------|--------------|--------------|
| | | | | | | | | | | | | |
| | | | | | | | | Max. | Max. Front Yard | Max. | Max. | Max. Exposed |
| | Min. Lot | Min. Lot | Min. Lot | Min. Front | Min. Side | Min. Total | Min. Rear | Impervious | Impervious | Building | Building | Building |
| | Area | Frontage | Width | Yard | Yard | Side Yard | Yard | Surface Ratio | Surface Ratio | Coverage | Height | Height |
| | | | | | | | | | | | 2.5 stories/ | |
| Required | 50,000 SF | 100 FT | 150 FT | 50 FT | 30 FT | 75 FT | 50 FT | 0.2 | 0.15 | 0.1185 | 25 FT | 40 FT |
| Variances | | | | | | | | | | | | |
| Previously | | | | | | | | | | | | |
| Granted | | 20.3 FT | | | | | 33 FT | 0.26 | 0.169 | | | |
| | | | | | | | | | | | 2 stories/23 | |
| Provided | 80,253 SF | 20.3 FT | 381.6 FT | 50 FT | 25 FT | 281 FT | 31.9 FT | 0.36 | 0.23 | 0.112 | FT | 40 FT |
| VARIANCES ORIGINALLY GRANTED ON SEPTEMBER 16, 2020 | | | | | | | | | | | | |

VARIANCE REQUIRED FOR 230-14.O(6) FOR MORE THAN TWO ACCESSORY STRUCTURES. SPECIAL PERMIT REQUIRED FOR AN ACCESSORY SPORTS COURT GREATER THAN 2,500 SF

> **REV FOR ZBA** JANUARY 17, 2025 **REV UTILITIES** DECEMBER 31, 2024 REV 6 REV FOR TENNIS COURT AUGUST 7, 2024 REV 5 REV PER VILLAGE ENGINEER'S COMMENTS NOVEMBER 15, 2021 OCTOBER 27, 2021 REV PER VILLAGE ENGINEER'S COMMENTS OCTOBER 14, 2021 REV 2 REV PER SOIL TESTING OCTOBER 6, 2021 REV 1 REV PER VILLAGE ENGINEER'S COMMENTS

2. LOT DESCRIBED BY DEED IN INSTRUMENT NO. 2020 AT PAGE 3. BEING LOT 1 ON A MAP ENTITLED "ARNOLD C. GILBERT", FILED IN THE ROCKLAND COUNTY CLERKS OFFICE ON OCTOBER 12, 1973 IN


S.B.L. 41.14 - 1 - 62 **BUILDING PERMIT PLAN** FOR


12A MARTHA ROAD VILLAGE OF WESLEY HILLS - ROCKLAND COUNTY - NEW YORK

DESCRIPTION


REVISIONS

| | | | . • |
|--|--|-----------|-----------|
| CIVIL TEC E | ngineering & Surveying PC | DATE: | 12/7/2020 |
| 139 Lafayette Avenue, 2nd Fl. Suffern, NY 10901 P 845.547.2241 - F 845.547.224 | 111 Main Street Chester, NY 10918 | DRAWN BY: | RB/LT |
| Civil Engineering & | Land Surveying Services that Build Communities www.Civil-Tec.com | CHKD BY: | RB/LT |
| | | JOB No. | 3814 |
| | | SCALE: | 1"=20' |
| | Rachel B. Barese, P.E. N.Y. Lic. No. 90143 | DWG No. | 3 OF 5 |

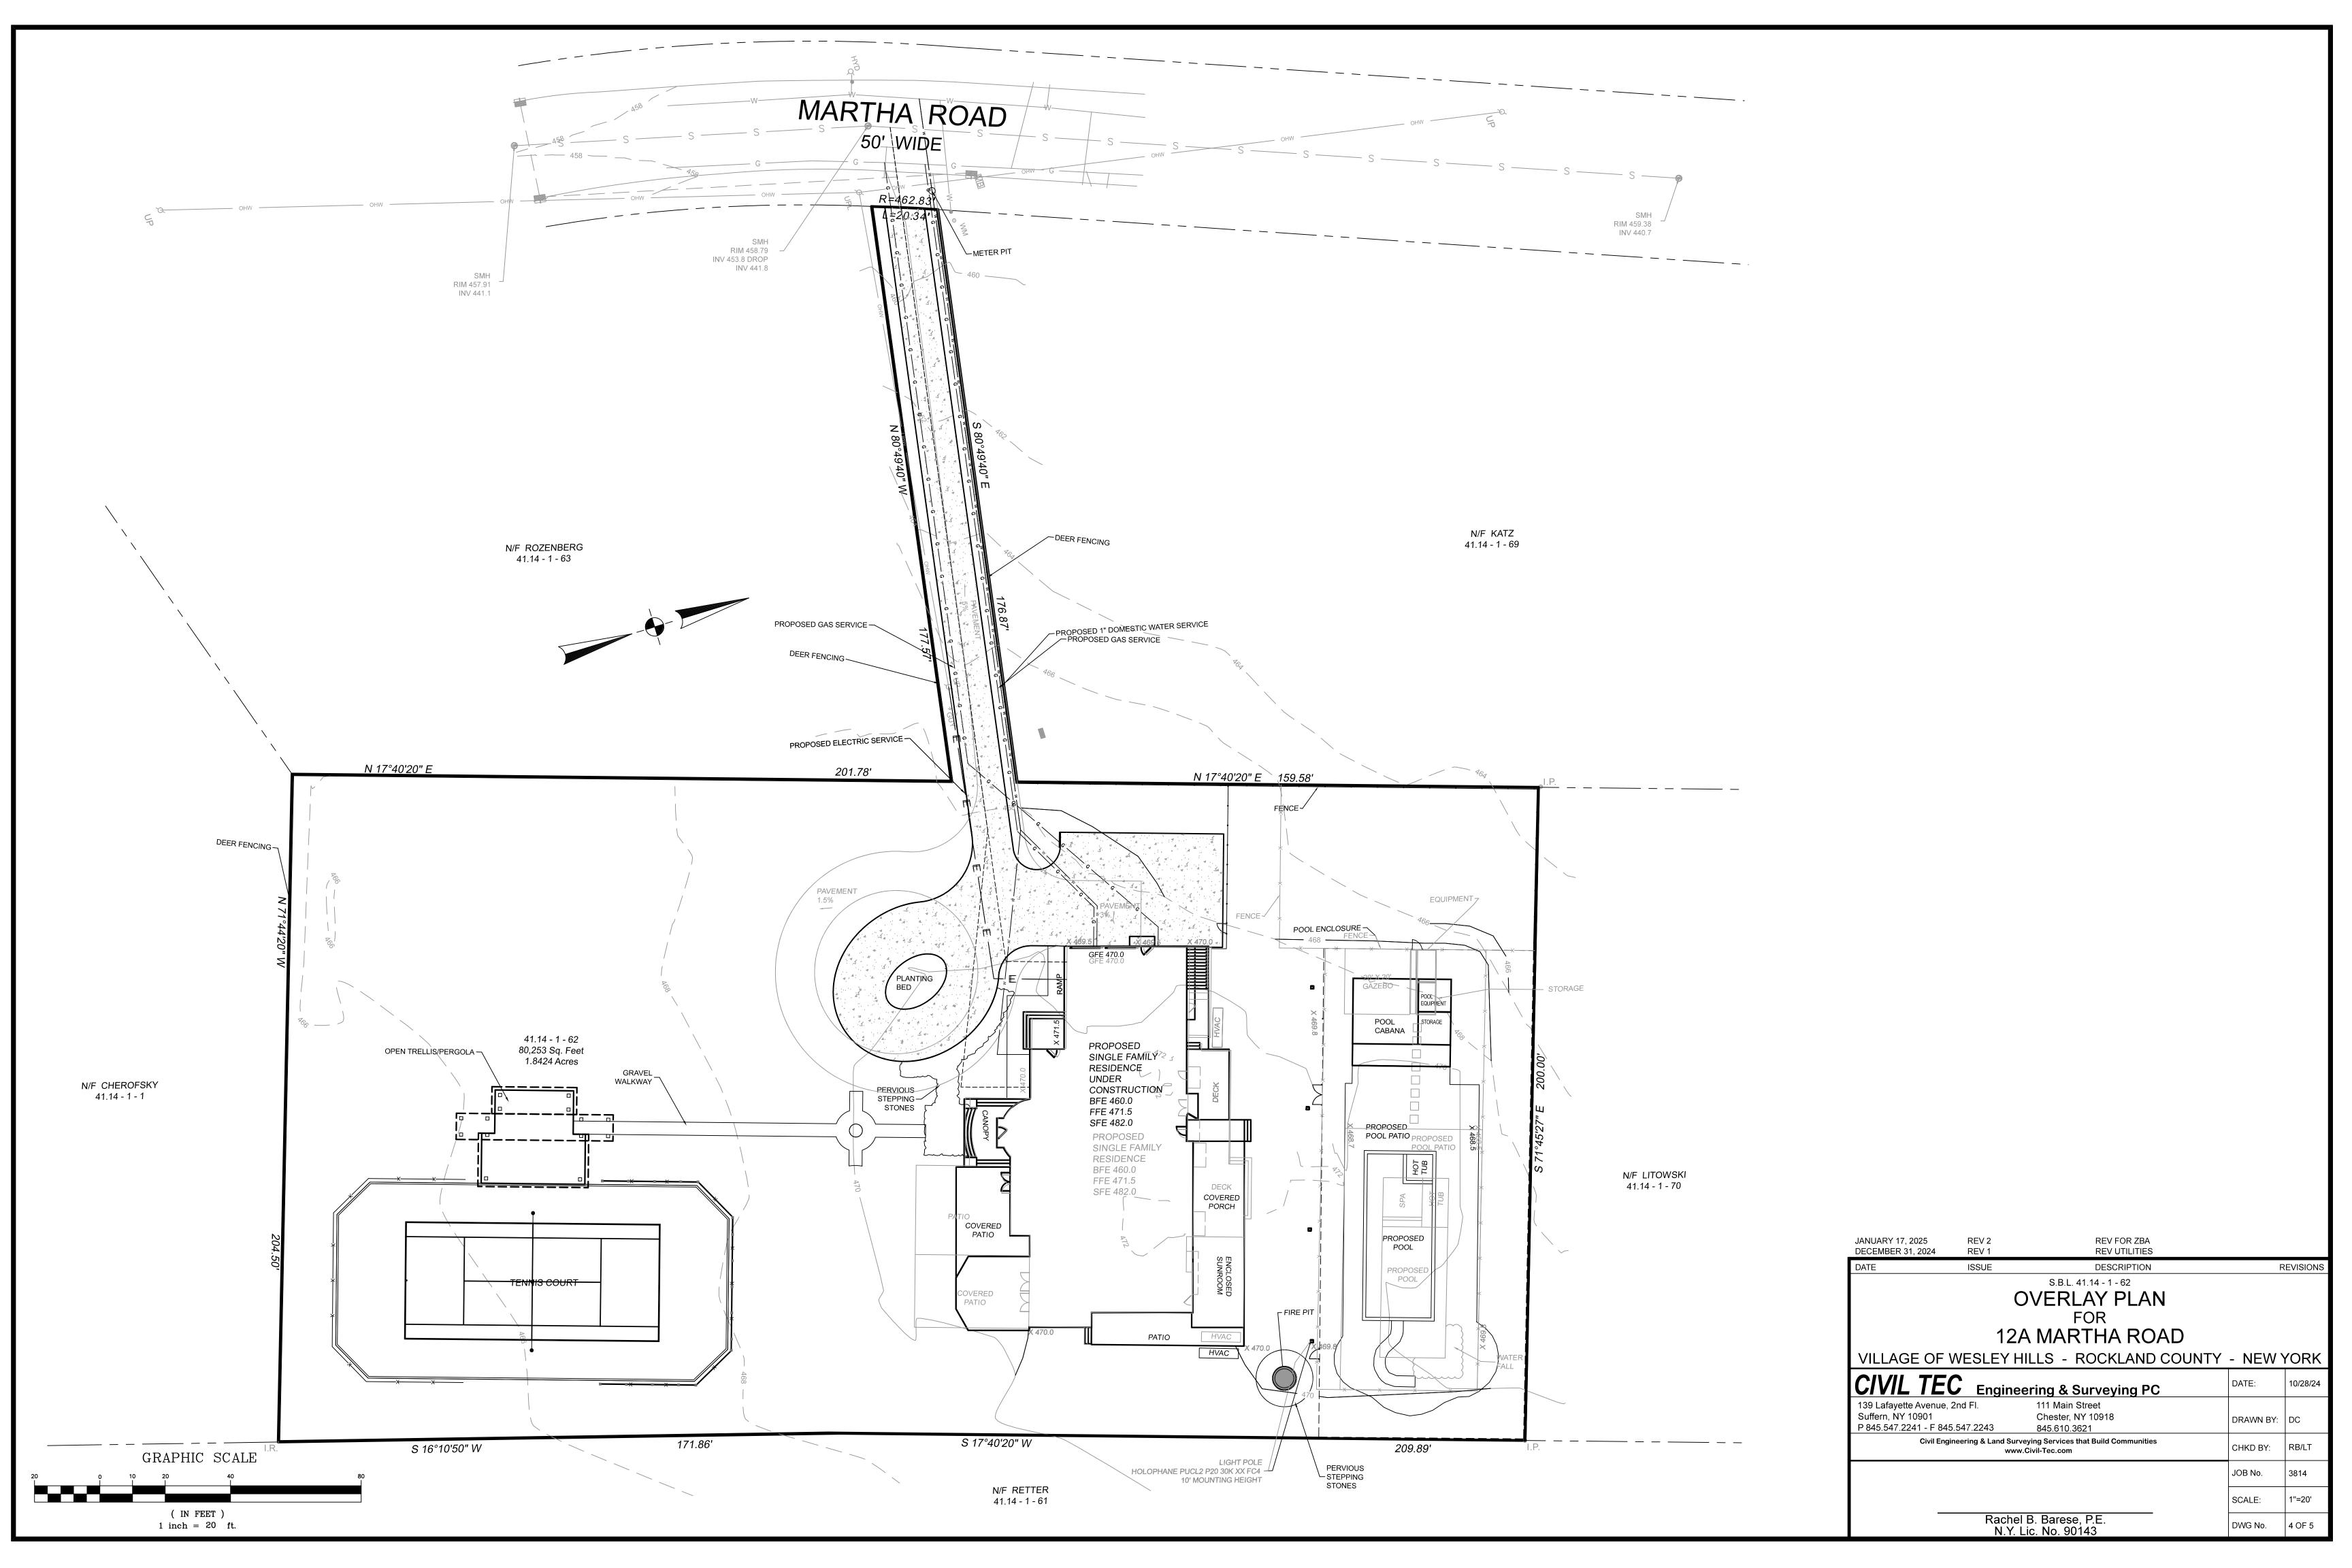

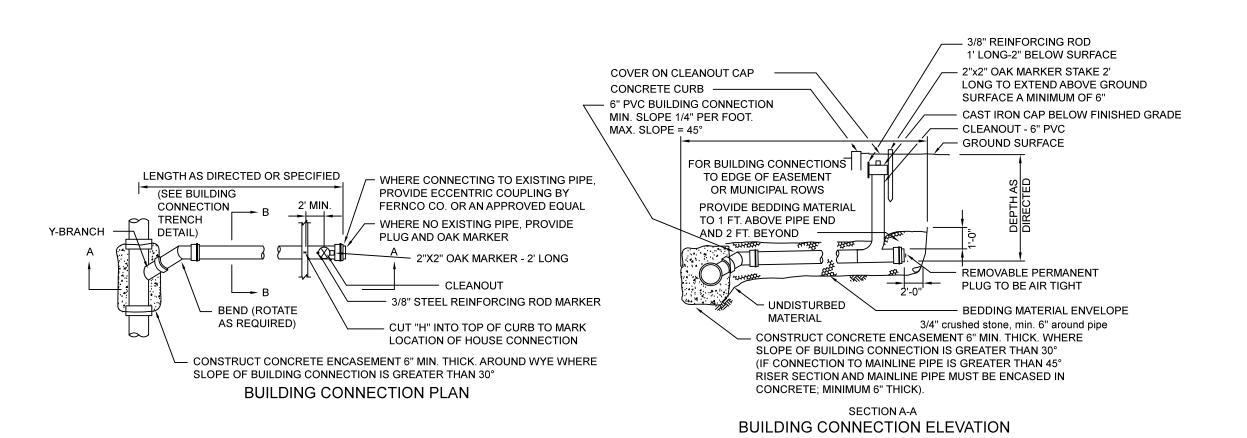



BUILDING CONNECTION DETAIL

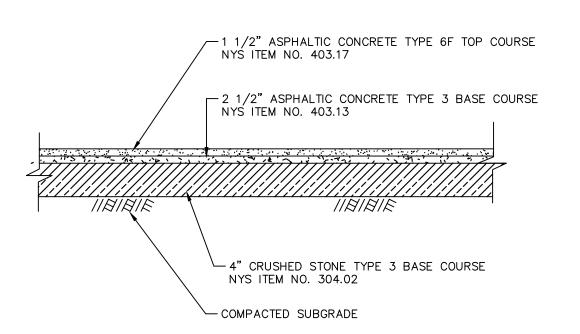

TYPICAL DRIVEWAY PAVEMENT SECTION

SCALE: N. T. S.

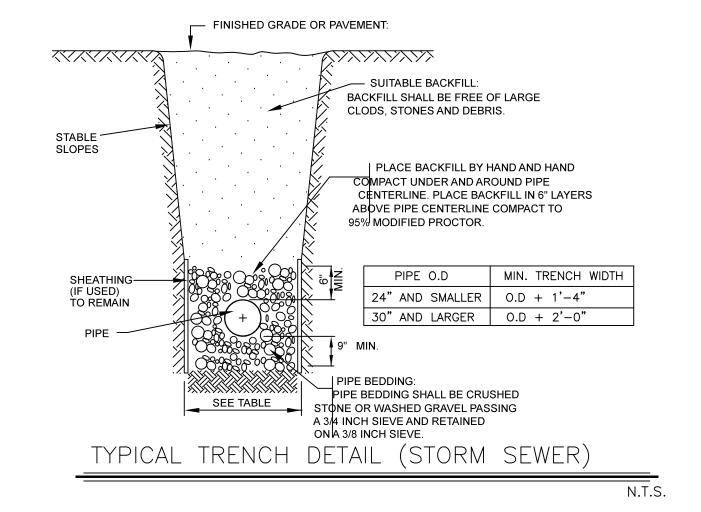

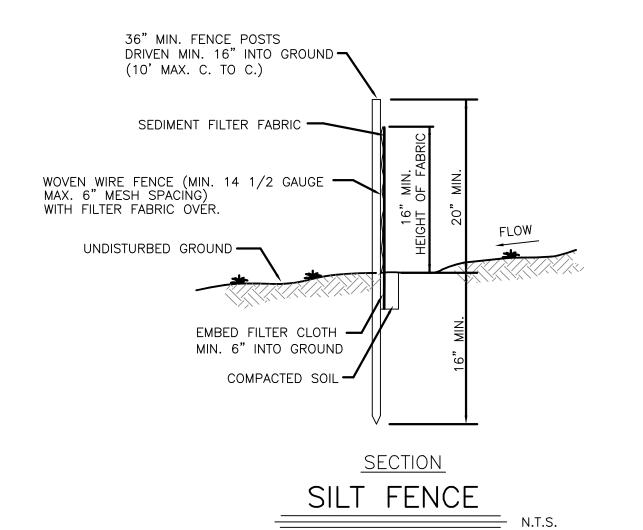


CONSTRUCTION NOTES FOR FABRICATED SILT FENCE

- 1. WOVEN WIRE FENCE TO BE FASTENED SECURELY TO FENCE POSTS WITH WIRE TIES OR STAPLES.
- 2. FILTER CLOTH TO BE FASTENED SECURELY TO WOVEN WIRE FENCE WITH TIES SPACED EVERY 24" AT TOP AND MID SECTION.
- 3. WHEN TWO SECTIONS OF FILTER CLOTH ADJOIN EACH OTHER THEY
- SHALL BE OVERLAPPED BY SIX INCHES AND FOLDED.

 4. MAINTENANCE SHALL BE PERFORMED AS NEEDED AND MATERIAL
- REMOVED WHEN BULGES DEVELOP IN THE SILT FENCE.

 5. POST TO BE STEEL EITHER "T" OR "U" TYPE OR 2" HARWOOD.
- 6. FILTER CLOTH TO BE MIRAFI 100X STABILINKA T140N OR APPROVED EQUAL.
- 7. PREFABRICATED UNIT GEOFAB. ENVIROFENCE OR APPROVED EQUAL.

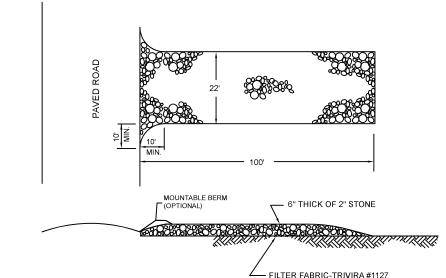


STABILIZED CONSTRUCTION ENTRANCE

- CONSTRUCTION SPECIFICATIONS

 1. STONE SIZE USE 2 INCHES STONE, OR RECLAIMED OR RECYCLED CONCRETE EQUIVALENT.
- CONCRETE EQUIVALENT.

 2. LENGTH NOT LESS THAN 50 FEET (EXCEPT ON A SINGLE RESIDENCE LOT WHERE A 30 FOOT MINIMUM LENGTH WOULD APPLY).
- 3. THICKNESS NOT LESS THAN 6 INCHES.
- 4. WIDTH 12 FEET MINIMUM. BUT NOT LESS THAN THE FULL WIDTH AT POINTS WHERE INGRESS OR EGRESS OCCURS. TWENTY FOUR FEET IF SINGLE ENTRANCE TO SITE
- SINGLE ENTRANCE TO SITE.

 5. FILTER CLOTH WILL BE PLACED OVER THE ENTIRE AREA PRIOR TO PLACING OF STONE.
- 6. SURFACE WATER ALL SURFACE WATER FLOWING OR DIVERTED TOWARD CONSTRUCTION ENTRANCES SHALL BE PIPED ACROSS THE ENTRANCE. IF PIPING IS IMPRACTICAL. A MOUNTABLE BERM WITH 5:1 SLOPES WILL BE DEPARTED.
- 7. MAINTENANCE THE ENTRANCE SHALL BE MAINTAINED IN A CONDITION WHICH WILL PREVENT TRACKING OR FLOWING OF SEDIMENT ONTO PUBLIC RIGHTS—OF—WAY. ALL SEDIMENT SPILLED. DROPPED. WASHED OR TRACKED
- RIGHTS-OF-WAY. ALL SEDIMENT SPILLED. DROPPED. WASHED OR TRACKI ONTO PUBLIC RIGHTS-OF-WAY MUST BE REMOVED IMMEDIATELY.
- 8. WHEN WASHING IS REQUIRED. IT SHALL BE DONE ON AN AREA STABILIZED WITH STONE AND WHICH DRAINS INTO AN APPROVED SEDIMENT TRAPPING
- 9. PERIODIC INSPECTION AND NEEDED MAINTENANCE SHALL BE PROVIDED AFTER EACH RAIN.

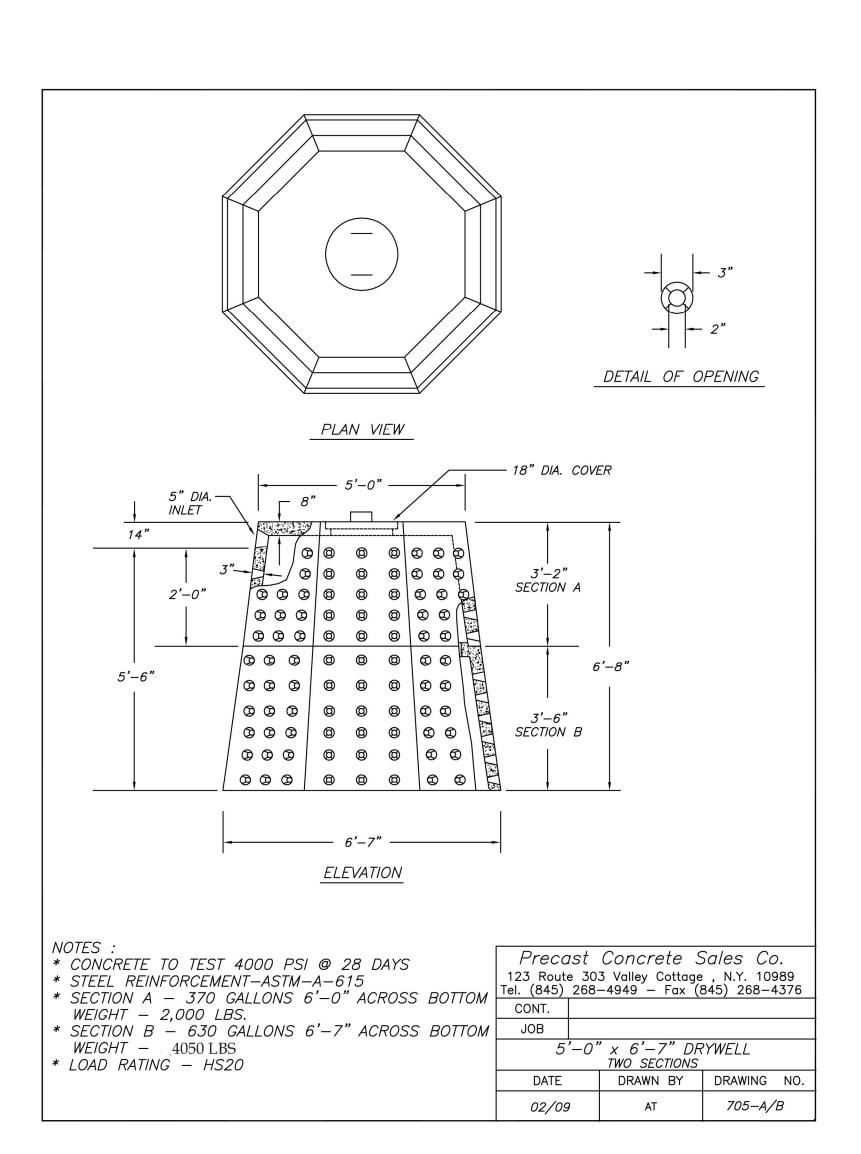

EROSION CONTROL & SEDIMENT NOTES

- 1. A TEMPORARY SEEDING SHALL BE APPLIED TO DISTURBED AREAS THAT ARE LEFT BARE FOR 15 DAYS UNLESS CONSTRUCTION WILL BEGIN WITHIN 30 DAYS. IF CONSTRUCTION IS SUSPENDED OR COMPLETED, AREAS SHALL BE SEEDED DOWN OR MULCHED IMMEDIATELY.
- 2. STRUCTURAL MEASURES MUST BE MAINTAINED TO BE EFFECTIVE. IN GENERAL, THESE MEASURES MUST BE PERIODICALLY INSPECTED TO INSURE STRUCTURAL INTEGRITY, DETECT VANDALISM DAMAGE, AND FOR CLEANING AND REPAIR WHENEVER NECESSARY.
- 3. DURING CONSTRUCTION, ALL STRUCTURES SHALL BE INSPECTED WEEKLY AND AFTER EVERY RAIN.
- 4. AFTER CONSTRUCTION, INSPECTION SHALL BE MADE AT LEAST SEMI—ANNUALLY AND AFTER EVERY RAIN.
 5. THE STORM DRAIN INLET STRUCTURES SHALL BE PROTECTED WITH A FILTER BERM UNTIL THE AREA IS STABILIZED WITH
- VEGETATION OR THE BASE COURSE OF PAVEMENT IS INSTALLED.

 6. CONSIDER LIMITING LAND DISTURBANCE TO ONLY THAT AREA NECESSARY FOR DEVELOPMENT.
- 7. THE MACADAM SURFACE SHALL BE SWEPT "BROOM CLEAN" AT THE END OF EACH DAY DURING THE CONSTRUCTION PHASE OF THE SIDEWALKS AND CURB.
- 8. A STABILIZED CONSTRUCTION ENTRANCE SHALL BE INSTALLED AT ALL POINTS WHERE A DISTURBED AREA MEETS AN
- IMPERVIOUS SURFACE, THIS INCLUDES ALL NEW DRIVEWAY CONNECTIONS ALONG THE NEW ROADWAY.

 9. CONSTRUCTION EQUIPMENT SHALL BE LIMITED TO THOSE AREAS WITHIN THE SILT FENCE SEDIMENT PROTECTION. AT THE CONCLUSION OF CONSTRUCTION OPERATIONS, THE AREA COMPACTED BY MACHINERY SHALL BE DICED OR OTHERWISE LOOSENED TO A DEPTH OF 12 INCHES PRIOR TO FINAL GRADING WITH TOPSOIL AND SEEDING.

JANUARY 17, 2025 **REV FOR ZBA DECEMBER 31, 2024 REV UTILITIES** REV 6 AUGUST 7, 2024 REV FOR TENNIS COURT NOVEMBER 15, 2021 REV PER VILLAGE ENGINEER'S COMMENTS OCTOBER 27, 2021 REV PER VILLAGE ENGINEER'S COMMENTS OCTOBER 14, 2021 REV 2 REV PER SOIL TESTING OCTOBER 6, 2021 REV 1 REV PER VILLAGE ENGINEER'S COMMENTS

S.B.L. 41.14 - 1 - 62

BUILDING PERMIT PLAN

FOR

12A MARTHA ROAD

VILLAGE OF WESLEY HILLS - ROCKLAND COUNTY - NEW YORK

| VILLAGE OF WESLET I | IILLS - NOCKLAND COON | | IONN |
|---|--|-----------|----------|
| CIVIL TEC Engine | DATE: | 7/21/21 | |
| 139 Lafayette Avenue, 2nd Fl. Suffern, NY 10901 P 845.547.2241 - F 845.547.2243 | 111 Main Street Chester, NY 10918 845.610.3621 | DRAWN BY: | RB/LT |
| Civil Engineering & Land Su ww | CHKD BY: | RB/LT | |
| | | JOB No. | 3814 |
| | | SCALE: | AS SHOWN |
| | el B. Barese, P.E. Lic. No. 90143 | DWG No. | 5 OF 5 |