June 17, 2024

3J CONSULTING 9600 SW NIMBUS AVENUE, SUITE 100 BEAVERTON, OREGON 97008 PH: (503) 946.9365 WWW.3JCONSULTING.COM

Cindy Luxhoj, AICP Associate Planner City of Wilsonville 29799 SW Town Center Loop East Wilsonville, OR 97070


Frog Pond Neighborhood Park Wilsonville, Oregon

Dear Cindy,

On behalf of the Applicant team, 3J Consulting would like to provide the City with revised land use plans for the proposed Frog Pond Neighborhood Park (DB24-0004, SDR24-0002, TPLN24-0002, SIGN24-0007, SROZ24-0001, SRIR24-0001). The intent of this letter is to describe the minor revisions made to the proposed park plans prior to the scheduled Development Review Board hearing on June 24, 2024. A revised "Appendix D – Land Use Plans and Materials Sheets" has been provided to the City with this letter.

The following changes have been made to the land use plans:

- At the Playground area the boardwalk paving has been revised to use a thickened edge in lieu of flush curbs. This change has been made for ease of constructability and allows board stamping to extend to edges of the boardwalk.
- At the southeast seating area in the aggregate paving area the layout has been revised to work better with the grades. The updated plans show the aggregate paving extended slightly further and a bench and freestanding column provided for seating instead of two freestanding columns.
- At the south entry to the park the paving layout has been revised to better accommodate the majority of pedestrian flow between the right-of-way and school on the adjacent property to the west.
- In the fitness area, a "Push N' Pull FIT-2671" will be provided in lieu of the "Invigorate Strider – FIT-2925". This will better accommodate a wider range of physical abilities.
- Salvaged street trees along Brisband Street were incorrectly identified as "Tilia Cordata" on the Plant Schedule and Notes (Sheet L5.00) of the plans set. Sheet L5.00 has been revised to state the salvaged street trees botanical name is "Tilia Americana".
- Throughout the entire park, the following changes to the plans have been made:
 - All bench locations have flares added to the concrete to widen the area where the bench is placed. This will protect planting areas from being damaged or degraded over time.
 - All path intersections have additional radii to protect planting areas from being damaged or degraded over time.
 - Concrete paving areas are revised to show the intent of concrete scoring and construction joint placement.
 - Boulders are more accurately drawn at retaining wall locations in lieu of representing walls with edges only.

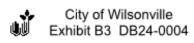

The Applicant team trusts that these revisions to "Appendix D" will assist in the Development Review Board's favorable evaluation of the application. Please feel free to contact me directly if you have any questions or need any additional clarification about these minor revisions.


Sincerely,

Sund Hund

Sam Huck Planner 3J Consulting, Inc. sam.huck@3j-consulting.com

Page 2 of 2



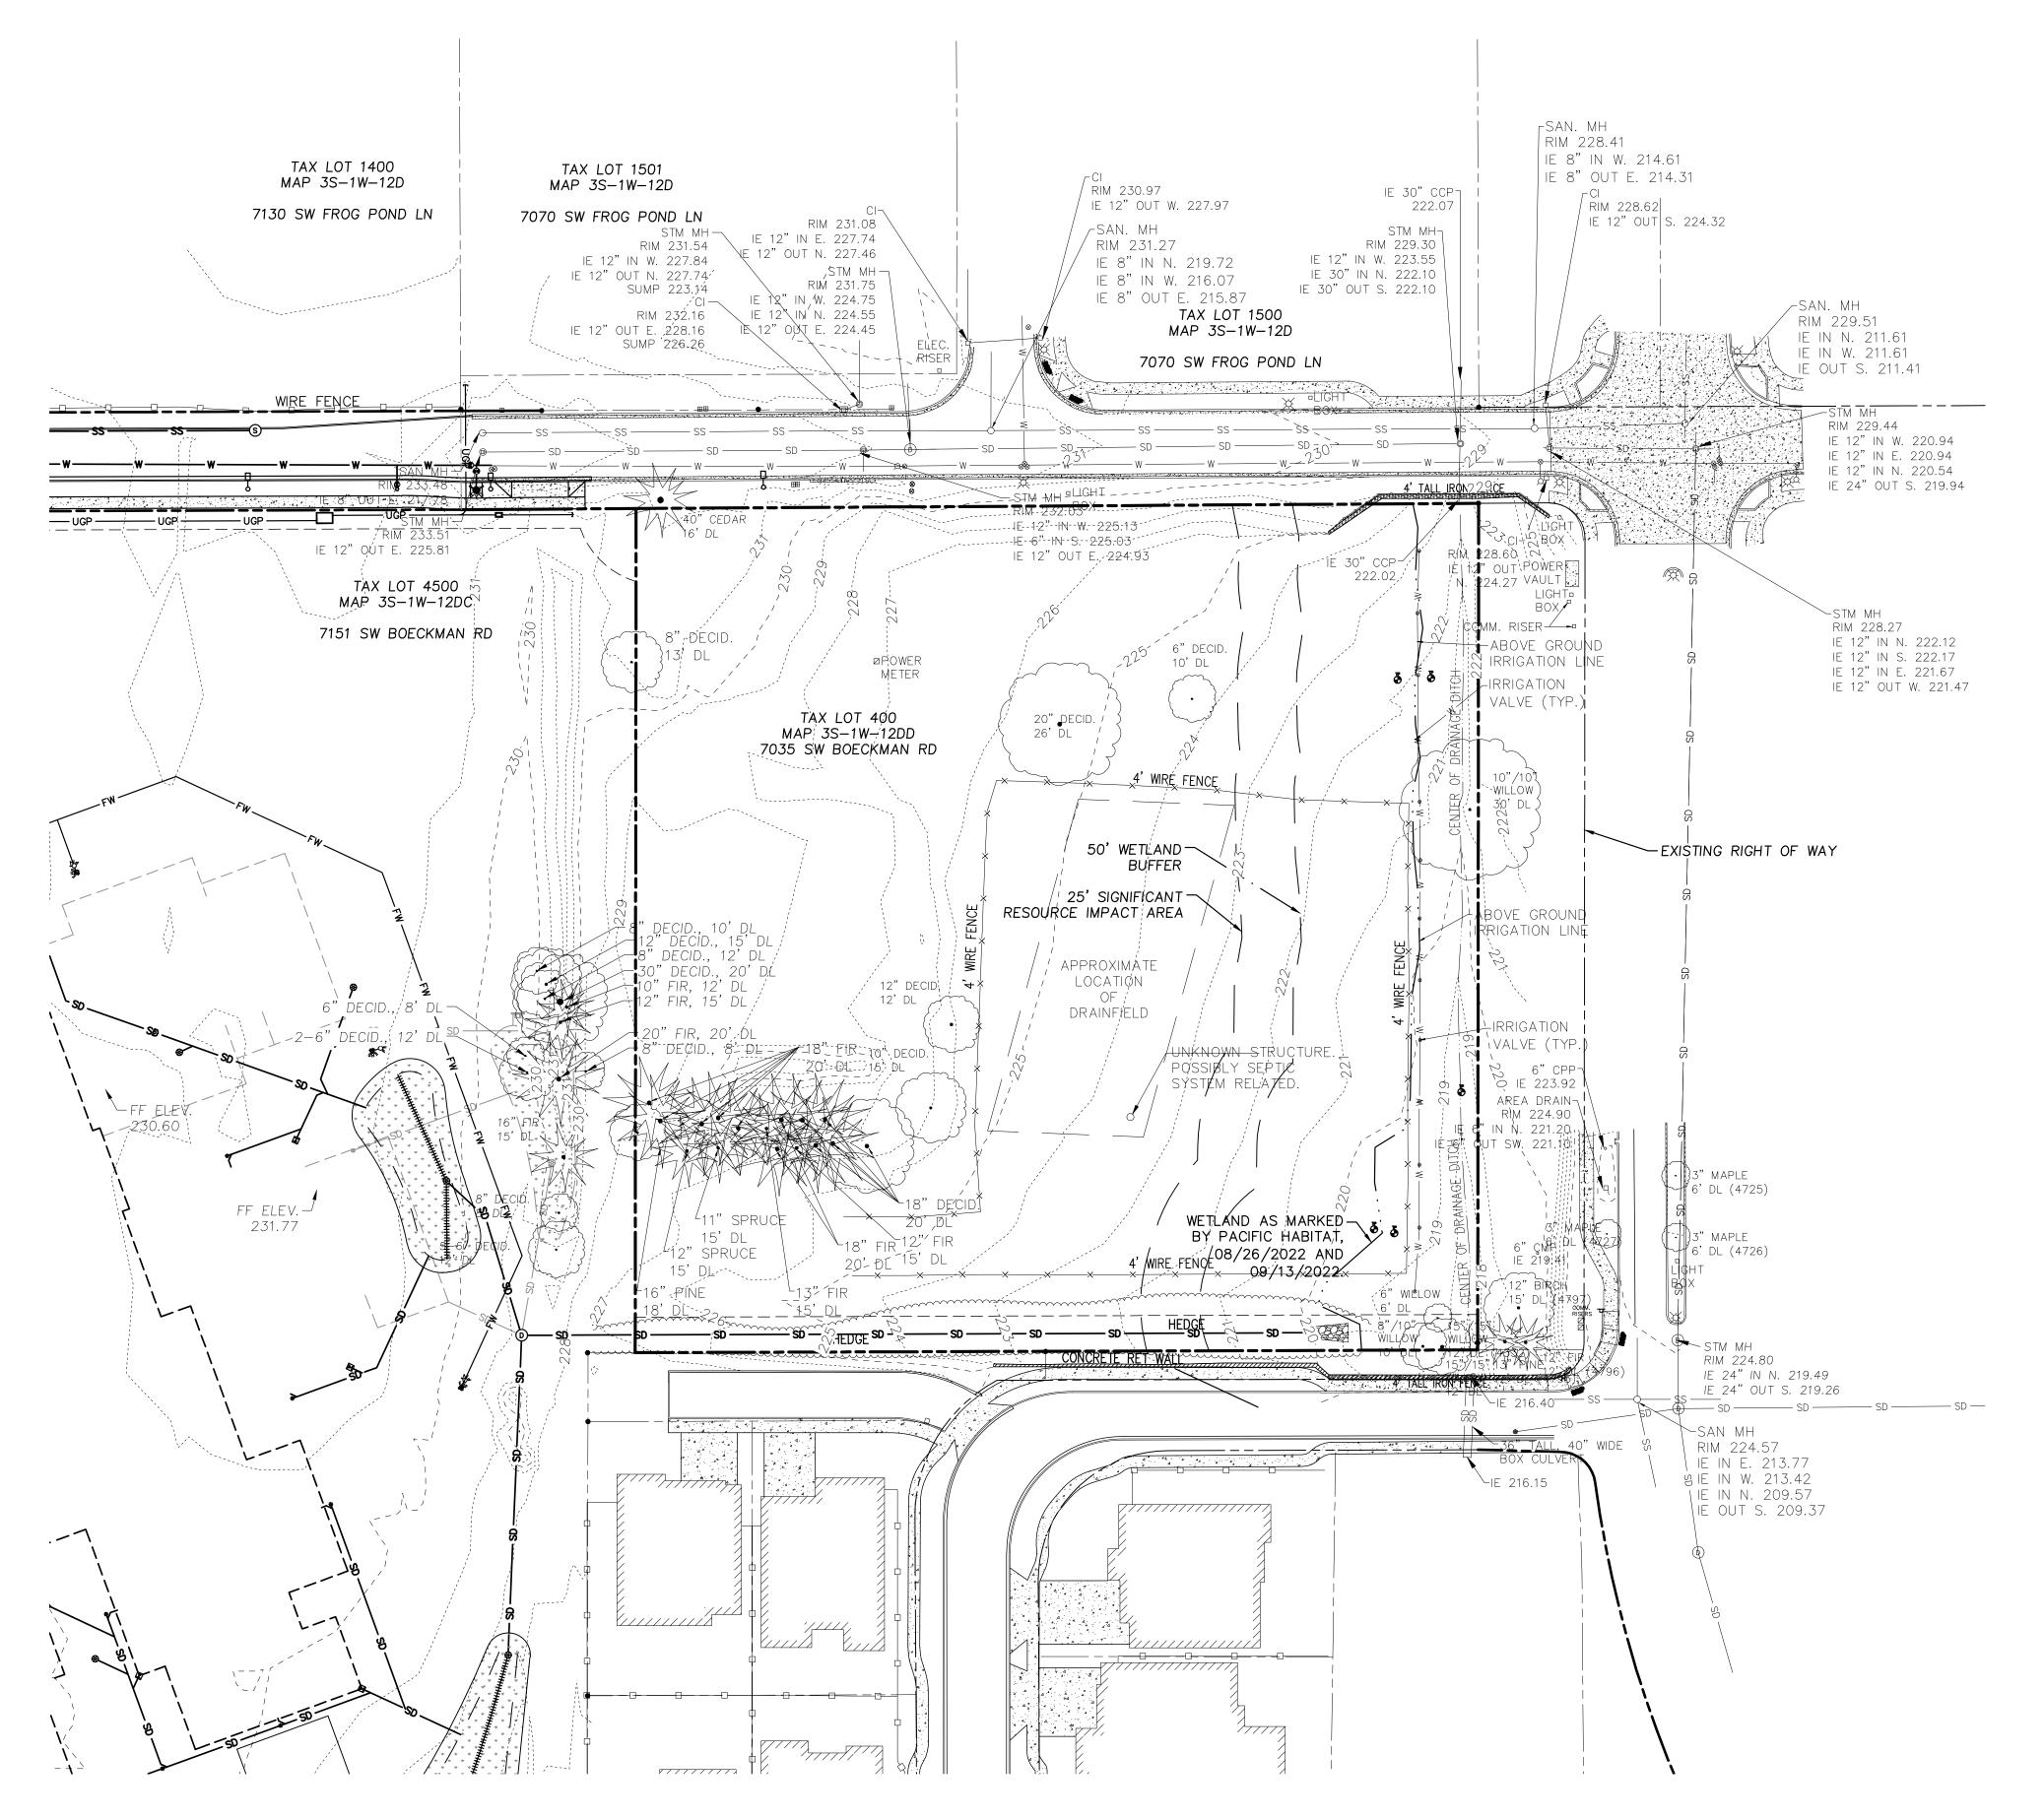

EXISTING LEGEND

| | PROPERTY LINE | | STORM MANHOLE |
|---------|------------------------|-------------------|----------------------|
| | EASEMENT LINE | | CATCH BASIN |
| SD | STORM LINE | 0 | CLEANOUT/ROOF DRAIN |
| SS | SEWER LINE | 0 | SEWER MANHOLE |
| W | WATER LINE | Ķ | FIRE HYDRANT |
| G | GAS LINE | | WATER METER |
| | UNDERGROUND POWER LINE | \otimes | WATER VALVE |
| OHP | OVERHEAD POWER LINE | 0 | GAS METER |
| T | COMMUNICATIONS LINE | \square | GAS VALVE |
| -00 | FENCE | | ELECTRICAL VAULT/BOX |
| XX0 | MAJOR CONTOUR | X | LIGHT POLE |
| XX1 | MINOR CONTOUR | -0- | UTILITY POLE |
| _ · · · | EDGE OF BRUSH | \longrightarrow | UTILITY POLE ANCHOR |
| | CURB | 묘 | SIGN |
| | EXTG BUILDING | | MAILBOX |
| | BUILDING EAVE | | |
| | WALL | | CONIFEROUS TREE |
| | ASPHALT | | |
| | CONCRETE | | DECIDUOUS TREE |
| | GRAVEL PATH | | |
| | | (+) | SEPTIC TANK |

EXISTING CONDITIONS PLAN

THIS PLAN HAS BEEN PREPARED FOR ILLUSTRATIVE PURPOSES ONLY. SITE BACKGROUND INFORMATION AND FEATURES HAVE BEEN GENERATED FROM A COMBINATION OF PUBLIC GIS DATA SOURCES, AERIAL PHOTOS, TAX ASSESSOR MAPS, PHYSICAL SITE OBSERVATIONS AND A TOPOGRAPHIC MAP PROVIDED BY COMPASS LAND SURVEYORS. PROPOSED SITE FEATURES ARE PRELIMINARY IN NATURE AND SUBJECT TO CHANGE. NO WARRANTY OR GUARANTEE IS EXPRESSED OR IMPLIED.

SURVEYORS NOTES

1. VERTICAL DATUM: NAVD '88, OREGON REAL TIME GNSS NETWORK (ORGN)

2. HORIZONTAL DATUM: OREGON COORDINATE REFERENCE SYSTEM, PORTLAND ZONE, BASED UPON OBSERVATIONS TIED TO THE OREGON REAL TIME GNSS NETWORK, (ORGN) NAD '88 (2011) EPOCH 2010.00.

3. UTILITY INFORMATION SHOWN ON THIS MAP IS BASED UPON OBSERVED FEATURES AND UTILITY LOCATES. NO WARRANTIES ARE MADE REGARDING THE ACCURACY OR COMPLETENESS OF THE UTILITY INFORMATION SHOWN. ADDITIONAL UTILITIES MAY EXIST. INTERESTED PARTIES ARE HEREBY ADVISED THAT UTILITY LOCATIONS SHOULD BE VERIFIED PRIOR TO DESIGN OR CONSTRUCTION OF ANY CRITICAL ITEMS.

4. CONTOUR INTERVAL IS ONE FOOT.

5. TOPOGRAPHIC FEATURES SHOWN ON THIS MAP WERE LOCATED USING STANDARD PRECISION TOPOGRAPHIC MAPPING PROCEDURES. THIRD PARTY USERS OF DATA FROM THIS MAP PROVIDED VIA AUTOCAD DRAWING FILES OR DATA EXCHANGE FILES SHOULD NOT RELY ON ANY AUTOCAD GENERATED INFORMATION WHICH IS BEYOND THE LIMITS OF PRECISION OF THIS MAP. THIRD PARTIES USING DATA FROM THIS MAP IN AN AUTOCAD FORMAT SHOULD VERIFY ANY ELEMENTS REQUIRING PRECISE LOCATIONS PRIOR TO COMMENCEMENT OF ANY CRITICAL DESIGN OR CONSTRUCTION. CONTACT COMPASS LAND SURVEYORS FOR FURTHER INFORMATION. FURTHERMORE, COMPASS LAND SURVEYORS WILL NOT BE RESPONSIBLE NOR HELD LIABLE FOR ANY DESIGN OR CONSTRUCTION RELATED PROBLEMS THAT ARISE OUT OF THIRD PARTY USAGE OF THIS MAP (IN AUTOCAD OR OTHER FORMAT) FOR ANY PURPOSE OTHER THAN SPECIFICALLY STATED HEREIN. THIS STATEMENT IS AN OFFICIAL PART OF THIS MAP.


6. PUBLIC UTILITIES NOTIFIED BY OREGON UTILITY NOTIFICATION CENTER TICKET NUMBER 20041523:

CLACKAMAS COUNTY D.O.T. CLACKAMAS COUNTY D.O.T.-CBX COMCAST FRONTIER NW NATURAL PORTLAND GENERAL ELECTRIC CENTURYLINK 360 NETWORKS USA



Mayer/Reed

Mayer/Reed, Inc. 319 SW Washington St. Suite 820 Portland, Oregon 97204 503.223.5953 www.mayerreed.com

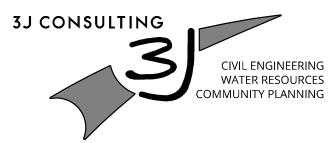

9600 SW NIMBUS AVE., SUITE 100; BEAVERTON, OR 97008



Revisions

Submittal / Date LAND USE PERMIT

REVISED 06.13.2024


Project FROG POND NEIGHBORHOOD PARK

Sheet Title

EXISTING CONDITIONS PLAN



| 503-722-6301 |
|--------------|
| |
| 503-722-6663 |
| 800-778-9140 |
| 800-778-9140 |
| 503-220-2415 |
| 503-255-4634 |
| 800-778-9140 |
| 888-267-1063 |

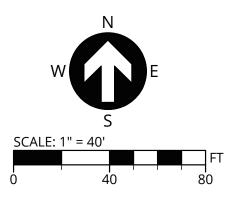



STANDARD EROSION CONTROL NOTES

- 1. ONCE KNOWN, INCLUDE A LIST OF ALL CONTRACTOR(S) THAT WILL ENGAGE IN CONSTRUCTION ACTIVITIES. REVISE THE LIST AS APPROPRIATE UNTIL THE PERMIT COVERAGE IS TERMINATD (SECTION 4.4.c.i). IN ADDITION, INCLUDE A LIST OF PERSONNEL (BY NAME AND POSITION) THAT ARE RESPONSIBLE FOR THE DESIGN, INSTALLATION AND MAINTENANCE OF STORMWATER CONTROL MEASURES (E.G. ESCP DEVELOPER, BMP INSTALLER (SECTION 4.10), AS WELL AS THEIR INDIVIDUAL RESPONSIBILITIES (SECTION 4.4.c.ii). 2. VISUAL MONITORING INSPECTION REPORTS MUST BE MADE IN ACCORDANCE WITH DEQ 1200-C PERMIT
- **REQUIREMENTS (SECTION 6.5).**
- 3. INSPECTION LOGS MUST BE KEPT IN ACCORDANCE WITH DEQ'S 1200-C PERMIT REQUIREMENTS (SECTIONS 4 AND 4.11)
- 4. RETAIN A COPY OF THE ESCP AND ALL REVISIONS ON SITE AND MAKE IT AVAILABLE ON REQUEST TO DEQ, AGENT, OR THE LOCAL MUNICIPALITY (SECTION 4.7).
- 5. THE PERMIT REGISTRANT MUST IMPLEMENT THE ESCP. FAILURE TO IMPLEMENT ANY OF THE CONTROL MEASURES OR PRACTICES DESCRIBED IN THE ESCP IS A VIOLATION OF THE PERMIT (SECTIONS 4 AND 4.11). 6. THE ESCP MUST BE ACCURATE AND REFLECT SITE CONDITIONS (SECTION 4.8).
- 7. SUBMISSION OF ALL ESCP REVISIONS IS NOT REQUIRED. SUBMITTAL OF THE ESCP REVISIONS IS ONLY UNDER SPECIFIC CONDITIONS. SUBMIT REVISIONS TO DEQ OR AGENT WITHIN 10 DAYS (SECTION 4.9).
- 8. SEQUENCE CLEARING AND GRUBBING TO THE MAXIMUM EXTENT PRACTICAL TO PREVENT EXPOSED INACTIVE AREAS FROM BECOMING A SOURCE OF EROSION (SECTION 2.2.2).
- 9. CREATE SMOOTH SURFACES BETWEEN SOIL SURFACE AND EROSION AND SEDIMENT CONTROLS TO PREVENT STORMWATER FROM BYPASSING CONTROLS AND PONDING (SECTION 2.2.3).
- 10. IDENTIFY, MARK, AND PROTECT (BY CONSTRUCTION FENCING OR OTHER MEANS) CRITICAL RIPARIAN AREAS AND VEGETATION INCLUDING IMPORTANT TREES AND ASSOCIATED ROOTING ZONES, AND VEGETATION AREAS TO BE PRESERVED. IDENTIFY VEGETATIVE BUFFER ZONES BETWEEN THE SITE AND SENSITIVE AREAS (E.G., WETLANDS), AND OTHER AREAS TO BE PRESERVED, ESPECIALLY IN PERIMETER AREAS (SECTION 2.2.1).
- 11. PRESERVE EXISTING VEGETATION WHEN PRACTICAL AND RE-VEGETATE OPEN AREAS. RE-VEGETATE OPEN AREAS WHEN PRACTICABLE BEFORE AND AFTER GRADING OR CONSTRUCTION. IDENTIFY THE TYPE OF VEGETATIVE SEED MIX USED (SECTION 2.2.5)
- 12. MAINTAIN AND DELINEATE ANY EXISTING NATURAL BUFFER WITHIN THE 50-FEET OF WATERS OF THE STATE (SECTION 2.2.4).
- 13. INSTALL PERIMETER SEDIMENT CONTROL, INCLUDING STORM DRAIN INLET PROTECTION AS WELLL AS ALL SEDIMENT BASINS, TRAPS, AND BARRIERS PRIOR TO LAND DISTURBANCE (SECTION 2.1.3). 14. CONTROL BOTH PEAK FLOW RATES AND TOTAL STORMWATER VOLUME, TO MINIMIZE EROSION AT OUTLETS
- AND DOWNSTREAM CHANNELS AND STREAM BANKS (SECTIONS 2.1.1 AND 2.2.16). 15. CONTROL SEDIMENT AS NEEDED ALONG THE SITE PERIMETER AND AT ALL OPERATIONAL INTERNAL STORM
- DRAIN INLETS AT ALL TIMES DURING CONSTRUCTION, BOTH INTERNALLY AND AT THE SITE BOUNDARY (SECTIONS 2.2.6 AND 2.2.21). 16. ESTABLISH CONCRETE TRUCK AND OTHER CONCRETE EQUIPMENT WASHOUT AREAS BEFORE BEGINNING
- CONCRETE WORK (SECTION 2.2.14). 17. APPLY TEMPORARY AND/OR PERMANENT SOIL STABILIZATION MEASURES IMMEDIATELY ON ALL DISTURBED
- AREAS AS GRADING PROGRESSES. TEMPORARY OR PERMANENT STABILIZATION MEASURES ARE NOT REQUIRED FOR AREAS THAT ARE INTENDED TO BE LEFT UNVEGETATED, SUCH AS DIRT ACCESS ROADS OR UTILITY POLE PADS (SECTIONS 2.2.20 AND 2.2.21).
- 18. ESTABLISH MATERIAL AND WASTE STORAGE AREAS, AND OTHER NON-STORMWATER CONTROLS (SECTION 19. KEEP WASTE CONTAINER LIDS CLOSED WHEN NOT IN USE AND CLOSE LIDS AT THE END OF THE BUSINESS
- DAY FOR THOSE CONTAINERS THAT ARE ACTIVELY USED THROUGHOUT THE DAY. FOR WASTE CONTAINERS THAT DO NOT HAVE LIDS, PROVIDE EITHER (1) COVER (E.G., A TARP, PLASTIC SHEETING, TEMPORARY ROOF) TO PREVENT EXPOSURE OF WASTES TO PRECIPITATION, OR (2) A SIMILARLY EFFECTIVE MEANS DESIGNATED TO PREVENT THE DISCHARGE OF POLLUTANTS (E.G., SECONDARY CONTAMINANT) (SECTION 2.3.7).
- 20. PREVENT TRACKING OF SEDIMENT ONTO PUBLIC OR PRIVATE ROADS USING BMPS SUCH AS: CONSTRUCTION ETRANCE, GRAVELED (OR PAVED) EXITS AND PARKING AREAS, GRAVEL ALL UNPAVED ROADS LOCATED ONSITE, OR USE AN EXIT TIRE WASH. THESE BMPS MUST BE IN PLACE PRIOR TO LAND-DISTURBING ACTIVITIES (SECTION 2.2.7).
- 21. WHEN TRUCKING SATURATED SOILS FROM THE SITE, EITHER USE WATER-TIGHT TRUCKS OR DRAIN LOADS ON SITE (SECTION 2.2.7.F).
- 22. CONTROL PROHIBITED DISCHARGES FROM LEAVING THE CONSTRUCTION SITE, I.E., CONCRETE WASH-OUT WASTEWATER FROM CLEANOUT OF STUCCO, PAINT AND CURING COMPOUNDS (SECTIONS 1.5 AND 2.3.9).
- 23. ENSURE THAT STEEP SLOPE AREAS WHERE CONSTRUCTION ACTIVITIES ARE NOT OCCURRING ARE NOT **DISTURBED (SECTION 2.2.10)**
- 24. PREVENT SOIL COMPACTION IN AREAS WHERE POST-CONSTRUCTION INFILTRATION FACILITIES AREA TO BE INSTALLED (SECTION 2.2.12).
- 25. USE BMPS TO PREVENT OR MINIMIZE STORMWATER EXPOSURE TO POLLUTANTS FROM SPILLS; VEHICLE AND EQUIPMENT FUELING, MAINTENANCE, AND STORAGE; OTHER CLEANING AND MAINTENANCE ACTIVITIES; AND WASTE HANDLING ACTIVITIES. THESE POLLUTANTS INCLUDE FUEL, HYDRAULIC FLUID, AND OTHER OILS FROM VEHICLES AND MACHINERY, AS WELL AS DEBRIS, FERTILIZER, PESTICIDES AND HERBICIDES, PAINTS, SOLVENTS, CURING COMPOUNDS AND ADHESIVES FROM CONSTRUCTION OPERATIONS (SECTIONS 2.2.15 AND 2 3)
- 26. PROVIDE PLANS FOR SEDIMENTATION BASINS THAT HAVE BEEN DESIGNED PER SECTION 2.2.17 AND AMPED BY AN OREGON PROFESSIONAL ENGINEER (SECTION 2.2.17.A)
- 27. IF ENGINEERED SOILS ARE USED ON SITE, A SEDIMENTATION BASIN/IMPOUNDMENT MUST BE INSTALLED (SECTIONS 2.2.17 AND 2.2.18).
- 28. PROVIDE A DEWATERING PLAN FOR ACCUMULATED WATER FROM PRECIPITATION AND UNCONTAMINATED GROUNDWATER SEEPAGE DUE TO SHALLOW EXCAVATION ACTIVITIES (SECTION 2.4).
- 29. IMPLEMENT THE FOLLOWING BMPS WHEN APPLICABLE: WRITTEN SPILL PREVENTION AND RESPONSE PROCEDURES, SPILL KITS IN ALL VEHICLES, REGULAR MAINTENANCE SCHEDULE FOR VEHICLES AND MACHINERY, MATERIAL DELIVERY AND STORAGE CONTROLS, TRAINING AND SIGNAGE, AND COVERED STORAGE AREAS FOR WASTE AND SUPPLIES (SECTION 2.3)
- 30. USE WATER, SOIL-BINDING AGENT OR OTHER DUST CONTROL TECHNIQUE AS NEEDED TO AVOID WIND-BLOWN SOIL (SECTION 2.2.9).
- 31. THE APPLICATION RATE OF FERTILIZERS USED TO REESTABLISH VEGETATION MUST FOLLOW MANUFACTURER'S RECOMMENDATIONS TO MINIMIZE NUTRIENT RELEASES TO SURFACE WATERS. EXERCISE CAUTION WHEN USING TIME-RELEASE FERTILIZERS WITHIN ANY WATERWAY RIPARIAN ZONE (SECTION 2.3.5).
- 32. IF AN ACTIVE TREATMENT SYSTEM (FOR EXAMPLE, ELECTRO-COAGULATION, FLOCCULATION, FILTRATION, ETC) FOR SEDIMENT OR OTHER POLLUTANT REMOVAL IS EMPLOYED. SUBMIT AN OPERATION AND MAINTENANCE PLAN (INCLUDING SYSTEM SCHEMATIC, LOCATION OF SYSTEM, LOCATION OF INLET, LOCATION OF DISCHARGE, DISCHARGE DISPERSION DEVICE DESIGN, AND A SAMPLING PLAN AND FREQUENCY) BEFORE OPERATING THE TREATMENT SYSTEM. OBTAIN ENVIRONMENTAL MANAGEMENT PLAN APPROVAL FROM DEQ BEFORE OPERATING THE TREATMENT SYSTEM. OPERATE AND MAINTAIN THE TREATMENT SYSTEM ACCORDING TO MANUFACTURER'S SPECIFICATIONS (SECTION 1.2.9).
- 33. TEMPORARILY STABILIZE SOILS AT THE END OF THE SHIFT BEFORE HOLIDAYS AND WEEKENDS. IF NEEDED. THE REGISTRANT IS RESPONSIBLE FOR ENSURING THAT SOILS ARE STABLE DURING RAIN EVENTS AT ALL TIMES OF THE YEAR (SECTION 2.2).
- 34. AS NEEDED BASED ON WEATHER CONDITIONS, AT THE END OF EACH WORKDAY SOIL STOCKPILES MUST BE STABILIZED OR COVERED, OR OTHER BMPS MUST BE IMPLEMENTED TO PREVENT DISCHARGES TO SURFACE WATERS OR CONVEYANCE SYSTEMS LEADING TO SURFACE WATERS (SECTION 2.2.8).
- 35. SEDIMENT FENCE: REMOVE TRAPPED SEDIMENT BEFORE IT REACHES ONE THIRD THE ABOVE GROUND FENCE HEIGHT AND BEFORE FENCE REMOVAL (SECTION 2.1.5.B). 36. OTHER SEDIMENT BARRIERS (SUCH AS BIOBAGS): REMOVE SEDIMENT BEFORE IT REACHES TWO INCHES
- DEPTH ABOVE GROUND HEIGHT AND BEFORE BMP REMOVAL (SECTION 2.1.5.C). 37. CATCH BASINS: CLEAN BEFORE RETENTION CAPACITY HAS BEEN REDUCED BY FIFTY PERCENT. SEDIMENT
- BASINS AND SEDIMENT TRAPS: REMOVE SEDIMENT BEFORE DESIGN CAPACITY HAS BEEN REDUCED BY FIFTY PERCENT AND AT COMPLETION OF PROJECT (SECTION 2.1.5.D). 38. WITHIN 24 HOURS, SIGNIFICANT SEDIMENT THAT HAS LEFT THE CONSTRUCTION SITE, MUST BE REMEDIATED.
- INVESTIGATE THE CAUSE OF THE SEDIMENT RELEASE AND IMPLEMENT STEPS TO PREVENT A RECURRENCE OF THE DISCHARGE WITHIN THE SAME 24 HOURS. ANY IN-STREAM CLEAN-UP OF SEDIMENT SHALL BE PERFORMED ACCORDING TO THE OREGON DEPARTMENT OF STATE LANDS REQUIRED TIMEFRAME (SECTION 2.2.19.A)
- 39. THE INTENTIONAL WASHING OF SEDIMENT INTO STORM SEWERS OR DRAINAGE WAYS MUST NOT OCCUR. VACUUMING OR DRY SWEEPING AND MATERIAL PICKUP MUST BE USED TO CLEANUP RELEASED SEDIMENTS. 40. DOCUMENT ANY PORTION(S) OF THE SITE WHERE LAND DISTURBING ACTIVITIES HAVE PERMANENTLY
- CEASED OR WILL BE TEMPORARILIY INACTIVE FOR 14 OR MORE CALENDAR DAYS (SECTION 6.5.F). 41. PROVIDE TEMPORARY STABILIZATION FOR THAT PORTION OF THE SITE WHERE CONSTRUCTION ACTIVITIES CEASE FOR 14 DAYS OR MORE WITH A COVERING OF BLOWN STRAW AND TACKIFIER, LOOSE STRAW, OR AN ADEQUATE COVERING OF COMPOST MULCH UNTIL WORK RESUMES ON THAT PORTION OF THE SITE (SECTION 2.2.20).
- 42. DO NOT REMOVE TEMPORARY SEDIMENT CONTROL PRACTICES UNTIL PERMANENT VEGETATION OR OTHER COVER OF EXPOSED AREAS IS ESTABLISHED. ONCE CONSTRUCTION IS COMPLETE AND THE SITE IS STABILIZED, ALL TEMPORARY EROSION CONTROLS ARE REMOVED AND DISPOSED OF PROPERLY, UNLESS NEEDED FOR LONG TERM USE FOLLOWING TERMINATION OF PERMIT COVERAGE (SECTION 2.2.21).

PROJECT TEAM

OWNER / APPLICANT WILSONVILLE PARKS AND RECREATION 29600 SW PARK PLACE WILSONVILLE, OR 97070 CONTACT: KRIS AMMERMAN PHONE: (503) 570-1579 EMAIL: kammerman@ci.wilsonville.or.us

LANDSCAPE ARCHITECT

MAYER/REED INC. 319 SW WASHINGTON STREET, SUITE 820 PORTLAND, OR 97204 CONTACT: ANNE SAMUEL PHONE: (503) 223-5953 EMAIL: anne@mayerreed.com

LAND SURVEYOR

COMPASS LAND SURVEYORS 4107 SE INTERNATIONAL WAY, SUITE 705 MILWAUKIE, OR 97222 CONTACT: JOSEPH MCALLISTER, PLS PHONE: (503) 496-1489 EMAIL: joem@compass-landsurveyors.com

CIVIL ENGINEER

3J CONSULTING INC. 9600 SW NIMBUS DRIVE, SUITE 100 BEAVERTON, OR 97008 CONTACT: JOSH GILCHRIST PHONE: (503) 946-9365 x215 EMAIL: josh.gilchrist@3j-consulting.com


CONTRACTOR

NAME: TBD ADDRESS: TBD ADDRESS: TBD ADDRESS: TBD CONTACT: TBD PHONE: TBD EMAIL: TBD

BMP MATRIX FOR CONSTRUCTION PHASE

| YEAR | | | 2025 | | |
|---|----------|----------------|-------------------------|--------------------------|------------------------|
| PHASE /BMP | CLEARING | MASS GRADING | UTILITY CONSTRUCTION | VERTICAL CONSTRUCTION | FINAL STABILIZATION |
| | | EROSION PREV | ENTION | | |
| GROUND COVER | | X | x | X | |
| PLASTIC SHEETING | | Х | Х | | |
| DUST CONTROL | Х | | | | |
| TEMPORARY STABILIZATION (STRAW MULCH) | | | х | х | |
| PERMANENT STABILIZATION | | | | Х | Х |
| BUFFER ZONE (FROM RAVINE) | | | | | |
| | | SEDIMENT COI | NTROL | | |
| SEDIMENT FENCE (PERIMETER) | х | x | х | х | |
| SEDIMENT FENCE (INTERIOR) | Х | х | Х | | |
| STRAW WATTLES | Х | Х | Х | Х | |
| INLET PROTECTION | Х | Х | Х | Х | |
| DEWATERING | | | | | |
| | | RUN OFF CON | ITROL | | |
| CONSTRUCTION ENTRANCE | Х | x | х | | |
| EXISTING OUTLET PROTECTION | Х | x | Х | Х | Х |
| NEW OUTLET PROTECTION | | | | | |
| EXISTING CURB INLET CHECK DAMS | | | | | |
| | | POLLUTION PREY | VENTION | | |
| HAZARDOUS WASTE MANAGEMENT | Х | x | х | Х | |
| SPILL KIT ONSITE | | | | | |
| CONCRETE WASHOUT | | | | | |

Ø

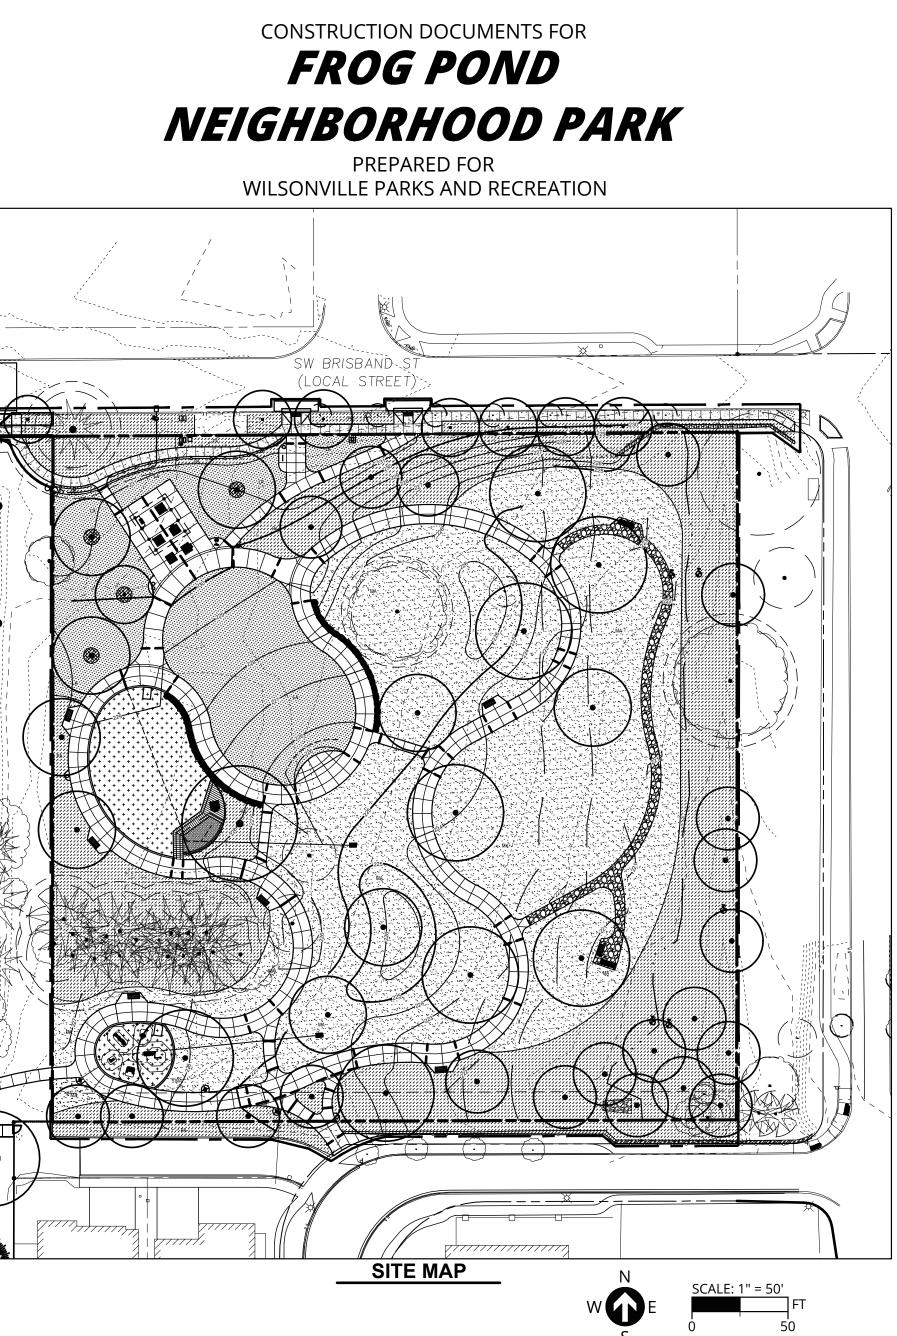

EROSION AND SEDIMENT CONTROL PLANS SHEET INDEX

| Sheet Number | Sheet Title |
|-----------------|---|
| C1.20 | EROSION AND SEDIMENT CONTROL PLAN COVER |
| C1.30 | EXISTING CONDITIONS AND DEMOLITION ESCP |
| C1.40 | MASS GRADING AND UTILITY CONSTRUCTION ESCP |
| C1.50 | VERTICAL CONSTRUCTION ESCP |
| C1.60 | FINAL STABILIZATION ESCP |
| C1.70 | EROSION AND SEDIMENT CONTROL DETAILS |

WORK HOURS

| | | - |
|-----------|-----------|---|
| MONDAY | 7AM - 8PM | Í |
| TUESDAY | 7AM - 8PM | |
| WEDNESDAY | 7AM - 8PM | |
| THURSDAY | 7AM - 8PM | |
| FRIDAY | 7AM - 8PM | |
| SATURDAY | 7AM - 8PM | |
| SUNDAY | -NO WORK- | |
| | | • |

PROJECT SCHEDULE

| UTILITY CONSTRUCTION | MARCH 2025 |
|--|------------------------------|
| MASS GRADING | JANUARY 2025 - MARCH 2025 |
| FINAL STABILIZATION | MAY 2025 - JUNE 2025 |
| REMOVAL OF TEMPORARY FACILITIES AND POLLUTANT GENERATING ACTIVITIES | AUGUST 2025 |
| | |

POLLUTANT GENERATING **ACTIVITIES:**

- VEHICLE/CONSTRUCTION EQUIPMENT **OPERATION. POLLUTANTS MAY INCLUDE:** FUEL, OIL, HYDRAULIC FLUID
- PETROLEUM PRODUCT STORAGE/DISPENSING, POLLUTANTS MAY
- INCLUDE: PETROLEUM, SOLVENTS EXCAVATION AND TUNNELING.
- POLLUTANTS MAY INCLUDE: SEDIMENT, CONTAMINATED SUBSTRATES, DEWATERING SPOILS WASTE
- CONCRETE AND GROUT POLLUTANTS MAY INCLUDE: PROCESS WATER, SLURRY

CEMENT AMENDED SOILS:

CEMENT AMENDED SOILS WILL NOT BE UTILIZED OR AUTHORIZED ON THIS PROJECT

AUTHORIZED NON-STORMWATER DISCHARGES EXPECTED

WATER AND ASSOCIATED DISCHARGES FROM EMERGENCY FIREFIGHTING ACTIVITIES;


- FIRE HYDRANT FLUSHING;
- PROPERLY MANAGED LANDSCAPE IRRIGATION;
- WATER USED TO WASH EQUIPMENT VEHICLES (EXCLUDING THE ENGINE, UNDERCARRIAGE, AND WHEELS/TIRES) PROVIDED THERE IS NO DISCHARGE OF SOAPS, SOLVENTS, OR DETERGENTS USED:
- WATER USED TO CONTROL DUST;
- POTABLE WATER INCLUDING UNCONTAMINATED WATER LINE FLUSHINGS; • EXTERNAL BUILDING WASHDOWN, PROVIDED SOAPS, SOLVENTS, AND DETERGENTS
- ARE NOT USED, AND EXTERNAL SURFACES DO NOT CONTAIN HAZARDOUS SUBSTANCES; • PAVEMENT WASH WATERS, PROVIDED SPILLS OR LEAKS OF TOXIC OR HAZARDOUS
- SUBSTANCES HAVE NOT OCCURRED (UNLESS ALL SPILL MATERIAL HAS BEEN REMOVED) AND WHERE SOAPS, SOLVENTS, AND DETERGENTS ARE NOT USED. DIRECTING PAVEMENT WASH WATERS INTO ANY SURFACE WATER, STORM DRAIN INLET, OR STORMWATER CONVEYANCE IS PROHIBITED, UNLESS THE CONVEYANCE IS CONNECTED TO A SEDIMENT BASIN, SEDIMENT TRAP, OR SIMILARLY EFFECTIVE CONTROL FOR THE POLLUTANTS PRESENT. PER 2.2.19.B, HOSING OF ACCUMULATED SEDIMENTS ON PAVEMENT INTO ANY STORMWATER CONVEYANCE IS PROHIBITED; UNCONTAMINATED AIR CONDITIONING OR COMPRESSOR CONDENSATE;
- UNCONTAMINATED, NON-TURBID DISCHARGES OF GROUNDWATER OR SPRING WATER; FOUNDATION OR FOOTING DRAINS WHERE FLOWS ARE NOT CONTAMINATED WITH
- PROCESS MATERIALS SUCH AS SOLVENTS OR CONTAMINATED GROUNDWATER; AND CONSTRUCTION DEWATERING ACTIVITIES (INCLUDING GROUNDWATER DEWATERING AND WELL DRILLING DISCHARGE ASSOCIATED WITH THE REGISTERED CONSTRUCTION ACTIVITY), PROVIDED THAT:
- THE WATER IS LAND APPLIED IN A WAY THAT RESULTS IN COMPLETE INFILTRATION WITH NO POTENTIAL TO DISCHARGE TO A SURFACE WATER OF THE STATE, OR THE USE OF A SANITARY OR COMBINED SEWER DISCHARGE IS AUTHORIZED WITH LOCAL SEWER DISTRICT APPROVAL; OR
- BEST MANAGEMENT PRACTICES AND A TREATMENT SYSTEM APPROVED BY DEQ OR AGENT (SEE SECTION 1.2.9) ARE USED TO ENSURE COMPLIANCE WITH DISCHARGE AND WATER QUALITY REQUIREMENTS IN SECTION 2.4.

REQUIRED INSPECTION FREQUENCY

SITE CONDITION 1. ACTIVE PERIOD

INACTIVE PERIODS GREAT FOURTEEN (14) CONSECU CALENDAR DAYS.

- . PERIODS DURING WHICH INACCESSIBLE DUE TO INC WEATHER.
- CONSTRUCTION ACTIVITIE SUSPENDED AND RUNOFF UNLIKELY DUE TO FROZEN CONDITIONS.
- . PERIODS DURING WHICH CONSTRUCTION ACTIVITIE CONDUCTED AND RUNOFF UNLIKELY DURING FROZEN CONDITIONS.
- PERIODS DURING WHICH

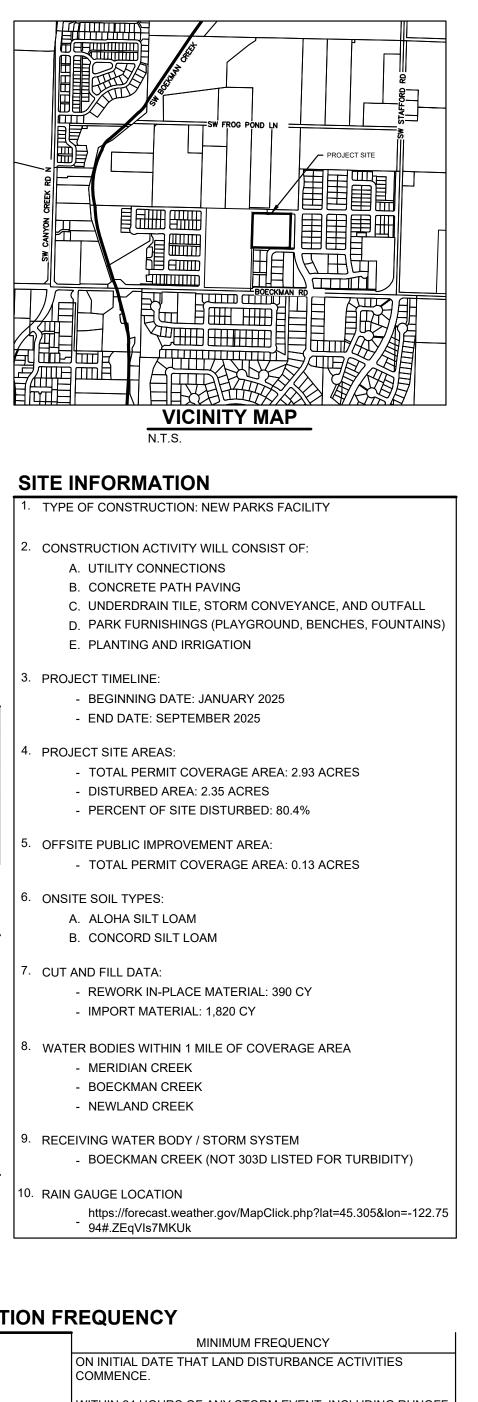



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Revisions

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Project FROG POND NEIGHBORHOOD PARK


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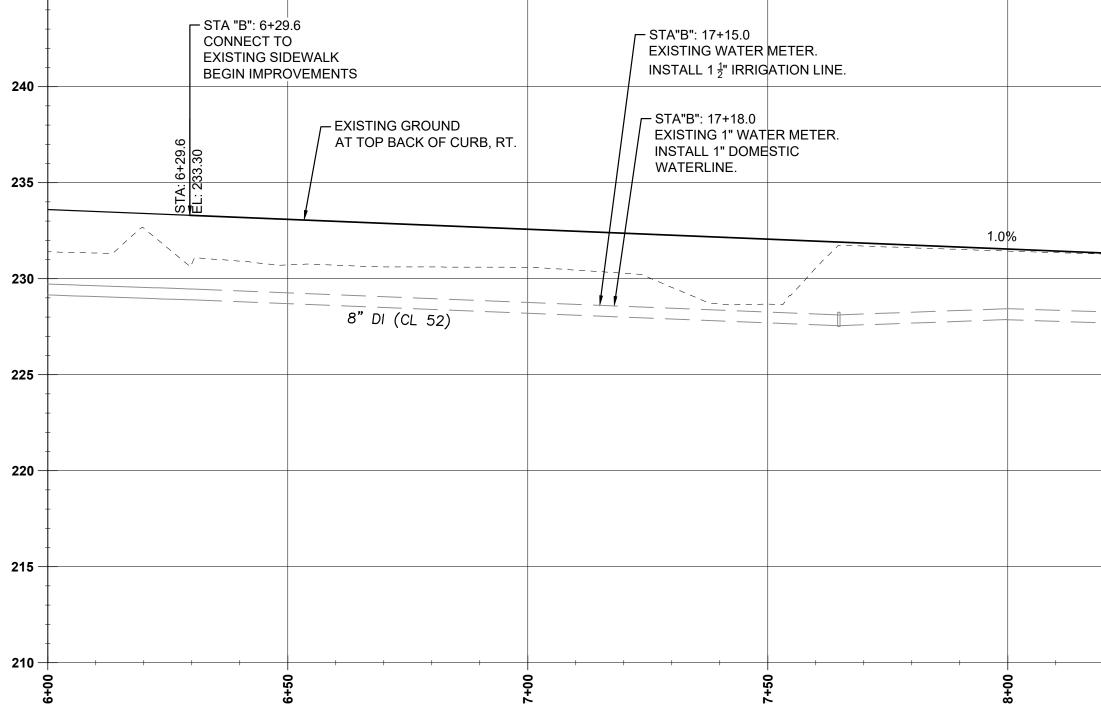
EROSION AND SEDIMENT CONTROL PLAN COVER



| N | |
|------------------------|--|
| | ON INITIAL DATE THAT LAND DISTURBANCE ACTIVITIES COMMENCE. |
| | WITHIN 24 HOURS OF ANY STORM EVENT, INCLUDING RUNOFF FROM SNOW MELT, THAT RESULTS IN DISCHARGE FROM THE SITE. |
| | AT LEAST ONCE EVERY 14 DAYS, REGARDLESS OF WHETHER STORM RUNOFF IS OCCURRING. |
| TER THAN JTIVE | THE INSPECTOR MAY REDUCE THE FREQUENCY OF INSPECTIONS IN ANY AREA OF THE SITE WHERE THE STABILIZATION STEPS IN SECTION 2.2.20 HAVE BEEN COMPLETED TO TWICE PER MONTH FOR THE FIRST MONTH, NO LESS THAN 14 CALENDAR DAYS APART, THEN ONCE PER MONTH. |
| THE SITE IS CLEMENT | IF SAFE, ACCESSIBLE AND PRACTICAL, INSPECTIONS MUST OCCUR DAILY AT A RELEVANT DISCHARGE POINT OR DOWNSTREAM LOCATION OF THE RECEIVING WATER BODY. |
| ES ARE F IS N | VISUAL MONITORING INSPECTION MAY BE TEMPORARILY SUSPENDED. IMMEDIATELY RESUME MONITORING UPON THAWING, OR WHEN WEATHER CONDITIONS MAKE DISCHARGES LIKELY. |
| ES ARE F IS N | VISUAL MONITORING INSPECTIONS MAY BE REDUCED TO ONCE A MONTH. IMMEDIATELY RESUME MONITORING UPON THAWING, OR WHEN WEATHER CONDITIONS MAKE DISCHARGES UNLIKELY. |
| | |





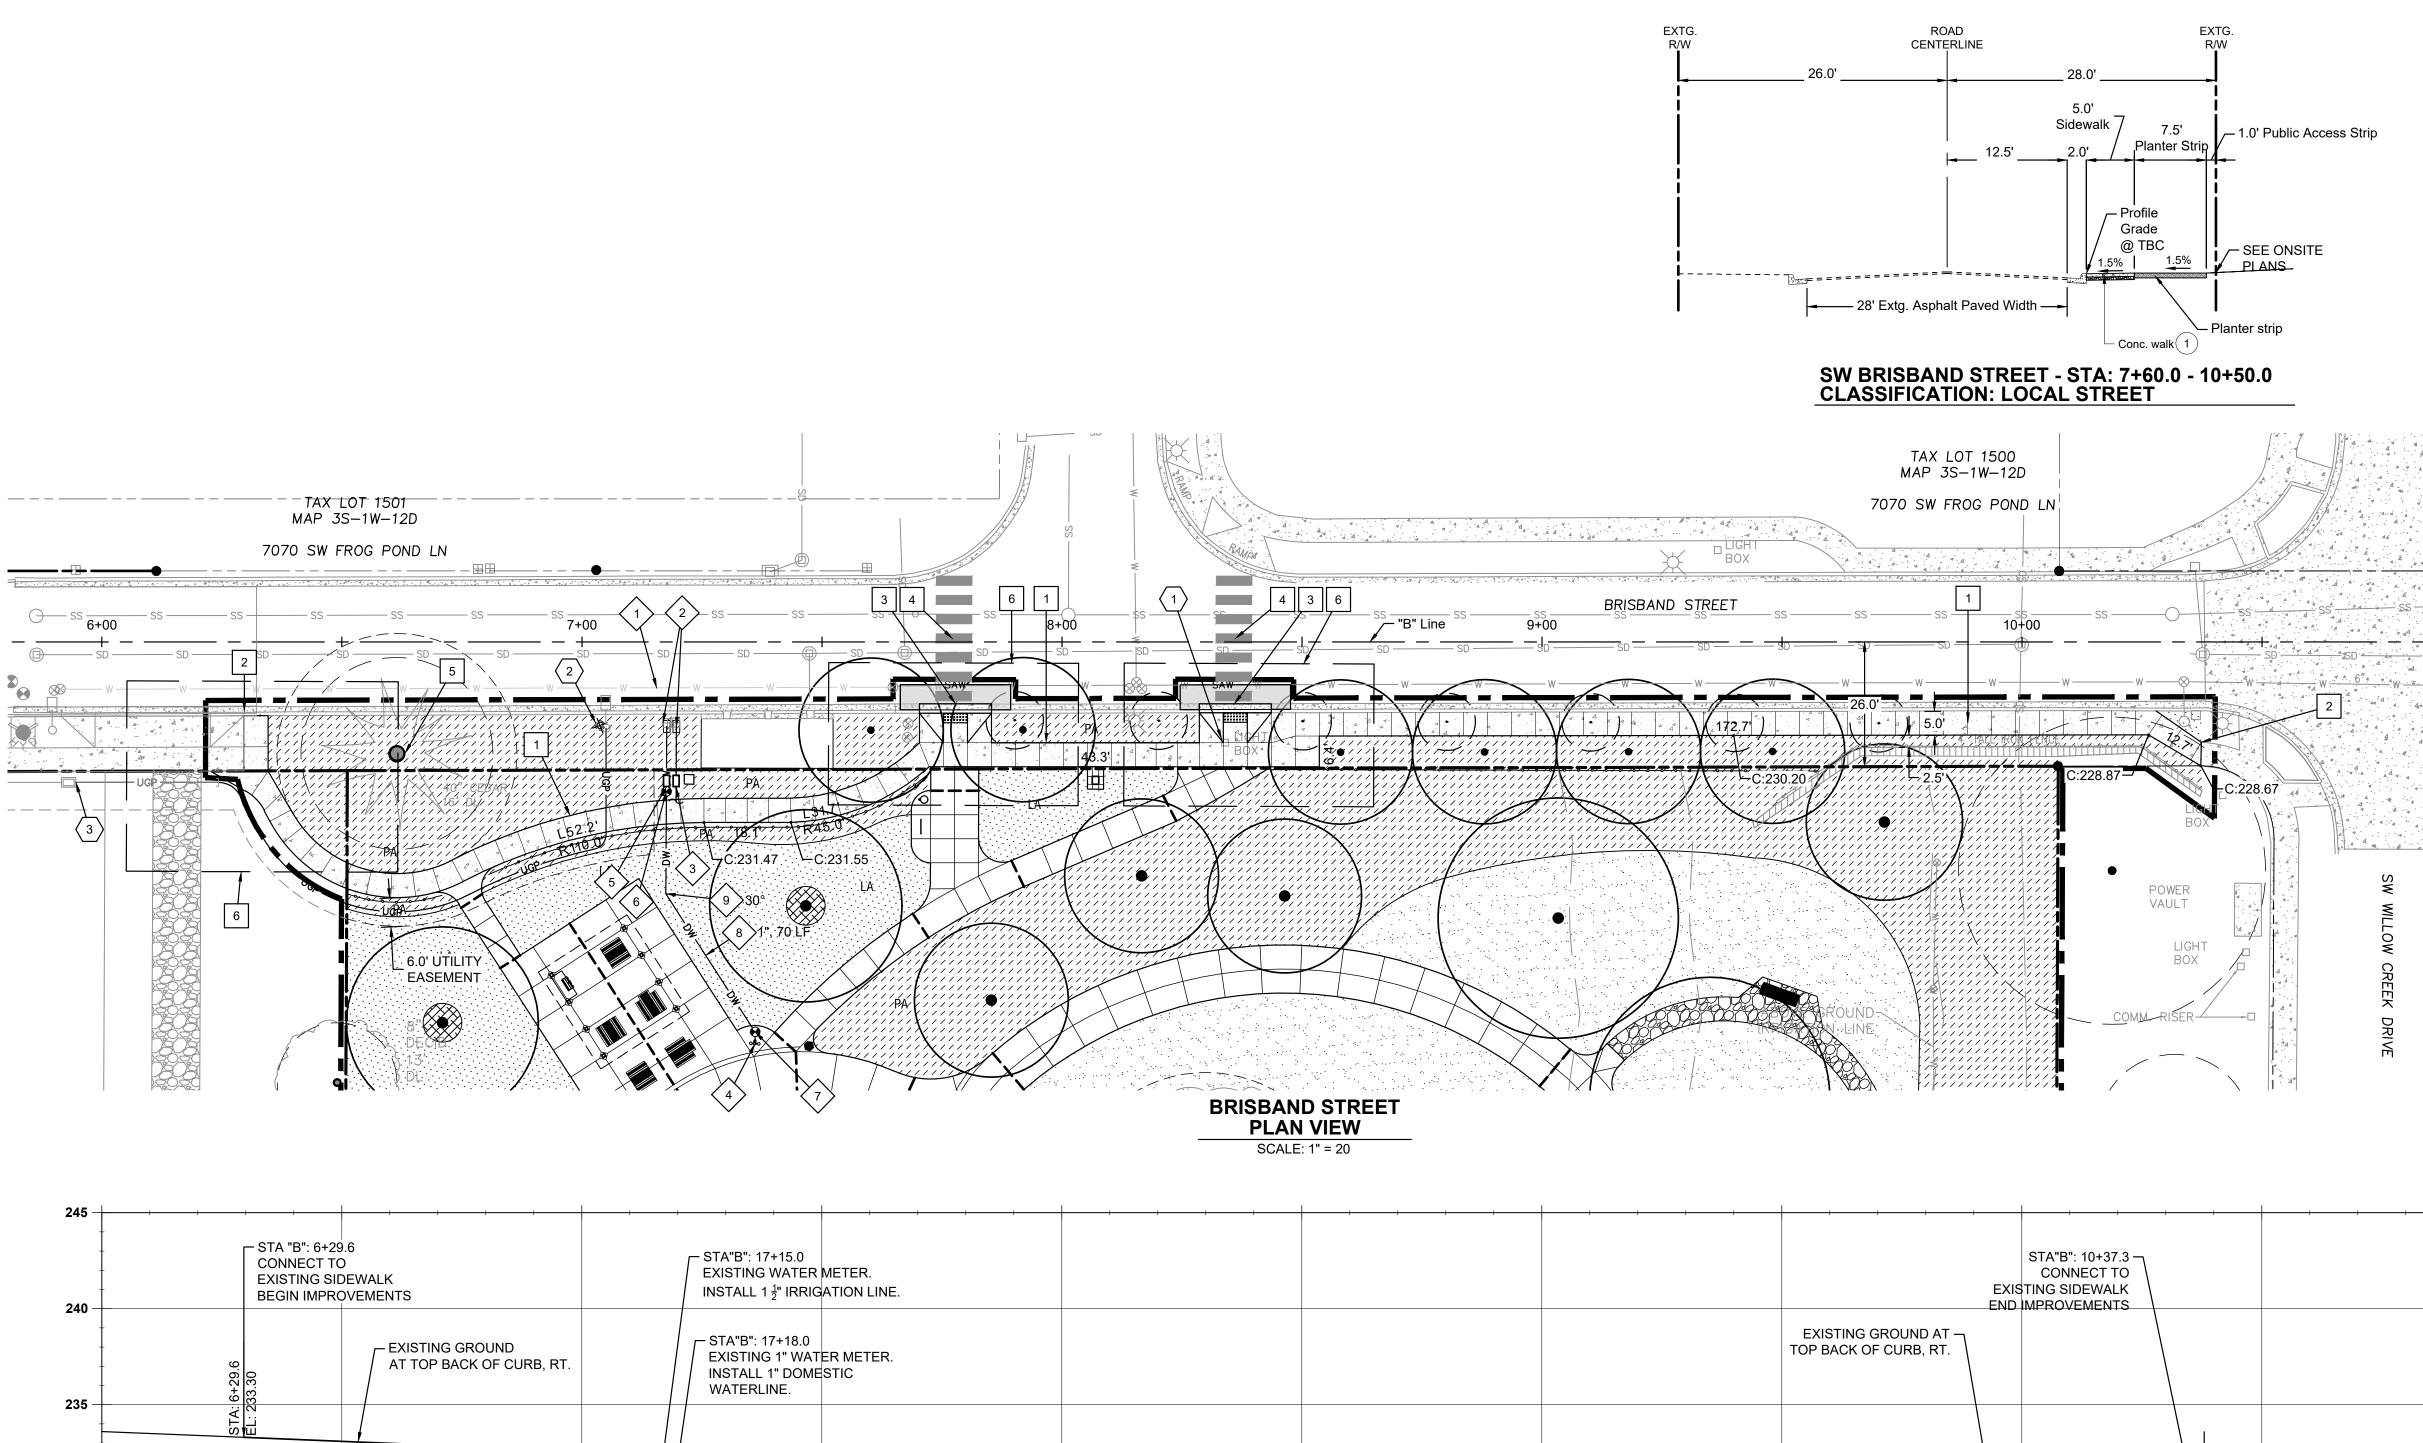

| | END | STA"B": 10+37.3 CONNECT TO STING SIDEWALK IMPROVEMENTS | |
|---------------------|-----------------------|--|--|
| | TOP BACK OF CURB, RT. | | |
| | | 87.10 1.8 1.0 1.0 1.0 1.0 1.0 1.0 1.0 1.0 1.0 1.0 | |
| | | | |
| | | | |
| | | | |
| | | | |
| · · · · · · · · | | 10+00 | |

BRISBAND STREET "B" PROFILE

HORIZ. SCALE: 1" = 20 VERT. SCALE: 1" = 5'

CONSTRUCTION KEY NOTES

| 1 | CONSTRUCT SIDEWALK PER CITY OF WILSONVILLE STD. DWG. RD-1075 ON SHEET C9.01. |
|------------|---|
| 2 | CONNECT TO EXISTING SIDEWALK. |
| 3 | CONSTRUCT PERPENDICULAR SIDEWALK RAMP PER CITY OF WILSONVILLE STD. DWGS. RD-1115 ON SHEET C9.01 USING REINFORCED CONCRETE RATED FOR VEHICLE TRAFFIC. INSTALL DETECTABLE WARNING SURFACE PER CITY OF WILSONVILLE STD. DWG. RD-1125 ON SHEET C9.01. |
| 4 | INSTALL CONTINENTAL CROSSWALK PAVEMENT MARKING PER CITY OF WILSONVILLE STD. DWG. RD-1280, 140 LF, ON SEE SHEET C9.01. |
| 5 | ARBORIST TO SUPERVISE AND DOCUMENT ROOT PRUNING OUTSIDE OF 25' RADIUS TREE PROTECTION ZONE. SEE SHEET L0.02. |
| 6 | ADA RAMP GRADING DETAILS. SEE SHEET C7.30. |
| WAT | ER SYSTEM KEY NOTES |
| | EXISTING WATER LINE. SHOWN FOR REFERENCE ONLY. |
| | EXISTING METER BOX AND LID. SHOWN FOR REFERENCE ONLY. |
| $\sqrt{3}$ | INSTALL 1" IRRIGATION DOUBLE CHECK VALVE ASSEMBLY PER CITY OF WILSONVILLE STD. DWG B-4000 ON SHEET C9.01. |
| | INSTALL MDF DRINKING FOUNTAIN MODEL 10145SM WITH PET FOUNTIAN WITH SUMP FOR DRAIN PIPE. SEE LANDSCAPING PLANS FOR DETAIL. |
| 5 | INSTALL PLUMBING-CODE APPROVED SINGLE CHECK BACKFLOW ASSEMBLY WITH ACCESSIBLE BOX ENCLOSURE AT LOCATION SHOWN. |
| | INSTALL PLUMBING-CODE APPROVED SHUT OFF VALVE. |
| | INSTALL PLUMBING-CODE APPROVED DRAIN VALVE FOR WINTERIZATION. |
| 8 | INSTALL AWWA C901 (DR7) HDPE WATER PIPE AT DIAMETER, LENGTH, AND ALIGNMENT SHOWN. PROVIDE CLASS 'B' BACKFILL PER DETAIL 1 ON SHEET C9.01. |
| 9 | INSTALL AWWA C901 (DR7) HDPE BEND [MJ] TO ANGLE AND SIZE SHOWN. |
| | |

FRANCHISE UTILITIES

- 240

- 235

- 230

225

- 220

- 215

- 210

SCALE: 1" = 20'

FT

Know what's **below**.

Call before you dig.

A 4 A

D

- RELOCATE EXISTING LIGHT BOX
- INSTALL CONDUIT AND WIRING FOR PUBLIC STREET LIGHT (150 LF). $\langle 2 \rangle$
- CONNECT WIRING FOR STREET LIGHT INTO EXISTING JUNCTION BOX. $\langle 3 \rangle$



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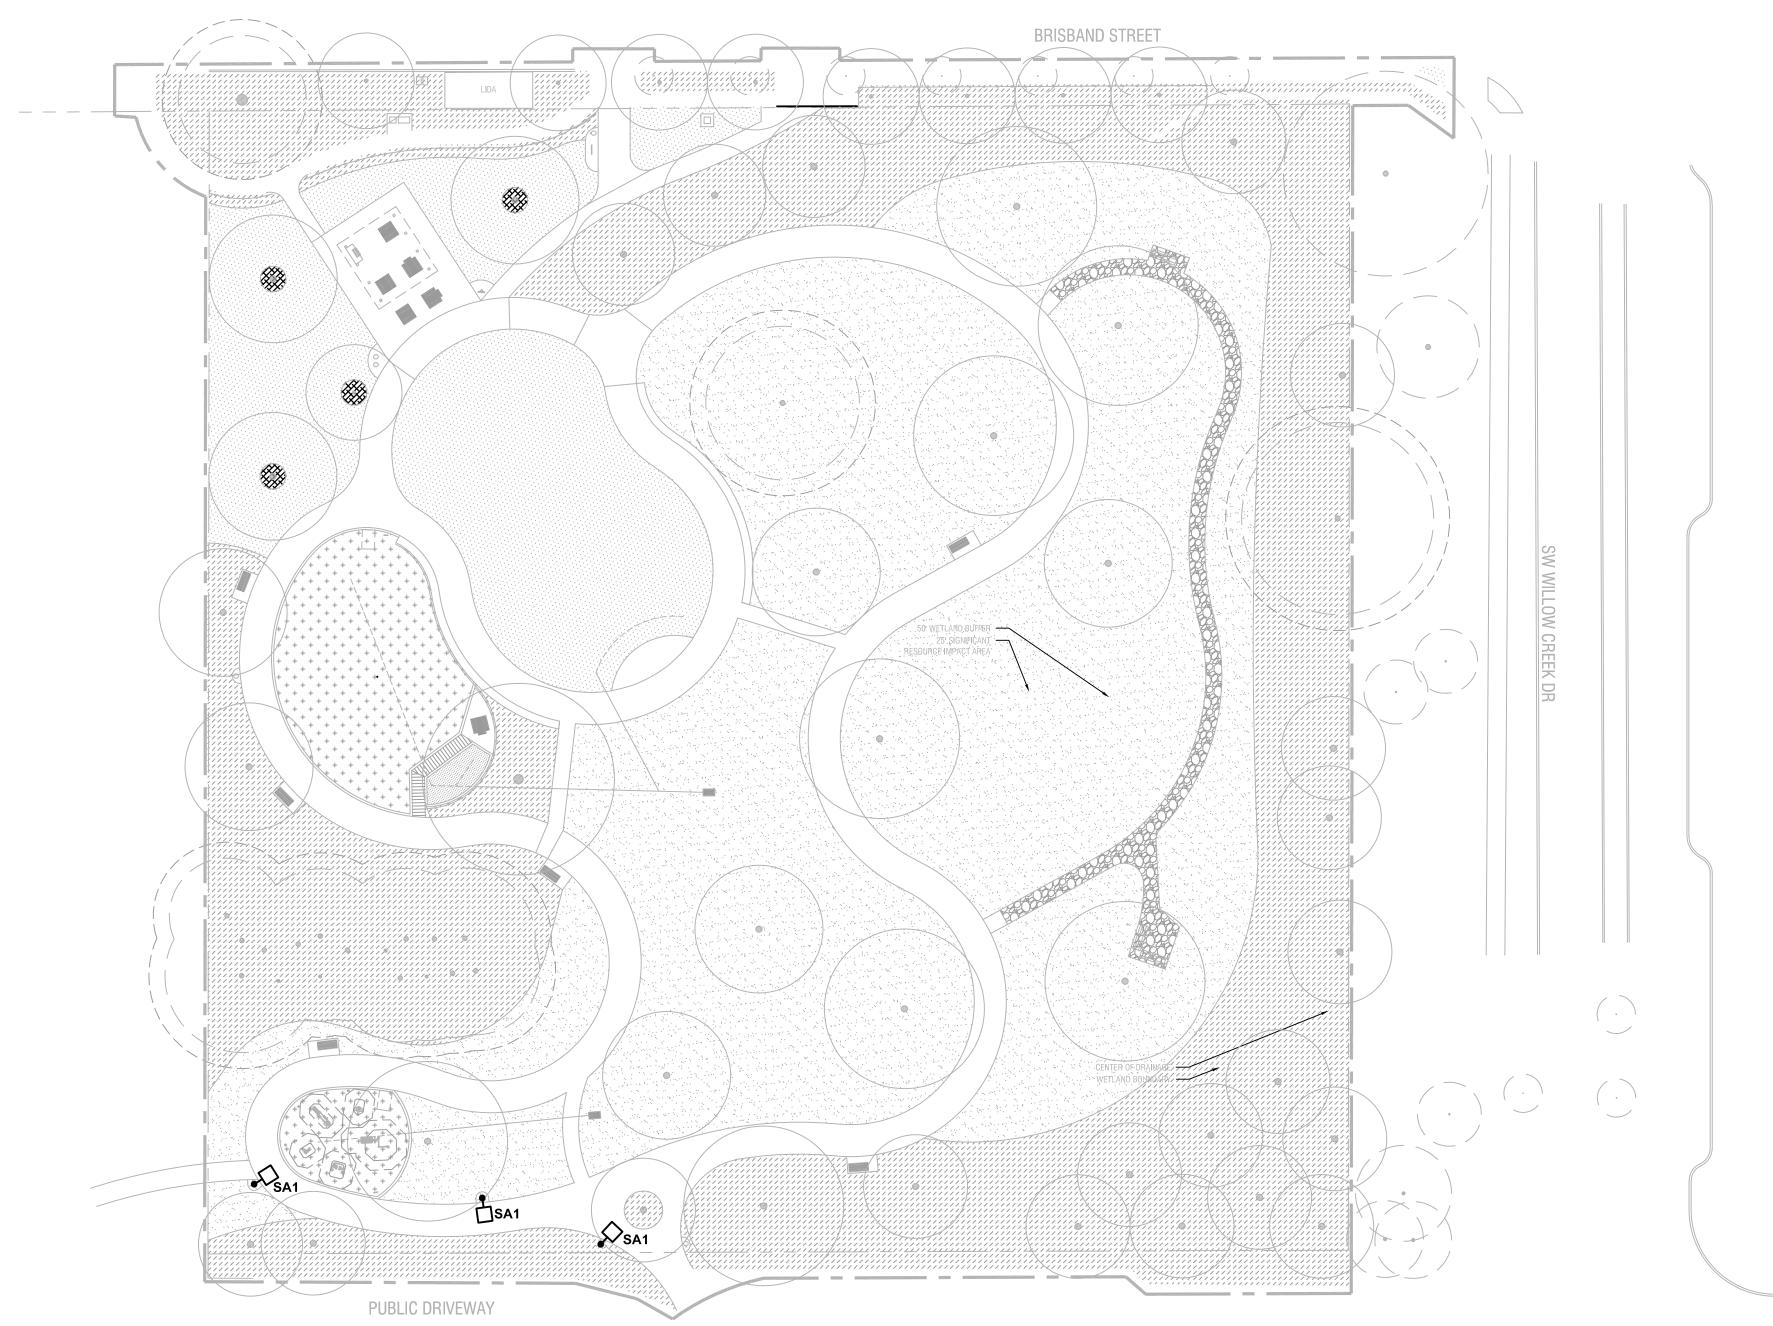
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Project FROG POND NEIGHBORHOOD PARK

Sheet Title

BRISBAND PLAN AND PROFILE





| | LUMINAIRE SCHEDULE | | | | | | |
|-----|------------------------------|------------------|---|----------------|--------|---------|--|
| ĀG | DESCRIPTION | MANUFACTURER | MODEL | CRI / CCT | LUMENS | WATTAGE | |
| SA1 | POLE MOUNTED TYPE 2 DIST. | HADCO BY SIGNIFY | CXF14-32-GE-T-'TBD'-2- 73Ø-A-'TBD'-N-SP1-N | 90 CRI / 3000K | 134/W | 35W | |

SHEET NOTES

A. NEW PARK LIGHTING SYSTEMS ARE TO BE PROVIDED WITH STAND ALONE POLE MOUNTED SOLAR AND BATTERY SYSTEMS AT EACH FIXTURE. LIGHTING SOLAR POWER SYSTEM TO BE DESIGNED AND PROVIDED BY THE LIGHTING MANUFACTURER - HADCO, AS AN ENGINEERED TO ORDER SYSTEM.


B. ALL LIGHTING SYSTEM WILL BE HAVE STAND ALONE LIGHTING CONTROLS VIA PHOTOCELL FOR ON/OFF OPERATION.

C. LIGHTING POLES AND POLE BASES SHALL BE DESIGNED FOR THE ADDITIONAL WIND AND WEIGHT LOADING ASSOCIATED WITH THE POLE MOUNTED SOLAR PANEL, CONTROLLER AND BATTERY SYSTEM BY A REGISTER STRUCTURAL ENGINEER IN COORDINATION WITH THE LIGHTING MANUFACTURER DESIGNING THE SOLAR POWER SYSTEM.

KEYED NOTES

1. BASIS OF DESIGN FOR LIGHT POLE - PEDESTRIAN POLE PER CITY OF WILSONVILLE STANDARD - 'SA1; WILSONVILLE STANDARD - 'SAI; MODEL NUMBER 'CXF14-32-GE-T-'TBD'-2-730-A-'TBD'-N-SP1-N - QUANTITIES AND LOCATIONS ARE APPROXIMATE. REFER TO SHEET E1.01 PHOTOMETRICS FOR SA1 PROPOSED LOCATIONS.

SW WEHLER WAY

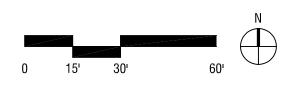

| NOTES |
|------------------------|
| 1Ø' MOUNTING HEIGHT |



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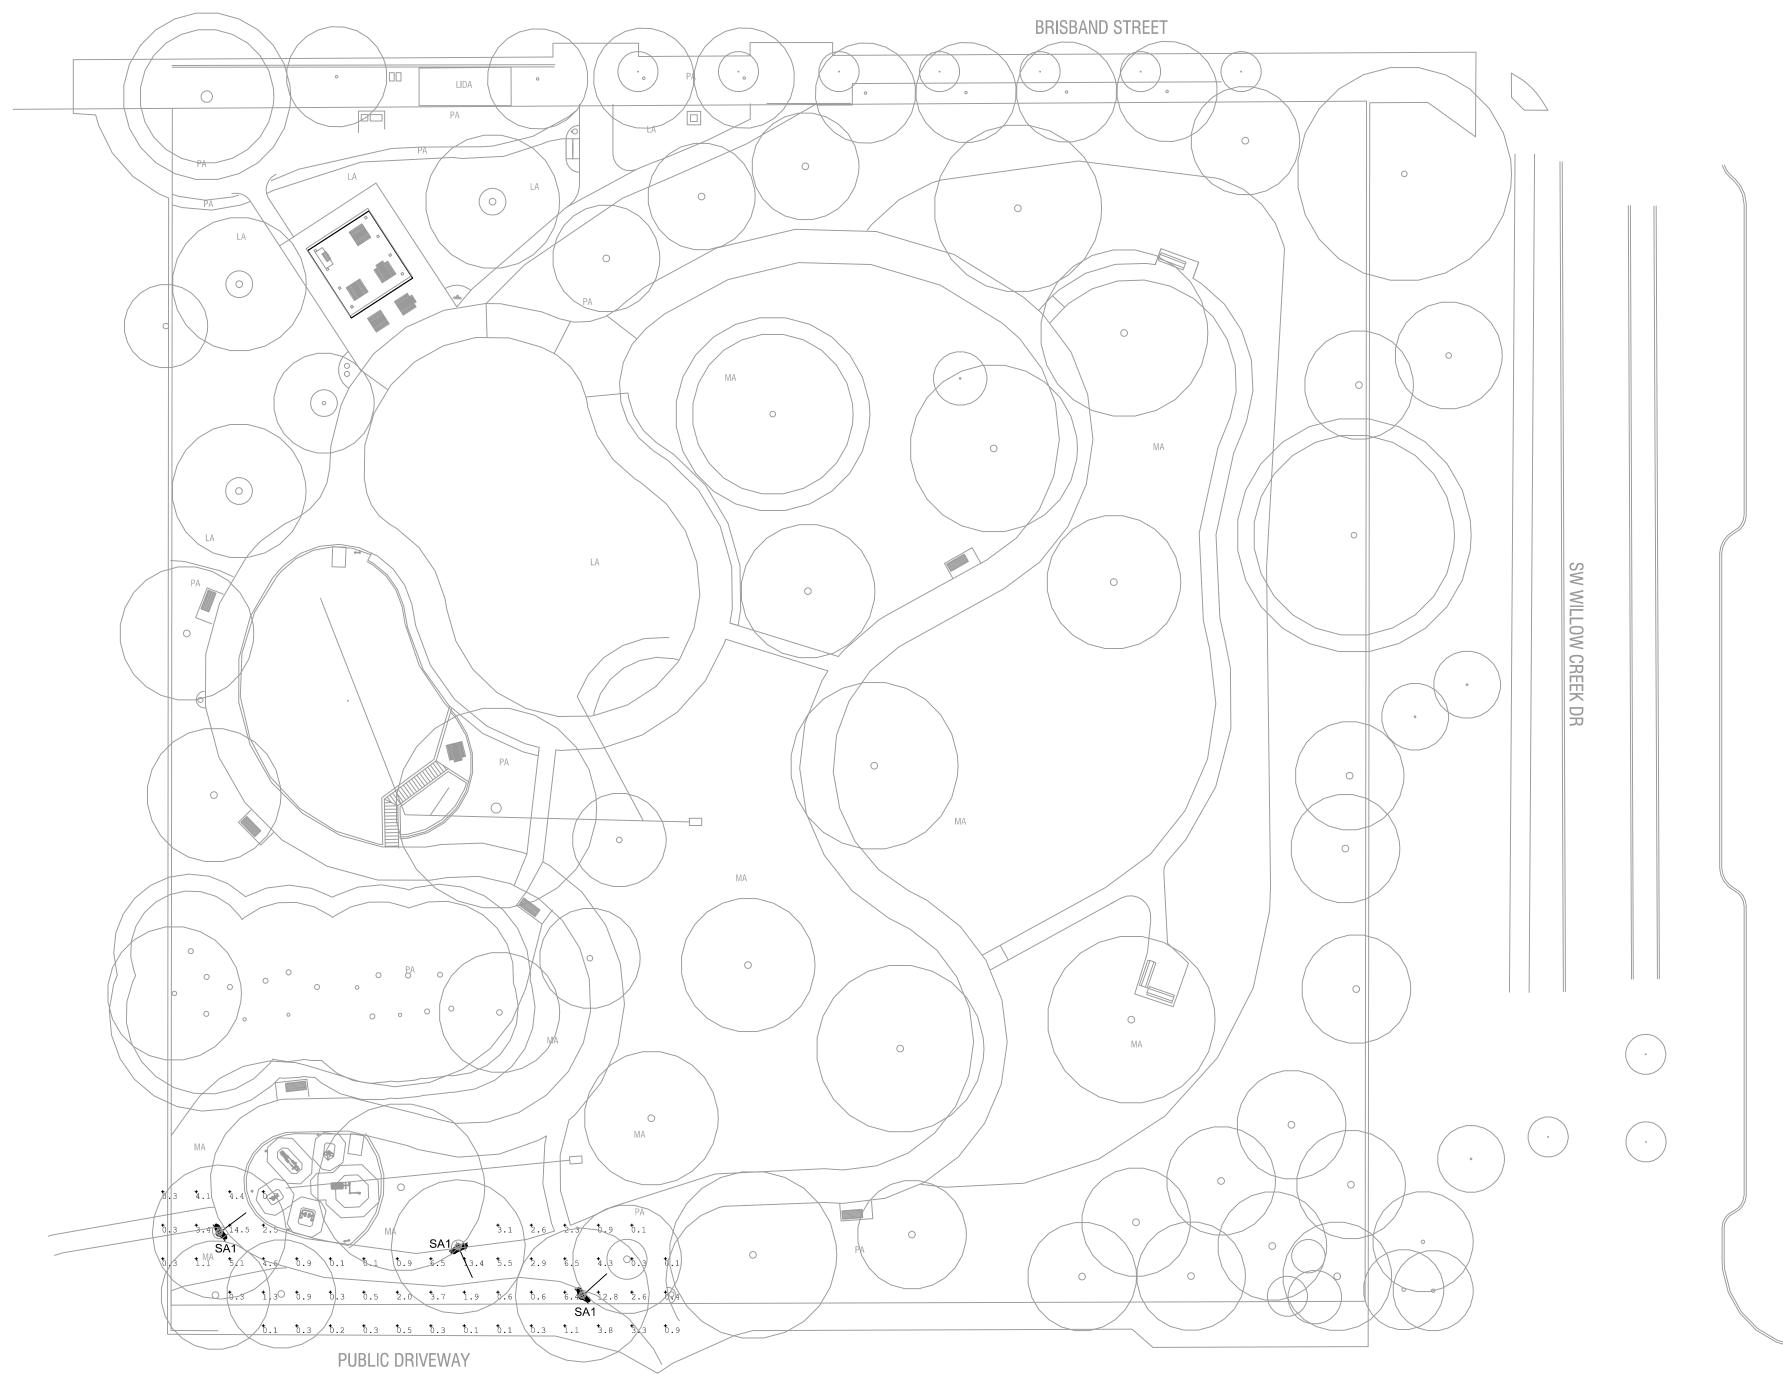
Project FROG POND

NEIGHBORHOOD PARK

E1.00

Sheet Title

LIGHTING PLAN



| Calculation Summary | | | | | | | | | |
|---------------------|-----------|-----------------------------|-------|--------|----|------|-------|---------|---------|
| Label | CalcType | e | Units | Av | /g | Max | Min | Avg/Min | Max/Min |
| CalcPts_1 | Illuminan | ce | Fc | 2.4 | 45 | 14.5 | 0.1 | 24.50 | 145.00 |
| | | | | | | | | | |
| Luminaire Scheo | dule | | | | | | | | |
| Symbol | Qty | Qty Tag Luminaire LLF Total | | | | | | Total | |
| | | | | Lumens | W | atts | | Watts | |
| \odot | 3 | SA1 | | 4715 | 35 | 5.2 | 1.000 | 105.6 | |

SW WEHLER WAY





A. PHOTOMETRICS PROVIDED FOR Landuse review.



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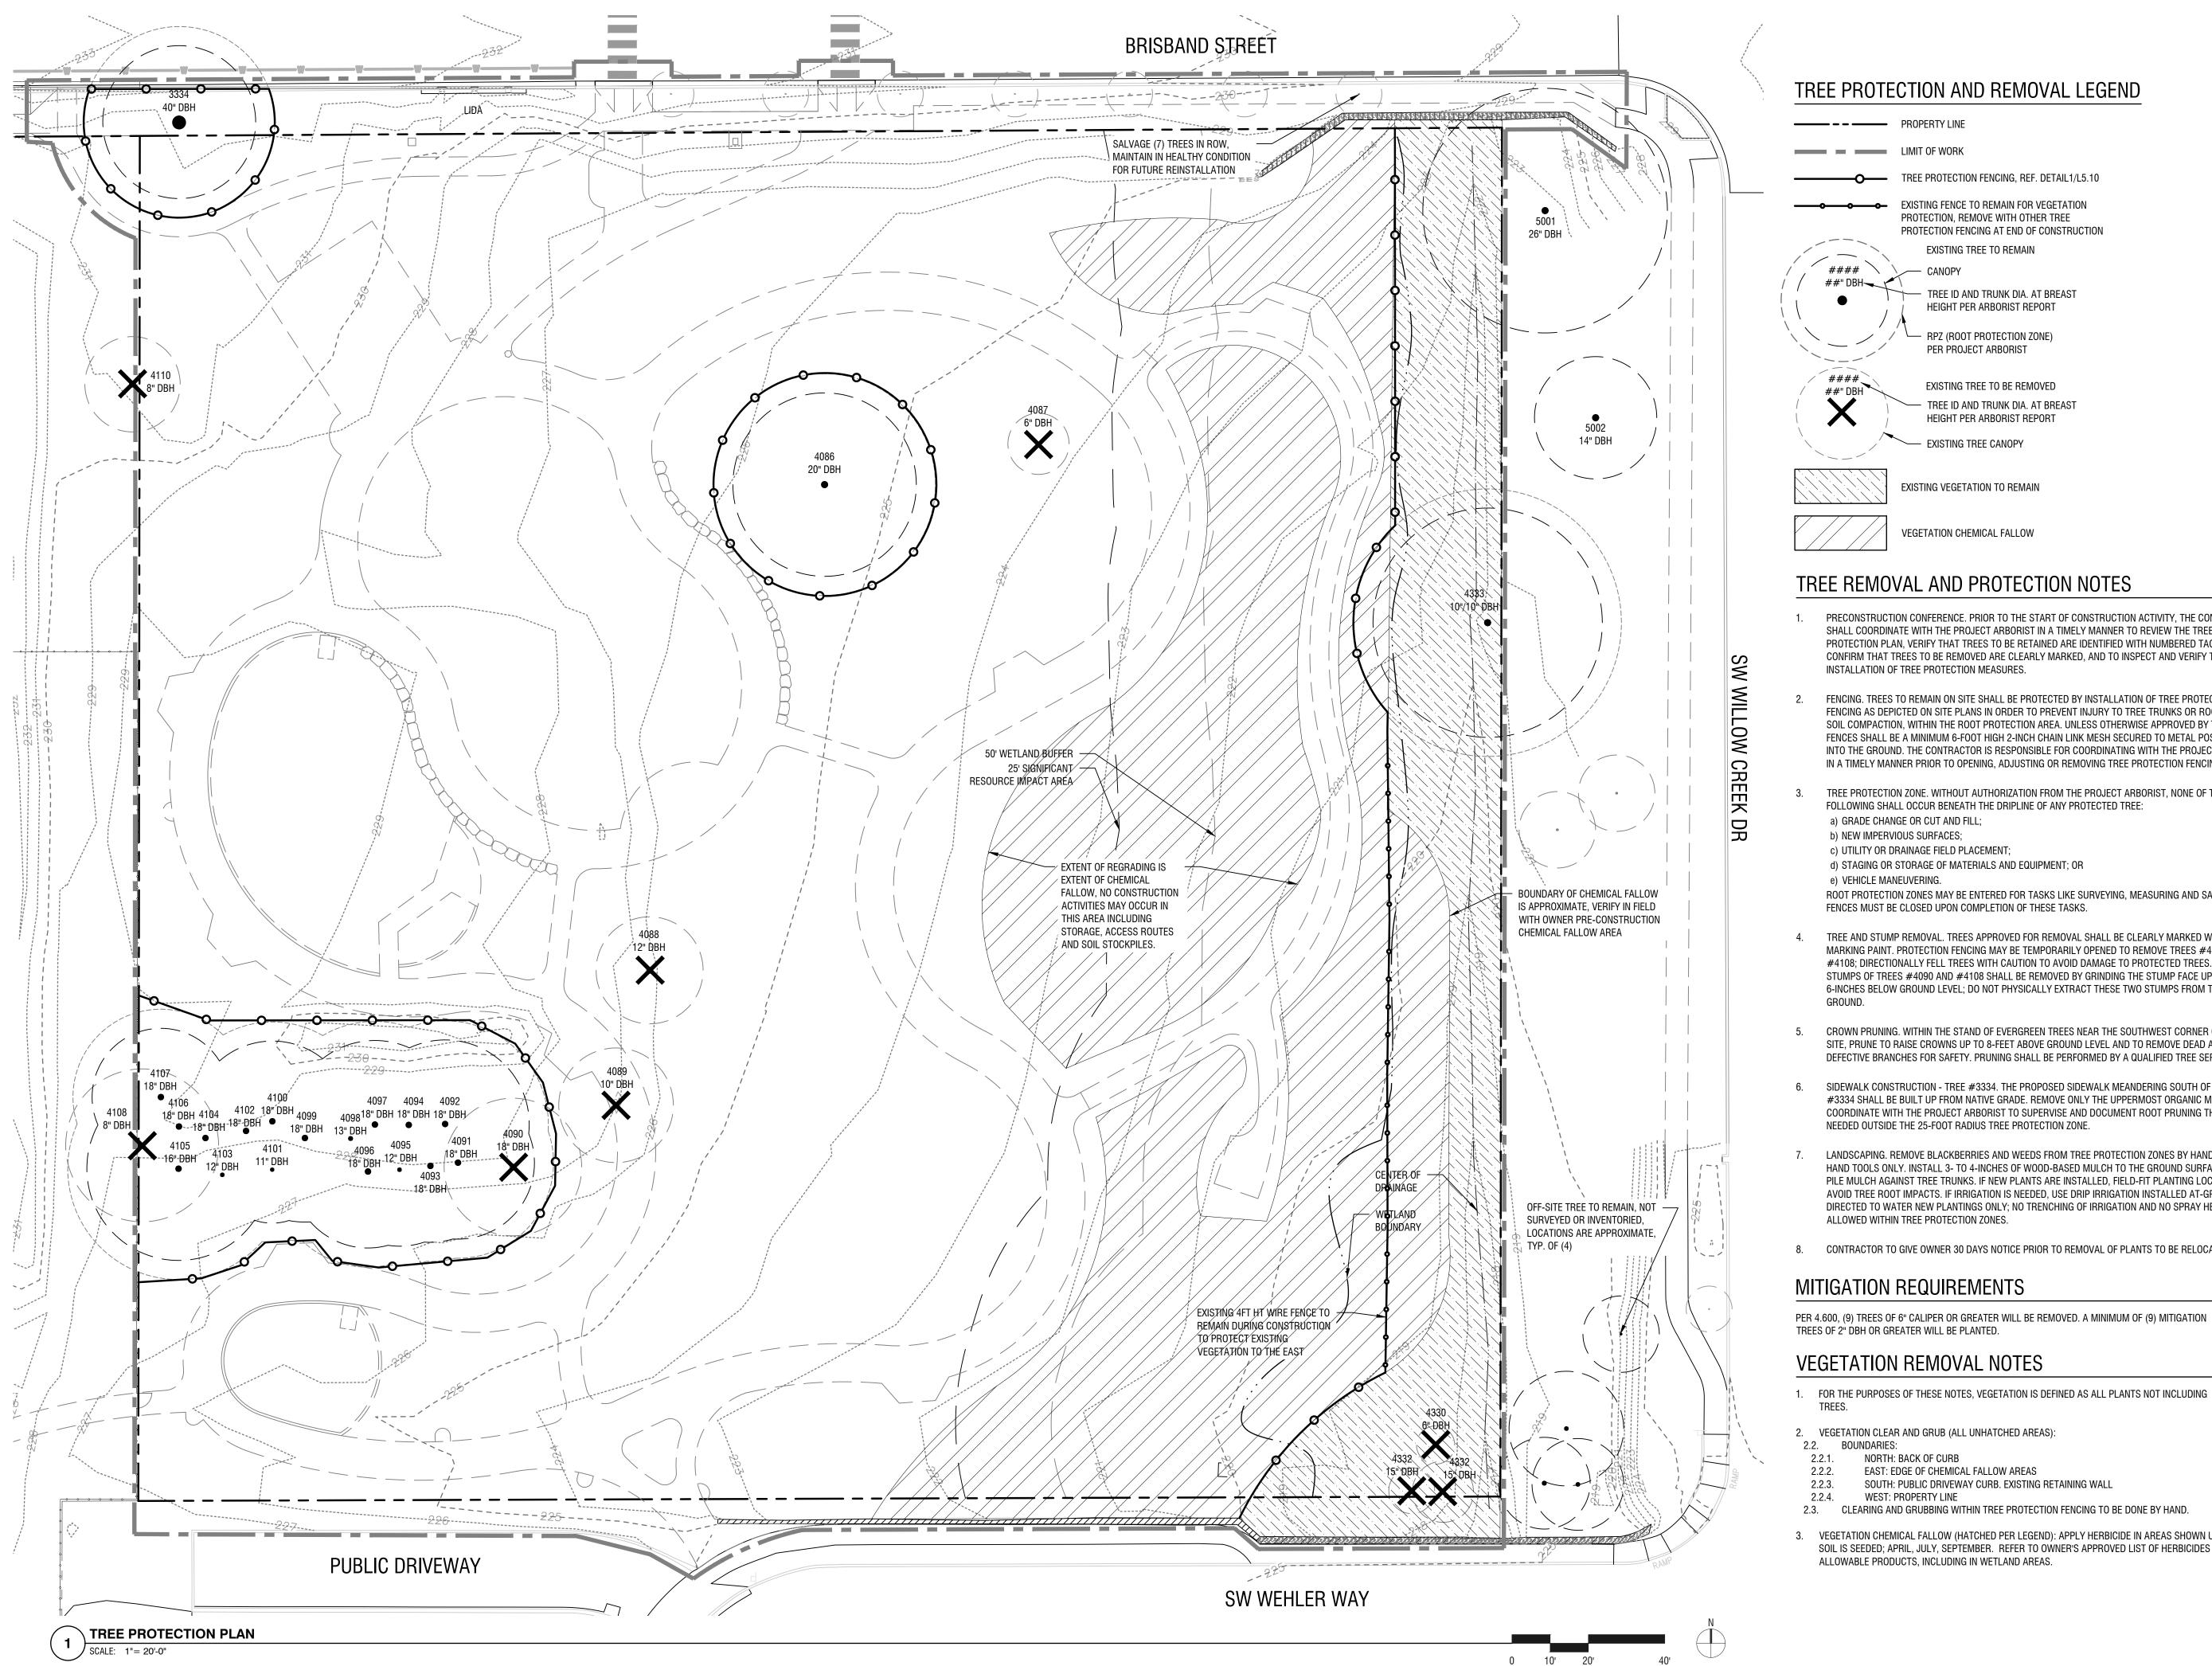
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Sheet Title

LIGHTING PHOTOMETRIC PLAN

E1.01



PRECONSTRUCTION CONFERENCE. PRIOR TO THE START OF CONSTRUCTION ACTIVITY, THE CONTRACTOR SHALL COORDINATE WITH THE PROJECT ARBORIST IN A TIMELY MANNER TO REVIEW THE TREE PROTECTION PLAN, VERIFY THAT TREES TO BE RETAINED ARE IDENTIFIED WITH NUMBERED TAGS, CONFIRM THAT TREES TO BE REMOVED ARE CLEARLY MARKED, AND TO INSPECT AND VERIFY THE

FENCING. TREES TO REMAIN ON SITE SHALL BE PROTECTED BY INSTALLATION OF TREE PROTECTION FENCING AS DEPICTED ON SITE PLANS IN ORDER TO PREVENT INJURY TO TREE TRUNKS OR ROOTS, OR SOIL COMPACTION, WITHIN THE ROOT PROTECTION AREA. UNLESS OTHERWISE APPROVED BY THE CITY, FENCES SHALL BE A MINIMUM 6-FOOT HIGH 2-INCH CHAIN LINK MESH SECURED TO METAL POSTS DRIVEN INTO THE GROUND. THE CONTRACTOR IS RESPONSIBLE FOR COORDINATING WITH THE PROJECT ARBORIST IN A TIMELY MANNER PRIOR TO OPENING, ADJUSTING OR REMOVING TREE PROTECTION FENCING.

TREE PROTECTION ZONE. WITHOUT AUTHORIZATION FROM THE PROJECT ARBORIST, NONE OF THE

ROOT PROTECTION ZONES MAY BE ENTERED FOR TASKS LIKE SURVEYING, MEASURING AND SAMPLING.

TREE AND STUMP REMOVAL. TREES APPROVED FOR REMOVAL SHALL BE CLEARLY MARKED WITH TREE MARKING PAINT. PROTECTION FENCING MAY BE TEMPORARILY OPENED TO REMOVE TREES #4090 AND #4108; DIRECTIONALLY FELL TREES WITH CAUTION TO AVOID DAMAGE TO PROTECTED TREES. THE STUMPS OF TREES #4090 AND #4108 SHALL BE REMOVED BY GRINDING THE STUMP FACE UP TO 6-INCHES BELOW GROUND LEVEL; DO NOT PHYSICALLY EXTRACT THESE TWO STUMPS FROM THE

CROWN PRUNING. WITHIN THE STAND OF EVERGREEN TREES NEAR THE SOUTHWEST CORNER OF THE SITE, PRUNE TO RAISE CROWNS UP TO 8-FEET ABOVE GROUND LEVEL AND TO REMOVE DEAD AND DEFECTIVE BRANCHES FOR SAFETY. PRUNING SHALL BE PERFORMED BY A QUALIFIED TREE SERVICE.

SIDEWALK CONSTRUCTION - TREE #3334. THE PROPOSED SIDEWALK MEANDERING SOUTH OF TREE #3334 SHALL BE BUILT UP FROM NATIVE GRADE. REMOVE ONLY THE UPPERMOST ORGANIC MATTER AND COORDINATE WITH THE PROJECT ARBORIST TO SUPERVISE AND DOCUMENT ROOT PRUNING THAT MAY BE

LANDSCAPING. REMOVE BLACKBERRIES AND WEEDS FROM TREE PROTECTION ZONES BY HAND AND WITH HAND TOOLS ONLY. INSTALL 3- TO 4-INCHES OF WOOD-BASED MULCH TO THE GROUND SURFACE; DO NOT PILE MULCH AGAINST TREE TRUNKS. IF NEW PLANTS ARE INSTALLED, FIELD-FIT PLANTING LOCATIONS TO AVOID TREE ROOT IMPACTS. IF IRRIGATION IS NEEDED, USE DRIP IRRIGATION INSTALLED AT-GRADE AND DIRECTED TO WATER NEW PLANTINGS ONLY; NO TRENCHING OF IRRIGATION AND NO SPRAY HEADS ARE

8. CONTRACTOR TO GIVE OWNER 30 DAYS NOTICE PRIOR TO REMOVAL OF PLANTS TO BE RELOCATED.

3. VEGETATION CHEMICAL FALLOW (HATCHED PER LEGEND): APPLY HERBICIDE IN AREAS SHOWN UNTIL SOIL IS SEEDED; APRIL, JULY, SEPTEMBER. REFER TO OWNER'S APPROVED LIST OF HERBICIDES FOR



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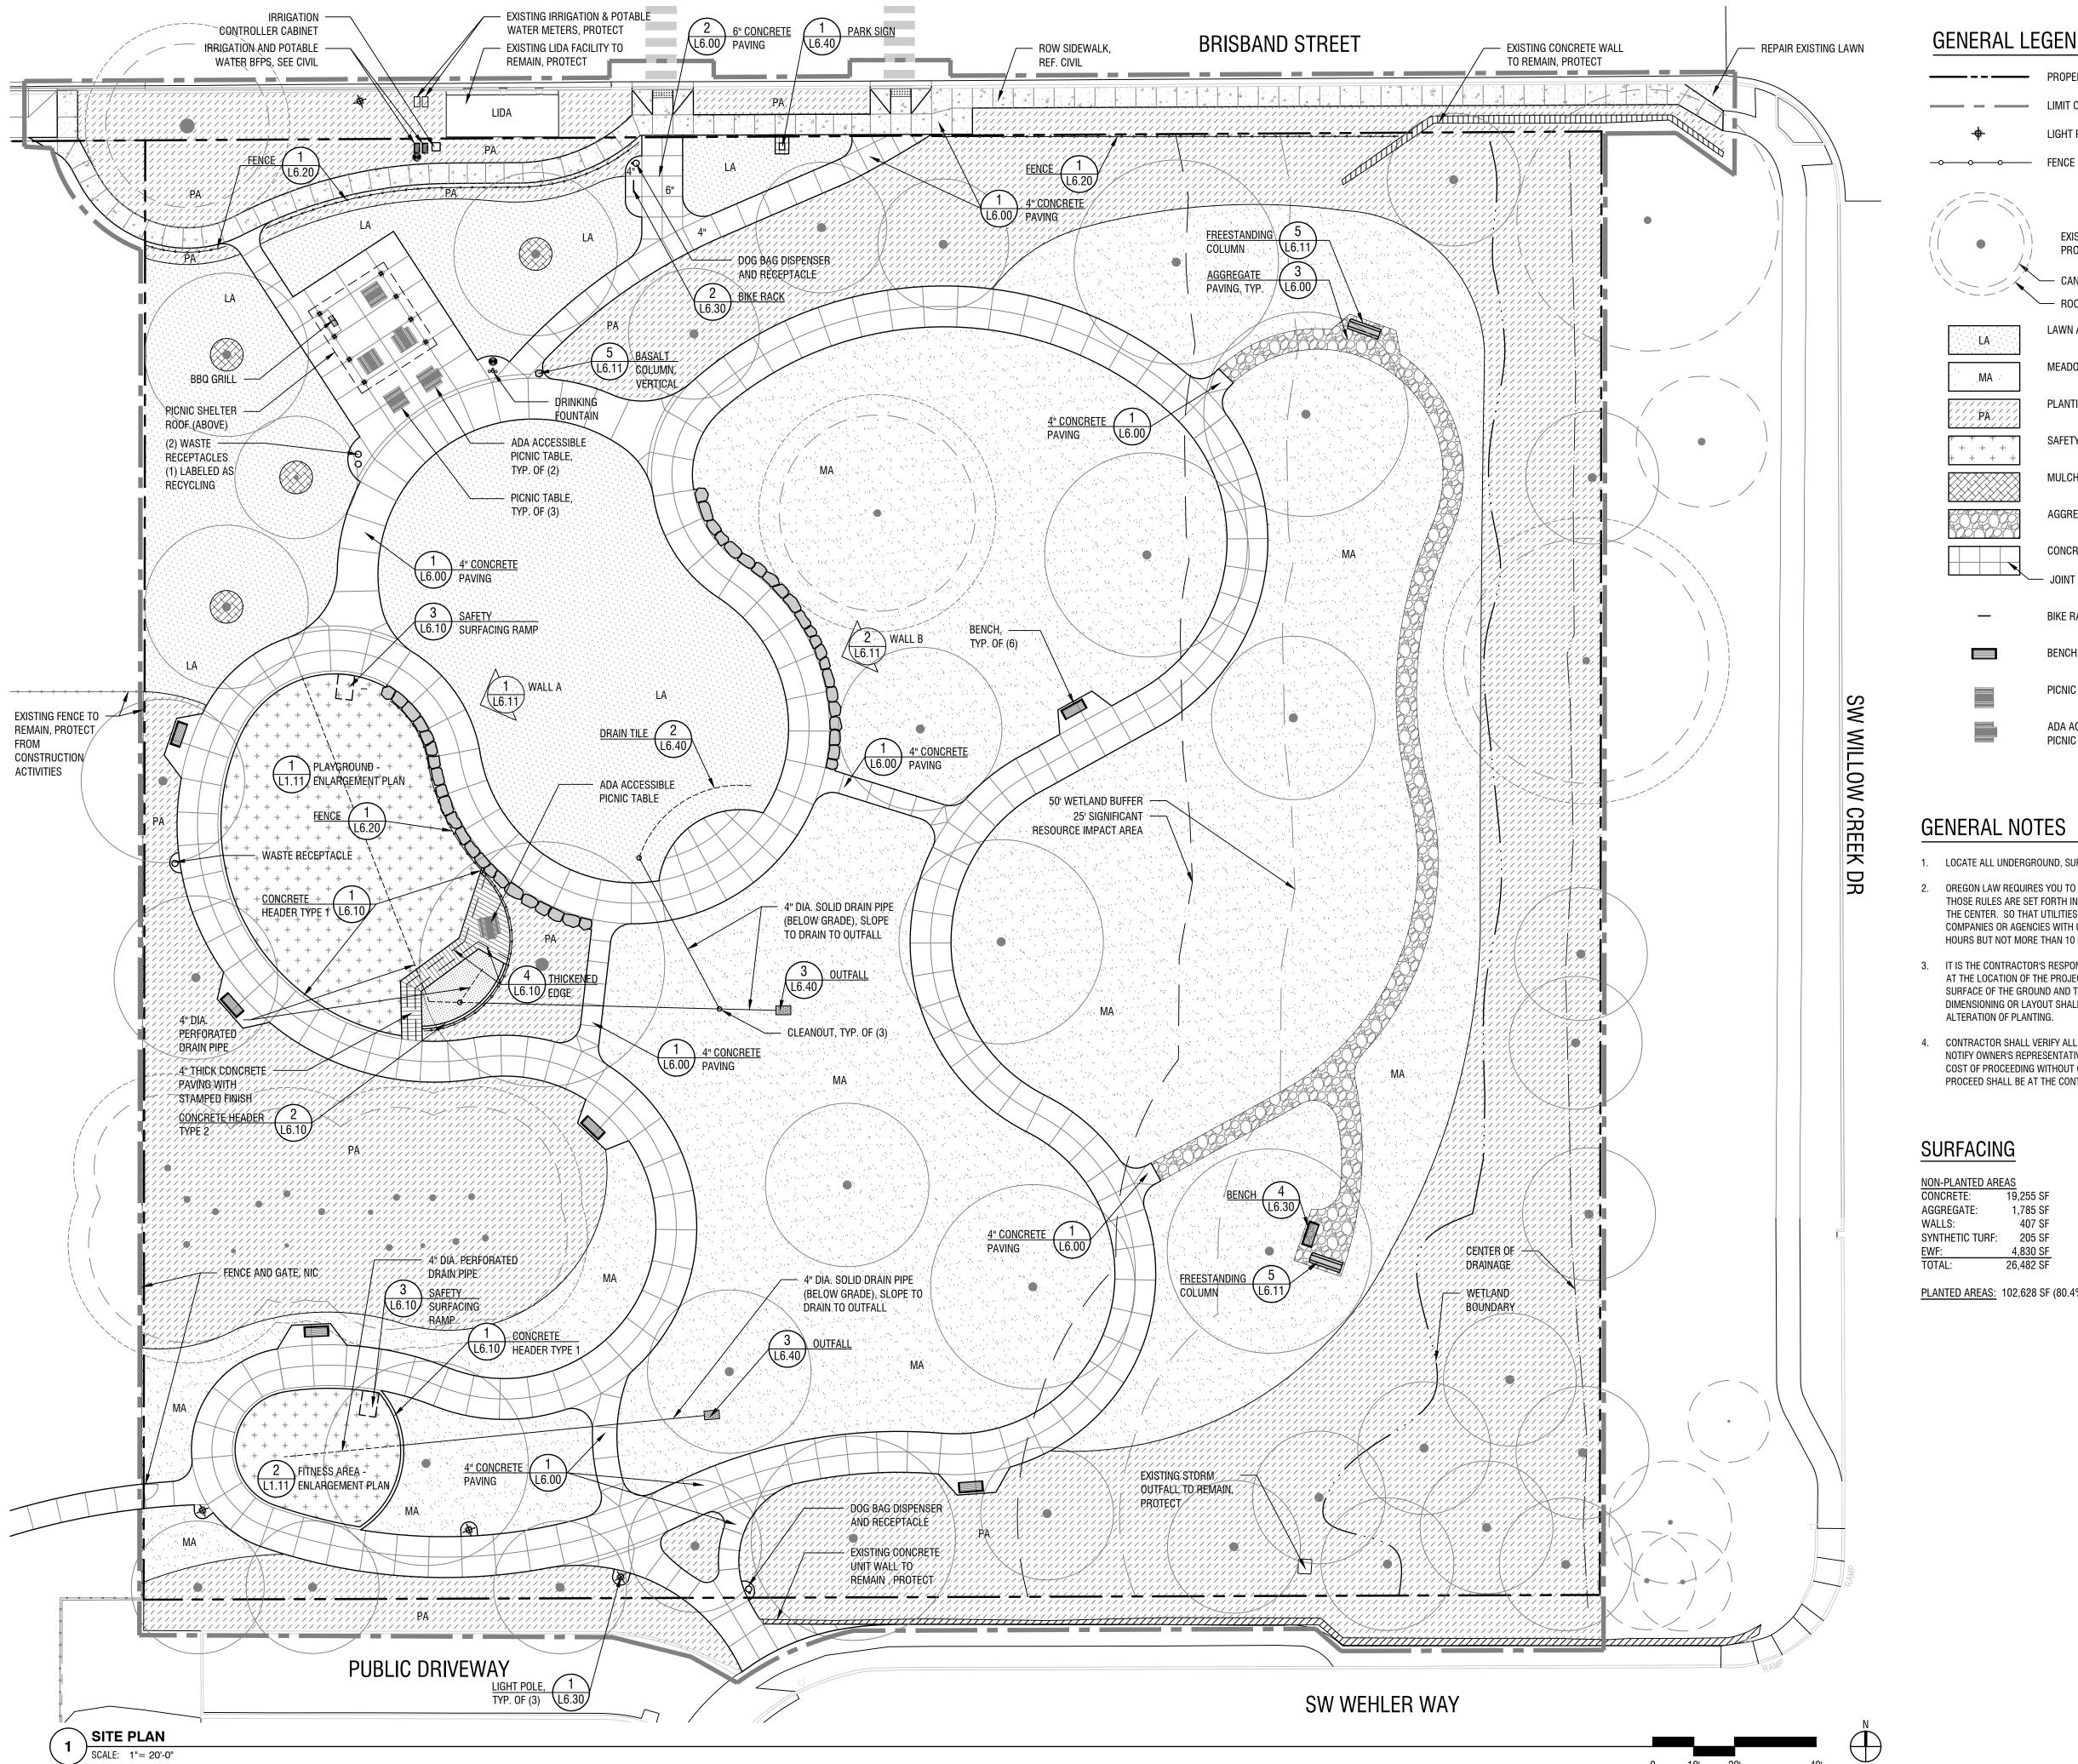
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Project FROG POND NEIGHBORHOOD PARK

Sheet Title

TREE PROTECTION AND REMOVAL PLAN

_0.02



0 10' 20'

LA

MA

/ PA// _____ + + + + +

> _____

SURFACING

NON-PLANTED ARE CONCRETE: SYNTHETIC TURF:

GENERAL LEGEND

---- PROPERTY LINE

LIMIT OF WORK

LIGHT POLE, REF. ELEC.

EXISTING TREE TO REMAIN, PROTECT

CANOPY - ROOT PROTECTION ZONE

LAWN AREA

MEADOW AREA

PLANTING AREA

SAFETY SURFACING

MULCH

AGGREGATE PAVING

CONCRETE PAVING

JOINT

BIKE RACK

BENCH

PICNIC TABLE

ADA ACCESSIBLE PICNIC TABLE

1. LOCATE ALL UNDERGROUND, SURFACE AND OVERHEAD UTILITIES PRIOR TO ANY WORK.

OREGON LAW REQUIRES YOU TO FOLLOW RULES ADOPTED BY THE OREGON UTILITY NOTIFICATION CENTER THOSE RULES ARE SET FORTH IN OAR 952-001-0090. YOU MAY OBTAIN COPIES OF THE RULES BY CALLING THE CENTER. SO THAT UTILITIES MAY BE ACCURATELY LOCATED, EXCAVATORS MUST NOTIFY ALL PERTINENT COMPANIES OR AGENCIES WITH UNDERGROUND UTILITIES IN THE PROJECT AREA AT LEAST 48 BUSINESS-DAY HOURS BUT NOT MORE THAN 10 BUSINESS DAYS PRIOR TO COMMENCING AN EXCAVATION.

3. IT IS THE CONTRACTOR'S RESPONSIBILITY TO ASCERTAIN ALL FACTS CONCERNING CONDITIONS TO BE FOUND AT THE LOCATION OF THE PROJECT INCLUDING PHYSICAL CHARACTERISTICS ABOVE AND BELOW THE SURFACE OF THE GROUND AND TO FULLY EXAMINE THE PLANS AND SPECIFICATIONS. ANY DISCREPANCIES IN DIMENSIONING OR LAYOUT SHALL BE BROUGHT TO THE ATTENTION OF THE AGENCY PRIOR TO THE ALTERATION OF PLANTING.

4. CONTRACTOR SHALL VERIFY ALL DIMENSIONS AND CONDITIONS PRIOR TO EACH PHASE OF CONSTRUCTION, NOTIFY OWNER'S REPRESENTATIVE PRIOR TO PROCEEDING WITH WORK. WHERE CONFLICT IS IDENTIFIED, COST OF PROCEEDING WITHOUT OWNER'S REPRESENTATIVE WRITTEN CLARIFICATION AND AUTHORIZATION TO PROCEED SHALL BE AT THE CONTRACTOR'S EXPENSE.

| REAS | | |
|------|------|----|
| 19 | ,255 | SF |
| 1 | ,785 | SF |
| | 407 | SF |
| | 205 | SF |
| 4 | ,830 | SF |
| 26 | ,482 | SF |

PLANTED AREAS: 102,628 SF (80.4% OF SITE)



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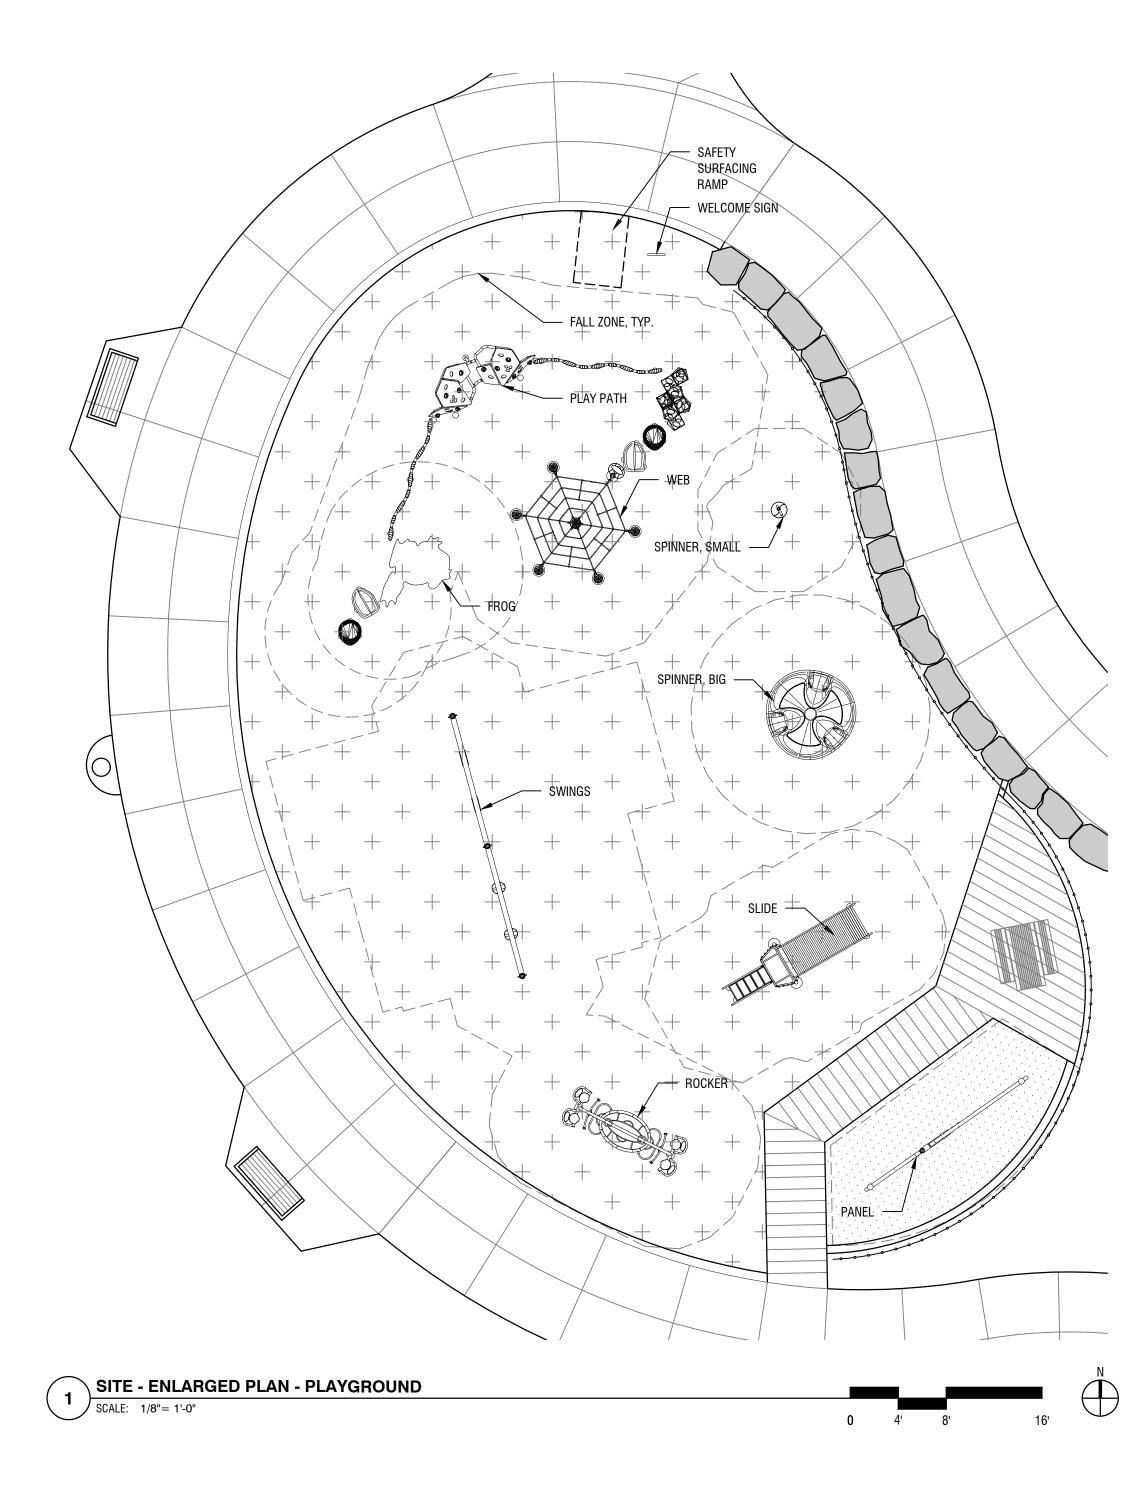
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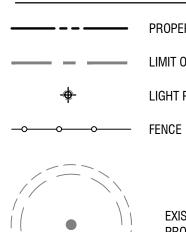
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Sheet Title

SITE PLAN










GENERAL NOTES

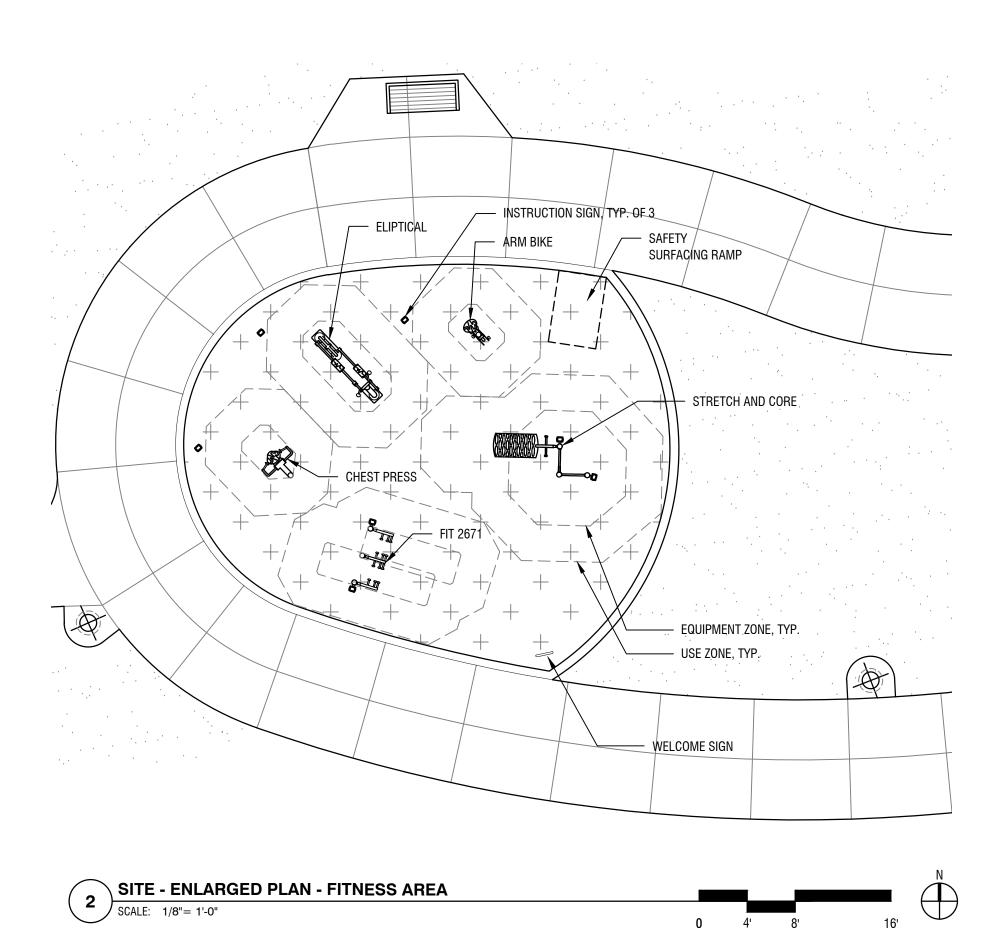



----------- PROPERTY LINE

LIMIT OF WORK

LIGHT POLE, REF. ELEC.

EXISTING TREE TO REMAIN, PROTECT

CANOPY - ROOT PROTECTION ZONE

LAWN AREA

MEADOW AREA

PLANTING AREA

SAFETY SURFACING

MULCH

AGGREGATE PAVING

CONCRETE PAVING - JOINT

BENCH

PICNIC TABLE

ADA ACCESSIBLE PICNIC TABLE

1. LOCATE ALL UNDERGROUND, SURFACE AND OVERHEAD UTILITIES PRIOR TO ANY WORK.

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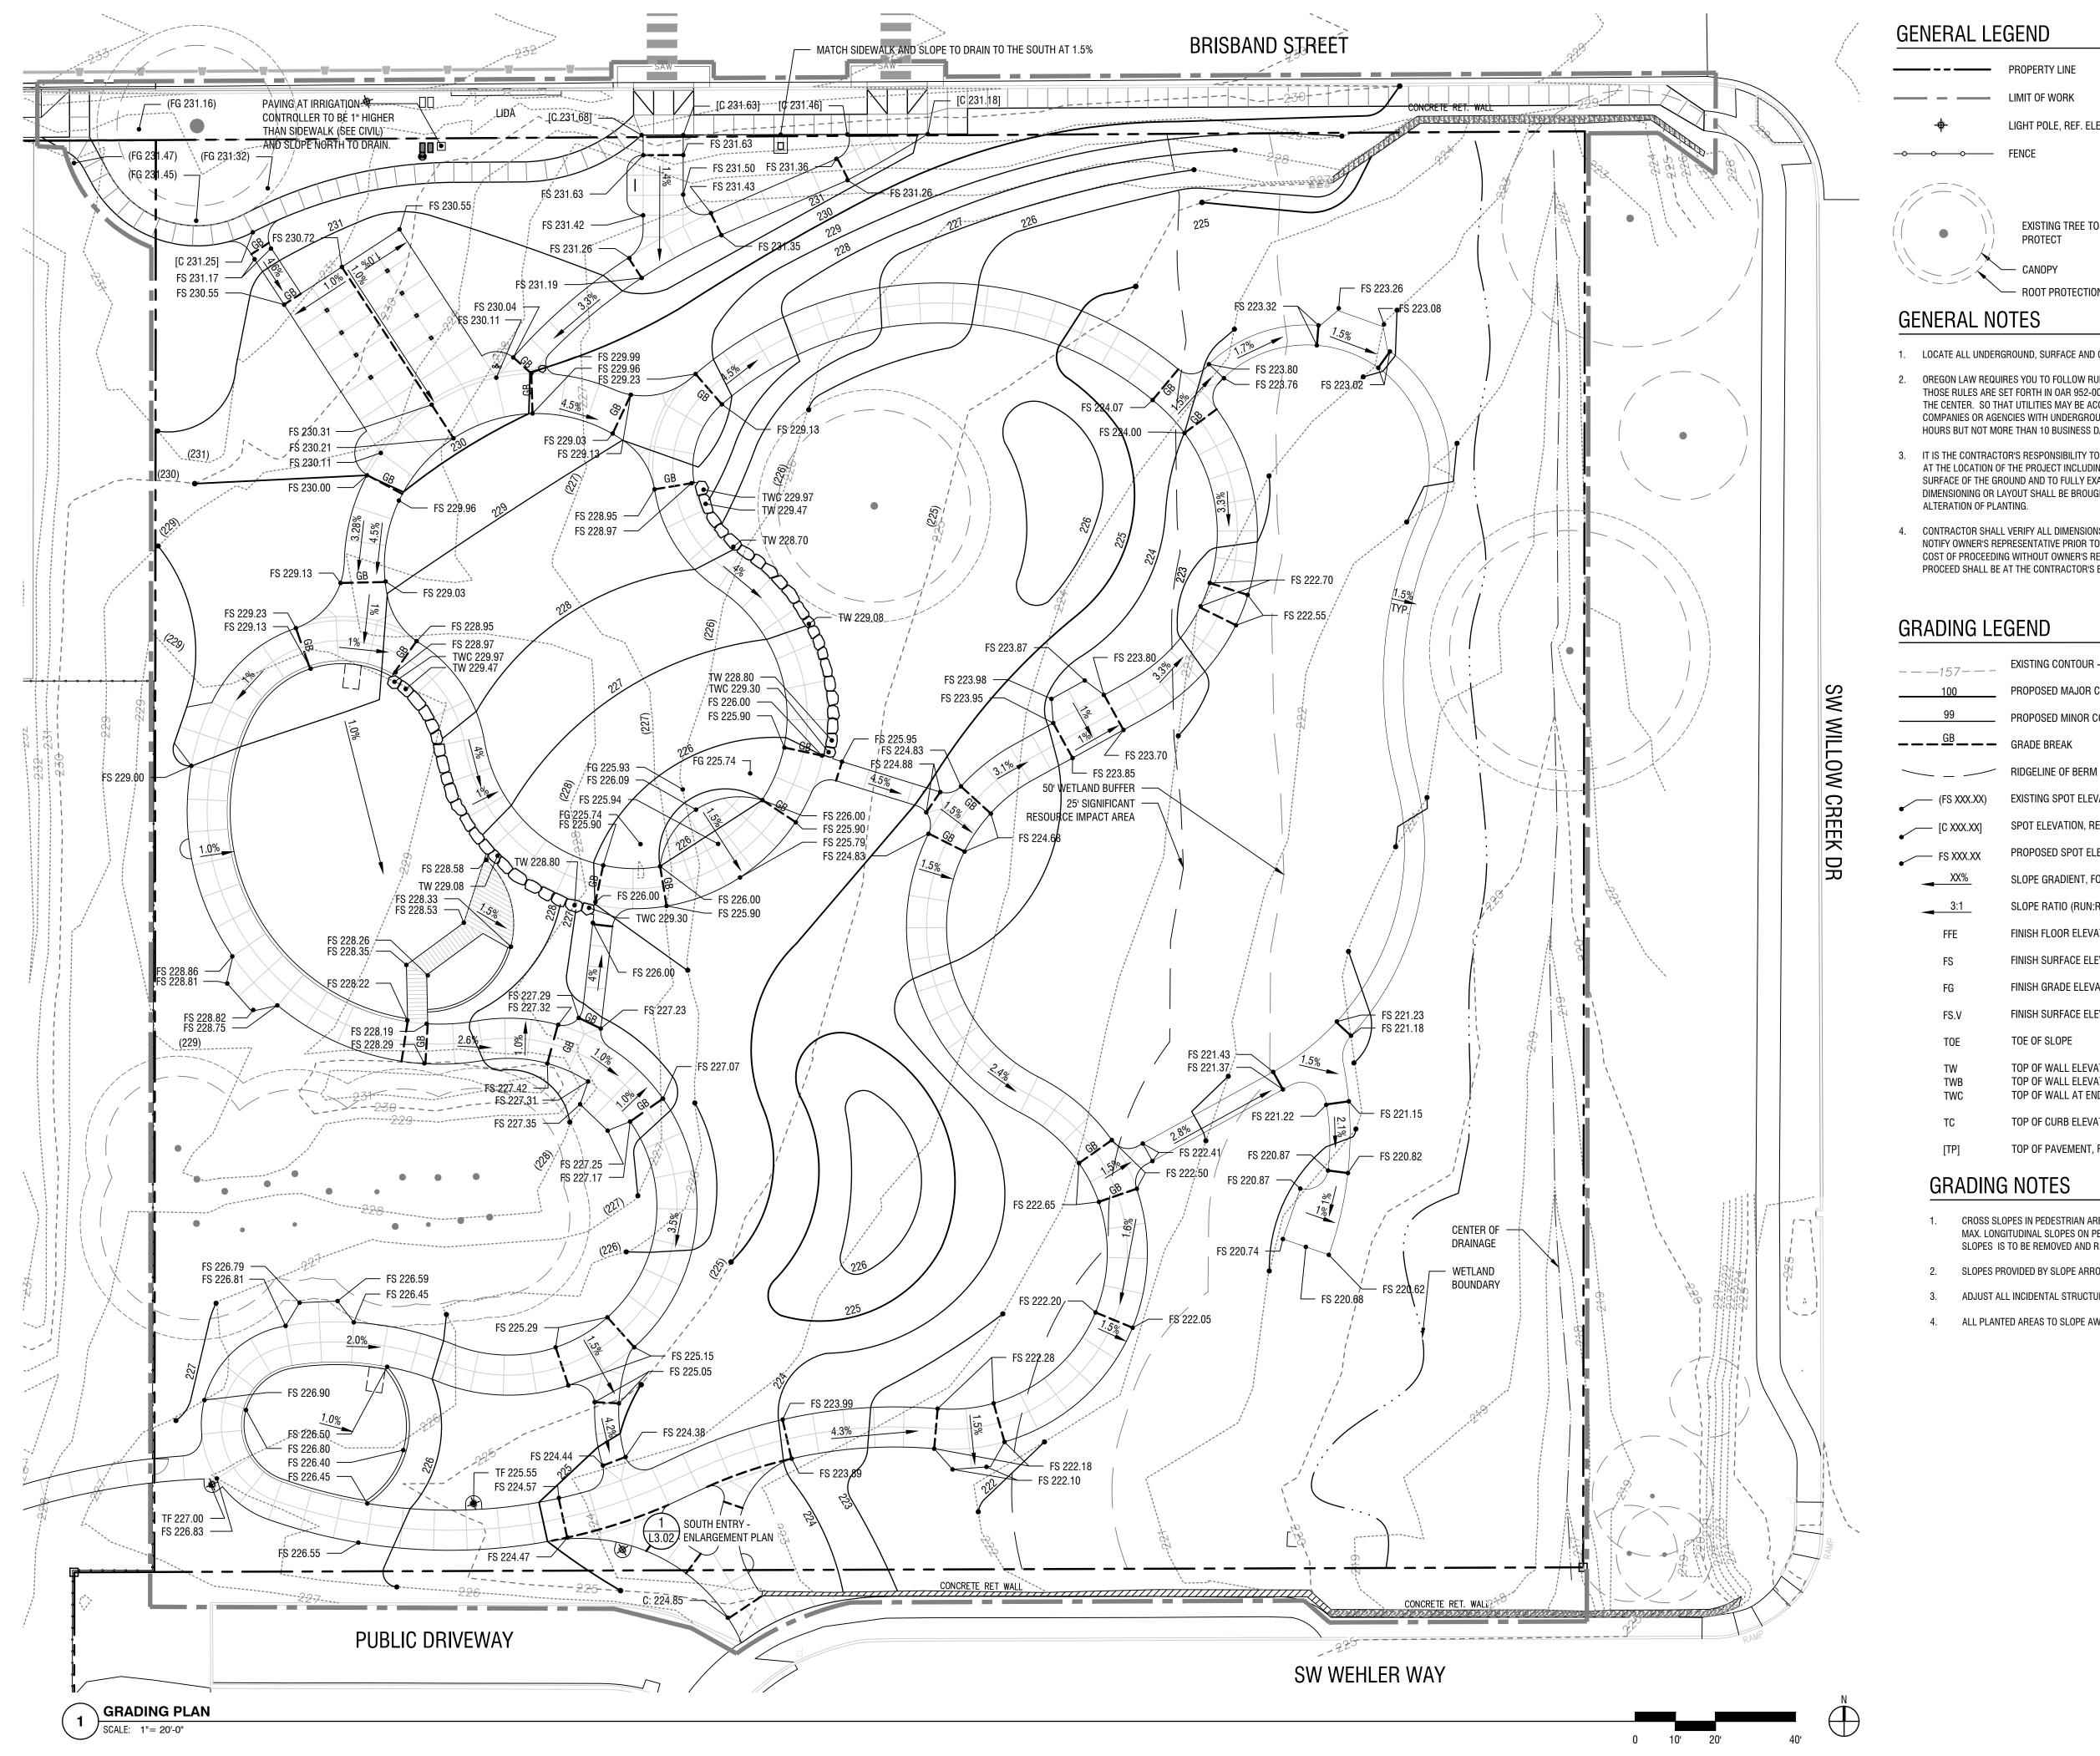
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FROG POND NEIGHBORHOOD PARK

Sheet Title

SITE - ENLARGED PLANS



GENERAL LEGEND

| PROPERTY LINE |
|---|
| LIMIT OF WORK |
| LIGHT POLE, REF. ELEC. |
| FENCE |
| EXISTING TREE TO REMAIN, PROTECT — CANOPY — ROOT PROTECTION ZONE |

1. LOCATE ALL UNDERGROUND, SURFACE AND OVERHEAD UTILITIES PRIOR TO ANY WORK.

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- EXISTING CONTOUR 1 FT INTERVAL PROPOSED MAJOR CONTOUR - 5 FT INTERVAL
- PROPOSED MINOR CONTOUR -1 FT INTERVAL
- ---- GRADE BREAK
- (FS XXX.XX) EXISTING SPOT ELEVATION GRADE
- [C XXX.XX] SPOT ELEVATION, REF. CIVIL
 - PROPOSED SPOT ELEVATION
 - SLOPE GRADIENT, FOR REFERENCE ONLY
 - SLOPE RATIO (RUN:RISE), FOR REFERENCE ONLY
 - FINISH FLOOR ELEVATION, REF ARCH
 - FINISH SURFACE ELEVATION (PAVING)
 - FINISH GRADE ELEVATION (SOFTSCAPE)
 - FINISH SURFACE ELEVATION UTILITY VAULT LID
 - TOE OF SLOPE
 - TOP OF WALL ELEVATION TOP OF WALL ELEVATION AT BREAK TOP OF WALL AT END COLUMNAR BASALT
 - TOP OF CURB ELEVATION
 - TOP OF PAVEMENT, REF. CIVIL

GRADING NOTES

CROSS SLOPES IN PEDESTRIAN AREAS TO BE 2% MAX. LONGITUDINAL SLOPES ON WALKWAYS TO BE 5% MAX. LONGITUDINAL SLOPES ON PEDESTRIAN RAMPS TO BE 8% MAX. ANY PAVING EXCEEDING THESE SLOPES IS TO BE REMOVED AND REPLACED AT THE CONTRACTOR'S EXPENSE.

SLOPES PROVIDED BY SLOPE ARROW ARE FOR REFERENCE ONLY.

ADJUST ALL INCIDENTAL STRUCTURES, MANHOLE LIDS, VALVE BOXES, ETC. TO FINISH GRADE.

4. ALL PLANTED AREAS TO SLOPE AWAY FROM BUILDINGS AT 2% MIN.



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Sheet Title

GRADING PLAN

| SYMBOL | CODE | BOTANICAL NAME | COMMON NAME | PLANT SIZE | | | QTY | REMARKS |
|--|------------|---|----------------------------------|------------|-----------|----------------------|-----|--|
| | | PLAN, "S" DESIGNATES SALVAGED TREE, ' | | FLANT SIZE | | | | REWARKS |
| | | | | | | | | |
| $\langle \cdot \rangle$ | AM | ACER MACROPHYLLUM | BIG LEAF MAPLE | 2" CAL. | | | 2 | |
| | | | | 0.754.041 | | | 0 | |
| | CO-R | CERCIS OCCIDENTALIS | WESTERN REDBUD | 0.75" CAL. | | | 2 | |
| | CO | CERCIS OCCIDENTALIS | WESTERN REDBUD | 2" CAL. | | | 3 | |
| \square | | | | 2 UAL. | | | 3 | |
| | MS | MAGNOLIA X SOULANGEANA | SAUCER MAGNOLIA | 2" CAL. | | | 1 | SPECIMEN QUALITY BRANCHING 2-4 |
| | | | | | | | | FROM GROUND |
| • R | MF-R | MALUS FUSCA | WESTERN CRABAPPLE | 0.75" CAL. | | | 5 | |
| $\frac{2}{2}$ | | | | | | | | |
| ({{ • R }}) | PP-R | PINUS PONDEROSA WILLAMETTENSIS | WILLAMETTE VALLEY PONDEROSA PINE | 5` HT. | | | 4 | STRONG CENTRAL LEADER |
| | | | | | | | | |
| | PE-R | PRUNUS EMARGINATA | BITTER CHERRY | 0.75" CAL. | | | 2 | SINGLE TRUNK |
| | | | | | | | | |
| | PE | PRUNUS EMARGINATA | BITTER CHERRY | 2" CAL. | | | 4 | |
| | | | | | | | | |
| | QG-R | QUERCUS GARRYANA | OREGON WHITE OAK | 0.75" CAL. | | | 8 | |
| North Charles | | | | | | | | |
| $\left(\begin{array}{c} \bullet \\ R \end{array}\right)$ | SS-R | SALIX SITCHENSIS | SITKA WILLOW | 0.75" CAL. | | | 8 | |
| <u>N</u> | | | | | | | | |
| ·R ⟨ | SG-R | SEQUOIADENDRON GIGANTEUM | GIANT SEQUOIA | 5` HT. | | | 2 | |
| X | | | | | | | | SALVAGED STREET TREES. INSTALI |
| | TC-S | TILIA AMERICANA | BASSWOOD | 2" CAL. | | | 6 | BEST QUALITY ONES, RETURN EXTE TREE TO OWNER. |
| | CODE | BOTANICAL NAME | | SIZE | CONTAINER | SPACING | | REMARKS |
| SHRUBS | | | | 3IZE | CONTAINER | SPACING | | REMARKS |
| { . } | ACC | ACER CIRCINATUM | VINE MAPLE | 6'-8' HT | B&B | AS SHOWN | | MULTI-STEMMED, 3-5 |
| <u> </u> | ACC-R2 | ACER CIRCINATUM | VINE MAPLE | 1 GAL | РОТ | 36" o.c. | | MULTI-STEMMED, 3-5 |
| <u> </u> | ACC-R1 | ACER CIRCINATUM | VINE MAPLE | 5 GAL | РОТ | AS SHOWN | | MULTI-STEMMED, 3-5 |
| (+) | CEG | CEANOTHUS GLORIOSUS | POINT REYES CEANOTHUS | 1 GAL | POT | 36" o.c. | | , |
| | CET | CEANOTHUS THYRSIFLORUS | | 5 GAL | | | | |
| <u> </u> | | | BLUEBLOSSOM | | POT | 60" o.c. | | |
| {•} | COS | CORNUS SERICEA | RED TWIG DOGWOOD | 5 GAL | РОТ | 48" o.c. | | 1 GAL IN MIX AREAS |
| <u>MIX 2</u> | GAS | GAULTHERIA SHALLON | SALAL | 1 GAL | POT | 36" o.c. | | |
| $\langle \Theta \rangle$ | HOD | HOLODISCUS DISCOLOR | OCEANSPRAY | 5 GAL | РОТ | 48" o.c. | | 1 GAL IN MIX AREAS |
| <u>MIX 6</u> | LOI | LONICERA INVOLUCRATA | TWINBERRY | 1 GAL | РОТ | 48" o.c. | | |
| <u>MIX 5,6</u> | MAA | MAHONIA AQUIFOLIUM | OREGON GRAPE | 1 GAL | РОТ | 36" o.c. | | |
| <u>MIX 6</u> | OEC | OEMLERIA CERASIFORMIS | OSOBERRY | 1 GAL | РОТ | 48" o.c. | | |
| \bigcirc | PHL | PHILADELPHUS LEWISII | WILD MOCK ORANGE | 5 GAL | РОТ | 48" o.c. | | 1 GAL IN MIX AREAS |
| MUNUVUL KUUU | POF | POTENTILLA FRUTICOSA | BUSH CINQUEFOIL | 3 GAL | РОТ | 36" o.c. | | 1 GAL IN MIX AREAS |
| MIX 4 | RIS | RIBES SANGUINEUM | RED FLOWERING CURRANT | 1 GAL | РОТ | 36" o.c. | | |
| MIX 6 | ROP | ROSA PISOCARPA | CLUSTERED WILD ROSE | 1 GAL | РОТ | 36" o.c. | | |
| | SPB | SPIRAEA BETULIFOLIA | BIRCHLEAF SPIREA | 1 GAL | РОТ | 24" o.c. | | |
| MIX 1,3 | | 1 | | | | | | |
| | _ | SPIRAFA DOLIGI ASII | WESTERN SPIRFA | 1 GAI | POT | 24" n c | | |
| <u>MIX 1,3</u> <u>MIX 5,6</u> MIX 1,5,6 | SPD SYA | SPIRAEA DOUGLASII SYMPHORICARPOS ALBUS | WESTERN SPIREA | 1 GAL | РОТ | 24" o.c. 36" o.c. | | |

| SYMBOL | CODE | BOTANICAL NAME | COMMON NAME | PLANT SIZE | | | QTY | REMARKS |
|--|-------|-------------------------|-----------------------|------------|-----|----------|-----|-----------------------------------|
| PERENNIA | LS | | | | | | | |
| A | ACMI | ACHILLEA MILLEFOLIUM | COMMON YARROW | 1 GAL | POT | 9" o.c. | | EACH SYMBOL IS A GROUP OF 3 PLANT |
| | IRTE | IRIS TENAX | OREGON IRIS | 1 GAL | POT | 9" o.c. | | EACH SYMBOL IS A GROUP OF 3 PLANT |
| MIX 6 | JUEF | JUNCUS EFFUSUS | SOFT RUSH | PLUGS | | 36" o.c. | | |
| | LOCI | LONICERA CILIOSA | ORANGE HONEYSUCKLE | 1 GAL | POT | 9" o.c. | | EACH SYMBOL IS A GROUP OF 3 PLANT |
| R | RUHI | RUDBECKIA HIRTA | BLACK-EYED SUSAN | 1 GAL | POT | 9" o.c. | | EACH SYMBOL IS A GROUP OF 3 PLANT |
| MIX 6 | SCMI | SCIRPUS MICROCARPUS | SMALL-FRUITED BULRUSH | PLUGS | | 36" o.c. | | |
| GROUNDC | OVER | | | | | | | , |
| , | MANE | MAHONIA NERVOSA | OREGON GRAPE | 1 GAL | POT | 30" o.c. | | |
| * | MARE | MAHONIA REPENS | CREEPING MAHONIA | 1 GAL | РОТ | 24" o.c. | | |
| Ê | POMU | POLYSTICHUM MUNITUM | WESTERN SWORD FERN | 1 GAL | POT | 36" o.c. | | |
| GROUND C | OVERS | • | | · | | · | • | |
| en de la companya de la companya Antiente de la companya de la companya Antiente de la companya de la companya Antiente de la companya de la companya | ARUV | ARCTOSTAPHYLOS UVA-URSI | KINNIKINNICK | 1 GAL | РОТ | 24" o.c. | | |

PLANTING LEGEND


| ROOT BA | RRIER | |
|--|---|--|
| | PLANTING TO PROTECT PER L0.02 | |
| LAWN (L | A), REF. SPECS | |
| MEADOW | / MIX (MA), REF. SPECS | |
| MULCH | | |
| <u>MIX 1 - 3</u> SPB SYA | <u>6" O.C.</u> SPIREA BETULIFOLIA SYMPHORICARPOS ALBUS | 50% 50% |
| <u>MIX 2 - 2</u> GAS MARE | <u>4" O.C.</u> Gaultheria Shallon Mahonia Repens | 30% 70% |
| <u>MIX 3 - 2</u> POF SPB | <u>4" O.C.</u> POTENTILLA FRUTICOSA SPIREA BETULIFOLIA | 50% 50% |
| MIX 4 - 3 CET HOD PHL RIS | <u>6" O.C.</u> CEONOTHUS THYSIFLORUS HOLODISCUS DISCOLOR PHILADELPHUS LEWISII RIBES SANGUINEUM | 20% 20% 20% 40% |
| MIX 5 - 3 ACC-R2 HOD MAA SPD SYA VIT | <u>6" O.C.</u> ACER CIRCINATUM HOLODISCUS DISCOLOR MAHONIA AQUIFOLIUM SPIREA DOUGLASII SYMPHORICARPOS ALBUS VIBURNUM TRILOBUM | 20% 20% 20% 10% 10% 20% |
| MIX 6 - 3 ACC-R2 COS JUEF LOI MAA OEC ROP SCMI SPD SYA | <u>6" O.C.</u> ACER CIRCINATUM CORNUS SERICEA JUNCUS EFFUSUS LONICERA INVOLUCRATA MAHONIA AQUIFOLIUM OEMLERIA CERASIFORMIS ROSA PISOCARPA SCIRPUS MICROCARPUS SPIREA DOUGLASII SYMPHORICARPOS ALBUS | 10% 10% 10% 10% 10% 10% 10% 10% |

RESTORATION AREAS AREAS OF MIX 4, 5 AND 6 TO BE HAND SEEDED WITH AREAS 4,5: UPLAND MIX AREA 6: WETLAND MIX

PLANTING NOTES

- 1. DO NOT BEGIN PLANTING UNTIL IRRIGATION SYSTEM IS INSTALLED, TESTED AND APPROVED.
- 2. DO NOT BEGIN PLANTING UNTIL SOIL PREPARATION IS COMPLETE AND APPROVED. SEE SOIL SPECIFICATION FOR SOIL AND MULCH DEPTHS.
- 3. LOCATE PLANTS AS DIMENSIONED ON THE PLANS AND AS SHOWN IN THE PLANT SCHEDULE. LANDSCAPE ARCHITECT TO MEET FIELD CONDITIONS.
- 4. PROCESS TO BE ESTABLISHED AT PRE-CONSTRUCTION MEETING.
- 5. THOROUGHLY WATER IN ALL PLANTS WITHIN 6 HOURS OF PLANTING.
- 6. APPLY SPECIFIED MULCH OVER PLANTING AREAS WITHIN TWO DAYS OF INSTALLING PLANTS, UNLESS OTHERWISE NOTED.
- 7. ALL PLANTS ARE REQUIRED TO MEET AMERICAN STANDARD FOR NURSERY STOCK, ANSI Z60.1-2014.

| TRIANGULAR SPACING | 9" | 12" | 15" | 18" | 24" | 30" | 36" | 48" |
|----------------------|-------|-------|-------|-------|-------|-------|-------|-------|
| SQUARE FT MULTIPLIER | 2.053 | 1.155 | 0.739 | 0.513 | 0.289 | 0.185 | 0.128 | 0.072 |

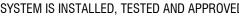

PLANT SPACING IS MEASURED CENTER TO CENTER. PLANT LOCATIONS MAY BE ADJUSTED BY THE

VERIFY ALL QUANTITIES AND VARIETIES SHOWN ON THE DRAWINGS PRIOR TO ORDERING. OWNER MUST APPROVE ANY NECESSARY SUBSTITUTIONS DURING SUBMITTALS PROCESS. REVIEW

8. TO CALCULATE THE QUANTITY OF PLANTS PER AREA, USE THE FOLLOWING SPACING MULTIPLIERS:



Mayer/Reed

Mayer/Reed, Inc. 319 SW Washington St. Suite 820 Portland, Oregon 97204 503.223.5953 www.mayerreed.com

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Revisions

Submittal / Date LAND USE PERMIT REVISED


06.13.2024

L5.00

Project FROG POND NEIGHBORHOOD PARK

Sheet Title

PLANT SCHEDULE AND NOTES

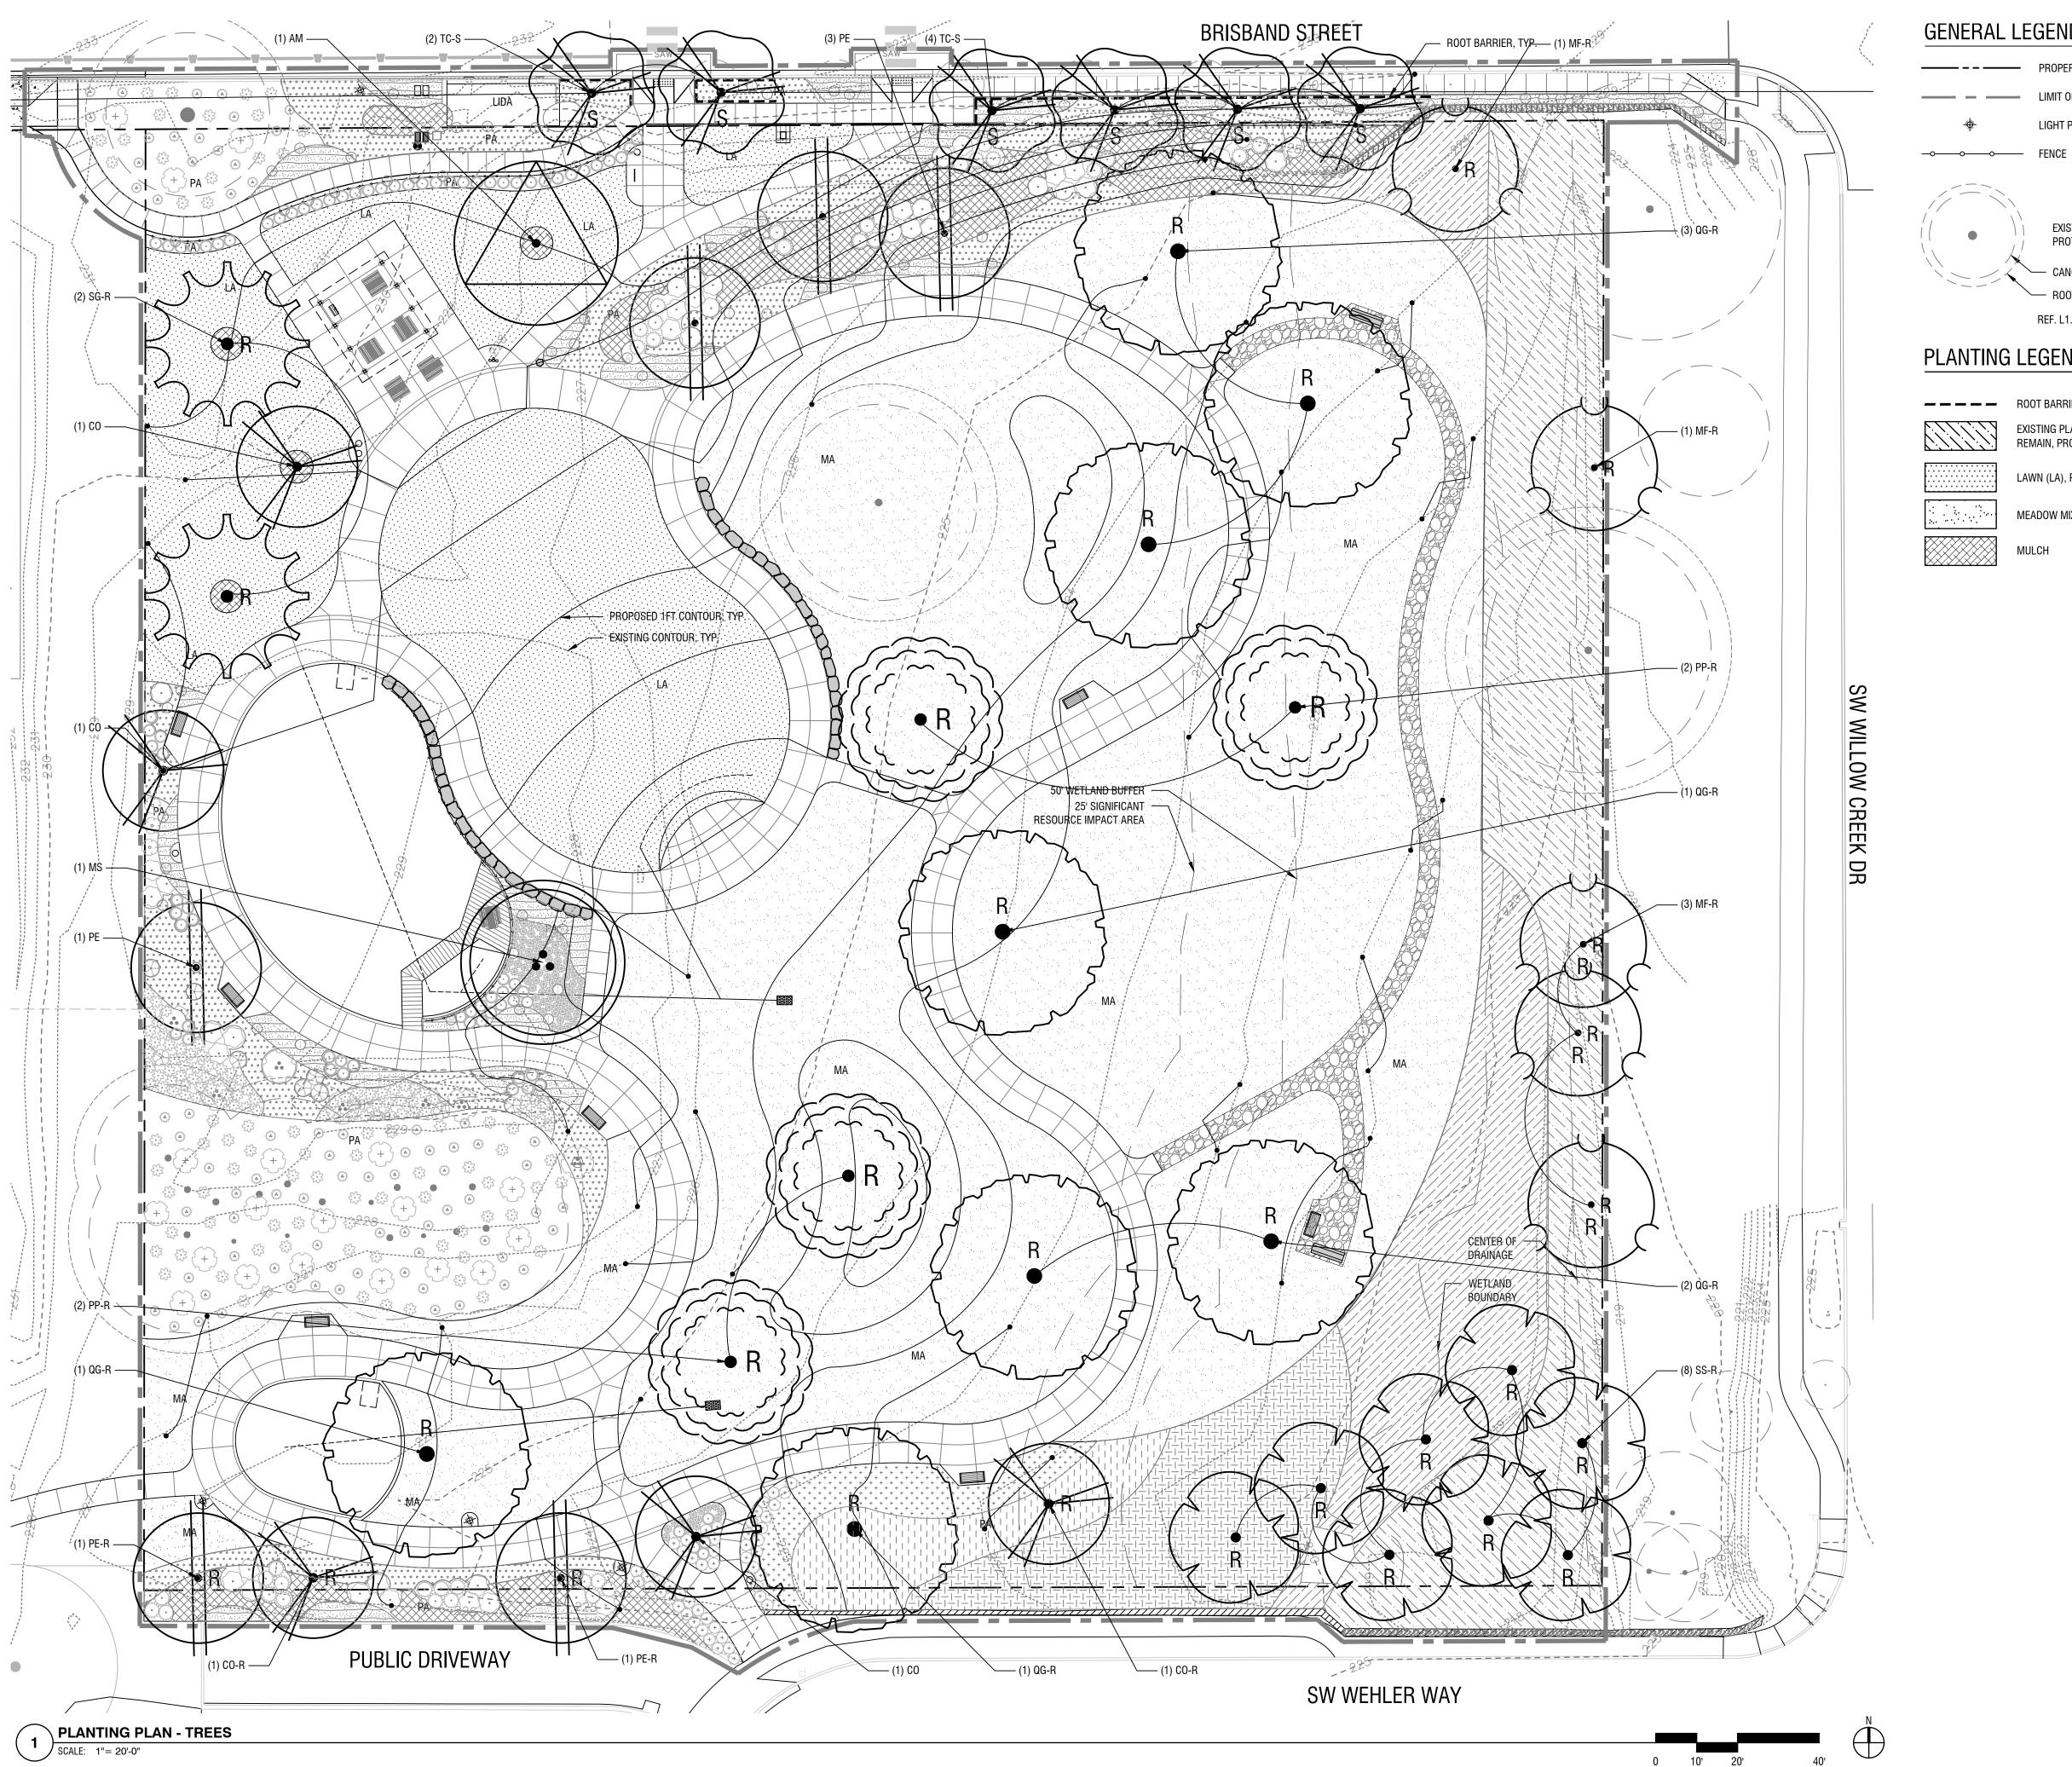

0 10' 20'

GENERAL LEGEND

- PROPERTY LINE
- _____ LIMIT OF WORK
 - LIGHT POLE, REF. ELEC.

EXISTING TREE TO REMAIN, PROTECT

- ROOT PROTECTION ZONE REF. L1.01 FOR GENERAL NOTES

PLANTING LEGEND

ROOT BARRIER EXISTING PLANTING TO REMAIN, PROTECT PER L0.02

LAWN (LA), REF. SPECS

MEADOW MIX (MA), REF. SPECS

MULCH



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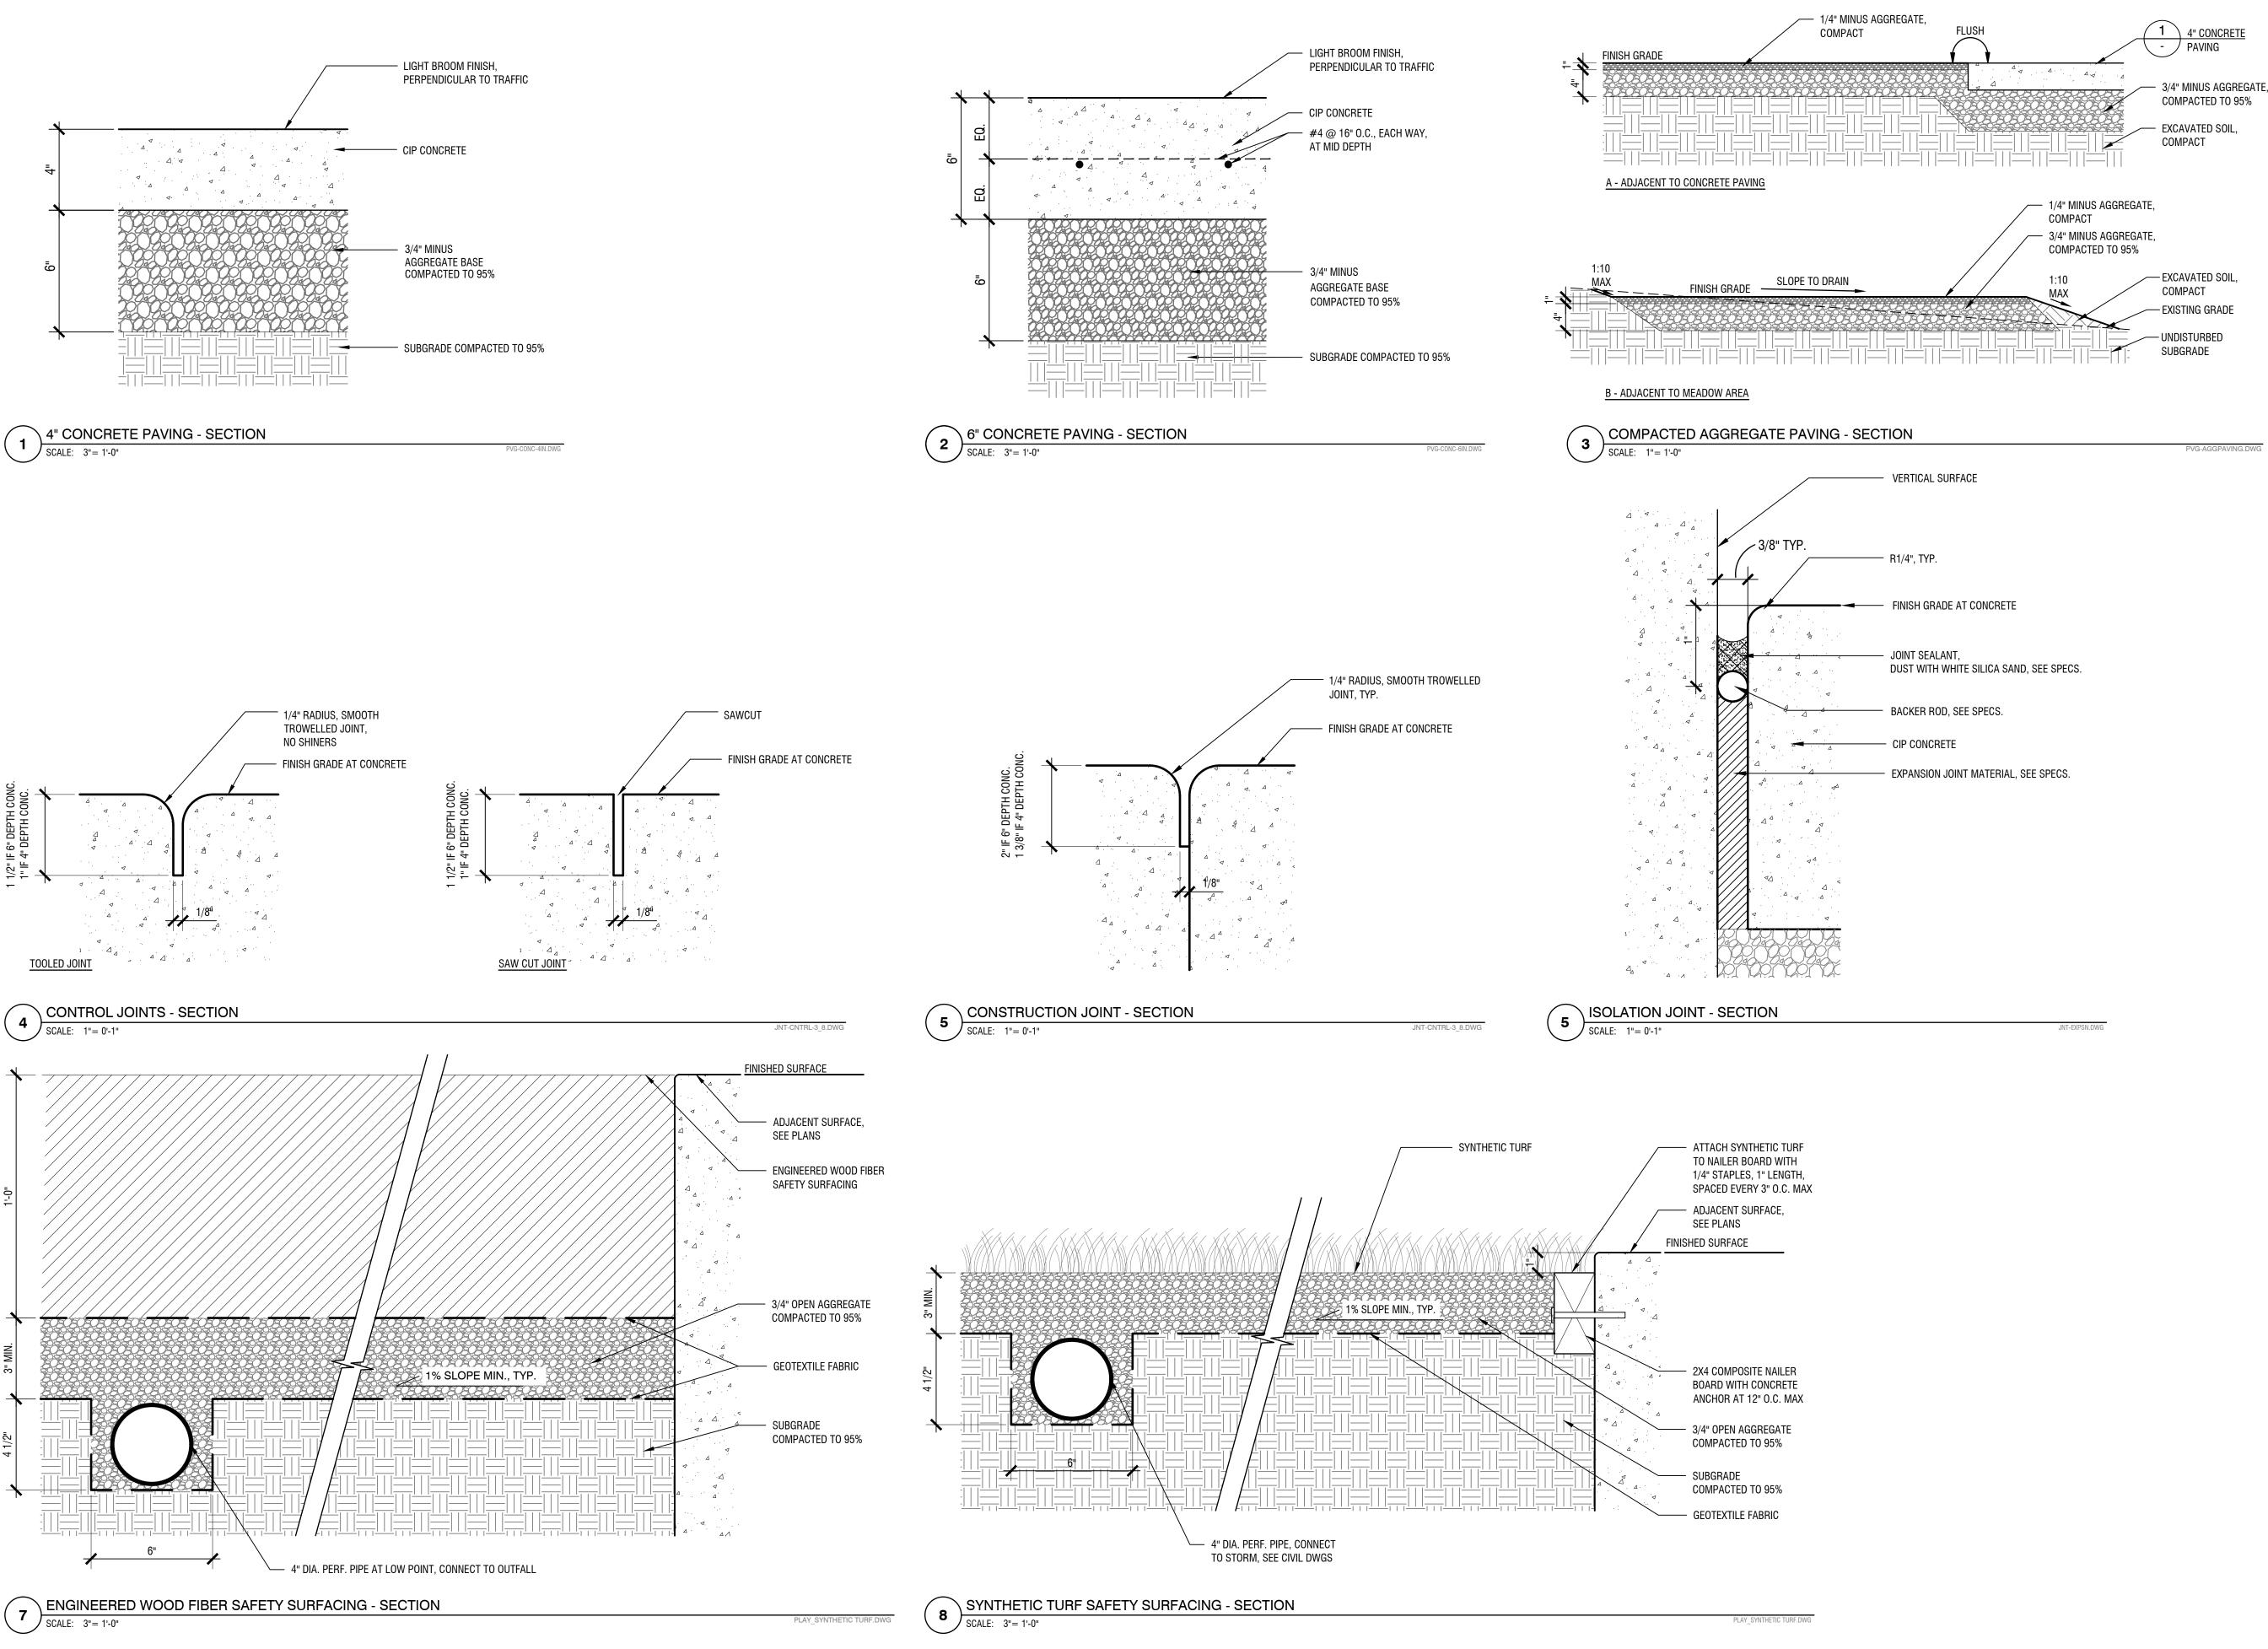
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Project FROG POND NEIGHBORHOOD PARK

Sheet Title

PLANTING PLAN - TREES

L5.01





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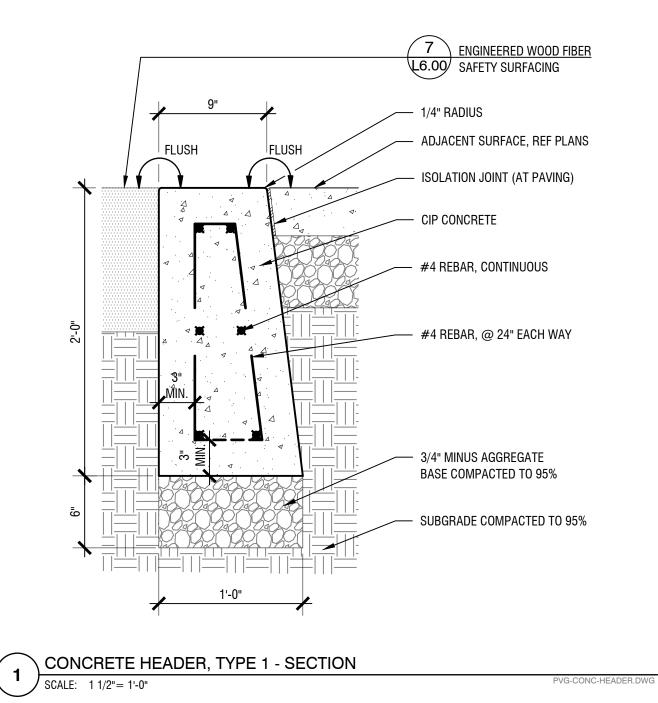
Submittal / Date LAND USE PERMIT REVISED 06.13.2024


Project FROG POND NEIGHBORHOOD PARK

Sheet Title


SITE DETAILS - PAVING

L6.00



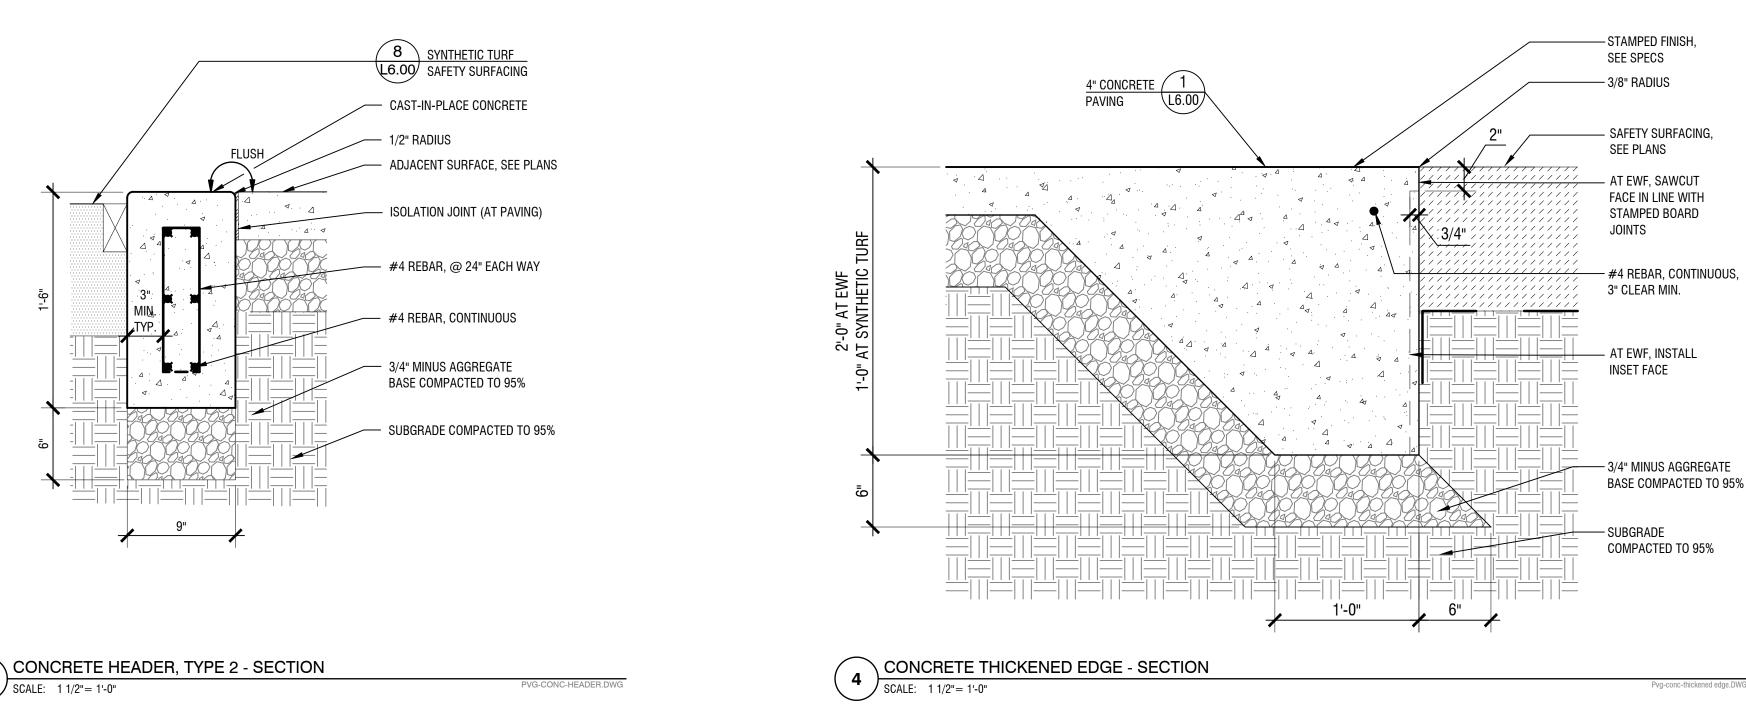

2 SCALE: 1 1/2"= 1'-0"

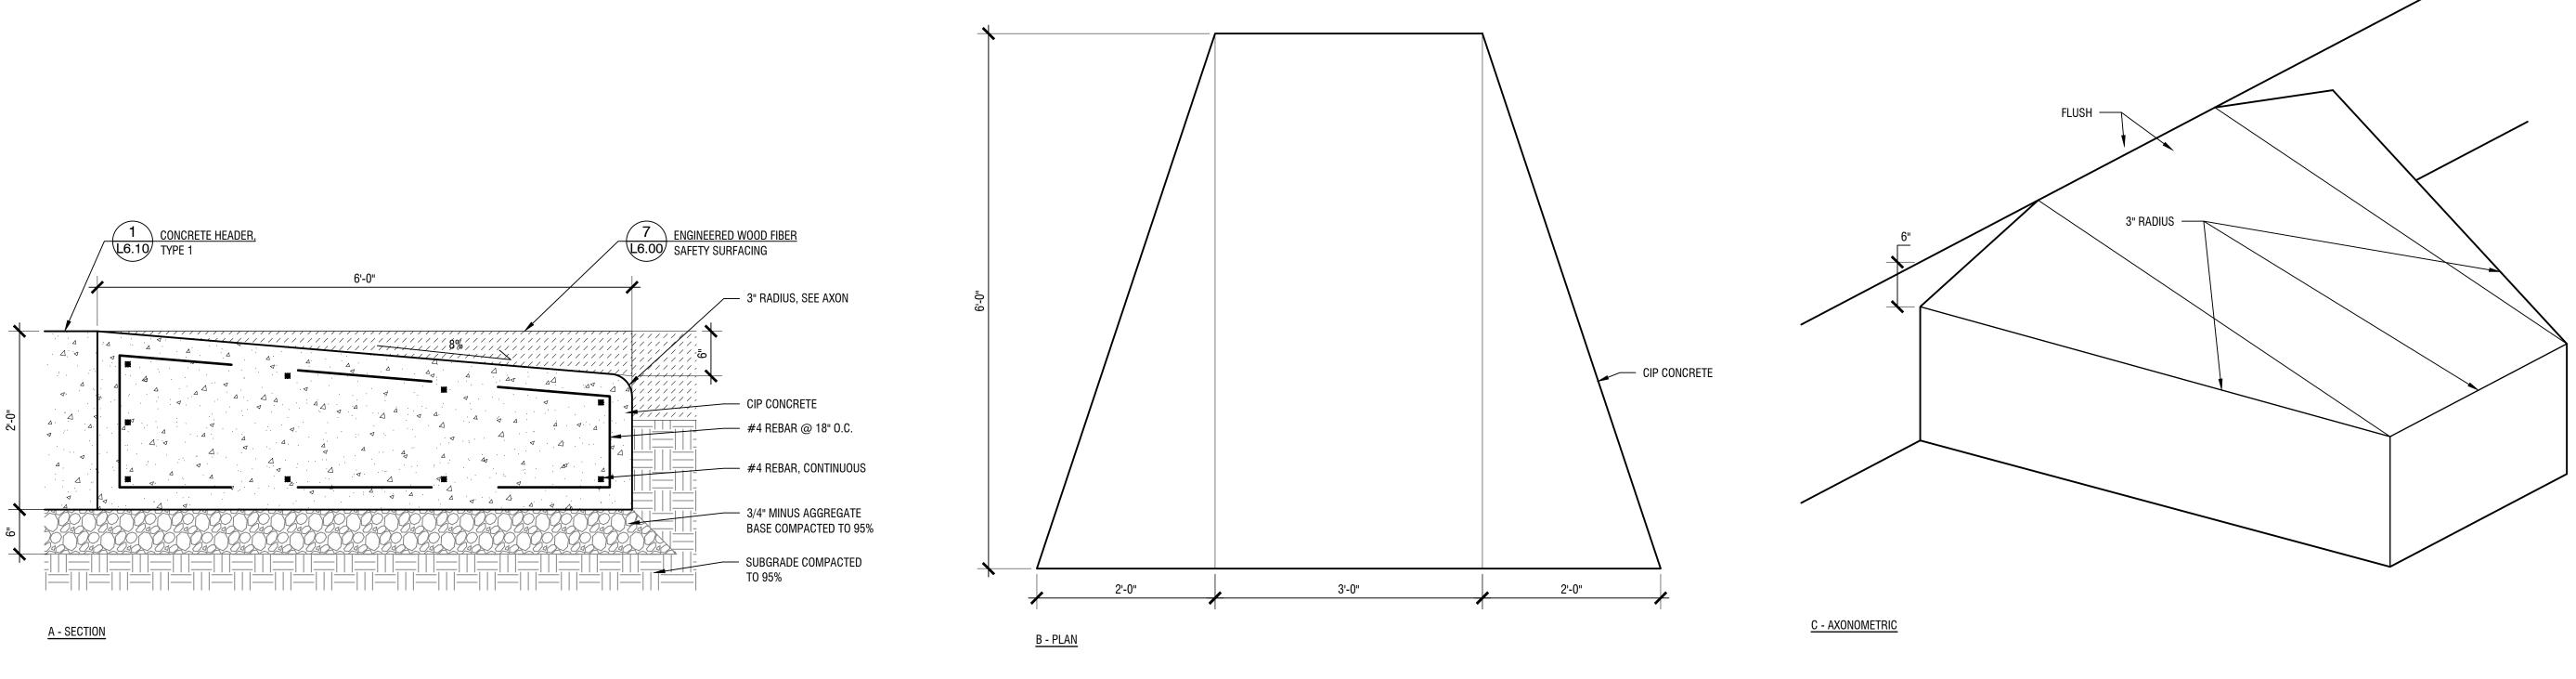

∖ SAFETY SURFACING RAMP (**3**) SCALE: 1"= 1'-0"



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Project FROG POND NEIGHBORHOOD PARK


L6.10


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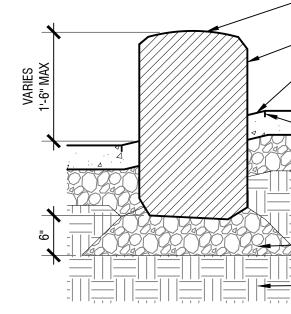
SITE DETAILS -WALLS & CURBS


Sheet No.

pvg-safety surfacing ramp.D



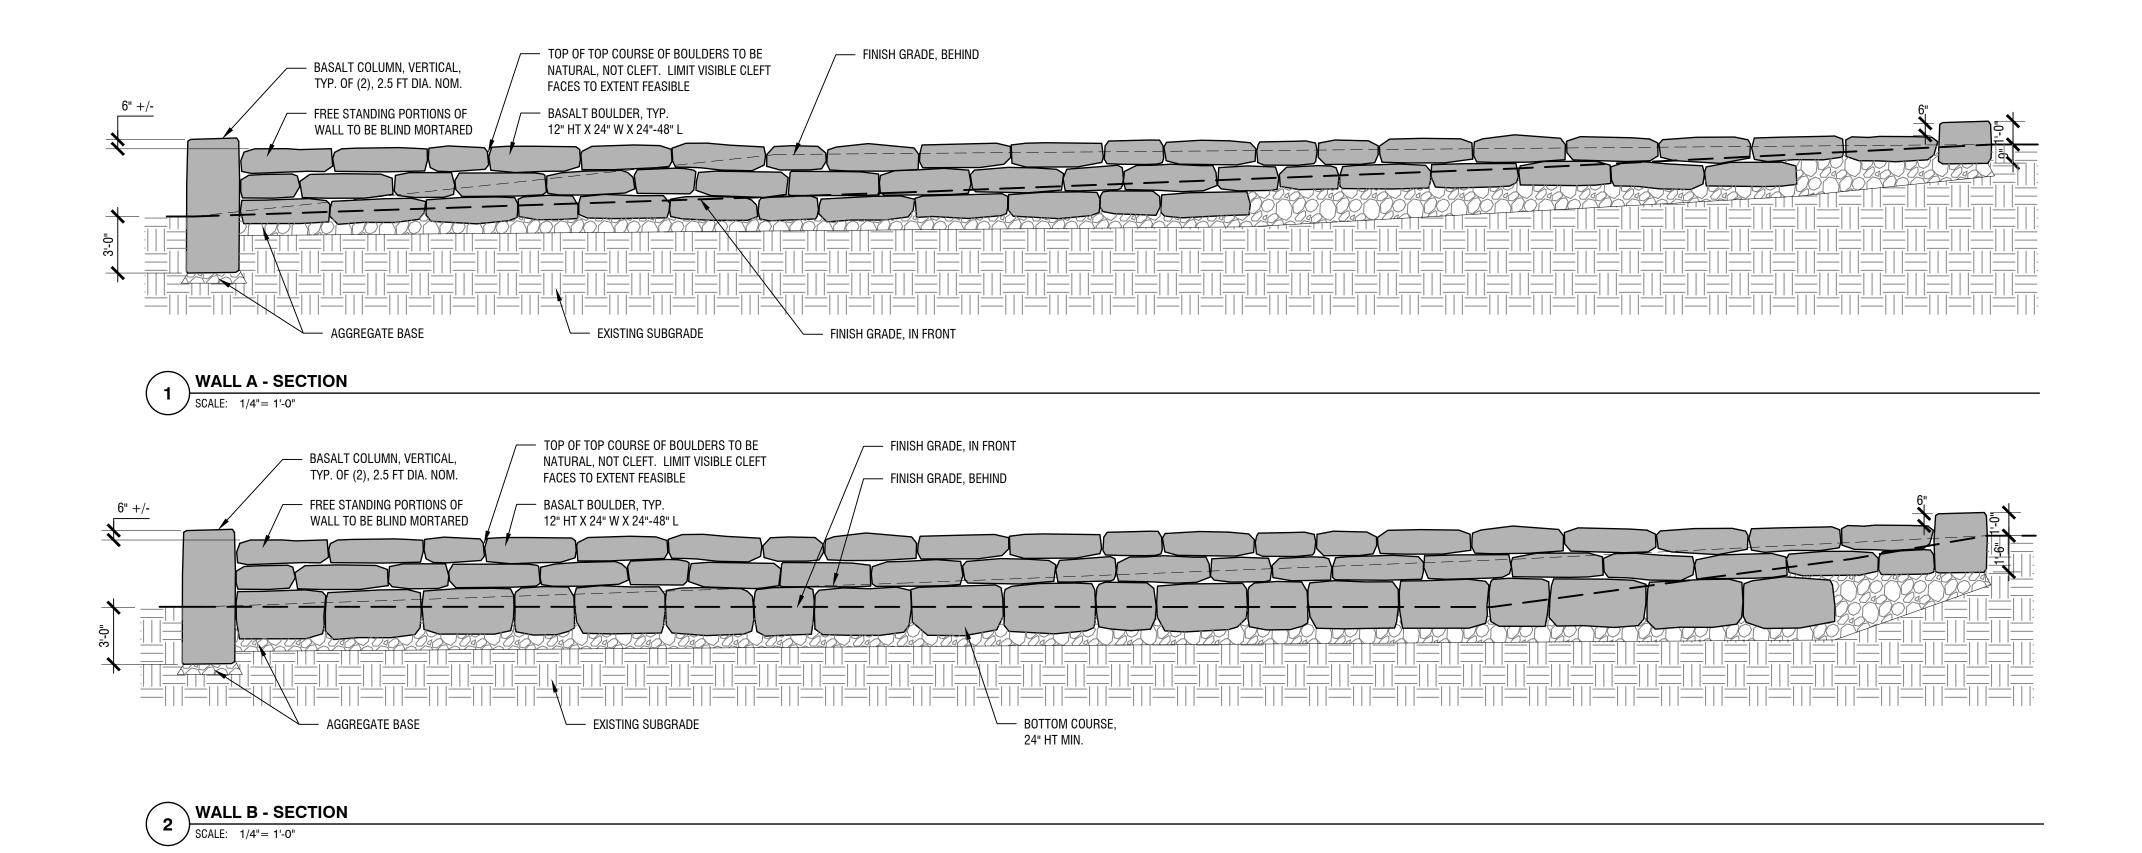


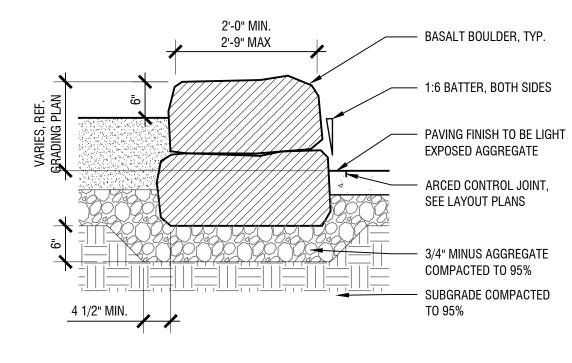

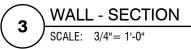

L6.00 SITE DETAILS.DWG

→ BASALT COLUMN, VERTICAL - SECTION 4 SCALE: 3/4"= 1'-0"

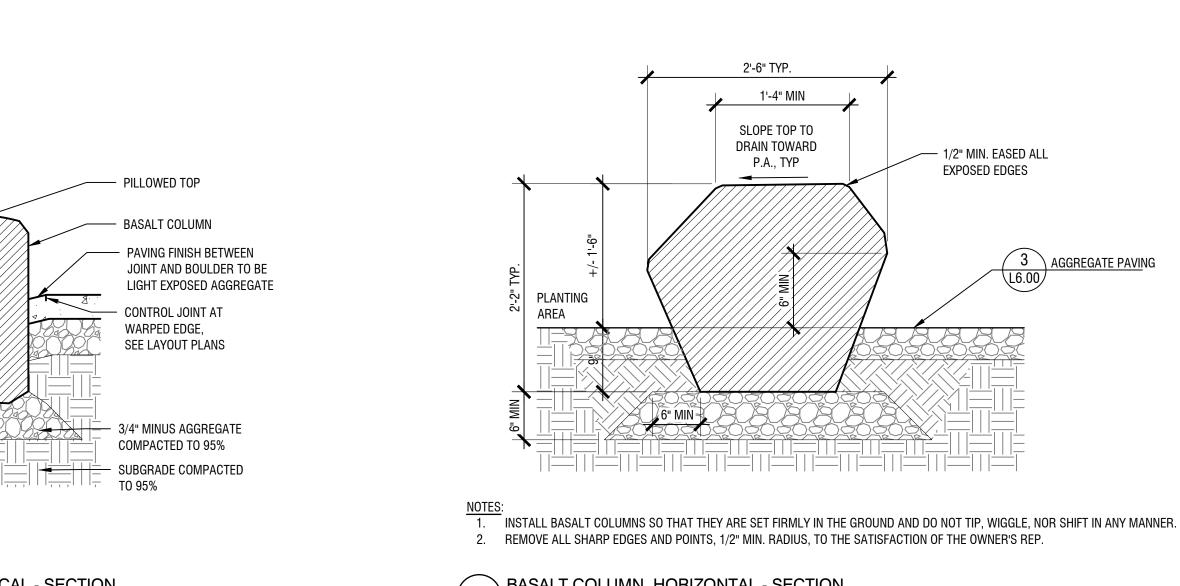

5 BASALT COL SCALE: 1"= 1'-0"

L6.00 SITE DETAILS.DWG

 \uparrow BASALT COLUMN, HORIZONTAL - SECTION



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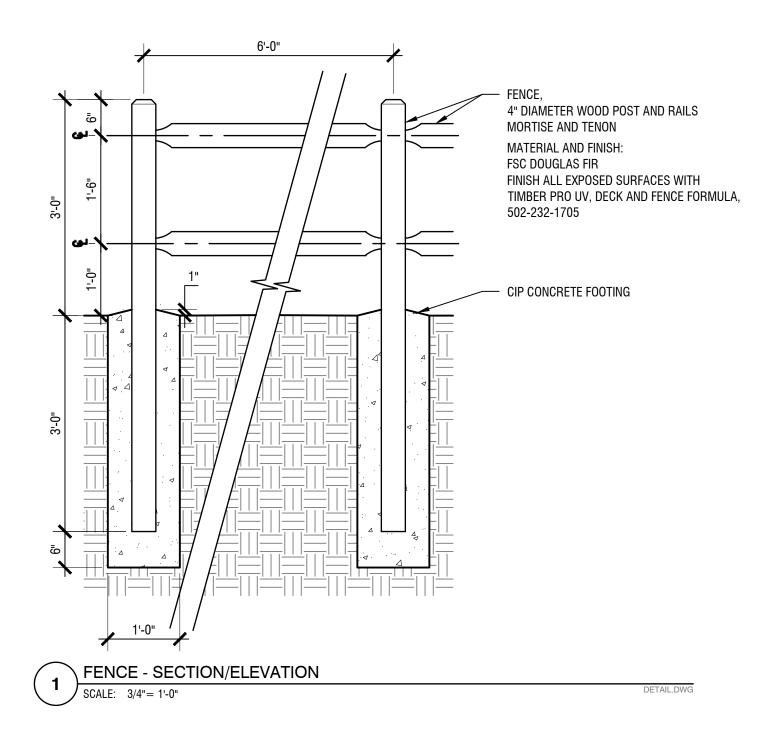
Project FROG POND NEIGHBORHOOD PARK

Sheet Title

SITE DETAILS - WALLS & CURBS

Sheet No.

L6.11





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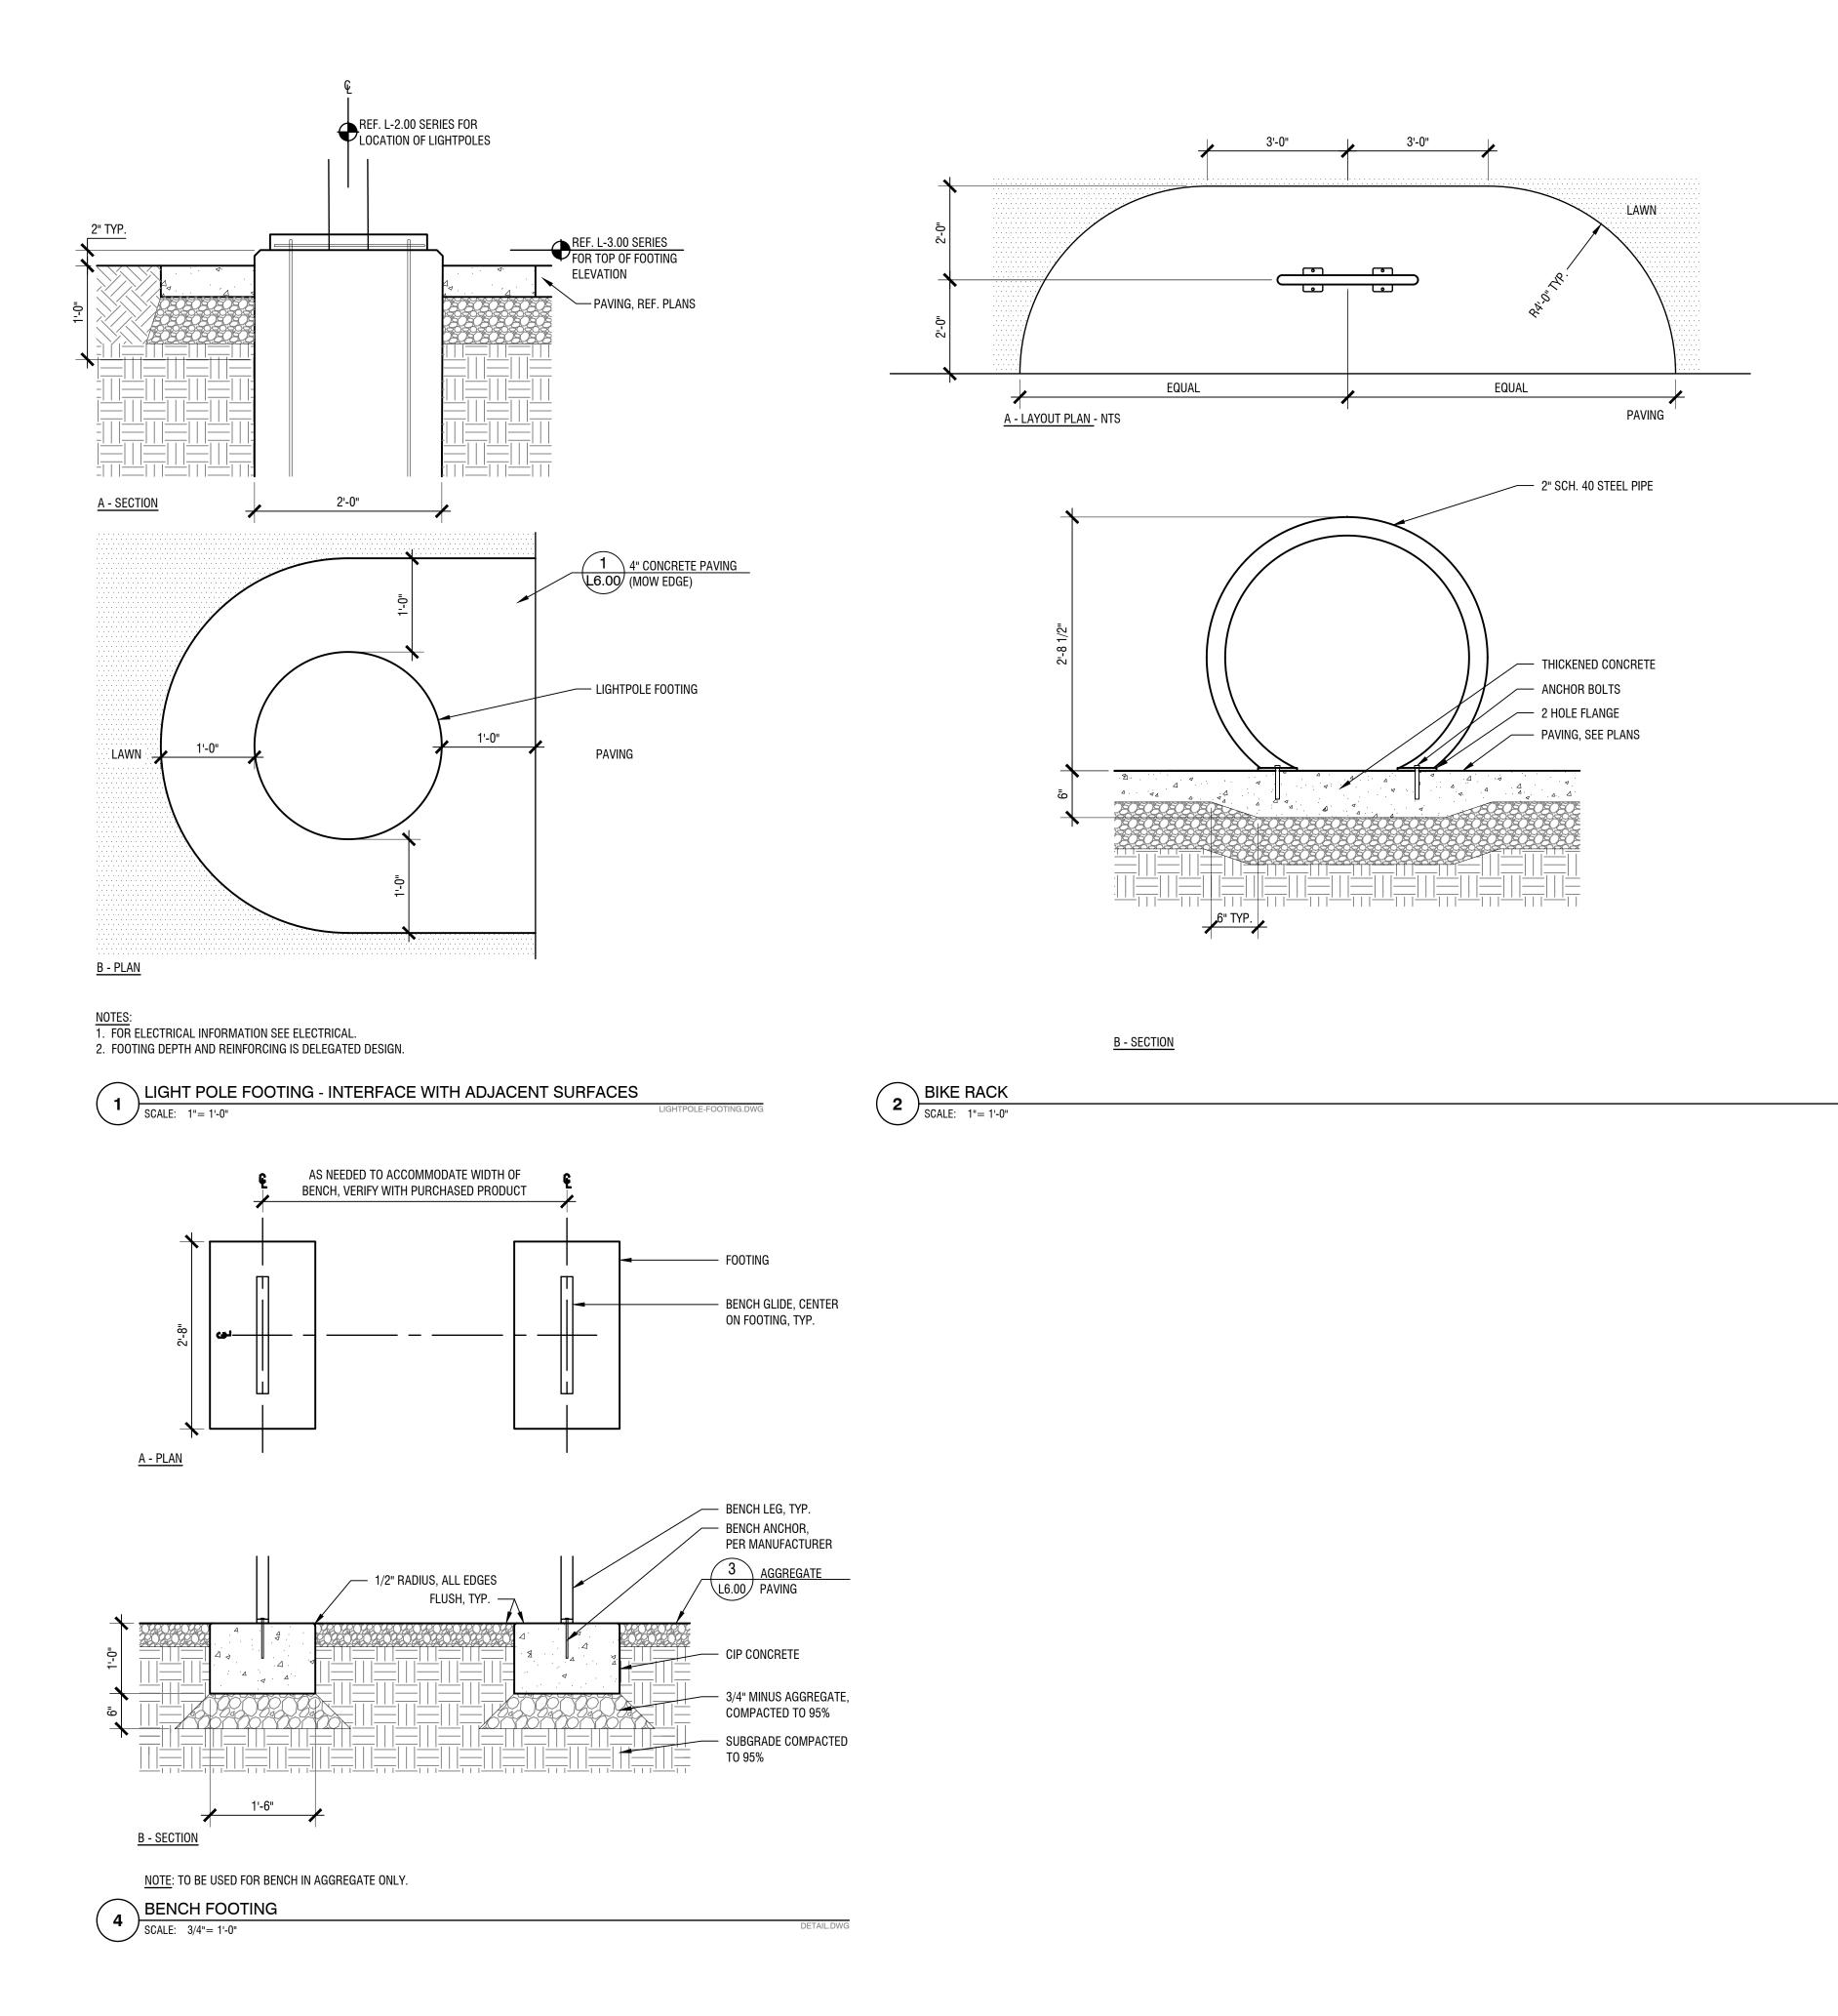
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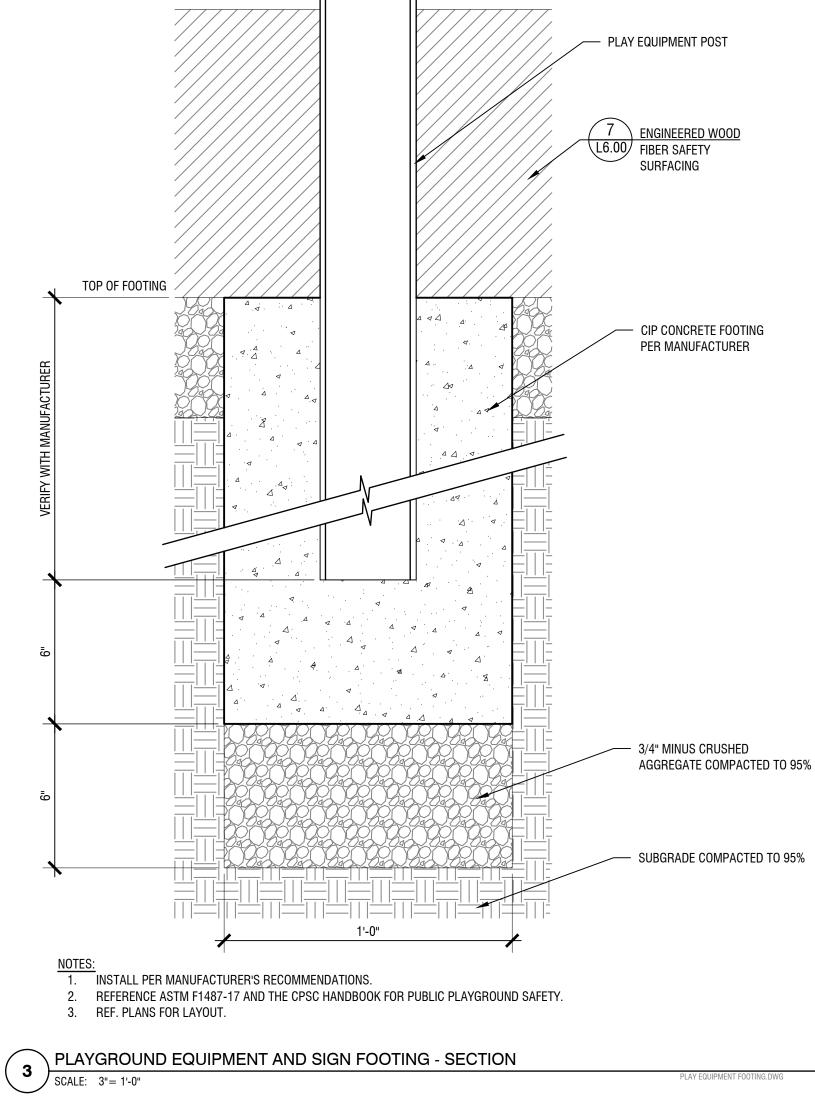
Project FROG POND NEIGHBORHOOD PARK

L6.20

Sheet Title

SITE DETAILS -FENCING







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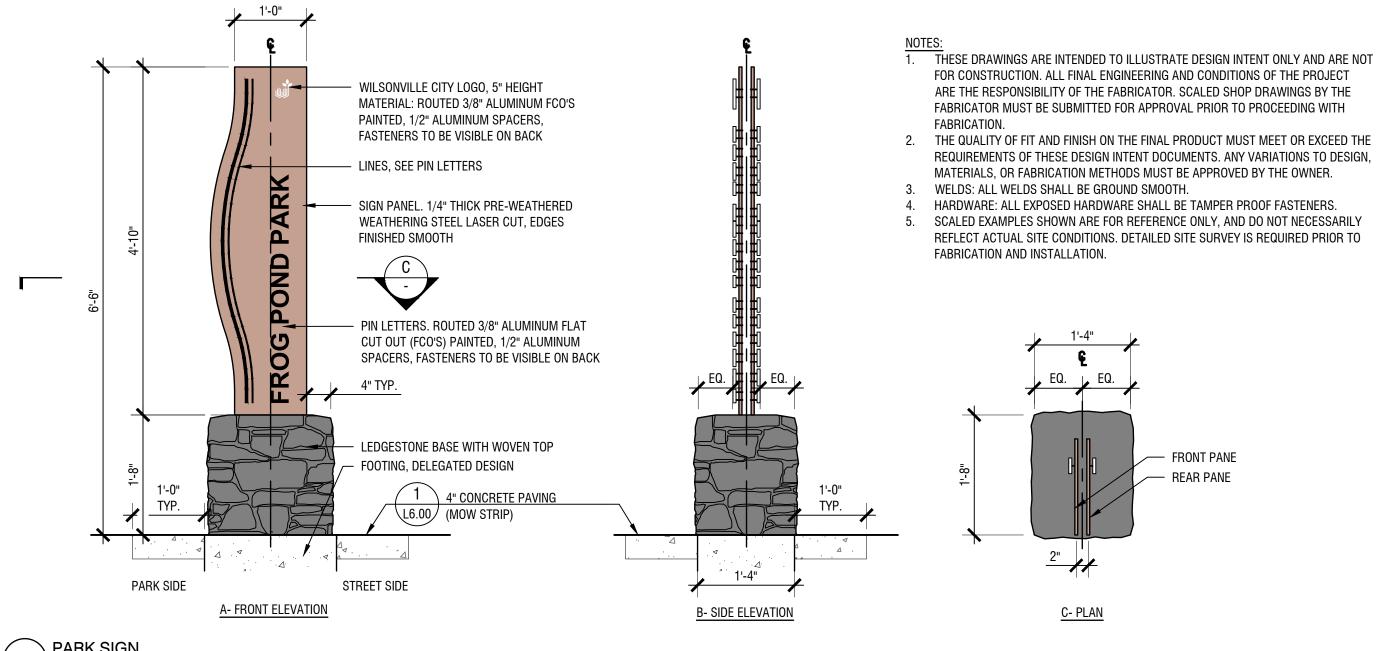
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Project FROG POND NEIGHBORHOOD PARK

Sheet Title


SITE DETAILS - SITE FURNISHINGS






DETAIL.DWG

1 PARK SIGN SCALE: 3/4"= 1'-0"

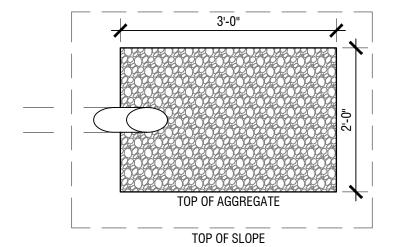


<u>A - PLAN</u>

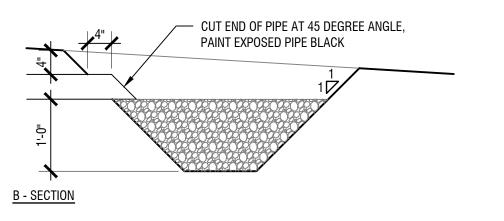

3 OUTFALL SCALE: 3/4"= 1'-0"

SIGN-PARK-SMALL.DWG

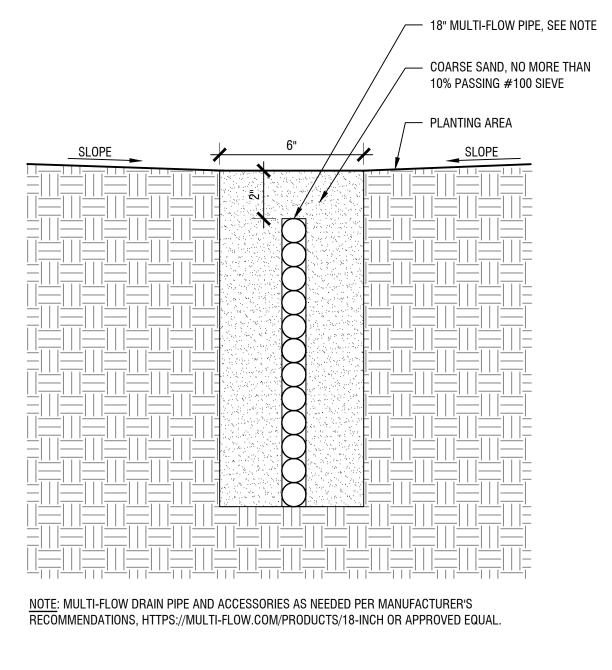

Multi-Flow Drain.DWG





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Project FROG POND NEIGHBORHOOD PARK

Sheet Title

SITE DETAILS -MISCELLANEOUS





picnic shelter - Western Wood Structures treated Douglas fir, powdercoated steel (dark green), standing seam metal roof (dark green)



bench and picnic table - Landscapeforms Gretchen thermally modified ash, powdercoated steel (black)

aged thermally modified ash



bike rack - Huntco Sol surface mounted, powdercoated (black)



grill - Bull Grills 4 burner with counter tile counter and ledger stone base BYO propane tank



waste receptacle - DuMor 70 thermally modified oak powdercoated steel (black)





Rolled bag


pet station - DOGIPOT powder coated aluminum (green)



aged thermally modified oak



Most Dependable Fountain 10145SM powdercoated steel (dark green)

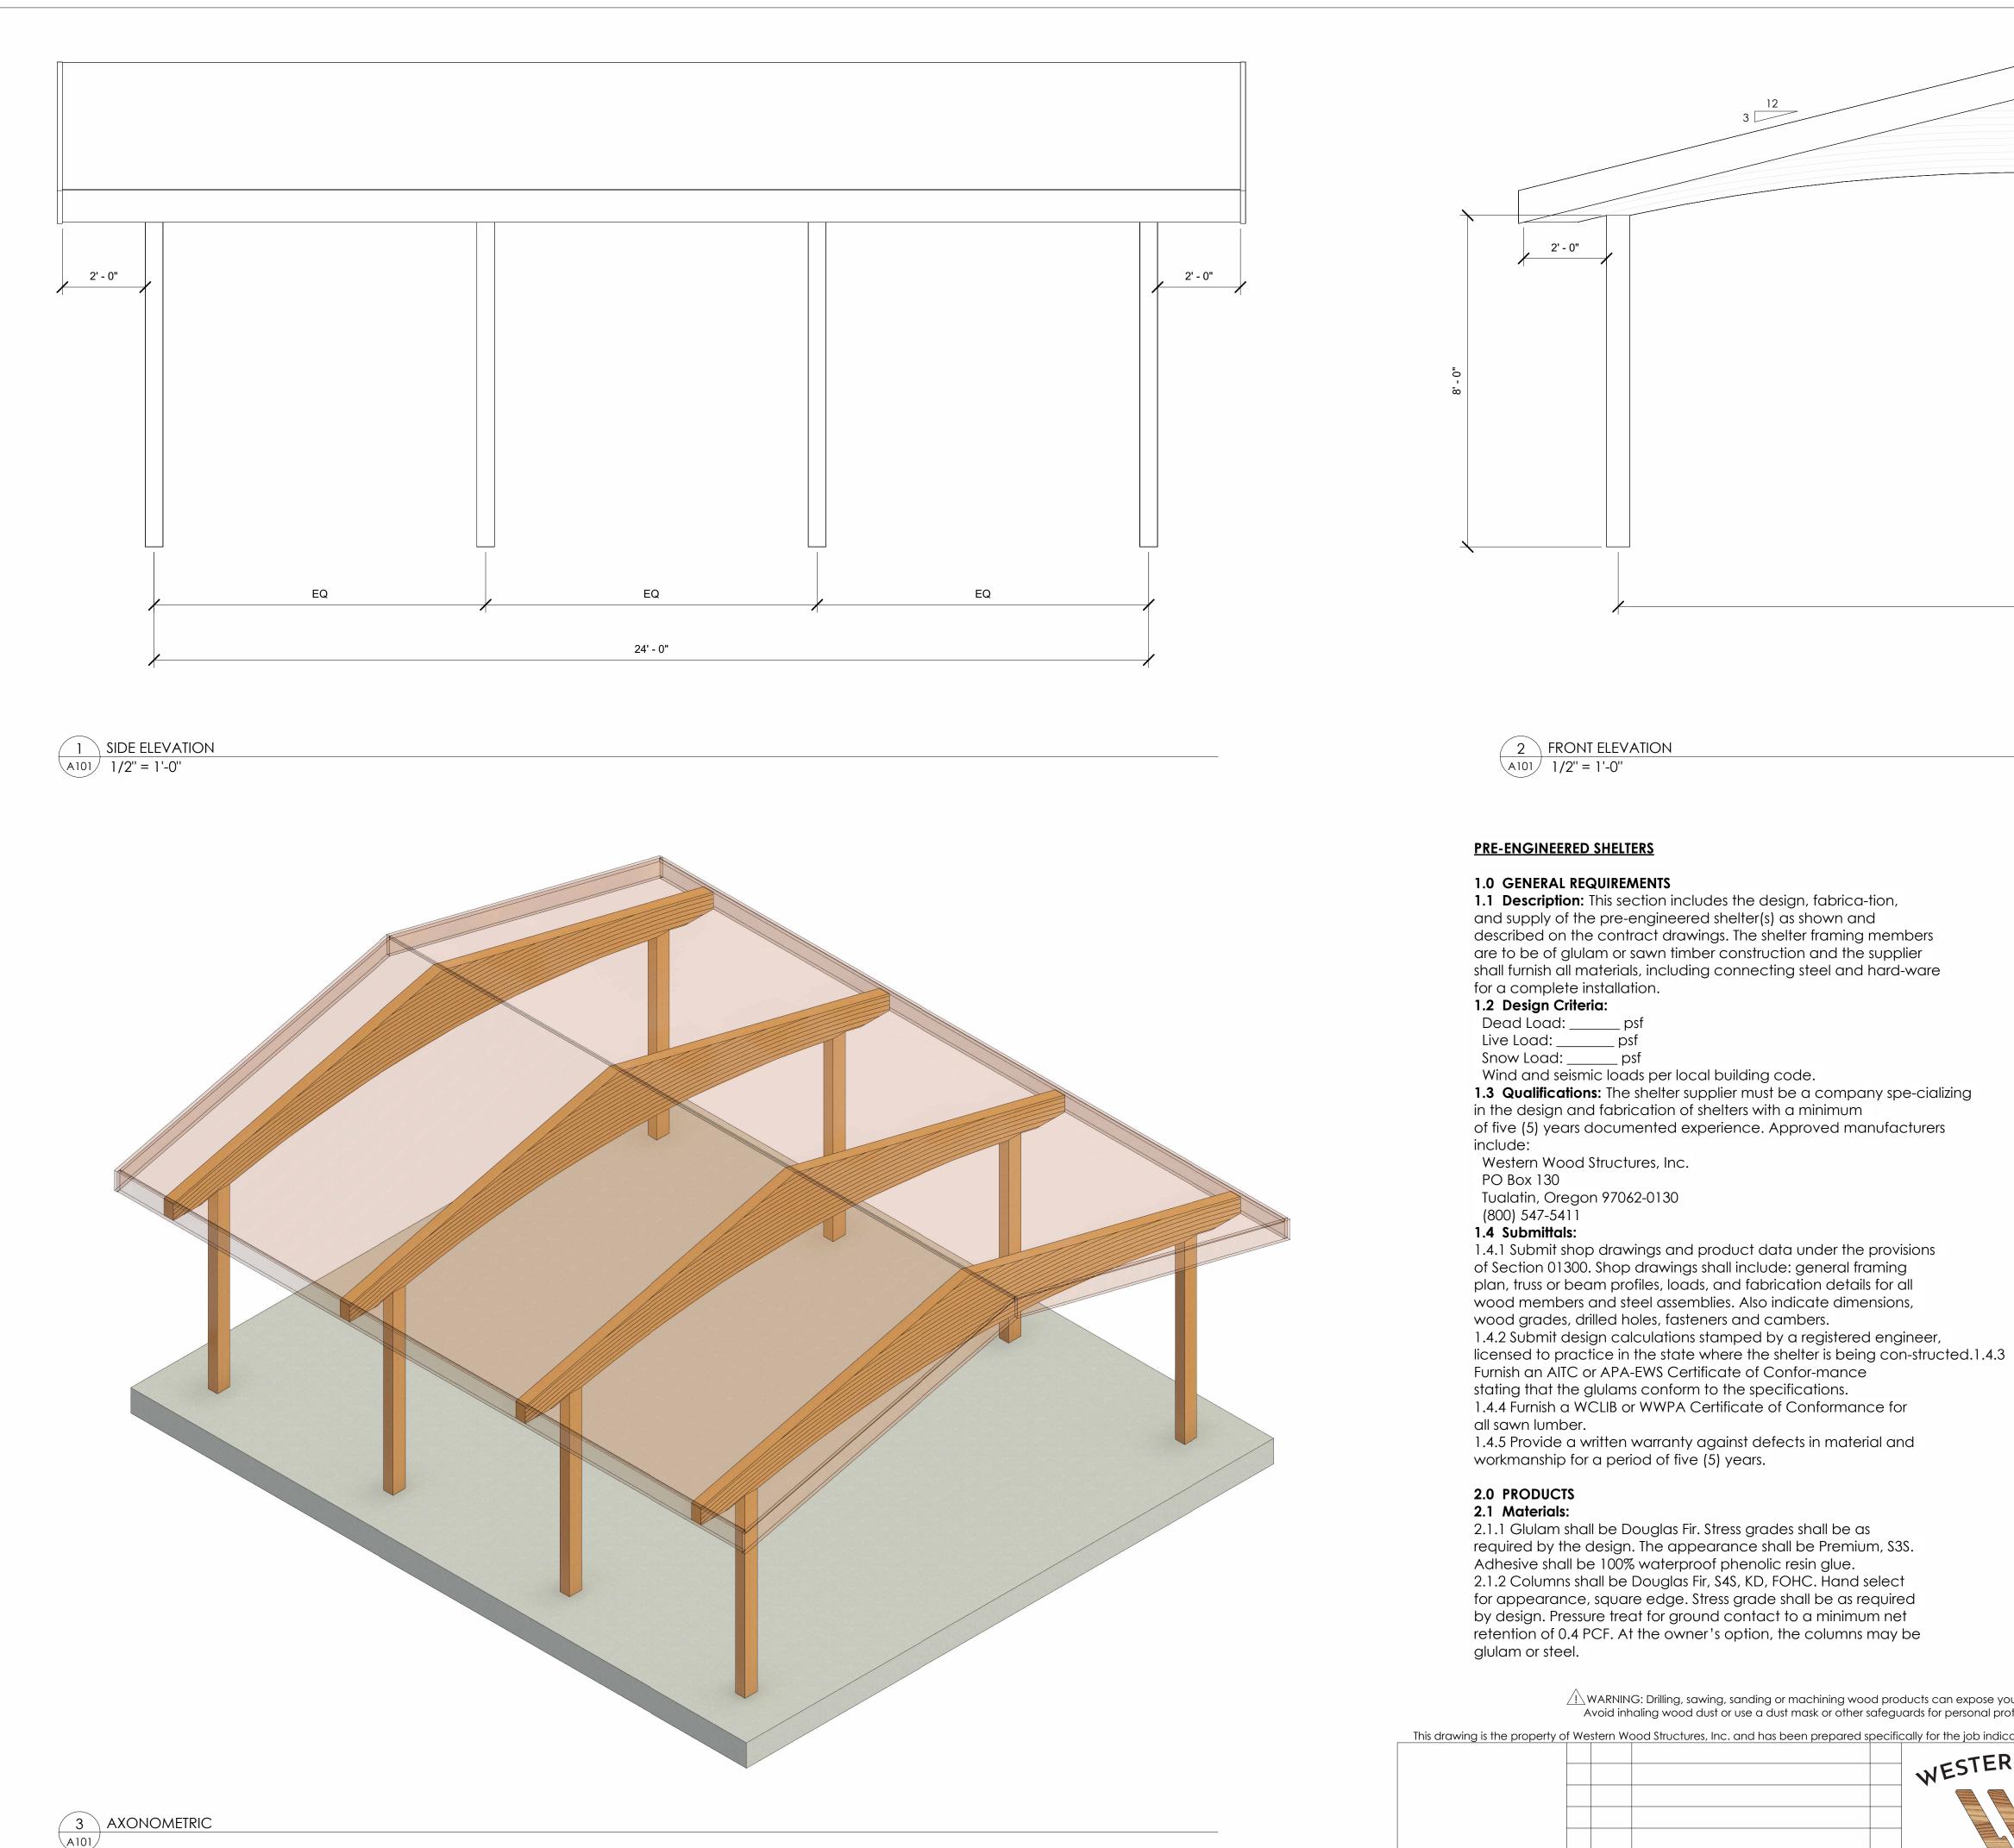

/! WARNING: Drilling, sawing, sanding or machining wood products can expose you to wood dust, a substance known to the State of California to cause cancer. Avoid inhaling wood dust or use a dust mask or other safeguards for personal protection. For more information go to www.P65Warnings.ca.gov/wood This drawing is the property of Western Wood Structures, Inc. and has been prepared specifically for the job indicated. It shall not be reproduced or used on any other project without the written consent of Western Wood Structures, Inc.

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| NO. | DATE | REVISIONS | BY | |
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| ARCHITECT: | | | | | |
|---------------|-----|------|---------|-------------|-------|
| ENGINEER: | | | | | |
| CONTRACTOR: | | | | | |
| DRAWN BY: | BJM | DATE | 3/25/24 | JOB NO. 23- | H-115 |
| CHECKED BY: | | DATE | | PLOT DATE | SHT. |
| DATE PRINTED: | | | | 3/25/24 | OF |
| | | | | | |

for performing work specified. Factory drill all holes to the extent possible using steel as templates. For glulam or sawn mem-bers of 8" nominal width or greater, drill holes from both sides of members to ensure the true hole alignment. 2.2.2 Concealed connector locations shall be fabricated to within 1/8" of true position. Fabricate length of members to be within 1/8" of required length to achieve tight connections. Make end cuts flat and true to ensure consistent load transfer. 3.0 EXECUTION 3.1 Delivery, Storage and Handling: 3.1.1 The purchaser or installer is responsible for handling and protection of shelter framing materials after arrival at destination. All trusses and/or beams shall be unloaded and handled with a forklift or crane using nylon slings. 3.1.2 If the materials are to be stored at the site, they must be placed on a level surface and stickered to prevent warpage and twisting. 3.1.3 Any damage must be reported immediately to the truss manufacturer's professional engineer. 3.2 Installation: 3.2.1 Install the shelter according to supplier 's shop details and installation instructions. Do not field cut, drill, or alter structural members without written approval from the pre-engineered build-ing supplier. Set framing members in locations and to elevations indicated. Make provisions for erection loads and provide tempo-rary bracing to maintain framing members true and plumb, and in true alignment until completion of erection. 3.2.2 Maintain factory-applied wrapping until roof structure is enclosed.

> P.O. Box 130 Tualatin, Oregon 97062

> > 503-692-6900 WWSI.com

20' - 0"

2.1 Materials (continued): 2.1.3 Decking shall be 2"x 6" Douglas Fir Select Dex, S2S, KD, EV1S, Paper Wrap. 2.1.4 Fascia to be Western Red Cedar, KD, S4S. Select for appear-ance.2.1.5 Steel and Hardware. Steel to be ASTM A-36 and hard-ware

to be ASTM A-307. Welding by certified welders per AWS

specifications D1.1. All steel and hardware to be hot-dipped galvanized. 2.2 Fabrication: 2.2.1 The main structural beams and/or trusses are to be fabricated and assembled to the fullest extent possible in a plant with facili-ties

Structures, Inc. 20675 SW 105th Ave

| ARCHITECT: | | | | | | | |
|---------------|-----|------|---------|---------|-----|------|----|
| ENGINEER: | | | | | | | |
| CONTRACTOR: | | | | | | | |
| DRAWN BY: | BJM | DATE | 3/25/24 | JOB NO. | 23- | H-11 | 5 |
| CHECKED BY: | | DATE | | PLOT D/ | ATE | SHT. | |
| DATE PRINTED: | | | | 3/25/ | 24 | 1 | OF |
| | | | | | | | |

Frog Pond Park Fitness



27227 SW Stafford Road | Wilsonville, OR 97070



Buell Recreation

7327 Barnes Road #601 | Portland, OR 97725 | 503-922-1650

OUR MISSION IS TO BRING PLAY THAT MOVES YOU® TO COMMUNITIES AROUND THE WORLD

Proposal 907-180072-1 | 2/8/2024



DESIGN SUMMARY

Buell Recreation is very pleased to present this Proposal for consideration for the Frog Pond Park Fitness located in Wilsonville. BCI Burke Company, LLC has been providing recreational playground equipment for over 100 years and has developed the right mix of world-class capabilities to meet the initial and continuing needs of City of Wilsonville. We believe our proposal will meet or exceed your project's requirements and will deliver the greatest value to you.

The following is a summary of some of the key elements of our Proposal:

- Project Name: Frog Pond Park Fitness
- Project Number: 907-180072-1
- User Capacity: 8
- Age Groups: 13Plus
- Dimensions: 33' 11"x33' 2"
- Designer Name: Pa Der Vang


Buell Recreation has developed a custom playground configuration based on the requirements as they have been presented for the Frog Pond Park Fitness playground project. Our custom design will provide a safe and affordable playground environment that is aesthetically pleasing, full of fun for all users and uniquely satisfies your specific requirements. In addition, proposal # 907-180072-1 has been designed with a focus on safety, and is fully compliant with ASTM F1487 and CPSC playground safety standards.


We invite you to review this proposal for the Frog Pond Park Fitness playground project and to contact us with any questions that you may have.


Thank you in advance for giving us the opportunity to make this project a success.

OUR MISSION IS TO BRING PLAY THAT MOVES YOU TO COMMUNITIES AROUND THE WORLD


Proposal 907-180072-1 | 2/8/2024

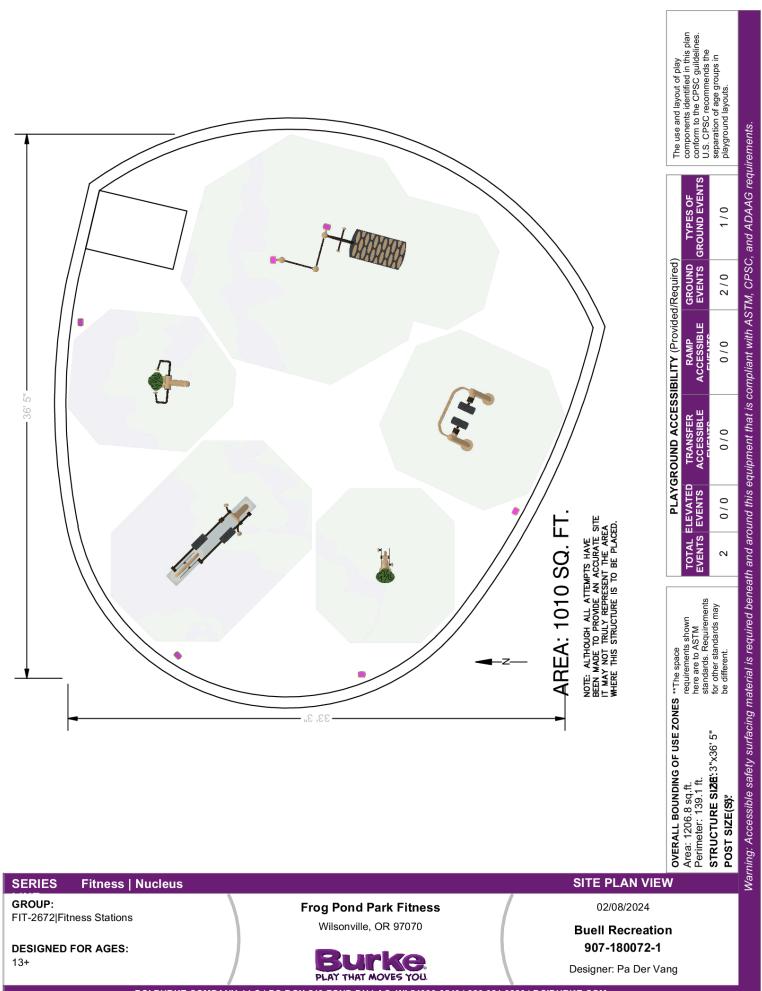

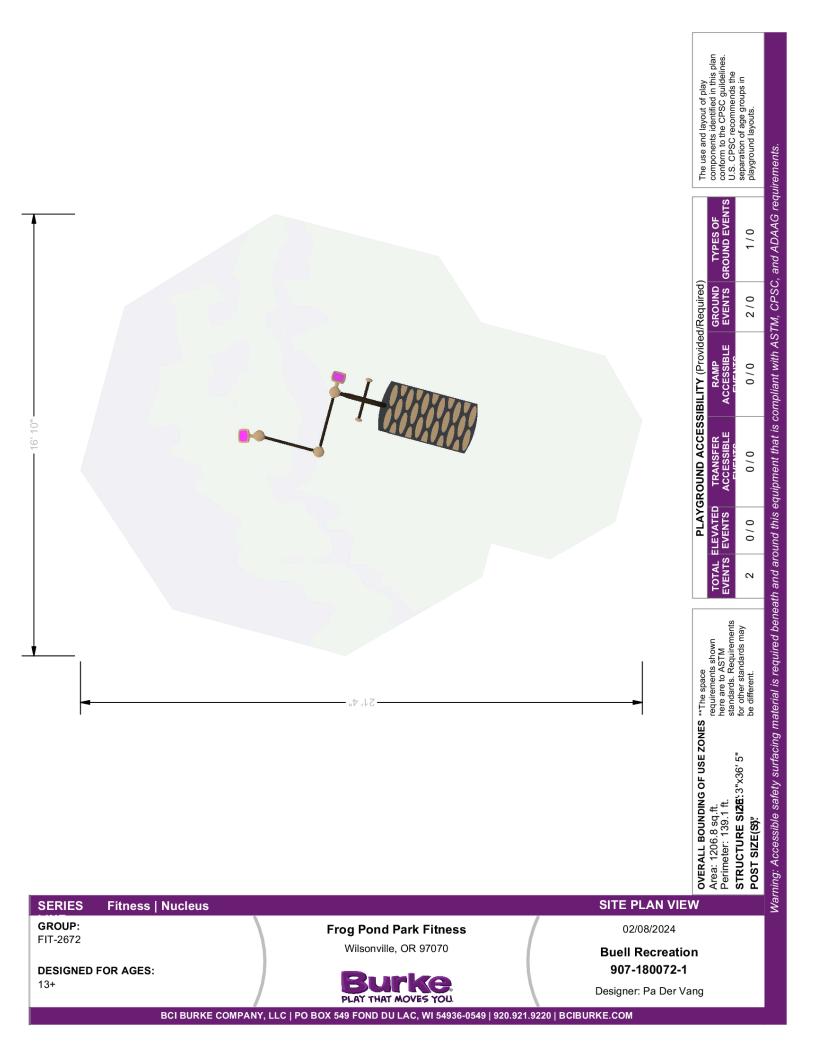

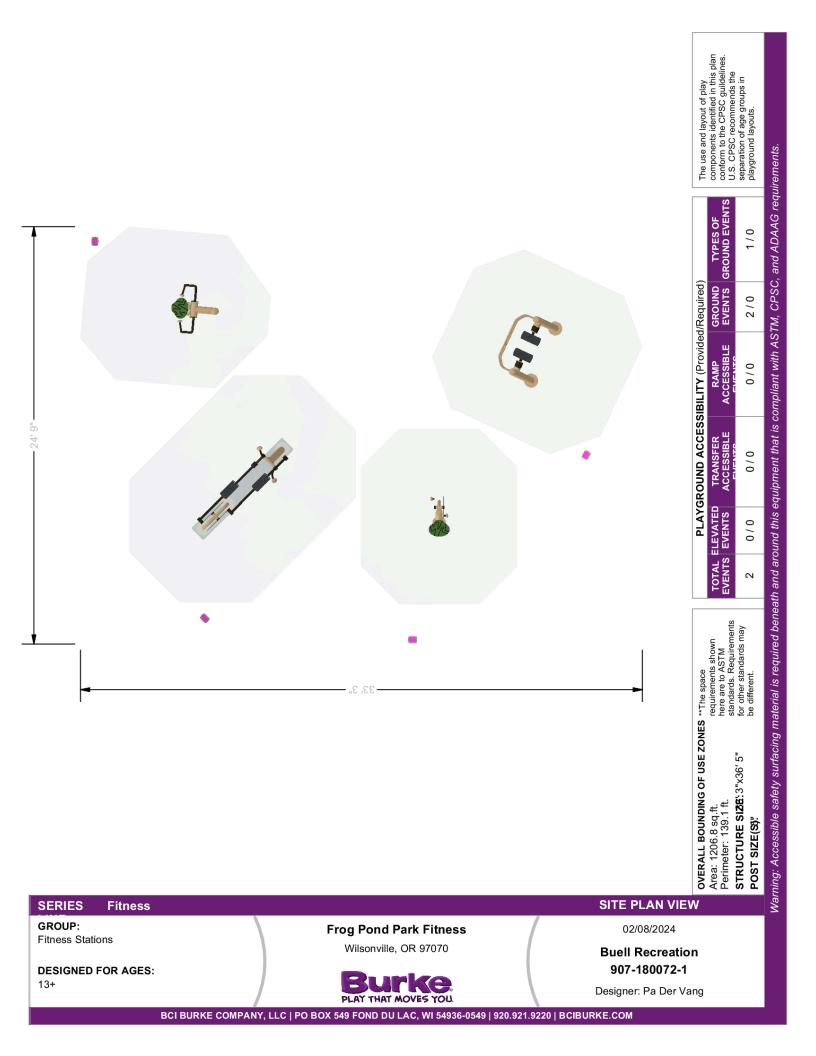


| ITEM COMP. 1 370-1597 STREFCH BEAMS 2 370-1601 CORE STATION 3 570-2659 SIGN, CORE STATION 4 570-2657 SIGN, STREFCH BEAMS |
|--|
|--|

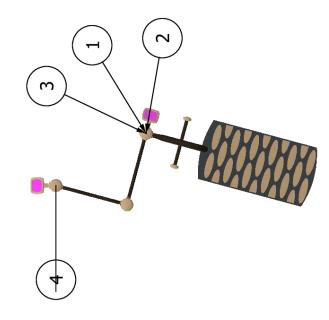


| SERIES Fitness Nucleus | | COMPONENT VIEW |
|---------------------------|---|---|
| GROUP: FIT-2672 | Frog Pond Park Fitness | 02/08/2024 |
| DESIGNED FOR AGES: 13+ | Wilsonville, OR 97070 | Buell Recreation 907-180072-1 Designer: Pa Der Vang |
| BCI BURKE COMPANY, | PLAY THAT MOVES YOU. LLC PO BOX 549 FOND DU LAC, WI 54936-0549 920.921.922 | |

| DESCRIPTION | 570-2690 INVIGORATE FITNESS CHEST PRESS | 570-2698 FS SIGN INVIGORATE CHEST PRESS | 570-2686 INVIGORATE FITNESS ELLIPTICAL | 570-2700 FS SIGN INVIGORATE ELLIPTICAL | 570-2691 INVIGORATE FITNESS STRIDER | 570-2697 FS SIGN INVIGORATE STRIDER | 570-2730 INVIGORATE HAND CYCLE | 570-2731 FS SIGN, INVIGORATE HAND CYCLE |
|-------------|---|---|--|--|-------------------------------------|-------------------------------------|--------------------------------|---|
| COMP. | 570-269(| 570-2698 | 570-2686 | 570-270(| 570-269 | 570-2697 | 570-273(| 570-273 |
| ITEM | 1 | 2 | 3 | 4 | 5 | 9 | 7 | 8 |



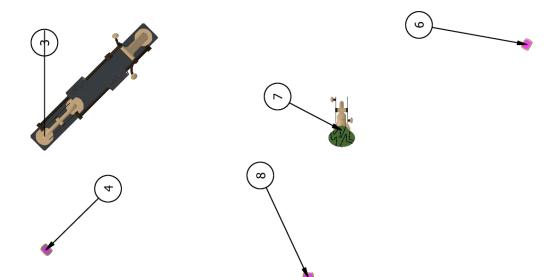



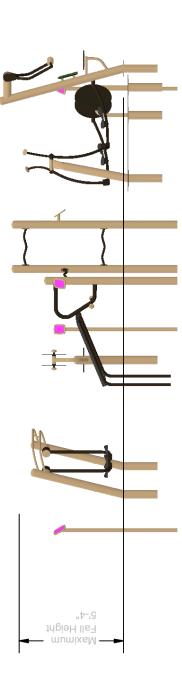

Overall Max Height 6'-5"

SERIES Fitness | Nucleus

GROUP: FIT-2672|Fitness Stations

DESIGNED FOR AGES: 13+

Frog Pond Park Fitness

Wilsonville, OR 97070




ELEVATION VIEW


02/08/2024

Buell Recreation 907-180072-1


Designer: Pa Der Vang

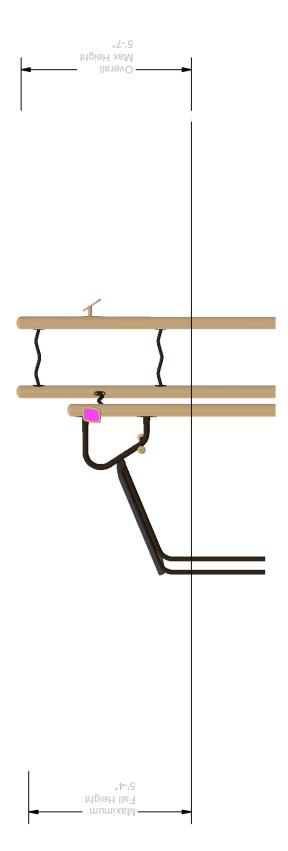

| SERIES Fitness Nucleus | | | |
|--------------------------|-------------------------------|-----------------------|--|
| GROUP: FIT-2672 | Frog Pond Park Fitness | 02/08/2024 | |
| F11=2072 | Wilsonville, OR 97070 | Buell Recreation | |
| DESIGNED FOR AGES: | Bunko | 907-180072-1 | |
| 13+ | Burke. PLAY THAT MOVES YOU | Designer: Pa Der Vang | |

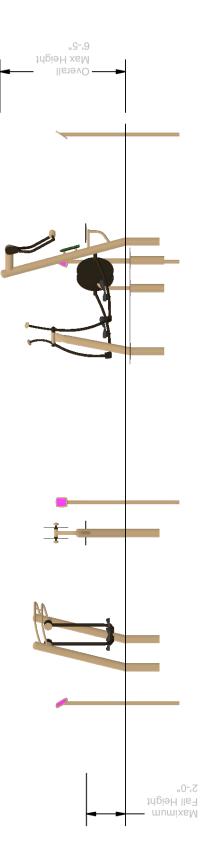



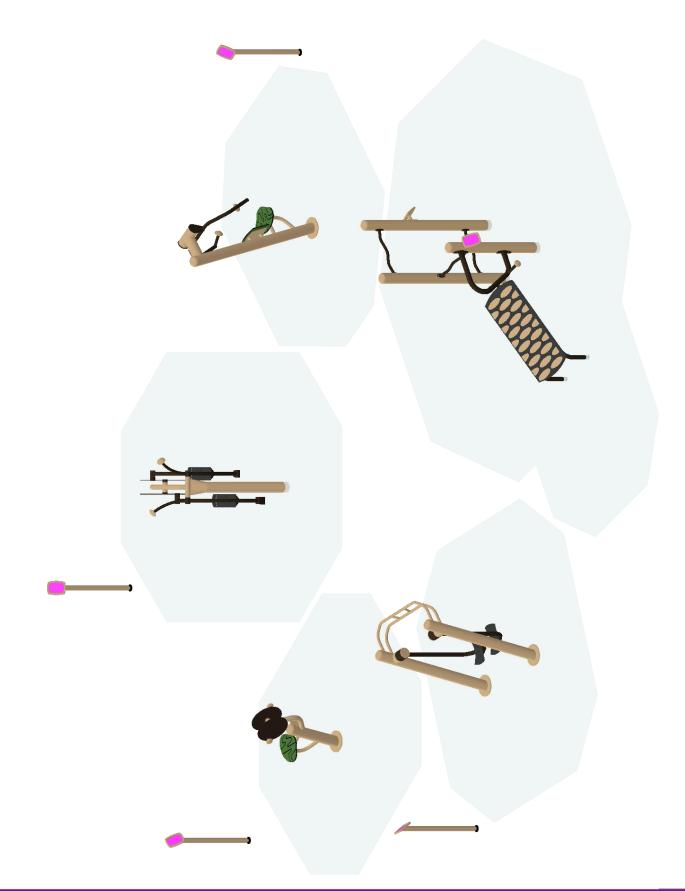

SERIES Fitness | Nucleus

GROUP: FIT-2672|Fitness Stations

DESIGNED FOR AGES: 13+

Frog Pond Park Fitness

Wilsonville, OR 97070



ISOMETRIC VIEW

02/08/2024

Buell Recreation 907-180072-1

Designer: Pa Der Vang

| ALY |
|------|
| |
| 100- |

SERIES Fitness | Nucleus

DESIGNED FOR AGES:

GROUP: FIT-2672

Frog Pond Park Fitness

Wilsonville, OR 97070



ISOMETRIC VIEW


02/08/2024

Buell Recreation 907-180072-1

Designer: Pa Der Vang

BCI BURKE COMPANY, LLC | PO BOX 549 FOND DU LAC, WI 54936-0549 | 920.921.9220 | BCIBURKE.COM

13+

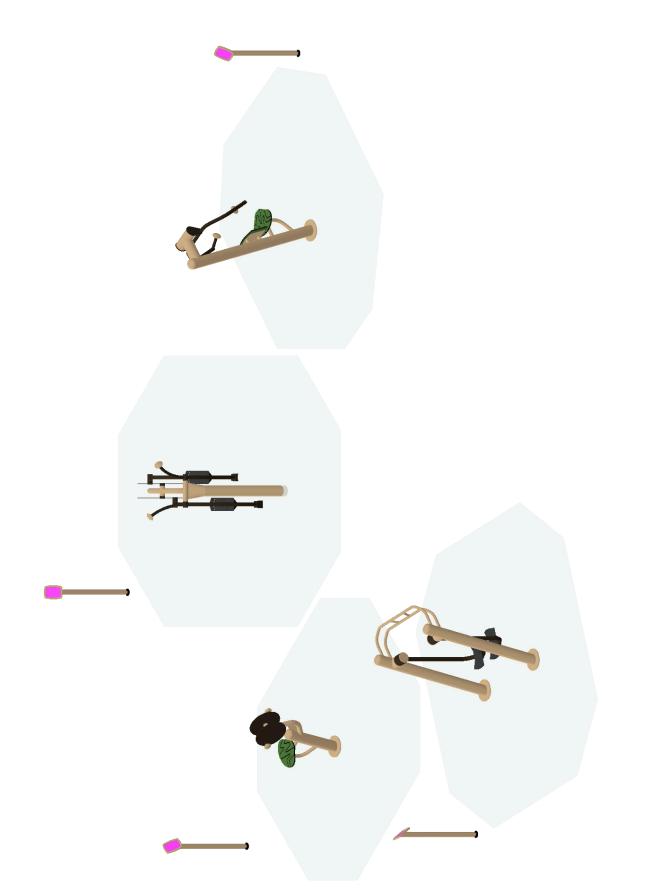

SERIES Fitness

GROUP: Fitness Stations

DESIGNED FOR AGES: 13+

Frog Pond Park Fitness Wilsonville, OR 97070




ISOMETRIC VIEW

02/08/2024

Buell Recreation 907-180072-1

Designer: Pa Der Vang

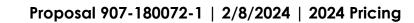

The play components identified in this proposal are IPEMA certified. The use and layout of these components conform to the requirements of ASTMF1487. To verify product certification, visit <u>www.ipema.org</u>.



The space requirements shown in this proposal are to ASTM standards. Requirements for other standards may be different.

FS SIGN, INVIGORATE HAND CYCLE

| Component | No. Description | Qty | User Cap | Ext. User Cap | Weight Ex | t. Weight |
|----------------------|---|----------|----------|---------------|------------|-----------|
| | | FIT-20 | 672 | | | |
| | | | | | | |
| Fitness | | 1 | 0 | 0 | 0 | 0 |
| 370-1597 370-1601 | STRETCH BEAMS CORE STATION | 1 | 2 1 | 2 1 | 9 126 | 9 126 |
| 570-1601 | SIGN, STRETCH BEAMS | 1 | 0 | 0 | 9.5 | 9.5 |
| 570-2659 | SIGN, CORE STATION | 1 | 0 | 0 | 7.5 9.5 | 9.5 |
| 600-0104 | NPPS SUPERVISION SAFETY KIT | 1 | 0 | 0 | 3 | 3 |
| 660-0103 | MAINTENANCE KIT, STRUCTURE | 1 | 0 | 0 | 7 | 7 |
| 660-0104 | INSTALLATION KIT, STRUCTURE | 1 | 0 | Ő | 5 | 5 |
| | | | - | - | - | - |
| | | FIT-2 | 672 | | | |
| Nucleus | | | | | | |
| 072-0500-100 | DC 5" OD X 100" CAPPED POST | 2 | 0 | 0 | 53 | 106 |
| 072-0500-800 | C 5" OD X 80" CAPPED POST | 1 | 0 | 0 | 42 | 42 |
| | | | | | | |
| | F | itness S | tations | | | |
| Fitness | | - | | | | 007 |
| 570-2686 | INVIGORATE FITNESS ELLIPTICAL | 1 |] | 1 | 297 | 297 |
| 570-2690 | INVIGORATE FITNESS CHEST PRESS | | | 1 | 154 | 154 |
| 570-2691 | INVIGORATE FITNESS STRIDER | 1 | | 1 | 200 | 200 |
| 570-2697 570-2698 | FS SIGN INVIGORATE STRIDER FS SIGN INVIGORATE CHEST PRESS | 1 | 0 | 0 | 24 24 | 24 24 |
| 570-2698 | FS SIGN INVIGORATE CHEST PRESS FS SIGN INVIGORATE ELLIPTICAL | 1 | 0 0 | 0 0 | 24 25 | 24 25 |
| 570-2700 | INVIGORATE HAND CYCLE | 1 | 2 | 2 | 25 98 | 25 98 |
| 5/0-2/50 | INVIGORATE HAND CTCLE | I | Z | Z | 70 | 70 |

Special Notes:

570-2731

Prices do not include freight, unloading, material storage, site excavation/preparation, removal of existing equipment, removal of excess soil from footing holes, site security, safety surfacing, installation, or sales tax (if applicable). Prices are based on standard colors per CURRENT YEAR BCI Burke Catalog. Custom colors, where available, would be an extra charge. **Pricing is valid for 30 days from the date of this proposal.**

1

0

0

25

25





Proposal 907-180072-1 | 2/8/2024 | 2024 Pricing

COLOR SELECTION LIST | Default Color Option

| GROUP 1 (FIT-2672) | | | | |
|--------------------|-------|--|--|--|
| Acc: | Brown | | | |
| Post: | Tan | | | |
| Flat: | Tan | | | |

GROUP 2 (Fitness Stations)

Post: Tan Panel: Olive-Black-Olive Acc: Brown

Flat: Tan

COLORS THAT MOVE YOU



BURKE GENERATIONS WARRANTY®

The Longest and Strongest warranty in the industry

BCI Burke Company, LLC ("Burke") warrants that all standard products are warranted to be free from defects in materials and workmanship, under normal use and service, for a period of one (1) year from the date of shipment.

We stand behind our products. In addition, the following products are warranted, under normal use and service from the date of shipment as follows:

- One Hundred (100) Year Limited Warranty on aluminum and steel upright posts (including Intensity[®], Synergy[™], Nucleus[®], Voltage[®], Little Buddies[®], ELEVATE[®], ACTIVATE[®], INVIGORATE[™]) against structural failure due to corrosion, deterioration or workmanship.
- One Hundred (100) Year Limited Warranty on KoreKonnect® clamps against structural failure due to corrosion, deterioration or workmanship.
- One Hundred (100) Year Limited Warranty on Hardware (nuts, bolts, washers)
- One Hundred (100) Year Limited Warranty on bolt-through fastening and clamp systems (Synergy™, Intensity®, Nucleus®, Voltage®, Little Buddies®, ELEVATE®).
- Twenty-Five (25) Year Limited Warranty on spring assemblies and aluminum cast animals.
- Fifteen (15) Year Limited Warranty on structure platforms and decks, metal roofs, table tops, bench tops, railings and barriers against structural failure due to materials or workmanship.
- Fifteen (15) Year Limited Warranty on all plastic components including StoneBorders against structural failure due to materials or workmanship.
- Ten (10) Year Limited Warranty on ShadePlay Canopies fabric, threads, and cables against degradation, cracking or material breakdown resulting from ultra-violet exposure, natural deterioration or manufacturing defects. This warranty is limited to the design loads as stated in the specifications.
- Ten (10) Year Limited Warranty on NaturePlay[®] Boulders and GFRC products against structural failure due to natural deterioration or workmanship. Natural wear, which may occur with
 any concrete product with age, is excluded from this warranty
- Ten (10) Year Limited Warranty on Full Color Custom Signage against manufacturing defects that cause delamination or degradation of the sign. Full Color Custom Signs also carry a two (2) year warranty against premature fading of the print and graphics on the signs.
- Five (5) Year Limited Warranty on Intensity® and RopeVenture® cables and LEVEL X® flex bridge against premature wear due to natural deterioration or manufacturing defects. Determination of premature wear will be at the manufacturer's discretion.
- Five (5) Year Limited Warranty on moving parts, including swing components, against structural failure due to materials or workmanship.
- Five (5) Year Limited Warranty on PlayEnsemble® cables and mallets against defects in materials and workmanship.
- Three (3) Year Limited Warranty on electronic panel speakers, sound chips and circuit boards against electronic failure caused by manufacturing defects.

The warranty stated above is valid only if the equipment is erected in conformity with the layout plan and/or installation instructions furnished by BCI Burke Company, LLC using approved parts; have been maintained and inspected in accordance with BCI Burke Company, LLC instructions. Burke's liability and your exclusive remedy hereunder will be limited to repair or replacement of those parts found in Burke's reasonable judgment to be defective. Any claim made within the above stated warranty periods must be made promptly after discovery of the defect. A part is covered only for the original warranty period of the applicable part. Replacement parts carry the applicable warranty from the date of shipment of the replacement from Burke. After the expiration of the warranty period, you must pay for all parts, transportation and service charges.

Burke reserves the right to accept or reject any claim in whole or in part. Burke will not accept the return of any product without its prior written approval. Burke will assume transportation charges for shipment of the returned product if it is returned in strict compliance with Burke's written instructions.

THE FOREGOING WARRANTIES ARE EXCLUSIVE AND IN LIEU OF ANY OTHER WARRANTY, EXPRESS OR IMPLIED, INCLUDING BUT NOT LIMITED TO ANY IMPLIED WARRANTY OR MERCHANTABILITY OR FITNESS FOR A PARTICULAR PURPOSE. IF THE FOREGOING DISCLAIMER OF ADDITIONAL WARRANTIES IS NOT GIVEN FULL FORCE AND EFFECT, ANY RESULTING ADDITIONAL WARRANTY SHALL BE LIMITED IN DURATION TO THE EXPRESS WARRANTIES AND BE OTHERWISE SUBJECT TO AND LIMITED BY THE TERMS OF BURKE'S PRODUCT WARRANTY. SOME STATES DO NOT ALLOW THE EXCLUSION OF CERTAIN IMPLIED WARRANTIES, SO THE ABOVE LIMITATION MAY NOT APPLY TO YOU.

Warranty Exclusions: The above stated warranties do not cover: "cosmetic" defects, such as scratches, dents, marring, or fading; damage due to incorrect installation, vandalism, misuse, accident, wear and tear from normal use, exposure to extreme weather; immersion in salt or chlorine water, unauthorized repair or modification, abnormal use, lack of maintenance, or other cause not within Burke's control; and

Limitation of Remedies: Burke is not liable for consequential or incidental damages, including but not limited to labor costs or lost profits resulting from the use of or inability to use the products or from the products being incorporated in or becoming a component of any other product. If, after a reasonable number of repeated efforts, Burke is unable to repair or replace a defective or nonconforming product, Burke shall have the option to accept return of the product, or part thereof, if such does not substantially impair its value, and return the purchase price as the buyer's entire and exclusive remedy. Without limiting the generality of the foregoing, Burke will not be responsible for labor costs involved in the removal of products or the installation of replacement products. Some states do not allow the exclusion of incidental damages, so the above exclusion may not apply to you.

The environment near a saltwater coast can be extremely corrosive. Some corrosion and/or deterioration is considered "normal wear" in this environment. Product installed within 500 yards of a saltwater shoreline will only be covered for half the period of the standard product warranty, up to a maximum of five years, for defects caused by corrosion. Products installed in direct contact with saltwater or that are subjected to salt spray are not covered by the standard warranty for any defects caused by corrosion.

Contact your local Burke Representative for warranty information regarding Burke Turf® and Burke Tile products.

Terms of Sale

Pricing: Prices published in this catalog are in USD, are approximate and do not include shipping & handling, surfacing, installation nor applicable taxes. All prices are subject to change without notice. Contact your Burke representative for current pricing. Payments are to be made in USD.

Weights: Weights are approximate and may vary with actual orders.

Installation: All equipment is shipped unassembled. For a list of factory-certified installers in your area, please contact your Burke representative.


Specifications: Product specifications in this catalog were correct at the time of publication. However, product improvements are ongoing at Burke, and we reserve the right to change or discontinue specifications without notice.

Loss or Damage in Transit: A signed bill of lading is our receipt from a carrier that our shipment to you was complete and in good condition upon arrival. Before you sign, please check the Bill of Lading carefully when the shipment arrives to make sure nothing is missing and there are no damages. Once the shipment leaves our plant, we are no longer responsible for any damage, loss or shortage.

For more information regarding the warranty, call Customer Service at 920-921-9220 or 1-800-356-2070.

01/2021



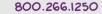

Frog Pond Park



27227 SW Stafford Road | Wilsonville, OR 97070



Buell Recreation

7327 Barnes Road #601 | Portland, OR 97725 | 503-922-1650

OUR MISSION IS TO BRING PLAY THAT MOVES YOU® TO COMMUNITIES AROUND THE WORLD

Proposal 907-175986-6 | 2/15/2024



DESIGN SUMMARY

Buell Recreation is very pleased to present this Proposal for consideration for the Frog Pond Park located in Wilsonville. BCI Burke Company, LLC has been providing recreational playground equipment for over 100 years and has developed the right mix of world-class capabilities to meet the initial and continuing needs of City of Wilsonville. We believe our proposal will meet or exceed your project's requirements and will deliver the greatest value to you.

The following is a summary of some of the key elements of our Proposal:

- Project Name: Frog Pond Park
- Project Number: 907-175986-6
- User Capacity: 66
- Age Groups: 2 to 5
- Dimensions: 56' 8"x81' 3"
- Designer Name: Pa Der Vang


Buell Recreation has developed a custom playground configuration based on the requirements as they have been presented for the Frog Pond Park playground project. Our custom design will provide a safe and affordable playground environment that is aesthetically pleasing, full of fun for all users and uniquely satisfies your specific requirements. In addition, proposal # 907-175986-6 has been designed with a focus on safety, and is fully compliant with ASTM F1487 and CPSC playground safety standards.


We invite you to review this proposal for the Frog Pond Park playground project and to contact us with any questions that you may have.


Thank you in advance for giving us the opportunity to make this project a success.


OUR MISSION IS TO BRING PLAY THAT MOVES YOU TO COMMUNITIES AROUND THE WORLD


Proposal 907-175986-6 | 2/15/2024

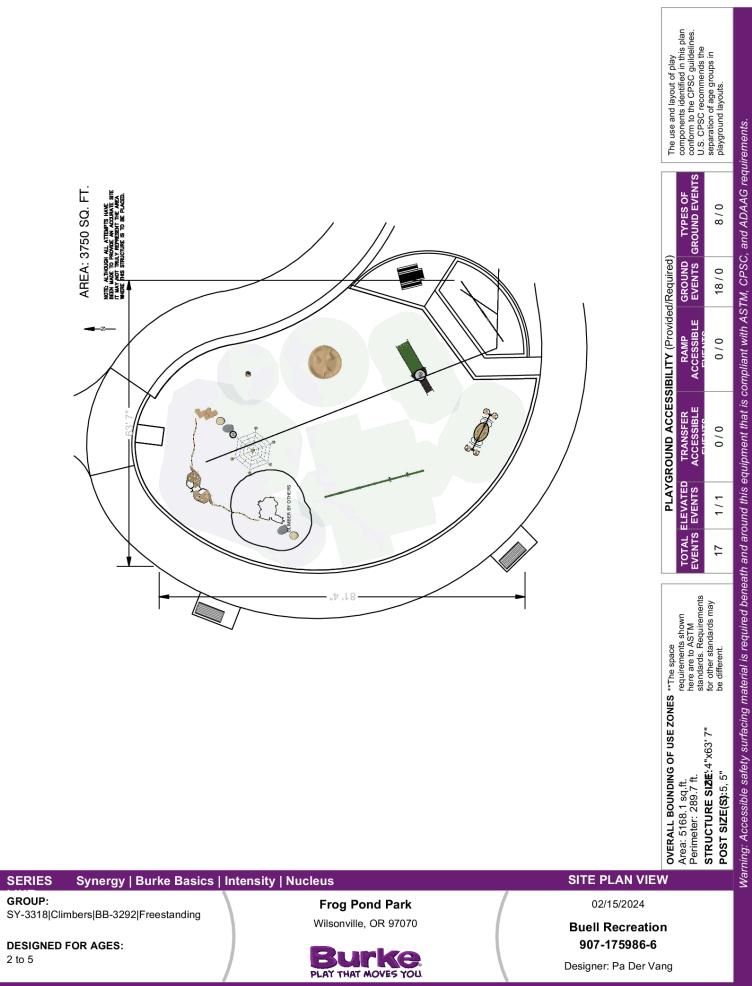

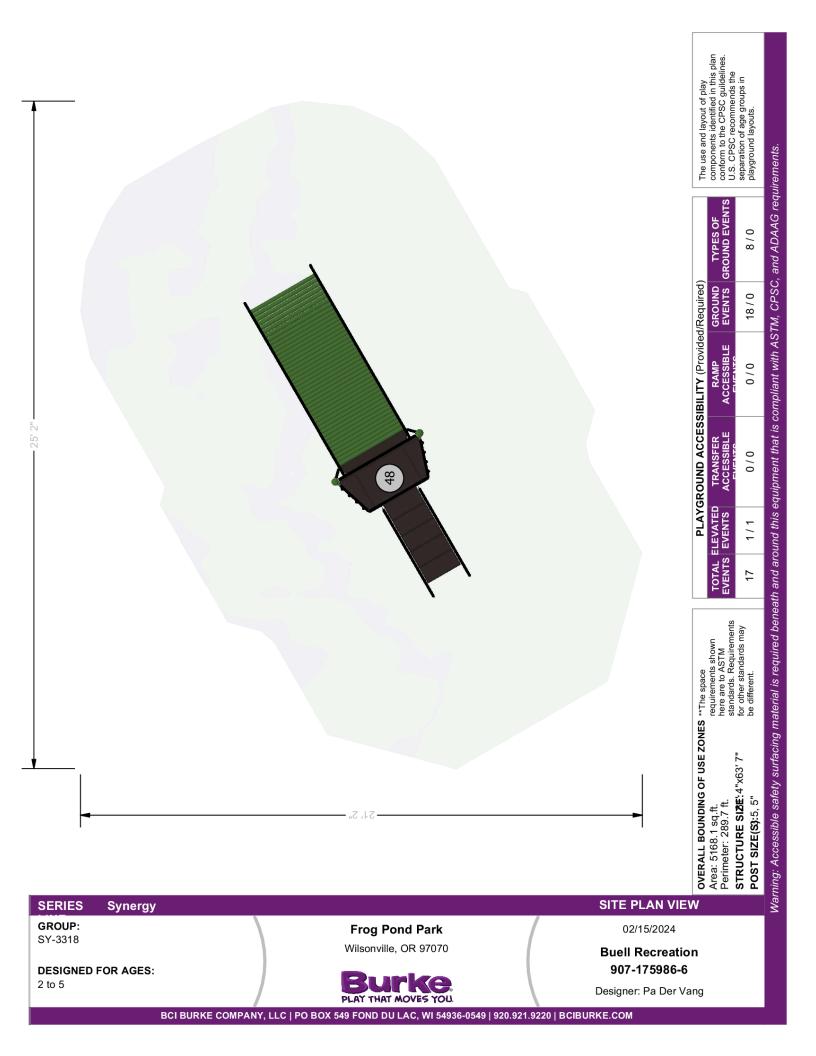


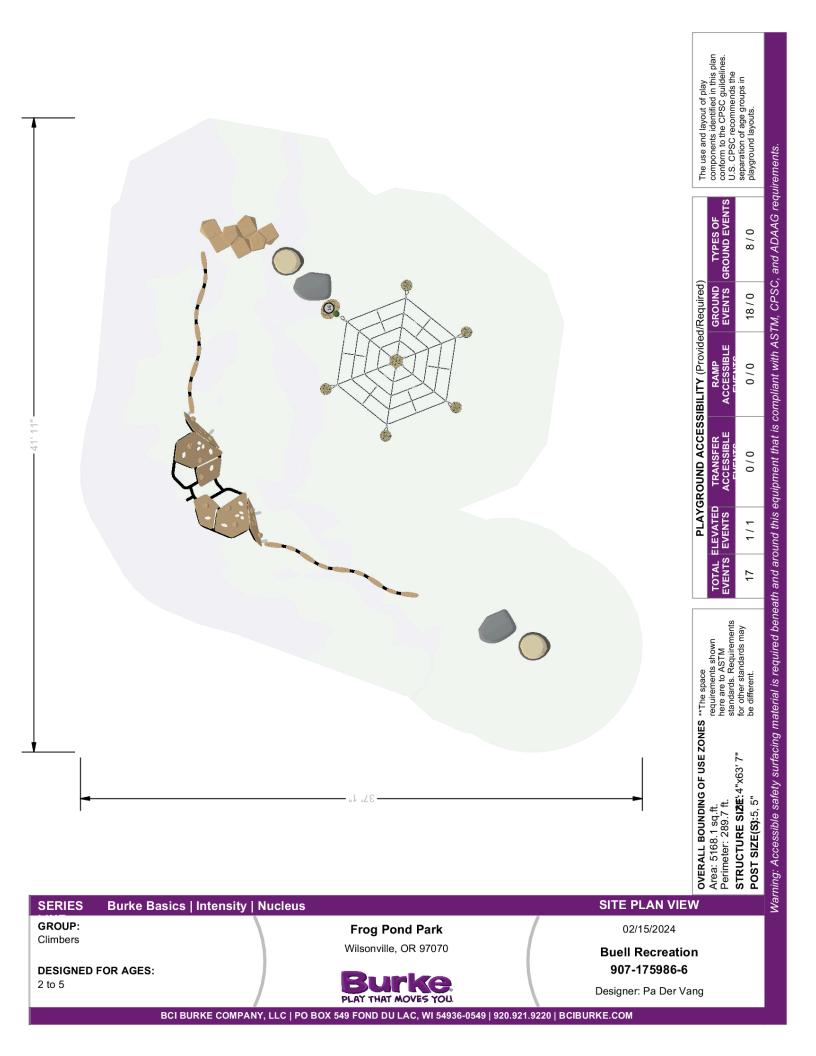

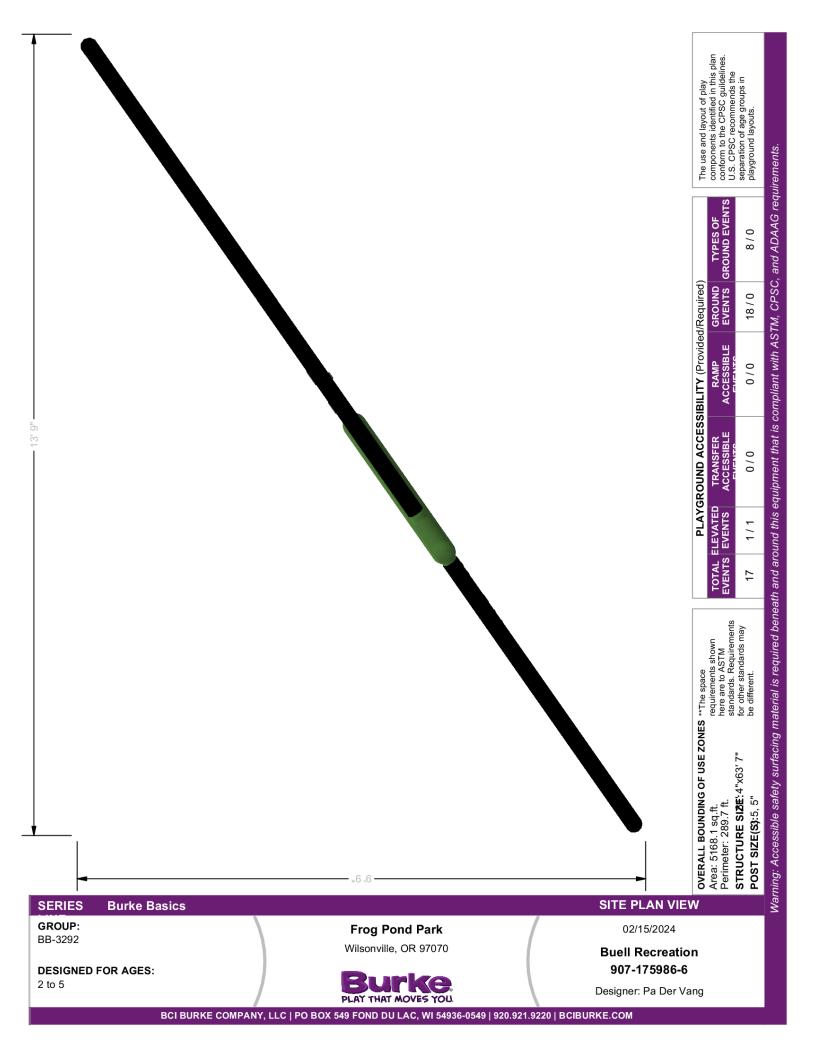

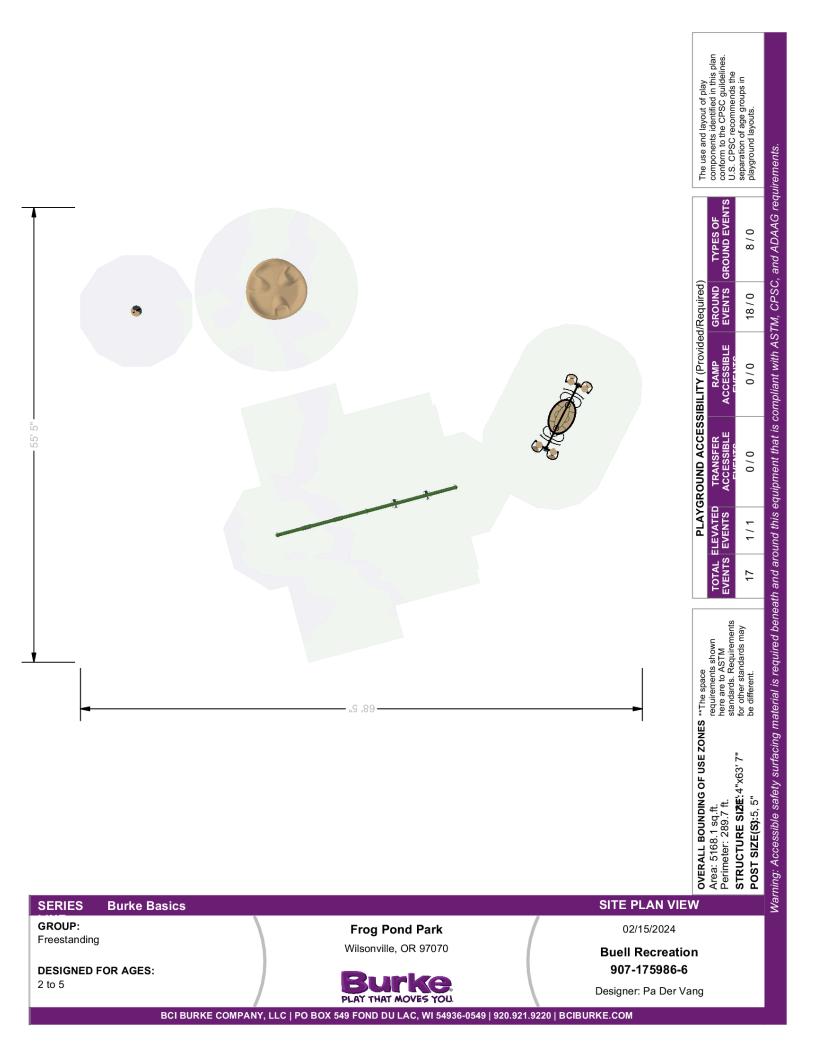


| ITEM | ITEM COMP. | DESCRIPTION |
|------|------------|-------------------------------------|
| 1 | 230-0216 | 230-0216 SLIDE PLATFORM & STAIR 48" |
| 2 | 490-0140 | 490-0140 ROLLER SLIDE 48"-56" |
| 3 | 490-0138 | 490-0138 DOUBLE SLIDE SIT DOWN BAR |

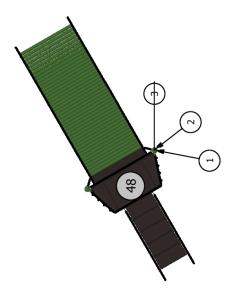

| SERIES Synergy | | COMPONENT VIEW | | | |
|--|-------------------------------|-----------------------|--|--|--|
| , | | | | | |
| GROUP: SY-3318 | Frog Pond Park | 02/15/2024 | | | |
| 31-3310 | Wilsonville, OR 97070 | Buell Recreation | | | |
| DESIGNED FOR AGES: 2 to 5 | | 907-175986-6 | | | |
| | Burke. PLAY THAT MOVES YOU | Designer: Pa Der Vang | | | |
| BCI BURKE COMPANY, LLC PO BOX 549 FOND DU LAC, WI 54936-0549 920.921.9220 BCIBURKE.COM | | | | | |

| COMP. DESCRIPTION | 370-1604 BALANCE CHALLENGE | 560-0553 NATURE PLAY STUMP - SMALL | 560-2709 EKO BUNDLE | 560-2614 NATURE PLAY ROCK, SMALL | 560-0062 FORMIS FREE 2-12 | 370-0814 WOBBLY WEB NET | 670-0413 WOBBLY WEB POST, SHORT | 670-0412 WOBBLY WEB POST, MED | 670-0411 WOBBLY WEB POST, TALL | 370-1608 OVISTEP LAUNCH PAD |
|-------------------|----------------------------|------------------------------------|---------------------|----------------------------------|---------------------------|-------------------------|---------------------------------|-------------------------------|--------------------------------|-----------------------------|
| COMP. | 370-160 | 560-055 | 560-270 | 560-261 | 560-006 | 370-081 | 670-041 | 670-041 | 670-041 | 370-160 |
| ITEM | 1 | 2 | ñ | 4 | 5 | 9 | 7 | 8 | 6 | 10 |

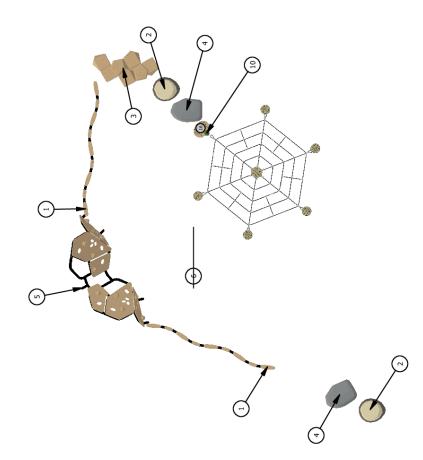


| SERIES Burke Basics Intensity I | Nucleus | COMPONENT VIEW | | | |
|--|-------------------------------|----------------------------------|--|--|--|
| GROUP: | Frog Pond Park | 02/15/2024 | | | |
| Climbers DESIGNED FOR AGES: | Wilsonville, OR 97070 | Buell Recreation 907-175986-6 | | | |
| 2 to 5 | Burke. PLAY THAT MOVES YOU | Designer: Pa Der Vang | | | |
| BCI BURKE COMPANY, LLC PO BOX 549 FOND DU LAC, WI 54936-0549 920.921.9220 BCIBURKE.COM | | | | | |

| ITEM | ITEM COMP. | COMP. DESCRIPTION |
|------|------------|--|
| 1 | 1 560-1703 | 560-1703 STEMPLAY SHORT ACTIVITY FRAME |
| 2 | 2 560-2688 | 560-2688 STEMPLAY CLASSIC GAMES |
| 3 | 560-2689 | 560-2689 STEMPLAY GRAVITY |

SERIES Burke Basics

GROUP: BB-3292

DESIGNED FOR AGES: 2 to 5

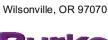

Frog Pond Park

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PLAY THAT MOVES YOU

COMPONENT VIEW


02/15/2024

Buell Recreation 907-175986-6


Designer: Pa Der Vang

| DESCRIPTION | 550-0201 SINGLE POST SWING ASSEMBLY 5" OD | 550-0202 SINGLE POST SWING ADD-ON 5" OD | 550-0099 TOT SEAT, 7' & 8' SINGLE, STD CHAIN | 550-0111 BELT SEAT, 8' SINGLE, STD CHAIN | 560-0457 SWIFT TWIST SPINNER | 560-2579 VOLTA INCLUSIVE SPINNER | 560-2765 VOLTA SPINNER FOOTER | 570-2745 ORB ROCKER | 570-2727 ORB ROCKER FOOTER |
|-------------|---|---|--|--|------------------------------|----------------------------------|-------------------------------|---------------------|----------------------------|
| COMP. | 550-0201 | 550-0202 | 550-0099 | 550-0111 | 560-0457 | 560-2579 | 560-2765 | 570-2745 | 570-2727 |
| ITEM | 1 | 2 | 3 | 4 | 5 | 9 | 7 | 8 | 6 |


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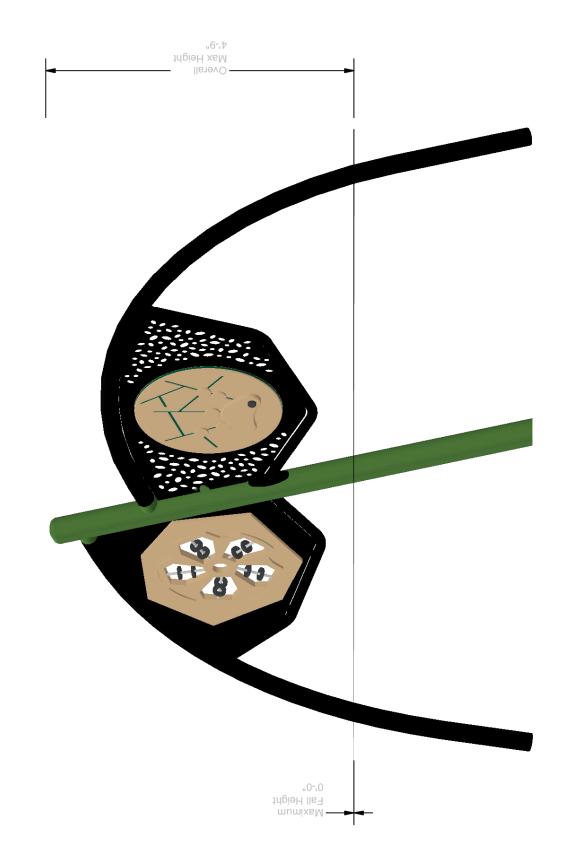
| SERIES Synergy Burke Basics | ELEVATION VIEW | |
|---|-------------------------------|-------------------------|
| GROUP: SY-3318 Climbers BB-3292 Freestanding | Frog Pond Park | 02/15/2024 |
| ST-SSTOCHINDERSBB-SZ92[FTeestanding | Wilsonville, OR 97070 | Buell Recreation |
| DESIGNED FOR AGES: | | 907-175986-6 |
| 2 to 5 | Burke. PLAY THAT MOVES YOU | Designer: Pa Der Vang |

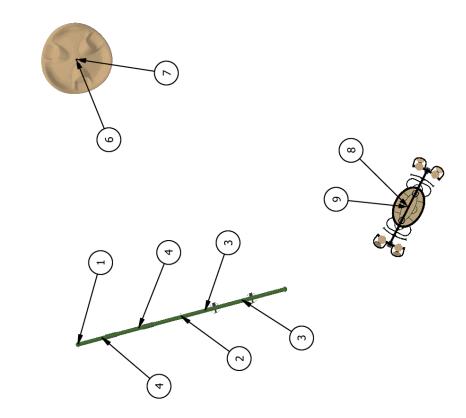




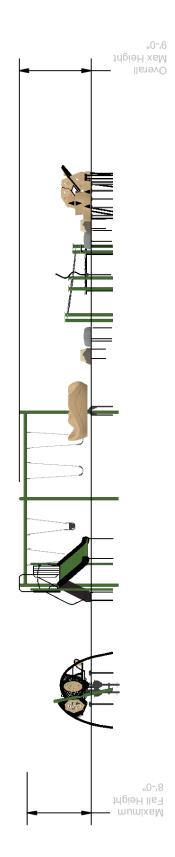




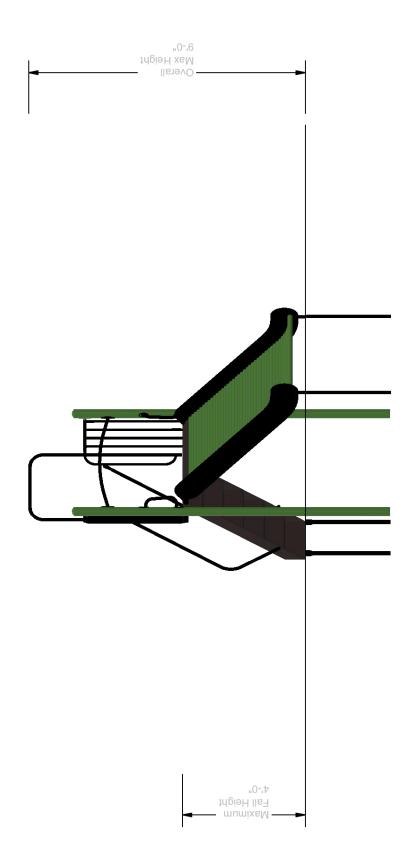



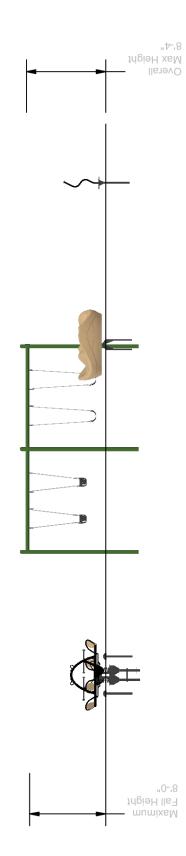


SERIESBurke BasicsELEVATION VIEWGROUP:
FreestandingFrog Pond Park
Wilsonville, OR 9707002/15/2024DESIGNED FOR AGES:
2 to 5Wilsonville, OR 97070Buell Recreation
907-175986-6
Designer: Pa Der Vang

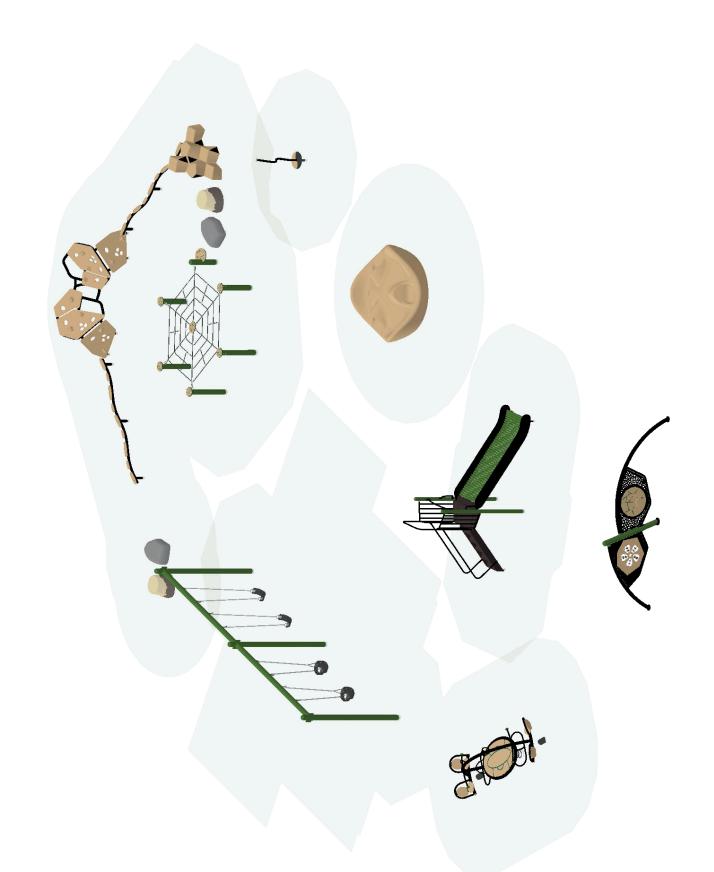

| SERIES | Synergy Burke Basics | ISOMETRIC VIEW | |
|---|------------------------|-------------------------------|-------------------------|
| GROUP: SY-3318 Climbers BB-3292 Freestanding | | Frog Pond Park | 02/15/2024 |
| | | Wilsonville, OR 97070 | Buell Recreation |
| DESIGNED F | OR AGES: | Dumles | 907-175986-6 |
| 2 to 5 | | Burke. PLAY THAT MOVES YOU | Designer: Pa Der Vang |



SERIES Synergy ISOMETRIC VIEW GROUP: Frog Pond Park 02/15/2024 SY-3318 Wilsonville, OR 97070 Buell Recreation DESIGNED FOR AGES: 907-175986-6 907-175986-6 2 to 5 Designer: Pa Der Vang Designer: Pa Der Vang

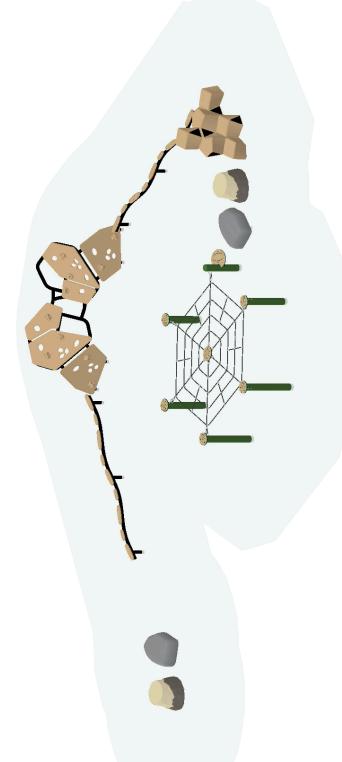

| SERIES Burke Basics Intensity | Nucleus | ISOMETRIC VIEW |
|---------------------------------|-------------------------------|-----------------------|
| GROUP: | Frog Pond Park | 02/15/2024 |
| Climbers | Wilsonville, OR 97070 | Buell Recreation |
| DESIGNED FOR AGES: 2 to 5 | Dumles | 907-175986-6 |
| | Burke. PLAY THAT MOVES YOU | Designer: Pa Der Vang |



SERIES Burke Basics

GROUP: BB-3292

DESIGNED FOR AGES: 2 to 5

Frog Pond Park Wilsonville, OR 97070



ISOMETRIC VIEW

02/15/2024

Buell Recreation 907-175986-6

Designer: Pa Der Vang



| SERIES Burke Basics | | ISOMETRIC VIEW |
|---------------------|-------------------------------|-------------------------|
| GROUP: | Frog Pond Park | 02/15/2024 |
| Freestanding | Wilsonville, OR 97070 | Buell Recreation |
| DESIGNED FOR AGES: | Dunla | 907-175986-6 |
| 2 to 5 | Burke. PLAY THAT MOVES YOU | Designer: Pa Der Vang |



BUPKE. PLAY THAT MOVES YOU. BCIBLIRKE.COM • 800.266.1250

Proposal 907-175986-6 | 2/15/2024 | 2024 Pricing

The play components identified in this proposal are IPEMA certified. The use and layout of these components conform to the requirements of ASTMF1487. To verify product certification, visit <u>www.ipema.org</u>.



The space requirements shown in this proposal are to ASTM standards. Requirements for other standards may be different.

| Component No. Description Qty User Cap Ext. User Cap Weight Ext. Weight | | | | | | | |
|---|---|---------|----------|---------------|--------|-------------|--|
| Component N | lo. Description | Qty | User Cap | Ext. User Cap | Weight | Ext. Weight | |
| | | | | | | | |
| | | SY-33 | 318 | | | | |
| | | 0.00 | | | | | |
| Synergy | | | | | | | |
| | C 3 1/2" OD X 123" CAPPED POST | 2 | 0 | 0 | 45 | 90 | |
| 230-0216 | SLIDE PLATFORM & STAIR 48" | 1 | 6 | 6 | 221 | 221 | |
| 490-0138 | DOUBLE SLIDE SIT DOWN BAR | 1 | 0 | 0 | 6 | 6 | |
| 490-0140 | ROLLER SLIDE 48"-56" | | 4 | 4 | 704 | 704 | |
| 600-0104 660-0103 | NPPS SUPERVISION SAFETY KIT MAINTENANCE KIT, STRUCTURE | 1 | 0 0 | 0 0 | 3 7 | 3 7 | |
| 660-0103 | INSTALLATION KIT, STRUCTURE | 1 | 0 | 0 | / 5 | 5 | |
| 000-0104 | INSTALLATION KIT, STRUCTURE | I | 0 | 0 | 5 | 5 | |
| | | | | | | | |
| | | | | | | | |
| | | | | | | | |
| | | BB-32 | 202 | | | | |
| | | DD-34 | 272 | | | | |
| Burke Basics | | | | | | | |
| 560-1703 | STEMPLAY SHORT ACTIVITY FRAME | 1 | 0 | 0 | 176 | 176 | |
| 560-2688 | STEMPLAY CLASSIC GAMES | 1 | 2 | 2 | 70 | 70 | |
| 560-2689 | STEMPLAY GRAVITY | 1 | 2 | 2 | 63 | 63 | |
| 660-0101 | INSTALL KIT, BURKE BASICS - P | 1 | 0 | 0 | 2 | 2 | |
| | | | | | | | |
| | | | | | | | |
| | | | | | | | |
| | | | | | | | |
| | | Freesta | nding | | | | |
| | | | | | | | |
| Burke Basics | | 2 | | 2 | 10 | <u> </u> | |
| 550-0099 | TOT SEAT, 7' & 8' SINGLE, STD | 2 | | 2 | 12 | 24 | |
| 550-0111 | BELT SEAT, 8' SINGLE, STD CHAIN | 2 | | 2 | 10 | 20 | |

BELT SEAT, 8' SINGLE, STD CHAIN 550-0111 20 Z 10 Z 1 550-0201 SINGLE POST SWING ASSEMBLY 5" OD 1 0 0 220 220 SINGLE POST SWING ADD-ON 5" OD 1 0 0 145 550-0202 145 560-0457 SWIFT TWIST SPINNER 1 1 1 52 52 9 9 475 560-2579 **VOLTA INCLUSIVE SPINNER** 1 475 VOLTA SPINNER FOOTER 1 0 0 560-2765 69 69 570-2727 ORB ROCKER FOOTER 0 0 93 93 1 **ORB ROCKER** 8 540.9 540.9 570-2745 1 8 660-0101 INSTALL KIT, BURKE BASICS - P ... 1 0 0 2 2

Climbers

| Burke Basics 370-1604 560-0062 560-0553 560-2614 560-2709 | BALANCE CHALLENGE FORMIS FREE 2-12 NATURE PLAY STUMP - SMALL NATURE PLAY ROCK, SMALL EKO BUNDLE | 2 1 2 1 Climbe | 2 5 1 1 6 rs | 4 5 2 2 6 | 76 313 66 95 148 | 152 313 132 190 148 | | |
|--|---|-----------------------------------|------------------------------------|------------------------|------------------------------|---------------------------------|--|--|
| Intensity 370-0814 370-1608 670-0411 670-0412 670-0413 | WOBBLY WEB NET OVISTEP LAUNCH PAD WOBBLY WEB POST, TALL WOBBLY WEB POST, MED WOBBLY WEB POST, SHORT | 1 1 2 2 1 | 10 1 0 0 0 | 10 1 0 0 0 | 36 10 59 55 50 | 36 10 118 110 50 | | |
| Climbers | | | | | | | | |
| Nucleus 072-0500-60C | 5" OD X 60" CAPPED POST | 1 | 0 | 0 | 32 | 32 | | |

Special Notes:

Prices do not include freight, unloading, material storage, site excavation/preparation, removal of existing equipment, removal of excess soil from footing holes, site security, safety surfacing, installation, or sales tax (if applicable). Prices are based on standard colors per CURRENT YEAR BCI Burke Catalog. Custom colors, where available, would be an extra charge. **Pricing is valid for 30 days from the date of this proposal.**





Proposal 907-175986-6 | 2/15/2024 | 2024 Pricing

COLOR SELECTION LIST | Default Color Option

GROUP 1 (SY-3318)

- Acc: Black Post: Olive
- Deck: Brown

GROUP 2 (Climbers)

Flat: Tan Acc: Black Plastic: Tan Panel: Tan-Green-Tan Post: Olive

GROUP 3 (Freestanding)

- Post: Olive Flat: Tan
- Acc: Black
- Plastic: Tan
- Panel: Tan-Green-Tan

GROUP 4 (BB-3292)

Post: Olive Acc: Black Flat: Tan Panel: Tan-Green-Tan

COLORS THAT MOVE YOU



BURKE GENERATIONS WARRANTY®

The Longest and Strongest warranty in the industry

BCI Burke Company, LLC ("Burke") warrants that all standard products are warranted to be free from defects in materials and workmanship, under normal use and service, for a period of one (1) year from the date of shipment.

We stand behind our products. In addition, the following products are warranted, under normal use and service from the date of shipment as follows:

- One Hundred (100) Year Limited Warranty on aluminum and steel upright posts (including Intensity[®], Synergy[™], Nucleus[®], Voltage[®], Little Buddies[®], ELEVATE[®], ACTIVATE[®], INVIGORATE[™]) against structural failure due to corrosion, deterioration or workmanship.
- One Hundred (100) Year Limited Warranty on KoreKonnect® clamps against structural failure due to corrosion, deterioration or workmanship.
- One Hundred (100) Year Limited Warranty on Hardware (nuts, bolts, washers)
- One Hundred (100) Year Limited Warranty on bolt-through fastening and clamp systems (Synergy™, Intensity®, Nucleus®, Voltage®, Little Buddies®, ELEVATE®).
- Twenty-Five (25) Year Limited Warranty on spring assemblies and aluminum cast animals.
- Fifteen (15) Year Limited Warranty on structure platforms and decks, metal roofs, table tops, bench tops, railings and barriers against structural failure due to materials or workmanship.
- Fifteen (15) Year Limited Warranty on all plastic components including StoneBorders against structural failure due to materials or workmanship.
- Ten (10) Year Limited Warranty on ShadePlay Canopies fabric, threads, and cables against degradation, cracking or material breakdown resulting from ultra-violet exposure, natural deterioration or manufacturing defects. This warranty is limited to the design loads as stated in the specifications.
- Ten (10) Year Limited Warranty on NaturePlay[®] Boulders and GFRC products against structural failure due to natural deterioration or workmanship. Natural wear, which may occur with
 any concrete product with age, is excluded from this warranty
- Ten (10) Year Limited Warranty on Full Color Custom Signage against manufacturing defects that cause delamination or degradation of the sign. Full Color Custom Signs also carry a two (2) year warranty against premature fading of the print and graphics on the signs.
- Five (5) Year Limited Warranty on Intensity® and RopeVenture® cables and LEVEL X® flex bridge against premature wear due to natural deterioration or manufacturing defects. Determination of premature wear will be at the manufacturer's discretion.
- Five (5) Year Limited Warranty on moving parts, including swing components, against structural failure due to materials or workmanship.
- Five (5) Year Limited Warranty on PlayEnsemble® cables and mallets against defects in materials and workmanship.
- Three (3) Year Limited Warranty on electronic panel speakers, sound chips and circuit boards against electronic failure caused by manufacturing defects.

The warranty stated above is valid only if the equipment is erected in conformity with the layout plan and/or installation instructions furnished by BCI Burke Company, LLC using approved parts; have been maintained and inspected in accordance with BCI Burke Company, LLC instructions. Burke's liability and your exclusive remedy hereunder will be limited to repair or replacement of those parts found in Burke's reasonable judgment to be defective. Any claim made within the above stated warranty periods must be made promptly after discovery of the defect. A part is covered only for the original warranty period of the applicable part. Replacement parts carry the applicable warranty from the date of shipment of the replacement from Burke. After the expiration of the warranty period, you must pay for all parts, transportation and service charges.

Burke reserves the right to accept or reject any claim in whole or in part. Burke will not accept the return of any product without its prior written approval. Burke will assume transportation charges for shipment of the returned product if it is returned in strict compliance with Burke's written instructions.

THE FOREGOING WARRANTIES ARE EXCLUSIVE AND IN LIEU OF ANY OTHER WARRANTY, EXPRESS OR IMPLIED, INCLUDING BUT NOT LIMITED TO ANY IMPLIED WARRANTY OR MERCHANTABILITY OR FITNESS FOR A PARTICULAR PURPOSE. IF THE FOREGOING DISCLAIMER OF ADDITIONAL WARRANTIES IS NOT GIVEN FULL FORCE AND EFFECT, ANY RESULTING ADDITIONAL WARRANTY SHALL BE LIMITED IN DURATION TO THE EXPRESS WARRANTIES AND BE OTHERWISE SUBJECT TO AND LIMITED BY THE TERMS OF BURKE'S PRODUCT WARRANTY. SOME STATES DO NOT ALLOW THE EXCLUSION OF CERTAIN IMPLIED WARRANTIES, SO THE ABOVE LIMITATION MAY NOT APPLY TO YOU.

Warranty Exclusions: The above stated warranties do not cover: "cosmetic" defects, such as scratches, dents, marring, or fading; damage due to incorrect installation, vandalism, misuse, accident, wear and tear from normal use, exposure to extreme weather; immersion in salt or chlorine water, unauthorized repair or modification, abnormal use, lack of maintenance, or other cause not within Burke's control; and

Limitation of Remedies: Burke is not liable for consequential or incidental damages, including but not limited to labor costs or lost profits resulting from the use of or inability to use the products or from the products being incorporated in or becoming a component of any other product. If, after a reasonable number of repeated efforts, Burke is unable to repair or replace a defective or nonconforming product, Burke shall have the option to accept return of the product, or part thereof, if such does not substantially impair its value, and return the purchase price as the buyer's entire and exclusive remedy. Without limiting the generality of the foregoing, Burke will not be responsible for labor costs involved in the removal of products or the installation of replacement products. Some states do not allow the exclusion of incidental damages, so the above exclusion may not apply to you.

The environment near a saltwater coast can be extremely corrosive. Some corrosion and/or deterioration is considered "normal wear" in this environment. Product installed within 500 yards of a saltwater shoreline will only be covered for half the period of the standard product warranty, up to a maximum of five years, for defects caused by corrosion. Products installed in direct contact with saltwater or that are subjected to salt spray are not covered by the standard warranty for any defects caused by corrosion.

Contact your local Burke Representative for warranty information regarding Burke Turf® and Burke Tile products.

Terms of Sale

Pricing: Prices published in this catalog are in USD, are approximate and do not include shipping & handling, surfacing, installation nor applicable taxes. All prices are subject to change without notice. Contact your Burke representative for current pricing. Payments are to be made in USD.

Weights: Weights are approximate and may vary with actual orders.

Installation: All equipment is shipped unassembled. For a list of factory-certified installers in your area, please contact your Burke representative.

Specifications: Product specifications in this catalog were correct at the time of publication. However, product improvements are ongoing at Burke, and we reserve the right to change or discontinue specifications without notice.

Loss or Damage in Transit: A signed bill of lading is our receipt from a carrier that our shipment to you was complete and in good condition upon arrival. Before you sign, please check the Bill of Lading carefully when the shipment arrives to make sure nothing is missing and there are no damages. Once the shipment leaves our plant, we are no longer responsible for any damage, loss or shortage.

For more information regarding the warranty, call Customer Service at 920-921-9220 or 1-800-356-2070.

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