

CITY OF WILLOWICK PLAN REVIEW BOARD APPLICATION FOR PERMIT TO OCCUPY FOR BUSINESS, COMMERCIAL, INDUSTRIAL, ETC. YOU MUST FILL OUT ENTIRE APPLICATION 440-516-3000

	TE:
	auton of Occupancy: 1107 EAST 305 Business Name: MAZZOUA Supply LLC.
	siness Owner's Name & Address: Mike MAZZULA 9032 FAST MOUNTAIN VIEW
	Y/STATE/ZIP: Chardon onto LI40 24
1	40-043-3313 Fax Number: N/A Federal ID Number: 270-60-2178 or Social Security Number
	INER OF PROPERTY/NAME/ADDRESS/TELEPHONE NUMBER: DOC - FORMICA.
	Stanford Dr wicklife ofto 44094
	BMIT NEW DETAILED FLOOR PLAN: SQ. FT. HABITABLE FLOOR AREA FOR OCCUPANCY: 20 Mike MAZZULA- Iding Size: 10 × 20 Total Number Of Employees: 0 / Me - MAZZULA-
	Iding Size: 10 × 20 Total Number Of Employees: 0 Me - MA COCCA
ı	ended Number of Occupants: / Total Number of Seating:
s	Plan With Number of Paved Parking Spaces: Hours Of Operation:
	ter of Intent: Previous Use: Phone Call's Proposed Use: Return Phone Calls'
d	ME OF PRINCIPAL OR CONTACT PERSON FOR NEW BUSINESS: MIKE MAZZOLA D32 + AS+ MOUNTAIN VIEW Charden OFTO 440-285-9455 me Address/City/Zip: 440-285-9455
9	reby certify that the above questions have been answered correctly by me and that the premises will be used for the purpose stated ove. Any change in the purpose of occupancy will not be made without approval from Lake County Building. Willowick Fire & Willowick hing Department. A final approval by The Willowick Building Department. A final approval by The Willowick Building Department. Of the County Building Department. A final approval by The Willowick Building Department. (440)516-3000 or a representative thereof, must be compiled with fare appearance of the City of Willowick Building Department.
	11ck 2-6-2023
,	olicant's Signature: 272471156 Date: 200005
9	ice use only:
2	ning District: Authorized Occupants:
1	MPORARY APPROVED BY: Date:
7	ling Dept. Inspected by: DATE:
2	ling Permit # Zoning Permit Fee \$
	Cant Inspected By:

MikeMazzola 440-943-3313. MAZZOLA Supply 21c. 1107 FAST 305 Willowick off 4485 My. intent for the new YARD SteAd is to Replace the 30+ YEAR Old ONE . That is BE coming Very hand to maintain Roof leaks. Floor. Rothis window Leaks ext, This is A None. Perminant Structure with NO Plumbing or Zunning water MINOR Thectri wak, over Head (Lights And Sevenal outlets, outside Light to Police Drive theo: This YARD SteAd is Used for. Mo. to Return Phone CAVIS. ANd Depen work no Staff, And Costomeris CAIL IN ORders Very Little to NO FOOT TRAFIC. Mark you

chair New And Jeris Shelves Alex Dia

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OLD HICKORY BUILDINGS, LLC MURFREESBORO, TN 37133 P.O. BOX 331973

- GENERAL NOTES:

 1. STRUCTURE HAS BEEN DESIGNED IN ACCORDANCE WITH THE 2017 OHIO BUILDING CODE.
- 2. ALL MATERIALS AND CONSTRUCTION SHALL BE IN ACCORDANCE WITH THE ABOVE CODES AT THE TIME OF
- 3. DRAWINGS SHALL NOT BE SCALED FOR DIMENSIONS
- 4. STRUCTURES ARE CLASSIFIED AS "MINOR STORAGE FACILITIES" (RISK CATEGORY I) PER OBC TABLE 1604.5 AND SHOULD NOT BE USED FOR HUMAN HABITATION.
- 5. STRUCTURES ARE DESIGNED FOR LOCATIONS THAT HAVE A 3 SECOND WIND GUST OF 105 MPH FOR RISK CATEGORY I FIGURE 26.5-1C. STRUCTURES PER OBC FIGURE 1609.3(3) AND ASCE 7-10
- 6. SIDING FASTENERS SHALL NOT BE INSTALLED IN PANEL SIDING GROOVES IN THE FIELD OF THE PANEL OR WHEN THE SIDING GROOVES OCCUR AT CUT EDGES OF THE SIDING PANEL. STRUCTURES SHOULD HAVE 25 YEAR RATED FIBERGLASS/ ASPHALT SHINGLES OR 29 GA METAL ROOFING OVER WOOD
- WOOD FRAMING SHALL COMPLY WITH THE ANSI/AWC "NATIONAL DESIGN SPECIFICATION (NDS) FOR WOOD
- CONSTRUCTION", 2015.
- 9. ALL ROOF DECKING IS TO BE 1/6" OSB.

- 10. ALL SIDING IS TO BE %" TREATED T1-11 PLYWOOD OR %" LP SMART PANEL SIDING.
- 11. ALL FLOOR JOISTS ARE TO BE PRESSURE TREATED SYP #2, OR BETTER, UNLESS NOTED OTHERWISE. FLOOR JOISTS FOR 10' WIDE BUILDINGS ARE TO BE SYP #1, OR BETTER.
- OR BETTER. ALL UN-TREATED WOOD FRAMING IS TO BE SPF #2
- ALL EXTERIOR NAILS ARE TO BE ZINC COATED.
- 14. ALL FLOOR DECKING IS TO BE %" OR 3/" PLYWOOD OR ENGINEERED FLOORING.
- ALL SKIDS ARE TO BE 4x6 PRESSURE TREATED. RATED FOR GROUND CONTACT.
- 16. SECTIONS AND DETAILS SHOWN ARE INTENDED TO BE TYPICAL AND SHALL APPLY AT ALL SIMILAR LOCATIONS, UNLESS NOTED OTHERWISE.

TIEMS BY OTHERS:
THE FOLLOWING ITEMS ARE TO BE SUPPLIED AND
INSTALLED BY OTHERS. THESE ITEMS MAY BE SUBJECT
TO LOCAL JURISDICTION APPROVAL. OLD HICKORY AS ALLOWED BY CODE.

1. RISK CATEGORY

2. FLOOR LIVE LOAD: 40 PSF

- 3. SNOW LOADS ARE BASED ON THE FOLLOWING: GROUND SNOW LOAD, Pg = 30 PSF FLAT ROOF SNOW LOAD, Pf = 20 PSF THERMAL FACTOR, Ct = 1.2 IMPORTANCE FACTOR, I = 0.8 EXPOSURE FACTOR, Ce = 1.0
- 4. WIND LOADS ARE BASED ON THE FOLLOWING: Vull = 105 MPH (OBC FIGURE 1609.3(3)) INTERNAL PRESSURE COEFFICIENT: RISK CATEGORY $GCpi = \pm 0.18$

ROOF-ZONE 1 = 10.0, -10.9 PSF ROOF-ZONE 2 = 10.0, -19.0 PSF ROOF-ZONE 3 = 10.0, -28.0 PSF WALL-ZONE 4 = 11.9, -12.9 PSF WALL-ZONE 5 = 11.9, -15.4 PSF

COMPONENTS & CLADDING:

NOTE: CAC WIND PRESSURES SHOWN ARE FOR A 10 SQUARE FOOT EFFECTIVE AREA (A6) AND MAY BE REDUCED FOR LARGER AREAS


- PIERS (IF REQUIRED):

 1. PIERS ARE NOT REQUIRED WHEN THE SKIDS CAN BE ARE PERMITTED TO BE ORIENTED WITH THE LONG SIDE PARALLEL TO THE SKID PROVIDED THAT THE INTERIOR SKIDS SHALL BE ORIENTED WITH THE LONG SIDE PERPENDICULAR TO THE SKID. PIERS ALONG PERPENDICULAR TO THE SKID. PIERS ALONG THE INTERIOR SKID ARE ORIENTED THE OUTSIDE SKIDS OF BUILDINGS WITH 4 SKIDS SUPPORTED ON FIRM, LEVEL GROUND. PIERS ALONG
- 2. PIERS SHALL TYPICALLY BE 8"x8"x16" OPEN CELL OR SOLID BLOCK. OPEN CELL BLOCKS AND 2" THICK SOLID BLOCKS ARE NOT TO BE USED AS THE BASE OF ANY PLACED ON THEIR SIDE CELLS RUNNING VERTICALLY AND MUST NOT BE PIERS. OPEN CELL BLOCKS ARE TO BE PLACED ON TOP OF SOLID BLOCKS AS NEEDED WITH THE OPEN WITH THE GROUND AT EACH PIER SHALL BE A 4"x8"x16" SOLID CONCRETE BLOCKS, DRY STACKED TO A MAXIMUM HEIGHT OF 36". THE BLOCK IN CONTACT

ON EACH ROW. BLOCKS BY ALTERNATING THE DIRECTION OF BLOCKS

CORNER PIERS OVER 20" TALL SHALL BE DOUBLE STACKED CONCRETE BLOCKS. TIE DOUBLE STACKED

- 3. OLD HICKORY BUILDINGS IS NOT RESPONSIBLE FOR SUPPORT THE PROPOSED STRUCTURE. IT IS THE PROPERTY OWNER'S RESPONSIBILITY TO DETERMINE IF SITE CONDITIONS ARE SUITABLE TO SUPPORT THE PREPARATION OF THE PROPOSED SITE OR DETERMINATION OF THE SITE'S SUITABILITY TO THE STRUCTURE
- 4. PIERS SHOWN ON SHEET S-1 ARE CONCEPTUAL AND MAY NOT REFLECT ACTUAL CONDITIONS. THE PIER LAYOUT MAY BE ADJUSTED AS NEEDED BASED ON SITE CONDITIONS, PROVIDED THAT THE MAXIMUM SPACING SHOWN IS NOT EXCEEDED.

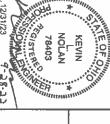

12/31/23

TILITY SHED--C 110--SNOW=30PSF--OBC 2017


3. ELECTRICAL SERVICE HOOKUP 2. RAMPS, STAIRS, AND GENERAL ACCESS 1. THE COMPLETE FOUNDATION AND TIE-DOWN SYSTEM BUILDINGS IS NOT RESPONSIBLE FOR THESE ITEMS



	KLN	CHECKED BY:
	KLN	DRAWN BY:
	09-28-2022	DATE:
SHEET		PROJECT NO:


NUMBER

SCALE: NONE

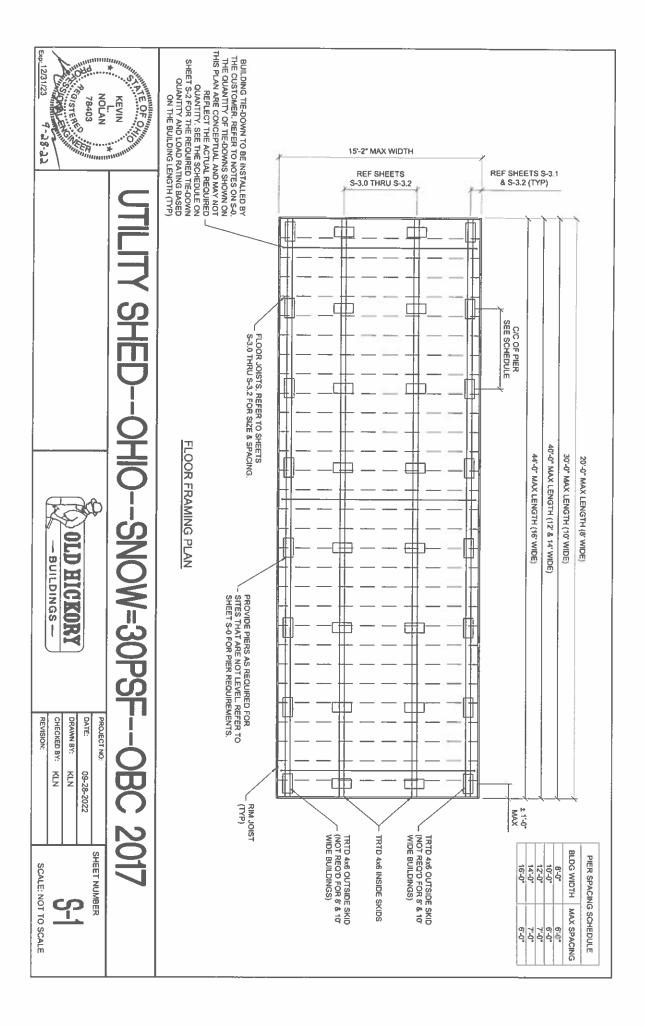

DATE: DRAWN BY: REVISION: CHECKED BY: PROJECT NO: Š Z 09-28-2022 SHEET NUMBER SCALE: 1/4" = 1'-0" S-30



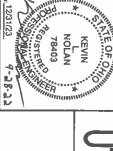

)--C)--SNOW=30PSF--C

NOTES: 1. PROVIDE A DOUBLE TOP PLATE ALONG THE SIDE WALLS WHEN THE RAFTER SPACING DOES NOT MATCH THE WALL STUD SPACING.

2. ACTUAL SKID SPACING MAY VARY PROVIDED THAT THE CENTER TO CENTER SPACING IS WITHIN THE MAXIMIN SPACING STATED.

3. 2x6 FRAMING MAY BE SUBSTITUTED FOR THE 2x4 FRAMING SHOWN.

THE SPACING OF THE 2x6 FRAMING SHALL BE AS SHOWN FOR THE 2x4.

BUILDING SECTIONS

WALL STUD SPACING SCHEDULE (REFER TO NOTE 1)

STUD SPACING

%" LP SMART PANEL %" T1-11 PLYWOOD WALL SIDING

16" MAX 24" MAX

