UTILITY COMPANIES

CONSTRUCTION & ENGINEERING 600 E. ST. LOUIS ROOM 630 TEL. (417) 836-2507

SEWER / WATER RANDY BROWN CITY OF WILLARD 224 W. JACKSON ST. P.O. BOX 187 WILLARD, MO 65 TEL. (417) 343-0285

LIBERTY UTILITIES - EMPIRE DISTRICT RICK WINGENDER

2110 STATE HIGHWAY 14 OZARK, MO 65721 TEL. (417) 425-7763

<u>GAS</u> TODD FAGAN 207 PINE ST. MONETT, MO 6570 TEL. (314) 658-5496

KYLE KELLER 1535 S. ENTERPRISE AVE. SPRINGFIELD, MO 65804 TEL. (417) 496-8577

GENERAL NOTES:

- 1. IT SHALL BE THE CONTRACTOR'S RESPONSIBILITY TO OBTAIN ALL NECESSARY PERMITS PRIOR TO THE START OF CONSTRUCTION
- ACCORDANCE WITH GENERALLY ACCEPTED CONSTRUCTION PRACTICES, THE CONTRACTOR SHALL BE SOLELY AND COMPLETELY RESPONSIBLE FOR CONDITIONS OF THE JOB SITE, INCLUDING SAFETY OF OF THE WORK. THIS REQUIREMENT WILL APPLY CONTINUOUSLY AND
- IT IS THE CONTRACTOR'S RESPONSIBILITY TO DETERMINE THE EXACT HORIZONTAL AND VERTICAL LOCATION OF EXISTING UNDERGROUND FACILITIES PRIOR TO BEGINNING OF CONSTRUCTION.
- 4. IT IS THE CONTRACTOR'S RESPONSIBILITY TO CORRECT ANY DAMAGE TO UNDERGROUND UTILITIES OR OTHER OBSTRUCTIONS DUE TO HIS
- 5. ALL IMPROVEMENTS TO PEDESTRIAN AREAS SHALL MEET ALL A.D.A.
- 6. ALL DIMENSIONS ARE TO BACK OF CURB UNLESS OTHERWISE NOTED.

UTILITY NOTES

- EXISTING UTILITIES SHOWN ARE BASED ON ENGINEER'S CONTACT WITH REASONABLY REPRESENT EXISTING LOCATIONS. HOWEVER, THE ENGINEER AND OWNER MAKE NO GUARANTEE AS TO ACCURACY OR COMPLETENESS OF INFORMATION SHOWN. THE CONTRACTOR SHALL NOTIFY ALL UTILITY AGENCIES PRIOR TO BEGINNING WORK AND SHALL COOPERATE WITH THEM IN LOCATING AND PROTECTING THEIR
- 2. PUBLIC AND PRIVATE UTILITY FACILITIES SHALL BE MOVED OR ADJUSTED PRIOR TO CONSTRUCTION AS NECESSARY BY THE CONTRACTOR TO FIT THE CONSTRUCTION UNLESS NOTED ON THE PLANS OR IN THE PROPOSAL. THE CONTRACTOR IS RESPONSIBLE FOR MAKING HIS OWN DETERMINATION AS TO THE TYPE AND LOCATION OF UNDERGROUND UTILITIES AS MAY BE NECESSARY TO AVOID DAMAGE

DISCLAIMER:

THE CONTRACTOR SHALL NOTIFY THE ENGINEER IMMEDIATELY IF HE OBSERVES CONDITIONS IN THE FIELD THAT APPEAR TO BE UNFORESEEN OR ARE MATERIALLY DIFFERENT THAN SHOWN ON THE PLANS OR WOULD CAUSE THE DESIGN, AS SHOWN ON THE PLANS OR THE SPECIFICATIONS, TO BE IMPRACTICAL OR INAPPROPRIATE BASED ON CUSTOMARY STANDARDS OF THE INDUSTRY. THE CONTRACTOR SHALL CONSULT WITH THE ENGINEER


THE ENGINEER DISCLAIMS THE RESPONSIBILITY FOR ANY ACTIONS TAKEN BY THE CONTRACTOR NOT IN COMPLIANCE WITH THE ABOVE.

PUBLIC IMPROVEMENTS FOR JACKSON STREET SIDEWALK

COUNTY LOCATION MAP



CITY OF WILLARD GREENE COUNTY, MISSOURI SEC. 25 T30N, R23W

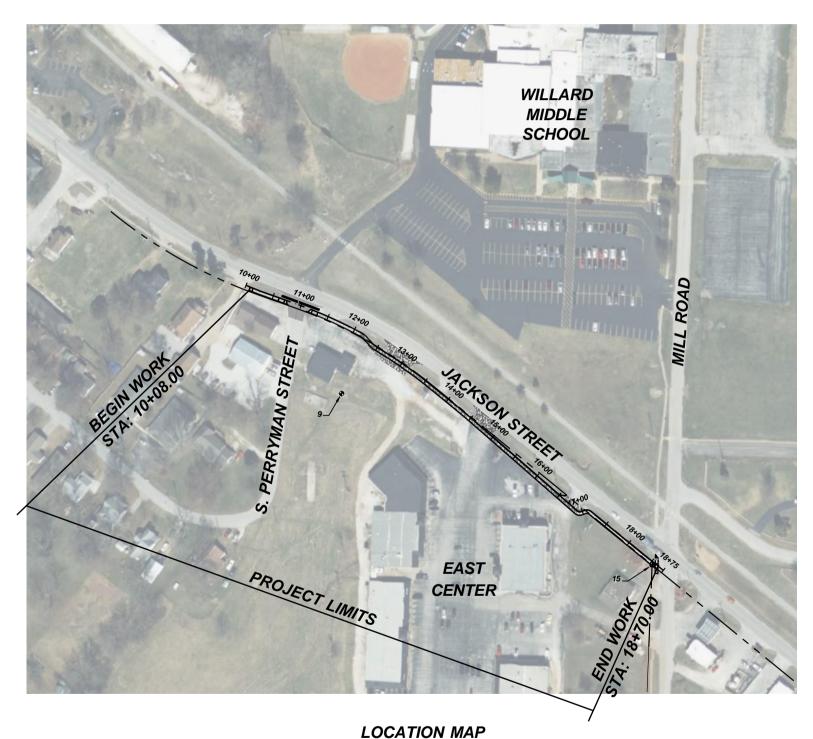

BENCHMARK NOTES:

HORIZONTAL CONTROL IS BASED UPON A MODIFIED STATE PLANE COORDINATE SYSTEM. THE COORDINATE VALUES SHOWN ON THIS SURVEY WERE DERIVED BY USING PUBLISHED VALUES ON MISSOURI DEPARTMENT OF NATURAL RESOURCES HORIZONTAL CONTROL MONUMENT NAME GR-56, SCALING THE PUBLISHED VALUES UP FROM A GRID POSITION TO A GROUND POSITION USING A COMBINED GRID FACTOR OF 1.000042002. AND THEN MONUMENT GR-56 IS IN THE MISSOURI STATE PLANE COORDINATE SYSTEM

THE PUBLISHED VALUES FOR STATION NAME GR-90 ARE NORTH (Y) = 162,074.202M AND EAST (X) = 420,124.923M WITH A PUBLISHED GRID FACTOR

THE MODIFIED GROUND VALUES FOR STATION NAME GR-56 USED FOR THE PURPOSE OF THIS SURVEY ARE NORTH (Y) = 531,738.4444 FT AND EAST (X) = 1,278,359.8515 FT.

BENCHMARK LOCATIONS							
POINT #	NORTHING	EASTING	ELEVATION	DESCRIPTION			
9	536436.85	1371156.48	1222.77	EIP STRIBLING LC000373			
15	536144 53	1371686 00	1228 20	FIP AUSTIN PLS 2000147872			

<u>PREPARED AND SUBMITTED BY:</u>

CJW TRANSPORTATION CONSULTANTS, LLC 5051 S. NATIONAL AVE, SUITE 7A

GARRETT EVANS, P.E.,


APPROVED BY:

CITY ADMINISTRATOR



www.mo1eall.com

DATE

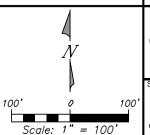

SHEET LIST TABLE

SHEET TITLE

GENERAL NOTES GENERAL LEGEND

TYPICAL SECTIONS & DETAILS

SIDEWALK PLAN & PROFILE

SIDEWALK PLAN & PROFILE

EROSION CONTROL PLAN EROSION CONTROL DETAILS

TRAFFIC CONTROL PLAN

INTERSECTION & DRIVEWAY DETAILS

SHEET

NUMBER

06

08

(IMPROVEMENTS), MISSOURI SIDEWALK PF STREET CITY

SCALE HOR. 1" = 100' SCALE VERT.

COVER SHEET

CJW NO. 24123

- 1. THE CONTRACTOR SHALL MAINTAIN ACCESS FOR RESIDENTIAL AND COMMERCIAL DRIVEWAYS AT ALL TIMES
- 2. THE CONTRACTOR SHALL MAINTAIN ALL SIGNALIZED INTERSECTIONS LOCATED WITHIN THE WORK ZONE AT ALL TIMES.
- 3. ALL EXISTING SIGNS SHALL BE MAINTAINED AND RELOCATED WHEN NECESSARY. SIGNING SHALL BE INSTALLED PRIOR TO OPENING ANY SECTION OF THE ROADWAY FOR TRAFFIC.
- 4. DISTANCES MAY BE SHORTENED BETWEEN ADVANCE WARNING
- 5. PAVEMENT MARKINGS NO LONGER APPLICABLE SHALL BE REMOVED OR OBLITERATED. TEMPORARY MARKINGS SHALL BE USED AS NECESSARY.
- 6. LOCATION AND SPACING OF SIGNS, AND BUFFER SPACE MAY BE ADJUSTED IN THE FIELD TO MORE ACCURATELY REFLECT ACTUAL
- 7. CHANNELIZERS SHALL BE PLACED OFF OF THE PAVEMENT WHEN NORK IS NOT IN PROGRESS UNLESS LANE CLOSURE IS IN EFFECT

CONDITIONS WITH APPROVAL OF THE ENGINEER.

- 8. THE MAXIMUM SPACING BETWEEN CHANNELIZING DEVICES IN A TAPER SHOULD BE APPROXIMATELY EQUAL IN FEET TO THE SPEED LIMIT. CHANNELIZING DEVICES SHOULD BE 5-10 FEET
- 9. THE CONTRACTOR SHALL MAINTAIN MINIMUM 10' WIDE LANES AT
- 10. THE CONTRACTOR SHALL OBTAIN ALL NECESSARY PERMITS
- 11. SUPPLEMENTAL WARNING METHODS MAY BE USED TO CALL ATTENTION TO THE WORK ZONE.
- 12. CONES MAY BE USED FOR DAYLIGHT OPERATION ONLY
- 13. BARRICADES REQUIRE LIGHTS IF USED OVERNIGHT
- 14. IF APPLICABLE, OTHER APPROPRIATE SIGNS MAY BE USED IN LIEU OF THE "ROAD WORK AHEAD" SIGN.
- 15. SUPPLEMENTAL WARNING METHODS MAY BE USED TO CALL ATTENTION TO THE WORK ZONE.
- 16. FOR MOBILE OPERATIONS WHERE WORKERS ARE ON FOOT AND MOVE WITH THE OPERATION, CHANNELIZERS MAY BE REDUCED OR ELIMINATED.
- 17. ALL CONSTRUCTION SIGNS, BARRICADES, DRUMS, MARKINGS AND OTHER TRAFFIC CONTROL DEVICES MUST BE UTILIZED AND MAINTAINED IN COMPLIANCE WITH PART VI OF THE "MANUAL ON UNIFORM TRAFFIC CONTROL DEVICES"; 2023 EDITION REVISION OR LATEST REVISION THEREOF (MUTCD).
- 18. WHERE FLAGGERS ARE REQUIRED, ADVANCED SIGNING SHALL BE AS PERMITTED BY MUTCD. THE FLAGGER SHALL MEET THE REQUIREMENTS OF MUTCD WITH REGARD TO CHARACTER, ATTIRE, BEHAVIOR, AND MUST BE CERTIFIED AS A FLAGGER ORGANIZATION SUCH AS ATSSA OR IMSA OR AN APPROVED
- 19. WHERE MINIMUM LANE WIDTHS CANNOT BE ACHIEVED ON THE MINOR STREETS, THE CONTRACTOR SHALL CLOSE HALF OF THE APPROACH AND POSITION A FLAGGER AT EACH END OF THE WORK AREA. ADVANCE FLAGGER SIGNING SHALL BE INSTALLED AS OUTLINED IN THE MUTCD. AT THE SAME TIME, ALL TURNS FROM THE MAJOR STREET SHOULD BE PROHIBITED. THE CONTRACTOR WOULD APPLY THE TRAFFIC CONTROL FOR THE LEFT TURN LANE CLOSURE AND INSTALL RIGHT TURN PROHIBITION SIGNS AS DESCRIBED ABOVE.
- 20. THE CONTRACTOR SHALL BE RESPONSIBLE FOR MAINTAINING IN POSITION, CLEANING AND REPLACING, DAMAGED TRAFFIC CONTROL DEVICES, STREET LIGHTS, AND OR OTHER UTILITIES.
- 21. THE CONTRACTOR SHALL BE RESPONSIBLE FOR KEEPING ALL
- 22. ADEQUATE CLEARANCE AT INTERSECTIONS SHALL BE MAINTAINED TO PROVIDE PROPER SIGHT DISTANCE FOR THE SAFE OPERATION OF VEHICLES, SIGNALS, AND PROVIDE SAFETY FOR
- 23. CONTRACTOR IS RESPONSIBLE FOR AVOIDING ANY AND ALL UTILITIES WHEN SETTING SIGN POSTS AND WILL BE REQUIRED TO COORDINATE HIS ACTIVITIES WITH ANY AND ALL UTILITY COMPANIES, WHETHER THEIR FACILITY IS INDICATED ON THE
- 24. PAYMENT WILL BE MADE FOR "TEMPORARY TRAFFIC CONTROL" AS LISTED IN THE BID PROPOSAL. SUCH PAYMENT SHALL CONSTITUTE FULL COMPENSATION FOR ALL WORK NECESSARY
- 25 THE TRAFFIC CONTROL REQUIREMENTS SHOWN ON THESE PLANS ARE MINIMUM REQUIREMENTS ONLY AND DO NOT ATTEMPT TO ADDRESS IN DEPTH THE VARIETY OF SITUATIONS THAT MAY OCCUR ONCE CONSTRUCTION HAS STARTED. IN NO WAY DO T REQUIREMENTS SHOWN ON THESE PLANS RELIEVE THE CONTRACTOR OF THE RESPONSIBILITY FOR SELECTION OF THE PROPER TRAFFIC CONTROL DEVICES AND IMPLEMENTATION PROCEDURES THAT WILL ASSURE THE SAFETY OF MOTORISTS. QUANTITIES OF TRAFFIC CONTROL DEVICES NECESSARY TO COMPLETE CONTRACT. REQUIRED AS PART OF CONTRACTORS MEANS & METHODS, OR AS ORDERED BY THE ENGINEER SHALL

TEMP. EROSION CONTROL NOTES:

- 1. THIS PLAN SHOWS THE LOCATION AND DETAILS FOR PRIMARY SEDIMENT CONTROL TO BE CONSTRUCTED. THE CONTRACTOR IS RESPONSIBLE FOR CONTROLLING EROSION AND DISCHARGE OF THE CONTRACTOR SHALL PROVIDE NECESSARY MEASURES DURING ALL PHASES OF OPERATIONS REGARDLESS OF WHETHER THEY ARE SPECIFICALLY NOTED ON THIS PLAN AND SHALL MAINTAIN AND REPLACE CONTROLS AS NECESSARY DURING THE
- 2. GRAVEL BAGS AND FIBER ROLLS OR OTHER INITIAL SEDIMENT CONTROLS SHOWN ON THIS PLAN MUST BE INSTALLED PRIOR TO ANY OTHER WORK. GRAVEL BAGS AND FIBER ROLLS OR OTHER CONTROLS SHALL BE INSPECTED AND MAINTAINED ONCE A WEEK AND AT THE HALF WAY POINT OF CONSTRUCTION.
- 3. THE CONTRACTOR SHALL CLEAN SWEEP AND VACUUM STREETS BOTH INTERIOR AND ADJACENT TO THE SITE DAILY, AND AS NEEDED FOR THE ON SITE INSPECTOR; AFTER EACH RAINFALL, AFTER COMPLETION OF EACH CONSTRUCTION PHASE, AND AT
- 4. THE CONTRACTOR IS RESPONSIBLE FOR CONTROLLING DUST DURING CONSTRUCTION AND SHALL WATER CONSTRUCTION
- 5. THE CONTRACTOR SHALL PREVENT STORM PIPES FROM ACCUMULATING SEDIMENT AS THEY ARE INSTALLED.
- 6. THE CONTRACTOR IS RESPONSIBLE FOR DEWATERING AS NEEDED. DURING DEWATERING, WATER SHOULD NOT BE RETURNED DIRECTLY TO WATERWAY BUT SHALL BE PUMPED UPLAND AND FILTERED THROUGH AN APPROPRIATE TREATMENT
- 7. THE CONTRACTOR SHALL MAINTAIN AND INSPECT EROSION CONTROL MEASURES AND BEST MANAGEMENT PRACTICES THROUGHOUT CONSTRUCTION IN ACCORDANCE WITH THE CONDITIONS OF THE LAND DISTURBANCE PERMIT. COPIES OF THE LAND DISTURBANCE PERMIT AND STORM WATER POLLUTION PREVENTION PLAN SHALL REMAIN ON SITE THROUGHOUT
- 8. PHASING AND SEQUENCING IS ONE OF THE BEST BMPS. WORK IN THE ACTIVE CHANNELS AND/OR ON SLOPES SHALL TO BE KEPT TO AS SHORT OF A DURATION AS POSSIBLE. AREAS NOT INSIDE A COFFER DAM SHALL BE STABILIZED IN 2 DAYS.
- 9. UTILITY WORK CANNOT OCCUR UNTIL BMPS ARE INSTALLED AND A PERMIT HAS BEEN ISSUED.
- 10. NO STOCKPILES ARE TO BE PLACED IN FRONT OF INLETS OR IN A DRAINAGE CHANNEL
- 11. CONTRACTOR SELECTED STAGING AREA SHALL PROVIDE PROTECTION FROM ALLOWING SEDIMENT, DEBRIS OR RESIDUE FROM ENTERING OR LEAVING THE PROJECT SITE. ALL STOCKPILES SHALL BE PROTECTED WITH THE APPROPRIATE BMP'S. ANY AND ALL BMP'S, REQUESTED BY OWNER, TO COMPLY WITH THE ABOVE SHALL BE INSTALLED AND MAINTAINED IMMEDIATELY BY CONTRACTOR AT THEIR EXPENSE. LOCATION SHALL BE DISCUSSED AT PRE PERMIT MEETING.
- 12. CONSTRUCTION EXIT SHALL BE INSTALLED AS NECESSARY TO PREVENT TRACK-OUT. LOCATIONS MAY VARY DEPENDING ON CONTRACTORS SELECTED MEANS & METHODS. OWNER MAY AT ANY TIME OR FROM TIME TO TIME REQUEST ADDITIONAL EXITS, DEPENDING ON SITE CONDITIONS.
- 13. THE CONTRACTOR SHALL BE RESPONSIBLE FOR MAINTAINING EROSION CONTROL DEVICES DURING THE ENTIRE CONSTRUCTION PERIOD. ALL EROSION CONTROL MEASURES SHALL BE IN PLACE PRIOR TO BEGINNING CONSTRUCTION ACTIVITIES UNLESS
- 14. EROSION CONTROL BLANKET SHOULD BE ONE WITH ALL NATURAL MATERIALS INSTEAD OF PLASTIC NETTING SUCH AS NORTH AMERICAN GREEN BIONET OR CURLEX FIBERNET.
- 15. THE CONTRACTOR SHALL CONTAIN SAWCUT SLURRY AND PREVENT SLURRY FROM ENTERING STORM DRAINS.
- 16. THE CONTRACTOR SHALL PLACE EROSION AND SEDIMENT CONTROL BARRIERS AROUND ANY STORM INLET THAT RECEIVE STORM WATER FROM THE CONSTRUCTION AREA.
- 17. THE CONTRACTOR SHALL BE RESPONSIBLE FOR THE INSTALLATION AND MAINTENANCE OF ANY ADDITIONAL BMP'S NEEDED TO KEEP SEDIMENT AND OR POLLUTANTS FROM LEAVING
- 18. ALL AREAS DISTURBED, CUT, GRATED OR LEFT WITHOUT GRASS WILL NEED PERMANENT STABILIZATION WITHIN 14 DAYS.
- 19. IF STABILIZATION CANNOT BE ACHIEVED WITHIN 14 DAYS, TEMP BMP'S WILL BE REQUIRED. THESE ADDITIONAL BMP'S AS REQUESTED BY OWNER ARE CONSIDERED INCIDENTAL TO
- 20. REFER TO STORM WATER POLLUTION PREVENTION PLAN (SWPPP).
- 21. ALL CHANGES TO ESC PLAN AND PHASES NEED TO BE APPROVED BY THE CITY'S WATER QUALITY INSPECTOR.
- 22. ALL TYPE II ROCK BLANKETS SHALL BE CONSTRUCTED OF WELL GRADED GRANULAR BACKFILL AS PER DETAIL STANDARDS.

REMOVAL NOTES:

- 1. THE CONTRACTOR SHALL REMOVE AND DISPOSE OF ALL DEBRIS, RUBBISH AND OTHER MATERIALS RESULTING FROM CURRENT DEMOLITION OPERATIONS.
- 2. DISPOSAL OF REMOVALS SHALL BE IN ACCORDANCE WITH ALL FEDERAL, STATE, AND LOCAL REGULATIONS GOVERNING SUCH
- 3. SAWCUT EXISTING PAVEMENT AND SIDEWALKS AS NEEDED FOR REMOVAL AND CONSTRUCTION OF IMPROVEMENTS
- 4. CONTRACTOR SHALL CONTAIN SAW CUT SLURRY AND PREVENT SLURRY FROM ENTERING STORM DRAINS.
- 5. ALL EXISTING ASPHALT AND CONCRETE PAVEMENT BEING REMOVED SHALL BE REMOVED TO ITS FULL DEPTH INCLUDING
- 6. THE CONTRACTOR SHALL COORDINATE THE REMOVAL OF EXISTING UTILITIES WITH THE UTILITY PROVIDER.
- 7. CONTRACTOR SHALL PROTECT EXISTING BUILDING WALLS / DOORS / WINDOWS AND SPECIAL ENTRY PAVEMENT ADJACENT TO SIDEWALK REMOVAL. CONTACT THE ENGINEER PRIOR TO DISTURBING AREAS OF SPECIALTY PAVING AT ENTRIES WHEN GRADES NEED TO BE ADJUSTED.
- 8. IT IS THE CONTRACTOR'S RESPONSIBILITY TO DETERMINE THE EXACT HORIZONTAL AND VERTICAL LOCATION OF THE EXISTING
- 9. THE CONTRACTOR SHALL IDENTIFY AND RELOCATE ALL IRRIGATION HEADS AND LINES TO BEYOND THE NEW RIGHT-OF-WAY LINE. CONTRACTOR SHALL NOTIFY ENGINEER WHEN IRRIGATION HEADS OR LINES ARE ENCOUNTERED WITHIN TEMPORARY CONSTRUCTION EASEMENTS THAT ARE IN CONFLICT WITH CONSTRUCTION OPERATIONS. IN SUCH CASE THE FACILITIES SHALL BE RELOCATED TO BEYOND THE CONSTRUCTION LIMITS. THE CONTRACTOR IS OTHERWISE WITH CONSTRUCTION OPERATIONS. RESPONSIBLE FOR ANY DAMAGE TO EXISTING IRRIGATION FACILITIES AND WILL BE CHARGED FOR REPAIRS INCURRED BY
- 10. WHEN REQUIRED THE CONTRACTOR SHALL INSTALL TREE PROTECTION AROUND ALL TREES WITHIN CONSTRUCTION LIMITS
 NOT DESIGNATED TO BE REMOVED. SEE TREE PROTECTION PLAN.

DISCLAIMER:

THE CONTRACTOR SHALL NOTIFY THE ENGINEER IMMEDIATELY IF HE OBSERVES CONDITIONS IN THE FIELD THAT APPEAR TO BE UNFORESEEN OR ARE MATERIALLY DIFFERENT THAN SHOWN ON THE PLANS OR WOULD CAUSE THE DESIGN, AS SHOWN ON THE PLANS THE SPECIFICATIONS. TO BE IMPRACTICAL OR INAPPROPRIATE BASED SHALL CONSULT WITH THE ENGINEER AND RECEIVE WRITTEN DIRECTION BEFORE MAKING ANY MODIFICATION TO THE PLANS OR

THE ENGINEER DISCLAIMS THE RESPONSIBILITY FOR ANY ACTIONS TAKEN BY THE CONTRACTOR NOT IN COMPLIANCE WITH THE ABOVE

GENERAL NOTE:

THESE APPROXIMATE QUANTITIES ARE PROVIDED SOLELY FOR THE CONTRACTOR'S CONVENIENCE. THE LIST OF MATERIAL DOES NOT CONSTITUTE ALL ITEMS REQUIRED FOR THE COMPLETION OF THIS

UTILITY NOTES:

EXISTING UTILITIES SHOWN ARE BASED ON ENGINEER'S CONTACT WITH UTILITY AGENCIES AND TOPOGRAPHIC SURVEY, AND ARE BELIEVED TO REASONABLY REPRESENT EXISTING LOCATIONS. HOWEVER, THE ENGINEER AND OWNER MAKE NO GUARANTEE AS TO ACCURACY OR COMPLETENESS OF INFORMATION SHOWN. THE CONTRACTOR SHALL NOTIFY ALL UTILITY AGENCIES PRIOR TO BEGINNING WORK AND SHALL COOPERATE WITH THEM IN LOCATING

PUBLIC AND PRIVATE UTILITY FACILITIES SHALL BE MOVED OR ADJUSTED PRIOR TO CONSTRUCTION AS NECESSARY BY THE OWNERS TO FIT THE CONSTRUCTION UNLESS NOTED ON THE PLANS OR IN TH PROPOSAL. THE CONTRACTOR IS RESPONSIBLE FOR MAKING HIS OWN DETERMINATION AS TO THE TYPE AND LOCATION OF UNDERGROUND UTILITIES AS MAY BE NECESSARY TO AVOID DAMAGE THERETO.

GENERAL NOTE:

- 4. IT IS THE CONTRACTOR'S RESPONSIBILITY TO DETERMINE THE EXACT HORIZONTAL AND VERTICAL LOCATION OF EXISTING UNDERGROUND FACILITIES PRIOR TO BEGINNING OF
- 5. CONTRACTOR IS TO USE EXTREME CAUTION WHEN MAKING ADJUSTMENTS TO AND/OR WORKING ABOVE OR NEAR UNDERGROUND ELECTRICAL VAULTS, COMMUNICATION VAULTS, &
- 6. IT IS THE CONTRACTOR'S RESPONSIBILITY TO CORRECT ANY DAMAGE TO UNDERGROUND UTILITIES OR OTHER OBSTRUCTIONS
- 7. ALL IMPROVEMENTS TO PEDESTRIAN AREAS SHALL MEET ALL A.D.A. REQUIREMENTS ACCORDING TO LATEST APPLICABLE

- 1. CONSTRUCTION SHALL CONFORM TO (WHAT STANDARDS?).
- 2. IT SHALL BE THE CONTRACTOR'S RESPONSIBILITY TO OBTAIN ALL NECESSARY PERMITS PRIOR TO THE START OF CONSTRUCTION
- 3. IN ACCORDANCE WITH GENERALLY ACCEPTED CONSTRUCTION PRACTICES, THE CONTRACTOR SHALL BE SOLELY AND COMPLETELY RESPONSIBLE FOR CONDITIONS OF THE JOB SITE. INCLUDING SAFETY OF ALL PERSONS AND PROPERTY AT ALL TIMES DURING THE PERFORMANCE OF THE WORK. THIS REQUIREMENT WILL APPLY CONTINUOUSLY AND NOT BE LIMITED TO NORMAL WORKING HOURS.

IMPROVEM! MISSOURI WILLARD, S OF CITY ST 뿔 SON

Š

MISSOUR

WILLARD,

CJW SCALE HOR. N/A SCALE VERT.


GENERAL

NOTES

Scale: 1" = N/A

JW NO. 24123


www.mo1eall.com

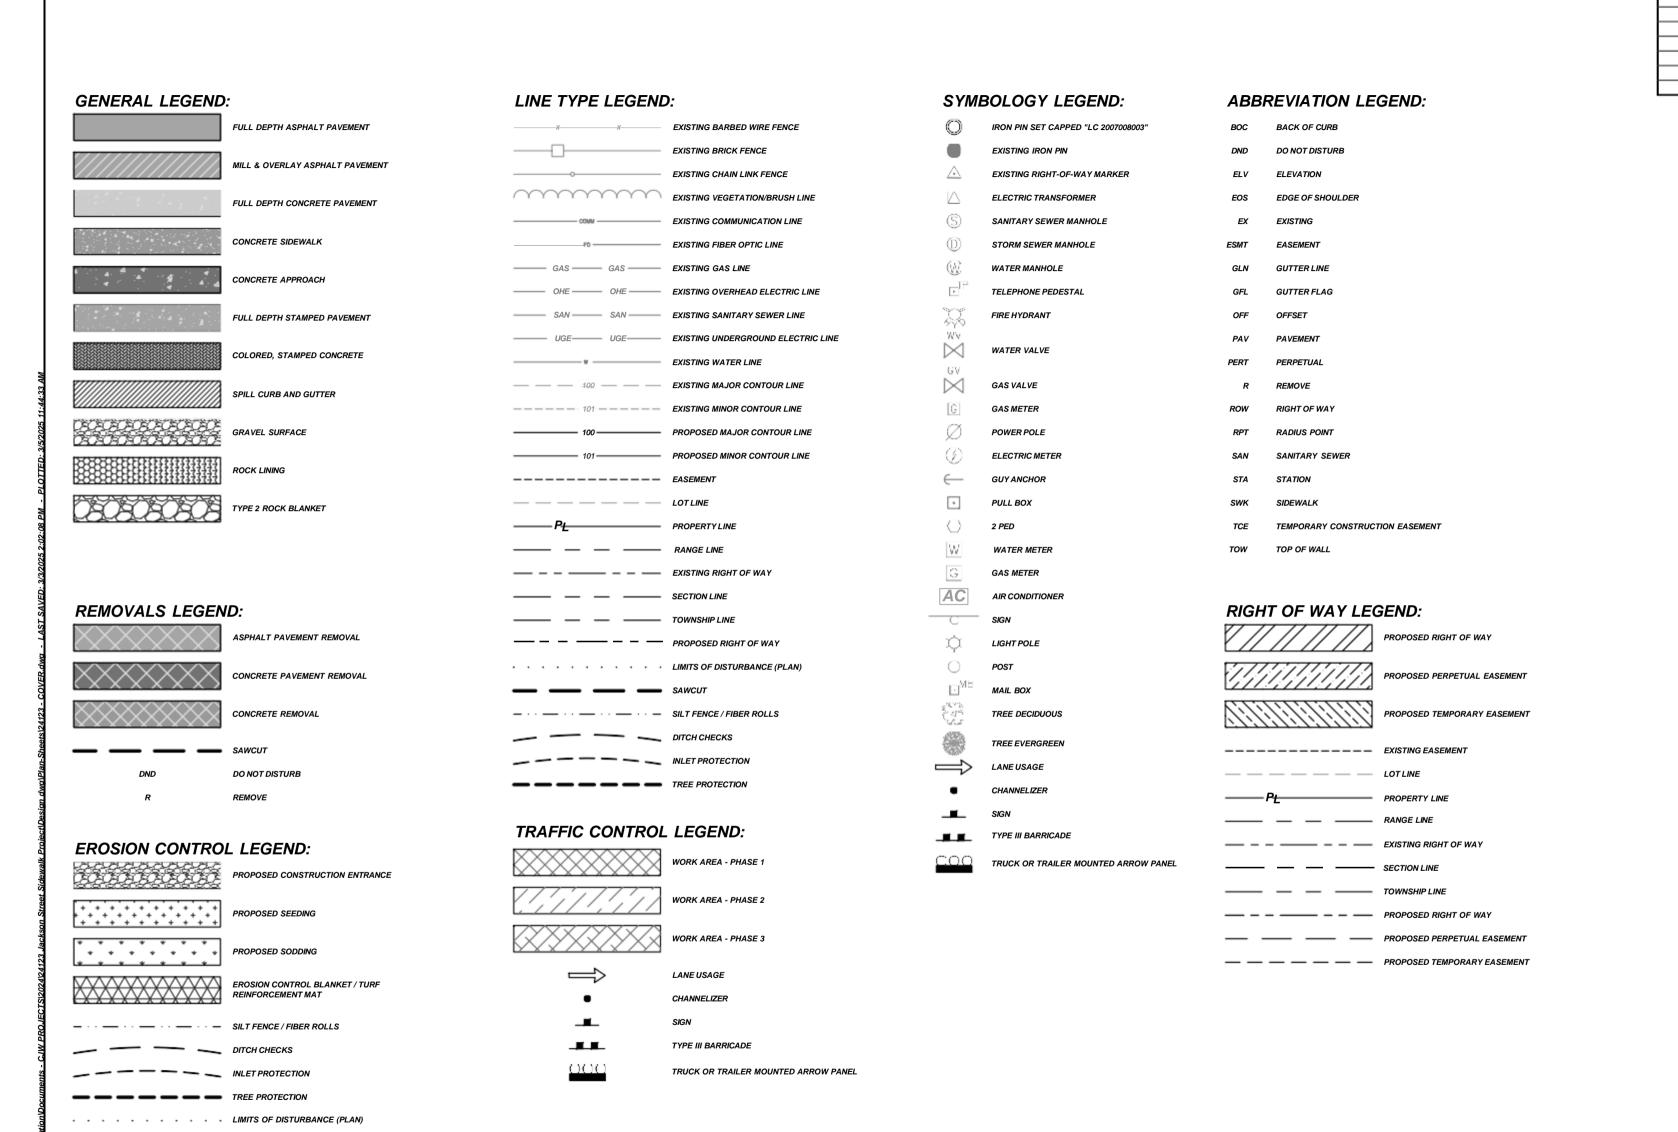

JACKSON STREET SIDEWALK IMPROVEMENTS
THE CITY OF WILLARD, MISSOURI

CJWA

DATE	DATE
SURVEYBY	CJW
DESIGN	CJW
DRAWN	CJW
CHECKED	CJW
SCALE HOR.	N/A
CALE VERT	N/A

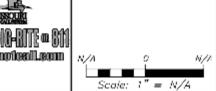



GENERAL LEGEND


SHEET NO.


03


CJW NO. 24123 OF xx

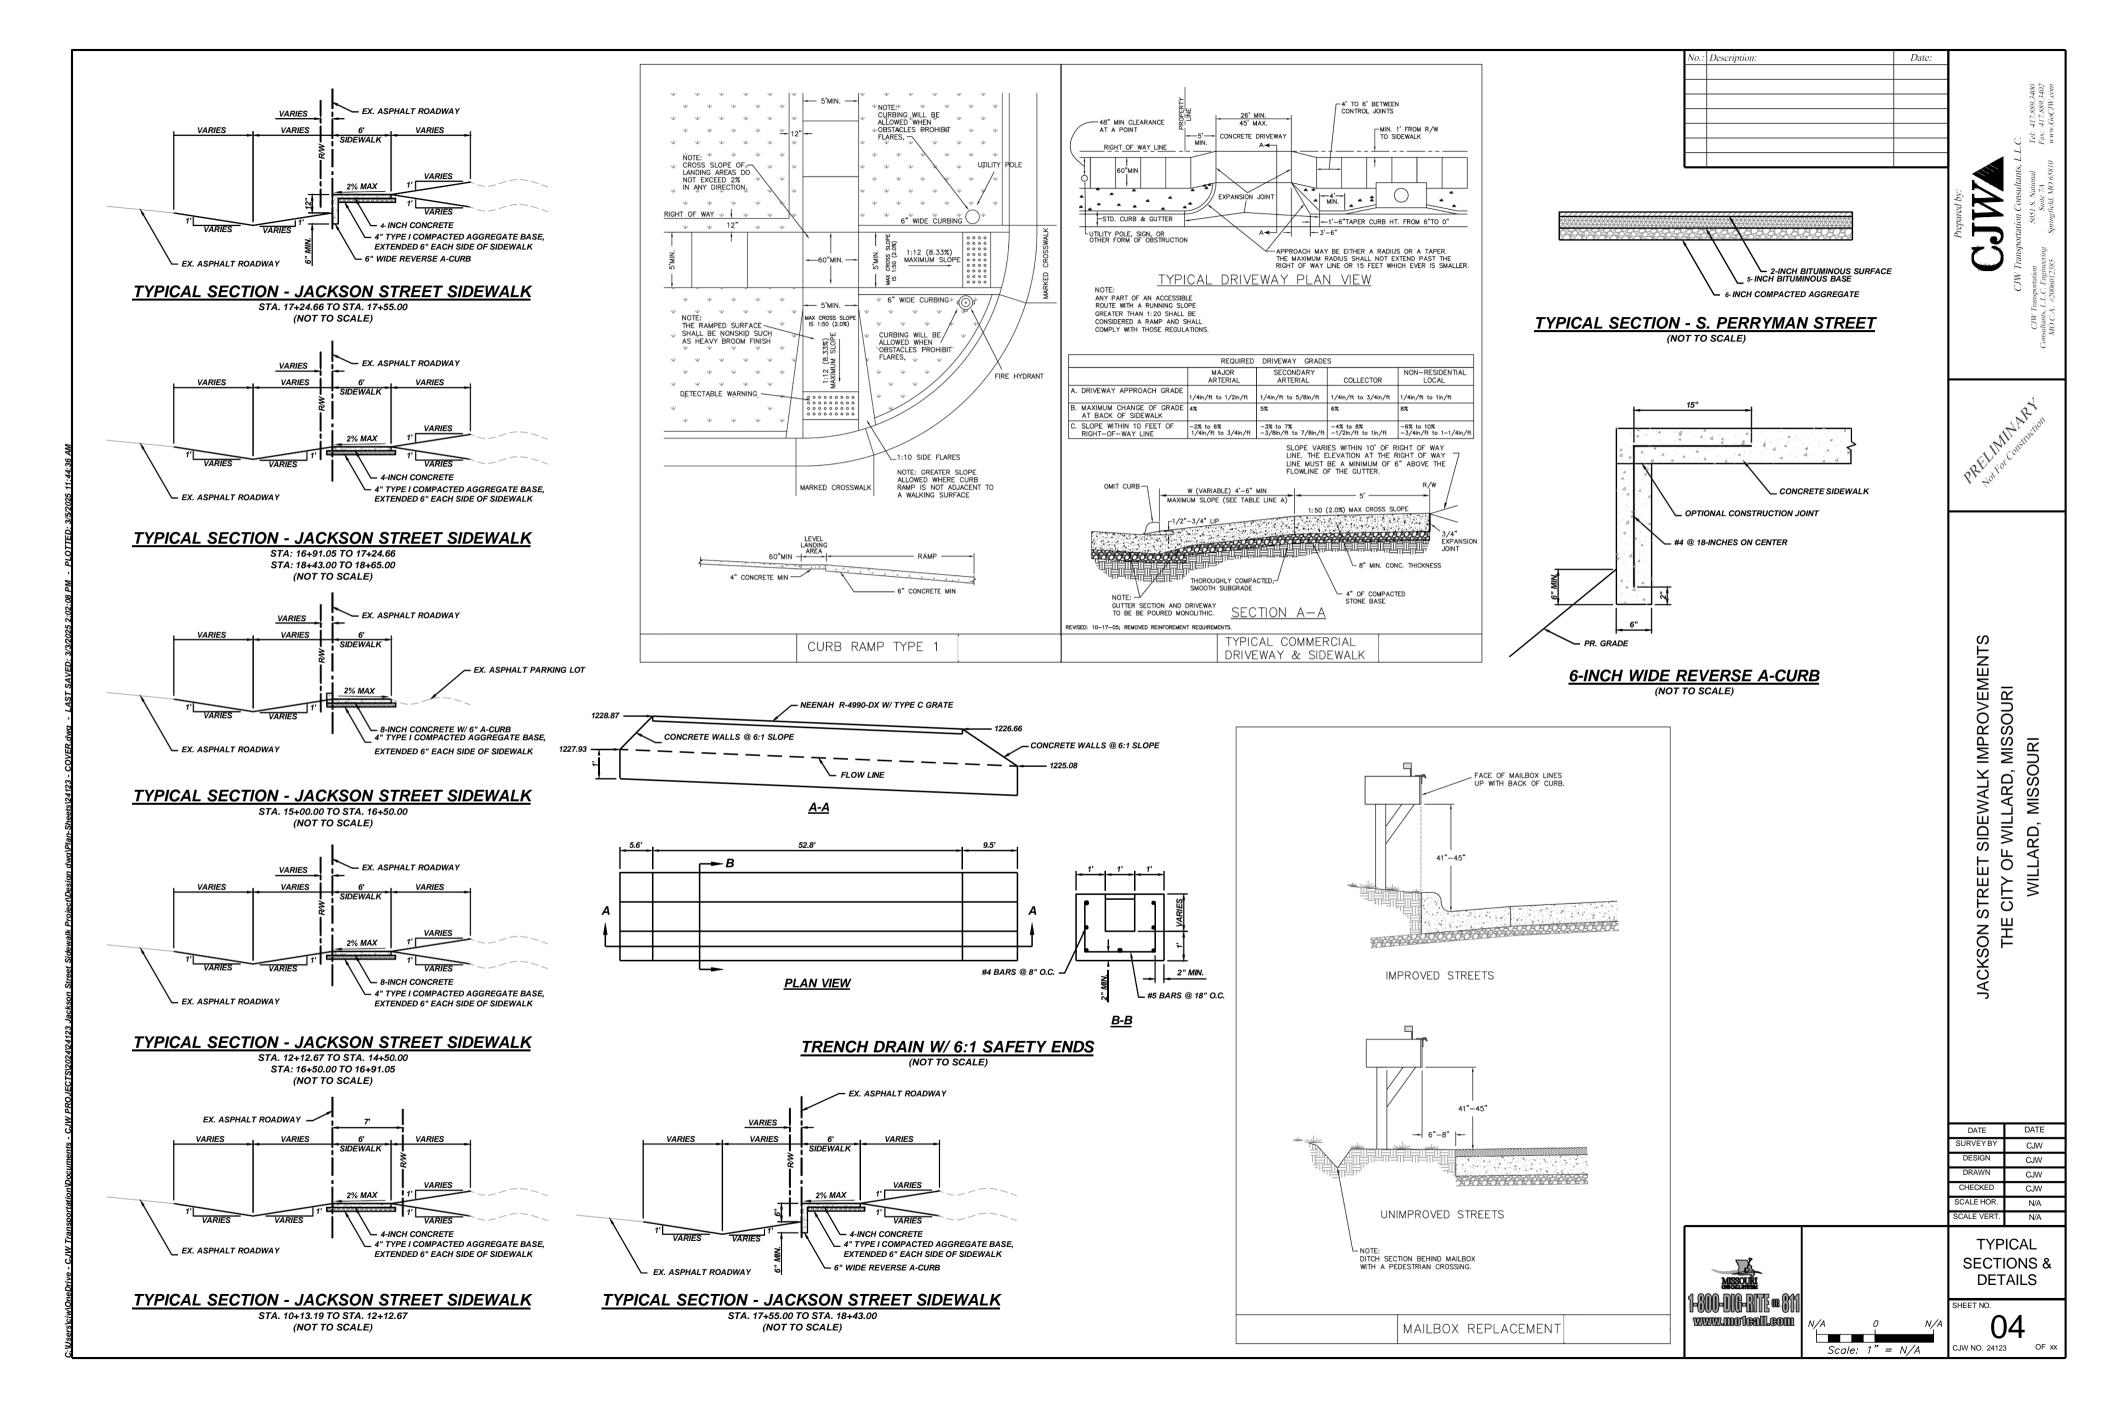


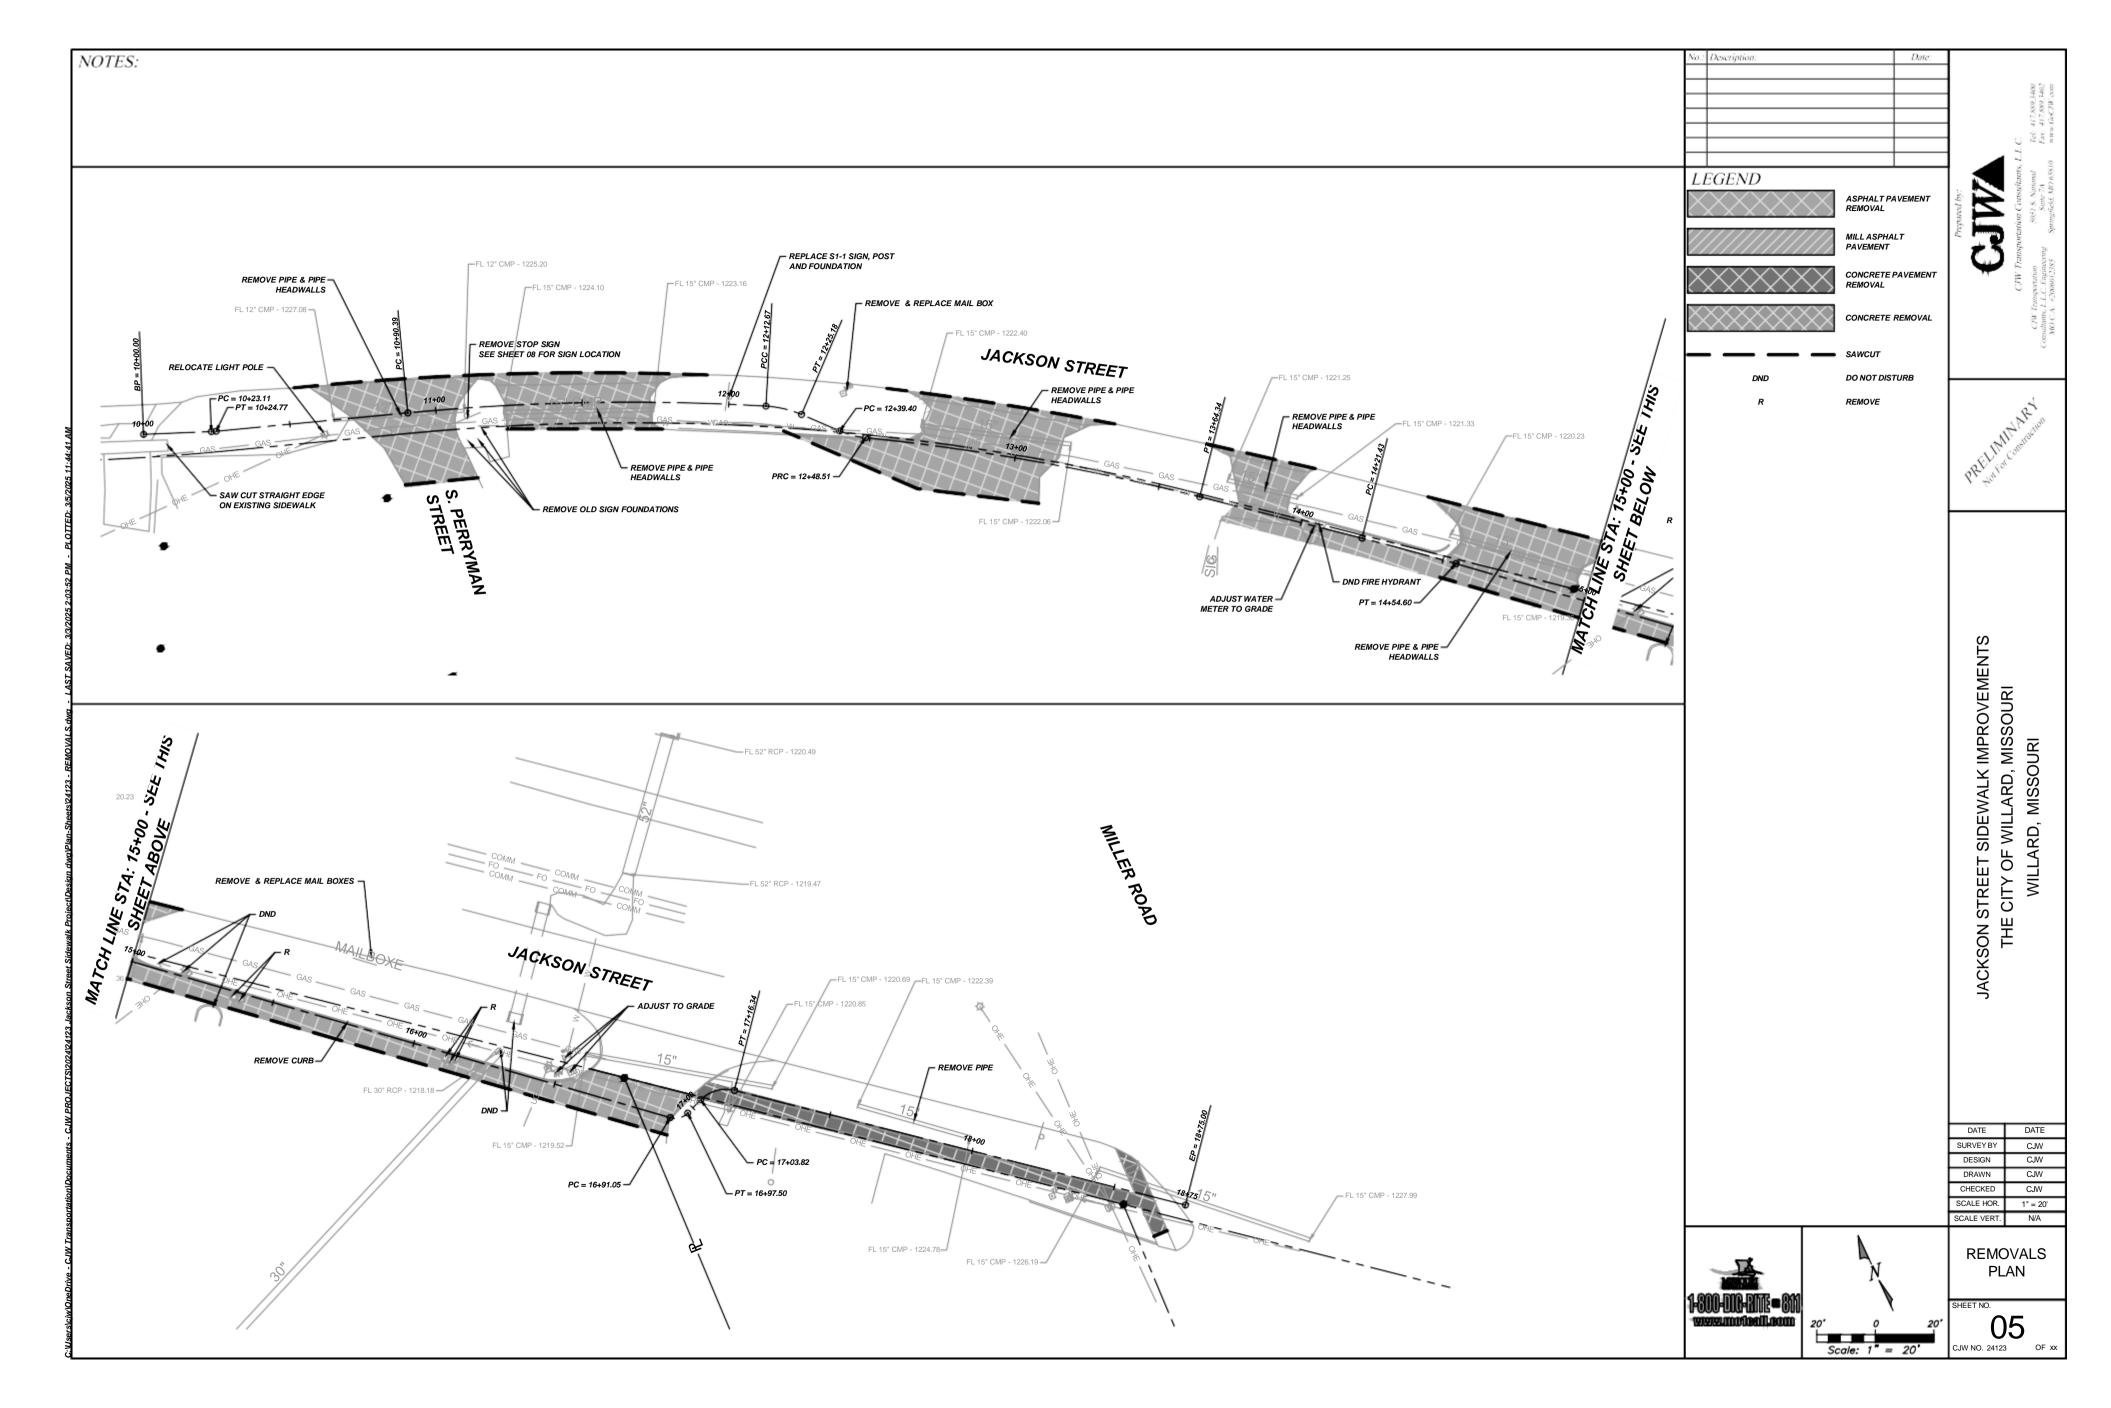

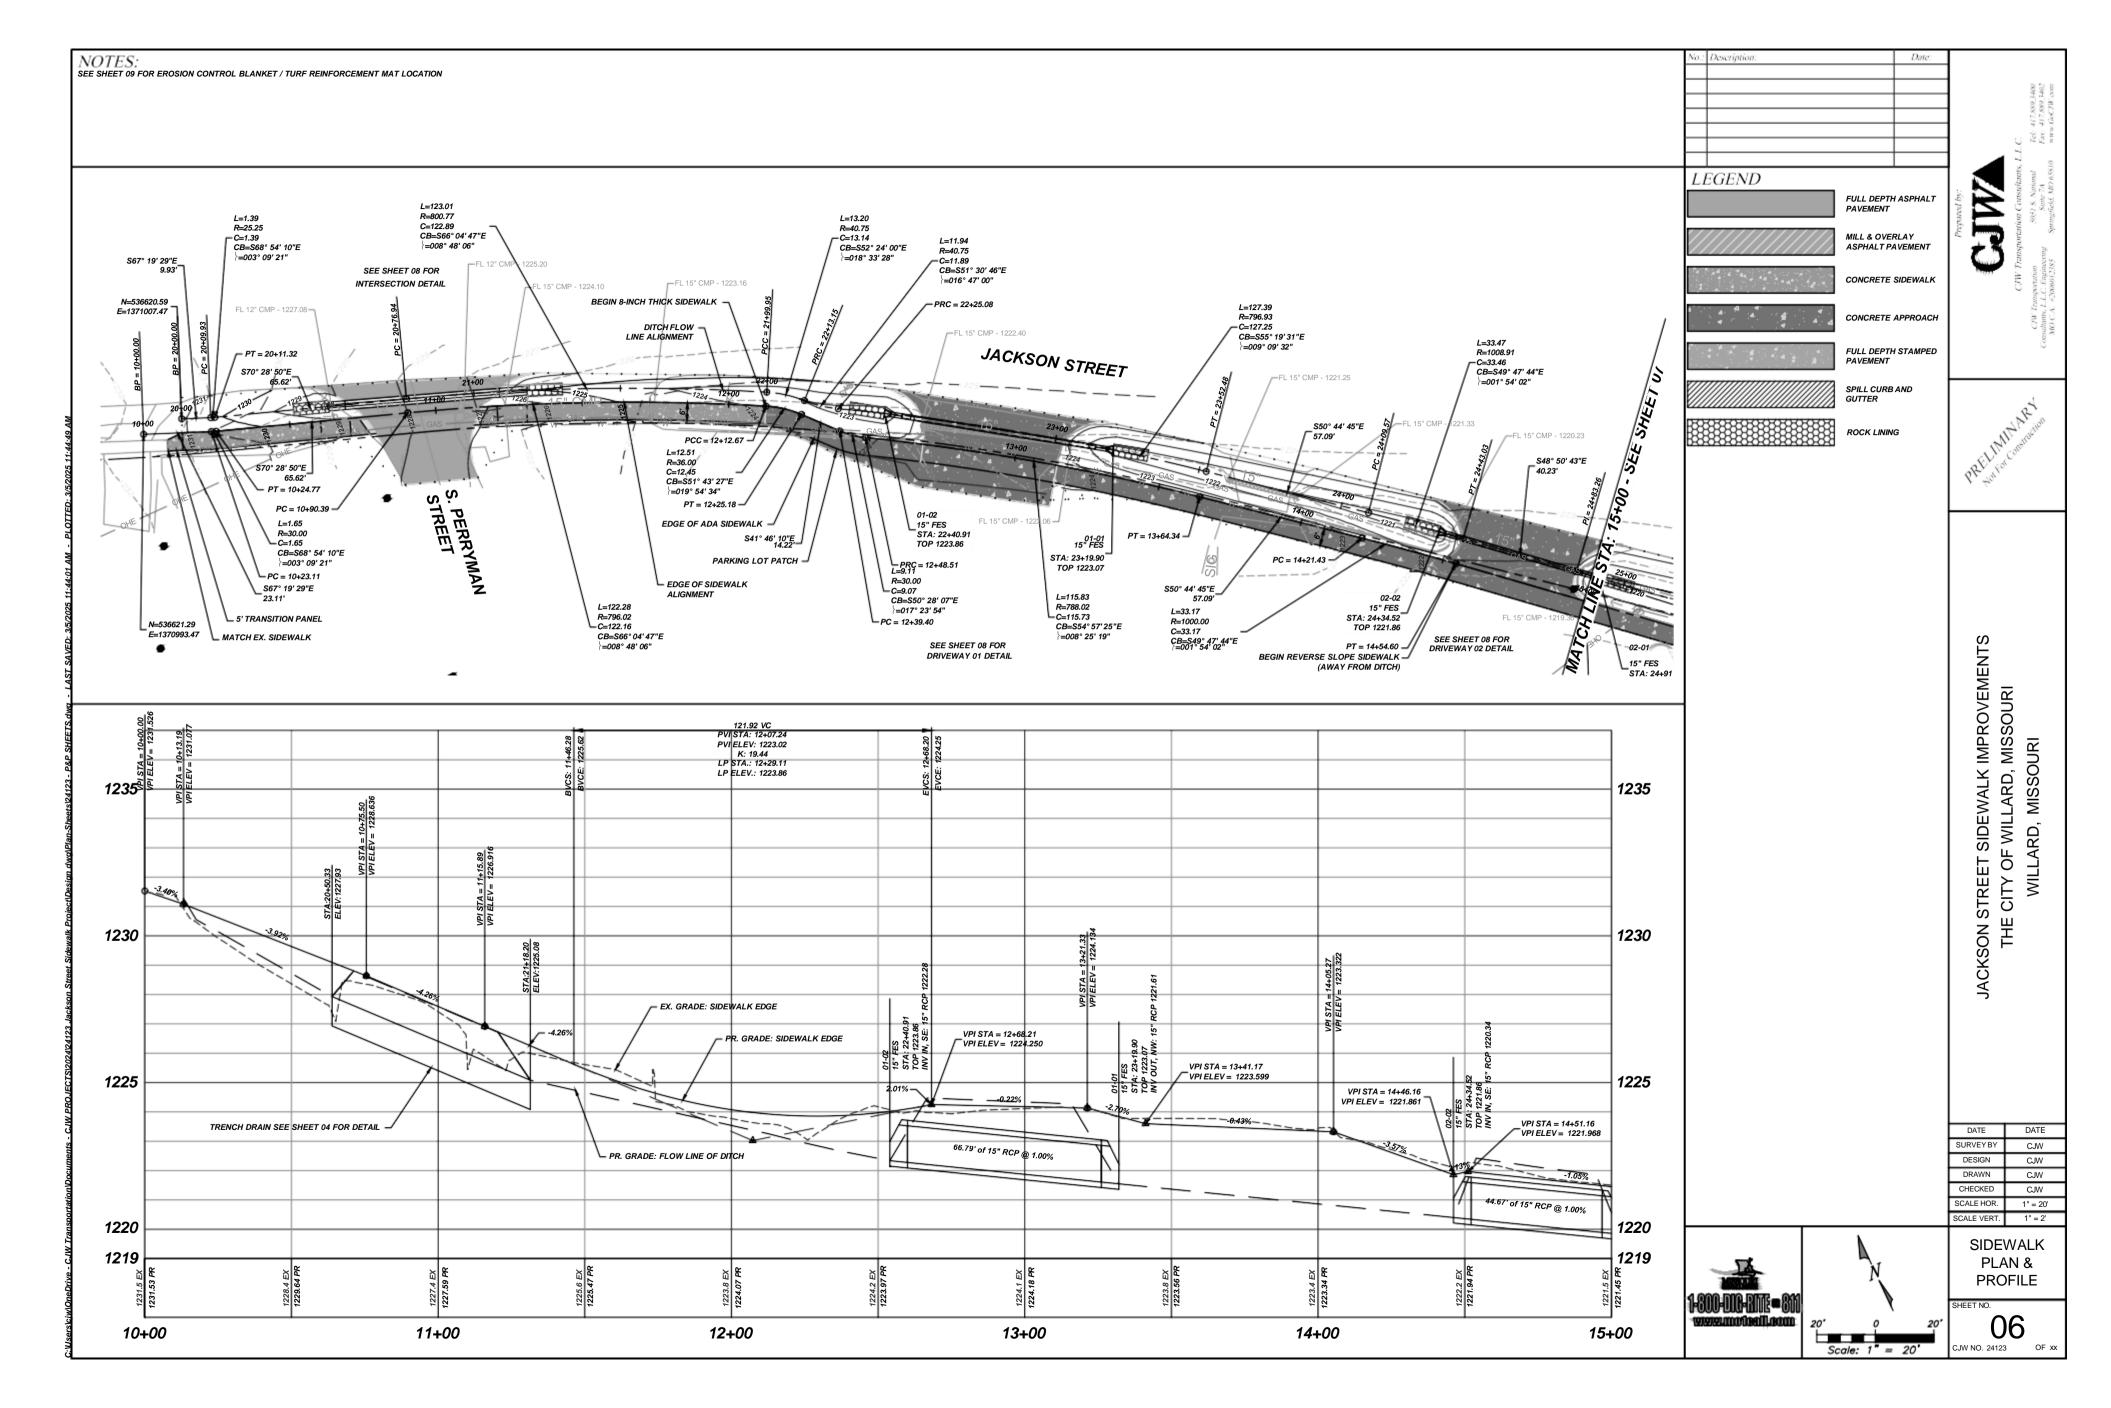


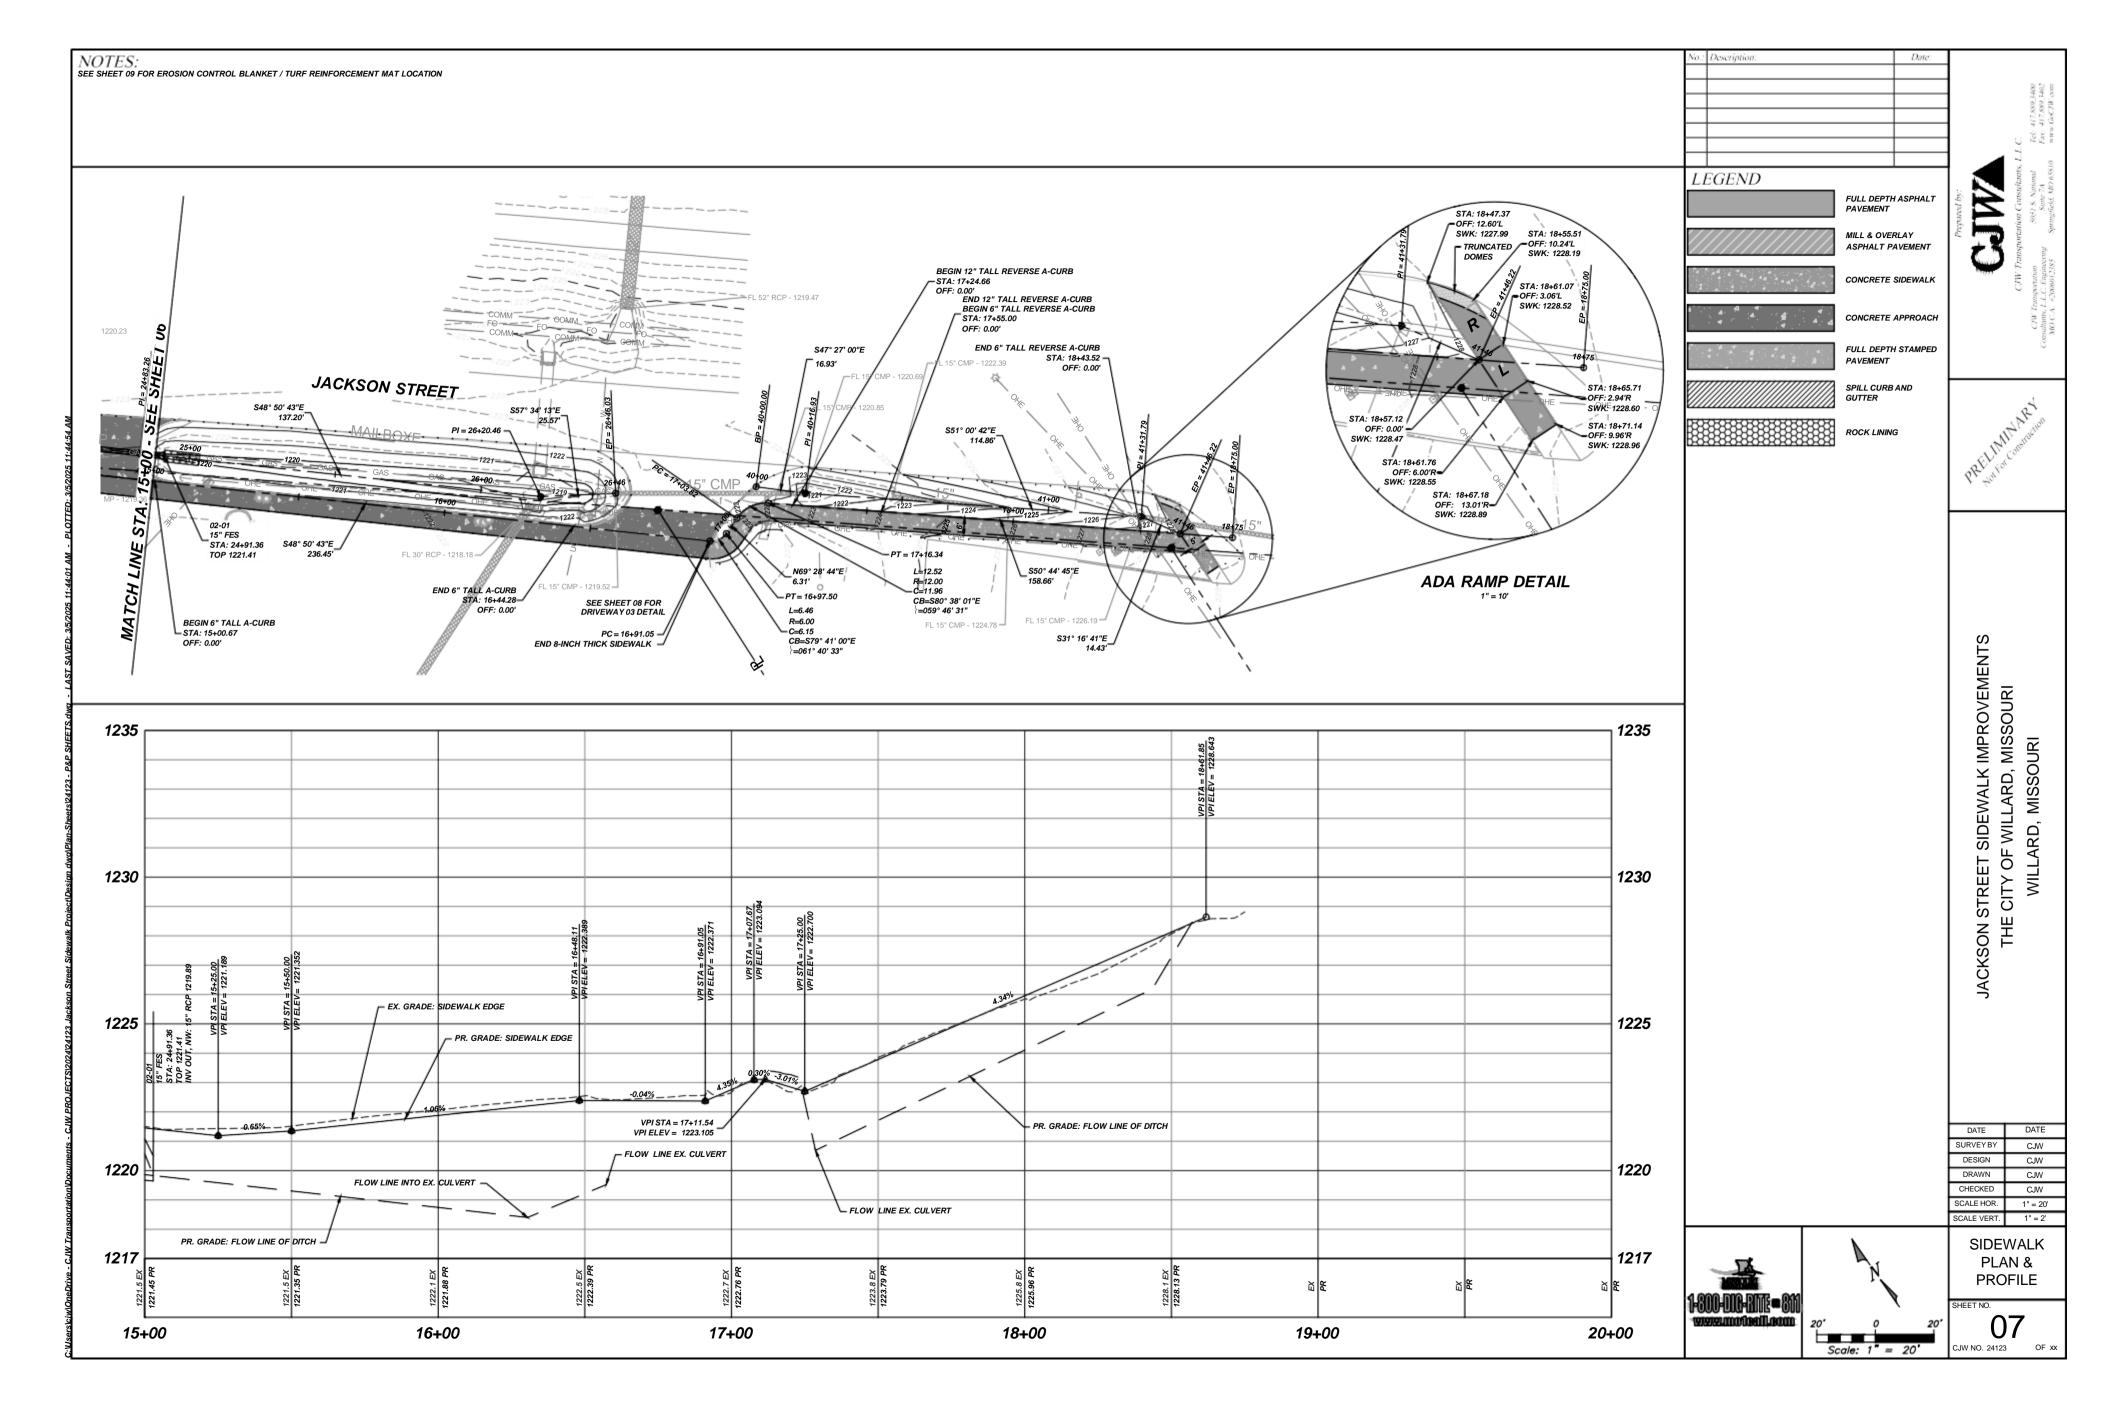


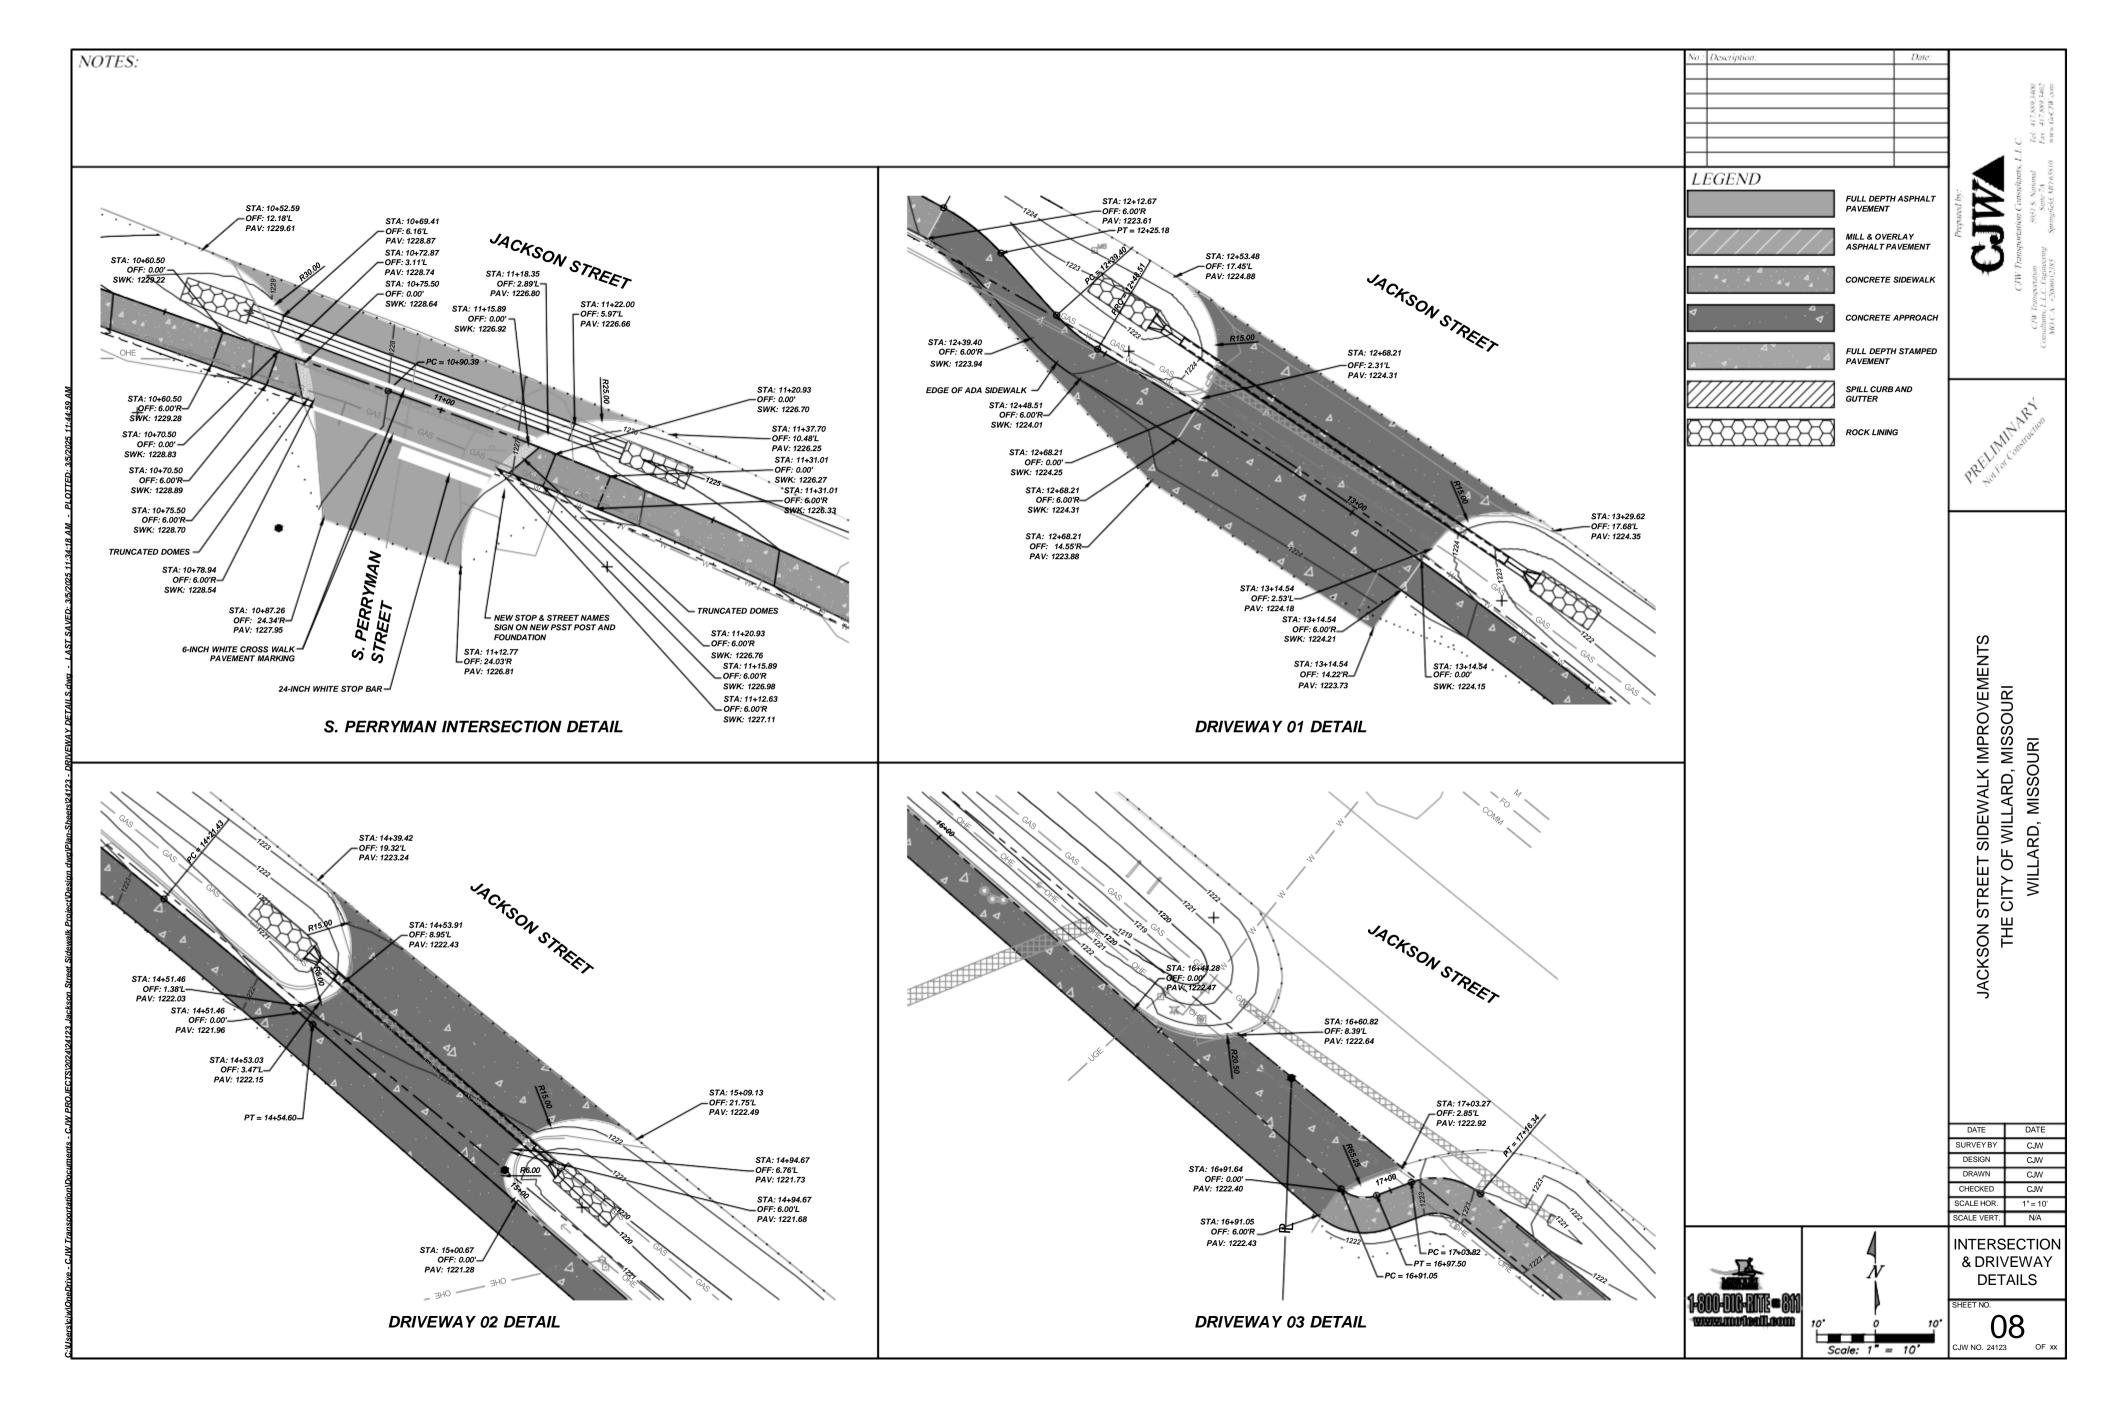


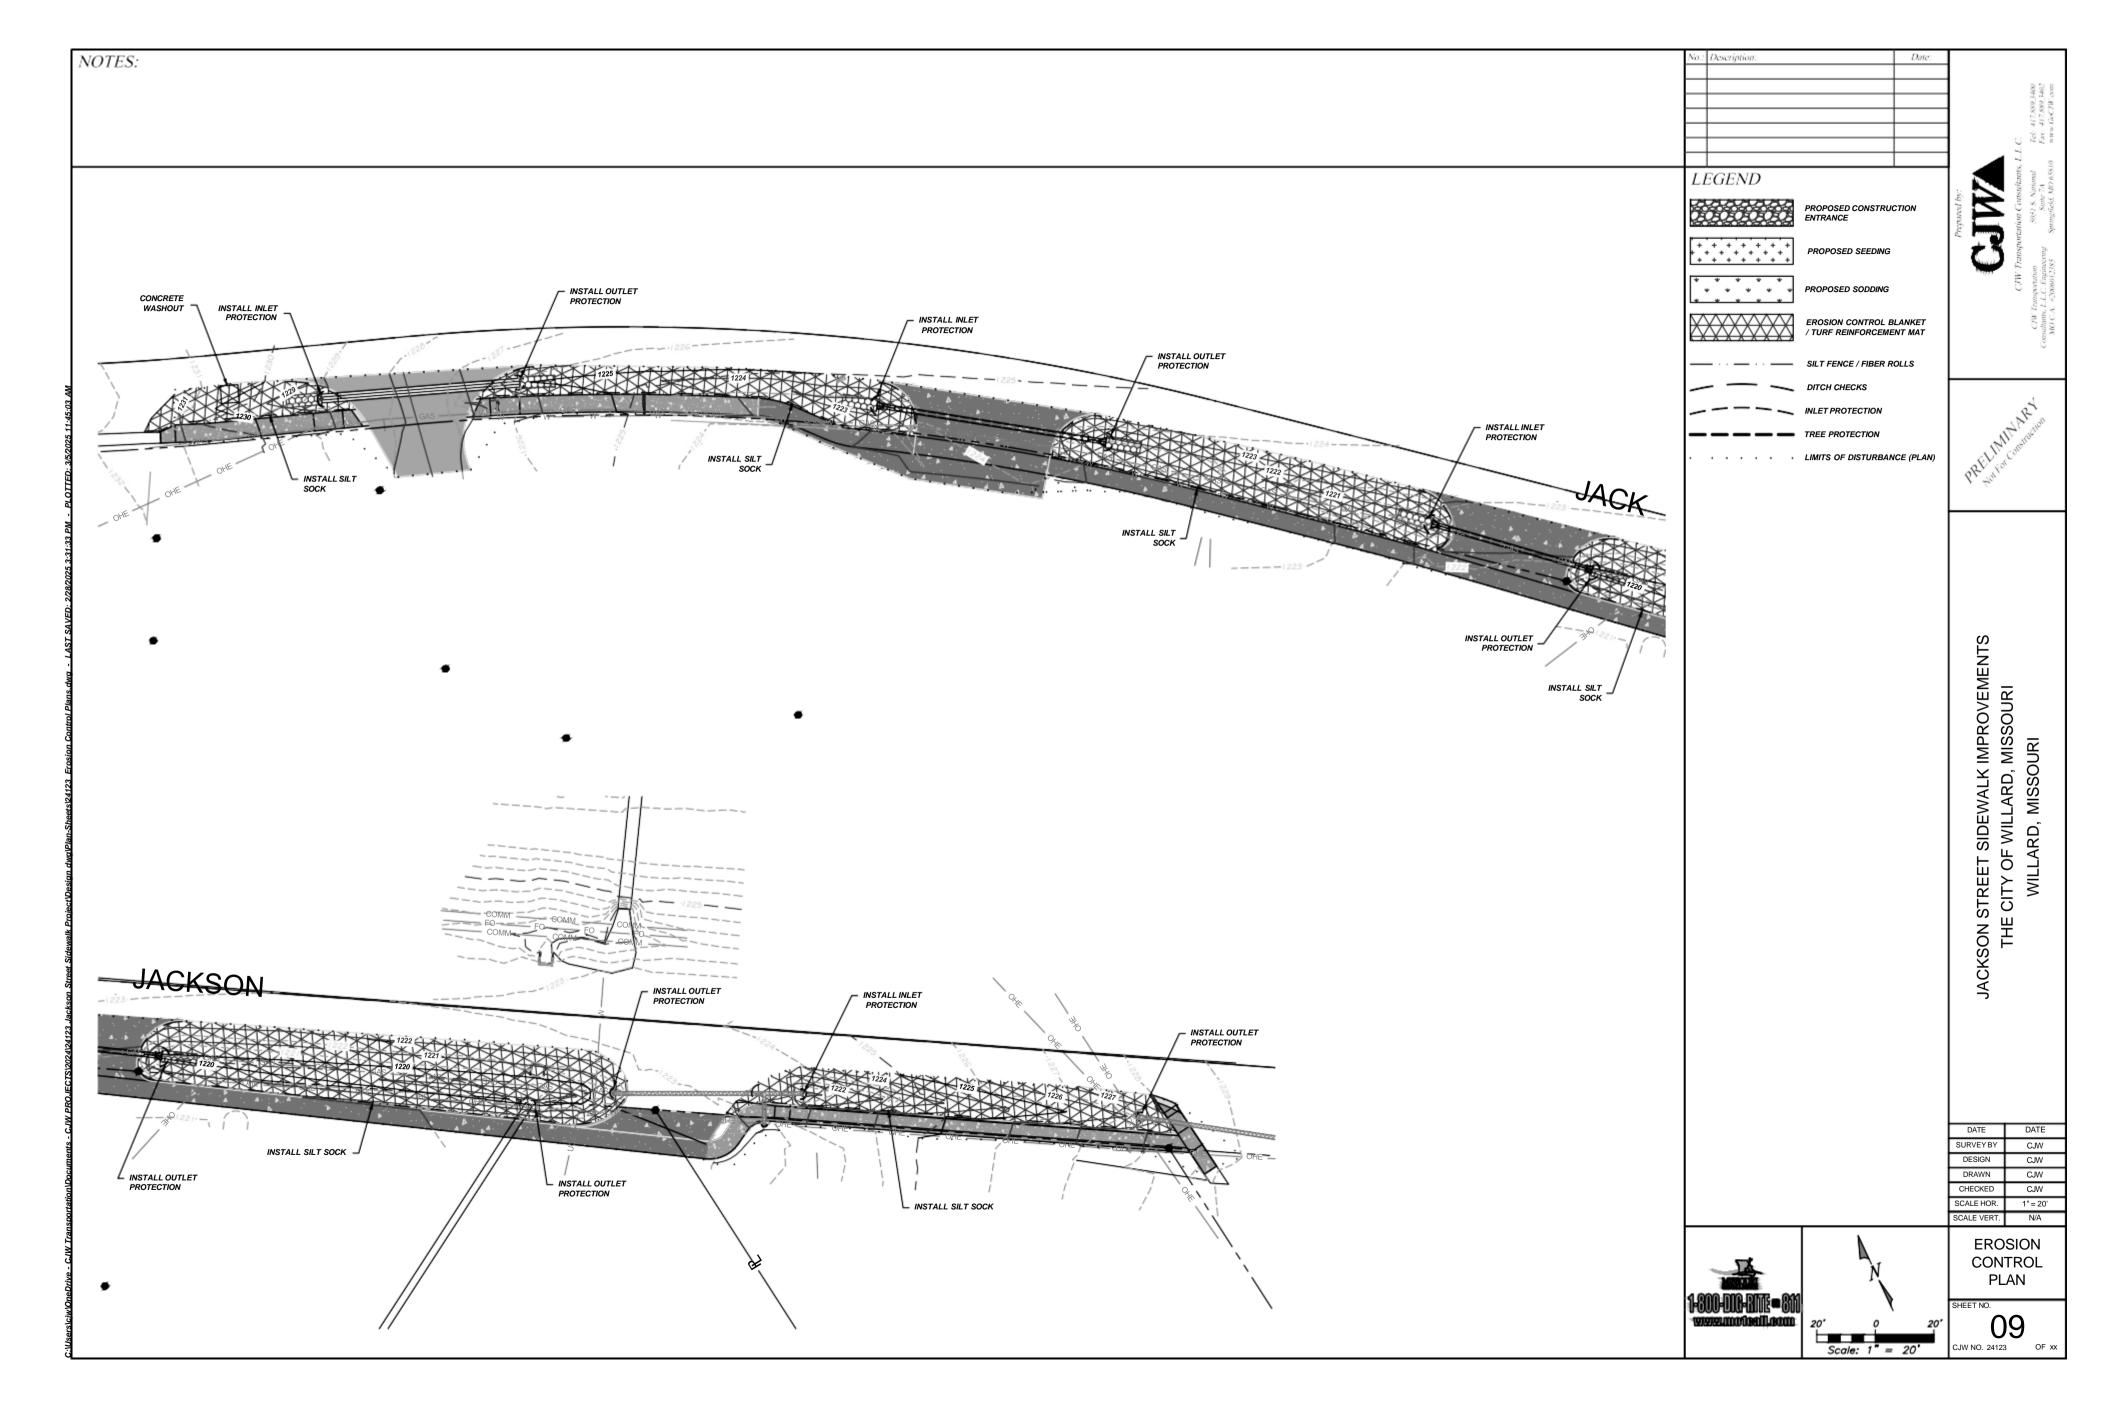





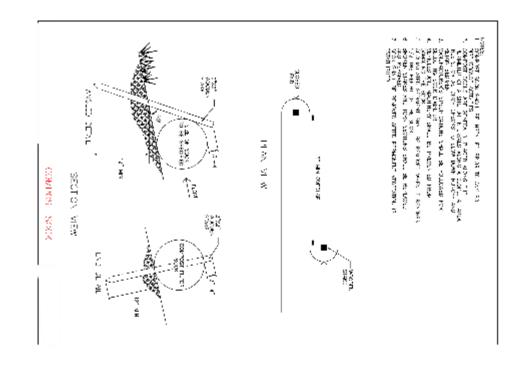


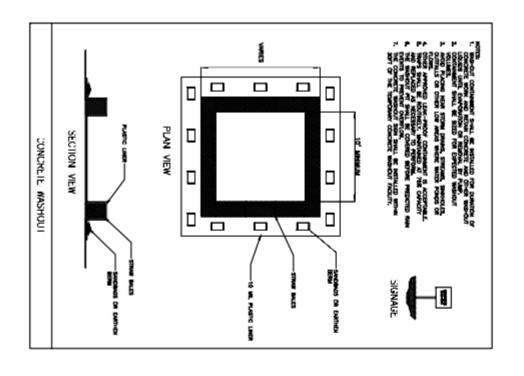


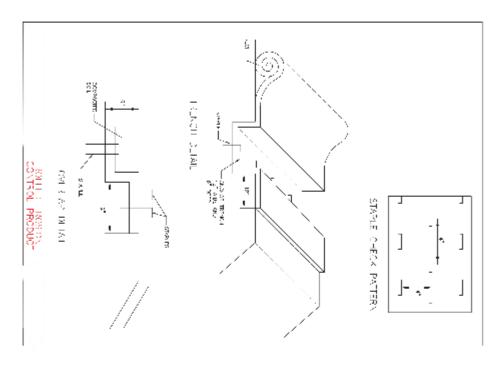


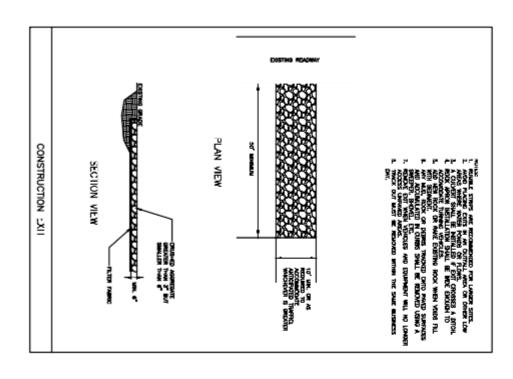

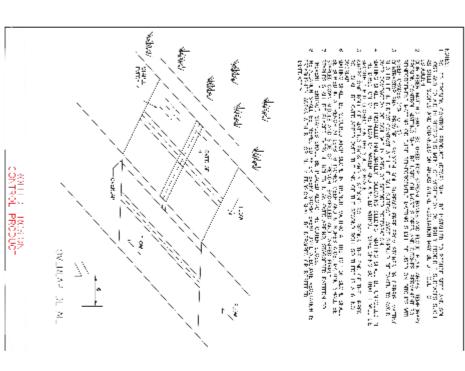

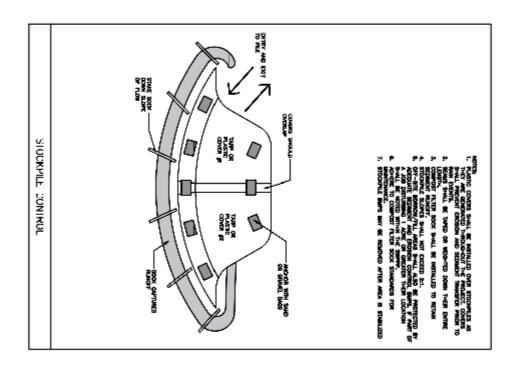

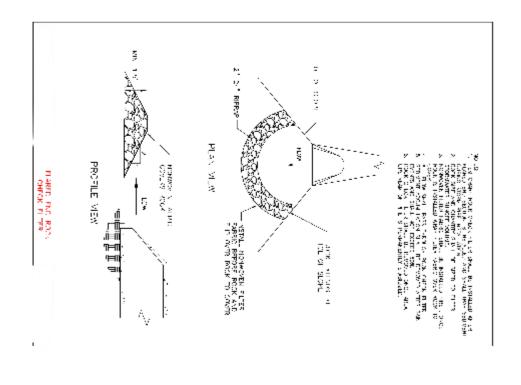

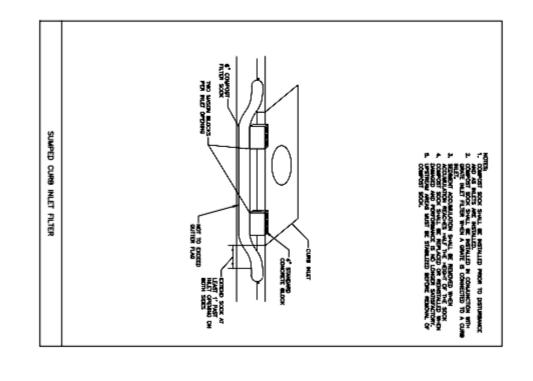



	≡	E
Scale: $1'' = N/A$	N/A 0 N/	12

SHEET NO.	EROSION CONTRO DETAILS	SCALE VERT.	SCALE HOR.	CHECKED	DRAWN	DESIGN	SURVEY BY	
	EROSION CONTROL DETAILS	N/A	N/A	CJW	CJW	CJW	CJW	

JACKSON STREET SIDEWALK IMPROVEMENTS THE CITY OF WILLARD, MISSOURI WILLARD, MISSOURI





Feb. 417,889,74(8) Feb. 417,889,1460 www.GoCTW.com CIVI Transportation Suite 7A Springfield, MO 65810 montusts, E.L.C. Fugineering MOCA #2049912385

LEGEND

C:\Users\cjw\OneDrive - CJW Transportation\Documents - CJW PROJECTS\2024\24123 Jackson Street Sidewalk Project\Design dwg\Plan-Sheets\24123 - DRIVEWAY DETAILS.dwg - LAST SAVED: 3/5/2025 11:34:18 AM - PLOTTED: 3/5/2025 11:45:07 AM NOTES: For other operations, refer to:

• Mobile: Advance warning signs may be eliminated if at least one of the following conditions are met:

1. Work space is 15 feet or more from the edge of any roadway.

2. Work space is behind the curb.

3. Work space is behind barrier or guardrail.

4. High-intensity rotating, flashing, oscillating, or strobe lights are activated. When vehicles or equipment are parked on the shoulder:

1. Activate high-intensity rotating, flashing, oscillating, or strobe lights.

2. Position the protective vehicle/TMA a minimum of 150 feet in advance of the work space, if possible.

3. Once you exit the work vehicle, return only when adjusting position or ready to leave the work location. 1. EPG 616.8.1M (TA-1M) Mobile Operation Work Beyond the Shoulder.
Short Duration (60 minutes or less):
1. EPG 616.8.1SD (TA-1SD) Short Duration Work Beyond the Shoulder.
Long-Term Stationary Operations:
2. EPG 616.6.2.2 Flags and Advance Warning Rail System.
3. EPG 617.1 Temporary Traffic Barriers. 616.8.15 (TA-1S) Stationary Work Beyond the Shoulder 9/2023 616.8.1S (TA-1S) Stationary Work Beyond the Shoulder Page 2 of 2 Field Notes: Work Zone Specialist: Type of Work: COMMENDED CHANNELIZER SPACING (ft.)

Buffer Tapers Buffer/
Length (ft.) Work Areas TRAFFIC CONTROL PLAN JACKSON STREET SIDEWALK IMPROVEMENTS THE CITY OF WILLARD, MISSOURI WILLARD, MISSOURI 5051 S. National Suite 7A Springfield, MO 65810 Tel: 417.889.3400 Fax: 417.889.3402 www.GoCJW.com CJW Transportation Consultants, L.L.C. Engineering MO C.A. #2006012385