**TILLMAN OPP NUMBER: TI-OPP-29018** SITE NAME: WHITEWATER SITE ADDRESS: 1002 S JANESVILLE STREET WHITEWATER, WI 53190 PARCEL ID: WUP 00341

**VICINITY MAP** 

FA#: 11655718

### SITE INFORMATION SITE ADDRESS: 1002 S JANESVILLE STREET LATITUDE (NAD 83): 42°49'08.8617" N (42.81912825) LONGITUDE (NADV 88): 88°45'13.7991" W (-88.75383307) GROUND ELEVATION: 850.37' (AMSL) FAA STUDY #: 2024-AGL-2388-OE JURISDICTION THE CITY OF WHITEWATER JURISDICTION CONTACT: GREG NOLL 312 W WHITEWATER STREET, WHITWATER WI 53190 920-675-9062 municipalzoningandinspection@gmail.com PARCEL/MAP NUMBER: WUP 00341 LANDLORD OWNER: HATCHETT ENTERPRISES LLC TILLMAN INFRASTRUCTURE TOWER OWNER 152 W 57TH STREET NEW YORK, NEW YORK 10019 STRUCTURE TYPE: SELF SUPPORT TOWER STRUCTURE HEIGHT 195'-0" (AGL) POWER SUPPLIER WE ENERGIES PHONE NUMBER: 800-714-7777 FIBER SUPPLIER: PHONE NUMBER: TBD

# **PROJECT TEAM**

APPLICANT: TILLMAN INFRASTRUCTURE

152 W. 57TH STREET NEW YORK, NEW YORK 10019

MANAGEMENT FIRM

LCC TELECOM SERVICES

10700 HIGGINS ROAD, SUITE 240 ROSEMONT, IL 60018

ARCHITECT ENGINEERING

604 FOX GLEN BARRINGTON, IL 60010

CONTACT: JOHN M. BANKS PHONE: (847) 277-0070 EMAIL: JBANKS@WESTCHESTERSERVICES.COM

# Lake Koshkonong Cold Spring Palmyra SITE Lauderd Lakes

# **DRIVING DIRECTIONS**



# **CODE COMPLIANCE**

ALL WORK AND MATERIALS SHALL BE PERFORMED AND INSTALLED IN ACCORDANCE WITH THE CURRENT EDITIONS OF THE FOLLOWING CODES AS ADOPTED BY THE LOCAL GOVERNING AUTHORITIES. NOTHING IN THESE PLANS IS TO BE CONSTRUED TO PERMIT WORK NOT CONFORMING TO THE LATEST EDITIONS OF THE FOLLOWING CODES.

- 2023 WISCONSIN STATE BUILDING CODE 2023 WISCONSIN STATE ELECTRICAL CODE
- 2023 WISCONSIN STATE MECHANICAL CODE 2023 WISCONSIN STATE PLUMBING CODE
- 2023 WISCONSIN STATE FIRE CODE
- AMERICAN CONCRETE INSTITUTE
- AMERICAN INSTITUTE OF STEEL CONSTRUCTION
- MANUAL OF STEEL CONSTRUCTION 13TH EDITION

- INSTITUTE FOR ELECTRICAL & ELECTRONICS ENGINEERING 81
- IEEE C2 NATIONAL ELECTRIC SAFETY CODE
- TELECORDIA GR-1275
- LATEST EDITION

# DRAWING INDEX

CONSTRUCTION APPROVAL

DATE:

DATE:

DATE:

TILLMAN SITE ACQUISITION MANAGERS

TILLMAN CONSTRUCTION MANAGER:\_

RF PROJECT MANAGER:

PROJECT MANAGER:

TITLE SHEET

SITE SURVEY

C-1 OVERALL SITE PLAN

C-2 ENLARGED SITE PLAN

ELEVATION C-3

C-4 CONSTRUCTION DETAILS

FENCE DETAILS C-5

C-5.1 FENCE DETAILS

C-6 SITE SIGNAGE

C-7 GRADING PLAN

**EROSION CONTROL DETAILS** C-8

F-1 LITILITY PLAN

ENLARGED UTILITY PLAN E-2

ELECTRICAL DIAGRAM E-3

GROUNDING PLAN & DETAILS GROUNDING PLAN AND RISER DIAGRAM

# DRAWING SCALE

THESE DRAWINGS ARE SCALED TO FULL SIZE AT 22"X34" AND HALF SIZE AT 11"X17 CONTRACTOR SHALL VERIFY ALL PLANS AND EXISTING DIMENSIONS AND CONDITIONS ON THE JOB SITE AND SHALL IMMEDIATELY NOTIFY THE DESIGNER / ENGINEER IN WRITING OF ANY DISCREPANCIES REFORE PROCEEDING WITH THE WORK OR MATERIAL ORDERS OR BE RESPONSIBLE FOR THE SAME. CONTRACTOR SHALL USE BEST MANAGEMENT PRACTICE TO PREVENT STORM WATER POLLUTION DURING CONSTRUCTION

# SCOPE OF WORK

# THIS PROJECT CONSISTS OF

- CONSTRUCTION OF A NEW UNMANNED TELECOMMUNICATIONS FACILITY
- SITE WORK: NEW TOWER, UNMANNED EQUIPMENT CABINET ON PLATFORM, AND UTILITY



TO OBTAIN LOCATION OF PARTICIPANTS UNDERGROUND FACILITIES BEFORE YOU DIG IN WISCONSIN, CALL LOCAL STATE ONE CALL

TOLL FREE: 1-800-242-8511 OR www.diggershotline.com

WORKING DAYS NOTICE Call before you dig. BEFORE YOU EXCAVATE







604 FOX GLEN BARRINGTON, IL 60010 PHONE: 847-277-0070 EMAIL: AE@Westchesterservices.com

# JOHN M. BANKS ARCHITECT 604 FOX GLEN BARRINGTON, IL 60010

TELEPHONE: 847-277-0070
FAX: 847-277-0080
EMAIL: JBANKS@WESTCHESTERSERVICES.COM

,	CHECKED BY:					
lí	REV	DATE	DESCRIPTION			
	A	03/04/24	PRELIMINARY CD			
	В	03/06/24	PRELIMINARY CD			

THEREBY CERTIFY THAT THESE PLANS WERE PREPARED BY ME OR UNDER MY DIRECT SUPERMISION AND THAT I AM A DULY REGISTERED ARCHITECT UNDER THE LAWS OF THE STATE OF WISCONSID

TILLMAN OPP# TI-OPP-29018 SITE NAME: WHITEWATER SITE ADDRESS: 1002 S JANESVILLE STREET WHITEWATER, WI 53190 FA#: 11655718 FAA STUDY #: 2024-AGL-23880E

SHEET TITLE

TITLE SHEET

SHEET NUMBER

# TITLE PROPERTY LEASE AREA VICINITY MAP NOT TO SCALE

# THE SOURCE OF BEARINGS WERE DETERMINED BY GPS OBSERVATIONS COMPLETED ON OCTOBER 31, 2023 0 75 150 300 1"=150' GRAPHIC SCALE

# GLOBAL POSITIONING SYSTEMS NOTE

- RANDOM TRAVERSE CONTROL MONUMENTS WERE SET USING GPS METHODS. A PORTION OF THE TOPOGRAPHY AND FOUND BOUNDARY MONUMENTS WERE ALSO LOCATED USING GPS METHODS.
- 2. THE TYPE OF GPS UTILIZES AS NETWORK ADJUSTED REAL TIME KINEMATIC (TOPCON VRS NETWORK), WISCONSIN COUNTY SYSTEMS: WALWORTH COUNTY, US FOOT.
- 3. TOPCON HIPER SR RECEIVERS WERE USED TO PERFORM THE SURVEY.

# GENERAL NOTES

- NO SEARCH OF PUBLIC RECORDS HAS BEEN COMPLETED BY XCEL CONSULTANTS TO DETERMINE ANY DEFECTS AND/OR AMBIGUITIES IN THE TITLE OF THE PARENT PARCEL.
- THIS SURVEY IS FOR THE PROPOSED LEASE AREA AND THE PROPOSED EASEMENTS ONLY, AND ONLY A PARTIAL BOUNDARY SURVEY OF THE PARENT PARCEL HAS BEEN PERFORMED.
- THIS PLAT IS NOT INTENDED FOR LAND TRANSFER.
- THIS PROPERTY IS SUBJECT TO ANY RECORDED EASEMENTS AND/OR RIGHTS OF WAY SHOWN HEREON OR NOT.
- THIS SURVEY WAS COMPLETED WITH THE AID OF TITLE WORK PREPARED BY WESTCOR LAND TITLE INSURANCE COMPANY, COMMITMENT DATE OF AUGUST 10, 2023, BEING FILE/COMMITMENT NO. TIL-159404-C, FOR THE SUBJECT PROPERTY, TO DETERMINE THE IMPACTS OF EXISTING TITLE EXCEPTIONS.

US HIGHWAY 12 VARIABLE WIDTH PUBLIC RIGHT OF WAY

# **\*** FAA COORDINATE POINT


NAD 83 LATITUDE: 42'49'08.8617" (42.81912825) LONGITUDE: -88'45'13.7991" (-88.75383307) NAVD88


ELEVATIONS: 850.37'± AMSL

# TEMPORARY BENCHMARK

LATITUDE: 42'49'07.8707" (42.81885298) LONGITUDE: -88'45'09.8384" (-88.75273289) ELEVATION: 845.76' LOCATION: SET IRON ROD

### **LEGEND**

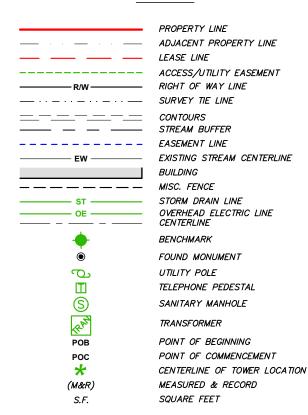

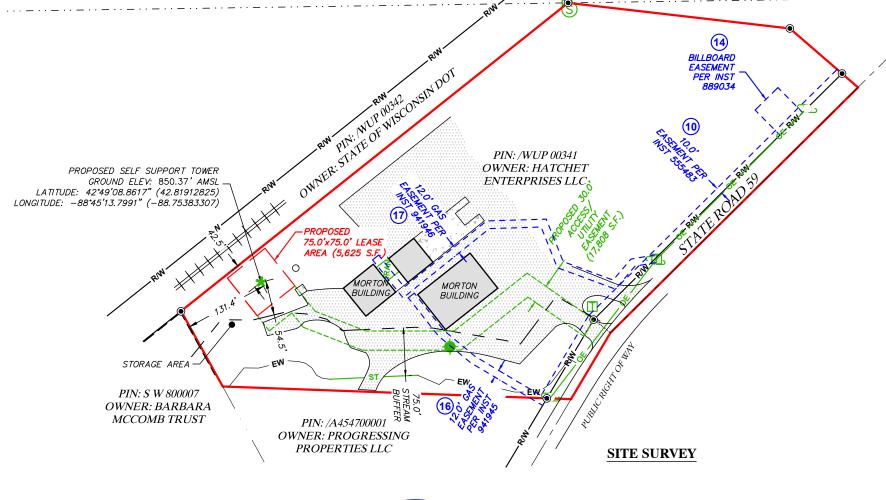

DAN J.
KUEHL

MORRISON
IL

NO SURVE

I, DAN J. KUEHL, A WISCONSIN PROFESSIONAL LAND SURVEYOR, CERTIFY THAT THE INFORMATION SHOWN HEREON WAS COMPILED USING DATA FROM AN ACTUAL FIELD SURVEY MADE UNDER MY DIRECT SUPERVISION AND THAT THE FIELD SURVEY AND THE COMPILATION OF INFORMATION SHOWN HEREIN WERE CONDUCTED IN ACCORDANCE WITH THE WISCONSIN MINIMUM STANDARDS OF PRACTICE.

DAN J. KUEHL

LICENSE NUMBER 3104-8
MY LICENSE RENEWAL DATE IS JANAURY 31, 2026
SHEETS COVERED BY THIS SEAL B-1, B-1.1, B-1.2, AND B-1.3

WESTCHESTER
SERVICES LLC
604 FOX GLEN
BARRINGTON, IL 60010
TELEPHONE: 847-277.0070
FAX: 847-277.0080

ae@westchesterservices.com

PREPARED FOR:



SURVEYED BY:

Consultants
120 10TH AVENUE EAST, SUITE 3
MILAN, II. 61264
(0) 309-787-9988
(F) 309-756-5540
(E) XCELEWCELCONSULTANTSINC.COM

XCEL PROJECT NUMBER: 234903

### SITE SURVEY

REV.	DATE	DESCRIPTION

# SITE INFORMATION: WHITEWATER

1002 S JANESVILLE STREET WHITEWATER, WI 53190

WALWORTH COUNTY
TAX PARCEL NUMBER:
/WUP 00341

PROPERTY OWNER: HATCHETT ENTERPRISES LLC 1002 S JANESVILLE STREET WHITEWATER, WI 53190

> SITE NUMBER: TI-OPP-29018

DRAWN BY: KJM
CHECKED BY: BCH
SURVEY DATE: 10/31/2023
PLAT DATE: XX


SHEET TITLE:

# SITE SURVEY

THIS DOES NOT REPRESENT A BOUNDARY SURVEY OF THE PARENT PARCEL

SHEET NUMBER:

B-1

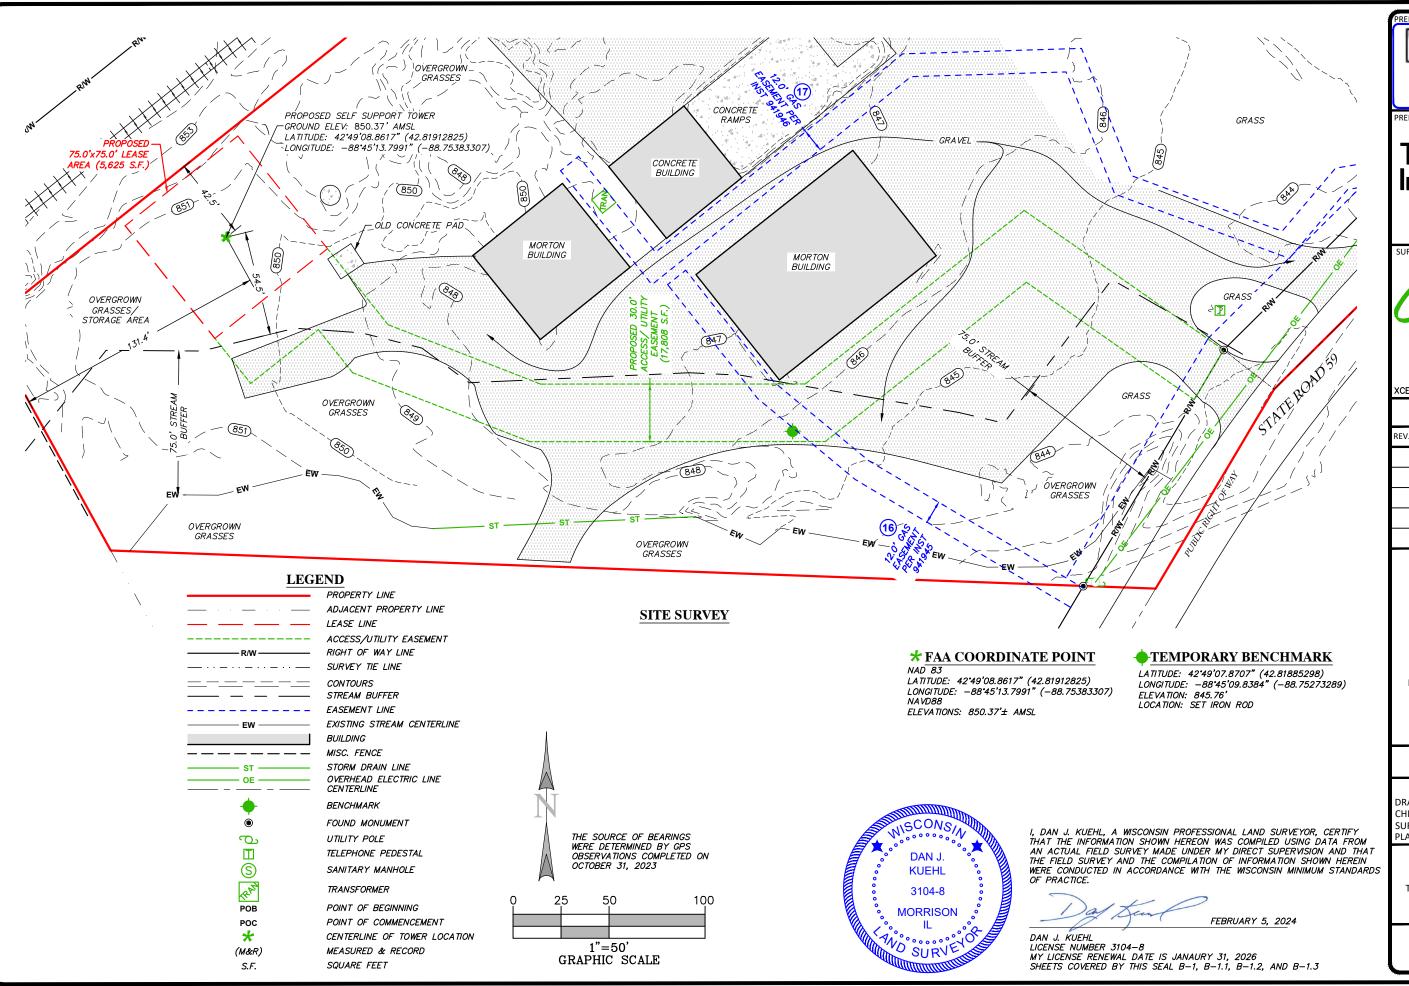

WESTCHESTER
SERVICES LLC
604 FOX GLEN
BARRINGTON, IL, 60010
TELEPHONE: 847.277.0070
FAX: 847.277.0080

PREPARED FOR:



ae@westchesterservices.com

XCEL

Consultants
120 10TH AVENUE EAST, SUITE 3
MILAN, IL 61264
(0) 309-787-9988
(F) 309-786-540
(E) XCELONCELCONSULTANTSINC.COM

XCEL PROJECT NUMBER: 234903

# SITE SURVEY

REV.	DATE	DESCRIPTION

# SITE INFORMATION: WHITEWATER

1002 S JANESVILLE STREET WHITEWATER, WI 53190 WALWORTH COUNTY

TAX PARCEL NUMBER: /WUP 00341

PROPERTY OWNER: HATCHETT ENTERPRISES LLC 1002 S JANESVILLE STREET WHITEWATER, WI 53190

> SITE NUMBER: TI-OPP-29018

DRAWN BY: KJM
CHECKED BY: BCH
SURVEY DATE: 10/31/2023
PLAT DATE: XX


SHEET TITLE:

# SITE SURVEY

THIS DOES NOT REPRESENT A
BOUNDARY SURVEY OF THE
PARENT PARCEL


SHEET NUMBER:

B-1.1

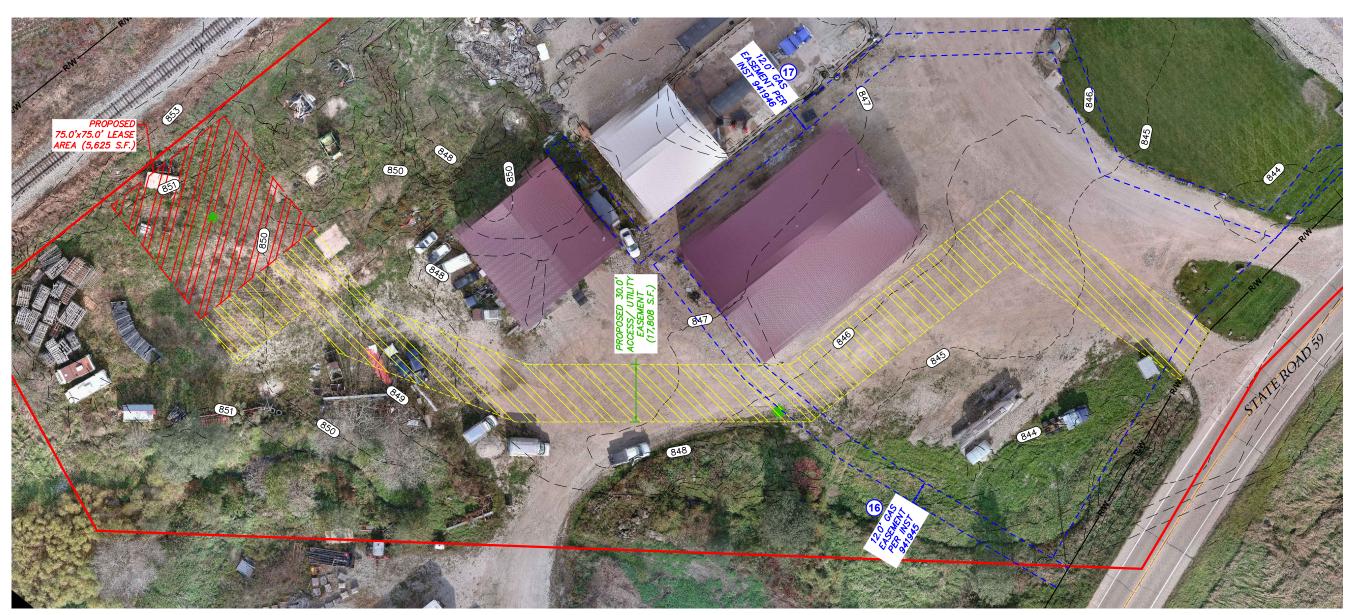


**AERIAL SURVEY** 

AERIAL PER XCEL FLOWN DRONE ON OCTOBER 31, 2023

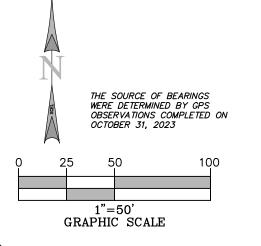

# LEGEND

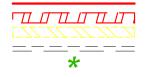

PROPERTY LINE
LEASE AREA
ACCESS/UTILITY EASEMENT
CONTOURS
CENTERLINE OF TOWER LOCATION



I, DAN J. KUEHL, A WISCONSIN PROFESSIONAL LAND SURVEYOR, CERTIFY THAT THE INFORMATION SHOWN HEREON WAS COMPILED USING DATA FROM AN ACTUAL FIELD SURVEY MADE UNDER MY DIRECT SUPERVISION AND THAT THE FIELD SURVEY AND THE COMPILATION OF INFORMATION SHOWN HEREIN WERE CONDUCTED IN ACCORDANCE WITH THE WISCONSIN MINIMUM STANDARDS OF PRACTICE.

FEBRUARY 5, 2024

DAN J. KUEHL LICENSE NUMBER 3104-8 MY LICENSE RENEWAL DATE IS JANAURY 31, 2026 SHEETS COVERED BY THIS SEAL B-1, B-1.1, B-1.2, AND B-1.3

# PREPARED FOR: WESTCHESTER SERVICES LLC 604 FOX GLEN BARRINGTON, II. 60010 TELEPHONE: 847.277.0070 FAX: 847.277.0080

FAX: 847.277.0080 ae@westchesterservices.com

PREPARED FOR:



SURVEYED BY:

XCEL

Consulta
120 10TH AVENUE EAS

CONSULTANTS
120 10TH AVENUE EAST, SUITE 3
MILAN, IL 61264
(0) 309-787-9988
(F) 309-786-5540
(E) XCEL®XCELCONSULTANTSINC.COM

XCEL PROJECT NUMBER: 234903

# SITE SURVEY

REV.	DATE	DESCRIPTION

# SITE INFORMATION: WHITEWATER

1002 S JANESVILLE STREET WHITEWATER, WI 53190 WALWORTH COUNTY

TAX PARCEL NUMBER: /WUP 00341

PROPERTY OWNER: HATCHETT ENTERPRISES LLC 1002 S JANESVILLE STREET WHITEWATER, WI 53190

> SITE NUMBER: TI-OPP-29018

DRAWN BY: KJM
CHECKED BY: BCH
SURVEY DATE: 10/31/2023
PLAT DATE: XX


SHEET TITLE:

# SITE SURVEY

THIS DOES NOT REPRESENT A BOUNDARY SURVEY OF THE PARENT PARCEL

SHEET NUMBER:

B-1.2

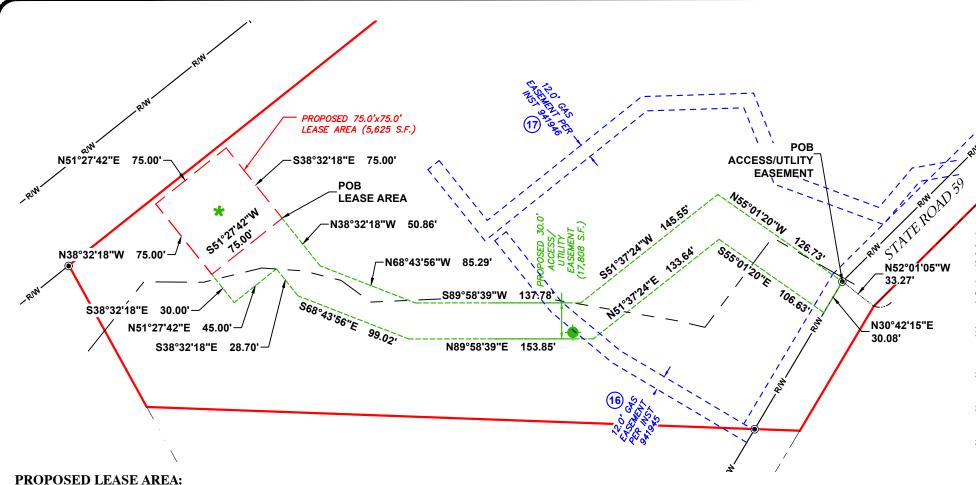

A PART OF THE N1/2 OF THE SW1/4 OF SECTION 8 TOWN 4 NORTH RANGE 15 FAST WITHIN THE CITY OF WHITEWATER, WALWORTH COUNTY, WISCONSIN, MORE PARTICULARLY DESCRIBED AS:
COMMENCING AT THE NW CORNER OF THE SAID SWI/4 OF SECTION 8; THENCE S89'09'35"W, ALONG THE NORTH LINE OF THE SAID SW1/4, 619.57 FEET TO THE CENTER LINE OF STATE ROAD 59; THENCE S45'15'35"W, ALONG THE SAID CENTER LINE, 744.62 FEET; THENCE N52'01'05"W, 33.27 FEET WEST LINE OF SAID STATE ROAD 59; THENCE N55'01'20"W, 126.73 FEET; THENCE S51"37"24"W, 145.55 FFFT: THENCE S89"58"39"W, 137.78 FFFT: THENCE N68"43"56"W, 85.29 FFFT: THENCE N38'32'18"W, 50.86 FEET TO THE POINT OF BEGINNING FOR THE LEASE AREA HEREIN INTENDED TO BE DESCRIBED; THENCE S51'27'42"W, 75.00 FEET; THENCE N38'32'18"W, 75.00 FEET; THENCE N51°27'42"E, 75.00 FEET; THENCE S38°32'18"E, 75.00 FEET TO THE POINT OF BEGINNING, CONTAINING 5.625 SQUARE FEET.

# PROPOSED ACCESS/UTILITY EASEMENT:

A PART OF THE N1/2 OF THE SW1/4 OF SECTION 8. TOWN 4 NORTH. RANGE 15 EAST. WITHIN THE CITY OF WHITEWATER, WALWORTH COUNTY, WISCONSIN, MORE PARTICULARLY DESCRIBED AS: COMMENCING AT THE NW CORNER OF THE SAID SWI/4 OF SECTION 8; THENCE S89'09'35"W, ALONG THE NORTH LINE OF THE SAID SWI /4. 619.57 FEET TO THE CENTER LINE OF STATE ROAD 59 THENCE S4575'35"W, ALONG THE SAID CENTER LINE, 744.62 FEET; THENCE N52'01'05"W, 33.27 FEET TO THE WEST LINE OF SAID STATE ROAD 59 AND BEING THE POINT OF BEGINNING FOR THE EASEMENT HEREIN INTENDED TO BE DESCRIBED; THENCE N55'01'20"W, 126.73 FEET; THENCE S51°37'24"W. 145.55 FFFT: THENCE S89°58'39"W. 137.78 FFFT: THENCE N68'43'56"W. 85.29 FFFT: THENCE N38'32'18"W, 50.86 FEET TO THE SE CORNER OF THE PROPOSED LEASE AREA; THENCE S51'27'42"W, ALONG THE SOUTHEASTERLY LINE OF PROPOSED LEASE AREA, 75.00 FEET; THENCE S38'32'18"E, 30.00 FEET; THENCE N51'27'42"E, 45.00 FEET; THENCE S38'32'18"E, 28.70 FEET; THENCE S68\*43'56"E. 99.02 FEET: THENCE N89'58'39"E. 153.85 FEET: THENCE N51\*37'24"E. 133.64 FEET; THENCE S55'01'20"E, 106.63 FEET TO THE SAID WEST LINE OF STATE ROAD 59; THENCE N30°42'15"E, ALONG THE SAID WEST LINE OF STATE ROAD 59, 30.08 FEET TO THE POINT OF BEGINNING, CONTAINING 17,808 SQUARE FEET.



I, DAN J. KUEHL, A WISCONSIN PROFESSIONAL LAND SURVEYOR, CERTIFY THAT THE INFORMATION SHOWN HEREON WAS COMPILED USING DATA FROM AN ACTUAL FIELD SURVEY MADE UNDER MY DIRECT SUPERVISION AND THAT THE FIELD SURVEY AND THE COMPILATION OF INFORMATION SHOWN HEREIN WERE CONDUCTED IN ACCORDANCE WITH THE WISCONSIN MINIMUM STANDARDS OF PRACTICE.

FEBRUARY 5, 2024 DAN J KUFHI

LICENSE NUMBER 3104-8 MY LICENSE RENEWAL DATE IS JANAURY 31, 2026 SHEETS COVERED BY THIS SEAL B-1, B-1.1, B-1.2, AND B-1.3

# THE FOLLOWING DESCRIBED REAL ESTATE, TOGETHER WITH THE RENTS, PROFITS, FIXTURES AND OTHER APPURTENANT INTERESTS, IN WALWORTH COUNTY, STATE OF WISCONSIN: PARCEL 1:

PARENT PARCEL, LEGAL DESCRIPTION (NOT FIELD SURVEYED) PER TITLE

A PARCEL OF LAND LOCATED IN THE SOUTHWEST 1/4 OF SECTION 8, TOWN 4 NORTH, RANGE 15 EAST OF THE CITY OF WHITEWATER, WALWORTH COUNTY, WISCONSIN, DESCRIBED AS FOLLOWS, TO-WIT:

COMMENCING AT THE MIDDLE 1/4 SECTION CORNER OF SAID SECTION 8; THENCE WEST ALONG THE EAST—WEST 1/4 SECTION LINE 619.72 FEET TO THE CENTER LINE OF STATE TRUNK HIGHWAY NO. 59, WHICH POINT IS THE
PLACE OF BEGINNING; THENCE SOUTH 43° 35' WEST ALONG THE CENTER LINE OF SAID HIGHWAY 743.72 FEET; THENCE SOUTH 28° 59' WEST ALONG THE CENTERLINE OF SAID HIGHWAY 664.31 FEET; THENCE NORTH 30° 29' WEST 690.20 FEET TO THE SOUTHERLY LINE OF THE C.M. ST. P. & P. RAIRROAD RIGHT OF WAY; THENCE NORTH 49° 41' EAST ALONG THE RAILROAD RIGHT OF WAY 774.72 FEET TO THE EAST—WEST 1/4 SECTION LINE OF SAID SECTION 8; THENCE EAST ALONG SAID LINE 594.31 FEET TO THE PLACE OF BEGINNING.

ALSO A TRIANGULAR—SHAPED PARCEL OF LAND LOCATED IN THE NORTHWEST 1/4 OF SECTION 8, TOWN 4 NORTH, RANGE 15 EAST OF THE CITY OF WHITEWATER, WALWORTH COUNTY, WISCONSIN, DESCRIBED AS FOLLOWS, TO-WIT:

COMMENCING AT THE MIDDLE 1/4 SECTION CORNER OF SAID SECTION 8; THENCE WEST ALONG THE EAST-WEST 1/4 SECTION LINE 1214.03 FEET TO THE SOUTHERLY LINE OF THE C. M. ST. P. & P. RAILROAD RIGHT OF WAY, WHICH POINT IS THE PLACE OF BEGINNING; THENCE EAST ALONG SAID EAST—WEST 1/4 SECTION LINE 291.155 FEET TO A POINT; THENCE NORTHWESTERLY TO A POINT ON THE SOUTHERLY LINE OF SAID RAILROAD RIGHT OF WAY, FROM THE PLACE OF BEGINNING HEREOF; THENCE SOUTH 49° 47' WEST ALONG THE SOUTHERLY LINE OF SAID RAILROAD RIGHT OF WAY 200 FEET TO THE PLACE OF BEGINNING.

EXCEPTING THEREFROM A TRIANGULAR—SHAPED PARCEL OF LAND LOCATED IN THE SOUTHWEST 1/4 OF SECTION 8, TOWN 4 NORTH, RANGE 15 EAST OF THE CITY OF WHITEWATER, WALWORTH COUNTY, WISCONSIN, DESCRIBED AS FOLLOWS, TO—WIT: COMMENCING AT THE MIDDLE 1/4 SECTION CORNER OF SAID SECTION 8; THENCE WEST ALONG THE EAST—WEST 1/4 SECTION LINE 619.72 FEET TO THE CENTER LINE OF STATE TRUNK HIGHWAY NO. 59, WHICH POINT IS THE PLACE OF BEGINNING; THENCE WEST ALONG SAID EAST—WEST 1/4 SECTION LINE 297.155 FEET TO A POINT; THENCE SOUTHEASTERLY TO A POINT ON THE CENTER LINE OF SAID STATE TRUNK HIGHWAY NO. 59 WHICH POINT IS 200 FEET SOUTHWESTERLY, AS MEASURED ALONG THE CENTER LINE OF SAID HIGHWAY, FROM THE PLACE OF BEGINNING HEREOF; THENCE NORTH 43° 35' EAST ALONG THE CENTER LINE OF SAID HIGHWAY 200 FEET TO THE PLACE OF BEGINNING.

FURTHER EXCEPTING LANDS CONVEYED TO THE STATE OF WISCONSIN BY DEED RECORDED AUGUST 28, 2001, AS DOCUMENT NO. 481415.

FURTHER EXCEPTING LANDS CONVEYED TO THE STATE OF WISCONSIN, DEPARTMENT OF TRANSPORTATION UNDER AN AWARD OF DAMAGES RECORDED JULY 6, 2009, AS DOCUMENT NO. 767729.

FURTHER EXCEPTING ALL THAT PORTION THEREOF AS IS SET FORTH IN CERTIFIED SURVEY MAP NO. 4547 RECORDED IN VOLUME 29 OF CERTIFIED SURVEYS ON PAGE 352 AS DOCUMENT NO. 890758, BEING A CERTIFIED SURVEY MAP OF PART OF THE NORTHWEST 1/4 OF THE SOUTHWEST 1/4 AND THE NORTHEAST 1/4 OF THE SOUTHWEST 1/4 OF SECTION 8, TOWN 4 NORTH, RANGE 15 EAST, CITY OF WHITEWATER,

WALWORTH COUNTY, WISCONSIN.

PARCEL ID: /WUP 00341

THIS BEING THE SAME PROPERTY CONVEYED TO HATCHETT ENTERPRISES, LLC, A WISCONSIN LIMITED LIABILITY COMPANY FROM PROGRESSING PROPERTIES, LLC, A WISCONSIN LIMITED LIABILITY COMPANY IN A DEED DATED MAY 2, 2022 AND RECORDED MAY 4, 2022 AS INSTRUMENT NO. 1061224, IN WALWORTH COUNTY, WI.

# **REPORT OF TITLE:**

THIS SURVEY DOES NOT CONSTITUTE A TITLE SEARCH BY XCEL CONSULTANTS, INC. AND AS SUCH WE ARE NOT RESPONSIBLE FOR THE INVESTIGATION OR INDEPENDENT SEARCH FOR EASEMENT OF RECORD, ENCLUMBRANCES, RESTRICTIVE COVENANTS, OWNERSHIP TITLE EVIDENCE, UNRECORDED EASEMENT, AUGMENTING EASEMENT, IMPLIES OR PRESCRIPTIVE EASEMENTS, OR ANY OTHER FACTS THAT AN ACCURATE AND CURRENT

S89°09'35"W 619.57'

POC

**NE COR OF SW1/4** 

SEC.8-4-15

THIS SURVEY WAS COMPLETED WITH THE AID OF TITLE WORK PREPARED BY WESTCOR LAND TITLE INSURANCE COMPANY, COMMITMENT DATE OF AUGUST 10, 2023, BEING FILE/COMMITMENT NO. TIL-159404-C, FOR THE SUBJECT PROPERTY, TO DETERMINE THE IMPACTS OF EXISTING TITLE EXCEPTIONS.

- SURVEY MATTERS OR EASEMENTS LISTED IN SCHEDULE 'B':
  10. EASEMENT BETWEEN NATIONAL DISTILLERS AND CHEMICAL CORP.; AND WISCONSIN ELECTRIC POWER
  COMPANY AND WISCONSIN TELEPHONE COMPANY, DATED NOVEMBER 14, 1963 AND RECORDED DECEMBER 1, 1963 IN (BOOK) 599 (PAGE) 643 (INSTRUMENT) 555483, IN WALWORTH COUNTY, WISCONSIN. <u>LIES ON</u>
- 11. PUBLIC SANITARY SEWER MAIN AND WATER MAIN EASEMENT BETWEEN S.M. HOLDINGS, LLP; AND HOFFMANN LANDS, LTD., DATED JUNE 4, 2003 AND RECORDED JULY 11, 2003 IN (PAGE) 1279 (INSTRUMENT) 0565278, IN WALWORTH COUNTY, WISCONSIN. <u>DOES NOT LIE ON SUBJECT PROPERTY</u>
- 12. ANY AND ALL MATTERS DISCLOSED ON THE MAP ENTITLED "TRANSPORTATION PROJECT PLAT NO: 3140-02-20-4.03"DATED FEBRUARY 26, 2009 AND RECORDED MARCH 5, 2009 IN (BOOK) D (PAGE) 150, (INSTRUMENT) 756802 IN WALWORTH COUNTY, WISCONSIN. NOTHING TO PLOT
- 13. NOTICE OF LIS PENDENS BETWEEN STATE OF WISCONSIN, COUNTY OF WALWORTH AND MOUNTAIN WEST OF WISCONSIN, LLC, A MONTANA LIMITED LIABILITY COMPANY, DATED JUNE 9, 2009 AND RECORDED JUNE 11, 2009 IN (INSTRUMENT) 765659, IN WALWORTH COUNTY, WISCONSIN. AFFECTED BY A(N) AWARD OF DAMAGES BETWEEN STATE OF WISCONSIN, DEPARTMENT OF TRANSPORTATION AND MOUNTAIN WEST OF WISCONSIN, LLC, A MONTANA LIMITED LIABILITY COMPANY; MOUNTAIN WEST BANK, N.A., DATED JULY 2, 2009 AND RECORDED JULY 6, 2009 IN (INSTRUMENT) 767729, IN WALWORTH COUNTY, WISCONSIN.
- 14. GRANT OF EASEMENT BETWEEN MOUNTAIN WEST BANK, NA; AND TLC PROPERTIES, INC., A LOUISIANA CORPORATION, DATED JULY 21, 2014 AND RECORDED JULY 31, 2014 IN (INSTRUMENT) 889034, IN WALWORTH COUNTY, WISCONSIN. LIES ON PROPERTY AS SHOWN
- 15. ANY AND ALL MATTERS DISCLOSED ON THE MAP ENTITLED "CERTIFIED SURVEY MAP NO. 4547" DATED JULY 14, 2014 AND RECORDED SEPTEMBER 3, 2014 IN (BOOK) 29 (PAGE) 352, (INSTRUMENT) 890758 IN WALWORTH COUNTY, WISCONSIN. <u>NOT ON SUBJECT PROPERTY — NOTHING TO PLOT</u>
- 16 DISTRIBUTION FASEMENT GAS RETWEEN PROCRESSING PROPERTIES LLC: AND WISCONSIN FLECTRIC POWER COMPANY, A WISCONSIN CORPORATION DOING BUSINESS AS WE ENERGIES, DATED OCTOBER 7, 2016 AND RECORDED FEBRUARY 23, 2017 IN (INSTRUMENT) 941945, IN WALWORTH COUNTY, WISCONSIN. <u>LIES ON</u> PROPERTY - CROSSES PROPSED ACCESS/UTILITY EASEMENT- AS SHOWN
- 17. DISTRIBUTION EASEMENT UNDERGROUND BETWEEN PROGRESSING PROPERTIES. LLC: AND WISCONSIN ELECTRIC POWER COMPANY, A WISCONSIN CORPORATION DOING BUSINESS AS WE ENERGIES, DATED OCTOBER 7, 2016 AND RECORDED FEBRUARY 23, 2017 IN (INSTRUMENT) 941946, IN WALWORTH COUNTY, WISCONSIN. LIES ON PROPERTY - AS SHOWN

# WESTCHESTER 604 FOX GLEN BARRINGTON II. 60010 TELEPHONE: 847.277.0070 FAX: 847.277.0080

PREPARED FOR:



ae@westchesterservices.com

SURVEYED BY XCE Consultants

120 10TH AVENUE EAST, SUITE 3 MILAN, IL 61264 (O) 309-787-9988 (F) 309-756-5540 XCFI @XCFI CONSULTANTSING COM

XCEL PROJECT NUMBER: 234903

# SITE SURVEY

	REV.	DATE	DESCRIPTION
1,			

# SITE INFORMATION: WHITEWATER

1002 S JANESVILLE STREET WHITEWATER, WI 53190 WALWORTH COUNTY

TAX PARCEL NUMBER: /WUP 00341

PROPERTY OWNER: HATCHETT ENTERPRISES LLC 1002 S JANESVILLE STREET WHITEWATER, WI 53190

> SITE NUMBER: TI-OPP-29018

DRAWN BY: CHECKED BY: SURVEY DATE: 10/31/2023 PLAT DATE: XX


SHEET TITLE:


# SITE SURVEY


THIS DOES NOT REPRESENT A **BOUNDARY SURVEY OF THE** PARENT PARCEL

SHEET NUMBER:

B-1.3

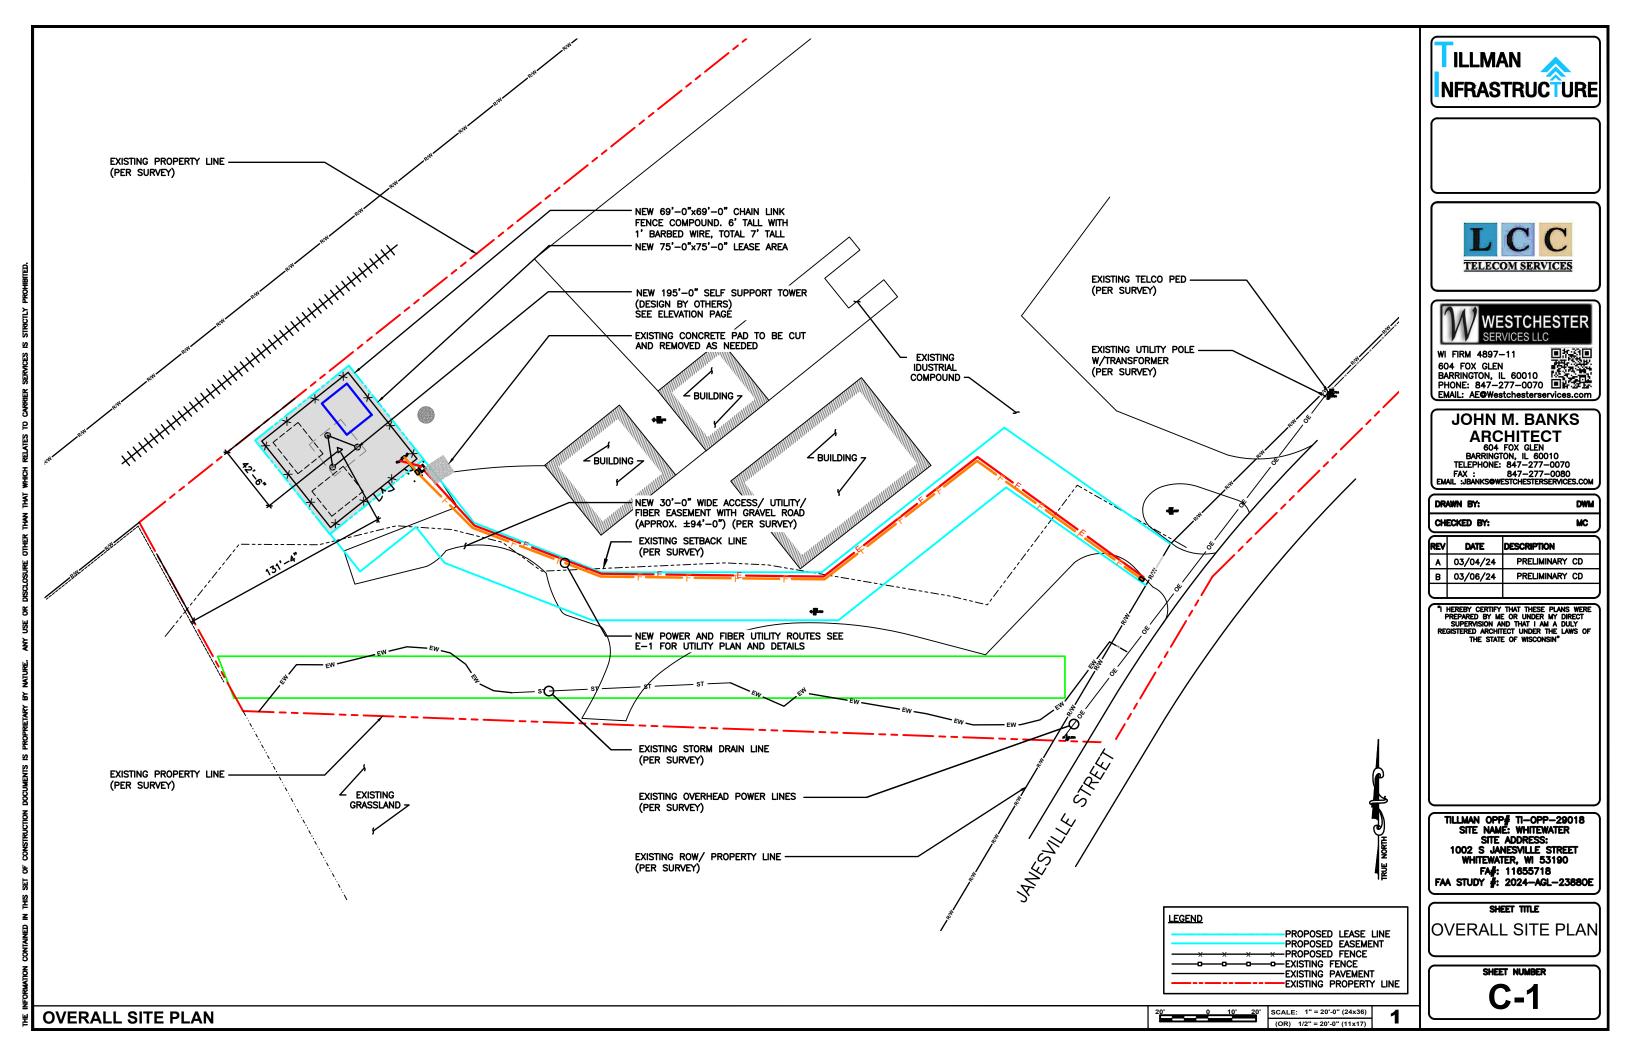

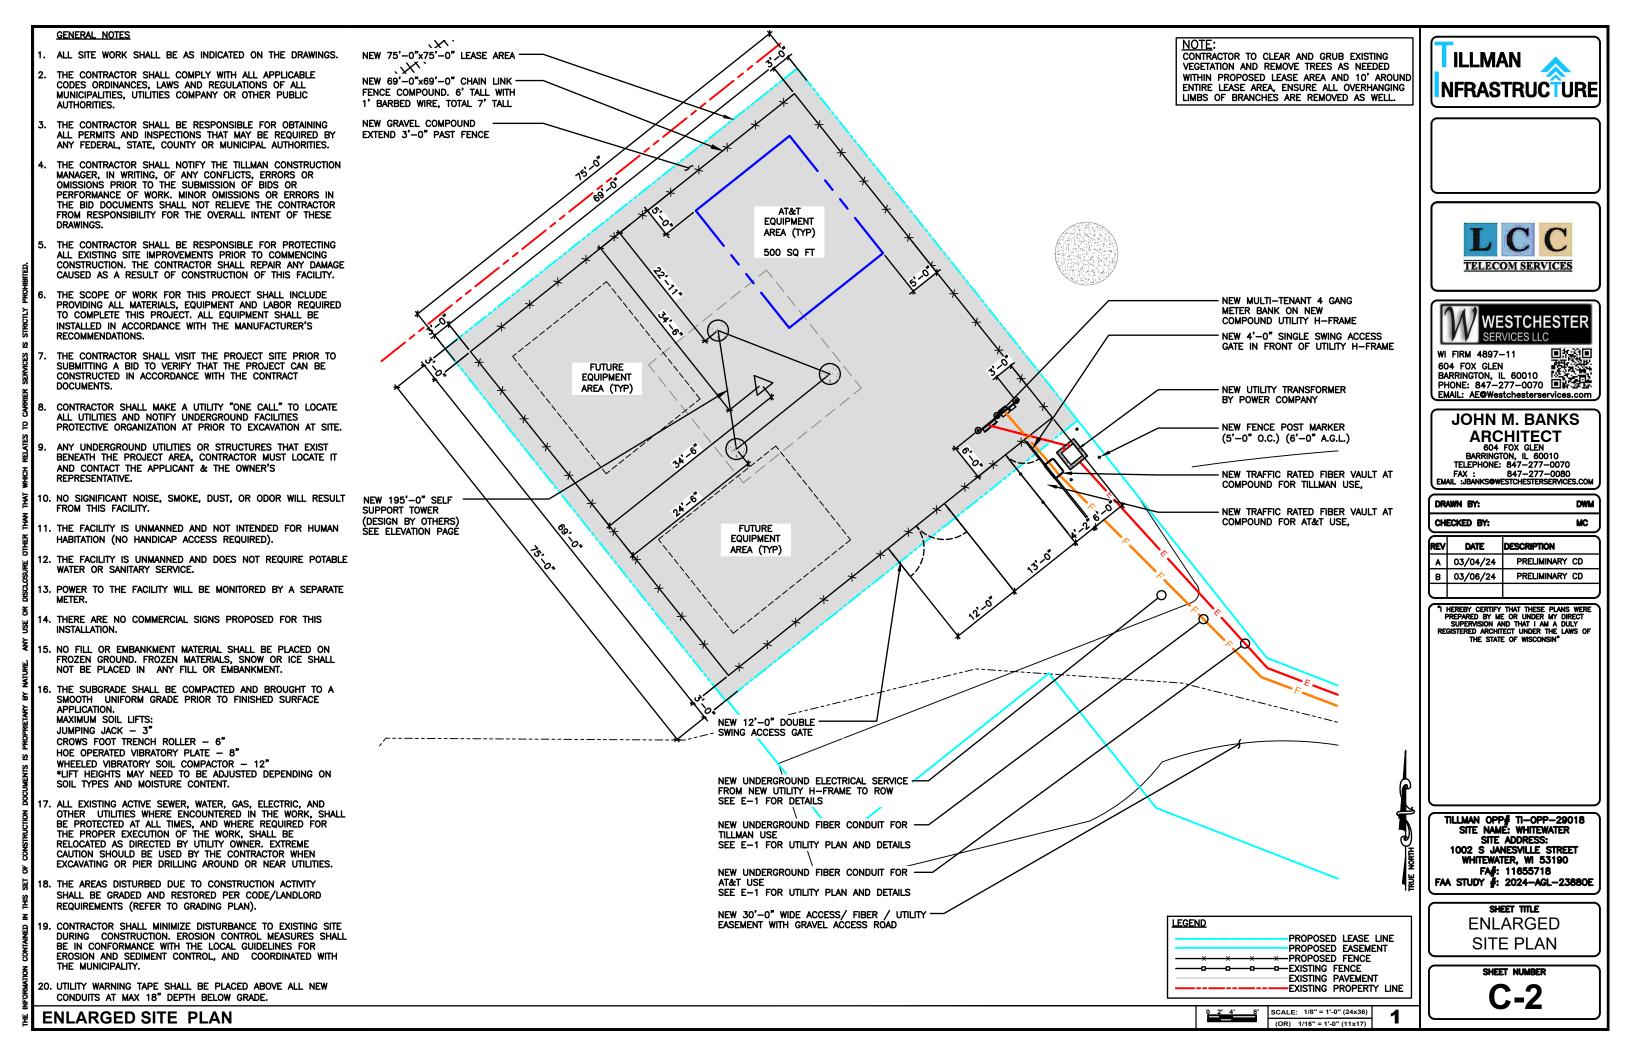

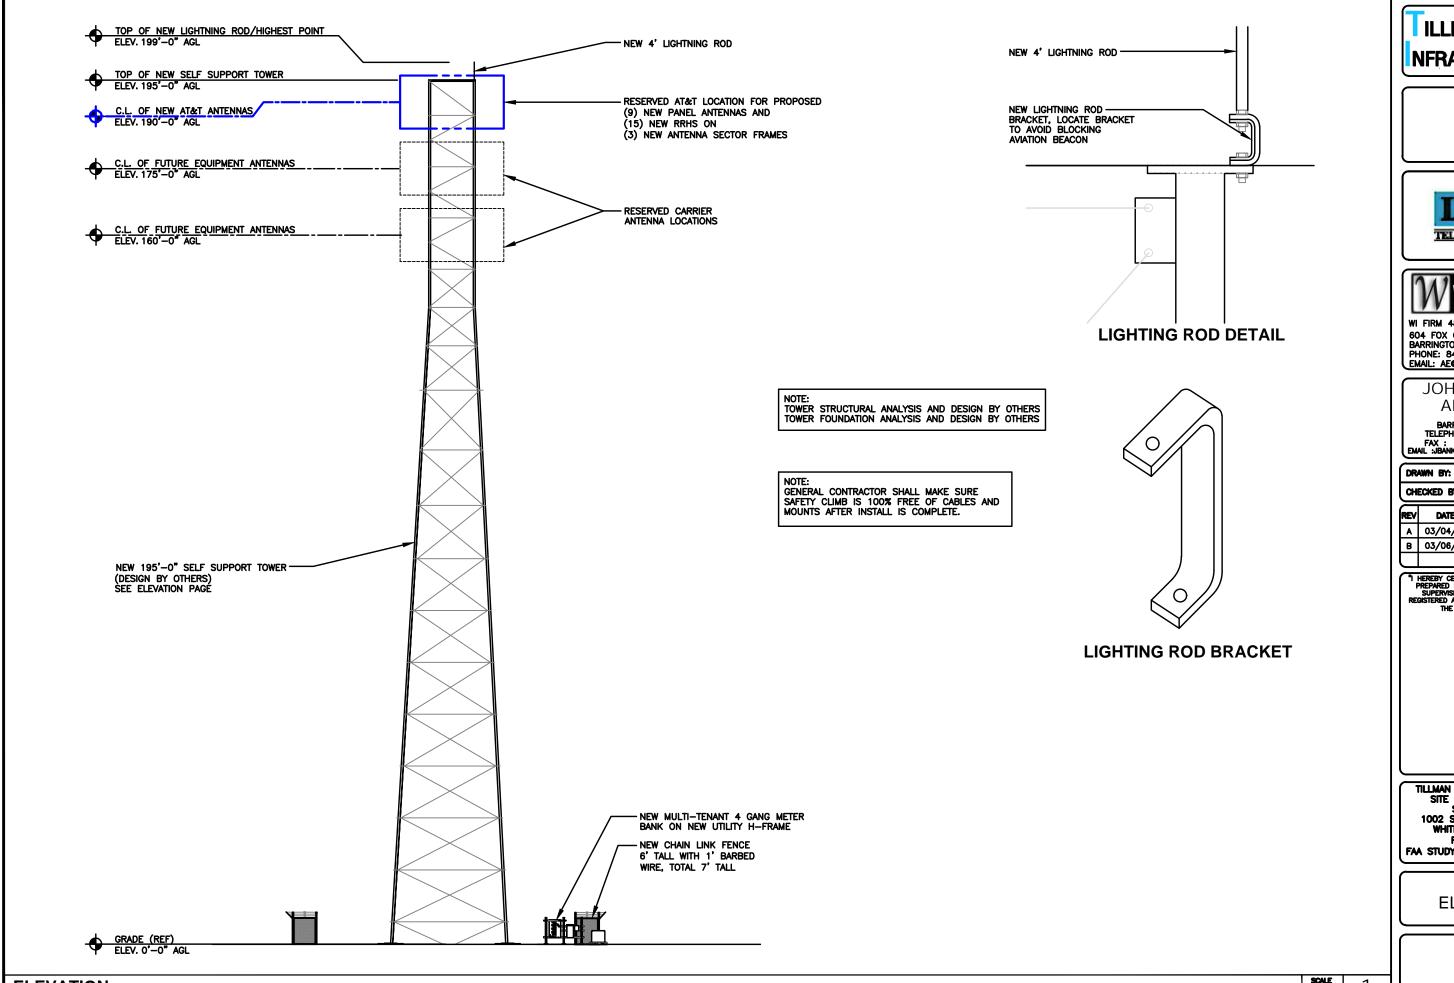

**ELEVATION** 

TILLMAN NFRASTRUCTURE





604 FOX GLEN
BARRINGTON, IL 60010
PHONE: 847-277-0070
EMAIL: AE©Westchesterservices.com

JOHN M. BANKS ARCHITECT

ARCHITECT
604 FOX GLEN
BARRINGTON, IL 60010
TELEPHONE: 847-277-0070
FAX: 847-277-0080
EMAIL: JBANKSØWESTCHESTERSERVICES.COM

DWM

"I HEREBY CERTIFY THAT THESE PLANS WERE PREPARED BY ME OR UNDER MY DIRECT SUPERVISION AND THAT I AM A DULY REGISTERED ARCHITECT UNDER THE LAWS OF THE STATE OF WISCONSIN"

TILLMAN OPP# TI-OPP-29018
SITE NAME: WHITEWATER
SITE ADDRESS:
1002 S JANESVILLE STREET
WHITEWATER, WI 53190
FA#: 11655718
FAA STUDY #: 2024-AGL-23880E


SHEET TITLE


**ELEVATION** 

SHEET NUMBER

N.T.S.

**C-3** 

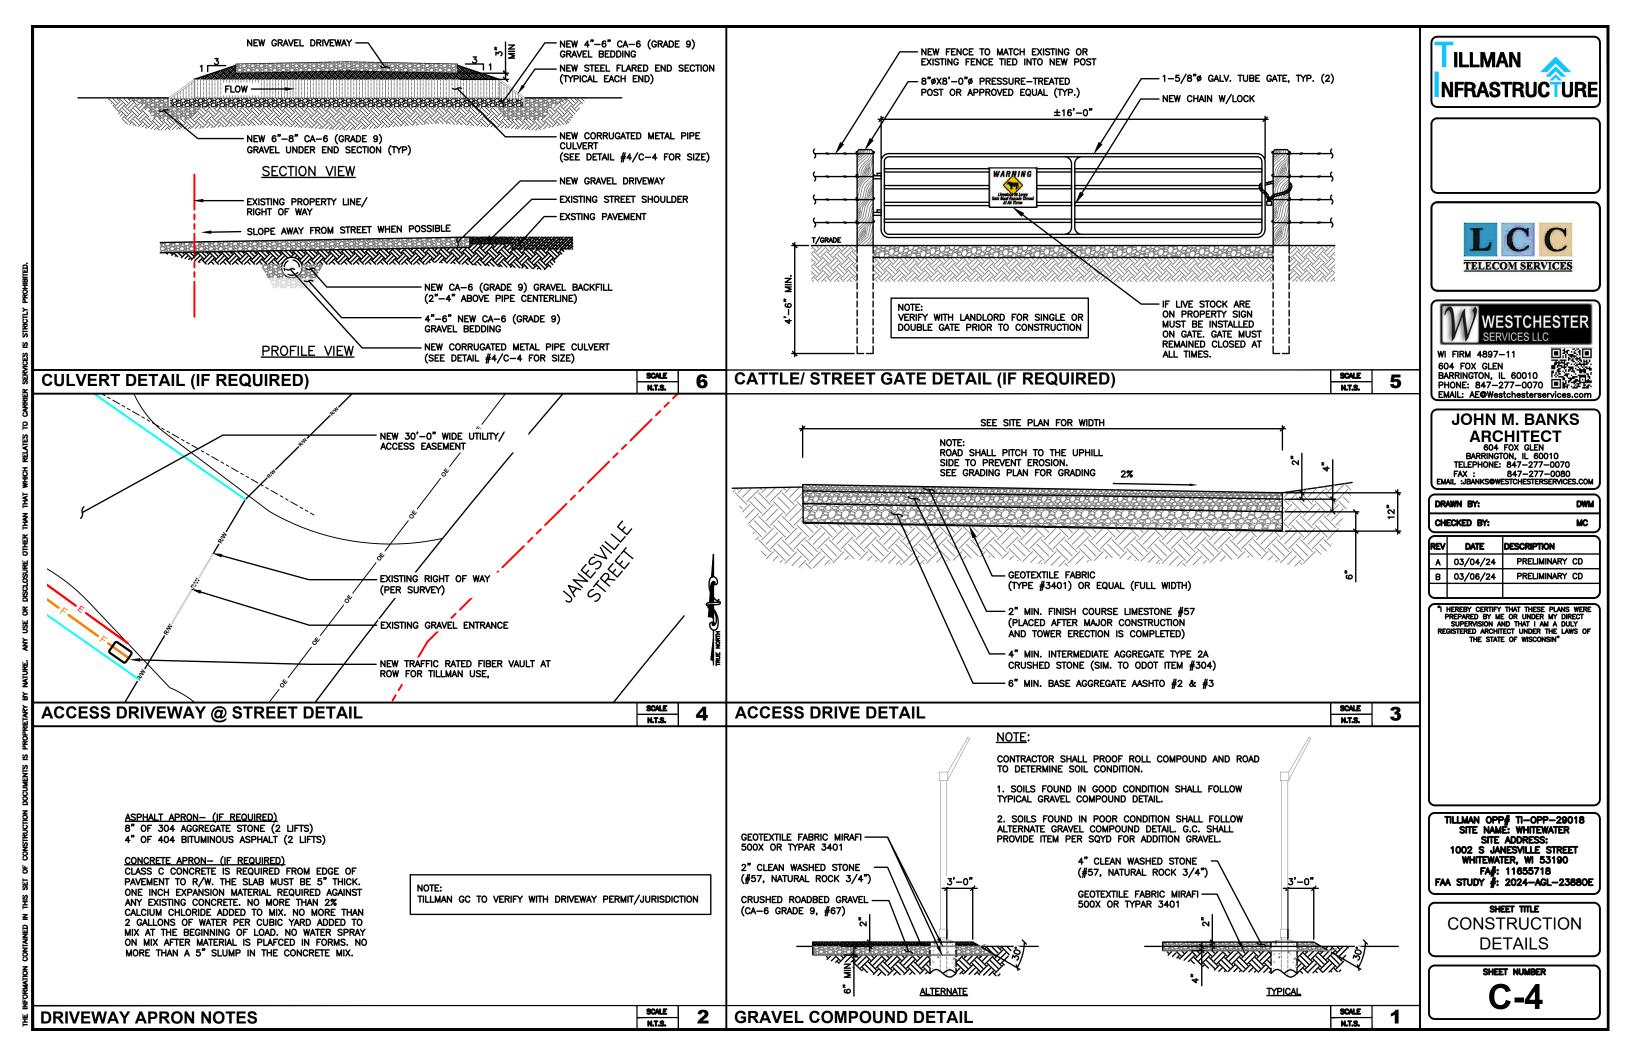

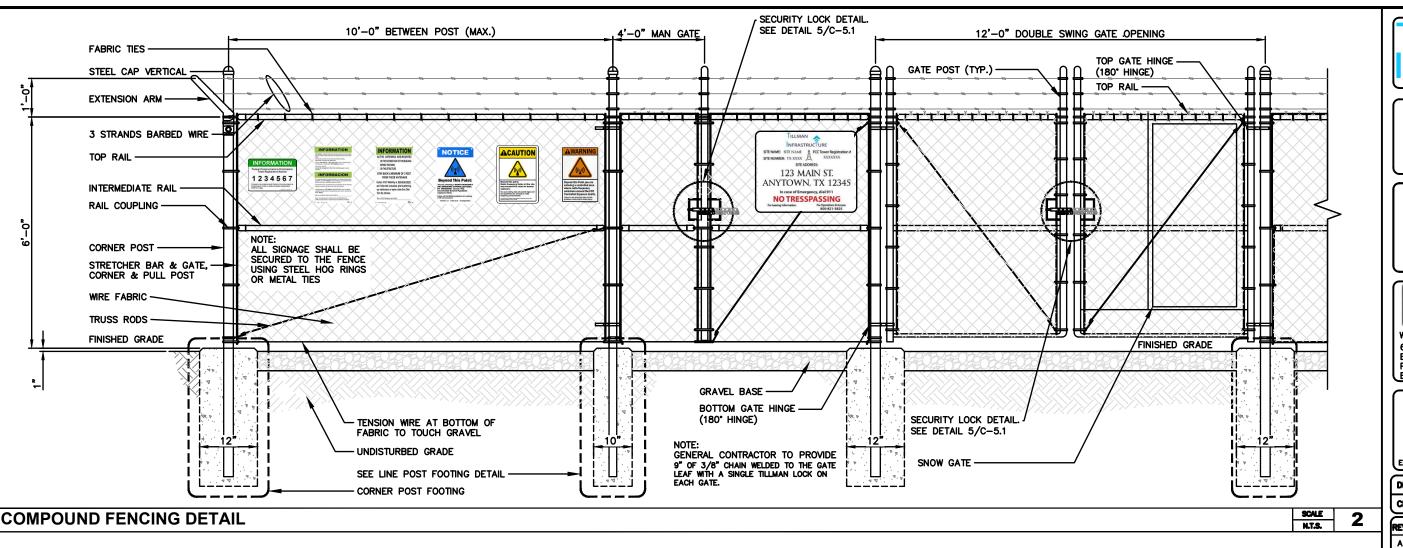

ILLMAN NFRASTRUCTURE





604 FOX GLEN
BARRINGTON, IL 60010
PHONE: 847-277-0070
EMAIL: AE©Westchesterservices.com

# **JOHN M. BANKS**

ARCHITECT

804 FOX GLEN
BARRINGTON, IL 60010
TELEPHONE: 847-277-0070
FAX: 847-277-0080
EMAIL: JBANKSØWESTCHESTERSERVICES.COM

DWM

CHECKED BY: MC REV DESCRIPTION DATE A 03/04/24 PRELIMINARY CD PRELIMINARY CD

03/06/24

TILLMAN OPP# TI-OPP-29018
SITE NAME: WHITEWATER
SITE ADDRESS:
1002 S JANESVILLE STREET
WHITEWATER, WI 53190
FA#: 11655718
FAA STUDY #: 2024-AGL-23880E

SHEET TITLE **FENCE DETAILS** 

SHEET NUMBER

"I HEREBY CERTIFY THAT THESE PLANS WERE PREPARED BY ME OR UNDER MY DIRECT SUPERVISION AND THAT I AM A DULY REGISTERED ARCHITECT UNDER THE LAWS OF THE STATE OF WISCONSIN"

**NOT USED** 


# WOVEN WIRE FENCE NOTES:


(INSTALL FENCING PER ASTM F-567) (SWING GATES PER ASTM F-900)

- GATE POSTS, CORNER, TERMINAL OR PULL POSTS SHALL BE 2 7/8" DIA. SCHEDULE 40 FOR GATE WIDTHS UP THROUGH 6 FEET OR 12 FEET FOR DOUBLE SWING GATE PER ASTM-F1083.
- 2. LINE POSTS: 2 3/8" DIA. SCHEDULE 40 PIPE PER ASTM-F1083
- 3. GATE FRAME: 1 1/2" DIA. SCHEDULE 40 PIPE PER ASTM-F1083
- 4. TOP RAIL AND BRACE RAIL: 1 1/4" SCHEDULE 40 PIPE PER ASTM-F1083
- 5. FABRIC: 9 GA. CORE WIRE SIZE 2" MESH, CONFORMING TO ASTM-A392 CLASS 1
- TIE WIRE: MINIMUM 11 GA. GALVANIZED STEEL. INSTALL A SINGLE WRAP TIE WIRE AT POSTS AND RAILS AT MAX. 24" INTERVALS. INSTALL HOG RINGS ON TENSION WIRE AT 24" **INTERVALS**
- 7. TENSION WIRE: 7 GA. GALVANIZED STEEL
- 8. BARBED WIRE: 3 STRANDS OF DOUBLE STRAND 12-1/2 GAUGE TWISTED WIRE, 4 POINT BARBS SPACED ON APPROXIMATELY 5" CENTERS
- 9. LOCAL ORDINANCE FORR BARB WIRE PERMIT SHALL **GOVERN INSTALLATION**
- HEIGHT = 6' VERTICAL + 1' BARBED WIRE VERTICAL **DIMENSION**
- 11. ALL WORK SHALL CONFORM WITH THE PROJECT **SPECIFICATIONS**


GENERAL CONTRACTOR TO PROVIDE (2) NEW LOCKS FOR MAIN GATE AND MAN GATE. COORDINATE COMBINATION WITH TILLMAN CONSTRUCTION MANAGER.


TILLMAN STANDARD REQUIRES 9" OF 3/8" CHAIN WELDED TO GATE LEAF WITH A SINGLE TILLMAN LOCK

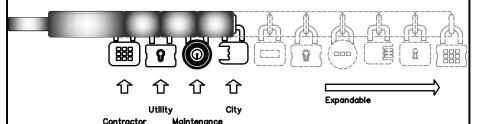

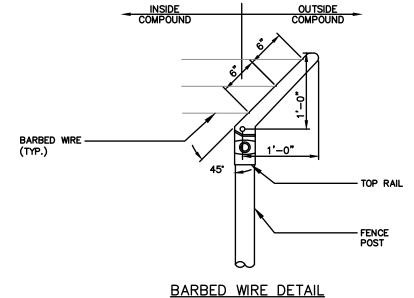

SCALE SCALE STYMIE LOCKING SYSTEM DETAIL 5 4 ANTI-CLIMB BARBED WIRE DETAIL N.T.S.

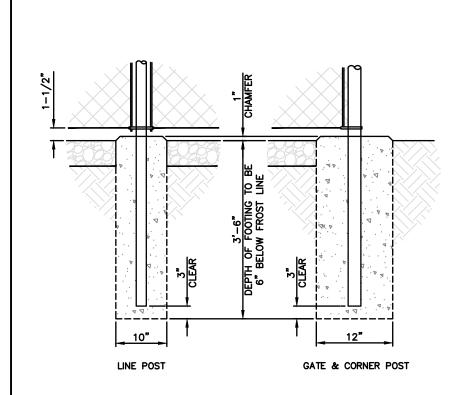

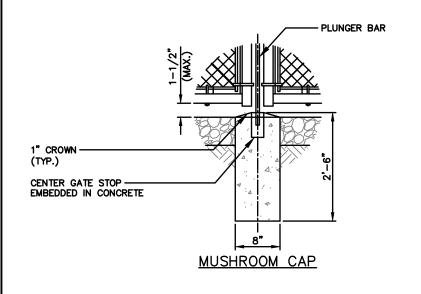







# JOHN M. BANKS

ARCHITECT
604 FOX GLEN
BARRINGTON, IL 60010
TELEPHONE: 847-277-0070
FAX: 847-277-0080
EMAIL: JBANKSOWESTCHESTERSERVICES.COM

_	١,	CHECKED BY:				
		REV	DATE	DESCRIPTION		
		4	03/04/24	PRELIMINARY CD		
		В	03/06/24	PRELIMINARY CD		

"I HEREBY CERTIFY THAT THESE PLANS WERE PREPARED BY ME OR UNDER MY DIRECT SUPERVISION AND THAT I AM A DULY REGISTERED ARCHITECT UNDER THE LAWS OF

TILLMAN OPP# TI-OPP-29018
SITE NAME: WHITEWATER
SITE ADDRESS:
1002 S JANESVILLE STREET
WHITEWATER, WI 53190
FA#: 11655718
FAA STUDY #: 2024-AGL-23880E

SHEET TITLE **FENCE DETAILS** 

C-5.1

FENCING NOTES

SCALE


3 POST FOOTING DETAIL

SCALE

2

**GATE STOP DETAILS** 

SCALE

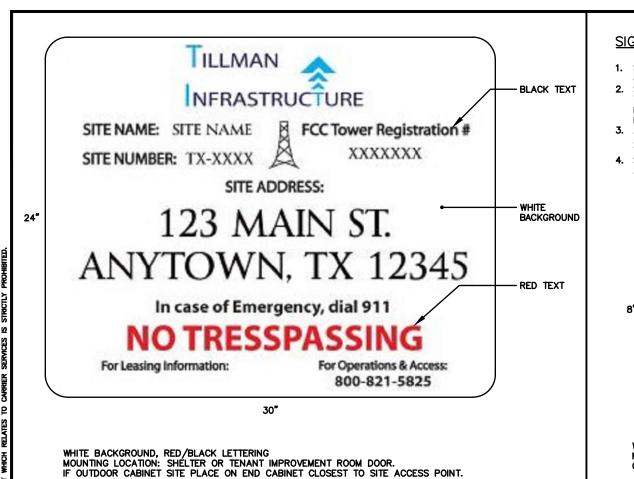

**BLACK TEXT** 

BACKGROUND

BACKGROUND


GREEN

# SIGNAGE NOTES:

- SIGNS SHALL BE FABRICATED FROM CORROSION RESISTANT PRESSED METAL & PAINTED WITH LONG LASTING UV RESISTANT COATING.
- 2. SIGNS (EXCEPT WHERE NOTED OTHERWISE) SHALL BE MOUNTED TO THE TOWER, GATE & FENCE USING A MINIMUM OF 9 GAUGE ALUMINUM WIRE, HOG RINGS (FENCE) OR BRACKETS, WHERE NECESSARY. BRACKETS SHALL BE OF SIMILAR METAL AS THE STRUCTURE TO AVOID GALVANIC CORROSION.
- ADDITIONAL E911 ADDRESS & FCC REGISTRATION SIGNS SHALL BE MOUNTED AT EACH ACCESS ROAD GATE LEADING TO THE COMPOUND AS WELL AS THE COMPOUND GATE ITSELF.
- SIGNS NEED NOT BE PLACED IF ACCURATE AND APPROPRIATE SIGNAGE ALREADY EXISTS.



WHITE/GREEN BACKGROUND, WHITE/BLACK LETTERING MOUNTING LOCATION: GATE & BASE OF TOWER

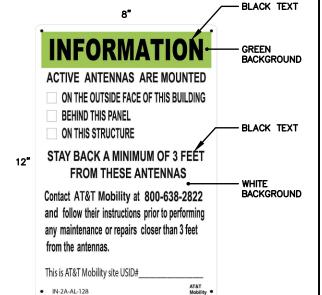

WHITE/GREEN BACKGROUND, WHITE/BLACK LETTERING MOUNTING LOCATION: GATE & BASE OF TOWER

WARNING

RF EXPOSURE INFORMATION SIGN







BARRINGTON, IL 60010 PHONE: 847-277-0070 EMAIL: AE@Westchesterservices.com

JOHN M. BANKS ARCHITECT 604 FOX GLEN BARRINGTON, IL 60010

TELEPHONE: 847-277-0070
FAX: 847-277-0080
EMAIL: JBANKS@WESTCHESTERSERVICES.COM

_	CONTROLLED DIT					
	REV	DATE	DESCRIPTION			
	Α	03/04/24	PRELIMINARY CD			
	В	03/06/24	PRELIMINARY CD			

THEREBY CERTIFY THAT THESE PLANS WERE PREPARED BY ME OR UNDER MY DIRECT SUPERMISION AND THAT I AM A DULY REGISTERED ARCHITECT UNDER THE LAWS OF THE STATE OF WISCONSIN



PLACE ON GENERATOR.

QUANTITY: 1 TO 2

This is Site USID #

FCC REGISTRATION SIGN

NOTICE BACKGROUND BACKGROUND BACKGROUND

En esta propiedad se ubican antenas de telecomunicaciones operadas por AT&T Mobility. Favor mantener una distancia de no menos de 3 pies y obedecer todos los avisos Comuniquese con el propietario o los propietarios de las antes de trabajar o caminar de menos de 3 pies de la antena

Comuniquese con AT&T Mobility 800-638-2822 antes de realizar cualquier mantenimiento o reparaciones cerca de las antenas de AT&T Mobility. Esta es la estacion base numero USID #\_\_\_

INFORMATION

Contact the owner(s) of the antenna(s) before working closer than 3 feet from the antenna(s).

Contact AT&T Mobility at 800-638-2822 prior to performing any maintenance or repairs near AT&T Mobility antennas.

Contact the management office if this door/hatch/gate is found

**INFORMACION** 

Favor comunicarse con la oficina de la administracion del

See 1 INSI-1A-AL-128

WHITE/GREEN BACKGROUND, WHITE/BLACK LETTERING MOUNTING LOCATION: GATE & BASE OF TOWER

WHITE TEXT BLACK TEXT **Beyond This Point:** You are entering a RADIO FREQUENCY (RF) EMISSIONS CONTROLLED AREA. RF EMISSIONS exceed FCC **Uncontrolled General Population** Follow all FCC/OSHA guidelines for working

BLACK TEXT YELLOW **ACAUTIÓI** BACKGROUND WHITE BACKGROUND YELLOW BACKGROUND 12" BLACK TEXT **Beyond this point:** Radio frequency fields at this sit may exceed FCC rules for human For your safety, obey all posted signs and site guidelines for working in radio

WHITE/YELOW BACKGROUND, WHITE/BLACK LETTERING MOUNTING LOCATION: GATE & BASE OF TOWER

WHITE **BACKGROUND** BACKGROUND 12" **BLACK TEXT Beyond this Point you are** entering a controlled area where radio frequency emissions exceed the FCC **Controlled Exposure Limits.** Failure to obey all posted signs and site guidelines could result in serious injury.

WHITE/ORANGE BACKGROUND, WHITE/BLACK LETTERING MOUNTING LOCATION: GATE & BASE OF TOWER

TILLMAN OPP# TI-OPP-29018 SITE NAME: WHITEWATER SITE ADDRESS: 1002 S JANESVILLE STREET WHITEWATER, WI 53190 FA#: 11655718 FAA STUDY #: 2024-AGL-23880E

> SHEET TITLE SITE SIGNAGE

> > SHEET NUMBER

WHITE/BLUE BACKGROUND, WHITE/BLACK LETTERING MOUNTING LOCATION: GATE & BASE OF TOWER

RF EXPOSURE CAUTION SIGN


2 RF EXPOSURE WARNING SIGN


SCALE 6

RF EXPOSURE INFORMATION SIGN SIGN 4 RF EXPOSURE NOTICE SIGN


**BLACK TEXT** 


BACKGROUND

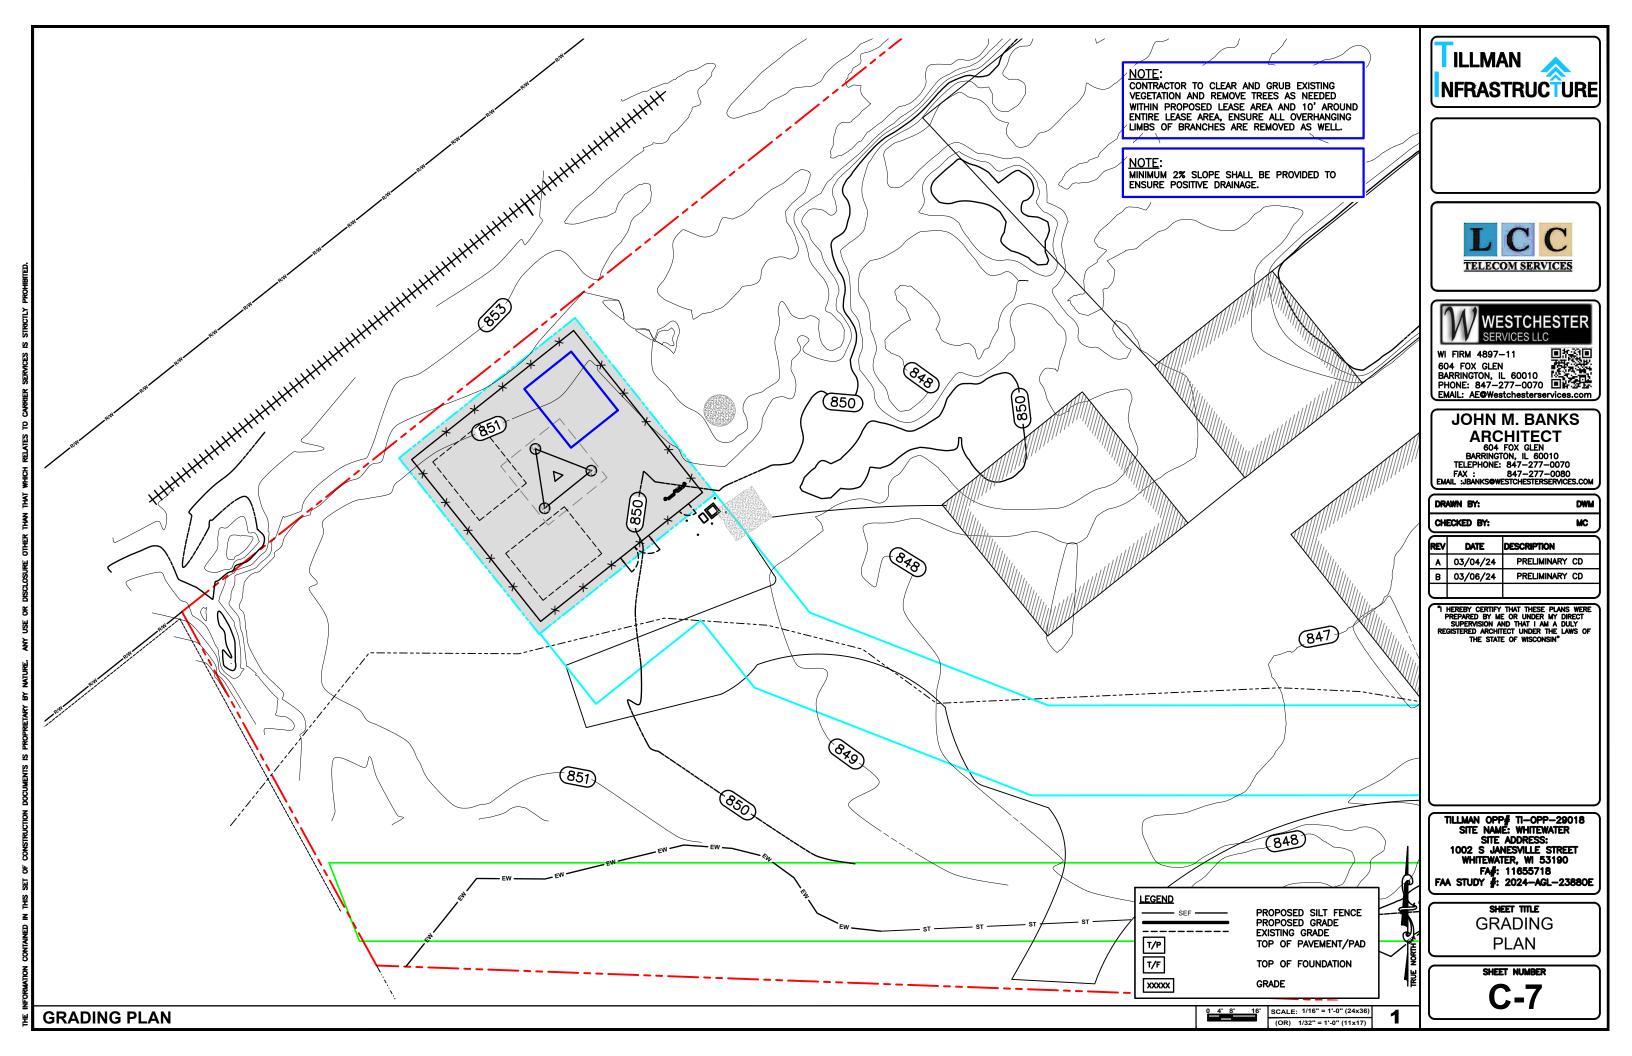

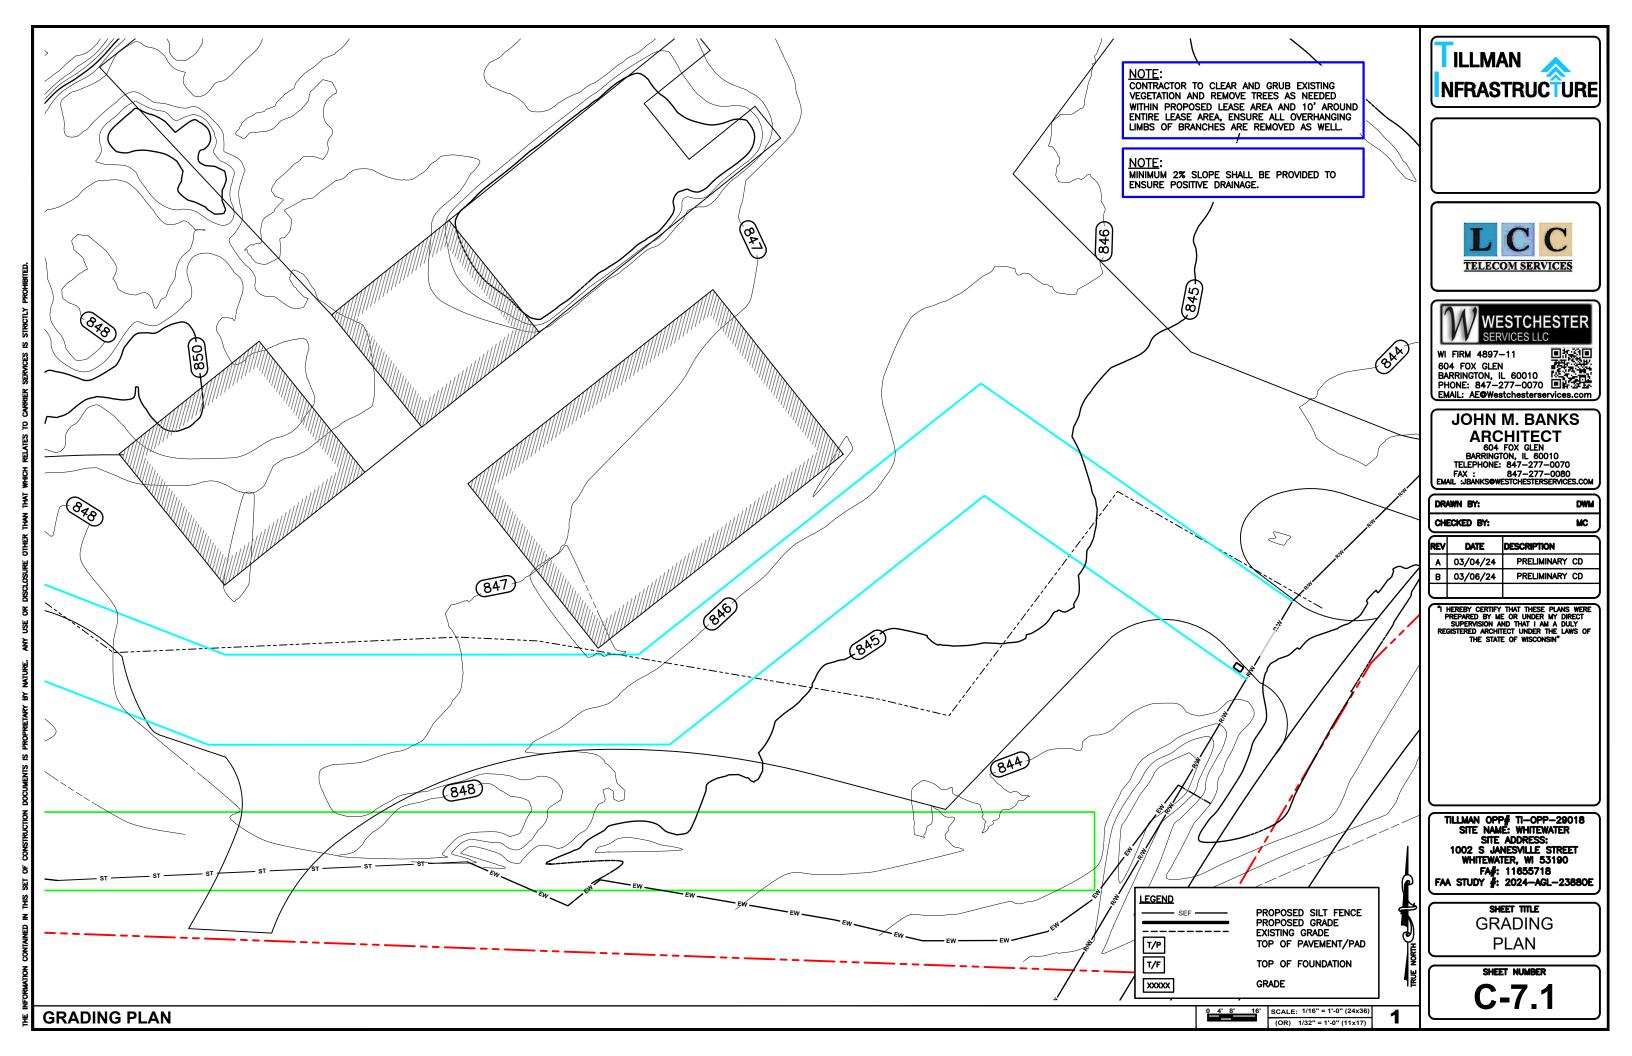

- 1. ALL VEGETATIVE AND STRUCTURAL EROSION CONTROL PRACTICES SHALL BE CONSTRUCTED AND MAINTAINED IN ACCORDANCE WITH THE MINIMUM STANDARDS AND SPECIFICATIONS OF THE APPLICABLE STATE ADOPTED "PROCEDURES AND STANDARDS FOR URBAN SOIL EROSION AND SEDIMENTATION CONTROL" AND THE "STANDARDS AND SPECIFICATIONS FOR SOIL EROSION AND SEDIMENT CONTROL" OF THE STATE ENVIRONMENTAL PROTECTION AGENCY.
- 2. A SOIL EROSION CONTROL FENCE SHALL BE INSTALLED BEFORE DISTURBING THE GROUND AND SHALL BE PROVIDED AS SHOWN ON THE PLAN. THE CONDITION OF THE FENCE SHALL BE INSPECTED REGULARLY AND AFTER EVERY RAINSTORM THAT MIGHT PRODUCE RUNOFF. DAMAGED OR DETERIORATED ITEMS SHALL BE REPLACED AND MAINTAINED IN AN EFFECTIVE
- 3. SOIL EROSION CONTROL MEASURES SHALL BE INCLUDED IN CONTRACTOR BID AND PRICING
- THE ENTIRE SITE SHALL BE GRADED SO THAT NO STORM WATER RUNOFF AND LIKEWISE SOIL SEDIMENT CAN FLOW UNRESTRICTED FROM THE SITE
- 5. ALL INLETS, STRUCTURES, PIPES, SWALES, AND ROADS SHALL BE KEPT CLEAN AND FREE OF DIRT AND SILT
- MAINTAIN SOIL EROSION CONTROL MEASURES THROUGH THE DURATION OF THIS PROJECT
- SEDIMENT DEPOSITS SHALL BE REMOVED WHEN REACHING ONE HALF THE HEIGHT OF THE
- ALL SOIL EROSION CONTROL MEASURES SHALL REMAIN IN PLACE UNTIL ALL DISTURBED EARTH HAS BEEN PAVED OR VEGETATED
- ANY EXCESS TOPSOIL THAT IS TO BE STOCKPILED FOR A PERIOD LONGER THAN 2 WEEKS SHALL BE PROTECTED BY EXCAVATING A TRENCH COMPLETELY AROUND THE STOCKPILE TO PREVENT THE ESCAPE OF SOIL MATERIAL THROUGH STORM WATER RUNOFF. STOCKPILES THAT ARE TO REMAIN LONGER THAN 14 DAYS SHALL BE SEEDED WITH AN APPROPRIATE GROUND COVER
- 10. TO PREVENT SOIL FROM LEAVING THE SITE ON CONSTRUCTION VEHICLE WHEELS, TEMPORARY GRAVEL ROADS AT WORK ENTRANCES SHALL BE CONSTRUCTED AND SHALL EXTEND INTO JOB SITE. THE EXISTING PAVEMENT SURFACES SHALL BE INSPECTED DAILY FOR SOIL DEBRIS AND SHALL BE CLEANED WHEN NECESSARY
- 11. FINAL RESTORATION SHALL BE COMPLETED PRIOR TO CLOSEOUT, PROVIDING 6" OF TOPSOIL RAKED TO A UNIFORM SURFACE.
- 12. SOIL EROSION CONTROL MEASURES SHALL BE REMOVED AND PROPERLY DISPOSED OF WHEN PROJECT IS COMPLETED

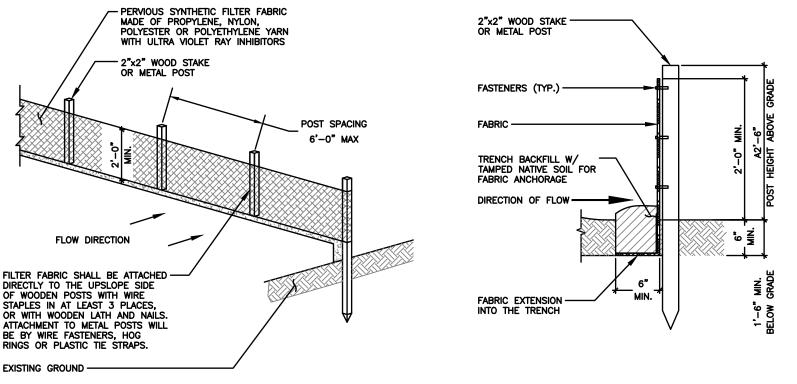

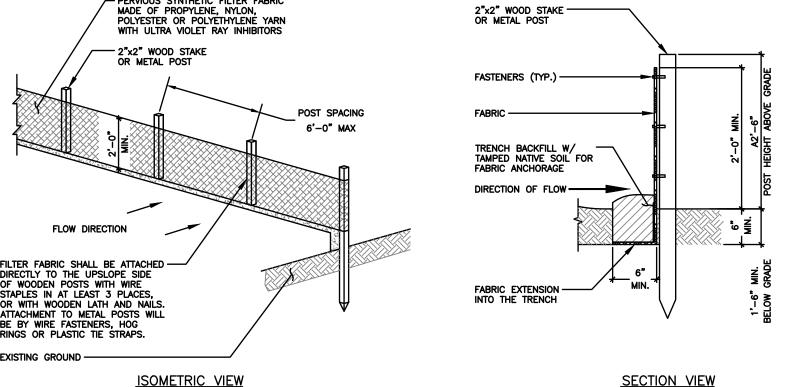







EMAIL: AE@Westchesterservices.com JOHN M. BANKS

ARCHITECT
604 FOX GLEN
BARRINGTON, IL 60010 TELEPHONE: 847-277-0070 FAX: 847-277-0080 EMAIL: JBANKS@WESTCHESTERSERVICES.COM

DWM

CHECKED BY: MC REV DATE DESCRIPTION PRELIMINARY CD 03/04/24 PRELIMINARY CD 03/06/24

DRAWN BY:

SCALE

N.T.S.

"I HEREBY CERTIFY THAT THESE PLANS WERE PREPARED BY ME OR UNDER MY DIRECT SUPERVISION AND THAT I AM A DULY REGISTERED ARCHITECT UNDER THE LAWS OF THE STATE OF WISCONSIN


TILLMAN OPP# TI-OPP-29018 SITE NAME: WHITEWATER SITE ADDRESS: 1002 S JANESVILLE STREET WHITEWATER, WI 53190 FA#: 11655718 FAA STUDY #: 2024-AGL-23880E

SHEET TITLE **EROSION CONTROL** DETAILS


SOIL EROSION & SEDIMENT CONTROL NOTES

SCALE

**EROSION CONTROL - SILT FENCE** 

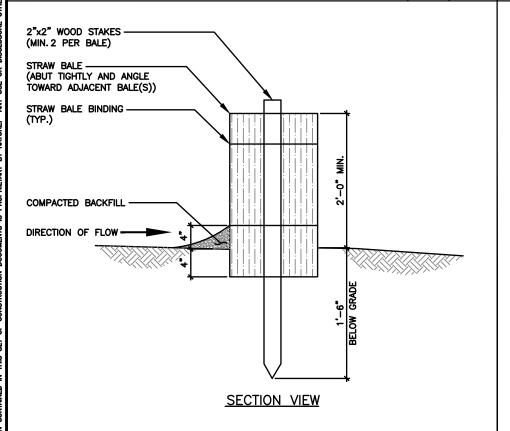



EROSION CONTROL - STRAW BALE (OPTIONAL) SOLE

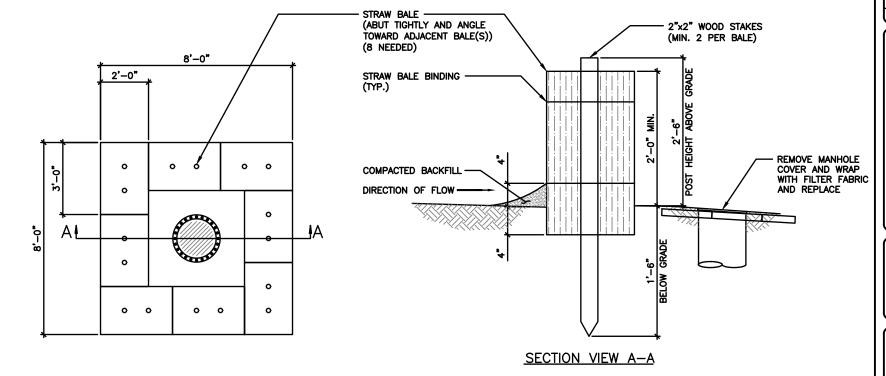

EROSION CONTROL - STRAW BALE AT STORM INLET MANHOLE (IF NEEDED SEE PLANS)

SCALE

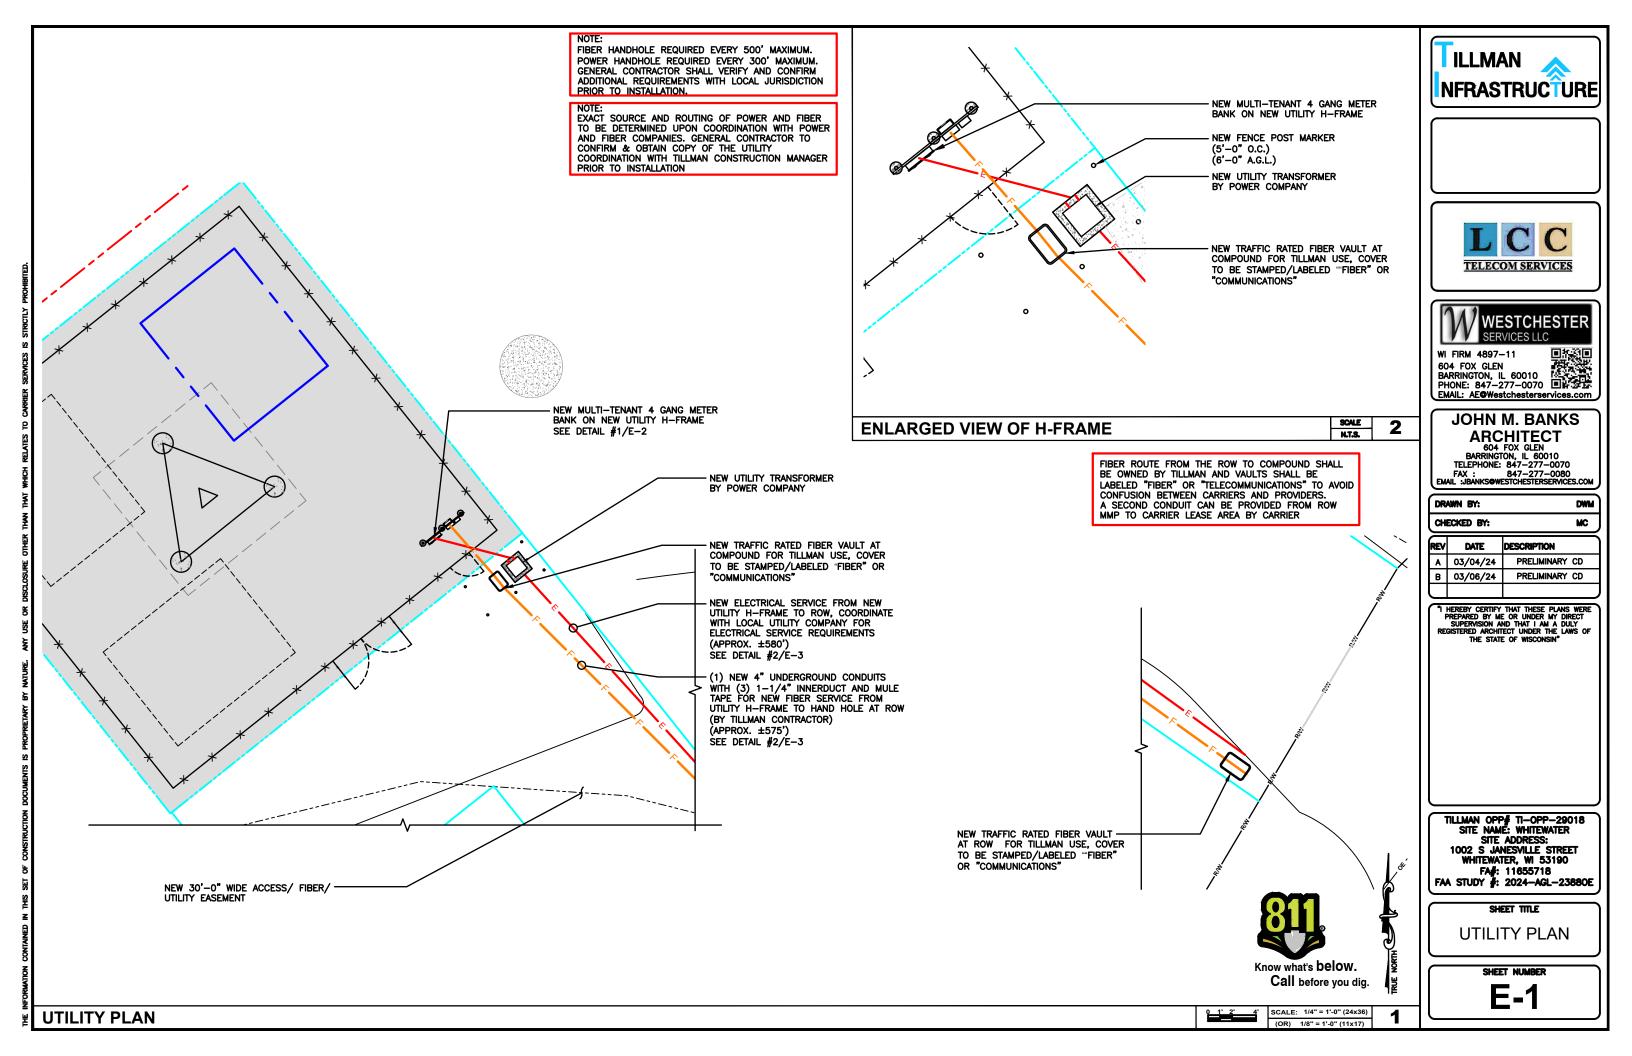

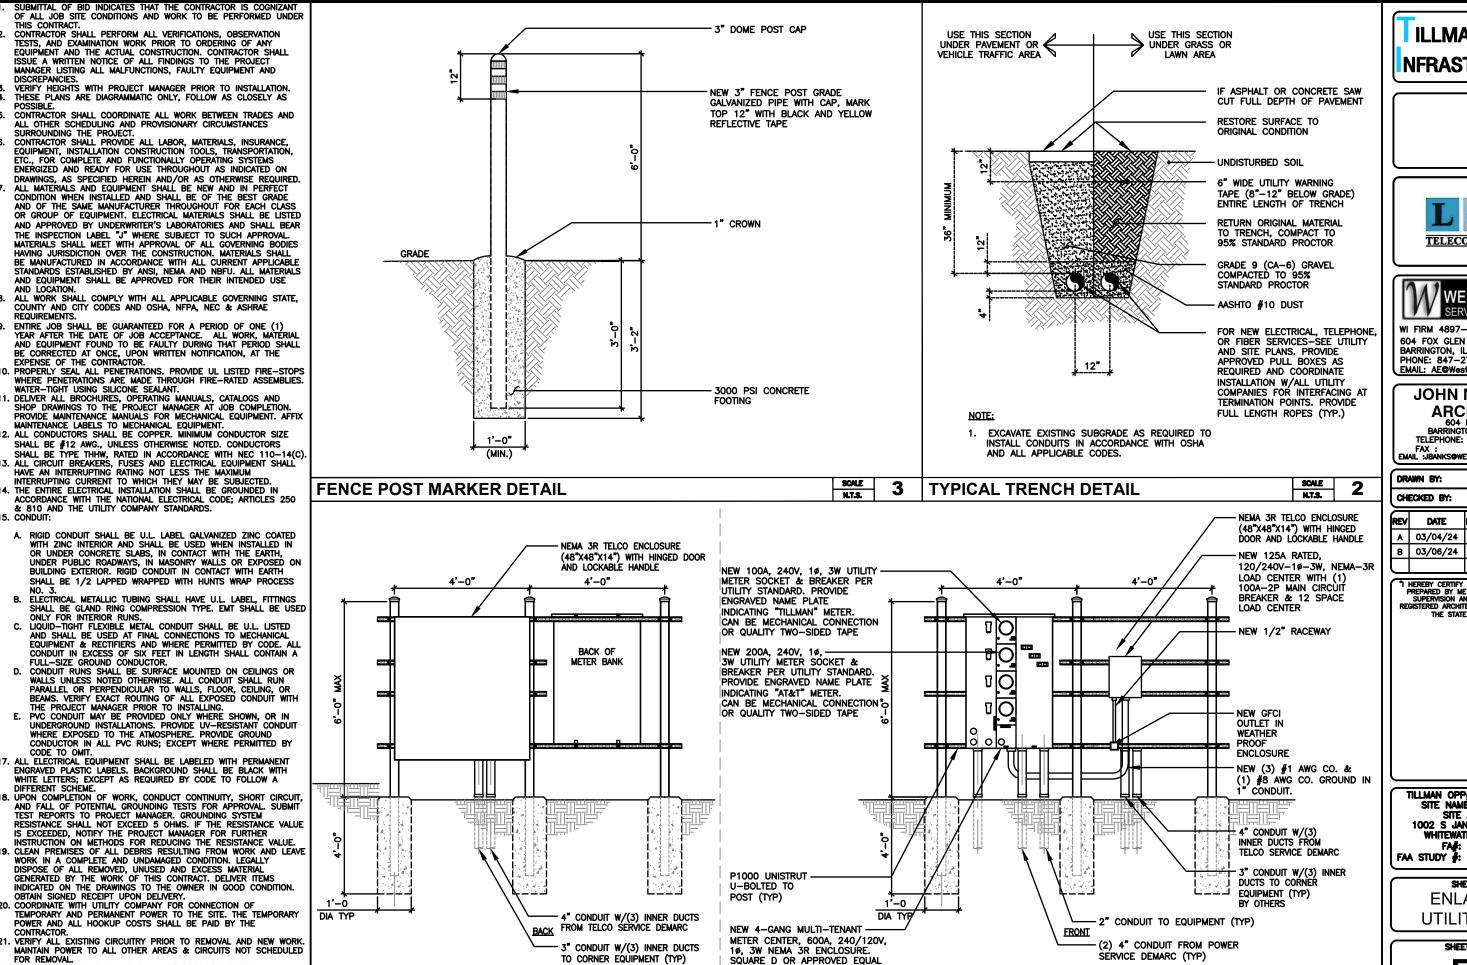

BY OTHERS

2. RED LINED AS-BUILT PLANS SHALL BE PROVIDED TO THE

4

**UTILITY FRAME DETAIL** 

CONSTRUCTION MANAGER

**ELECTRICAL NOTES** 

ILLMAN NFRASTRUCTURE





BARRINGTON, IL 60010 PHONE: 847-277-0070 EMAIL: AE@Westchesterservices.com

**DWM** 

# JOHN M. BANKS ARCHITECT 604 FOX GLEN BARRINGTON, IL 60010

TELEPHONE: 847-277-0070
FAX: 847-277-0080
EMAIL: JBANKS@WESTCHESTERSERVICES.COM

MC DESCRIPTION PRELIMINARY CD PRELIMINARY CD


> THEREBY CERTIFY THAT THESE PLANS WERE PREPARED BY ME OR UNDER MY DIRECT SUPERMISION AND THAT I AM A DULY REGISTERED ARCHITECT UNDER THE LAWS OF THE STATE OF WISCONSIN

TILLMAN OPP# TI-OPP-29018 SITE NAME: WHITEWATER SITE ADDRESS: 1002 S JANESVILLE STREET WHITEWATER, WI 53190 FA#: 11655718 FAA STUDY #: 2024-AGL-23880E

> SHEET TITLE **ENLARGED** UTILITY PLAN

SCALE

**E-2** 

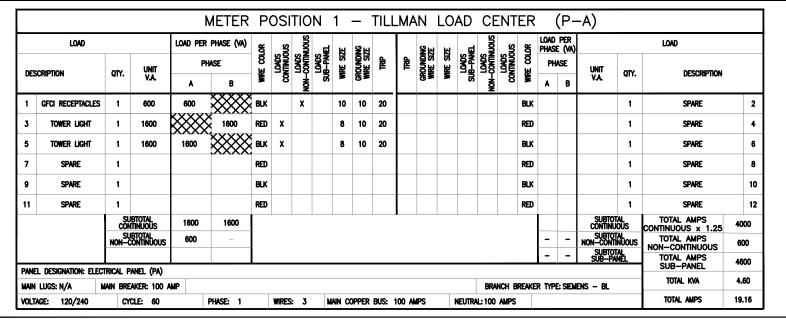







604 FOX GLEN
BARRINGTON, IL 60010
PHONE: 847-277-0070
EMAIL: AE©Westchesterservices.com

# JOHN M. BANKS ARCHITECT 604 FOX GLEN BARRINGTON, IL 60010

BARRINGTON, IL 60010
TELEPHONE: 847-277-0070
FAX: 847-277-0080
EMAIL: JBANKS@WESTCHESTERSERVICES.COM

H	СН	ECKED BY:	M		
16	REV	DATE	DESCRIPTION		
	Α	03/04/24	PRELIMINARY	CD	
Ιſ	D	03/06/24	PRFI IMINARY	CD	Τ

"I HEREBY CERTIFY THAT THESE PLANS WERE PREPARED BY ME OR UNDER MY DIRECT SUPERVISION AND THAT I AM A DULY REGISTERED ARCHITECT UNDER THE LAWS OF THE STATE OF WISCONSIN"


TILLMAN OPP# TI-OPP-29018
SITE NAME: WHITEWATER
SITE ADDRESS:
1002 S JANESVILLE STREET
WHITEWATER, WI 53190
FA#: 11655718
FAA STUDY #: 2024-AGL-23880E

SHEET TITLE ELECTRICAL DIAGRAM

SHEET NUMBE

1


E-3

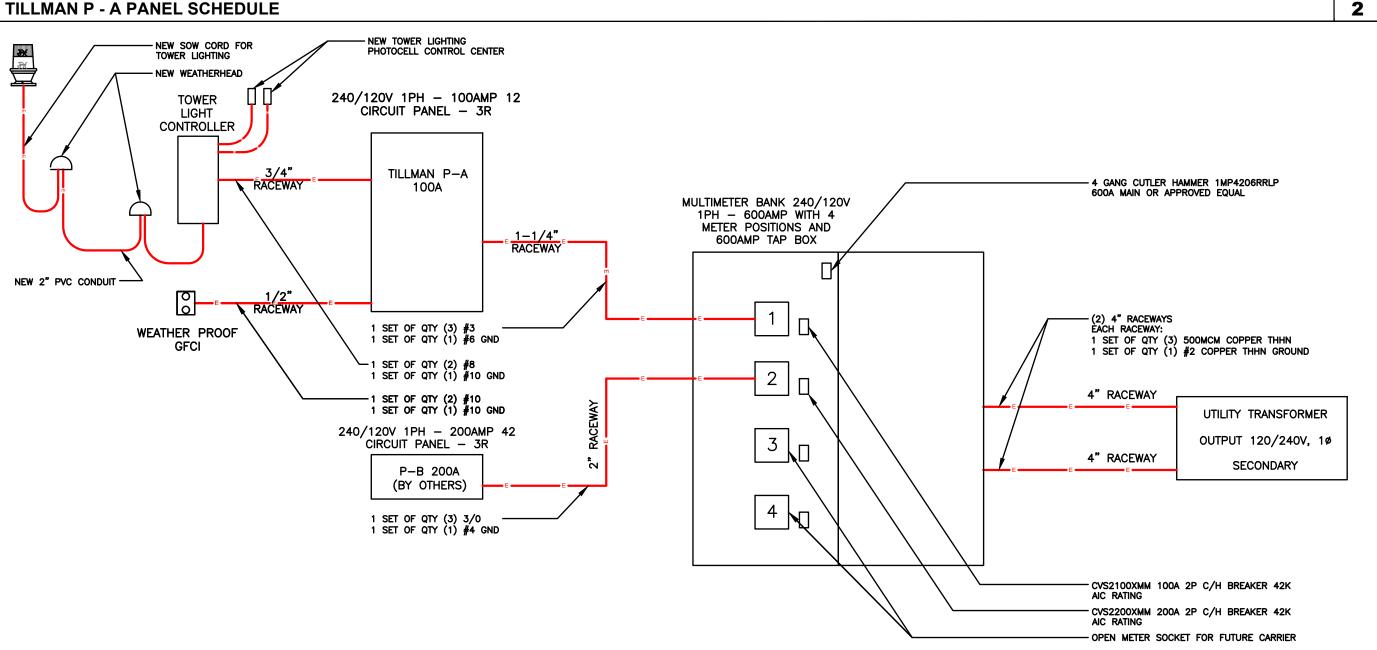

**ELECTRICAL SINGLE LINE DIAGRAM** 

# GROUNDING NOTES:

- GROUNDING SHALL COMPLY WITH ARTICLE 250 OF THE NATIONAL ELECTRICAL CODE.
- ALL GROUNDING DEVICES SHALL BE U.L. APPROVED OR LISTED FOR THEIR INTENDED USE.
- ALL WIRES SHALL BE AWG THHN/THWN COPPER UNLESS NOTED OTHERWISE.
- GROUNDING CONNECTIONS TO GROUND RODS, GROUND RING WIRE, TOWER BASE AND FENCE POSTS SHALL BE EXOTHERMIC ("CADWELDS") UNLESS NOTED OTHERWISE. CLEAN SURFACES TO SHINY METAL. WHERE GROUND WIRES ARE CADWELDED TO GALVANIZED SURFACES, SPRAY CADWELD WITH GALVANIZING PAINT.
- GROUNDING CONNECTIONS TO GROUND BARS ARE TO GROUNDING CONNECTIONS TO GROUND BARS ARE TO BE TWO-HOLE BRASS MECHANICAL CONNECTORS WITH STAINLESS STEEL HARDWARE (INCLUDING SCREW SET) CLEAN GROUND BAR TO SHINY METAL AFTER MECHANICAL CONNECTION, TREAT WITH PROTECTIVE ANTIOXIDANT COATING.
- GROUND COAXIAL CABLE SHIELDS AT BOTH ENDS WITH MANUFACTURER'S GROUNDING KITS.
- ROUTE GROUNDING CONDUCTORS THE SHORTEST AND STRAIGHTEST PATH POSSIBLE. BEND GROUNDING LEADS WITH A MINIMUM 12" RADIUS.
- INSTALL #2 AWG GREEN-INSULATED STRANDED WIRE FOR ABOVE GRADE GROUNDING AND #2 BARE TINNED COPPER WIRE FOR BELOW GRADE GROUNDING UNLESS
- REFER TO GROUNDING PLAN FOR GROUND BAR LOCATIONS. GROUNDING CONNECTIONS SHALL BE EXOTHERMIC TYPE ("CADWELDS") TO ANTENNA MOUNTS AND GROUND RING. REMAINING GROUNDING CONNECTIONS SHALL BE COMPRESSION FITTINGS. CONNECTIONS TO GROUND BARS SHALL BE MADE WITH
- O. THE GROUND ELECTRODE SYSTEM SHALL CONSIST OF 5/8"X10"-0" COPPER CLAD STEEL INTERCONNECTED WITH #2 BARE TINNED COPPER WIRE BURIED 36" BELOW GRADE. BURY GROUND RODS A MAXIMUM OF
- 11. IF ROCK IS ENCOUNTERED GROUND RODS SHALL BE PLACED AT AN OBLIQUE ANGLE NOT TO EXCEED 45°.
- 12. EXOTHERMIC WELDS SHALL BE MADE IN ACCORDANCE WITH ERICO PRODUCTS BULLETIN A-AT.
- 13. CONSTRUCTION OF GROUND RING AND CONNECTIONS TO EXISTING GROUND RING SYSTEM SHALL BE DOCUMENTED WITH PHOTOGRAPHS PRIOR TO BACKFILLING SITE. PROVIDE PHOTOS TO THE AT&T WIRELESS CONSTRUCTION MANAGER.
- all ground leads except those to the equipment are to be #2 bare tinned copper wire. All exterior ground bars tinned copper.
- 5. PRIOR TO INSTALLING LUGS ON GROUND WIRES, APPLY THOMAS & BETTS KOPR-SHIELD (TM OF JET LUBE INC.). PRIOR TO BOLTING GROUND WIRE LUGS TO GROUND BARS, APPLY KOPR-SHIELD OR EQUAL.
- 6. ENGAGE AN INDEPENDENT ELECTRICAL TESTING FIRM TO TEST AND VERIFY THAT IMPEDANCE DOES NOT EXCEED FIVE OHMS TO GROUND BY MEANS OF "FALL OF POTENTIAL TEST". TEST SHALL BE WITNESSED BY A METROPCS REPRESENTATIVE, AND RECORDED ON THE "GROUND RESISTANCE TEST" FORM.
- 7. WHERE BARE COPPER GROUND WIRES ARE ROUTED FROM ANY CONNECTION ABOVE GRADE TO GROUND RING, INSTALL WIRE IN LIQUID TIGHT CONDUITS, A MINIMUM 6" ABOVE AND BELOW GRADE/ GRAVEL
- PREPARE ALL BONDING SURFACES FOR GROUNDING CONNECTIONS BY REMOVING ALL PAINT AND CORROSION DOWN TO SHINY METAL. FOLLOWING CONNECTION, APPLY APPROPRIATE ANTI-OXIDIZATION PAINT.
- 9. ANY SITE WHERE THE EQUIPMENT (BTS, CABLE BRIDGE, PPC, GENERATOR, ETC.) IS LOCATED WITHIN 6 FEET OF METAL FENCING, THE GROUND RING SHALL BE BONDED TO THE NEAREST FENCE POST USING (3) RUNS OF #2

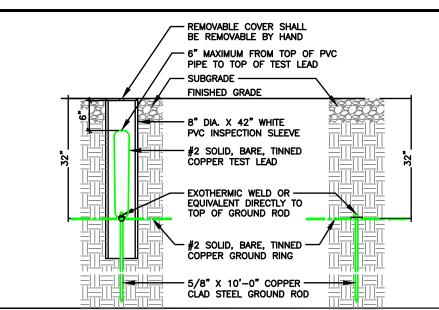

A LARGER CONDUCTOR SHALL BE REQUIRED IN AREAS HIGHLY PRONE TO LIGHTNING AND/OR AREAS W/HIGHLY ACIDIC SOIL

GROUND RODS MAY BE COPPER CLAD STEEL OR SOLID COPPER

GROUND RODS SHALL HAVE A RECOMMENDED SPACING TWICE THE LENGTH OF THE ROD

SEE RESISTIVITY REPORT FOR VERIFICATION AS AVAILABLE

GROUND RODS INSTALLED WITHIN CLOSE PROXIMITY TO TOWER OR WHEN SOIL IS AT OR BELOW 2,000 OHM-CM, SHALL BE GALVANIZED TO PREVENT GALVANIC CORROSION OF TOWER

**GROUND WELL, ROD, AND TEST WELL DETAIL** 

WI FIRM 4897-11 604 FOX GLEN BARRINGTON, IL 60010
PHONE: 847-277-0070 EMAIL: AE@Westchesterservices.com

ILLMAN

NFRASTRUCTURE

# JOHN M. BANKS ARCHITECT 604 FOX GLEN

TELECOM SERVICES

WESTCHESTER

BARRINGTON, IL 60010 TELEPHONE: 847-277-0070 FAX: 847-277-0080 EMAIL: JBANKSOWESTCHESTERSERVICES.COM

**DWM** 

MC


DRAWN BY: CHECKED BY:

DESCRIPTION DATE PRELIMINARY CD 03/04/24 PRELIMINARY CD 03/06/24

HEREBY CERTIFY THAT THESE PLANS WERE PREPARED BY ME OR UNDER MY DIRECT SUPERNSION AND THAT I AM A DULY REGISTERED ARCHITECT UNDER THE LAWS OF THE STATE OF WISCONSIN


TILLMAN OPP# TI-OPP-29018 SITE NAME: WHITEWATER SITE ADDRESS: 1002 S JANESVILLE STREET WHITEWATER, WI 53190 FA#: 11655718 FAA STUDY #: 2024-AGL-23880E


SHEET TITLE **GROUNDING PLAN** & DETAILS

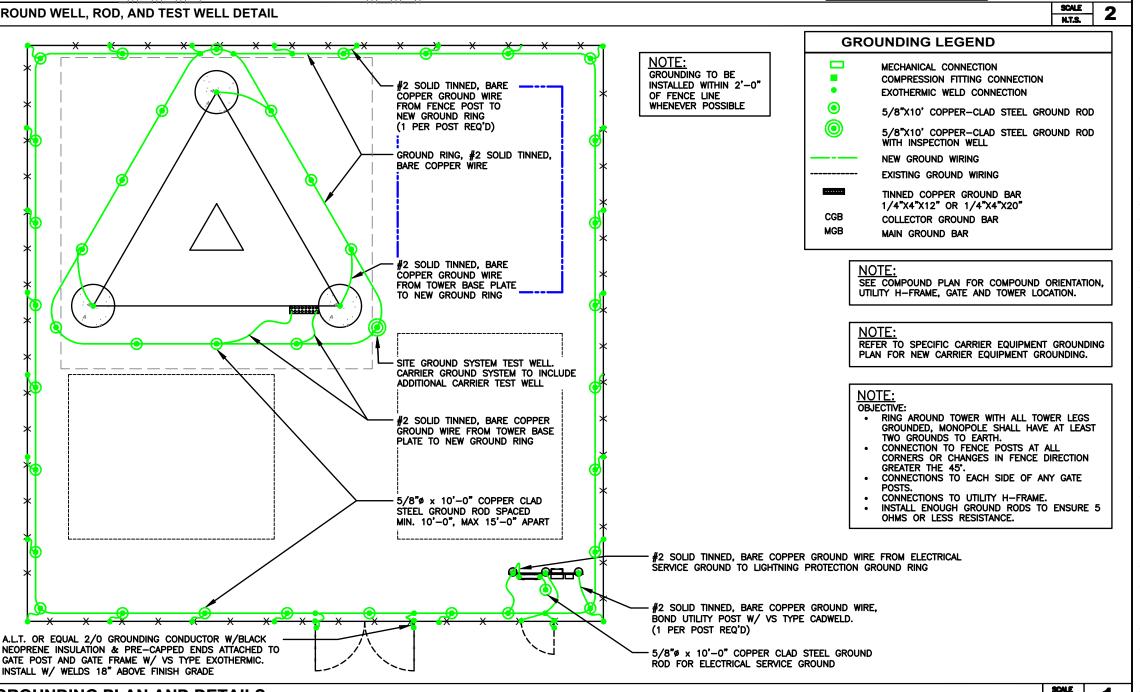

GROUNDING NOTES

**GROUNDING PLAN AND DETAILS** 

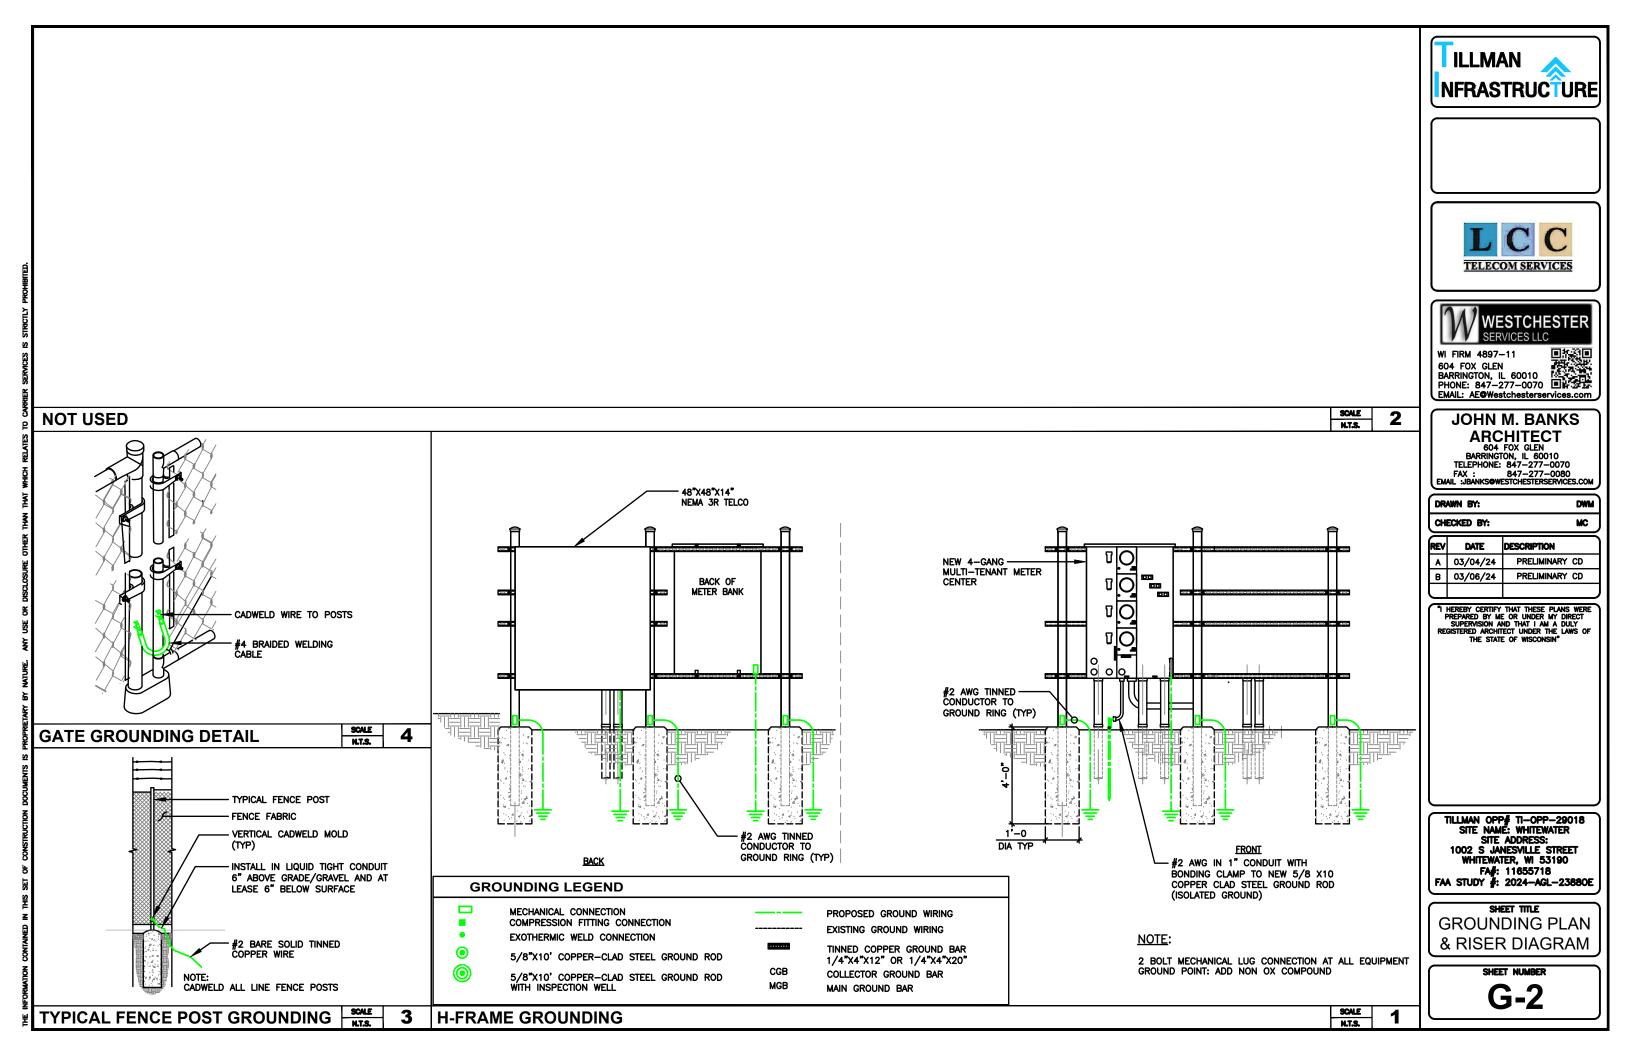

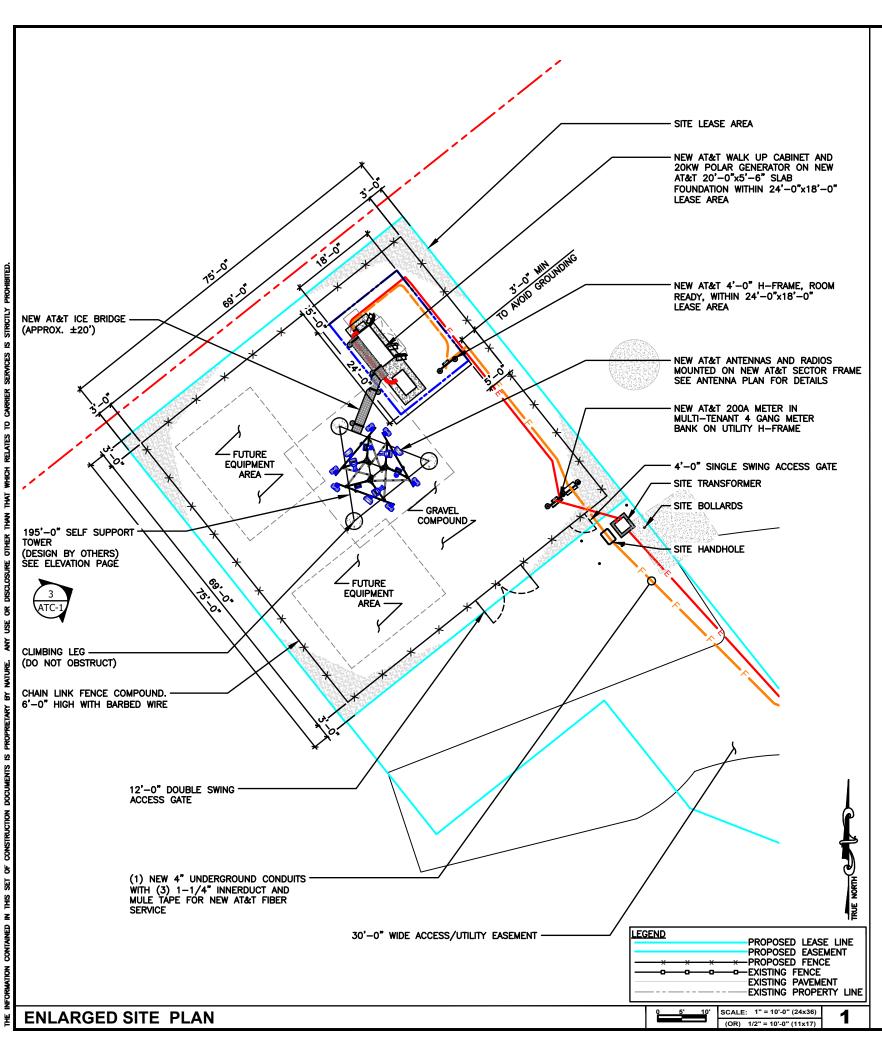



# **AT&T SITE NUMBER: WI2696** AT&T SITE NAME: WHITEWATER **FA CODE: 11655718 SITE ADDRESS: 1002 S JANESVILLE STREET** WHITEWATER, WI 53190 **TILLMAN SITE # TI-OPP-29018**

# SITE INFORMATION

SITE ADDRESS: 1002 S JANESVILLE STREET

42°49'08.8617"N (42.81912825°) LONGITUDE (NADV 88): 88°45'13.7991"W (-88.75383307°

GROUND ELEVATION: 850.37' (AMSL)

JURISDICTION: THE CITY OF WHITEWATER

PARCEL/MAP NUMBER:

LATITUDE (NAD 83):

LANDLORD OWNER:

TOWER OWNER:

HATCHETT ENTERPRISES LLC 1002 S JANESVILLE STREET WHITEWATER, WI 53190

TILLMAN INFRASTRUCTURE

152 W. 57TH STREET NEW YORK, NEW YORK 1001

SELF SUPPORT TOWER STRUCTURE TYPE:

STRUCTURE HEIGHT: 195'-0" (AGL) TILLMAN SITE #:

### PROJECT TEAM DRAWING INDEX TITLE SHEET & OVERALL SITE PLAN APPLICANT TILL MAN INFRASTRUCTURE AT-C-1 ELEVATION. ANTENNA PLAN AND SCHEDULE NEW YORK, NEW YORK 10019 WALK UP CABINET PAD DETAILS PROJECT MANAGEMENT FIRM: LCC TELECOM SERVICES AT-C-2.1 WALK UP CABINET PAD DETAILS 10700 HIGGINS ROAD, SUITE 240 ROSEMONT, IL 60018 CONSTRUCTION DETAILS RRH, ANTENNA AND EQUIPMENT SPECIFICATIONS AT-C-4 ARCHITECT JOHN M. BANKS 604 FOX GLEN ELECTRICAL PANEL SCHEDULE, DIAGRAM AND NOTE BARRINGTON, IL 60010 AT-E-2 CONTACT: JOHN M. BANKS PHONE: (847) 277-0070 EMAIL: JBANKS@WESTCHESTERSERVICES.COM AT-E-3 DC/FIBER SYSTEM DIAGRAM AT-E-4 GROUNDING PLAN AND RISER DIAGRAM GROUNDING DETAILS & NOTES

# **CODE COMPLIANCE**

ALL WORK AND MATERIALS SHALL BE PERFORMED AND INSTALLED IN ACCORDANCE WITH THE CURRENT EDITIONS OF THE FOLLOWING CODES AS ADOPTED BY THE LOCAL GOVERNING AUTHORITIES. NOTHING IN THESE PLANS IS TO BE CONSTRUED TO PERMIT WORK NOT CONFORMING TO THE LATEST EDITIONS OF THE FOLLOWING CODES

- 2023 WISCONSIN STATE BUILDING CODE 2023 WISCONSIN STATE ELECTRICAL CODE
- 2023 WISCONSIN STATE MECHANICAL CODE 2023 WISCONSIN STATE PLUMBING CODE
- 2023 WISCONSIN STATE FIRE CODE
- AMERICAN CONCRETE INSTITUTE
- AMERICAN INSTITUTE OF STEEL CONSTRUCTION
- MANUAL OF STEEL CONSTRUCTION 13TH EDITION
- ANSI/TIA-222-H

- INSTITUTE FOR ELECTRICAL & ELECTRONICS ENGINEERING 81
- IEEE C2 NATIONAL ELECTRIC SAFETY CODE
- LATEST EDITION TELECORDIA GR-1275









WI FIRM 4897-11 604 FOX GLEN BARRINGTON, IL 60010
PHONE: 847-277-0070
EMAIL: AE@Westchesterservices.com

# JOHN M. BANKS

ARCHITECT
604 FOX GLEN
BARRINGTON, IL 60010
TELEPHONE: 847-277-0070
FAX: 847-277-0080
EMAIL JBANKSOWESTCHESTERSERVICES.COM

CHECKED BY: MC REV DESCRIPTION DATE 03/04/24 PRELIMINARY CD

PRELIMINARY CD

DRAWN BY:


03/06/24


HEREBY CERTIFY THAT THESE PLANS WERE PREPARED BY ME OR UNDER MY DIRECT SUPERVISION AND THAT I AM A DULY REGISTERED ARCHITECT UNDER THE LAWS OF THE STATE OF WISCONSIN

EXPIRE DATE: 06/30/25

AT&T SITE# W12696 AT&T SITE NAME: WHITEWATER FA # 11655718 SITE ADDRESS: 1002 S JANESVILLE STREET WHITEWATER, WI 53190 FAA STUDY #: 2024-AGL-23880E

SHEET TITLE TITLE SHEET & OVERALL SITE PLAN

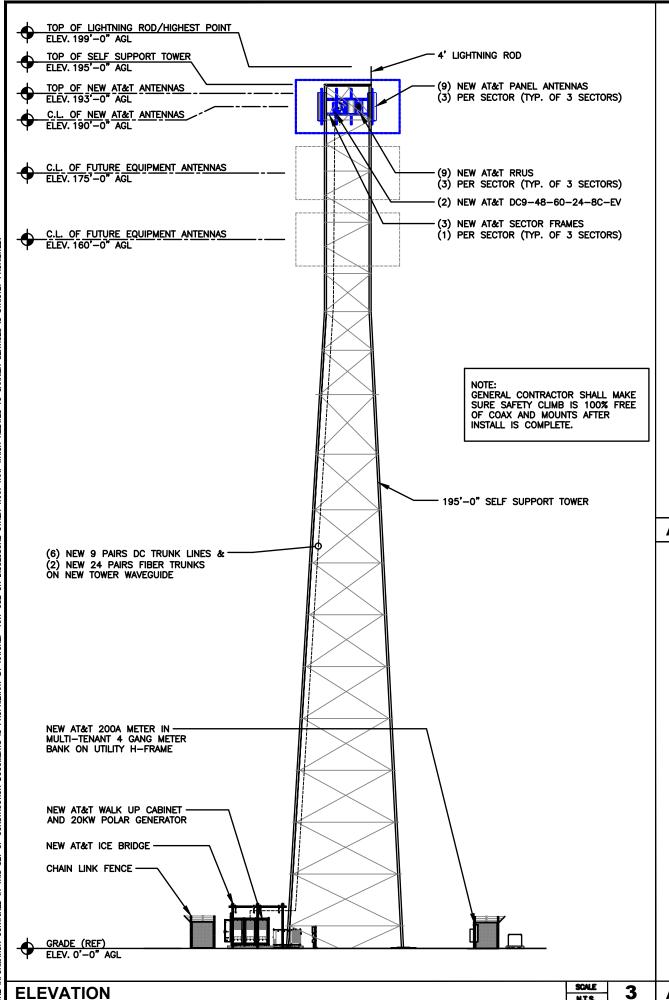

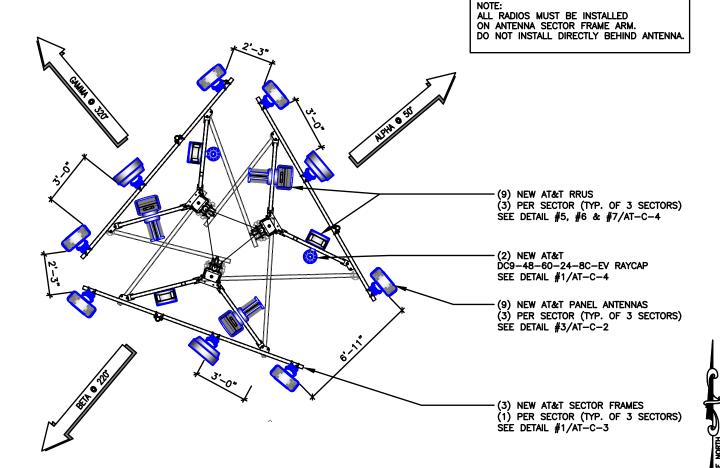

# ANTENNA LAYOUT (SELF SUPPORT)

ANTENNA AND RRH SCHEDULE BASED ON AT&T RFDS DATED: 04/24/23					
SECTOR	ANTENNA	TECH	ANTENNA & HEIGHT	AZIMUTH	RRU MODEL
	COMMSCOPE ANTENNAS NNH4-65B-R6H4	LTE 700 5G 850 LTE 1900 5G 1900 5G AWS LTE AWS	190'-0 <b>"</b> ±	50°	RRUS 4449 B5/B12 RRUS 8843 B2/B66A
ALPHA	ERICSSON AIR 6449 B77D	5G CBAND	190'-0"±	50°	-
	EMPTY	-	-	-	-
	COMMSCOPE ANTENNAS NNH4-65B-R6H4	LTE 700	190'-0"±	50°	RRUS 4478 B14
	COMMSCOPE ANTENNAS NNH4-65B-R6H4	LTE 700 5G 850 LTE 1900 5G 1900 5G AWS LTE AWS	190'-0"±	220°	RRUS 4449 B5/B12 RRUS 8843 B2/B66A
BETA	ERICSSON AIR 6449 B77D	5G CBAND	190'-0"±	220°	_
DLIA	EMPTY	-	-	-	-
	COMMSCOPE ANTENNAS NNH4-65B-R6H4	-	190'-0"±	220°	RRUS 4478 B14
	COMMSCOPE ANTENNAS NNH4-65B-R6H4	LTE 700 5G 850 LTE 1900 5G 1900 5G AWS LTE AWS	190'-0"±	320°	RRUS 4449 B5/B12 RRUS 8843 B2/B66A
GAMMA	ERICSSON AIR 6449 B77D	5G CBAND	190'-0"±	320°	=
	EMPTY	-	-	-	-
	COMMSCOPE ANTENNAS NNH4-65B-R6H4	-	190'-0"±	320°	RRUS 4478 B14

CA	BLE COUNT
QUANTITY	CABLE TYPE
6	6 CONDUCTOR (3 PR) 3/4" DC CABLE
2	36 FIBER (24 PR) 10MM FIBER
2	DC9 SQUIDS

SCALE









604 FOX GLEN BARRINGTON, IL 60010
PHONE: 847-277-0070
EMAIL: AE@Westchesterservices.com

# JOHN M. BANKS

ARCHITECT
604 FOX GLEN
BARRINGTON, IL 60010
TELEPHONE: 847-277-0070
FAX: 847-277-0080
EMAIL:JBANKS@WESTCHESTERSERVICES.COM

DWM

CHECKED BY: MC DATE DESCRIPTION 03/04/24 PRELIMINARY CD PRELIMINARY CD

DRAWN BY:

03/06/24

"I HEREBY CERTIFY THAT THESE PLANS WERE PREPARED BY ME OR UNDER MY DIRECT SUPERVISION AND THAT I AM A DULY REGISTERED ARCHITECT UNDER THE LAWS OF THE STATE OF WISCONSIN"


EXPIRE DATE: 08/30/25

AT&T SITE# W12696 AT&T SITE NAME: WHITEWATER FA # 11855718
SITE ADDRESS:
1002 S JANESVILLE STREET
WHITEWATER, WI 53190
FAA STUDY #: 2024-AGL-23880E

SHEET TITLE ELEVATION, ANT. PLAN & SCHEDULE

**ANTENNA AND RRH SCHEDULE** 

### FRONT VIEW

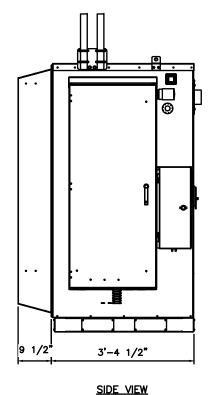


ALL CONDUIT FROM BELOW GRADE TO ABOVE GRADE MUST INCLUDE FROST SLEEVES TO PREVENT FROST DAMAGE TO CONDUIT OR EQUIPMENT.

SDC020 | 2.2L | 20 kW

INDUSTRIAL DIESEL GENERATOR SET

**EPA Certified Stationary Emergency** 

# DIMENSIONS AND WEIGHTS\*

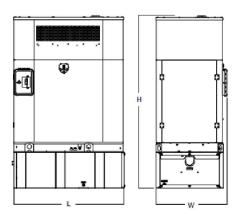

# COMPACT VARIANT

Run Time - Hours	Usable Capacity - Gal (L)	L x W x H - in (mm)	Weight - lbs (kg)
No Tank	-	56.0 (1,422) x 34.5 (876) x 68.9 (1,749)	1,465 (664)
31.9	51 (193)	56.0 (1,422) x 34.5 (876) x 87.3 (2,215)	1,914 (868)
64.4	103 (390)	56.0 (1,422) x 34.5 (876) x 99.1 (2,515)	2,090 (948)

GENERAC INDUSTRIAL

# **GENERAC 20KW NEQ.53187**

# **OPERATING DATA**

### **POWER RATINGS**

	Standby		
Single-Phase 120/240 VAC @1.0pf	20 kW, 20 kVA	Amps: 83	
Three-Phase 120/208 VAC @0.8pf	20 kW, 25 kVA	Amps: 70	
Three-Phase 120/240 VAC @0.8pf	20 kW, 25 kVA	Amps: 60	
Three-Phase 277/480 VAC @0.8pf	20 kW, 25 kVA	Amps: 30	

### MOTOR STARTING CAPABILITIES (skVA)

# skVA vs. Voltage Dip

120/240 VAC 10	30%	277/480 VAC 3Ø	30%	208/240 VAC 3Ø	30%
A0035044N26	50	K0035124Y26	68	K0035124Y26	50

### **FUEL CONSUMPTION RATES\***

	Diesel -	gph (Lph)
Eucl Dumn Lift, ft (m)	Deceast Load	Stand

Fuel Pump Lift- ft (m)	Percent Load	Standby	
3 (1)	25%	0.6 (2.1)	
	50%	0.9 (3.5)	
Total Fuel Pump Flow (Combustion + Return) - gph (Lph)	75%	1.3 (4.8)	
16.6 (63)	100%	1.6 (6.2)	

<sup>\*</sup> Fuel supply installation must accommodate fuel consumption rates at 100% load.

# COOLING

		Standby
Air Flow (Fan Air Flow Across Radiator) - Compact	cfm (m³/min)	1,653 (46.8)
Coolant Flow	gpm (Lpm)	15.5 (58.7)
Coolant System Capacity	gal (L)	4.2 (16.0)
Heat Rejection to Coolant	BTU/hr (kW)	76,090 (22.3)
Inlet Air	cfm (m³/min)	1,714 (48.5)
Maximum Operating Ambient Temperature	°F (°C)	120 (50)
Maximum Operating Ambient Temperature (Before Derate)	See Bulletin	No. 0199280SSD
Maximum Additional Radiator Backpressure	in H <sub>2</sub> O (kPa)	0.5 (0.12)

### COMBUSTION AIR REQUIREMENTS

		otaliday
Flow at Rat	ted Power - cfm (m³/min)	61.4 (1.7)

ENGINE			EXHAUST		
		Standby			Standby
Rated Engine Speed	RPM	1,800	Exhaust Flow (Rated Output)	cfm (m <sup>3</sup> /min)	160.4 (4.5)
Horsepower at Rated kW**	hp	32.5	Maximum Allowable Backpressure	inHg (kPa)	40.9 (138.5)
Piston Speed	ft/min (m/min)	1,182 (360)	Exhaust Temperature (Rated Output)	°F (°C)	950 (510)
BMEP	osi (kPa)	105.8 (729.4)			

<sup>\*</sup> Refer to "Emissions Data Sheet" for maximum bHP for EPA and SCAQMD permitting purposes









WI FIRM 4897-11 604 FOX GLEN
BARRINGTON, IL 60010
PHONE: 847-277-0070
EMAIL: AE©Westchesterservices.com

# **JOHN M. BANKS**

ARCHITECT
604 FOX GLEN
BARRINGTON, IL 60010
TELEPHONE: 847-277-0070
FAX: 847-277-0080
EMAIL: JBANKSOWESTCHESTERSERVICES.COM

,	CH.	ECKED BY:	MC		
1	REV	DATE	DESCRIPTION		
	A	03/04/24	PRELIMINARY CD		
	В	03/06/24	PRFLIMINARY CD		

"I HEREBY CERTIFY THAT THESE PLANS WERE PREPARED BY ME OR UNDER MY DIRECT SUPERMISION AND THAT I AM A DULY REGISTERED ARCHITECT UNDER THE LAWS OF THE STATE OF WISCONSIN"


EXPIRE DATE: 06/30/25

AT&T SITE# W12696 AT&T SITE NAME: WHITEWATER FA # 11855718
SITE ADDRESS:
1002 S JANESVILLE STREET
WHITEWATER, WI 53190
FAA STUDY #: 2024—AGL—23880E

SHEET TITLE WALK UP CABINET PAD DETAILS

W.U.C. ELEVATIONS

**GENERAC DIESEL GENERATOR DETAIL: GENERAC 20KW NEQ.53187** 

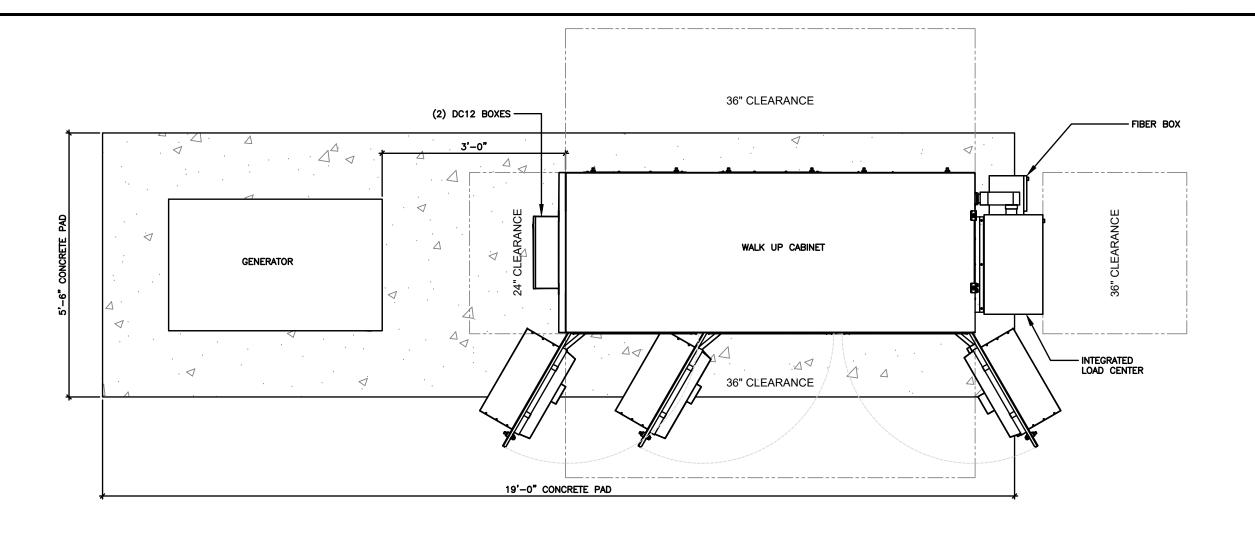









WI FIRM 4897-11 604 FOX GLEN BARRINGTON, IL 60010
PHONE: 847-277-0070
EMAIL: AE@Westchesterservices.com

# JOHN M. BANKS

DWM

MC

ARCHITECT
604 FOX GLEN
BARRINGTON, IL 60010
TELEPHONE: 847-277-0070
FAX: 847-277-0080
EMAIL: JBANKSØWESTCHESTERSERVICES.COM

DRAWN BY: CHECKED BY:


1	REV	DATE	DESCRIPTION
	A	03/04/24	PRELIMINARY CD
	В	03/06/24	PRELIMINARY CD

"I HEREBY CERTIFY THAT THESE PLANS WERE PREPARED BY ME OR UNDER MY DIRECT SUPERVISION AND THAT I AM A DULY REGISTERED ARCHITECT UNDER THE LAWS OF THE STATE OF WISCONSIN

EXPIRE DATE: 06/30/25

AT&T SITE# W12696 AT&T SITE NAME: WHITEWATER FA # 11655718 SITE ADDRESS: 1002 S JANESVILLE STREET WHITEWATER, WI 53190 FAA STUDY #: 2024-AGL-23880E

SHEET TITLE WALK UP CABINET PAD DETAILS

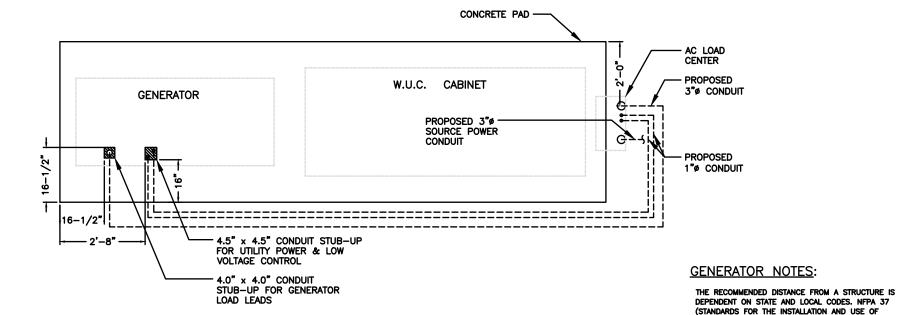

**WUC PAD LAYOUT** 

**GENERATOR INSTALLATION GUIDELINES:** 

1) EXHAUST IS AIMED AWAY FROM OR PARALLEL TO THE STRUCTURE.

ALL CONDUIT FROM BELOW GRADE TO ABOVE GRADE
MUST INCLUDE FROST SLEEVES TO PREVENT FROST

2) EXHAUST IS NOT DIRECTED AT PLAY AREAS, PATIOS OR OTHER AREAS WHERE PEOPLE CONGREGATE.

3) THE NEAREST WINDOW, VENT, DOOR OR SIMILAR STRUCTURE OPENING IS AT LEAST 5 FEET FROM THE EXHAUST END OF THE SET.

4) SET HAS PROPER OFFSET FROM STRUCTURE.

STATIONARY COMBUSTION ENGINES AND GAS TURBINES)

STATES THIS DISTANCE SHOULD BE AT LEAST 5 FEET FROM A COMBUSTIBLE MATERIAL FOR IN STALLATIONS NEAR NON-COMBUSTIBLE MATERIAL BE SURE TO LEAVE

A MINIMUM DISTANCE OF 3 FEET TO ENSURE PROPER

GENERATOR COOLING.

DAMAGE TO CONDUIT OR EQUIPMENT.

5) WINDOWS & DOORS ON ADJACENT WALLS ARE CLOSED.


6) FURNACE AND OTHER SIMILAR INTAKES ARE AT LEAST 10 FEET FROM EXHAUST END OF SET.

12" THICK CONCRETE PAD EXTENDING 6" BEYOND GENSET ON ALL SIDES.

8) WEED BARRIER & GRAVEL BED TO EXTEND 4 FT. FROM EXHAUST OUTLET. NO PLANTS, SHRUBS OR OTHER COMBUSTIBLES ALLOWED IN GRAVEL AREA.


9) SENSITIVE PLANTS, PATIO FURNITURE, ETC. ARE AT LEAST 8 FEET FROM EXHAUST END OF SET.

10) REFER TO OWNERS MANUAL FOR OTHER INSTALLATION CONSTRAINTS.

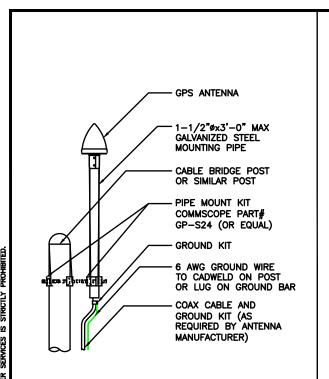


GALVANIZED PIPE CAP

(HOT DIPPED GALV.)

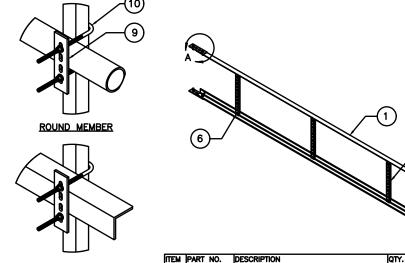

ITEM	PART NO.	DESCRIPTION	QTY.	WEIGHT
1	CL20.01	20' ANGLE SIDE RAIL	2	49.38 LBS
2	CL0620UH	HARDWARE KIT (ITEMS 3-10)	1	-
3	CL06R.01	20" LADDER RUNG	6	1.69 LBS
4	CL20H	HARDWARE KIT (ITEMS 5-7)	1	-
5	HKCLU.02	BACKING PLATE	2	0.95 LBS
6	GB-03145	3/8" X 1-1/2" GALV BOLT KIT	16	0.07 LBS
7	GWF-03	3/8" GALV FLAT WASHER	4	0.01 LBS
8	HKCLU	LADDER HARDWARE KIT (ITEMS 9-10)	2	-
9	HKCLU.02	BACKING PLATE	4	0.95 LBS
10	JB-8K	8" GALV J-BOLT	8	0.36 LBS

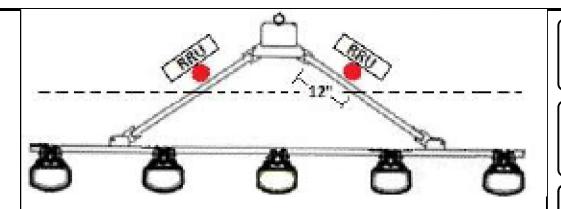

**RRH MOUNTING DETAIL** 

SCALE

3

2

FIGURE 1: A SECTOR FRAME IS SHOWN WITH A MAST PIPE (RED) ATTACHED TO THE UPPER AND LOWER STANDOFF ARMS, USING CROSSOVER PLATES.
THE MAST PIPE, USED AS AN RRU MOUNTING PIPE, IS WITHIN 12 INCHES OF THE CONNECTION POINT TO THE LEG (NOT TO SCALE). FOR MEASUREMENT PURPOSES, THE CONNECTION POINT IS CONSIDERED TO BEGIN WHERE THE STANDOFF ARM MEETS THE CONNECTION ASSEMBLY.









WI FIRM 4897-11 604 FOX GLEN BARRINGTON, IL 60010
PHONE: 847-277-0070
EMAIL: AE@Westchesterservices.com

# JOHN M. BANKS

ARCHITECT 604 FOX GLEN BARRINGTON, IL 60010 TELEPHONE: 847-277-0070
FAX: 847-277-0080
EMAIL: JBANKS@WESTCHESTERSERVICES.COM

126 147 34 DRAWN BY: DWM 16

CHECKED BY: MC DATE DESCRIPTION 03/04/24 PRELIMINARY CD 03/06/24 PRELIMINARY CD

"I HEREBY CERTIFY THAT THESE PLANS WERE PREPARED BY ME OR UNDER MY DIRECT SUPERVISION AND THAT I AM A DULY REGISTERED ARCHITECT UNDER THE LAWS OF THE STATE OF WISCONSIN

EXPIRE DATE: 06/30/25

AT&T SITE# WI2696 AT&T SITE NAME: WHITEWATER FA # 11655718 SITE ADDRESS: 1002 S JANESVILLE STREET WHITEWATER, WI 53190 FAA STUDY #: 2024-AGL-23880E

SHEET TITLE CONSTRUCTION DETAILS

GPS ANTENNA DETAIL 5 CABLE LADDER DETAIL SABRE # C20128021DP N.T.S. TIEBACK ANGLE RANGE DETAIL +/- 15 DEGREES VERTICAL +/- 25 DEGREES HORIZONTAL 'COMMSCOPE' WAVE GUIDE SUPPORT +15 DEGREES BRACKET 12" FOR SEE UPPER LEG MOUNTING DETAIL 3-1/2" O.D. -25 DEGREES +25 DEGREES LEGS #WB-LB12-3 -15 DEGREES 1/4"X4"X8" BACKER PLATE (18(19) 'COMMSCOPE' SAFETY GRATE WAVEGUIDE BRIDGE 12"WX10' #WB-CY11ø ATTACH CABLES W/STAINLESS STEEL SNAP-IN HANGERS. USE RUBBER GROMMETS AS 3-1/2" O.D. PIPE 'COMMSCOPE' PLAIN END PIPE 3.5"X192" #MT-547-192 EXOTHERMIC WELD SEE NOTE 1 -SEE LOWER LEG MOUNTING DETAIL SEE TIE BACK DETAIL GRADE #2 SOLID TINNED ISOMETRIC VIEW COPPER WIRE

DETAIL A

SCALE

4

5 C40026024 BOLT ASSEMBLY, 5/8 Ø X 2 1/4 A325 17. 2 C40034183 U-BOLT ASSEMBLY, 1/2 # X 2 15/16 C-C 1 Z30992001 MOUNT CLASSIFICATION TAG C10857001C 19. 2 C40062103 STAINLESS STEEL SELF-LOCKING CABLE TIE

12. 2 C40026073 BOLT ASSEMBLY, 1 Ø X 3 A325

13. 8 C40140004 BOLT ASSEMBLY, 5/8 Ø X 8 A307 1 C40026033 BOLT ASSEMBLY, 5/8 Ø X 4 1/2 A325

1. 2 CW01222 WELDMENT, STANDOFF ARM

9. 1 CS00098 PLATE, TIE BACK SWIVEL

10. 1 CS03285 PLATE, TIE BACK CLAMP 11. 1 CS03333 PIPE, TIE BACK

2 CW01223 WELDMENT, FACE PIPE

2 CS03109 PLATE, ROTATING
1 CS03110 PLATE, PIVOTING (UPPER)

CS03111 PLATE, LEG CLAMP (UPPER)

CS03112 PLATE, PIVOTING (LOWER)

CS03113 PLATE, LEG CLAMP (LOWER)

12 C40026025 BOLT ASSEMBLY, 5/8 # X 2 1/2 A325

CS03114 PLATE, LEG CLAMP (BACK)

### PACKAGING NOTE

ITEM QTY. PART NO.

CK00386 INCLUDES ITEMS 1, 3, 4, 5, 6, 7, 12 & 15 (8 QTY) CK00387-HDW INCLUDES ITEMS 8, 9, 10, 13, 14, 15 (4 QTY), 16, 17, 18 & 19 CK00387-STL INCLUDES ITEMS 2 & 11

C10857001C 12' HD V-BOOM ASSEMBLY W/TIEBACK

DESCRIPTION

### **INSTALLATION NOTES:**

- 1. INSTALL MOUNT TO TOWER AS SHOWN, SO THAT WELDED STANDOFF DIAGONAL IS SLOPING DOWNWARD FROM TOWER END TO FACE PIPE END.
  2. UPPER PIVOTING PLATE (ITEM 4) HAS THREE HOLES ON EACH SIDE AND UPPER LEG CLAMP PLATE (ITEM 5) HAS TWO HOLES ON EACH SIDE FOR TAPER ADJUSTMENT.

  3. INSTALL PRODUCT EXACTLY AS SHOWN IN DRAWING, WITH ALL BOLTS FACING UPWARDS.

	Sabre Industries	TOLERANCES DO NOT APPLY TO RAW MATERIAL	NCLUDE N INCHES	ARE IN ACTIONS GLES ±		F
1	CONFIDENTIAL			_	$\overline{}$	
ı	This document and the information			_	$\overline{}$	$\dashv$
ட	contained herein is the confidential trade					
	secret property of Sabre Communications			—	-	Н
╙	Corporation ("Sabre") and must not be reproduced, copied or used, in whole or in	YACING NOTE	REVISED PACE	FER	04/11/17 K	4
DA'	part, for any purpose without the prior	ALLATION MOTES	LIADOED INSTA	LEIDEL	10/19/18 IK	3
DR/	written consent of Sobre	AGING NOTE	JADDED PACK	WIDEL	02/05/16 D	2
	written consent of Sabre. © 2015 Sabre Communications Corporation.	es & added Tieback angle range Detail	REVISED NOTE	LE EK	01/21/16 K	1
CHI	All rights reserved.	DESCRIPTION	d	RWICHK	DATE D	REV

(16" DEG. TOLERANCES DO NOT APPLY TO RAW MATERIAL	Sabre Industries	12'
	CONFIDENTIAL This document and the information	
	contained herein is the confidential trade secret property of Sabre Communications Corporation ("Sabre") and must not be	
PACKAGING NOTE INSTALLATION NOTES	reproduced, copied or used, in whole or in part, for any purpose without the prior	DATE

HD V-BOOM ASSEMBLY W/TIEBACK (3' STANDOFF) W/NO ANTENNA MOUNTING PIPES

SCALE

N.T.S.

TOTAL WEIGHT

2

17

14

17

14

38

3

3

1

1

462

•							
•			SIZE		WING NO.		REV
in	DATE	12/22/15	В	C108	3570010	7	4
_	DRAWN BY	WRF			SCALE	P	AGE
m.	CHECKED BY	EK			None	1 1 7	OF 3

SCALE

'COMMSCOPE' VERTICAL Z-BRAKCET 4.3" FOR 12 COAX CABLE RUNS #ZB-V12 SURPLUS HYBRID CABLE SHALL BE STORED ABOVE MAIN LINE CABLES DOME TOP FOR DRAINAGE 요품호 MINIMUM 4000 PSI MIN. OR J DEPT CONCRETE 12"ø MIN.


18"ø MAX


ICE BRIDGE DETAIL

ANTENNA FRAME DETAIL (FOR REFERENCE ONLY)

1. MOUNTING PIES & CONSOVER PATER NTS MOST BE PORTASED SPARKTELT.
2. QUANTITIES SHOWN IN LISTS OF MATERIAL ARE FOR ONE (1) V-BOOM ONLY.
3. THIS V-BOOM WILL MOUNT TO THE FOLLOWING: 1 1/2"ø TO 5 9/16"ø ROUND LEG.
4. TIEBACK MUST BE CONNECTED TO A RIGID MEMBER THAT PROVIDES ADEQUATE SUPPORT WITHIN THE LIMITS NOTED ABOVE IN THE TIEBACK ANGLE RANGE DETAIL UNLESS APPROVED BY THE ENGINEER OF RECORD.

1. MOUNTING PIPES & CROSSOVER PLATE KITS MUST BE PURCHASED SEPARATELY.

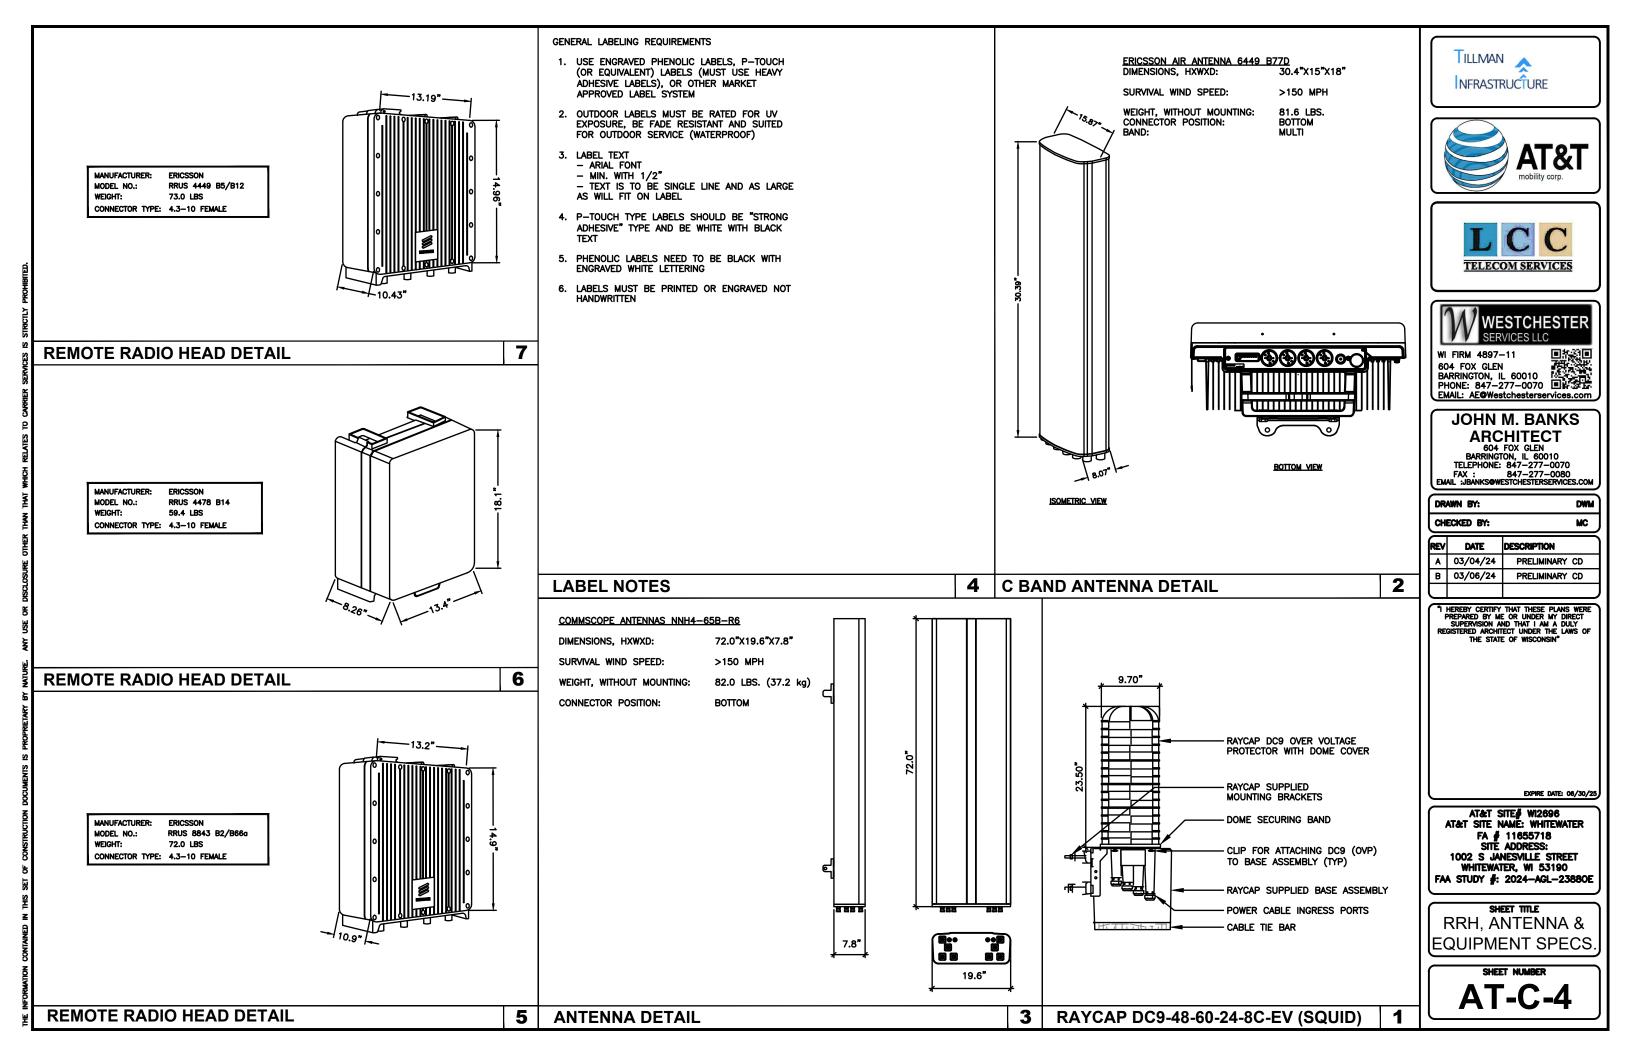

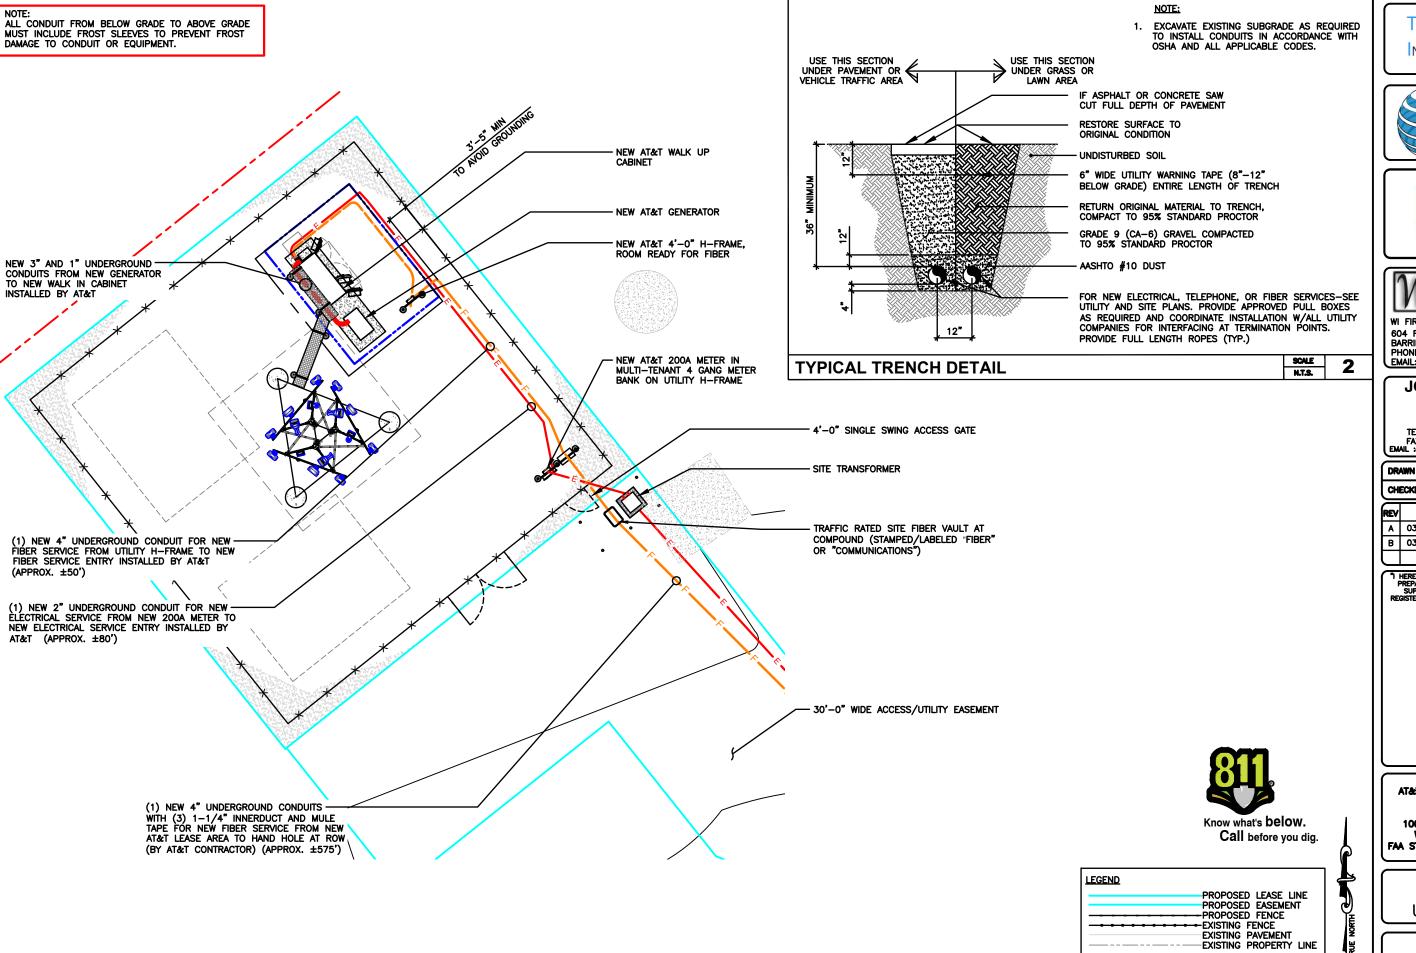

TILLMAN NFRASTRUCTURE







WI FIRM 4897-11 604 FOX GLEN

BARRINGTON, IL 60010
PHONE: 847-277-0070
EMAIL: AE©Westchesterservices.com

# JOHN M. BANKS

ARCHITECT
604 FOX GLEN
BARRINGTON, IL 60010
TELEPHONE: 847-277-0070
FAX: 847-277-0080
EMAIL: JBANKSØWESTCHESTERSERVICES.COM

DWM

MC

DRAWN BY: CHECKED BY:

-	RE	/ DATE	DESCRIPTION
1	Α	03/04/24	PRELIMINARY CD
1	В	03/06/24	PRELIMINARY CD
-	C		


"I HEREBY CERTIFY THAT THESE PLANS WERE PREPARED BY ME OR UNDER MY DIRECT SUPERVISION AND THAT I AM A DULY REGISTERED ARCHITECT UNDER THE LAWS OF THE STATE OF WISCONSIN

EXPIRE DATE: 06/30/25

AT&T SITE# W12696 AT&T SITE NAME: WHITEWATER FA # 11655718 SITE ADDRESS: 1002 S JANESVILLE STREET WHITEWATER, WI 53190 FAA STUDY #: 2024-AGL-23880E

> SHEET TITLE **ENLARGED UTILITY PLAN**

0 2' 4' 8' SCALE: 1/8" = 1'-0" (24x36) (OR) 1/16" = 1'-0" (11x17)

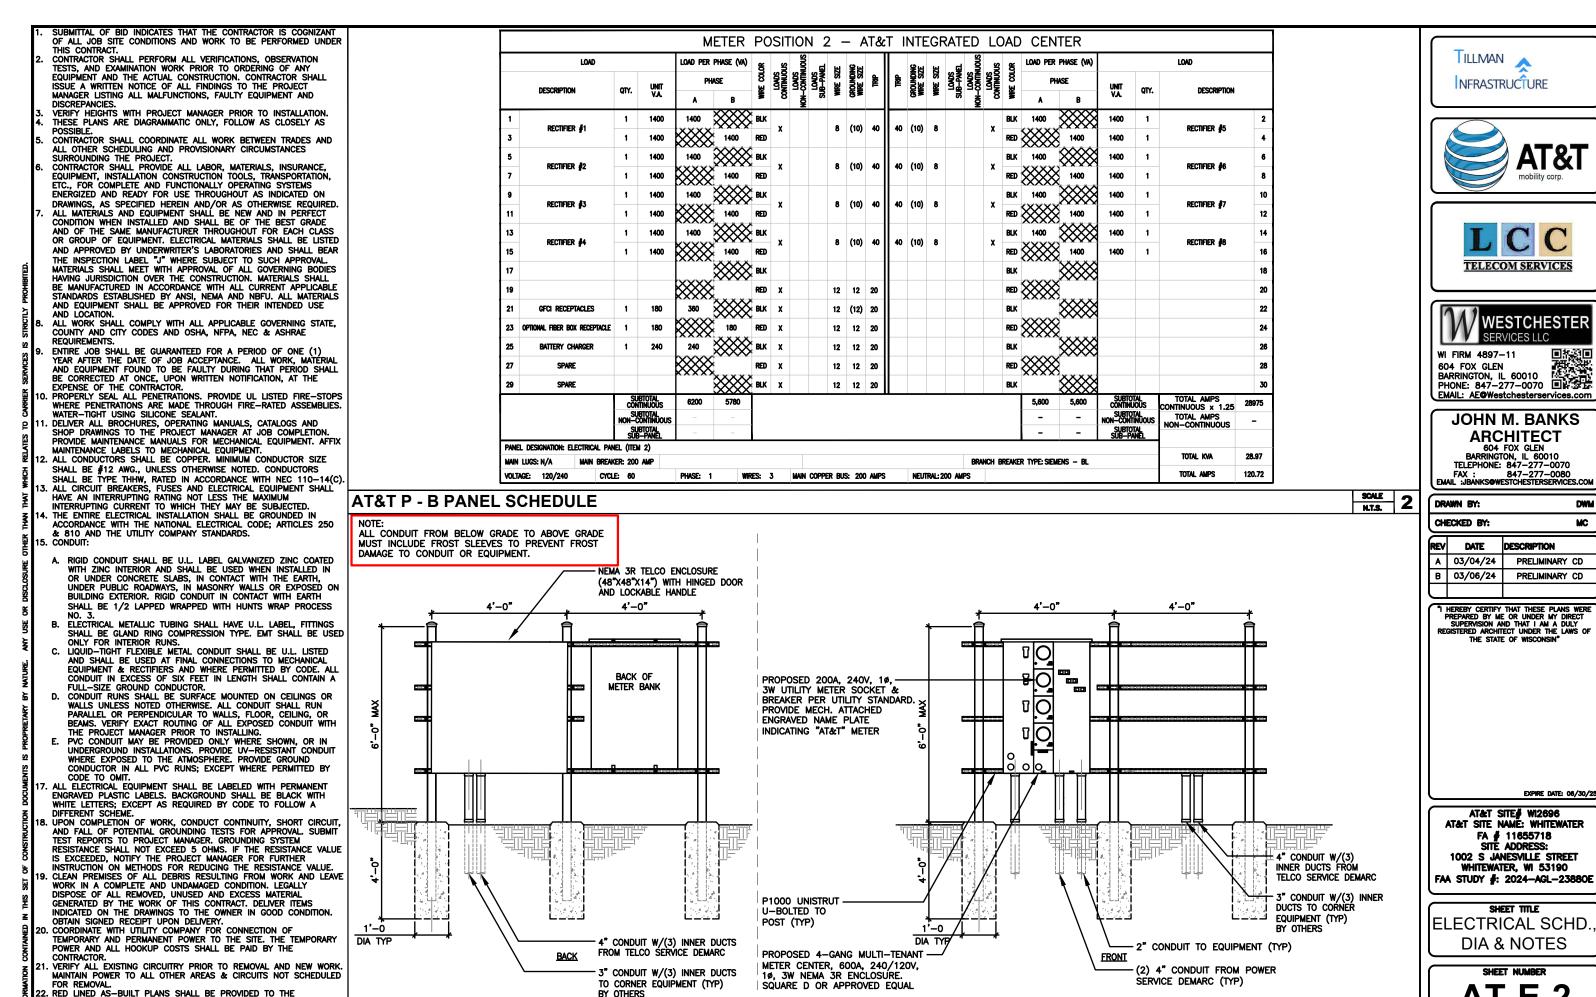


CONSTRUCTION MANAGER

**ELECTRICAL NOTES** 

N.T.S.

UTILITY FRAME DETAIL

SCALE 1

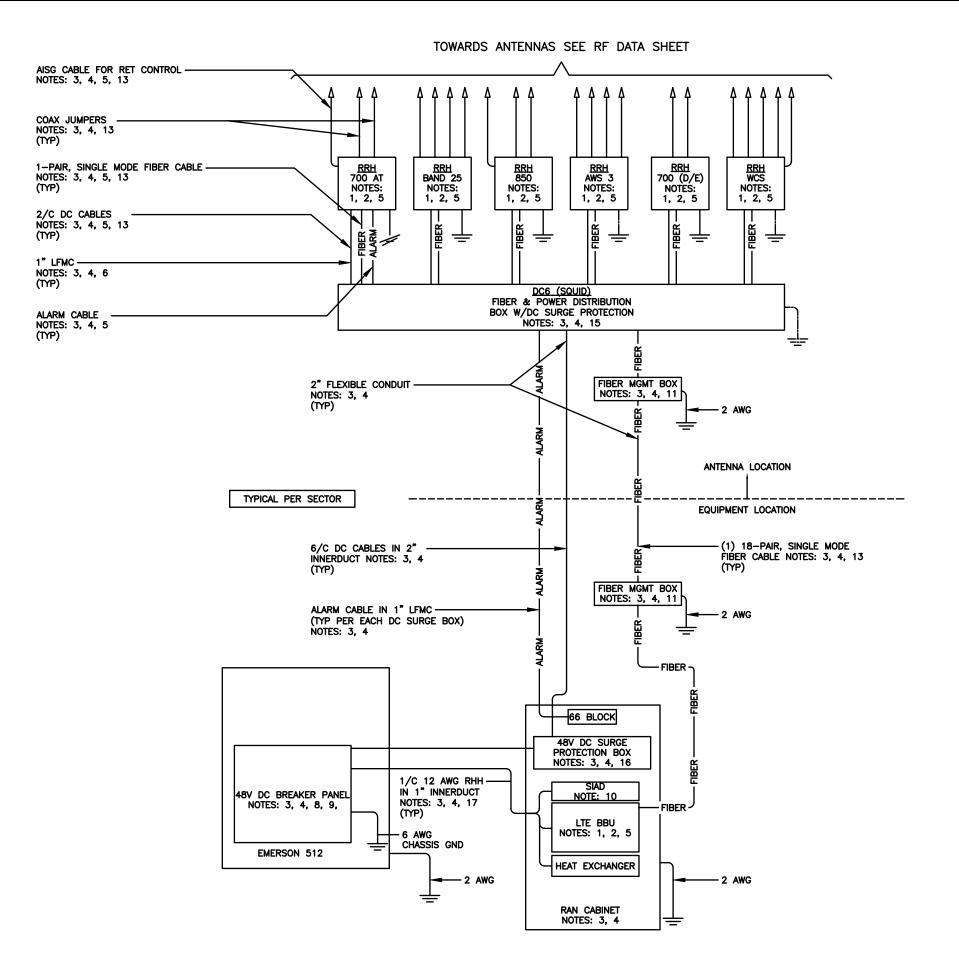

# NOTES:

- 1. FURNISHED BY OEM/AT&T.
- 2. INSTALLED BY OEM OR AS SCOPED BY MARKET.
- 3. FURNISHED BY OTHERS
- 4. INSTALLED BY OTHERS
- 5. FINAL CONNECTION BY OEM OR AS SCOPED BY MARKET.
- 6. OPEN END OF LFMC TO BE LEFT WEATHERPROOFED UNTIL TERMINATED.
- 7. DELETED.
- 8. BREAKERS SPECIFIED SOLD SEPERATELY.
- 9. BREAKERS TO BE TAGGED AND LOCKED OUT.
- 10. SIAD IS FURNISHED AND INSTALLED BY OTHERS AND INCLUDES POWER CONNECTIONS AND FIBER TO THE UNIT OR AS SCOPED BY MARKET. INSTALL 10 AWG CHASSIS GROUND, PROVIDE (2) 10A BREAKERS FROM A 24V DC POWER SOURCE OR (2) 5A BREAKERS FROM A 48V DC POWER SOURCE AND CONNECT USING MFR POWER CABLE WITH SPECIAL CONNECTOR.
- 11.FIBER MANAGEMENT BOX IS J-SOURCE MODEL 12126FM4SEC.
- 12.LEC TO FURNISH AND INSTALL NETWORK INTERFACE DEVICE.
- 13.LEAVE COILED AND PROTECTED UNTIL TERMINATED.
- 14.SEE DETAIL 1408 FOR DC POWER CABLE SIZES.
- 15.FIBER AND POWER DISTRIBUTION BOX 4/48V SURGE SHALL BE RAYCAP MODEL DC6-48-60-18-8F.
- 16.POWER DISTRIBUTION W/DC SURGE PROTECTION BOX SHALL BE RAYCAP MODEL DC6-48-60-0-18.
- 17.SINGLE-CONDUCTOR DC POWER CABLES SHALL BE TELCOFLEX OR KS24194, COPPER, UL LISTED RHH NON-HALOGEN, LOW SMOKE WITH BRAIDED COVER, TYPE TC (1/0 AND LARGER). UNLESS OTHERWISE NOTED, STRANDING SHALL BE CLASS B (TYPE III) FOR CABLES SIZES 14, 12 & 10 AWG AND CLASS 1 (TYPE IV) FOR SIZES 8 AWG AND LARGER. CABLES SHALL BE COLOR CODED RED FOR +244, BLUE FOR -48V AND GRAY FOR 24V AND 48V RETURN CONDUCTORS. MULTI-CONDUCTOR DC POWER CABLES SHALL COPPER, CLASS B STRANDED WITH FLAME RETARDANT PVC JACKET, TYPE TC, UL LISTED FOR 90°C DRY/ 75°C WET INSTALLATION.
- 18.10A FUSE FOR HEAT EXCHANGER FURNISHED AND INSTALLED BY OTHERS.
- 19.DELETED
- 20.GROUNDING WIRES SHALL BE COPPER, GREEN THHN/THWN UL LISTED FOR 90°C DRY/75°C WET INSTALLATION. MINIMUM SIZE IS 6 AWG UNLESS NOTED OTHERWISE.
- 21.RET CONTROL FROM THE RRH IS AN OPTIONAL METHOD OF CONNECTION. REFER TO RF DATA SHEET FOR APPLICABILITY.
- 22.DELETED.
- 23.FIBER AND POWER DISTRIBUTION BOX 4/48V SURGE SHALL BE RAYCAP MODEL DC6-48-60-0-1E.
- 24.FIBER MANAGEMENT BOX IS COMMSCOPE MODEL FB 18188.
- 25.FIBER AND POWER DISTRIBUTION BOX 4/48V SURGE SHALL BE RAYCAP MODEL DC12-48-60-0-25E.









WI FIRM 4897-11
604 FOX GLEN
BARRINGTON, IL 60010
PHONE: 847-277-0070
EMAIL: AE©Westchesterservices.com

### JOHN M. BANKS ARCHITECT 604 FOX GLEN BARRINGTON, IL 60010

604 FOX GLEN
BARRINGTON, IL 60010
TELEPHONE: 847-277-0070
FAX: 847-277-0080
EMAIL: JBANKSOWESTCHESTERSERVICES.COM

CHECKED BY: MC

REV DATE DESCRIPTION

A 03/04/24 PRELIMINARY CD

03/06/24

"I HEREBY CERTIFY THAT THESE PLANS WERE PREPARED BY ME OR UNDER MY DIRECT SUPERVISION AND THAT I AM A DULY REGISTERED ARCHITECT UNDER THE LAWS OF THE STATE OF WISCONSIN"

PRELIMINARY CD

EXPIRE DATE: 06/30/25

AT&T SITE# W12696
AT&T SITE NAME: WHITEWATER
FA # 11655718
SITE ADDRESS:
1002 S JANESVILLE STREET
WHITEWATER, W1 53190
FAA STUDY #: 2024-AGL-23880E


SHEET TITLE DC/FIBER SYSTEM DIAGRAM


SHEET NUMBER


DC/FIBER SYSTEM DIAGRAM

SCALE N.T.S.

- 1

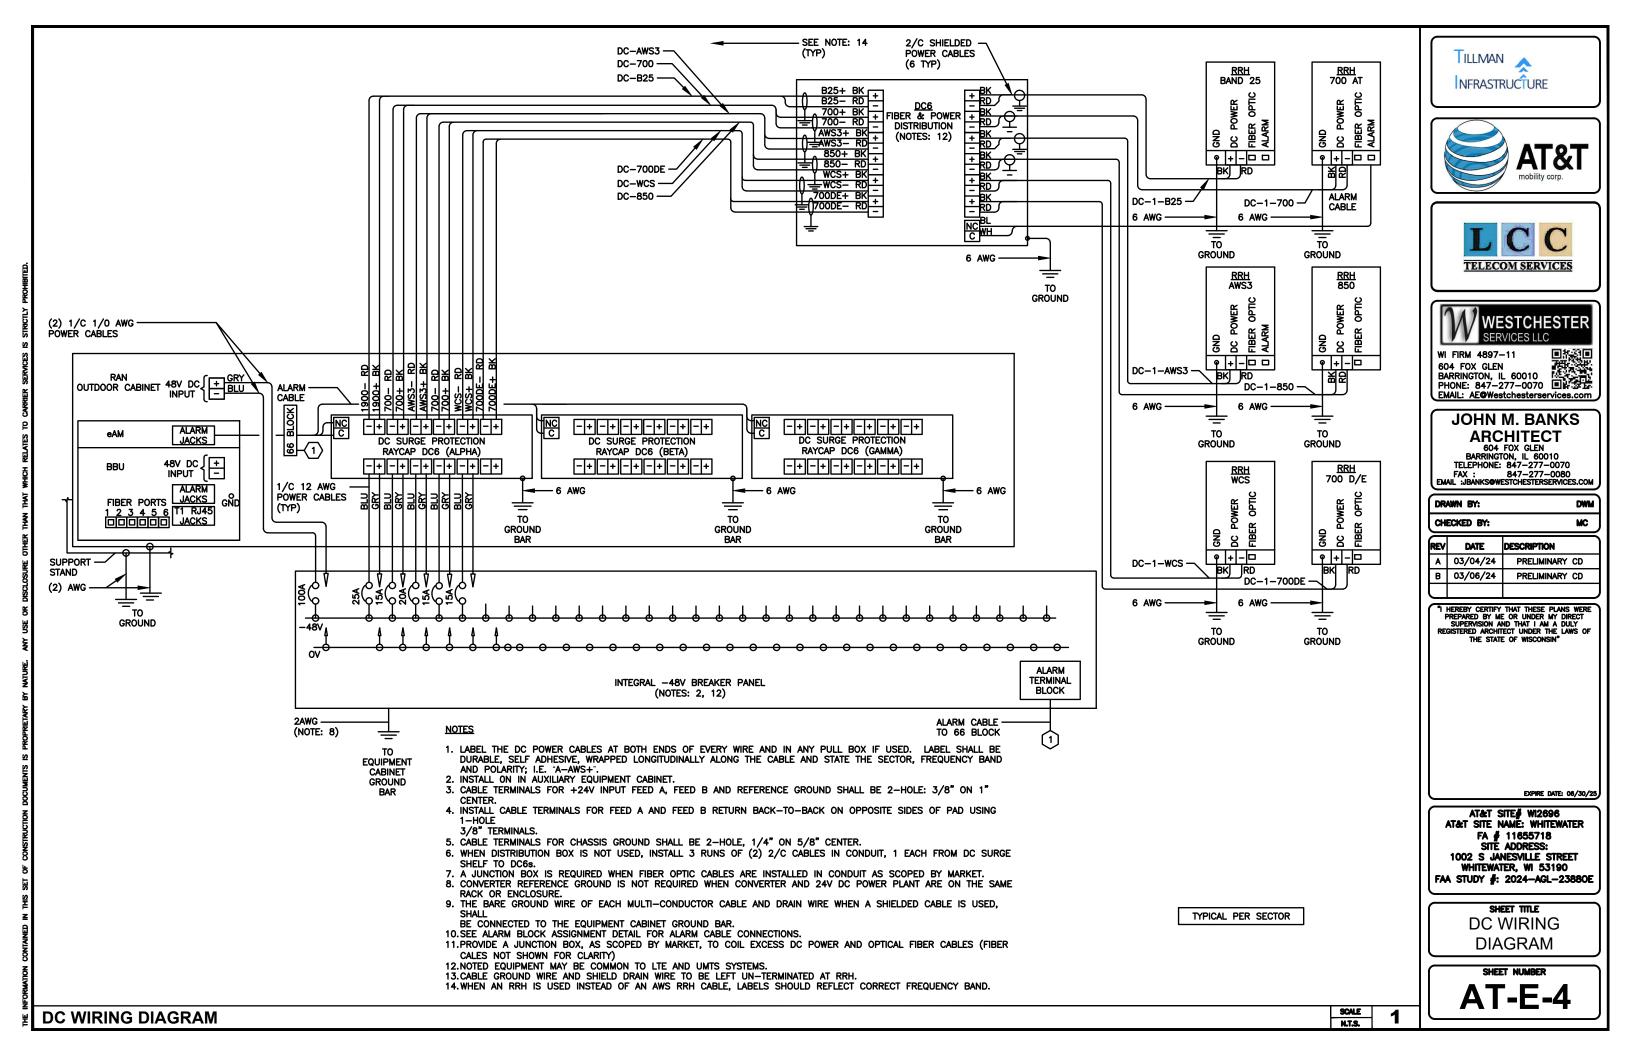

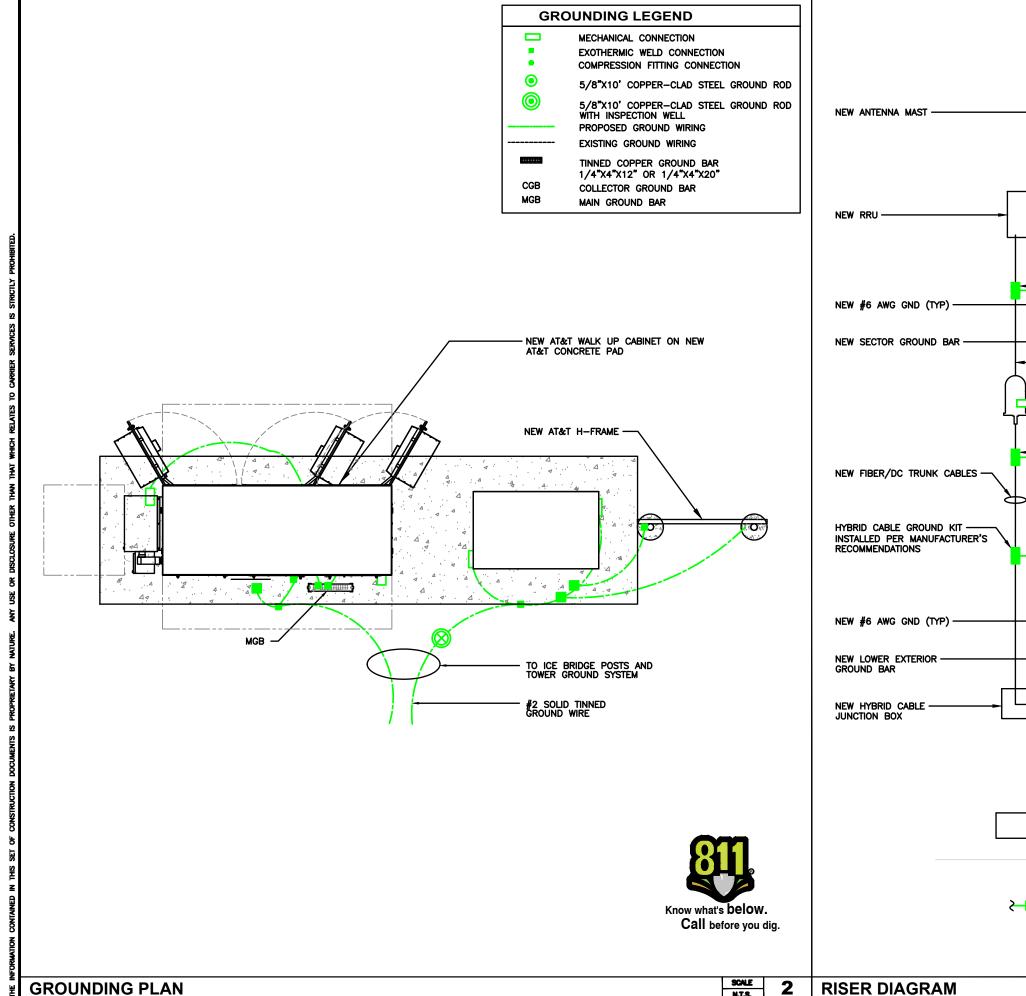

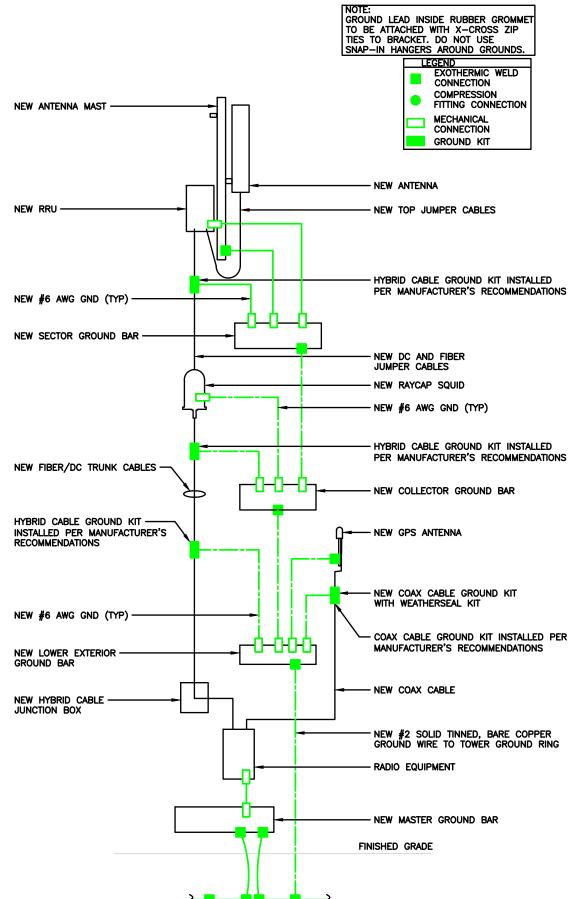









604 FOX GLEN BARRINGTON, IL 60010
PHONE: 847-277-0070
EMAIL: AE@Westchesterservices.com

# JOHN M. BANKS

ARCHITECT
604 FOX GLEN
BARRINGTON, IL 60010
TELEPHONE: 847-277-0070
FAX: 847-277-0080
EMAIL: JBANKSOWESTICHESTERSERVICES.COM

DWM

	CHECKED BY:			MC
		REV	DATE	DESCRIPTION
		A	03/04/24	PRELIMINARY CD
	ш	Ω	03/06/24	PRELIMINARY CD

DRAWN BY:

"I HEREBY CERTIFY THAT THESE PLANS WERE PREPARED BY ME OR UNDER MY DIRECT SUPERVISION AND THAT I AM A DULY REGISTERED ARCHITECT UNDER THE LAWS OF THE STATE OF WISCONSIN

EXPIRE DATE: 06/30/25

AT&T SITE# W12696 AT&T SITE NAME: WHITEWATER FA # 11655718 SITE ADDRESS: 1002 S JANESVILLE STREET WHITEWATER, WI 53190 FAA STUDY #: 2024-AGL-23880E

SHEET TITLE **GROUNDING PLAN** & RISER DIAGRAM

**RISER DIAGRAM** 

# GROUNDING NOTES:

- GROUNDING SHALL COMPLY WITH ARTICLE 250 OF THE NATIONAL ELECTRICAL CODE.
- ALL GROUNDING DEVICES SHALL BE U.L. APPROVED OR LISTED FOR THEIR INTENDED USE.
- ALL WIRES SHALL BE AWG THHN/THWN COPPER UNLESS NOTED OTHERWISE.
- GROUNDING CONNECTIONS TO GROUND RODS, GROUND RING WIRE, TOWER BASE AND FENCE POSTS SHALL BE EXOTHERMIC ("CADWELDS") UNLESS NOTED OTHERWISE. CLEAN SURFACES TO SHINY METAL. WHERE GROUND WIRES ARE CADWELDED TO GALVANIZED SURFACES, SPRAY CADWELD WITH GALVANIZING PAINT.
- GROUNDING CONNECTIONS TO GROUND BARS ARE TO BE TWO-HOLE BRASS MECHANICAL CONNECTORS WITH STAINLESS STEEL HARDWARE (INCLUDING SCREW SET) CLEAN GROUND BAR TO SHINY METAL.
  AFTER MECHANICAL CONNECTION, TREAT WITH PROTECTIVE
  ANTIOXIDANT COATING.
- GROUND COAXIAL CABLE SHIELDS AT BOTH ENDS WITH MANUFACTURER'S GROUNDING KITS.
- ROUTE GROUNDING CONDUCTORS THE SHORTEST AND STRAIGHTEST PATH POSSIBLE. BEND GROUNDING LEADS WITH A MINIMUM 12" RADIUS.
- INSTALL #2 AWG GREEN-INSULATED STRANDED WIRE FOR ABOVE GRADE GROUNDING AND #2 BARE TINNED COPPER WIRE FOR BELOW GRADE GROUNDING UNLESS OTHERWISE NOTED.
- REFER TO GROUNDING PLAN FOR GROUND BAR LOCATIONS. GROUNDING CONNECTIONS SHALL BE EXOTHERMIC TYPE ("CADWELDS") TO ANTENNA MOUNTS AND GROUND RING, REMAINING GROUNDING CONNECTIONS SHALL BE COMPRESSION FITTINGS.
  CONNECTIONS TO GROUND BARS SHALL BE MADE WITH TWO—HOLE
- 10. THE GROUND ELECTRODE SYSTEM SHALL CONSIST OF DRIVEN GROUND RODS POSITION ACCORDING TO GROUNDING PLAN. THE GROUND RODS SHALL BE 5/8"X10"-0" COPPER CLAD STEEL INTERCONNECTED WITH #2 BARE TINNED COPPER WIRE BURIED 36" BELOW GRADE. BURY GROUND RODS A MAXIMUM OF 15' APART, AND A MINIMUM OF 8' APART.
- IF ROCK IS ENCOUNTERED GROUND RODS SHALL BE PLACED AT AI OBLIQUE ANGLE NOT TO EXCEED 45°.
- 12. EXOTHERMIC WELDS SHALL BE MADE IN ACCORDANCE WITH ERICO PRODUCTS BULLETIN A-AT.
- 13. CONSTRUCTION OF GROUND RING AND CONNECTIONS TO EXISTING GROUND RING SYSTEM SHALL BE DOCUMENTED WITH PHOTOGRAPHS PRIOR TO BACKFILLING SITE. PROVIDE PHOTOS TO THE VERIZON WIRELESS CONSTRUCTION MANAGER.
- 4. ALL GROUND LEADS EXCEPT THOSE TO THE EQUIPMENT ARE TO BE #2 BARE TINNED COPPER WIRE. ALL EXTERIOR GROUND BARS TINNED COPPER.
- 5. PRIOR TO INSTALLING LUGS ON GROUND WIRES, APPLY THOMAS & BETTS KOPR-SHIELD (TM OF JET LUBE INC.). PRIOR TO BOLTING GROUND WIRE LUGS TO GROUND BARS, APPLY KOPR-SHIELD OR
- 16. ENGAGE AN INDEPENDENT ELECTRICAL TESTING FIRM TO TEST AND VERIFY THAT IMPEDANCE DOES NOT EXCEED FIVE OHMS TO GROUND BY MEANS OF "FALL OF POTENTIAL TEST". TEST SHALL BE WITNESSED BY A METROPCS REPRESENTATIVE, AND RECORDED ON THE "GROUND RESISTANCE TEST" FORM.
- WHERE BARE COPPER GROUND WIRES ARE ROUTED FROM ANY CONNECTION ABOVE GRADE TO GROUND RING, INSTALL WIRE IN 3/4" PVC SLEEVE, FROM 6" ABOVE AND BELOW GRADE/ GRAVEL AND SEAL TOP WITH SILICONE MATERIAL.
- 9. ANY SITE WHERE THE EQUIPMENT (BTS, CABLE BRIDGE, PPC, GENERATOR, ETC.) IS LOCATED WITHIN 6 FEET OF METAL FENCING THE GROUND RING SHALL BE BONDED TO THE NEAREST FENCE POST USING (3) RUNS OF #2 BARE TINNED COPPER WIRE.


8. PREPARE ALL BONDING SURFACES FOR GROUNDING CONNECTIONS BY REMOVING ALL PAINT AND CORROSION DOWN TO SHINY METAL FOLLOWING CONNECTION, APPLY APPROPRIATE ANTI-OXIDIZATION


# CABLE COLOR CODING NOTES:


- SECTOR ORIENTATION/AZIMUTH WILL VARY FROM REGION AND IS SITE SPECIFIC. REFER TO RF REPORT FOR EACH SITE TO DETERMINE THE ANTENNA LOCATION AND FUNCTION OF EACH TOWER SECTOR FACE.
- THE ANTENNA SYSTEM CABLES SHALL BE LABELED WITH VINYL TAPE EXCEPT IN LOCATIONS WHERE ENVIRONMENTAL CONDITIONS CAUSE PHYSICAL DAMAGE, THEN PHYSICAL TAGS ARE PREFERRED.
- THE STANDARD IS BASED ON EIGHT COLORED TAPES RED, BLUE, GREEN, YELLOW, ORANGE, BROWN, WHITE & VIOLET. THESE TAPES MUST BE 3/4" WIDE & UV RESISTANT SUCH AS SCOTCH 35 VINYL ELECTRICAL COLOR CODING TAPE AND SHOULD BE READILY AVAILABLE TO THE ELECTRICIAN OR SUBCONTRACTOR ON SITE.
- USING COLOR BANDS ON THE CABLES, MARK ALL RF CABLES BY SECTOR AND NUMBER AS SHOWN ON "CABLE MARKING COLOR CONVENTION TABLE".
- WHEN AN EXISTING COAXIAL LINE THAT IS INTENDED TO BE A WHEN AN EXISTING COAXIAL LINE THAT IS INTENDED TO BE A SHARED LINE BETWEEN GSM/3G AND IS—136 TDMA IS ENCOUNTERED, THE SUBCONTRACTOR SHALL REMOVE THE EXISTING COLOR CODING SCHEME AND REPLACE IT WITH THE COLOR CODING AND TAGGING STANDARD THAT IS OUTLINED IN THE CURRENT VERSION OF ND—00027. IN THE ABSENCE OF AN EXISTING COLOR CODING TAGGING SCHEME, OR WHEN INSTALLING PROPOSED COAXIAL CABLES, THIS GUIDELINE SHALL BE IMPLEMENTED AT THAT SITE PEGARDIES OF TECHNOLOGY.
- all color code tape shall be 3m-35 and shall be a minimum or (3) wraps of tape and shall be neatly trimmed and smoothed out so as to avoid unrayeling.
- ALL COLOR BANDS INSTALLED AT THE TOP OF TOWER SHALL BE A MINIMUM OF  $3^{\ast}$  WIDE AND SHALL HAVE A MINIMUM OF  $3/4^{\ast}$  OF SPACE IN BETWEEN EACH COLOR.
- ALL COLOR CODES SHALL BE INSTALLED AS TO ALIGN NEATLY WITH ONE ANOTHER FROM SIDE TO SIDE.
- IF EXISTING CABLES AT THE SITE ALREADY HAVE A COLOR CODING SCHEME AND THEY ARE NOT INTENDED TO BE REUSED OR SHARED WITH THE GSM TECHNOLOGY, THE EXISTING COLOR CODING SCHEME

### CABLE MARKING TAGS:

When using the alternative labeling method, each RF cable shall be identified with a metal id tag made of stainless steel or brass. The tag shall be  $1-1/2^{\circ}$  in diameter with  $1/4^{\circ}$  stamped letters and numbers indication the sector, antenna position and cable number. Id marking locations should be as per "cable marking locations table". The tag should be ATTACHED WITH CORROSION PROOF WIRE AROUND THE CABLE AT THE SAME LOCATION AS DEFINED ABOVE. THE TAG SHOULD BE LABELED AS SHOWN ON THE "GSM AND UMTS LINE TAG" DETAIL.

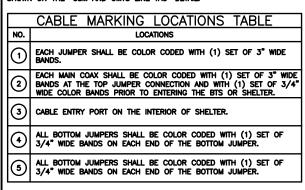

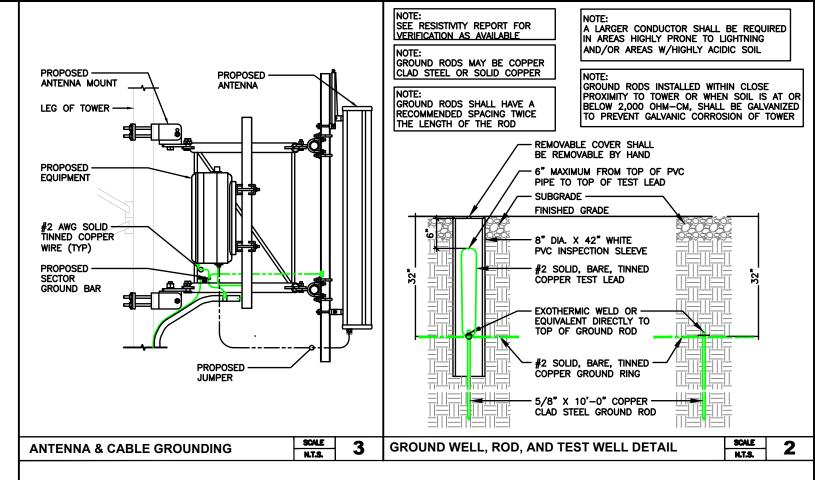

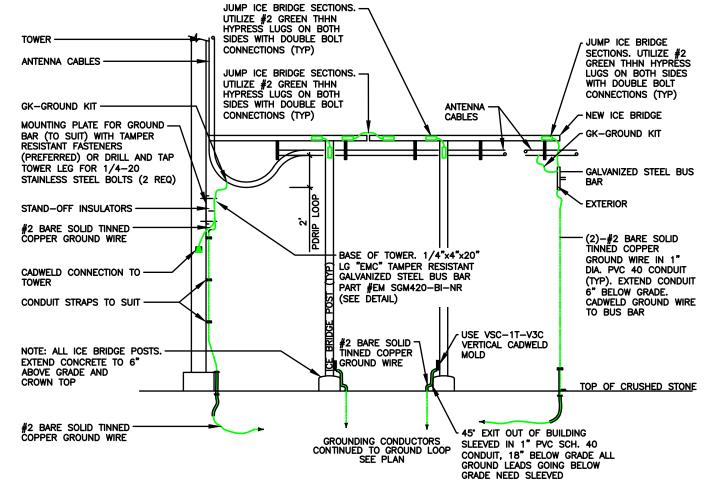









604 FOX GLEN BARRINGTON, IL 60010 PHONE: 847-277-0070 EMAIL: AE@Westchesterservices.com

# JOHN M. BANKS **ARCHITECT**

604 FOX GLEN BARRINGTON, IL 60010 TELEPHONE: 847-277-0070 FAX: 847-277-0080 EMAIL: JBANKS@WESTCHESTERSERVICES.COM

**DWM** 

CHECKED BY: MC REV DATE DESCRIPTION 03/04/24 PRELIMINARY CD

DRAWN BY:

03/06/24

THEREBY CERTIFY THAT THESE PLANS WERE PREPARED BY ME OR UNDER MY DIRECT SUPERMISION AND THAT I AM A DULY REGISTERED ARCHITECT UNDER THE LAWS OF THE STATE OF WISCONSIN

PRELIMINARY CD

EXPIRE DATE: 06/30/25

AT&T SITE# WI2696 AT&T SITE NAME: WHITEWATER FA # 11655718 SITE ADDRESS: 1002 S JANESVILLE STREET WHITEWATER, WI 53190 FAA STUDY #: 2024-AGL-23880E

SHEET TITLE **GROUNDING** DETAILS & NOTES

GROUNDING NOTES

5

SCALE

**CABLE COLOR CODING NOTES** 

SCALE

4

**COAXIAL GROUNDING AT ICE BRIDGE**