

GILBANK CONSTRUCTION, INC.

GENERAL CONTRACTORS

Commercial • Industrial • Residential

P.O. BOX 718 • 301 SCOT DRIVE • CLINTON, WISCONSIN 53525-0718

Established 1965

To: City of Whitewater
Att: Dan Buckingham
Re: 2nd Floor Municipal Offices
Date: 01/27/2025

Dan,

Thank you for allowing us the opportunity to submit a proposal for the following work at 312 West Whitewater Street. Following is a complete quote and scope of work.

Note:

- Normal working hours assumed.
- No abatement or contaminated materials removal/disposal included.
- I have only included work clarified in the scope below and the drawings attached
- Unforeseen conditions not listed below would be handled as approved change orders to the scope below.
- Final schedule to be determined after receipt of order.
- Permit by owner

Division 01 00 00 General Conditions

- Site Coordination
- Inspections through final occupancy
- Temporary restroom facilities
- Dumpsters and disposal
- Construction cleaning and final cleaning

Division 02 00 00 Demolition

- Removal of door from adjacent office

Division 07 00 00 Building Envelope

- Batt insulation for sound reduction in walls

Division 08 00 00 Openings

- (1) new man door
- (1) door re-used from adjacent office space

Division 09 00 00 Finishes

- Steel stud framing of (2) new office spaces per plans
- Gypsum patchwork in existing office following removal of 3070 door
- Gypsum in new offices

- Paint will be by owner
- Drop ceiling adjustments in new office spaces to accommodate wall construction

Division 23 00 00 Mechanical

- Furnish and install (1) GRD
- Relocate (1) GRD
- No plan approval fees included if necessary

Division 26 00 00 Electrical

- Demo existing electrical for new wall
- Relocate existing light fixtures
- Provide and install (2) light switches
- Provide and install (4) duplex receptacles fed from local circuit
- Provide and install (2) data rough-ins
- No plan approval fees included if necessary

Total estimated cost... \$29,674.00

Owner acceptance

Signature: _____ Date: _____

Proposal valid for 15 days

Sincerely,

Russ Tabaka

Gilbank Construction, Inc.

Consultant:

GENERAL PLAN NOTES

- ALL INTERIOR PARTITION TYPES ARE TYPE 6 UNLESS OTHERWISE NOTED.
- DO NOT SCALE DRAWINGS - USE GIVEN DIMENSIONS. NOTIFY ARCHITECT IF ADDITIONAL INFORMATION IS REQUIRED. ALL DIMENSIONS ARE GIVEN TO FACE OF WALL (---) OR CENTERLINE (---). ALL WALL THICKNESS DIMENSIONS ARE NOMINAL - SEE WALL SECTIONS AND PARTITION TYPE SECTIONS FOR EXACT CONSTRUCTION.
- SEE DRAWING 5.05 FOR PARTITION TYPES INDICATED ON THIS DRAWING.
- ALL PITCHED FLOOR AREAS SHOWN WITH FITCH LINES SHALL SLOPE AT 1/4" PER FOOT UNLESS OTHERWISE NOTED. PROVIDE A SLAB DEPRESSION AT ALL FLOOR DRAINS WHERE FITCH LINES ARE NOT SHOWN ON PLANS.
- ALL CMU WALLS SHALL BE RUNNING BOND EXCEPT WHERE OTHERWISE NOTED.
- DOOR FRAMES IN MASONRY CONSTRUCTION SHALL BE LOCATED ON THE SIDE OF THE WALL TOWARD THE ROOM WHICH THE DOOR SWINGS INTO UNLESS NOTED OTHERWISE.
- SITE ELEVATION 8710 = BUILDING ELEVATION 100'-0".
- SEE DRAWING 1.02 FOR REFERENCE PLAN INDICATING FIRE RATED PARTITIONS AND SPACES. ALL MECHANICAL, ELECTRICAL AND PLUMBING PENETRATIONS THROUGH FIRE RATED CONSTRUCTION SHALL BE SLEEVED AND FIRESTOPPED AND/OR HAVE FIRE DAMPERS EQUIVALENT TO THE HOURLY FIRE RATINGS OF THE CONSTRUCTION.
- SEE DRAWINGS 5.20 AND 5.21 FOR CASEWORK ELEVATIONS.
- SEE DRAWINGS 6.01 THROUGH 6.03 FOR REFLECTED CEILING PLANS.
- SEE DRAWING 5.21 FOR INTERIOR ELEVATIONS AT CONFERENCE ROOMS 201 AND 230.

SPECIFIC PLAN NOTES

- FIRE EXTINGUISHER CABINET
- COAT ROD & SHELF. SEE DETAIL 10/5.23.
- FUR OUT AROUND COLUMNS WITH 1 5/8" METAL STUDS AND 5/8" GIBS TYPICAL.
- ALIGN WITH DOOR 216A
- LADDER TO ROOF HATCH. SEE DETAIL 3/5.15.
- ALIGN PARTITION ON COLUMN CENTERLINE.
- LINE OF CANOPY BELOW
- AREA OF RESCUE ASSISTANCE.
- FUR OUT AROUND ROOF DRAIN PIPE WITH PARTITION TYPE 6, 1 HOUR RATED.
- TRENCH DRAIN. SEE PLUMBING DRAWINGS.

8-29-96 ISSUED FOR BIDDING


Date	Issuance/Revisions	Symbol

WHITEWATER MUNICIPAL BUILDING
ALTERATIONS & ADDITIONS


WHITEWATER, WISCONSIN

SECOND FLOOR AND APPARATUS ROOM PLANS

Project Number: 9501700	Sheet No. 52
Drawn By: FJC	

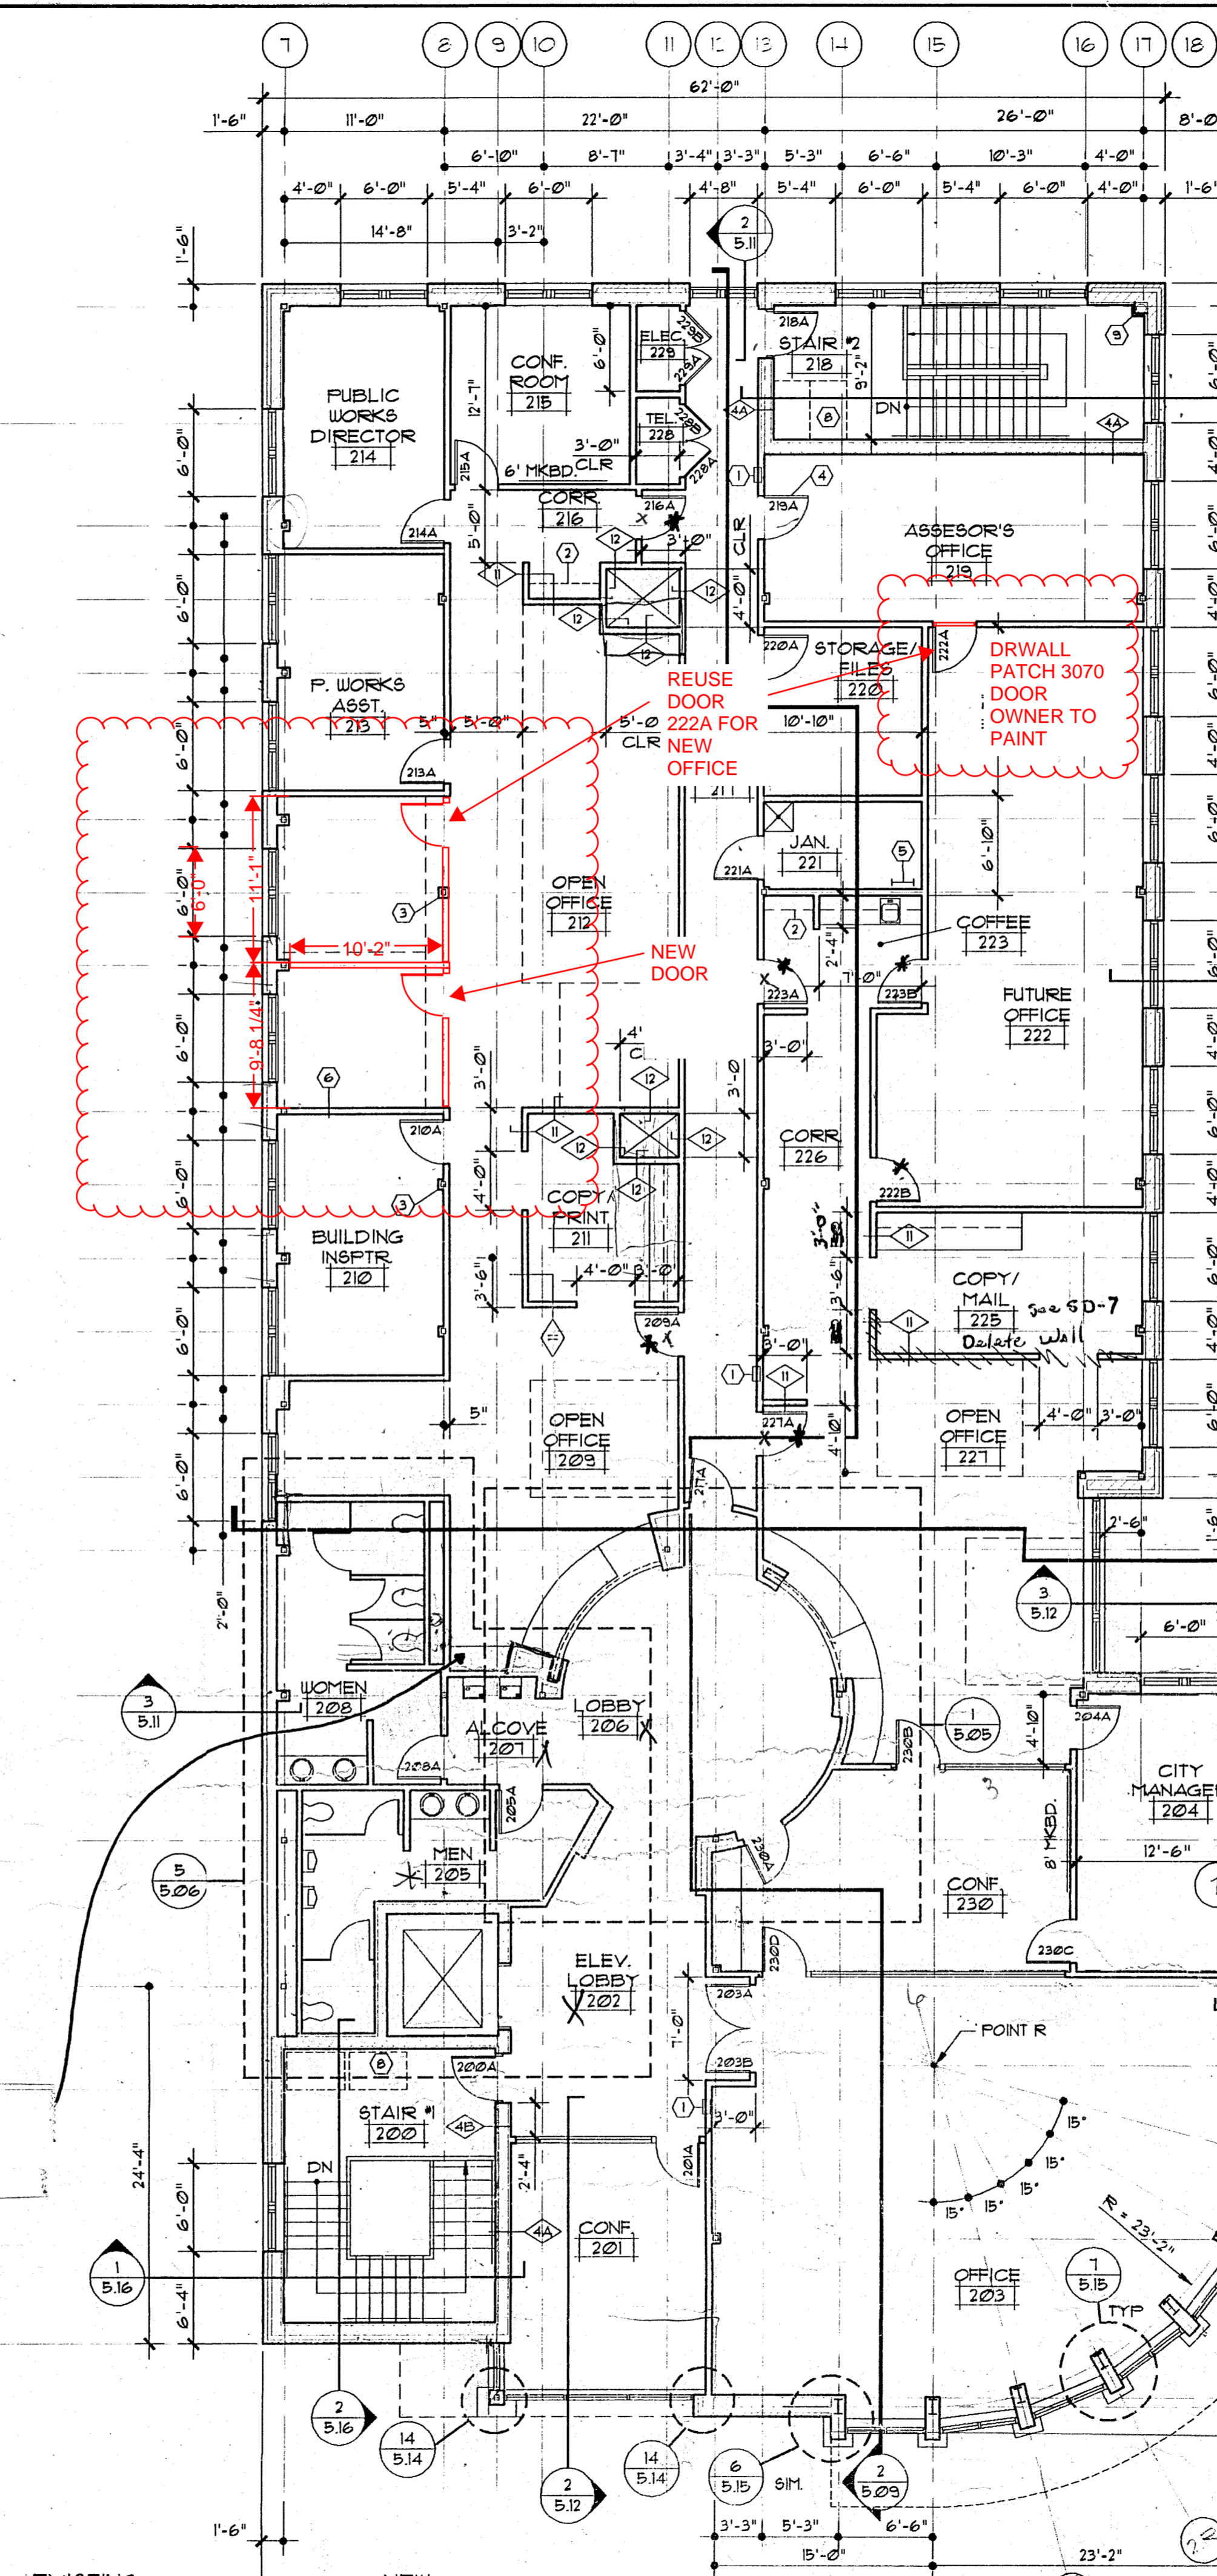

1 SECOND FLOOR PLAN
5.03 1/8" = 1'-0"

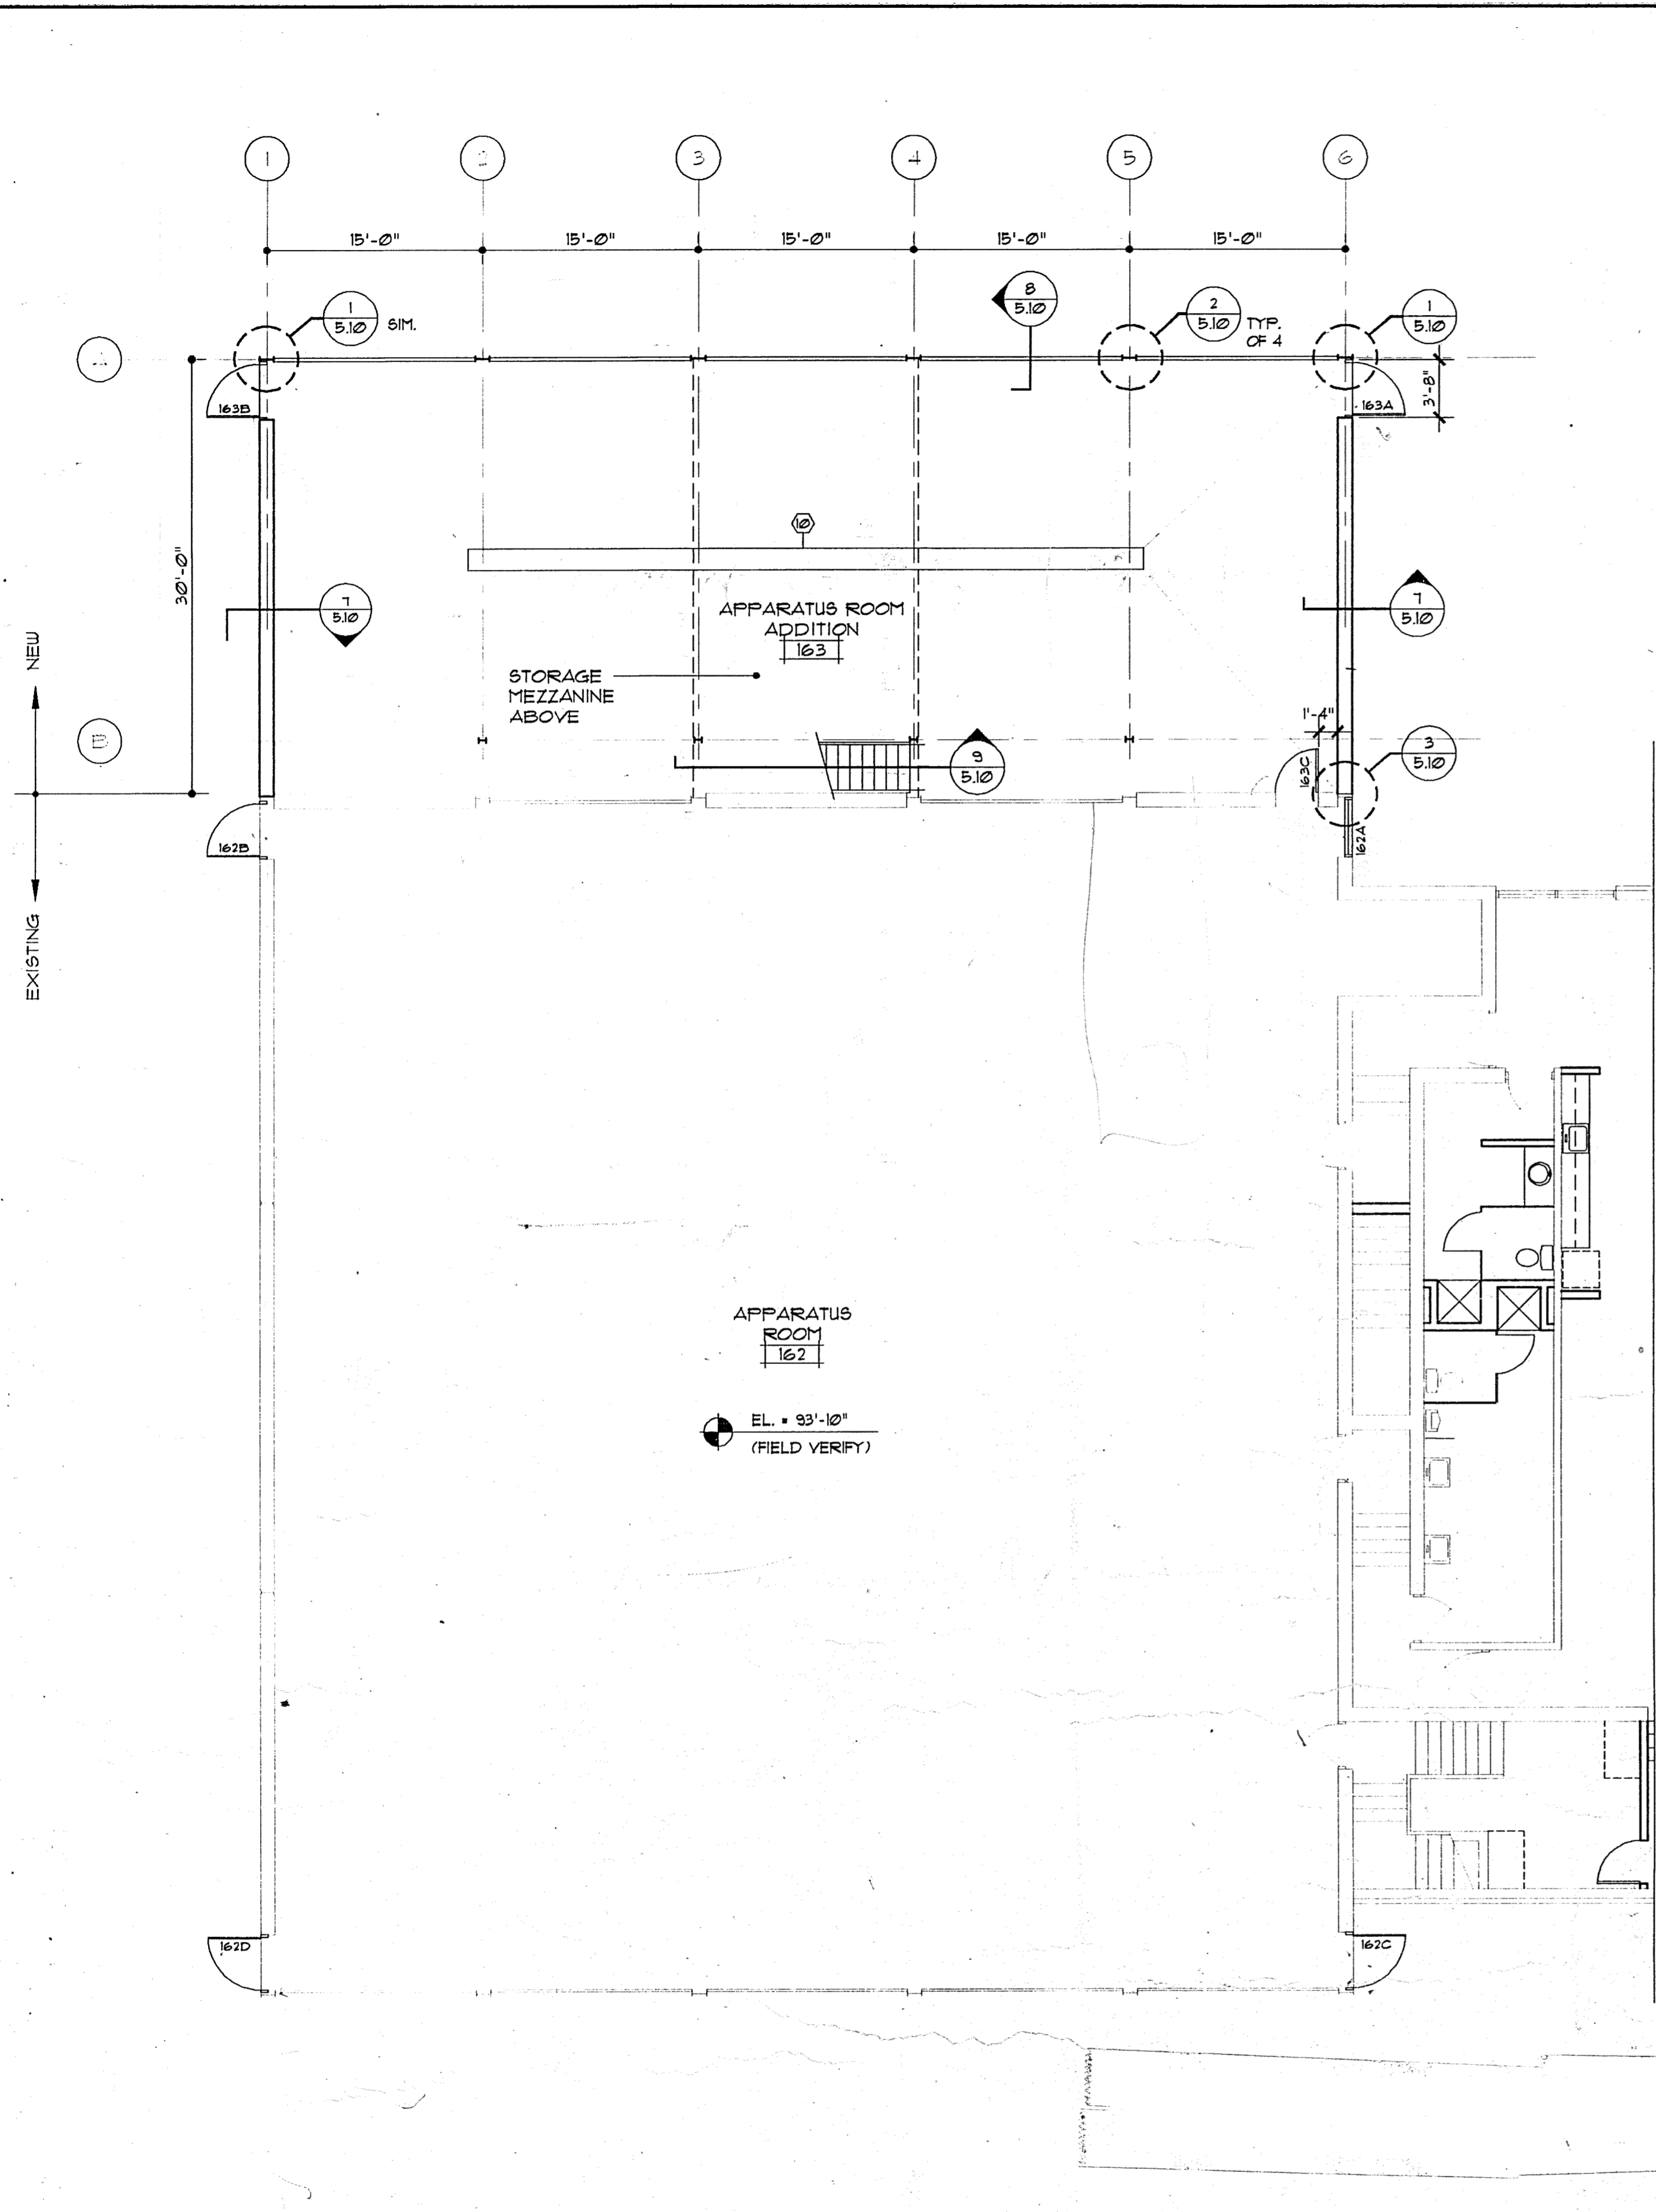
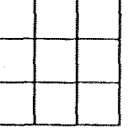
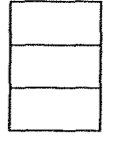

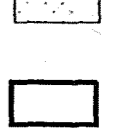
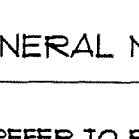


2 APPARATUS ROOM PLAN
5.03 1/8" = 1'-0"

PROJECT NAME: WHITEWATER MUNICIPAL BUILDING
PROJECT NUMBER: 950700
FILE NAME: 957-503

Consultant:

KEY TO CEILING SYMBOLS

-  CEILING HEIGHT ABOVE FINISH FLOOR
-  2 X 2 LAY-IN PANEL CEILING. CEILING CODE C1 (SEE ROOM FINISH SCHEDULE)
-  2 X 4 LAY-IN PANEL CEILING. CEILING CODE C2 (SEE ROOM FINISH SCHEDULE)
-  GUEB CEILING
-  E.I.F.S.
-  LIGHT FIXTURE (SEE ELECTRICAL DRAWINGS)

GENERAL NOTES

1. REFER TO ROOM FINISH SCHEDULE FOR CEILING TYPES AND CEILING HEIGHTS AT ROOMS WHICH ARE NOT INDICATED ON THESE DRAWINGS.
2. CEILING GRID LINES ARE SHOWN FOR LAYOUT PURPOSES ONLY. REFER TO ELECTRICAL DRAWINGS FOR LOCATIONS OF LIGHT FIXTURES AND OTHER ELECTRICAL EQUIPMENT NOT SHOWN ON THESE DRAWINGS. REFER TO MECHANICAL DRAWINGS FOR LOCATIONS OF DIFFUSERS AND OTHER MECHANICAL EQUIPMENT NOT SHOWN ON THESE DRAWINGS.


PLAN NOTES

1. SKYLIGHT. VERIFY RADIUS OF GUEB SOFFIT IN FIELD. SEE DETAIL 1/5/15 FOR SKYLIGHT CURB DETAIL.
2. SEE DRAWINGS 1/5/05 FOR LOCATION OF CENTER POINT OF ARCS.


8/23/96 ISSUED FOR BIDDING		
Date	Issuance/Revisions	Symbols

WHITEWATER MUNICIPAL BUILDING ALTERATIONS & ADDITIONS
WHITEWATER, WISCONSIN


Drawing Title: SECOND FLOOR REFLECTED CEILING PLAN	
Project Number: 9501100	Sheet No. 6.03
Drawn By: FJC	

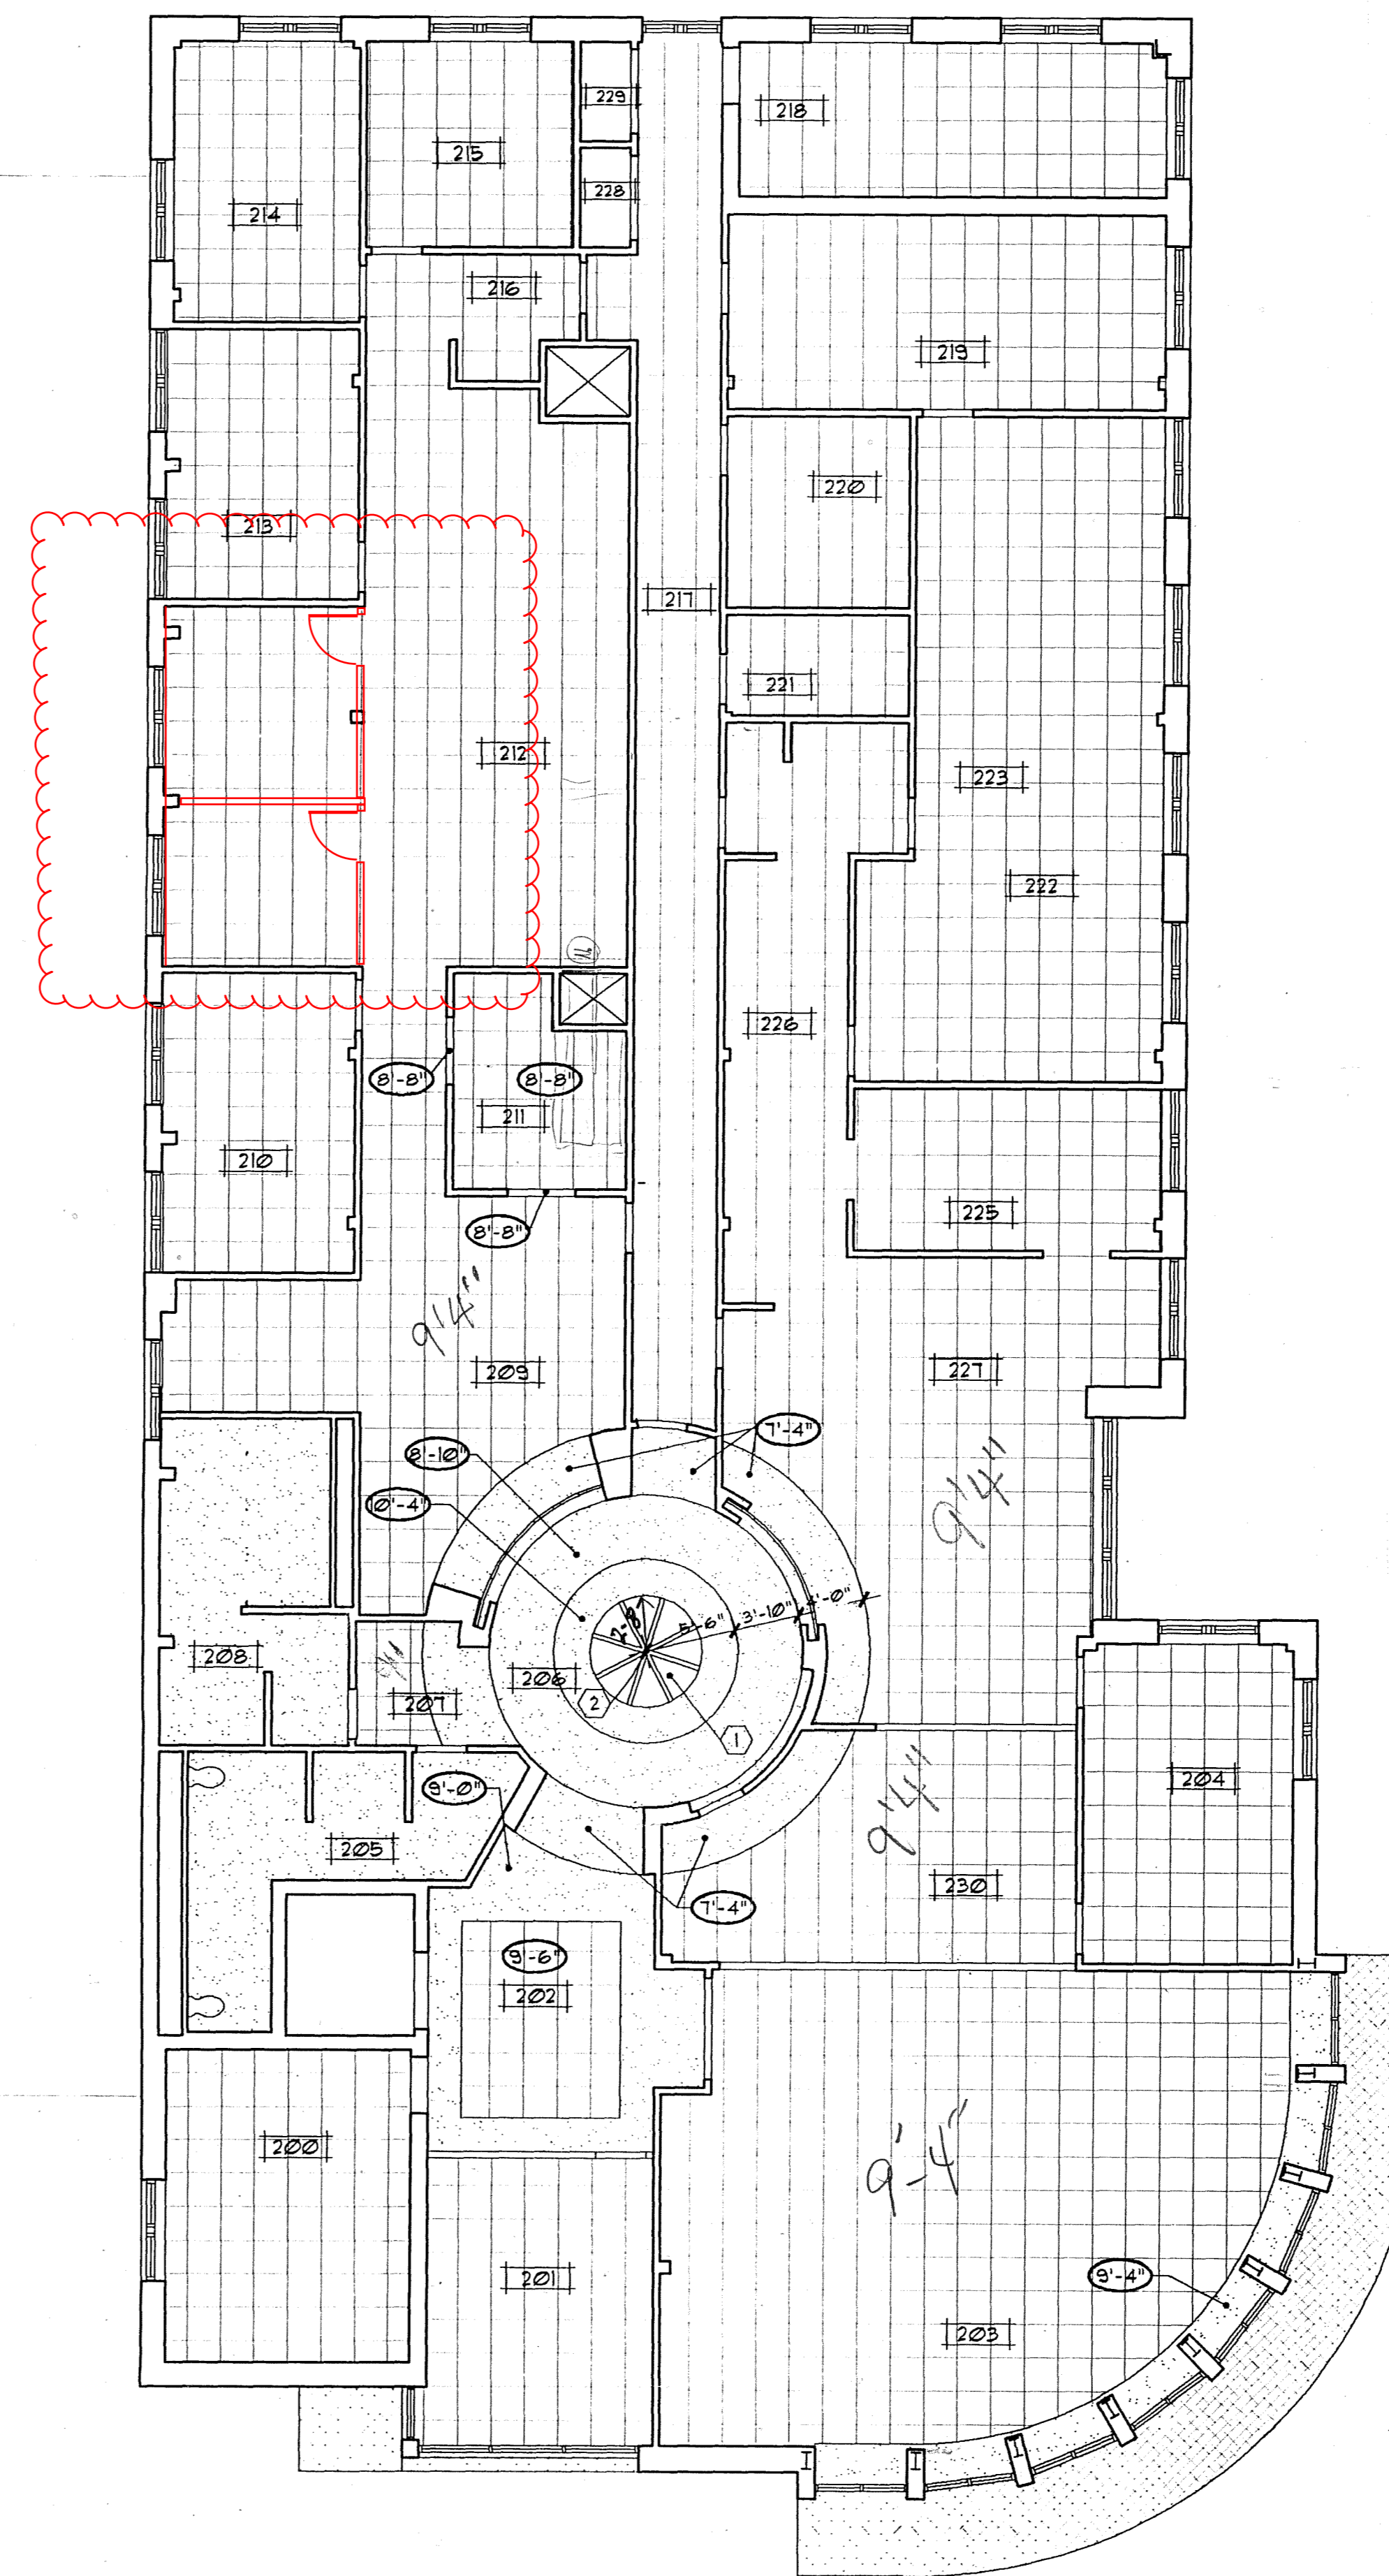

1
6.03 1/8" = 1'-0"
NORTH

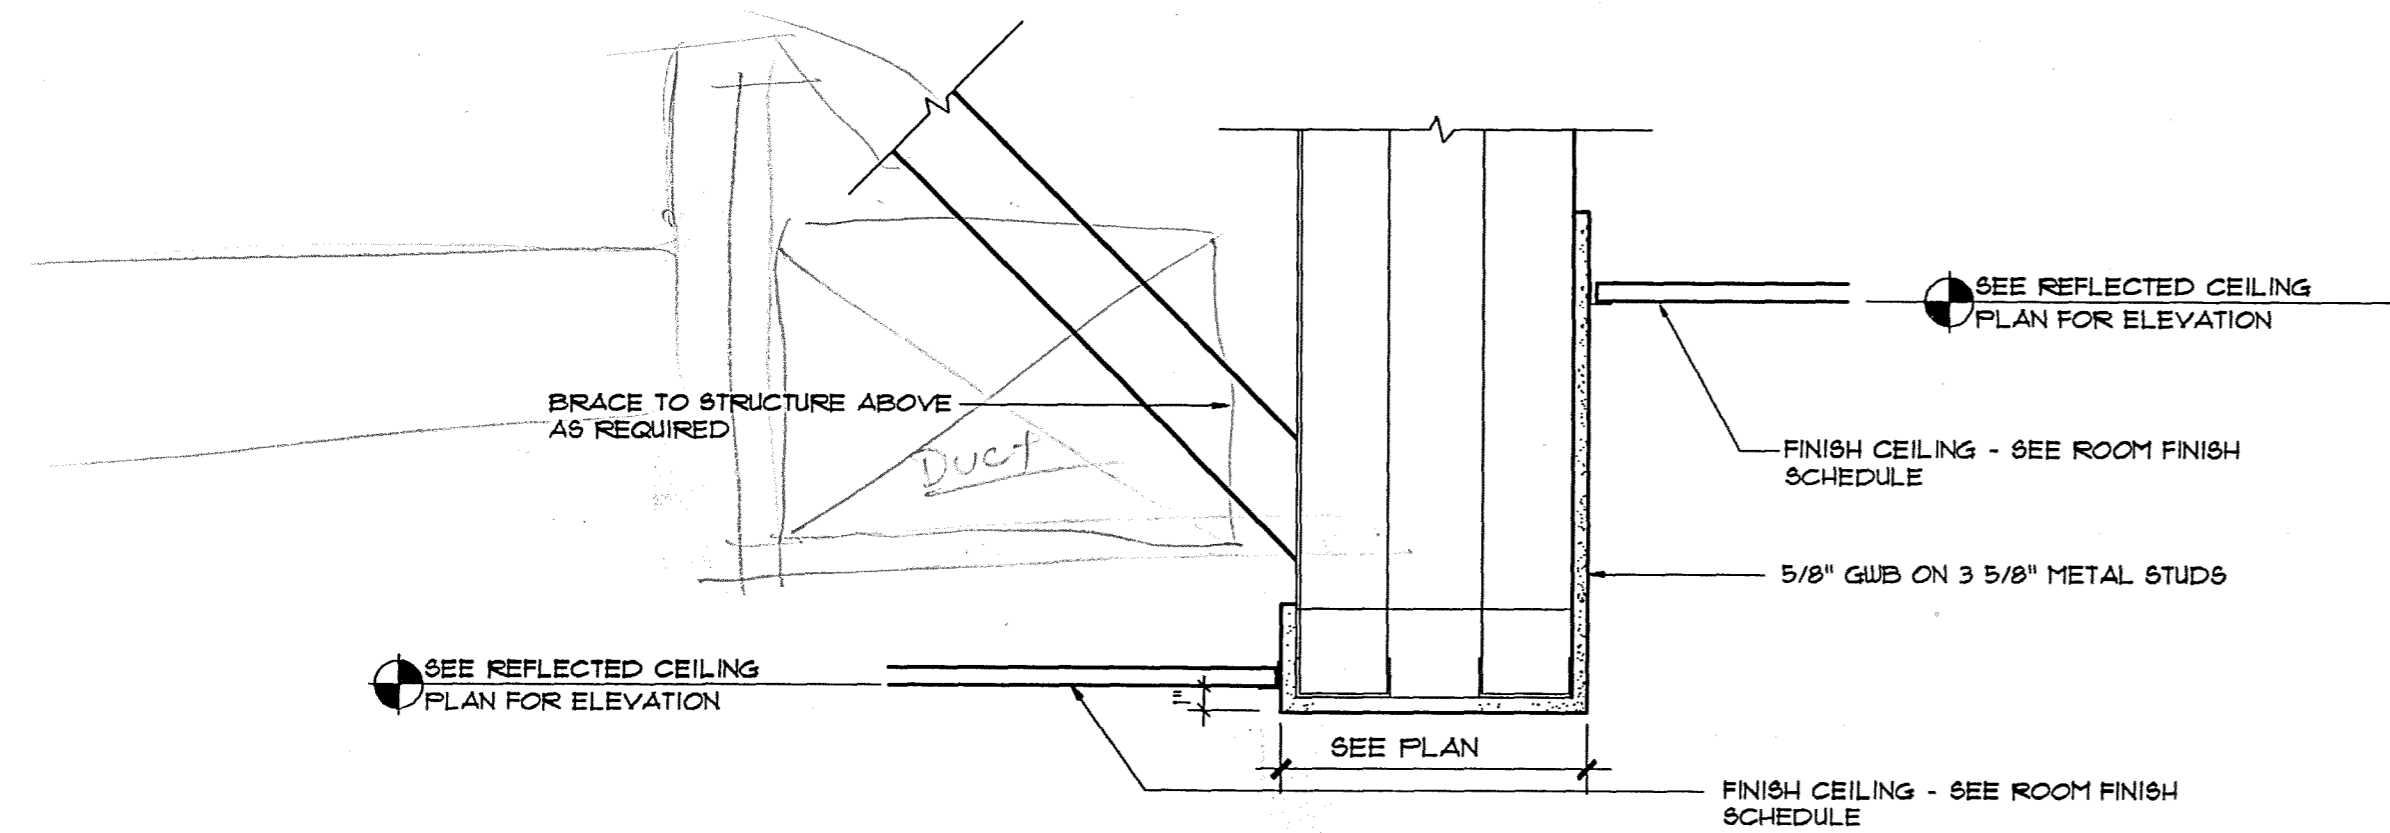

2
6.03 1 1/2" = 1'-0"
SOFFIT DETAIL

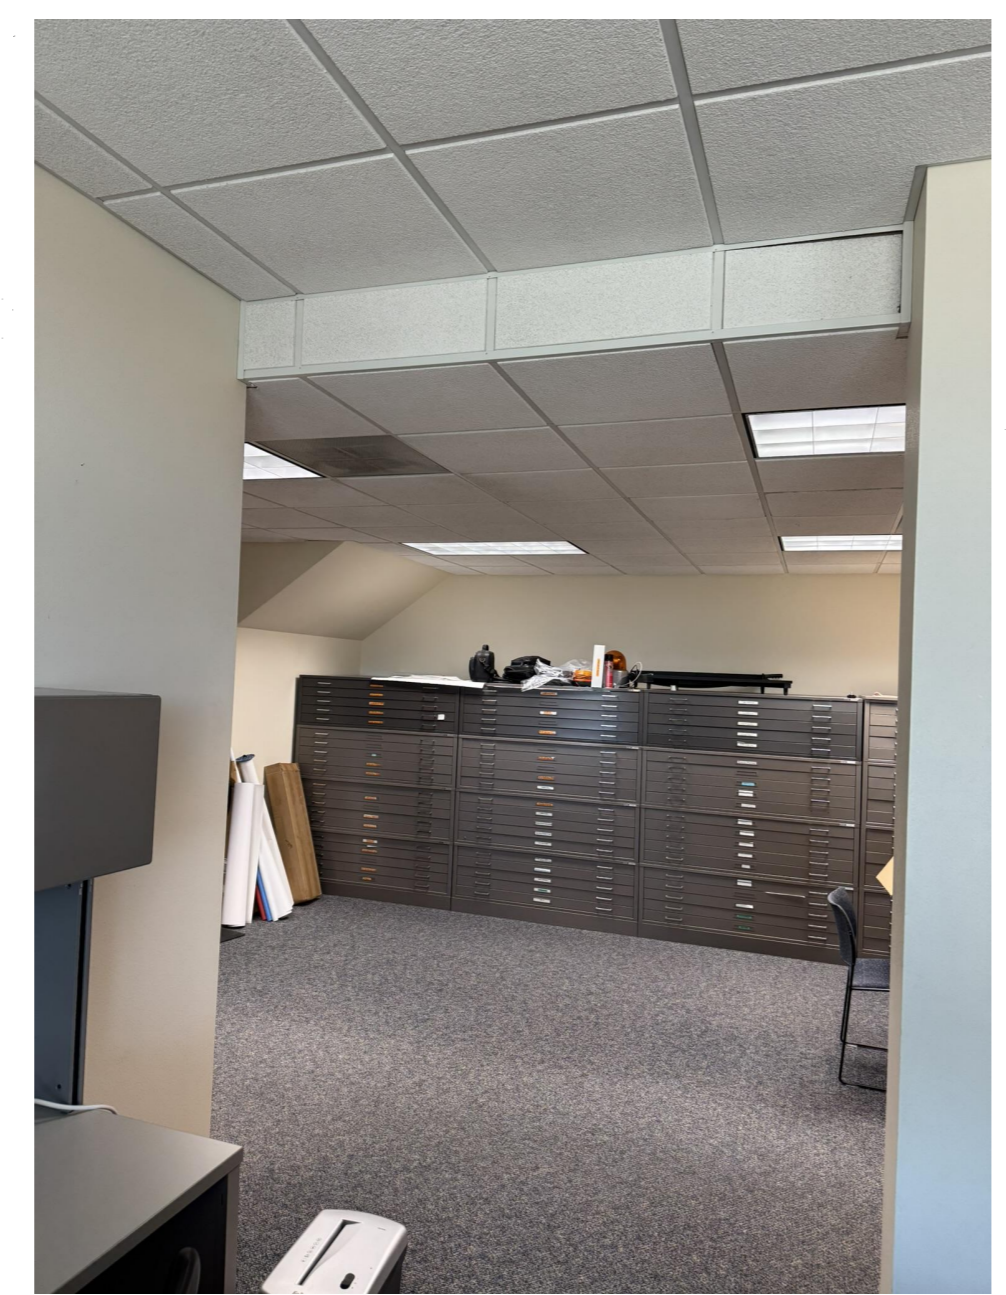


PROJECT NAME: WHITEWATER MUNICIPAL BUILDING
PROJECT NUMBER: 9501100
FILE NAME: 9501100

Consultant:


GENERAL NOTES

- REFER TO ROOM FINISH SYMBOL LEGEND IN PROJECT MANUAL FOR KEY TO FINISH SYMBOLS. REFER TO ROOM FINISH SCHEDULE FOR ALL FINISHES NOT INDICATED ON THE DRAWING.

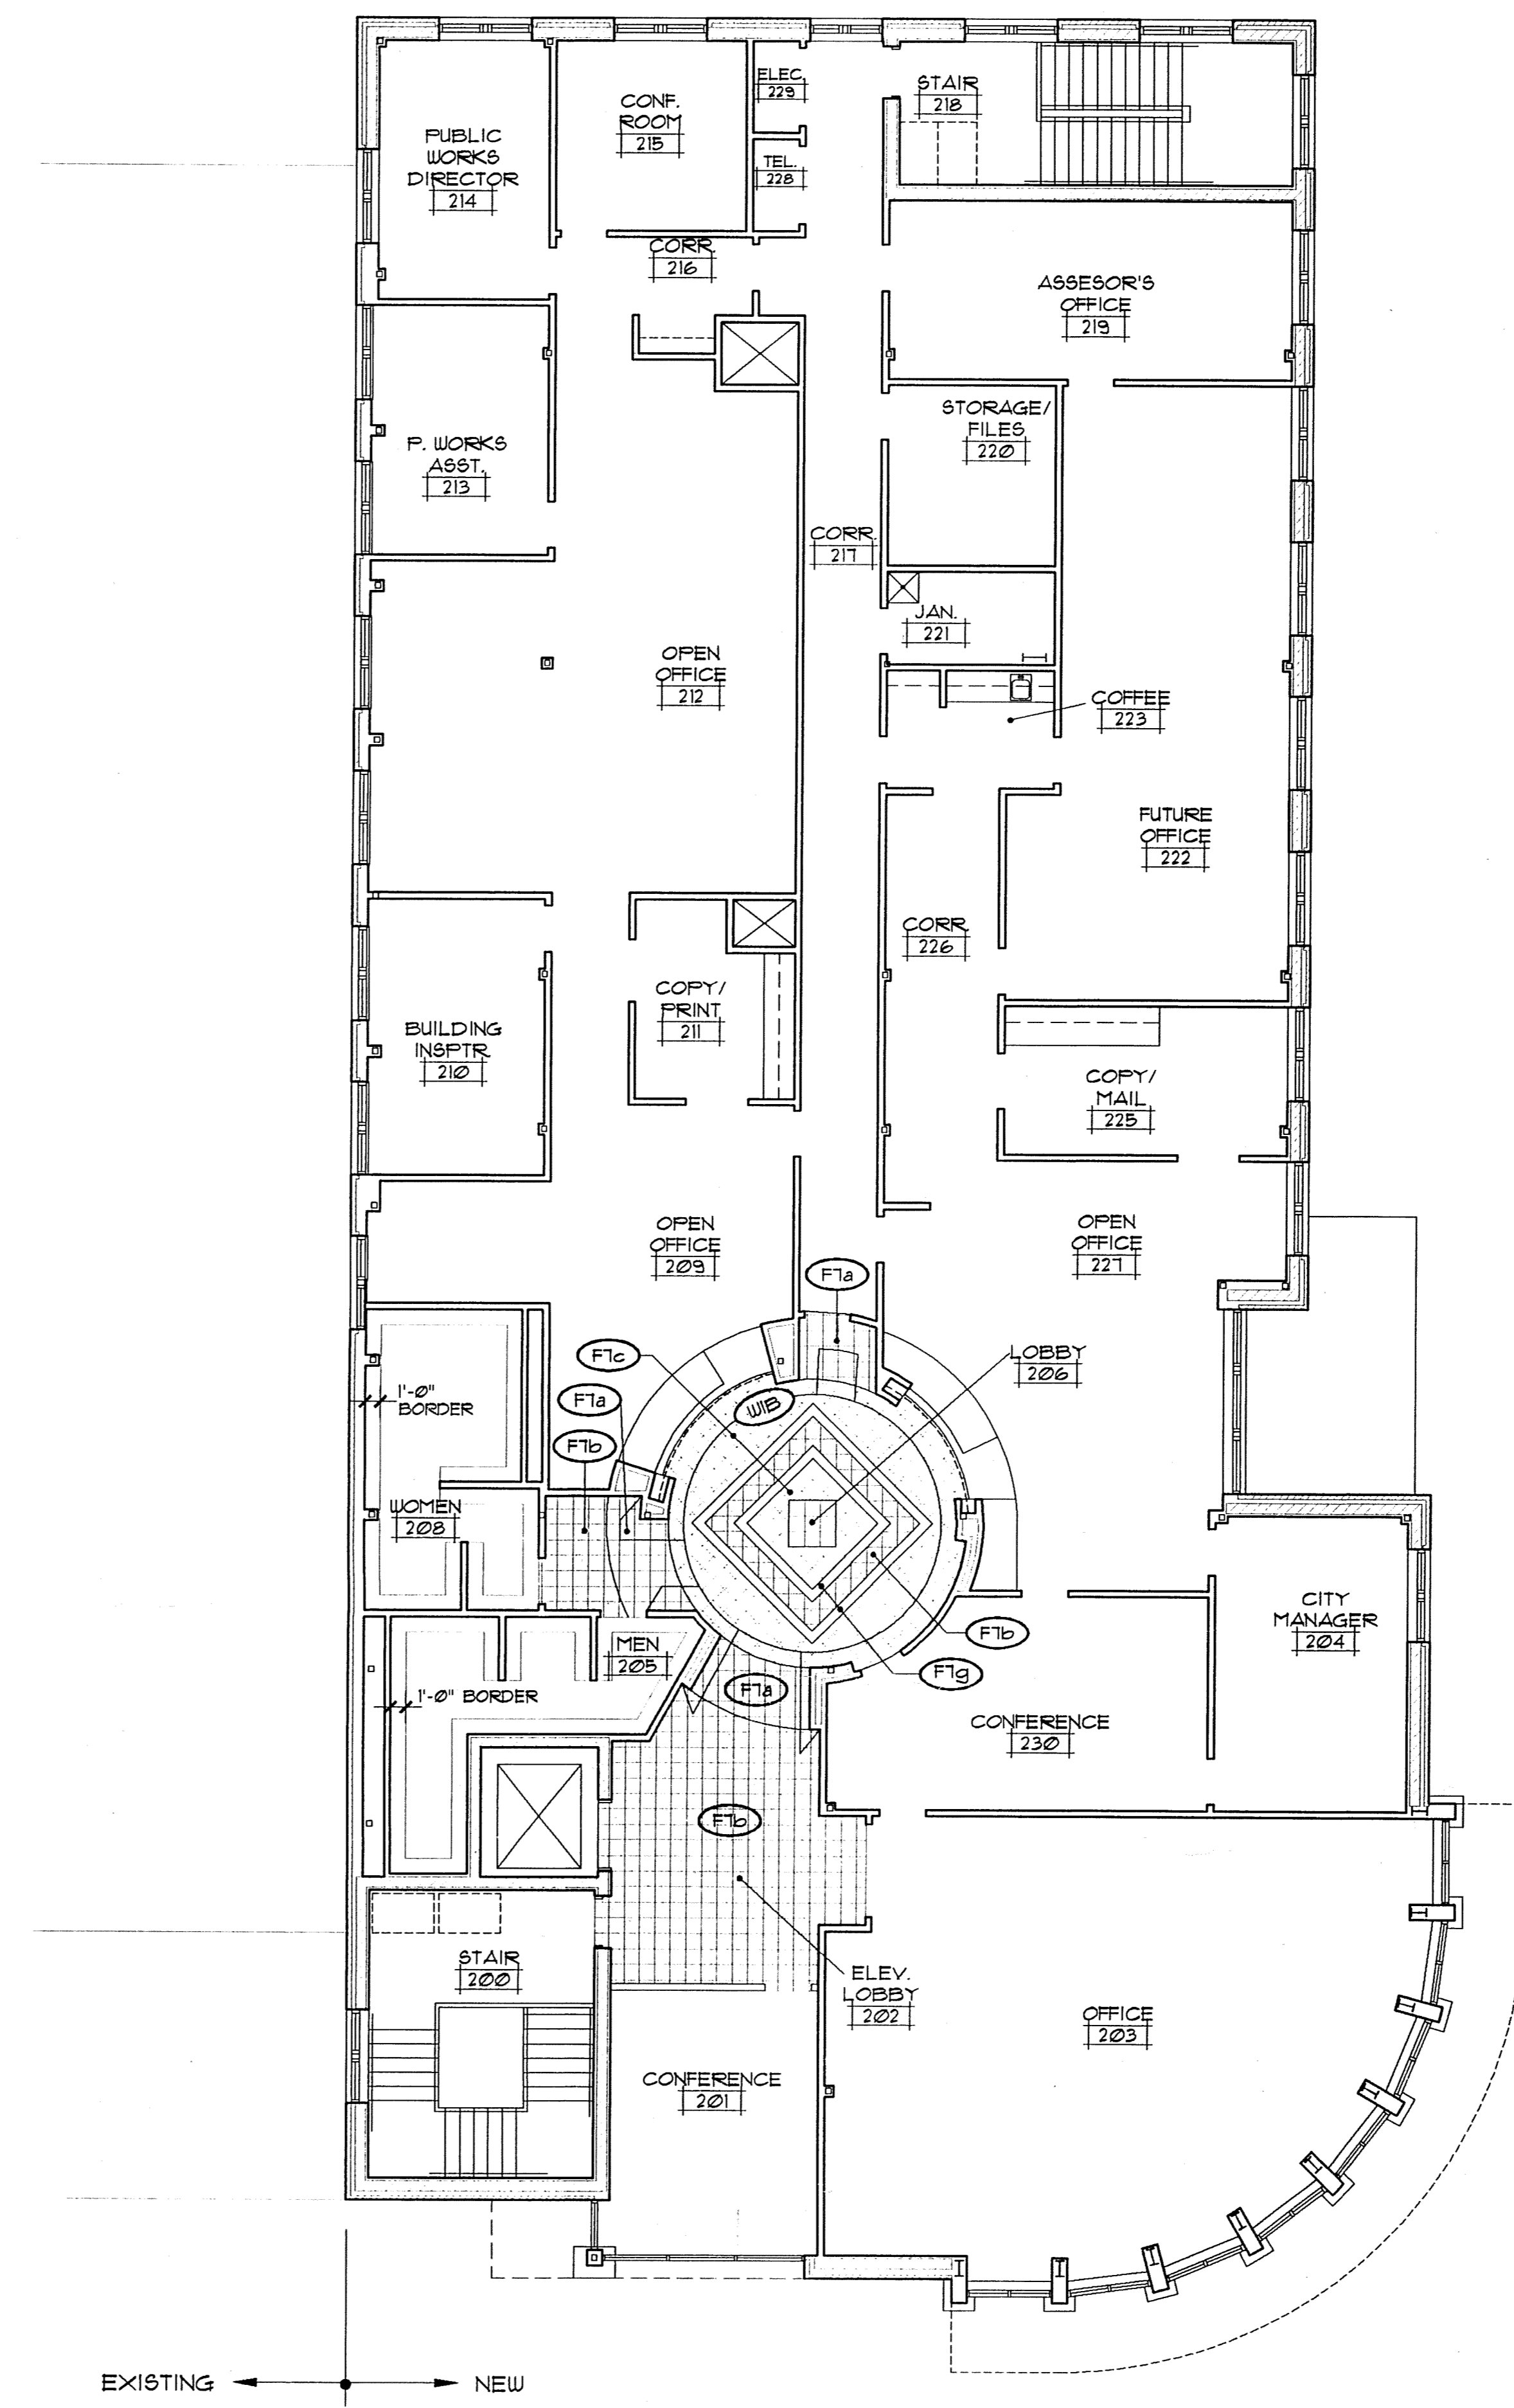

EXISTING ← → NEW

1 SECOND FLOOR FINISH PLAN
6.06 1/8" = 1'-0"

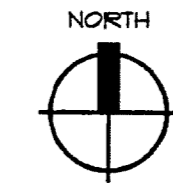

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Date	Issuance/Revisions	Symbols

WHITEWATER
MUNICIPAL BUILDING
ALTERATIONS & ADDITIONS


WHITEWATER, WISCONSIN

SECOND FLOOR FINISH PLAN

Project Number: 9501700	Sheet No.
Drawn By: FJC	6.06

PROJECT NAME: WHITEWATER MUNICIPAL BUILDING
PROJECT NUMBER: 9501700
FILE NAME: 957406


FILE: S:\401\450\407\633\4040\SETDWG\2-PLUMB.DWG
 DATE: SEP 19, 1996 - TIME: 10:07 AM - CAD TECH: BJH

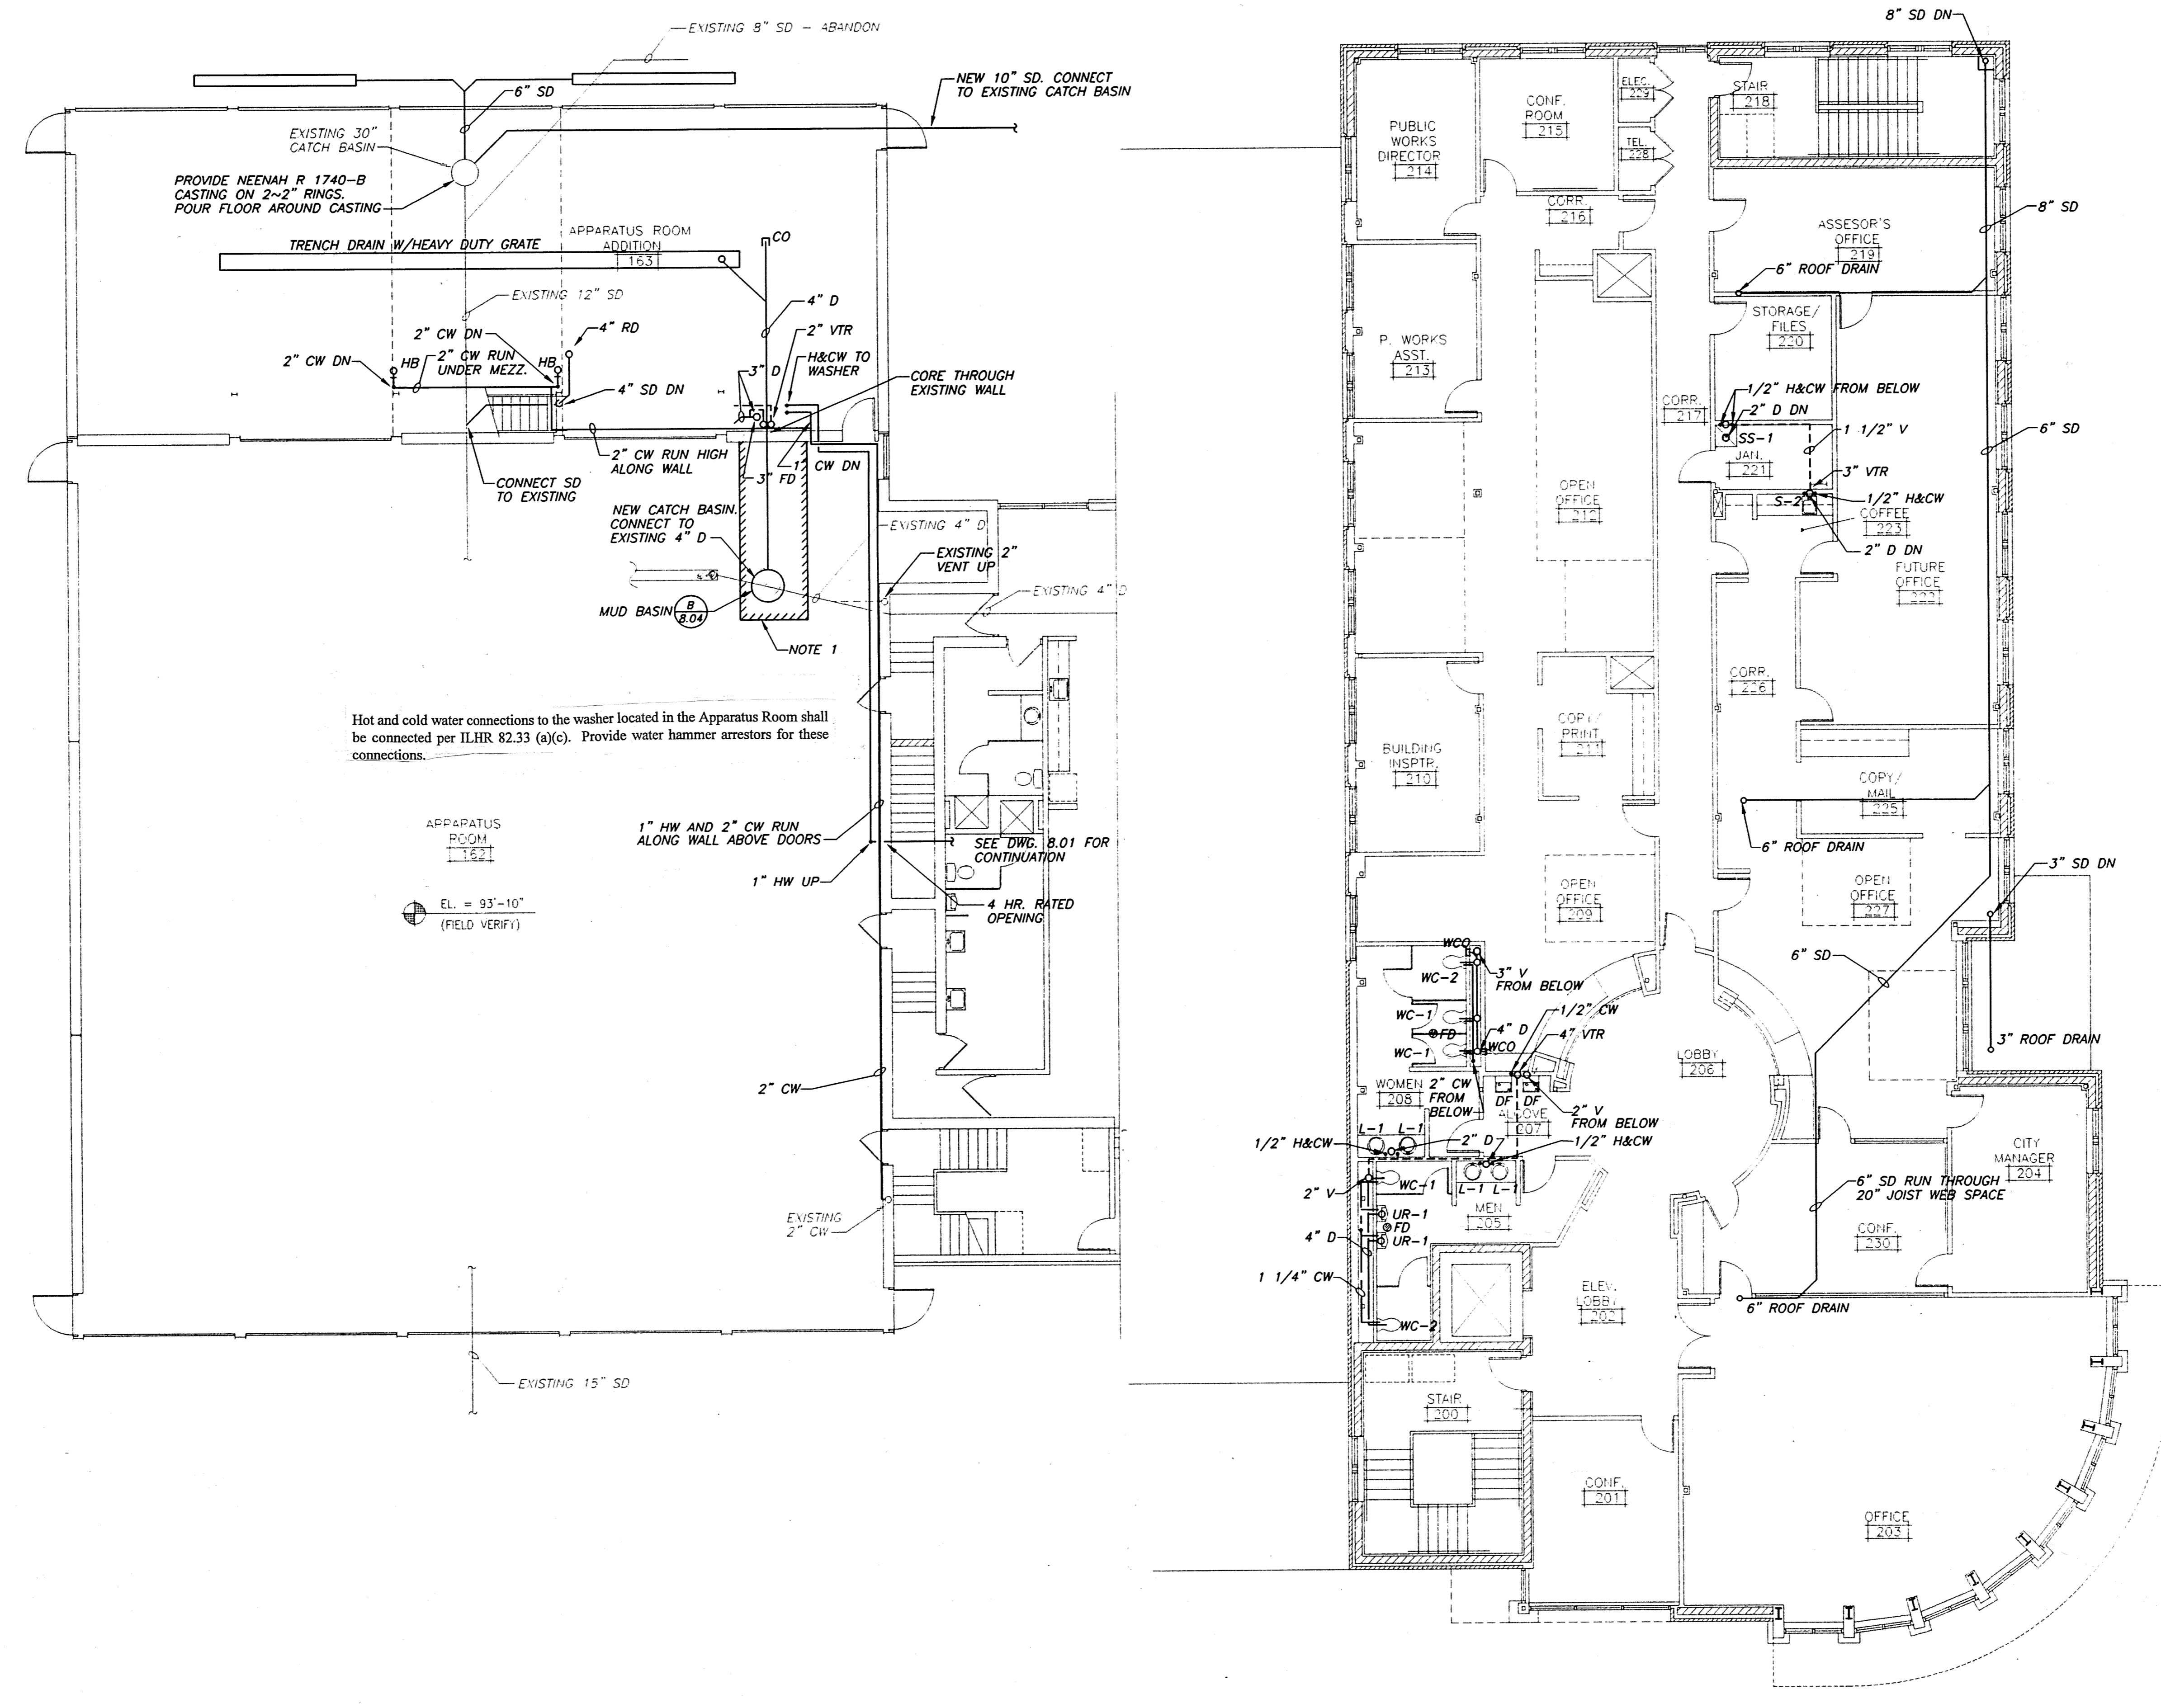

Hot and cold water connections to the washer located in the Apparatus Room shall be connected per ILHR 82.33 (a)(c). Provide water hammer arrestors for these connections.

APPARATUS ROOM
 163
 EL. = 93'-10"
 (FIELD VERIFY)

SECOND FLOOR PLUMBING PLAN
 1/8" = 1'-0"

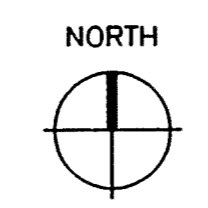

Potter Lawson
 Architects Engineers Interiors

Consultant:
STRAND ASSOCIATES, INC.
 ENGINEERS
 910 WEST WINGRA DRIVE
 MADISON, WISCONSIN 53715
 (608) 261-4845

- GENERAL PLAN NOTES:**
1. PLUMBING CONTRACTOR SHALL SAWCUT AND REMOVE FLOOR AS NECESSARY TO INSTALL NEW PLUMBING. PLUMBING CONTRACTOR TO REPAIR FLOOR PER $\frac{2}{3.06}$
- EXISTING FLOOR IS NOMINALLY 7" THICK WITH 2 LAYERS OF W/F.

SYMBOLS:

	HOT WATER SUPPLY (HWS)
	HOT WATER RETURN (HWR)
	COLD WATER (CW)
	VENT
	VENT THROUGH ROOF
	FLOOR DRAIN
	CLEAN OUT
	SANITARY TRAP
	CATCH BASIN
	STORM DRAIN
	WALL CLEAN OUT

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Date	Issuance/Revisions	Symbols

WHITEWATER MUNICIPAL BUILDING
 ALTERATIONS & ADDITIONS
 WHITEWATER, WISCONSIN

Drawing Title:
SECOND FLOOR PLUMBING PLAN

Project Number: 9501700	Sheet No.
Drawn By: BJH	8.03

GENERAL PLAN NOTES:

- SYMBOLS**
- HOT WATER SUPPLY
 - HOT WATER RETURN
 - GAS PIPING
 - ⊠ MOTOR OPERATED CONTROL VALVE
 - ⊞ GAS COCK
 - ⊞ BALANCING VALVE
 - ⊞ PRESSURE RELIEF VALVE
 - ⊞ THERMOSTAT
 - ⊞ SUPPLY OR OUTSIDE DUCT
 - ⊞ RETURN OR EXHAUST DUCT
 - ⊞ NON-DUCTED RETURN DIFFUSER
 - ⊞ MANUFACTURE DAMPER
 - BDD BACKDRAFT DAMPER (BDD)
 - FD FIRE DAMPER
 - TURNING VANES
 - ⊞ ROOF FAN (EXHAUST/SUPPLY)
 - TG TRANSFER GRILLES


8/29/96	ISSUED FOR BIDDING	
Date	Issuance/Revisions	Symbols

WHITEWATER MUNICIPAL BUILDING ALTERATIONS & ADDITIONS
WHITEWATER, WISCONSIN


Drawing Title:
SECOND FLOOR HEATING AND VENTILATING PLAN

Project Number: 9501700
Sheet No. 9.03


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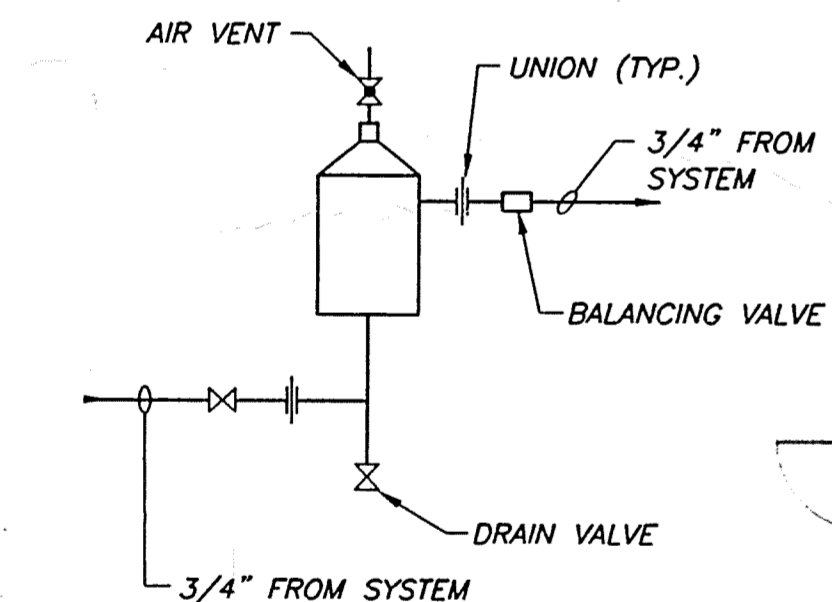
SECOND FLOOR HEATING AND VENTILATING PLAN
1/8" = 1'-0"

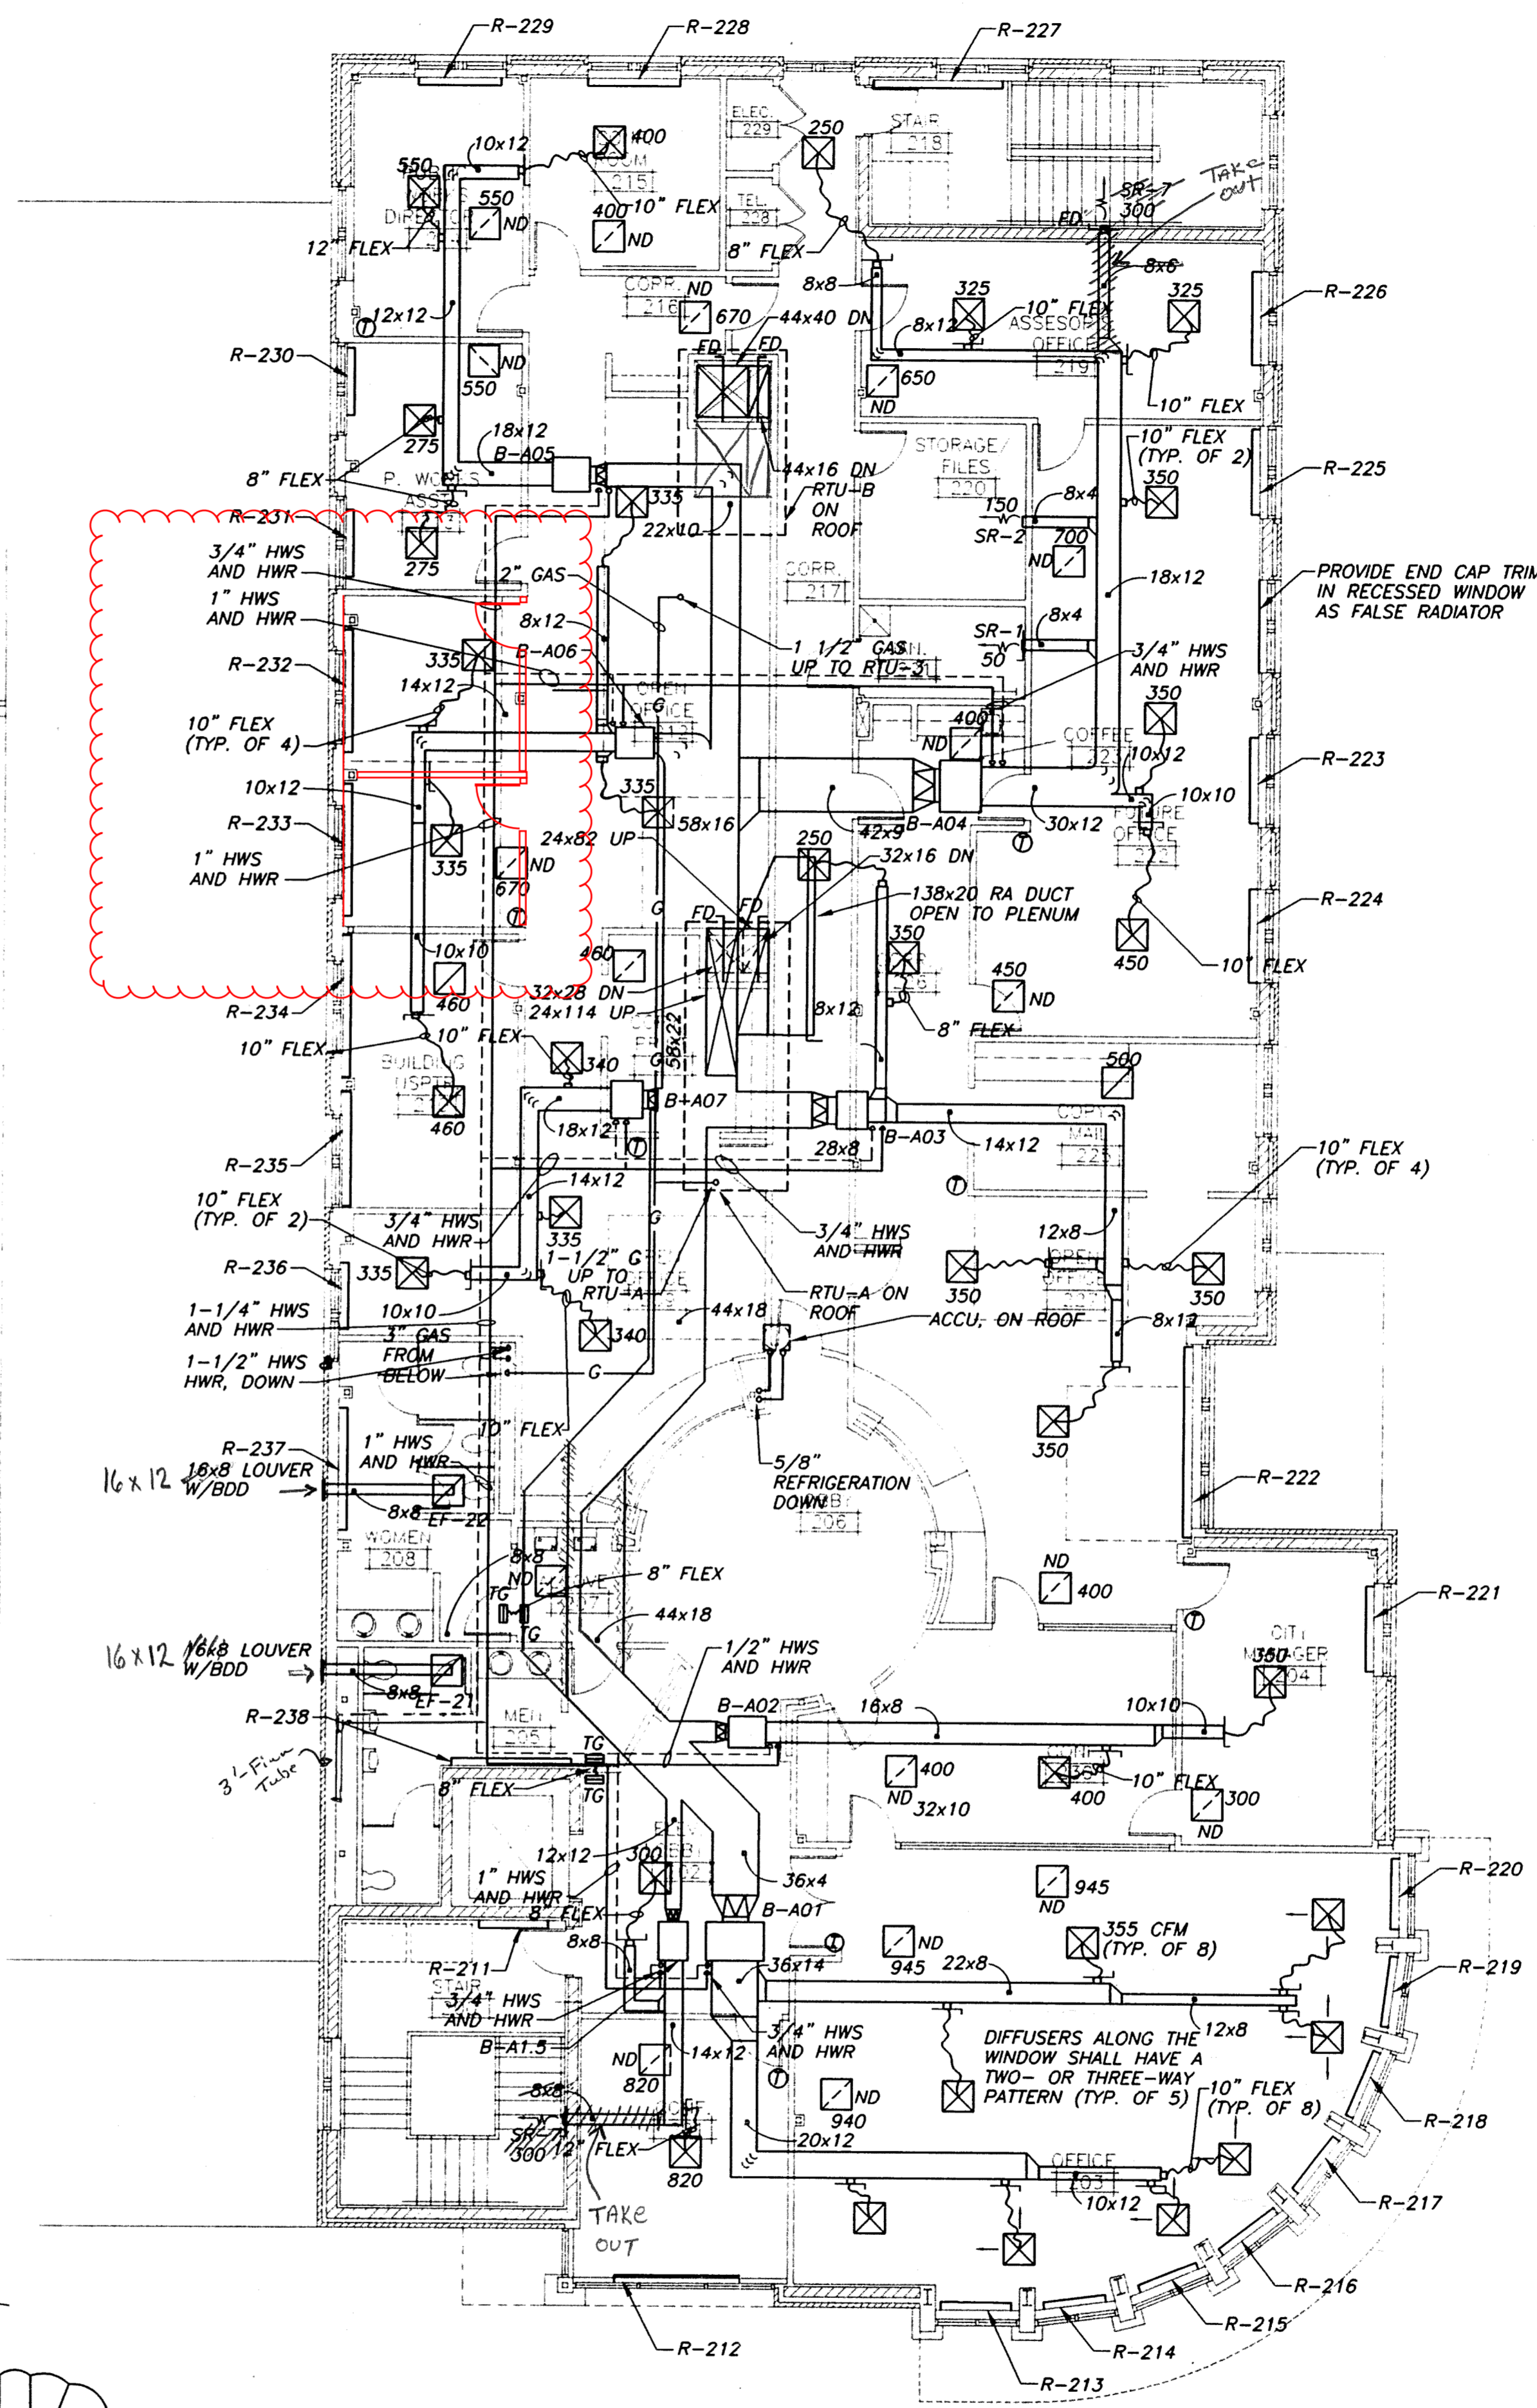


A 9.03 RADIATOR PIPING
NO SCALE

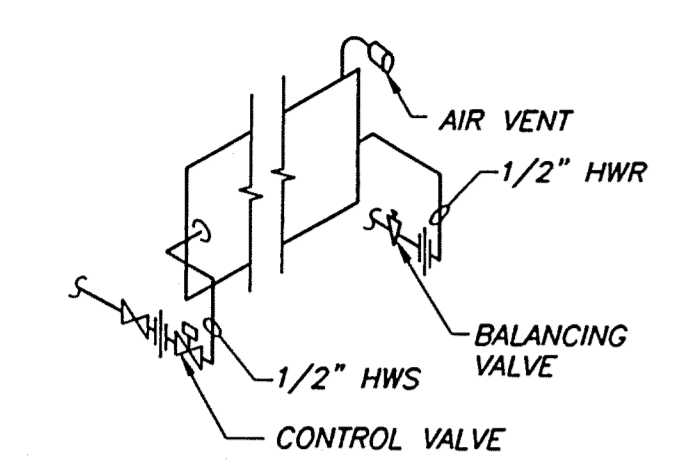


B 9.03 BOILER PIPING
NO SCALE

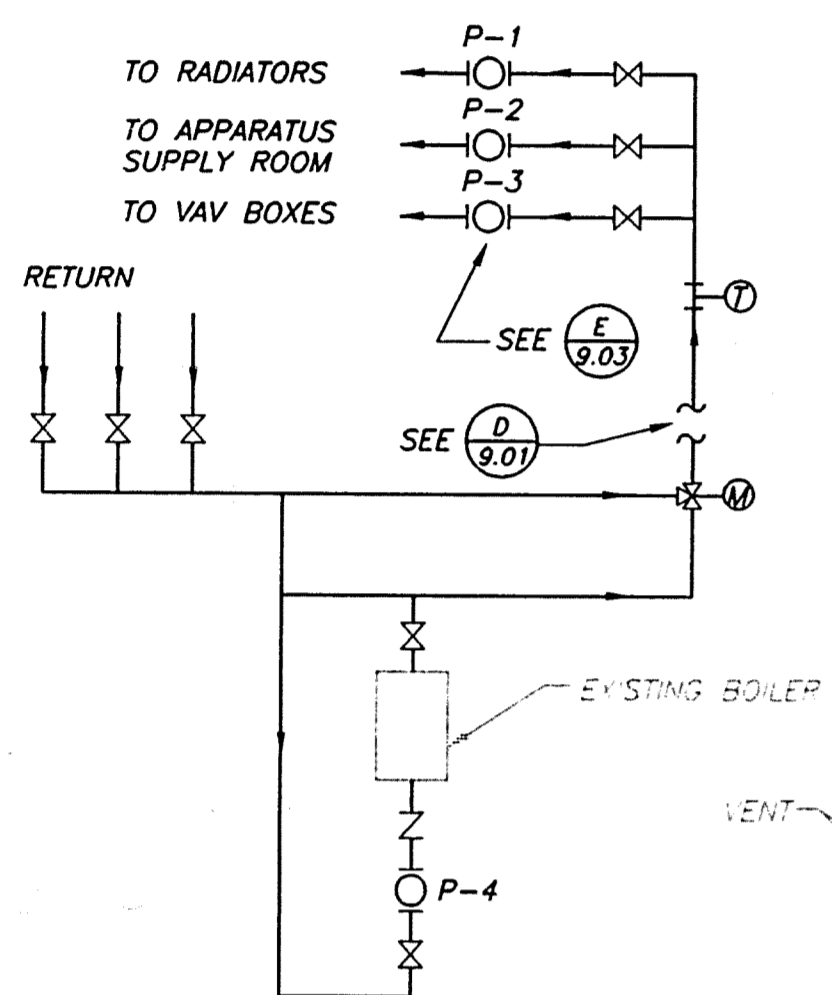


C 9.03 COMPOUND FEEDER SCHEMATIC
NO SCALE

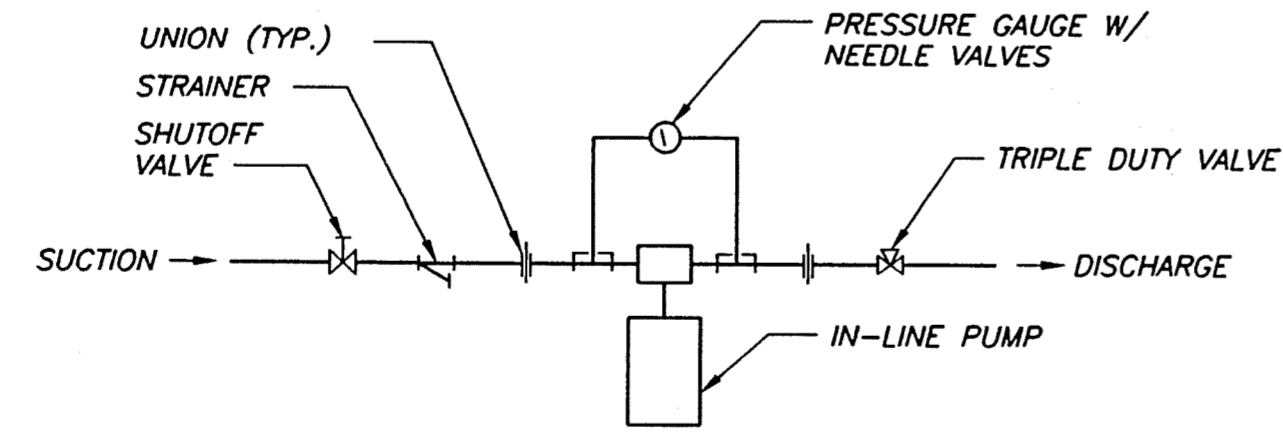


E 9.03 IN-LINE PUMP PIPING
NO SCALE

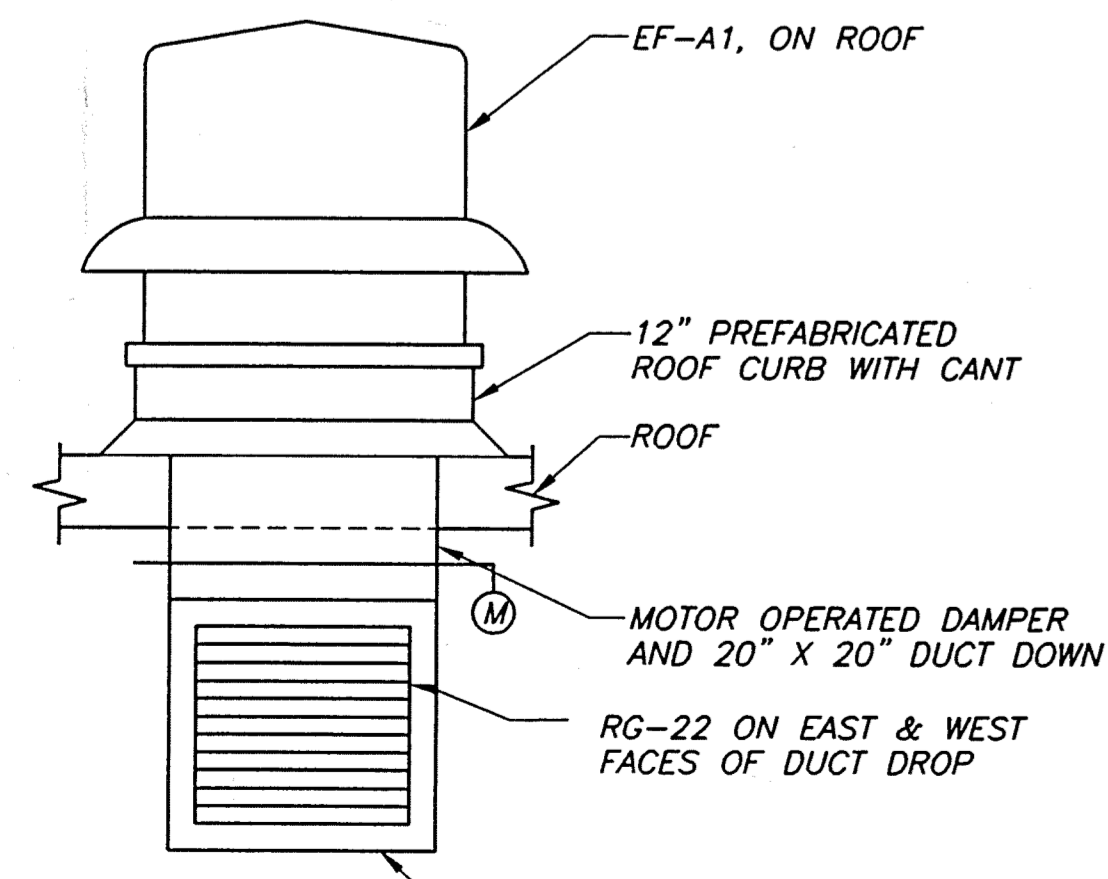

D 9.03 EXHAUST FAN (EF-A1)
NO SCALE

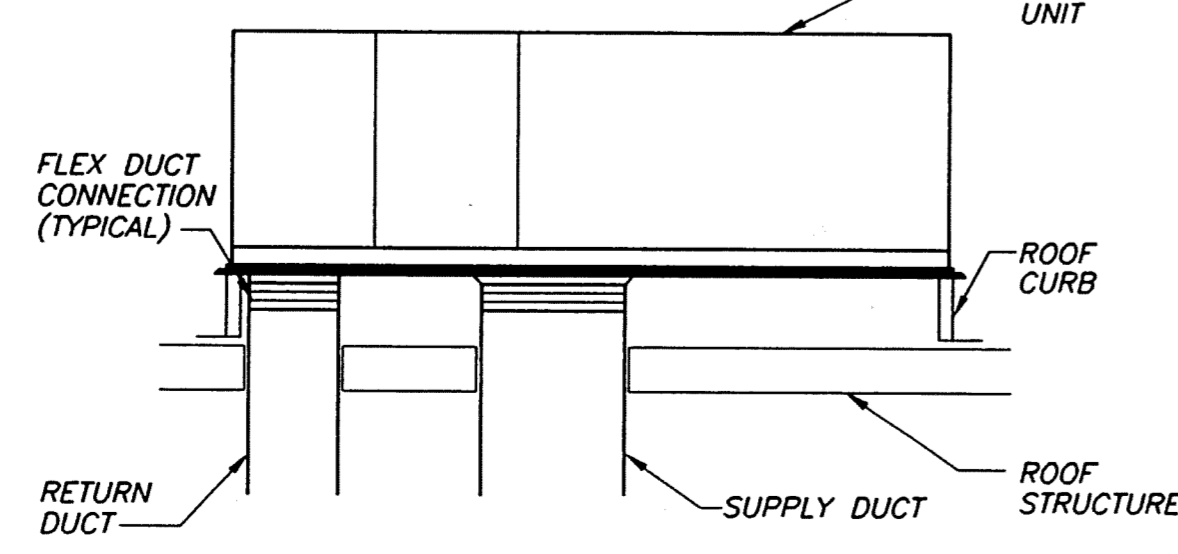


F 9.03 RTU INSTALLATION DETAIL
NO SCALE

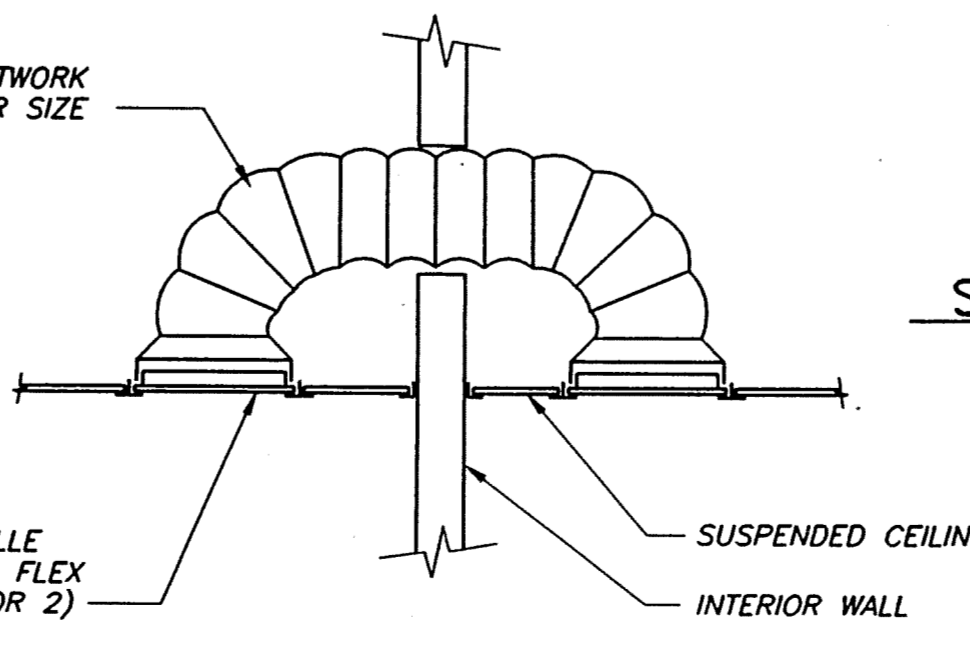


G 9.03 AIR TRANSFER DUCT
NO SCALE

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 DATE: SEP 19, 1996 - TIME: 8:19 AM - CAD TECH: BJH

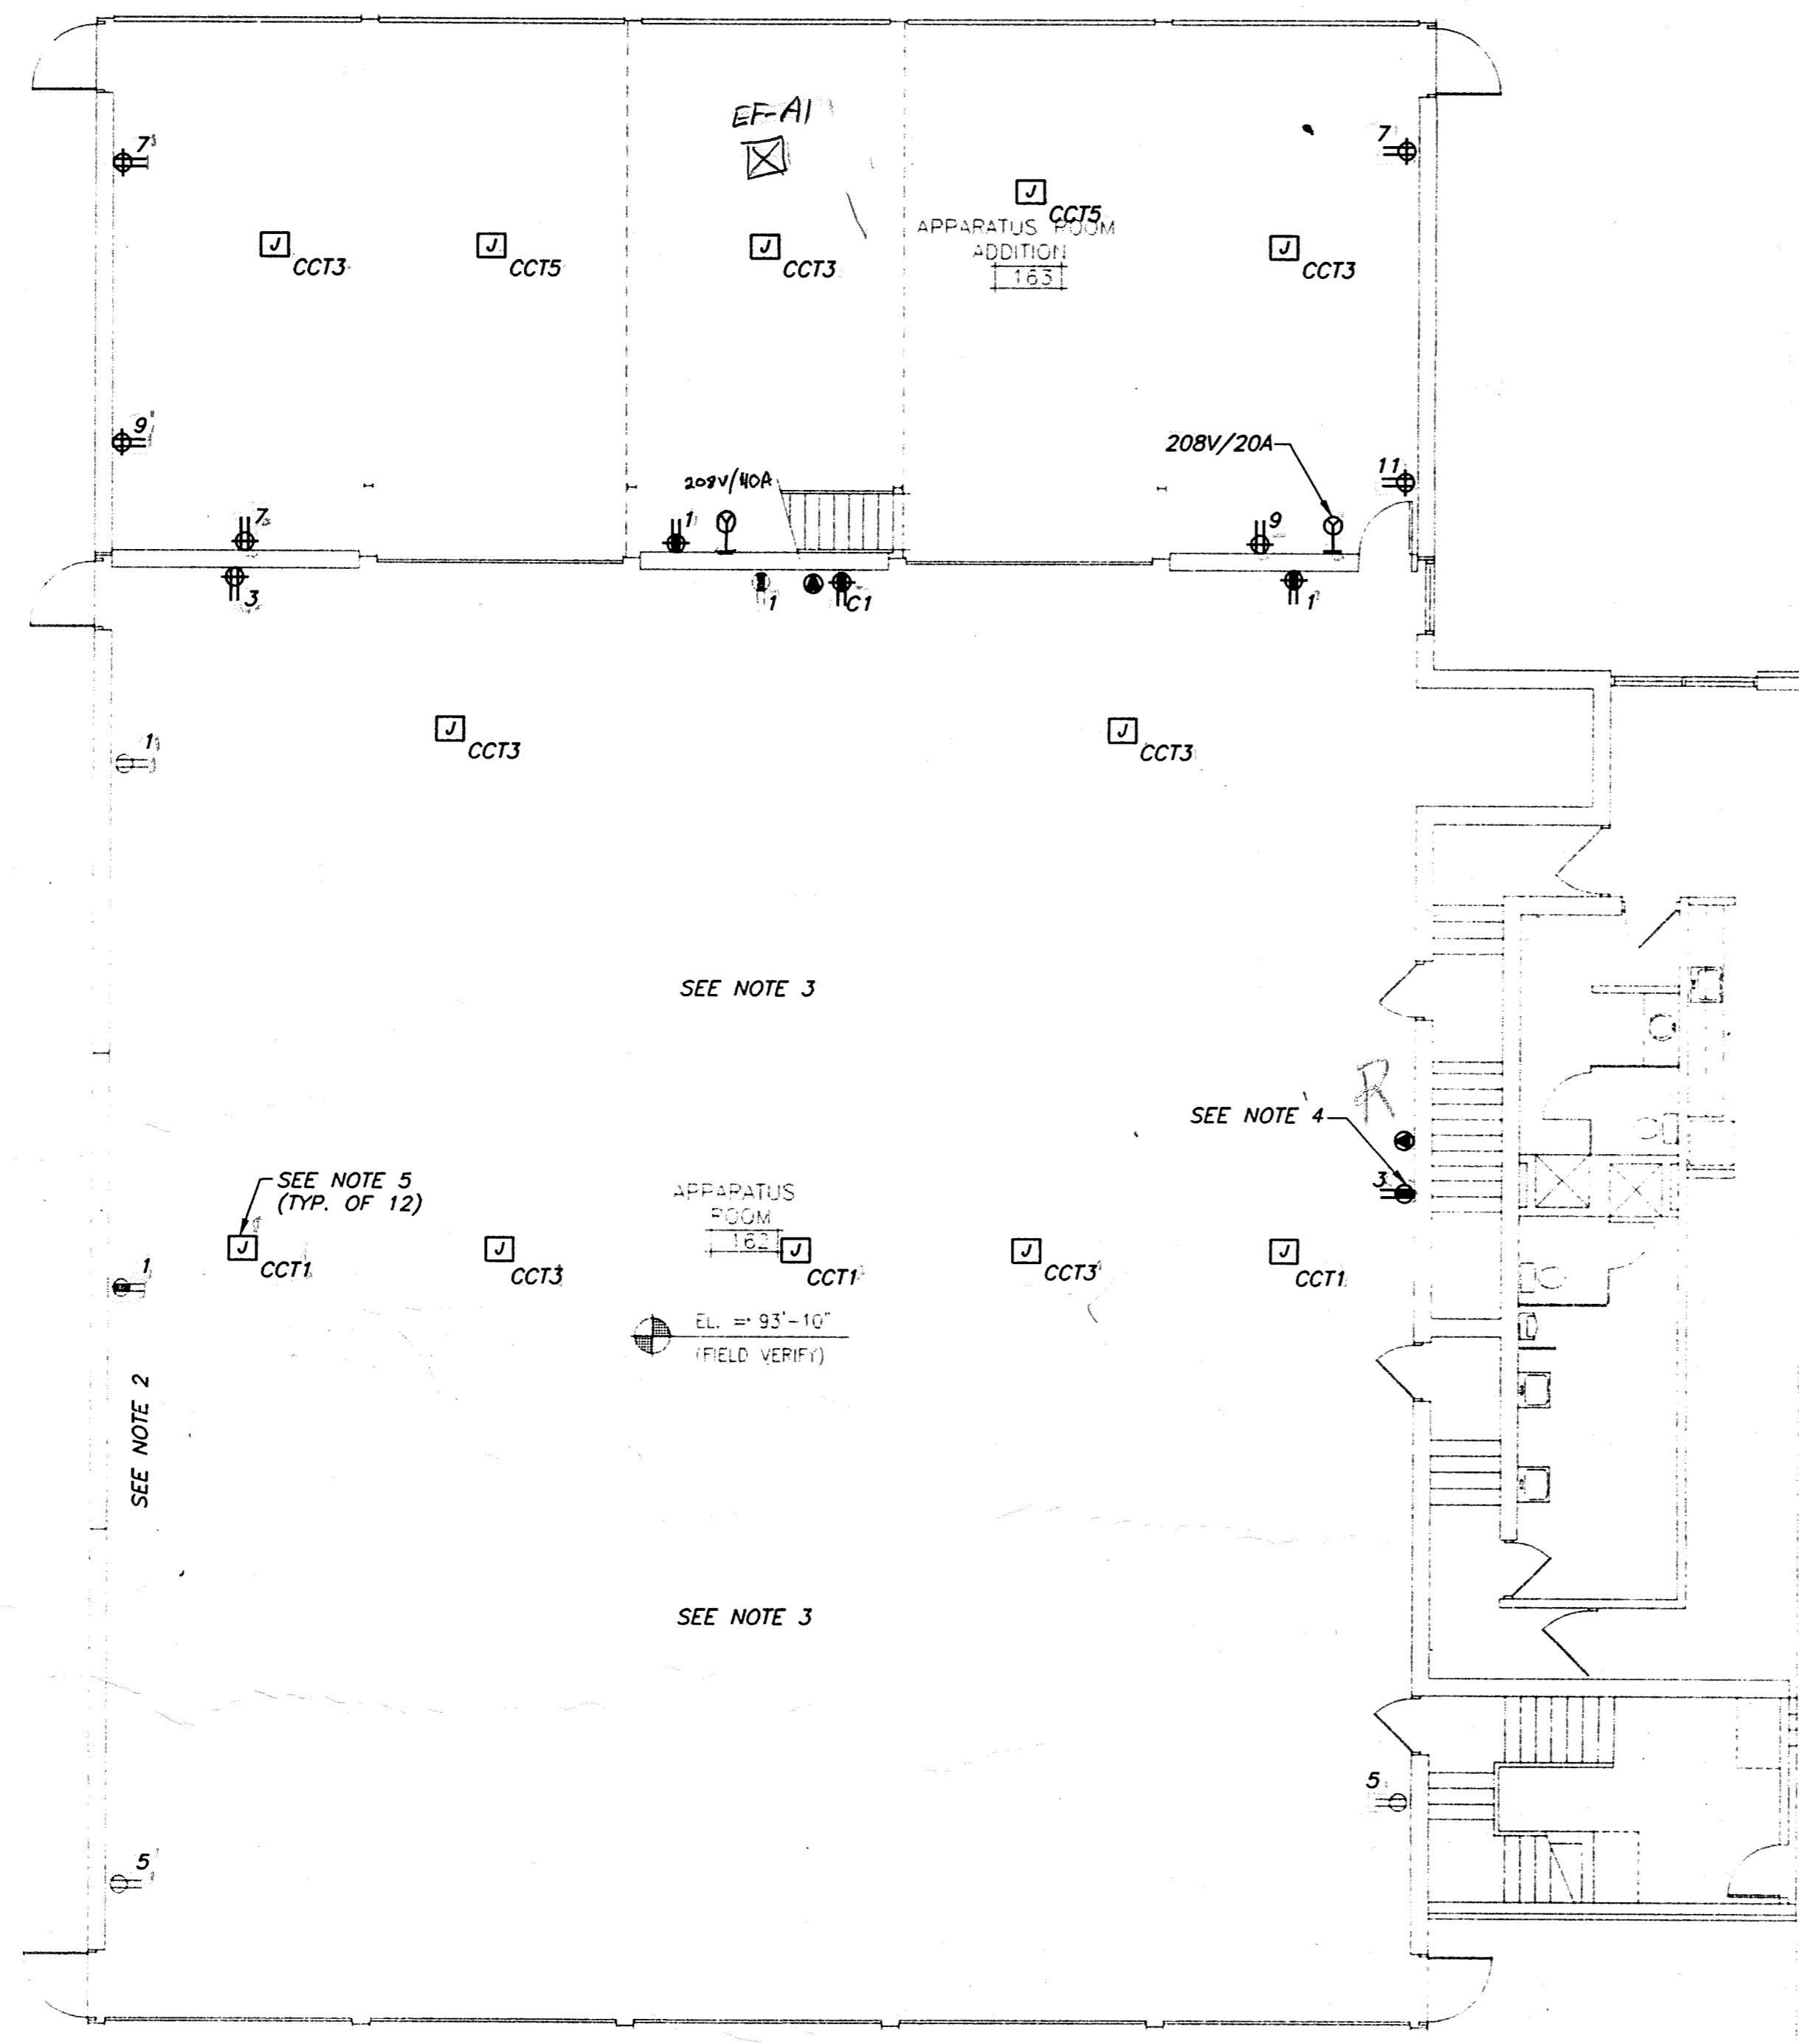

EXISTING BUILDING
 CP-1 EMP-1 LP-1A
 NEW BUILDING
 CP-2 EMP-1 LP-2A

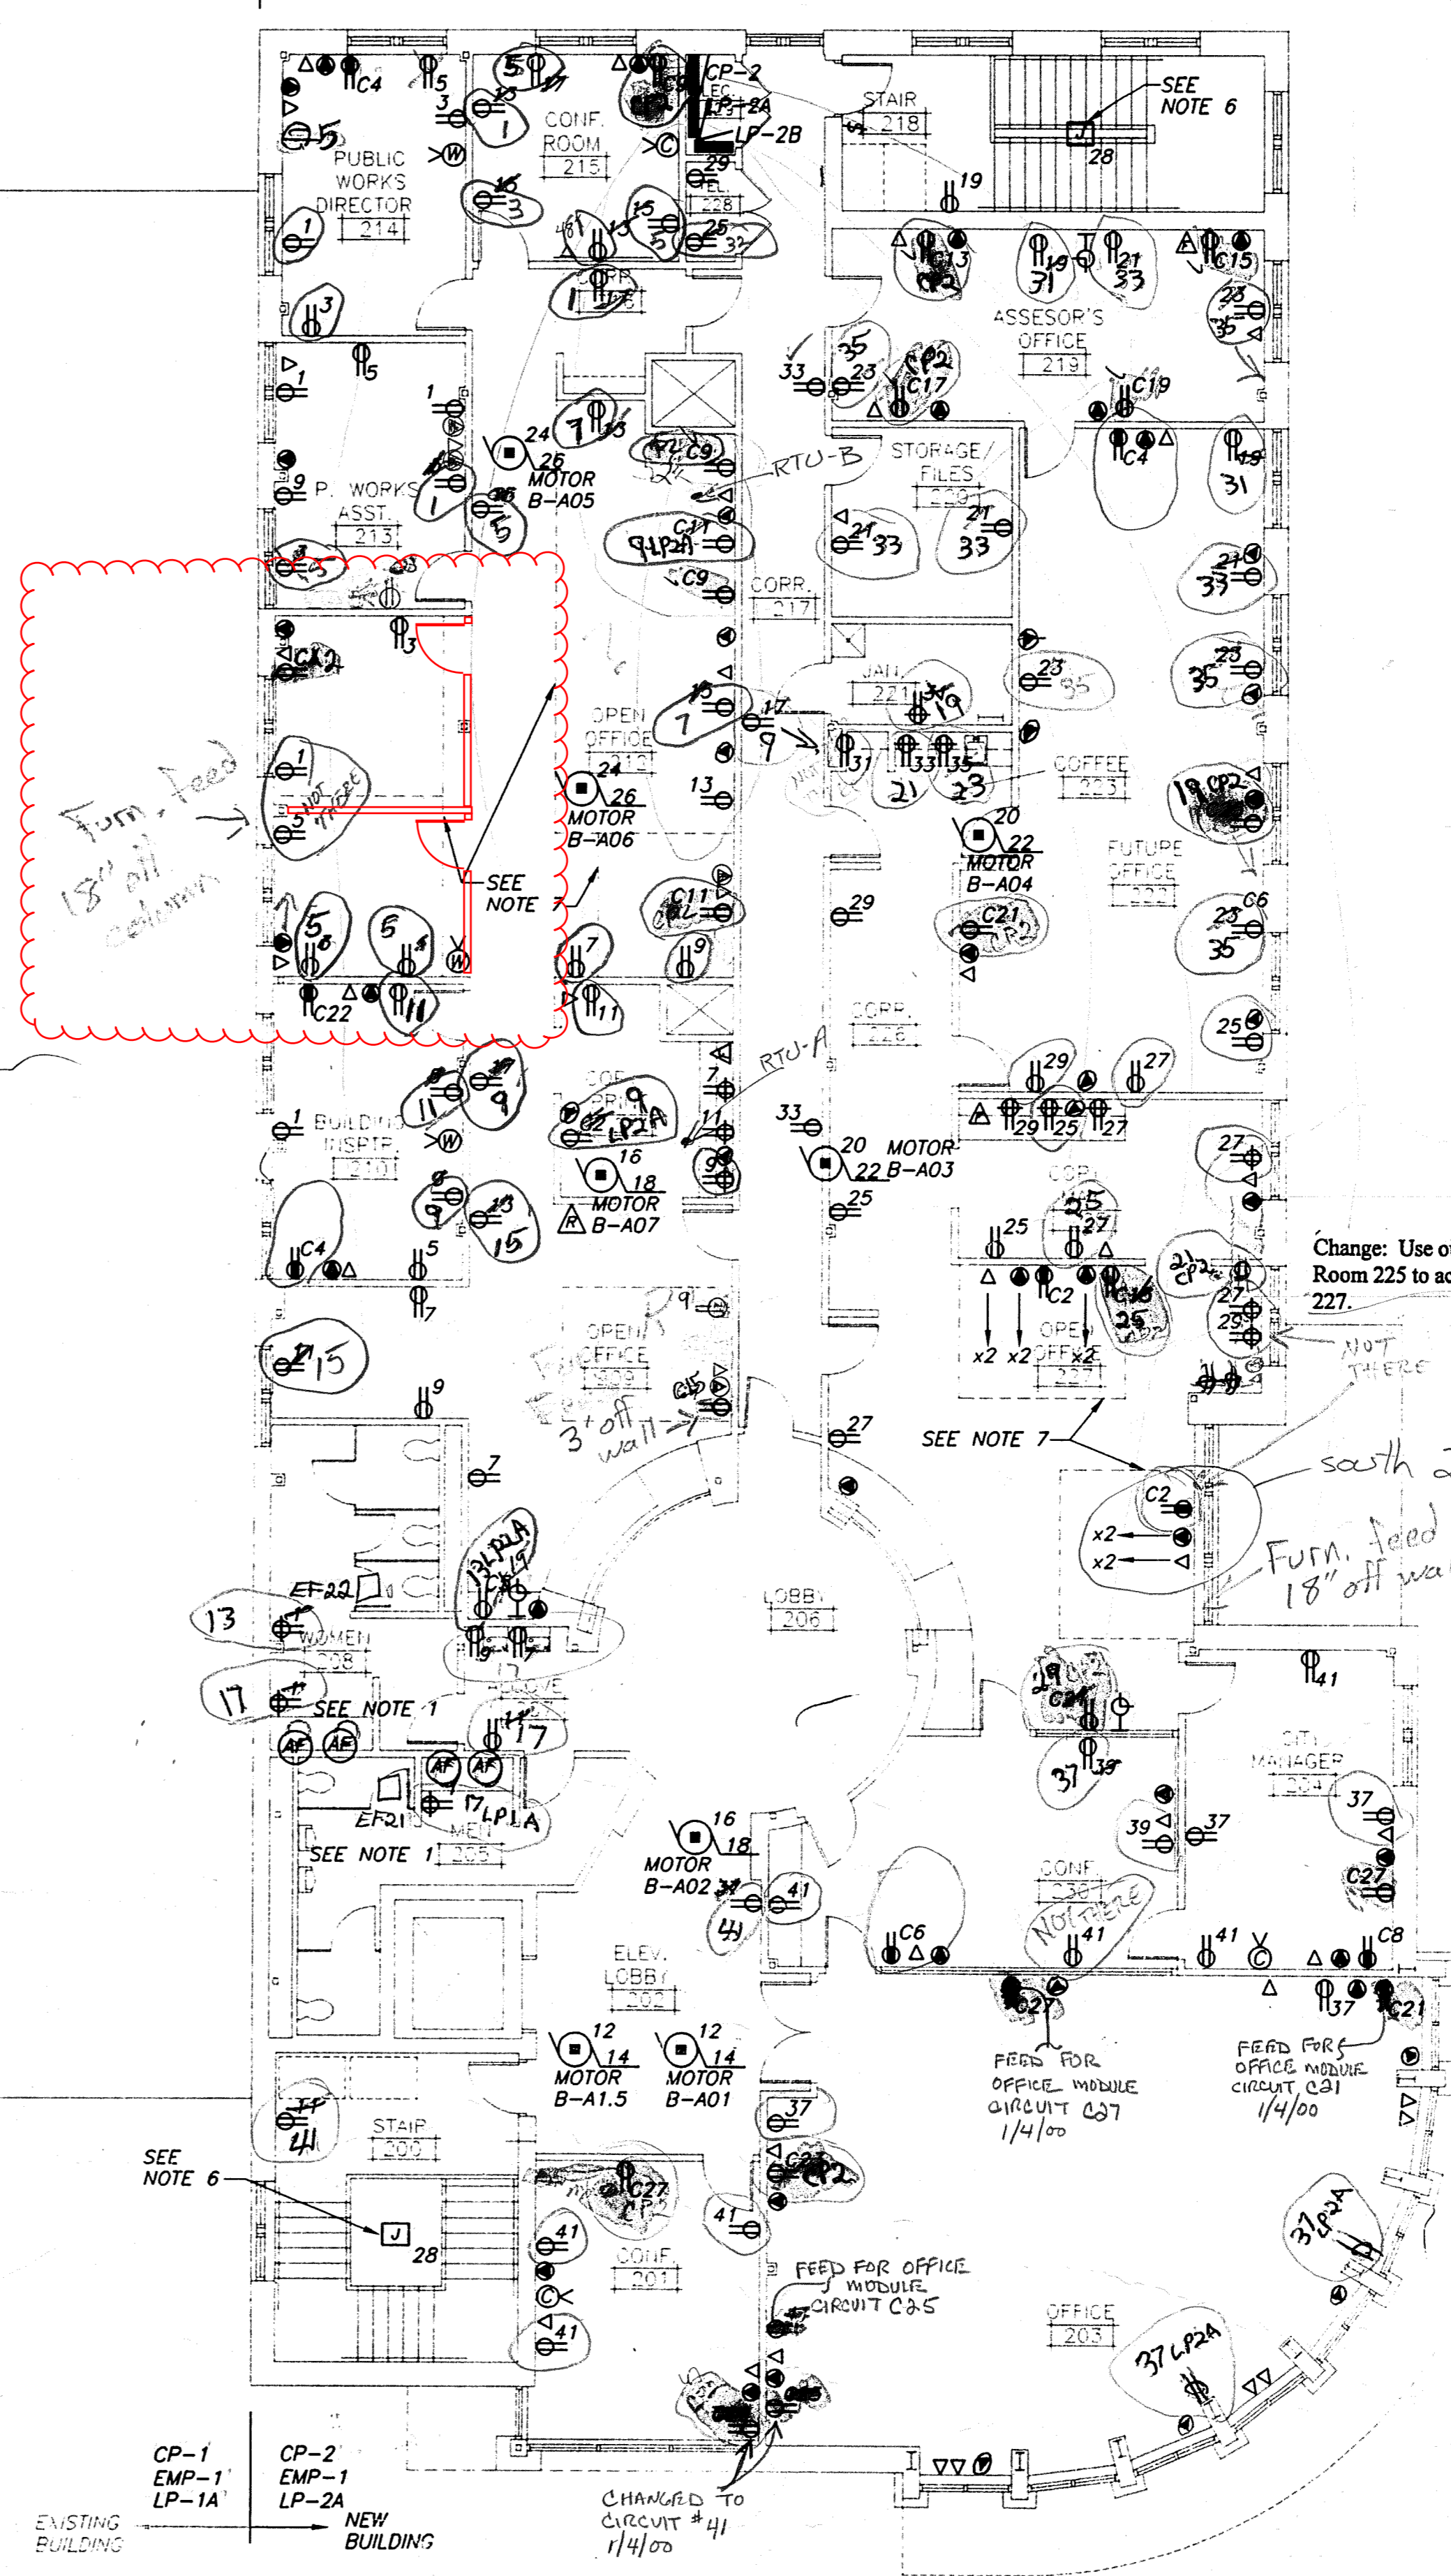

Public Works Assst 9+7
 Open door
 Front entrance
 Open door

Potter Lawson
 Architects Engineers Interiors

Consultant:
STRAND ASSOCIATES, INC.
 ENGINEERS
 510 WEST WINDRA DRIVE
 MADISON, WISCONSIN 53715
 (608) 251-4843

- GENERAL NOTES:**
1. ALL CLOCKS TO BE PROVIDED WITH 120V POWER AND 16 AWG. SH. PR. CONTROL WIRE FROM CCP ROOM B18.
 2. MECHANICAL CONTRACTOR TO PROVIDE TRANSFORMER FOR AUTOMATIC FAUCETS. ELECTRICAL CONTRACTOR TO PROVIDE WIRE AND CONNECT TRANSFORMER, SOLENOID VALVE, AND SENSOR AS REQUIRED BY DIVISION 15. TRANSFORMER FOR FAUCET SHALL BE POWERED FROM BATHROOM OUTLET BRANCH CIRCUIT.
 3. CONTRACTOR TO PROVIDE AN OUTLET FOR EACH ROOFTOP UNIT FROM PANEL LP-2A. OUTLET SHALL BE SURFACE MOUNTED ON THE ROOFTOP UNIT AS SHOWN ON ROOF PLAN DRAWING 5.04.

- PLAN NOTES:**
1. OUTLETS IN THIS AREA TO BE GFI TYPE.
 2. REUSE EXISTING CONDUIT AND BOXES. PULL NEW WIRE AND RECONNECT AS SPECIFIED.
 3. APPARATUS ROOM POWER TO BE FED FROM PANEL LP-1A (FIRST FLOOR).
 4. REUSE EXISTING CONDUIT. WIRE FROM EMERGENCY PANEL EMP-1.
 5. JUNCTION BOX FROM EMERGENCY POWER PANEL EMP-1. EACH JUNCTION BOX TO FEED EXISTING OVERHEAD GARAGE DOOR OPENERS AND OUTLETS.
 6. PROVIDE JUNCTION BOX AND WALL MOUNTED SWITCH AS SHOWN TO POWER STAIRWELL CEILING FAN.
 7. SYSTEMS FURNITURE TO BE PROVIDED. SYMBOLS AND CIRCUITING SHOWN AS REFERENCE.

- SYMBOLS:**
- (AF) - AUTOMATIC FAUCET FOR BATHROOM SINKS.
 - (A) - FAX MACHINE - ADDITIONAL PHONE LINE REQUIRED
 - (A) - PHONE LINE FOR MUNICIPAL RADIO
 - (C) - CABLE TV
 - (W) - WEATHER CH. COMM.
 - (R) - Red Outlets generator power thru EMP-1
 - (O) - Orange Outlets surge protected no generator power

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Date	Issuance/Revisions	Symbols


WHITEWATER MUNICIPAL BUILDING ALTERATIONS & ADDITIONS

WHITEWATER, WISCONSIN



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SECOND FLOOR POWER AND COMMUNICATION

Project Number: 9501700
 Sheet No. 10.03
 Drawn By: BJH


SECOND FLOOR POWER AND COMMUNICATION PLAN
 1/8" = 1'-0"

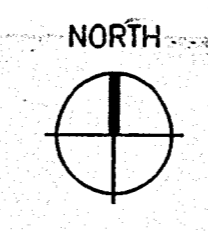

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DATE: SEP 17, 1996 - TIME: 5:01 PM - CAD TECH: BJH

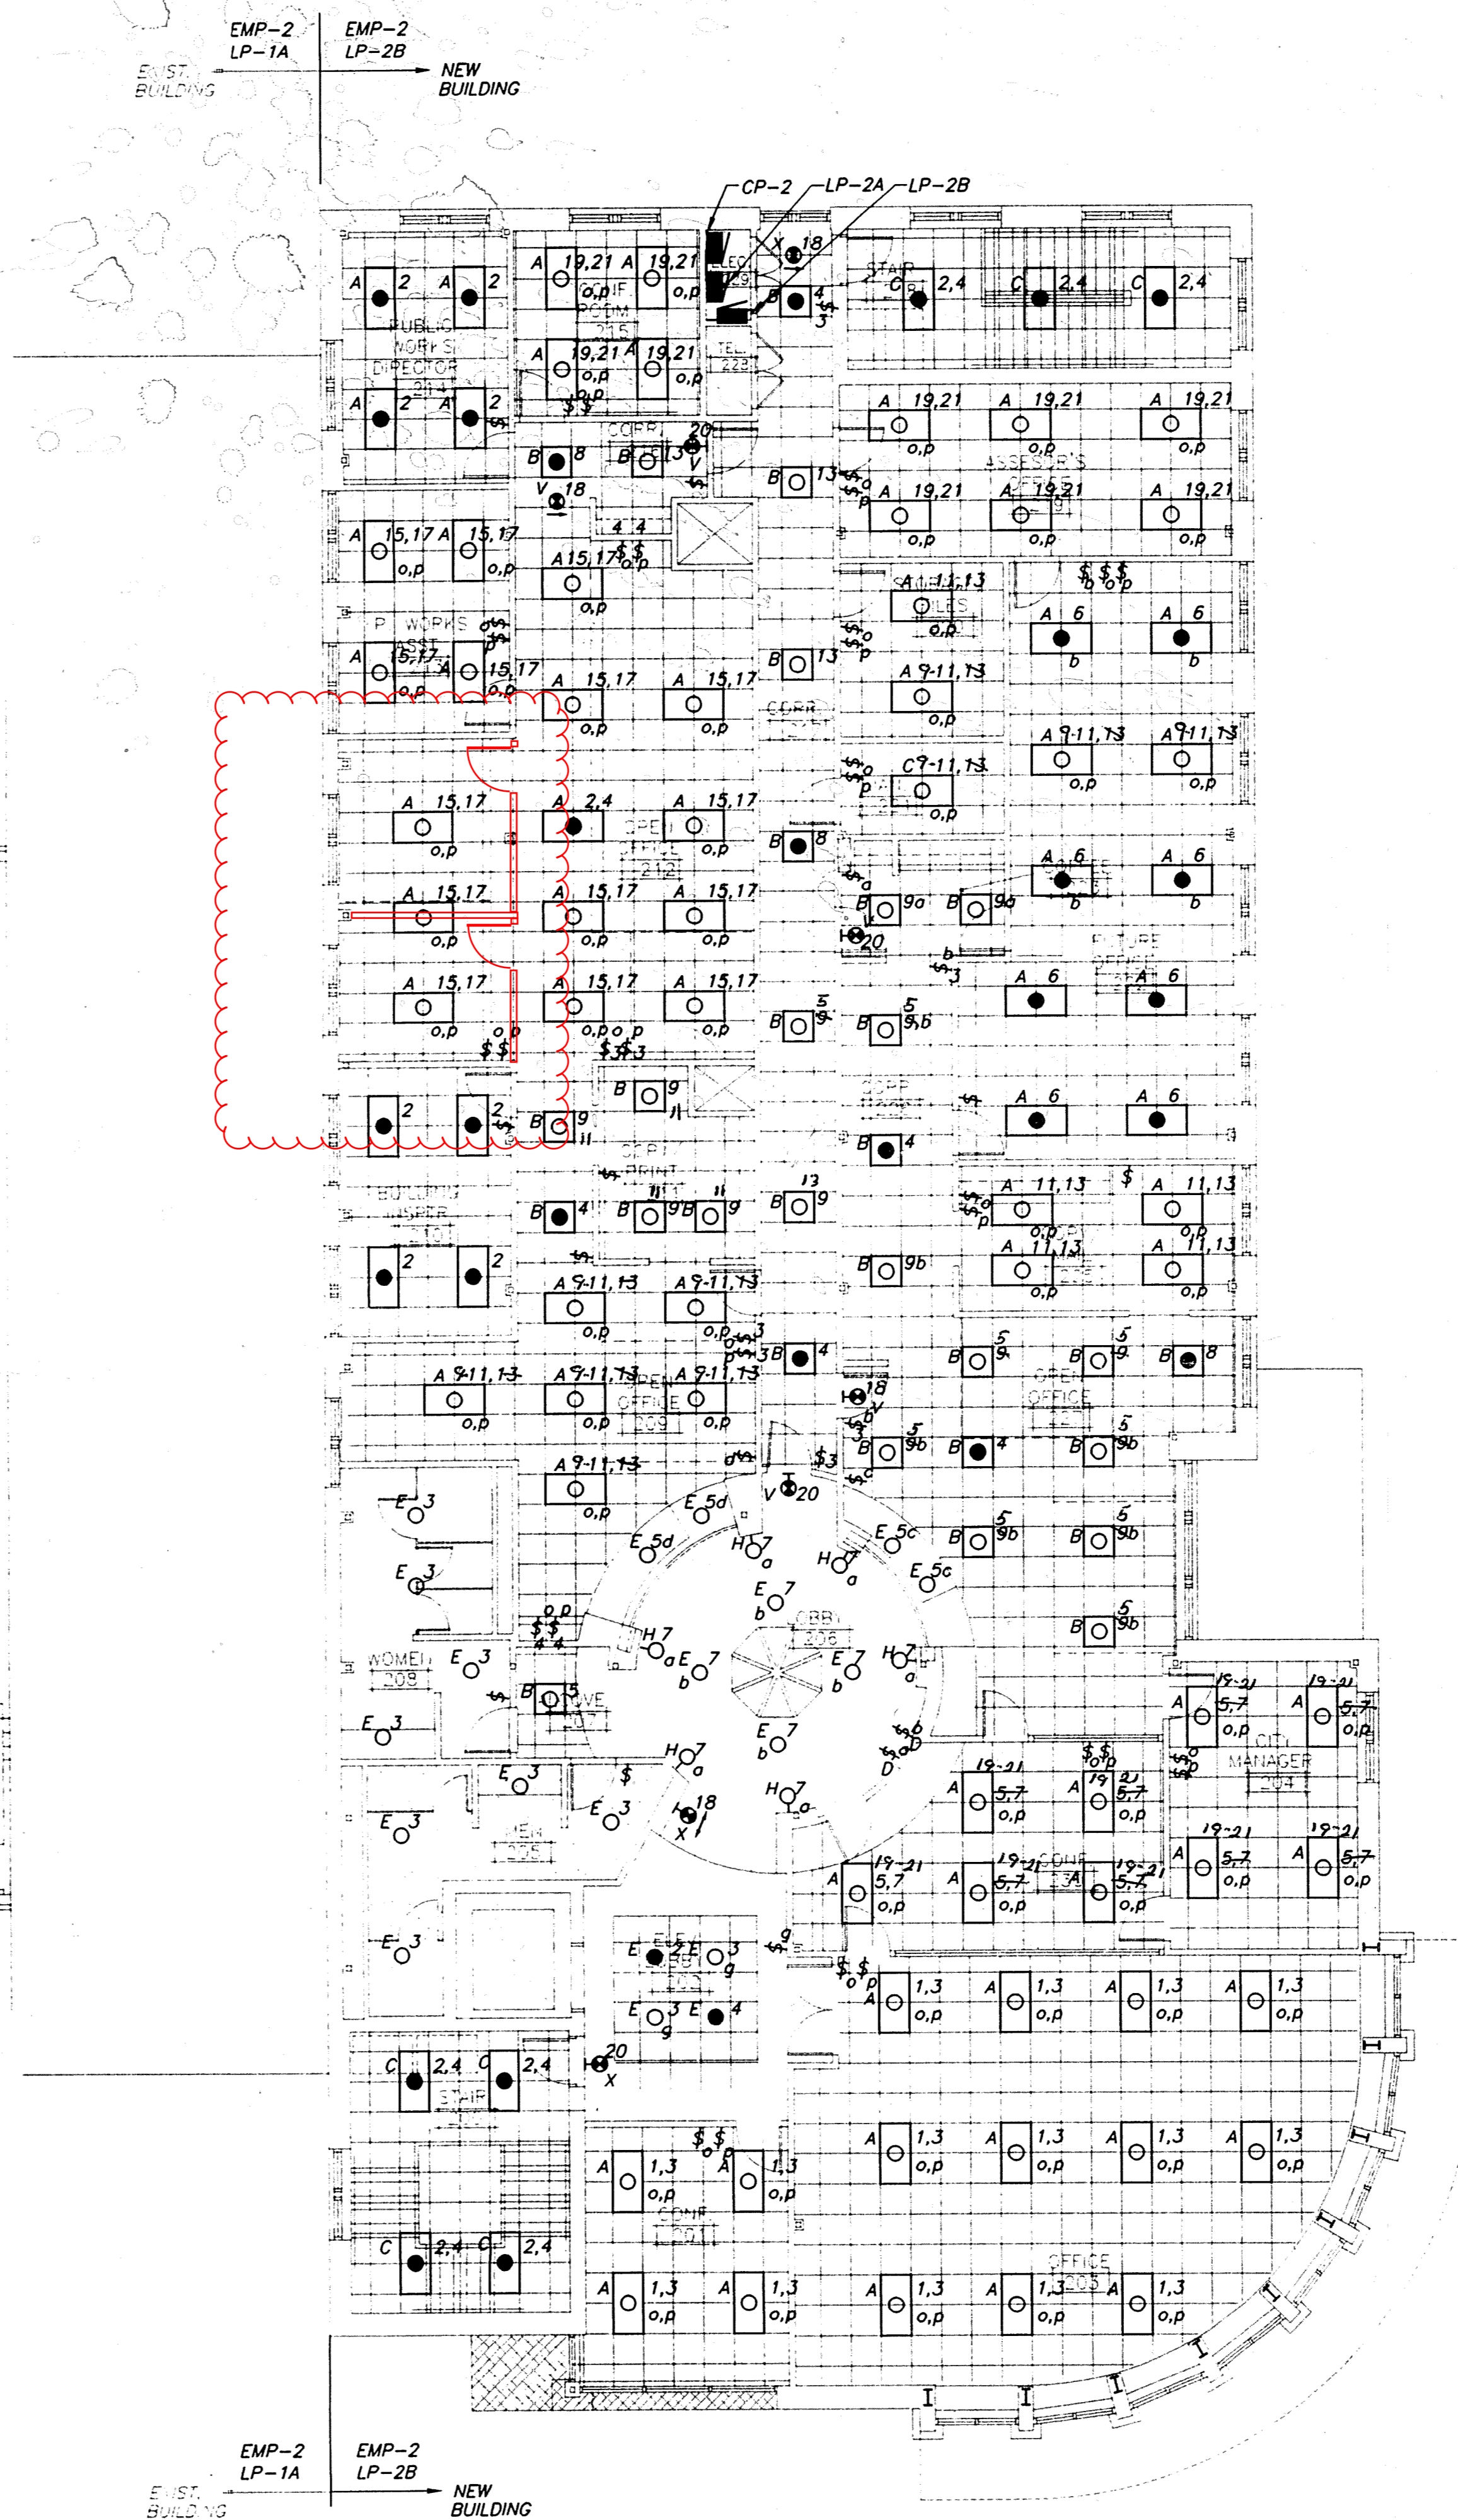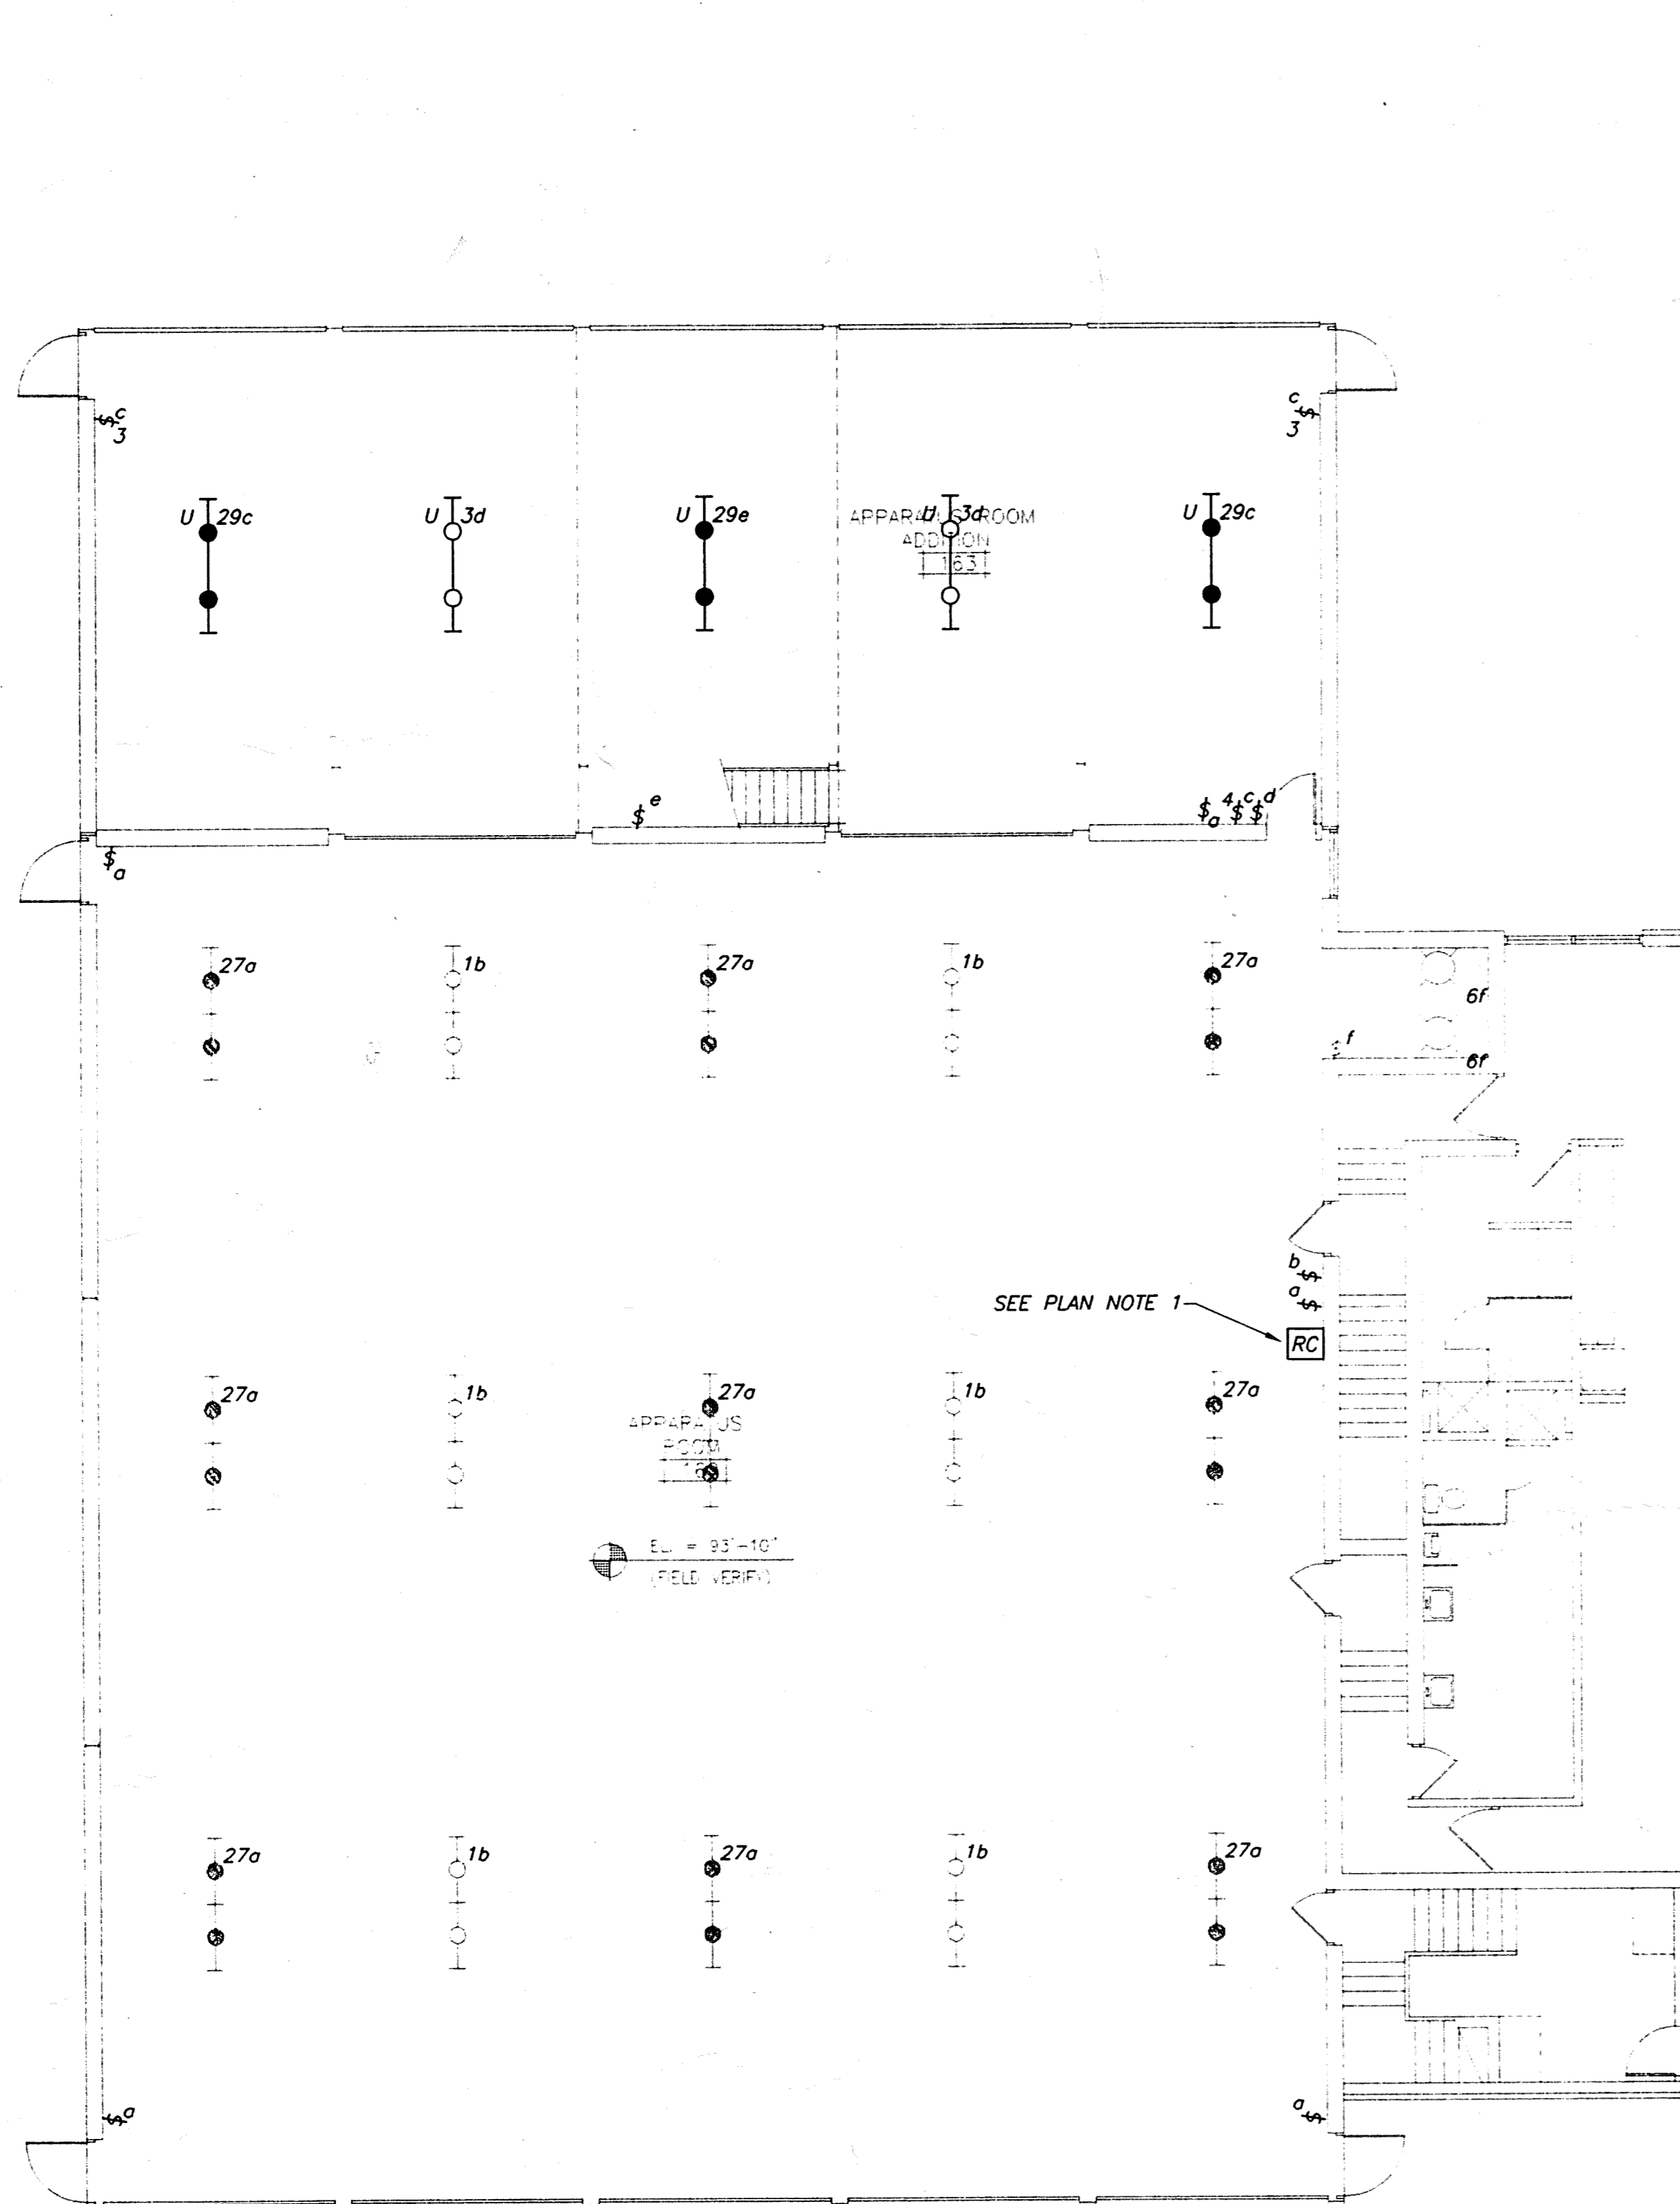

SECOND FLOOR LIGHTING PLAN
1/8" = 1'-0"

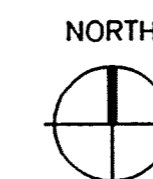

- GENERAL NOTES:**
1. SWITCHING INDICATION *o* TO SWITCH OUTSIDE LIGHTS AND *p* TO SWITCH INSIDE LIGHT.
 2. EXIT LIGHTING TO BE FED FROM PANEL EMP-2.

- PLAN NOTES:**
1. PROVIDE A NEW RELAY CONTROL SYSTEM TO SWITCH GARAGE LIGHTING CIRCUIT *o*. INSTALL RELAY CONTROL PANEL AS SHOWN.

- SYMBOLS:**
- RECESSED FIXTURE
 - A $\frac{2}{b}$ FIXTURE SYMBOL, TYPICAL
A - INDICATES FIXTURE TYPE
2 - INDICATES CIRCUIT TYPE
b - INDICATES SWITCHING
 - (with solid circle) SOLID CIRCLE INDICATES EMERGENCY LIGHTING
 - (with vertical line) FLUORESCENT, RECESSED
 - (with horizontal line) FLUORESCENT, SURFACE OR PENDANT
 - (with vertical line) FLUORESCENT, WALL
 - RC NEW RELAY CABINET FOR GARAGE LIGHTING

8/29/96	ISSUED FOR BIDDING	
Date	Issuance/Revisions	Symbols

**WHITWATER MUNICIPAL BUILDING
ALTERATIONS & ADDITIONS**

WHITWATER, WISCONSIN


Drawing Title:
SECOND FLOOR LIGHTING PLAN

Project Number: 9501700	Sheet No. 10.06
Drawn By: BJH	


GENERAL PLAN NOTES:

SYMBOLS:

- M/R - MANUAL RELEASE
- ⊙ - SMOKE DETECTOR
- ⊕ - HEAT DETECTOR
- ⊠ - MANUAL PULL STATION
- ⊠ - MANUAL PULL/VISUAL ALARM
- ⊠ - AUDIO/VISUAL ALARM
- ⊠ - VISUAL ONLY ALARM
- ⊠ - CLOCK CONTROL PANEL
- ⊠ - FIRE ALARM CONTROL PANEL
- ⊠ - CARD ACCESS CONTROL PANEL
- ⊠ - FIRE ALARM ANNUNCIATOR PANEL
- ⊠ - RESCUE ALARM
- ⊠ - RESCUE ALARM ANNUNCIATOR PANEL
- ⊠ - CARD READER
- ⊠ - REMOTE CAMERA
- ⊠ - CLOSED CIRCUIT TV CONNECTION (BNC TYPE) MONITOR LOCATION

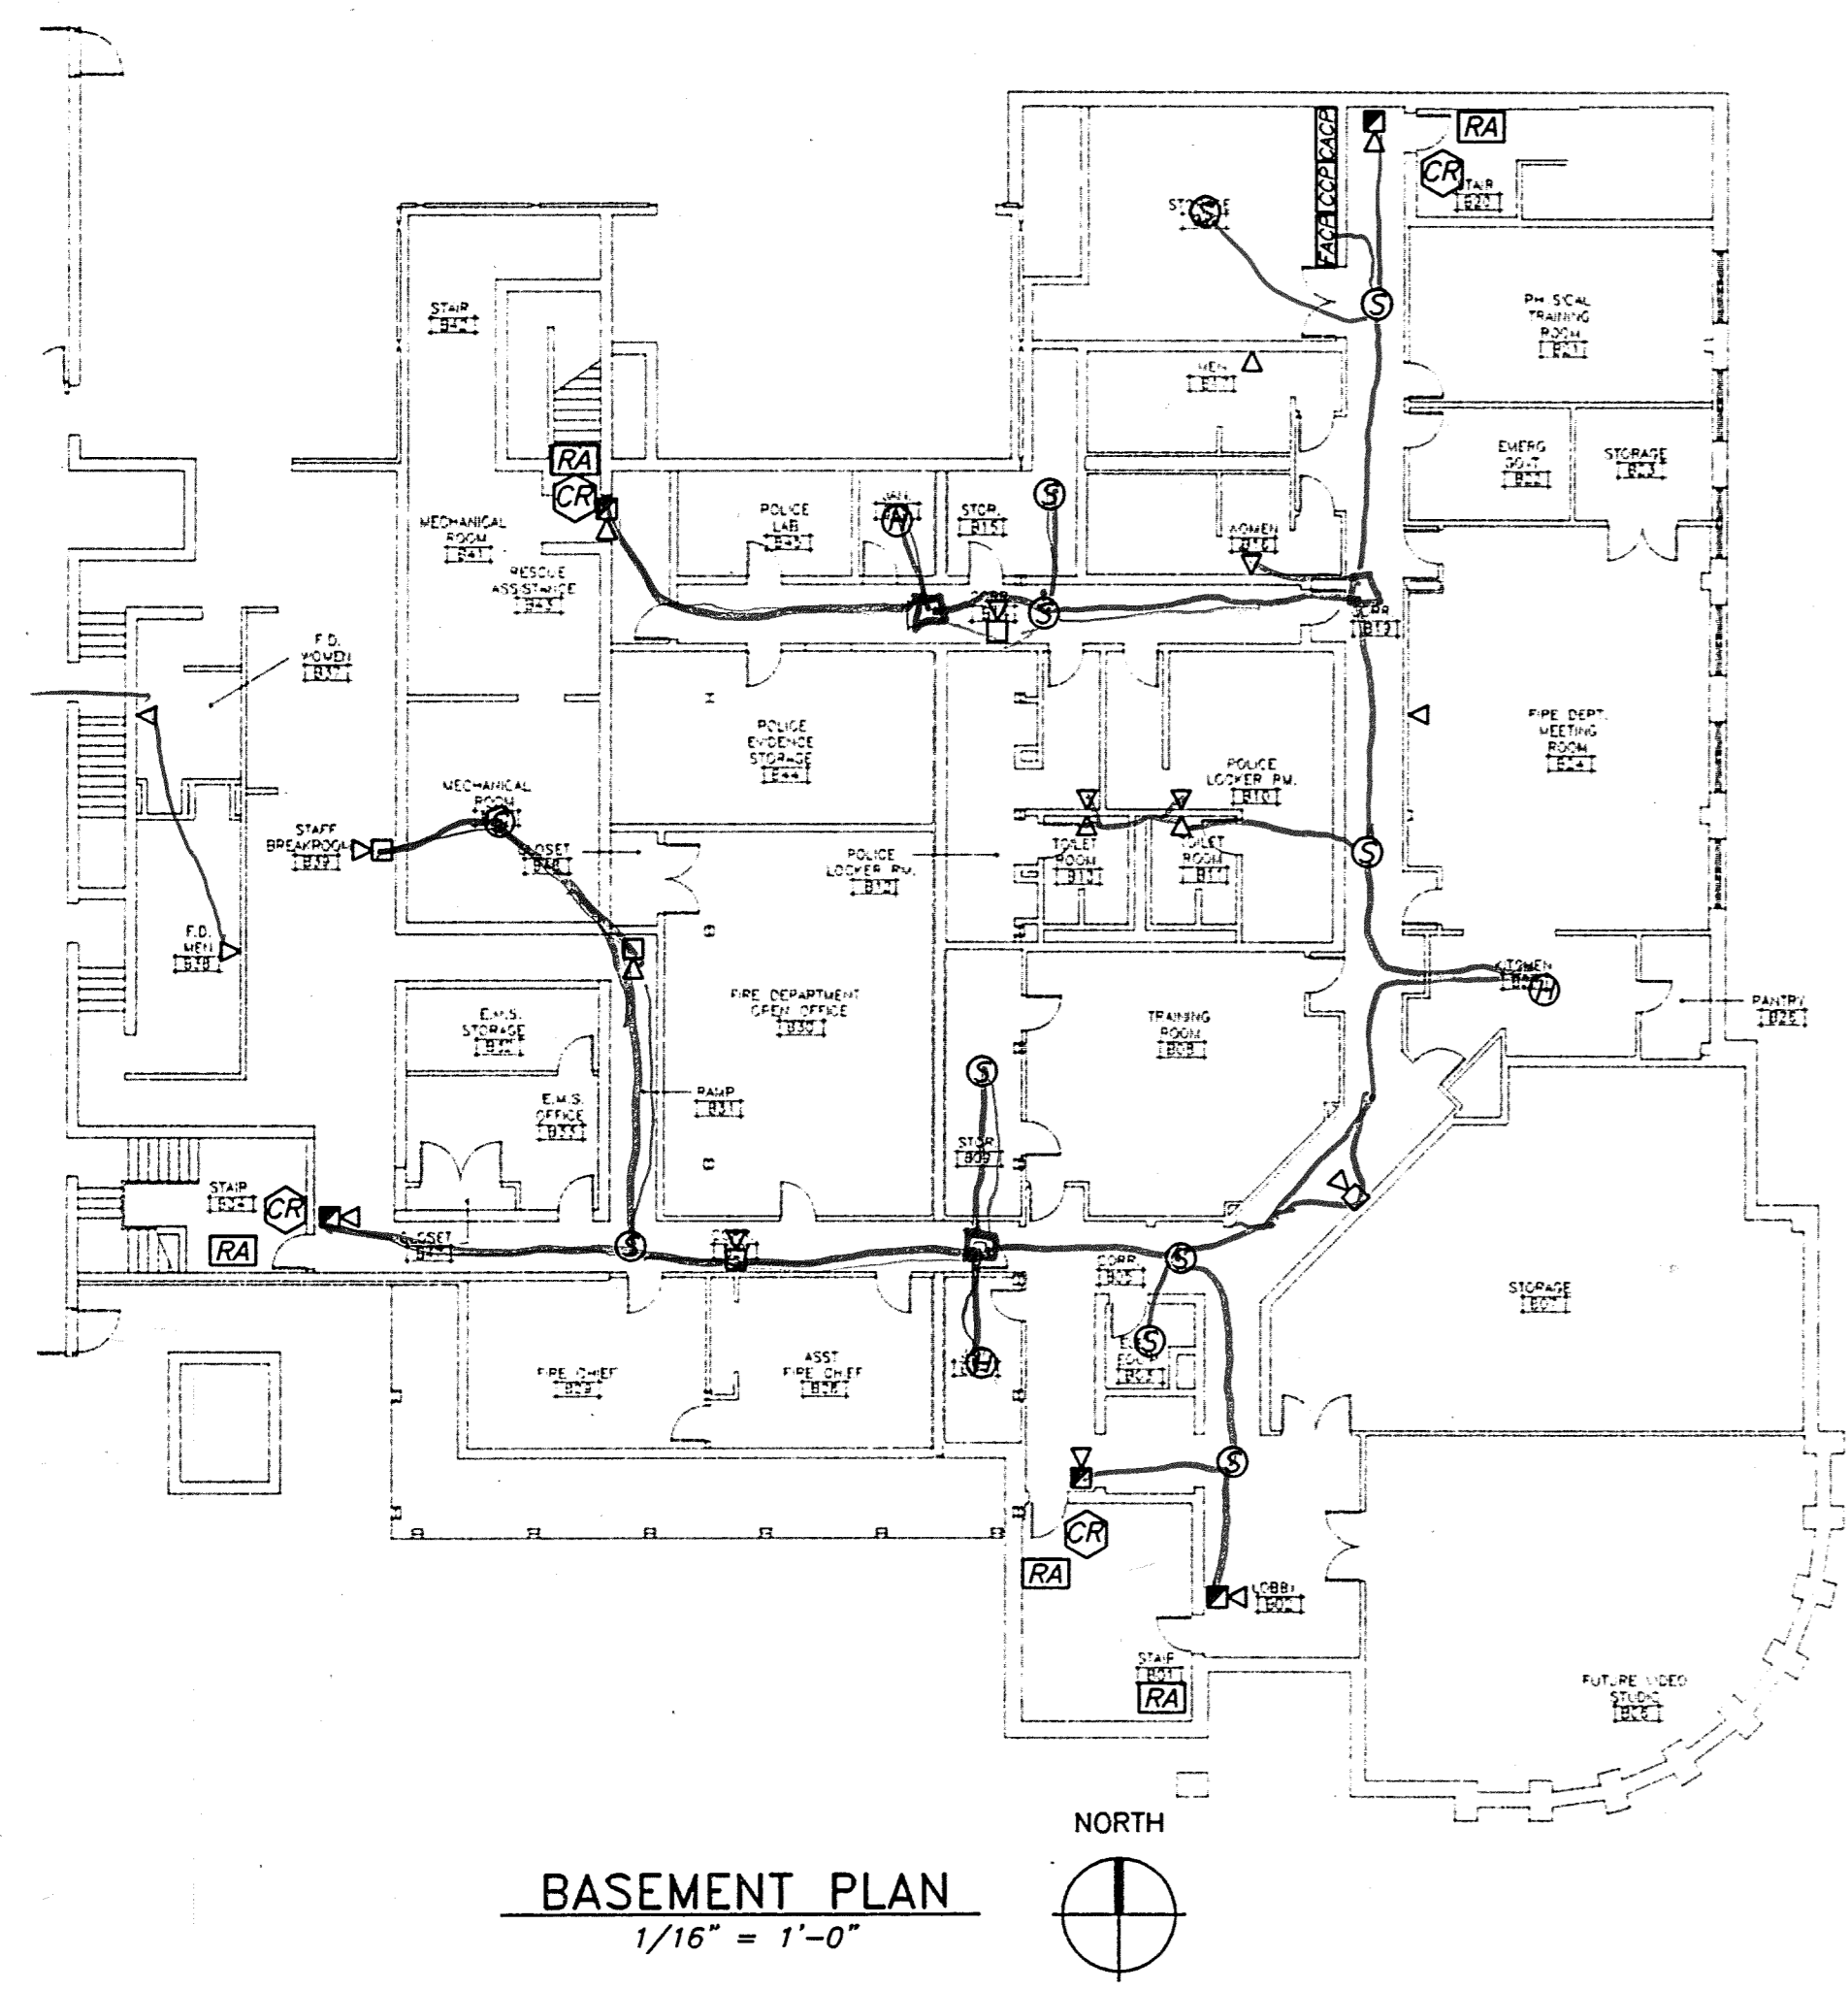


BASEMENT PLAN
1/16" = 1'-0"

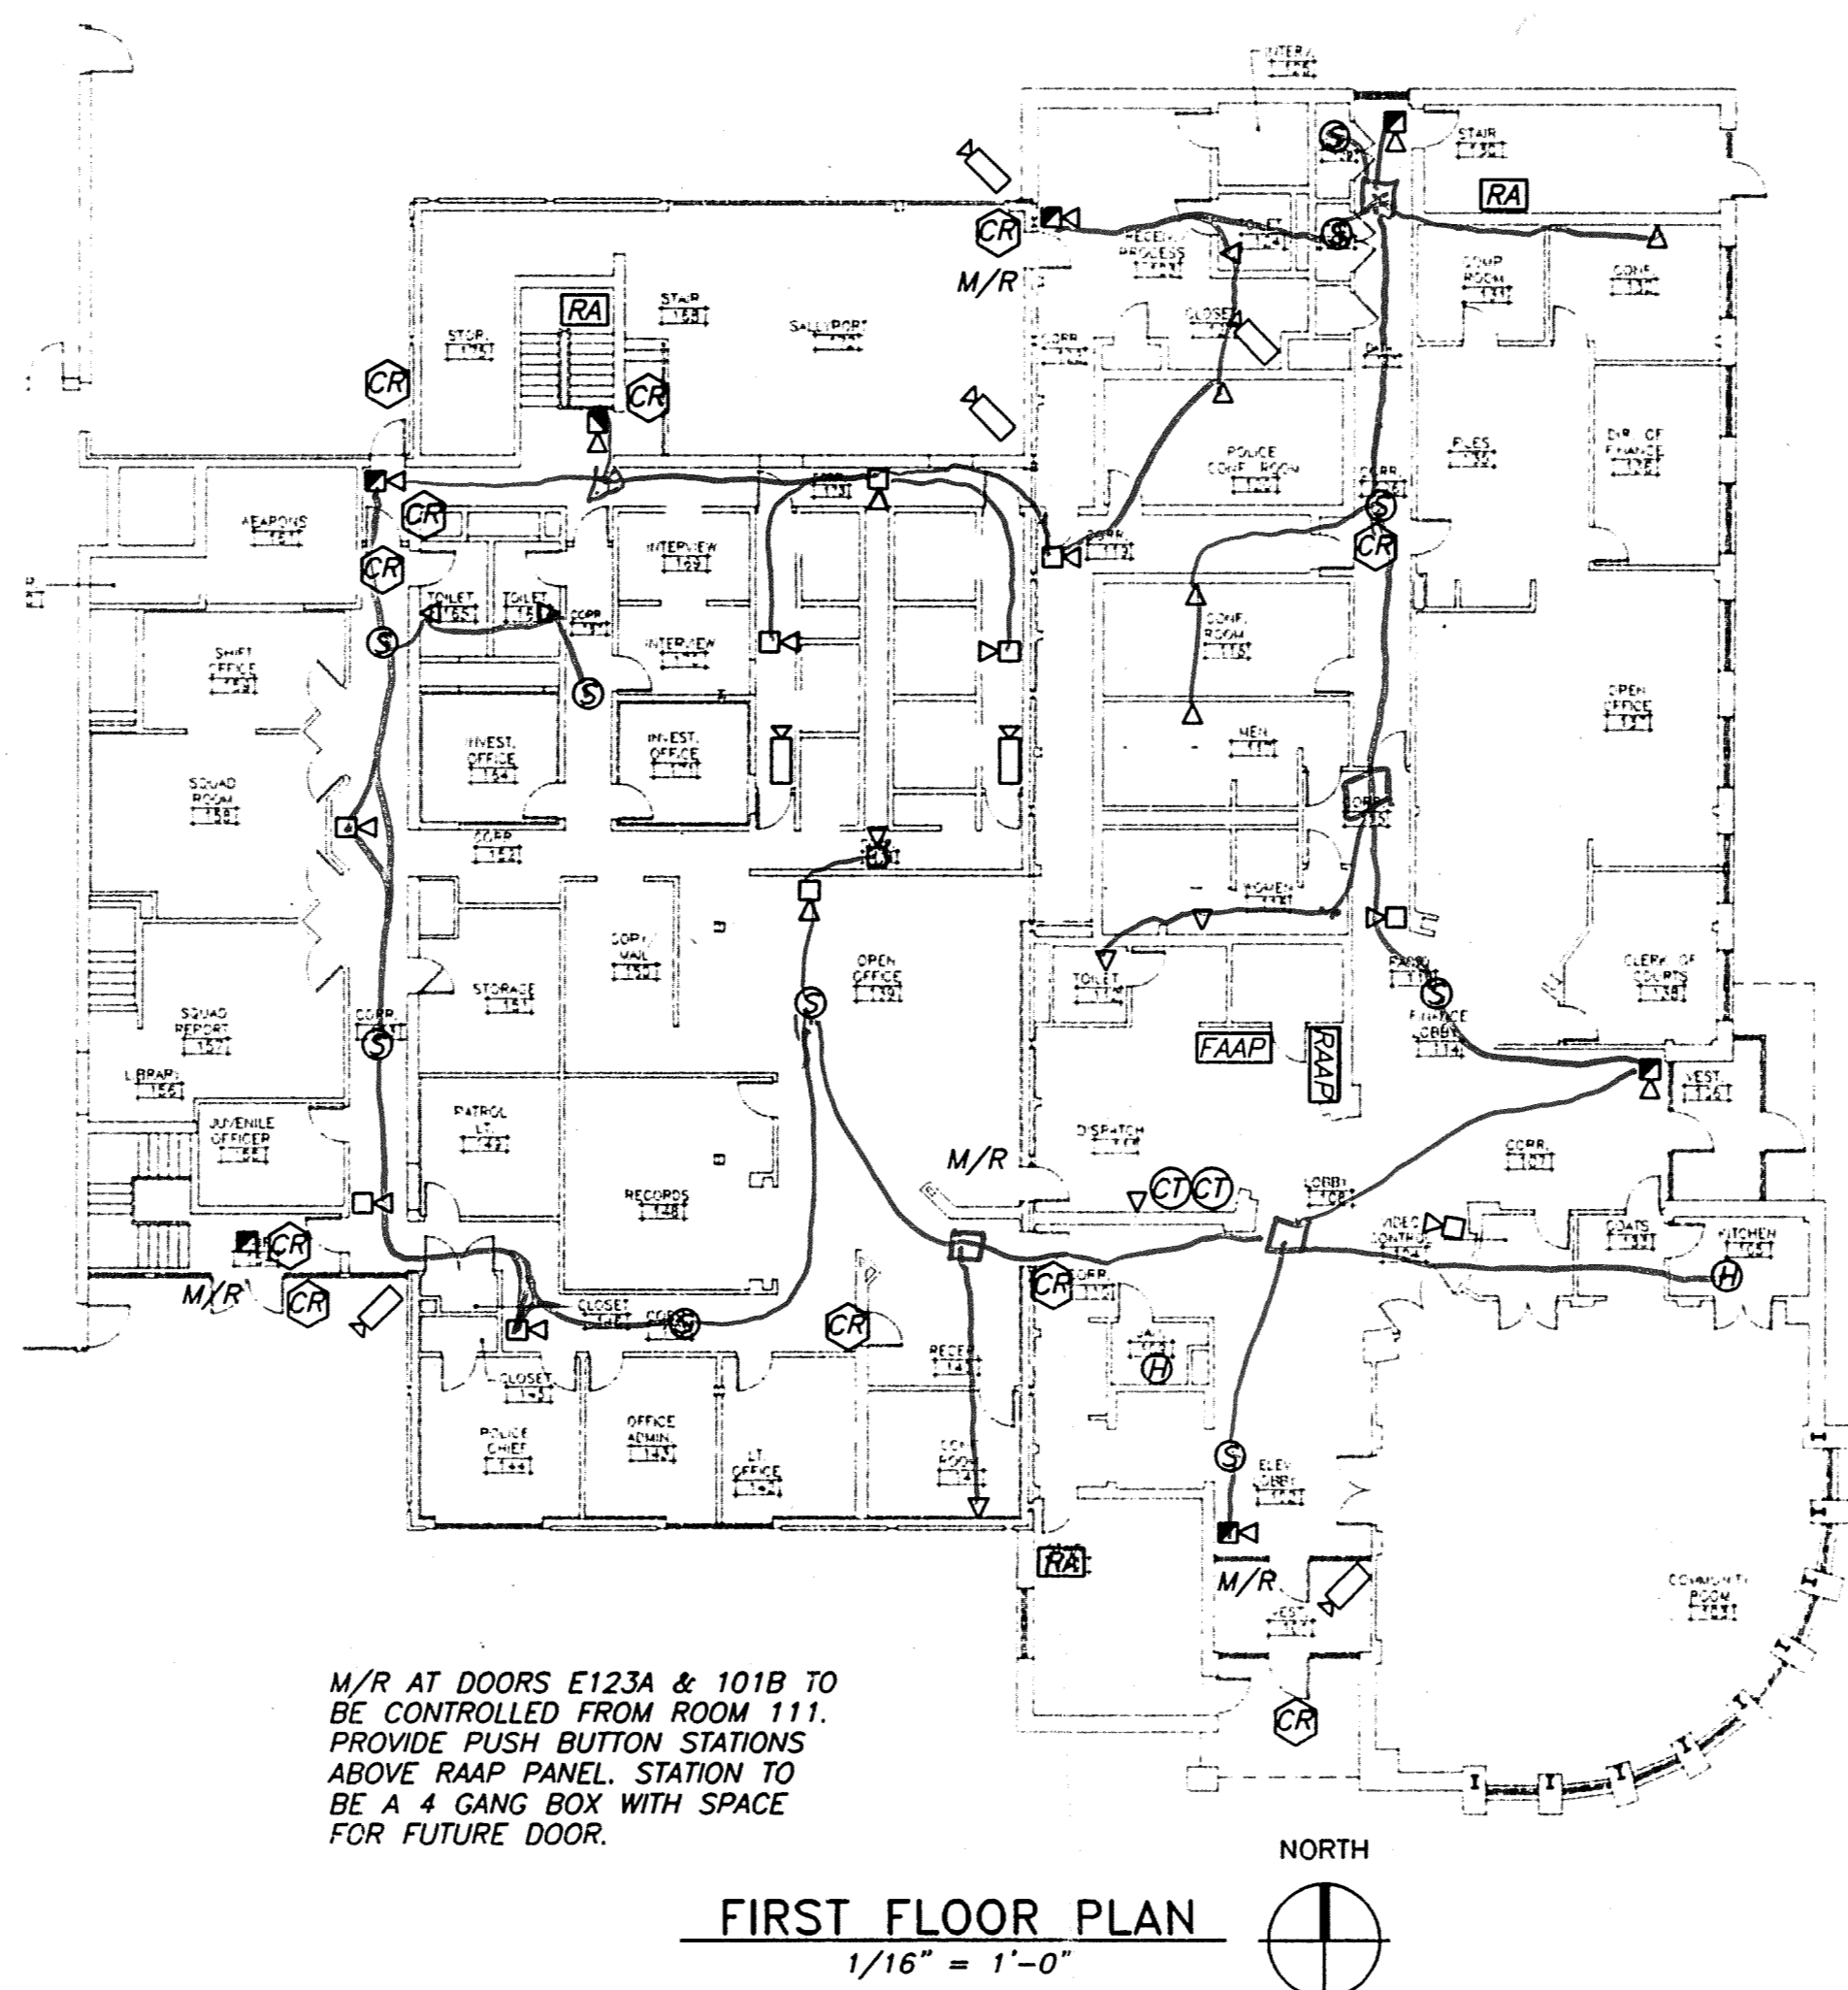


FIRST FLOOR PLAN
1/16" = 1'-0"

M/R AT DOORS E123A & 101B TO BE CONTROLLED FROM ROOM 111. PROVIDE PUSH BUTTON STATIONS ABOVE RAAP PANEL. STATION TO BE A 4 GANG BOX WITH SPACE FOR FUTURE DOOR.

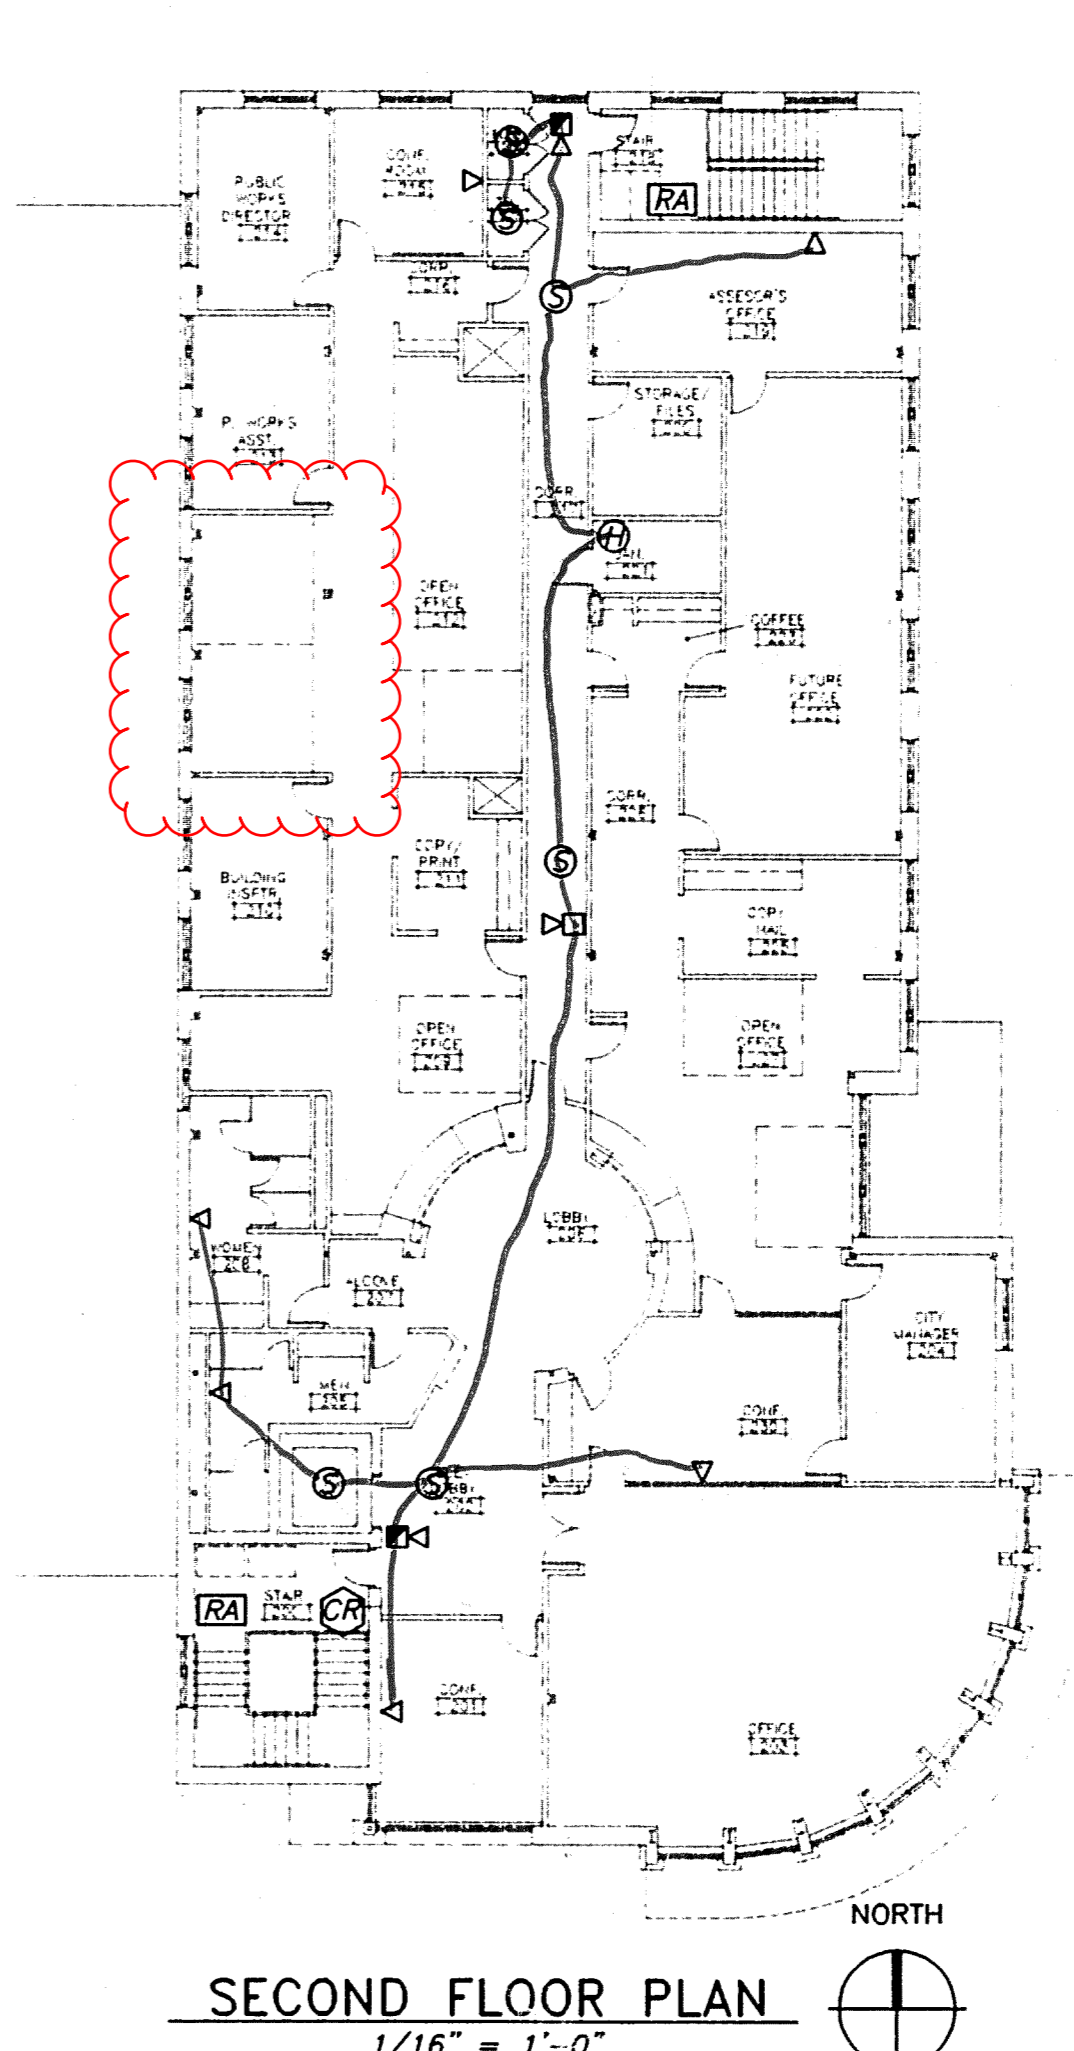


SECOND FLOOR PLAN
1/16" = 1'-0"

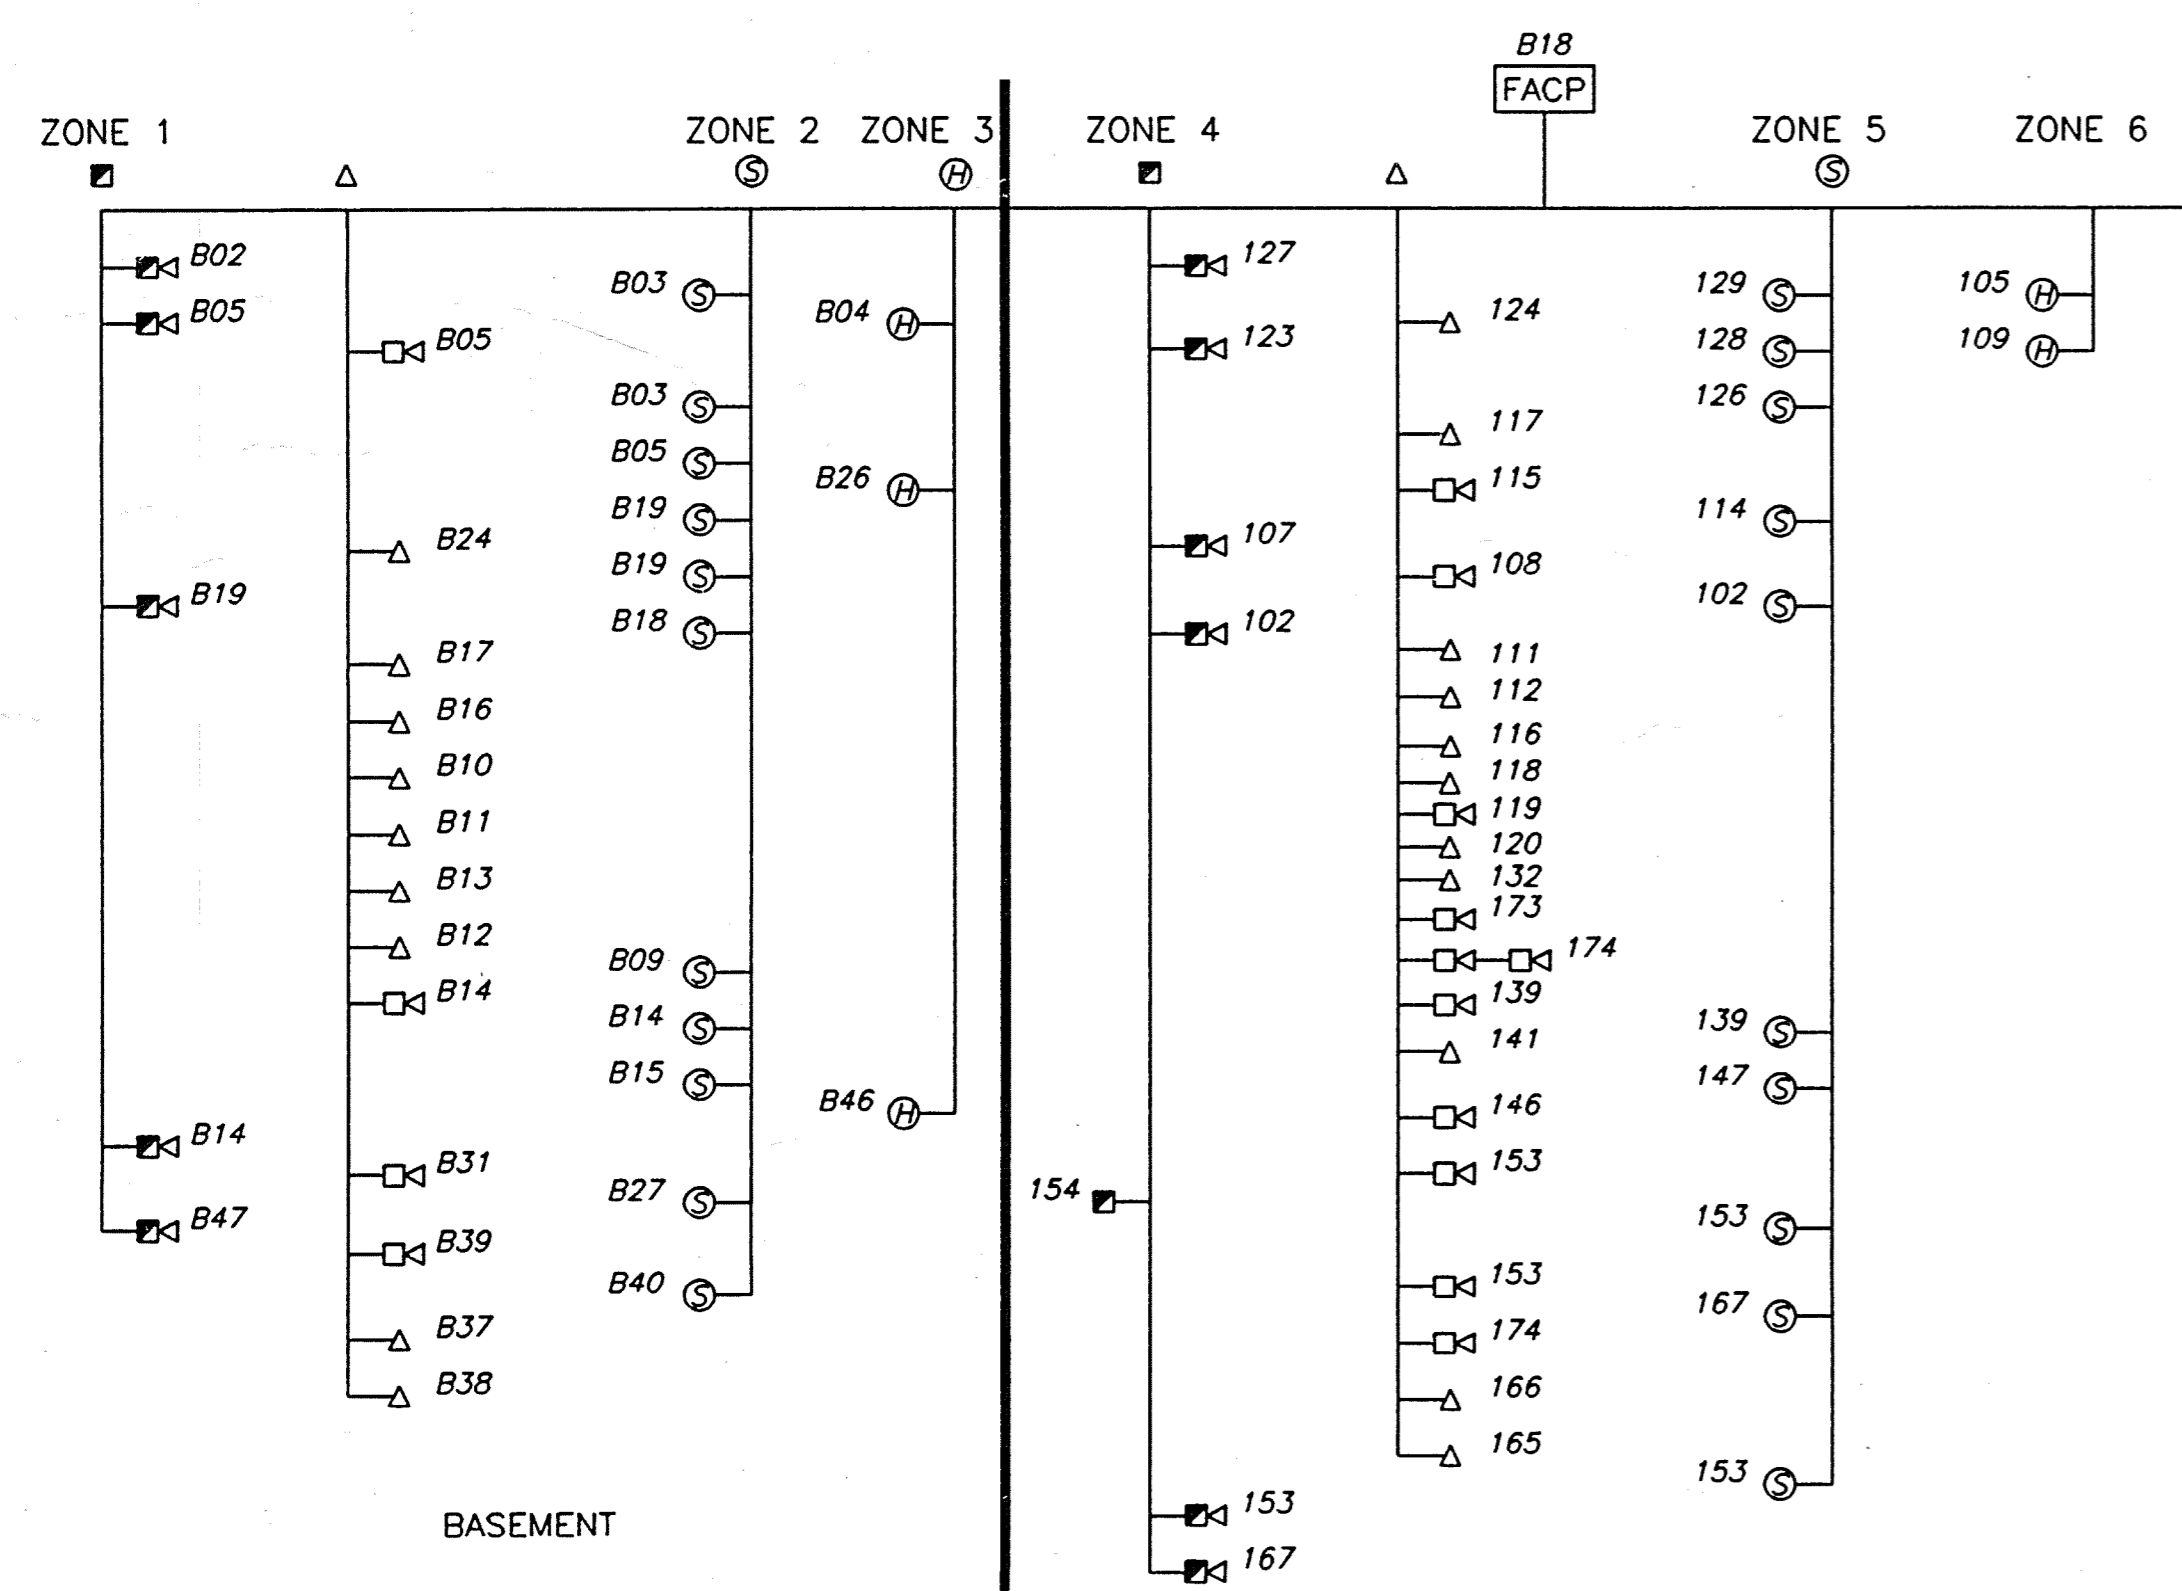


FIRE ALARM RISER


- KEY:**
- ZONE 1 - BASEMENT MANUAL PULL/VISUAL ALARM STATION
 - ZONE 2 - BASEMENT SMOKE
 - ZONE 3 - BASEMENT HEAT
 - ZONE 4 - MAIN FLOOR MANUAL PULL/VISUAL ALARM STATION
 - ZONE 5 - MAIN FLOOR SMOKE
 - ZONE 6 - MAIN FLOOR HEAT
 - ZONE 7 - SECOND FLOOR MANUAL PULL/VISUAL ALARM STATION
 - ZONE 8 - SECOND FLOOR SMOKE
 - ZONE 9 - SECOND FLOOR HEAT

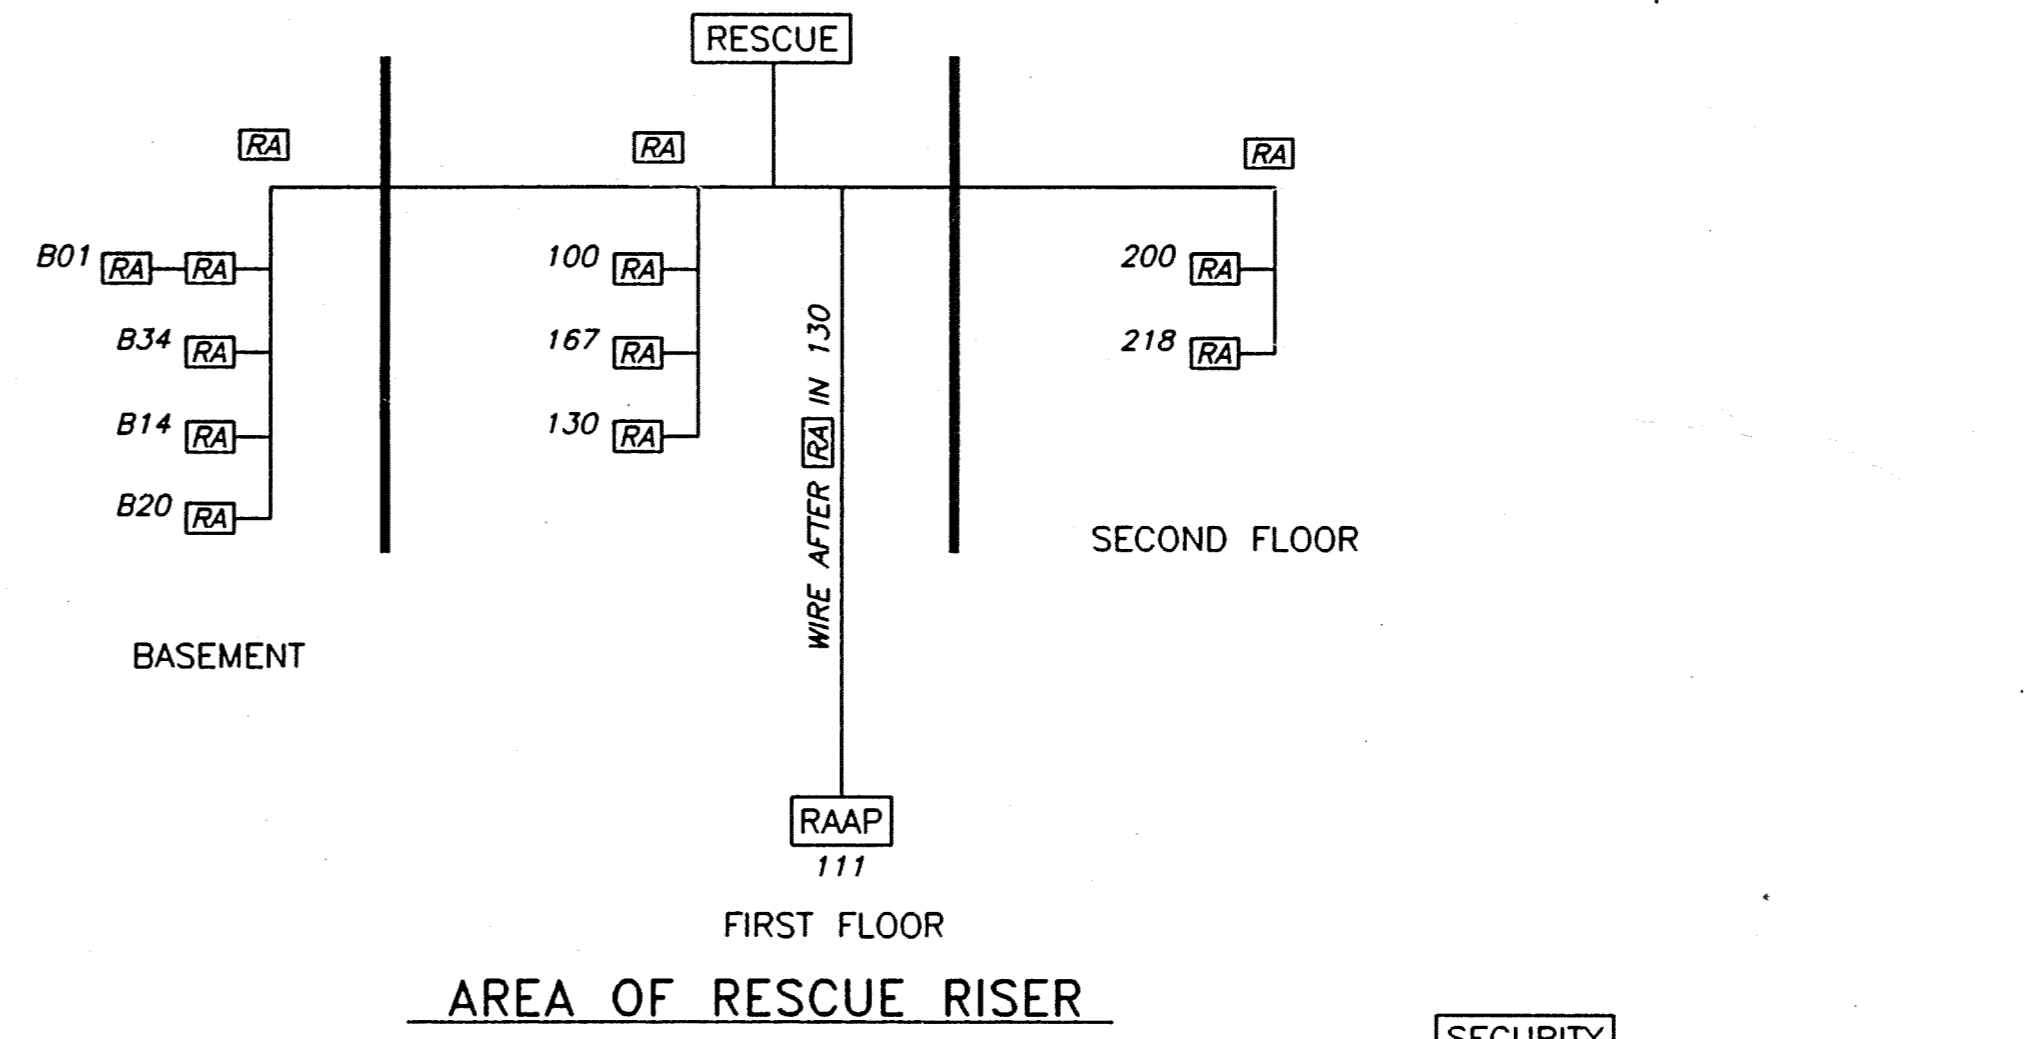

AREA OF RESCUE RISER

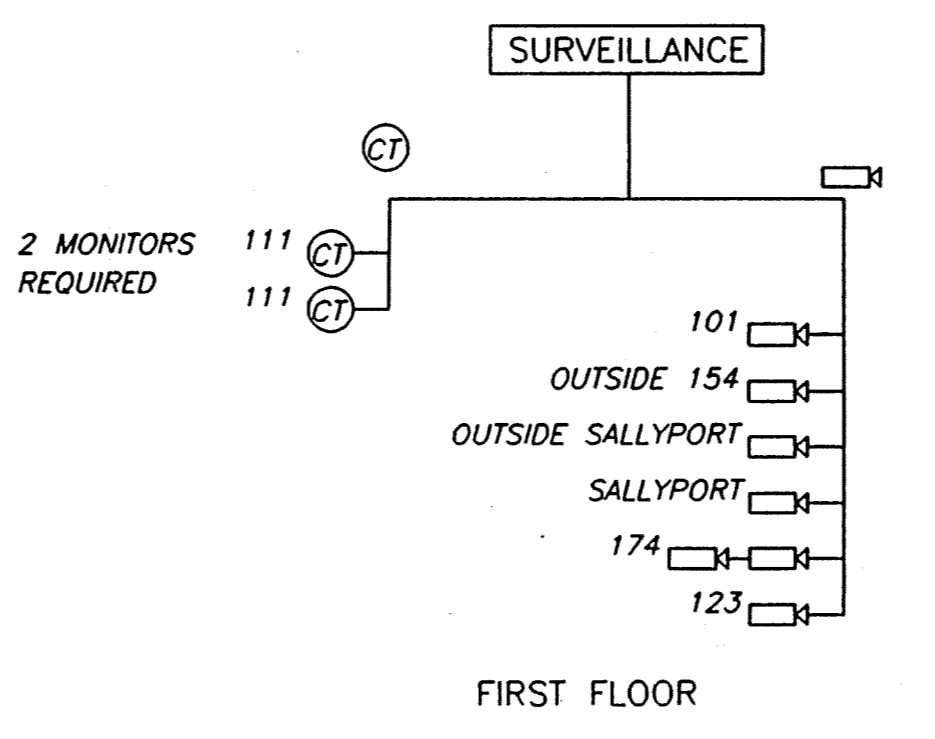

CLOSED CIRCUIT TV RISER

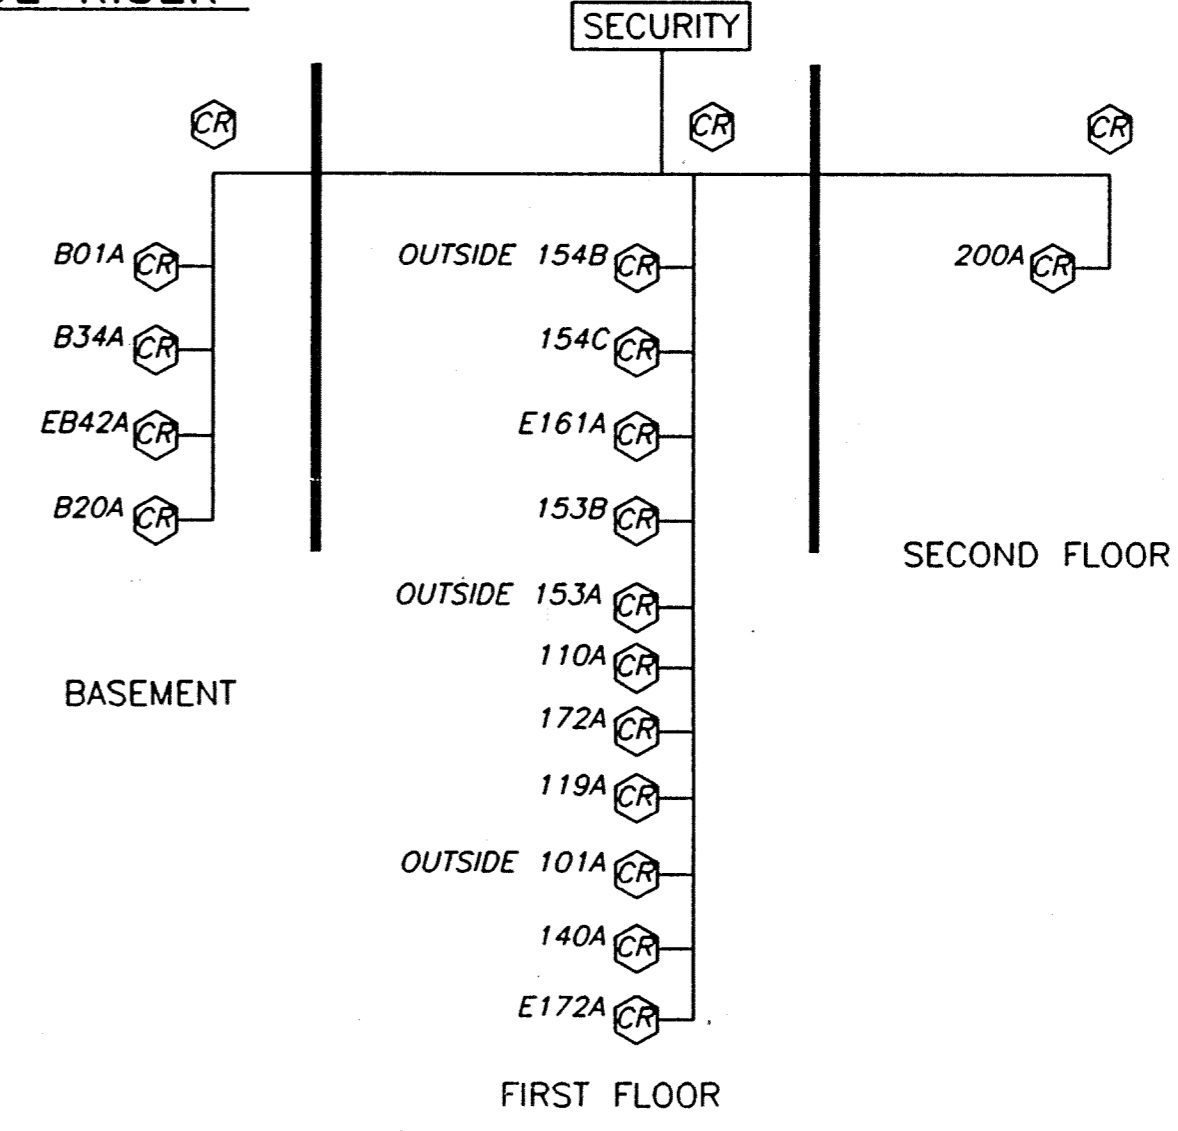

CARD READER LOCK SYSTEM RISER

8/29/96	ISSUED FOR BIDDING	
Date	Issuance/Revisions	Symbols

WHITEWATER MUNICIPAL BUILDING ALTERATIONS & ADDITIONS

WHITEWATER, WISCONSIN

ALARM PLANS AND RISERS

Project Number: 9501700	Sheet No.:
Drawn By: BJH	10.07

FILE: S:\401--450\407\633\ACAD\SETDWG\ALL-PLANDWG DATE: SEP 14, 1996 - TIME: 1:24 PM - CAD TECH: BJH

SERVICE: 120/208V, 3 PHASE, 4 WIRE
 MAIN BREAKER: 200A
 LOCATION: ELEC PANEL RM 129

PANEL CP-1
 ENCLOSURE: NEMA

MOUNTING: SURFACE
 MAIN BUS: 225A CU
 FEEDER: 4 WIRE & GRD

CIRCUIT USE	VA				A	P	VA				A	P	CIRCUIT USE
	L	A	B	C			L	A	B	C			
PC OUTLETS-RM 155,162,164	540				20	1							
PC OUTLETS-RM 155,162,164		540			20	1							
PC OUTLETS-RM 149,169,170,171			540		20	1							
PC OUTLETS-RM 149,169,170,171	540				20	1							
PC OUTLETS-RM 148,150		540			20	1							
PC OUTLETS-RM 148,150			180		20	1							
PC OUTLETS-RM 139,140,141		360			20	1							
PC OUTLETS-RM 139,140,141			540		20	1							
PC OUTLETS-RM 118,132,136,141				540	20	1							
PC OUTLETS-RM 118,132,136,141	540				20	1							
PC OUTLETS-RM 136,137		540			20	1							
PC OUTLETS-RM 136,137			540		20	1							
PC OUTLETS-RM 104,137,138		540			20	1							
PC OUTLETS-RM 104,137,138			540		20	1							
PC OUTLETS-RM 135			180		20	1							
PC OUTLETS-RM 135	180				20	1							
TOTAL PHASE A	2700												2700 VA
TOTAL PHASE B		2700											2700 VA
TOTAL PHASE C			1980										1980 VA
TOTAL CONNECTED LOAD													7380 VA

CONN. LOAD = 23 A
 CL - 25% = 6 A
 SPARE 25% = 8 A
 FEEDER LOAD = 37 A

SERVICE: 120/208V, 3 PHASE, 4 WIRE
 MAIN BREAKER: 200A
 LOCATION: ELEC. PANEL RM 175

PANEL LP-1A
 ENCLOSURE: NEMA

MOUNTING: SURFACE
 MAIN BUS: 225A CU
 FEEDER: 4 WIRE



CIRCUIT USE	VA				A	P	VA				A	P	CIRCUIT USE		
	L	A	B	C			L	A	B	C					
REG. OUTLETS-RM 162	360				20	1							EXISTING LIGHTING		
REG. OUTLETS-RM 162		720			20	1				936			APPARATUS ROOM LIGHTING		
REG. OUTLETS-RM 162			720		20	1					312		OUTDOOR OUTLETS-OLD BUILDING		
REG. OUTLETS-RM 155,159,161,163,175				1080	20	1					1260		OUTDOOR OUTLETS-OLD BUILDING		
REG. OUTLETS-RM 155,159,161,163,175	1080				20	1					1360		FIRST FLR LIGHTING RM 141,147,153,151,152,167		
REG. OUTLETS-RM 155,159,161,163,175			540		20	1					1214		FIRST FLR LIGHTING RM 140,142,143,148,149,155		
REG. O.LRM 141,142,143,144,149,151,164,175	900				20	1					1174		1ST FLR LTG RM 140,142,143,148-150,155,152,156		
REG. O.LRM 141,142,143,144,149,151,164,175				900	20	1					651		FIRST FLOOR LIGHTING RM 139,174		
REG. O.LRM 141,142,143,144,149,151,164,175					20	1						894	1ST FLR LIGHTING RM 166,165,161,169,172,173,175		
REG. OUTLETS-RM 148,150,171,172				1080	20	1					360		GF OUTLETS RMS 165-166-TOILETS		
REG. OUTLETS-RM 148,150,171,172		1260			20	2					1044		VAV MOTORS-ZONES B-C01,C06,C07		
REG. OUTLETS-RM 148,150,171,172			1260		20	2					1044		VAV MOTORS-ZONES B-C01,C06,C07		
REG. OUTLETS-RM 140,141,147,153,173,174	720				20	1					2	1032	VAV MOTORS-ZONES B-C02,C03		
REG. OUTLETS-RM 140,141,147,153,173,174		360			20	1						1032	VAV MOTORS-ZONES B-C02,C03		
REG. OUTLETS-RM 140,141,147,153,173,174				720	20	1						2	1032	VAV MOTORS-ZONES B-C04,C05	
REG. OUTLETS-RM 139,167,169,170,171,173				720	20	1							1032	VAV MOTORS-ZONES B-C04,C05	
REG. OUTLETS-RM 139,167,169,170,171,173					20	1							75	CEILING FAN - SOUTHWEST STAIRWELL	
REG. OUTLETS-RM 139,167,169,170,171,173					20	1									
TOTAL PHASE A	4860									10654 VA				5794	CONN. LOAD = 90 A
TOTAL PHASE B		5400								9874 VA				4474	CL - 25% = 23 A
TOTAL PHASE C			5400							10844 VA				5444	SPARE 25% = 29 A
TOTAL CONNECTED LOAD										31372 VA					FEEDER LOAD = 142 A

SERVICE: 120/208V, 3 PHASE, 4 WIRE
 MAIN BREAKER: 225A
 LOCATION: ELEC PANEL RM 129

PANEL LP-1B
 ENCLOSURE: NEMA

MOUNTING: SURFACE
 MAIN BUS: 225A CU
 FEEDER: 4 WIRE

CIRCUIT USE	VA				A	P	VA				A	P	CIRCUIT USE		
	L	A	B	C			L	A	B	C					
REG. OUTLETS-RM 111,118,125,132,136	1440				20	1							SPARE		
REG. OUTLETS-RM 111,118,125,132,136		1260			20	1				720			GF OUTLETS (TOILETS) RMS.112,116,117,124		
REG. OUTLETS-RM 111,118,125,132,136			1440		20	1							SPARE		
REG. OUTLETS-RM 104,105,137,138		1080			20	1							SPARE		
REG. OUTLETS-RM 104,105,137,138			1440		20	1				1080			OUTDOOR OUTLET (NEW BUILDING)		
REG. OUTLETS-RM 104,105,137,138				1260	20	1				900			OUTDOOR OUTLET (NEW BUILDING)		
REG. OUTLETS-RM 105,119,122,126,128,130		1260			20	1				840			OUTDOOR OUTLET, R,T TYPE LIGHTS		
REG. OUTLETS-RM 105,119,122,126,128,130			1260		20	1				450			P TYPE LIGHTS		
REG. OUTLETS-RM 105,119,122,126,130				1080	20	1				765			M TYPE LIGHTS		
REG. OUTLETS-RM 102,107,109,110,114,115		360			20	1							SPARE		
REG. OUTLETS-RM 102,107,109,110,114,115			720		20	1				1392			VAV MOTORS-ZONE B-B05,B06,B08,A10		
REG. OUTLETS-RM 102,107,109,110,114,115				720	20	1				1392			VAV MOTORS-ZONE B-B05,B06,B08,A10		
FIRST FLOOR LIGHTING RM 103		1340			20	2				1032			VAV MOTORS-ZONE B-A08,A09		
FIRST FLOOR LIGHTING RM 103, 101			1210		20	1				1032			VAV MOTORS-ZONE B-A08,A09		
1ST FLR LIGHTING RM 138,137,136,135,105			1054		20	2				516			VAV MOTORS-ZONE B-B07		
1ST FLR LTG. RM 135-138,105,111-114		1331			20	1				516			VAV MOTORS-ZONE B-B07		
F.F. LTG. RM 115-117,126,119,128,129,124			1370		20	1				1210			1ST FLR LTG. RM 109,110,108,104,107,106,133		
FIRST FLOOR LIGHTING RM 118,122			254		20	1									
FIRST FLOOR LIGHTING RM 118,122,131,132		678			20	1									
TOTAL PHASE A	7489									9877 VA				2388	CONN. LOAD = 110 A
TOTAL PHASE B		7260								13144 VA				5884	CL - 25% = 28 A
TOTAL PHASE C			5808							9381 VA				3573	SPARE 25% = 35 A
TOTAL CONNECTED LOAD										32402 VA					FEEDER LOAD = 173 A

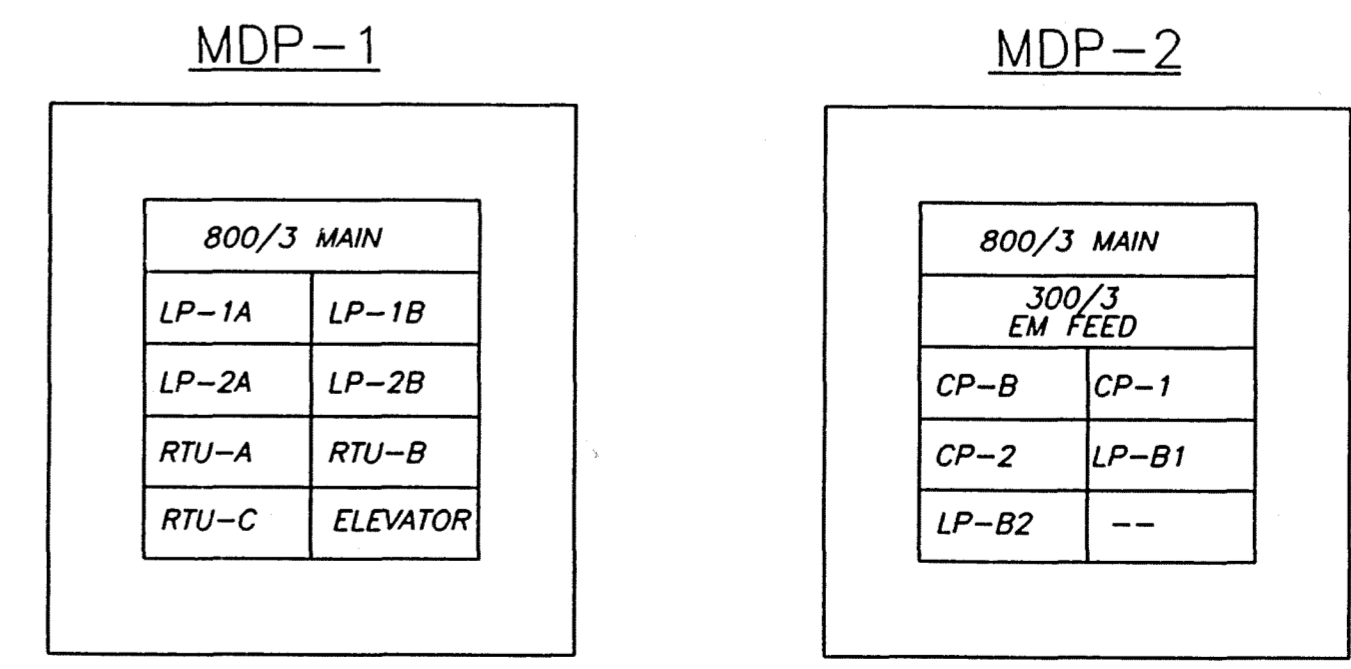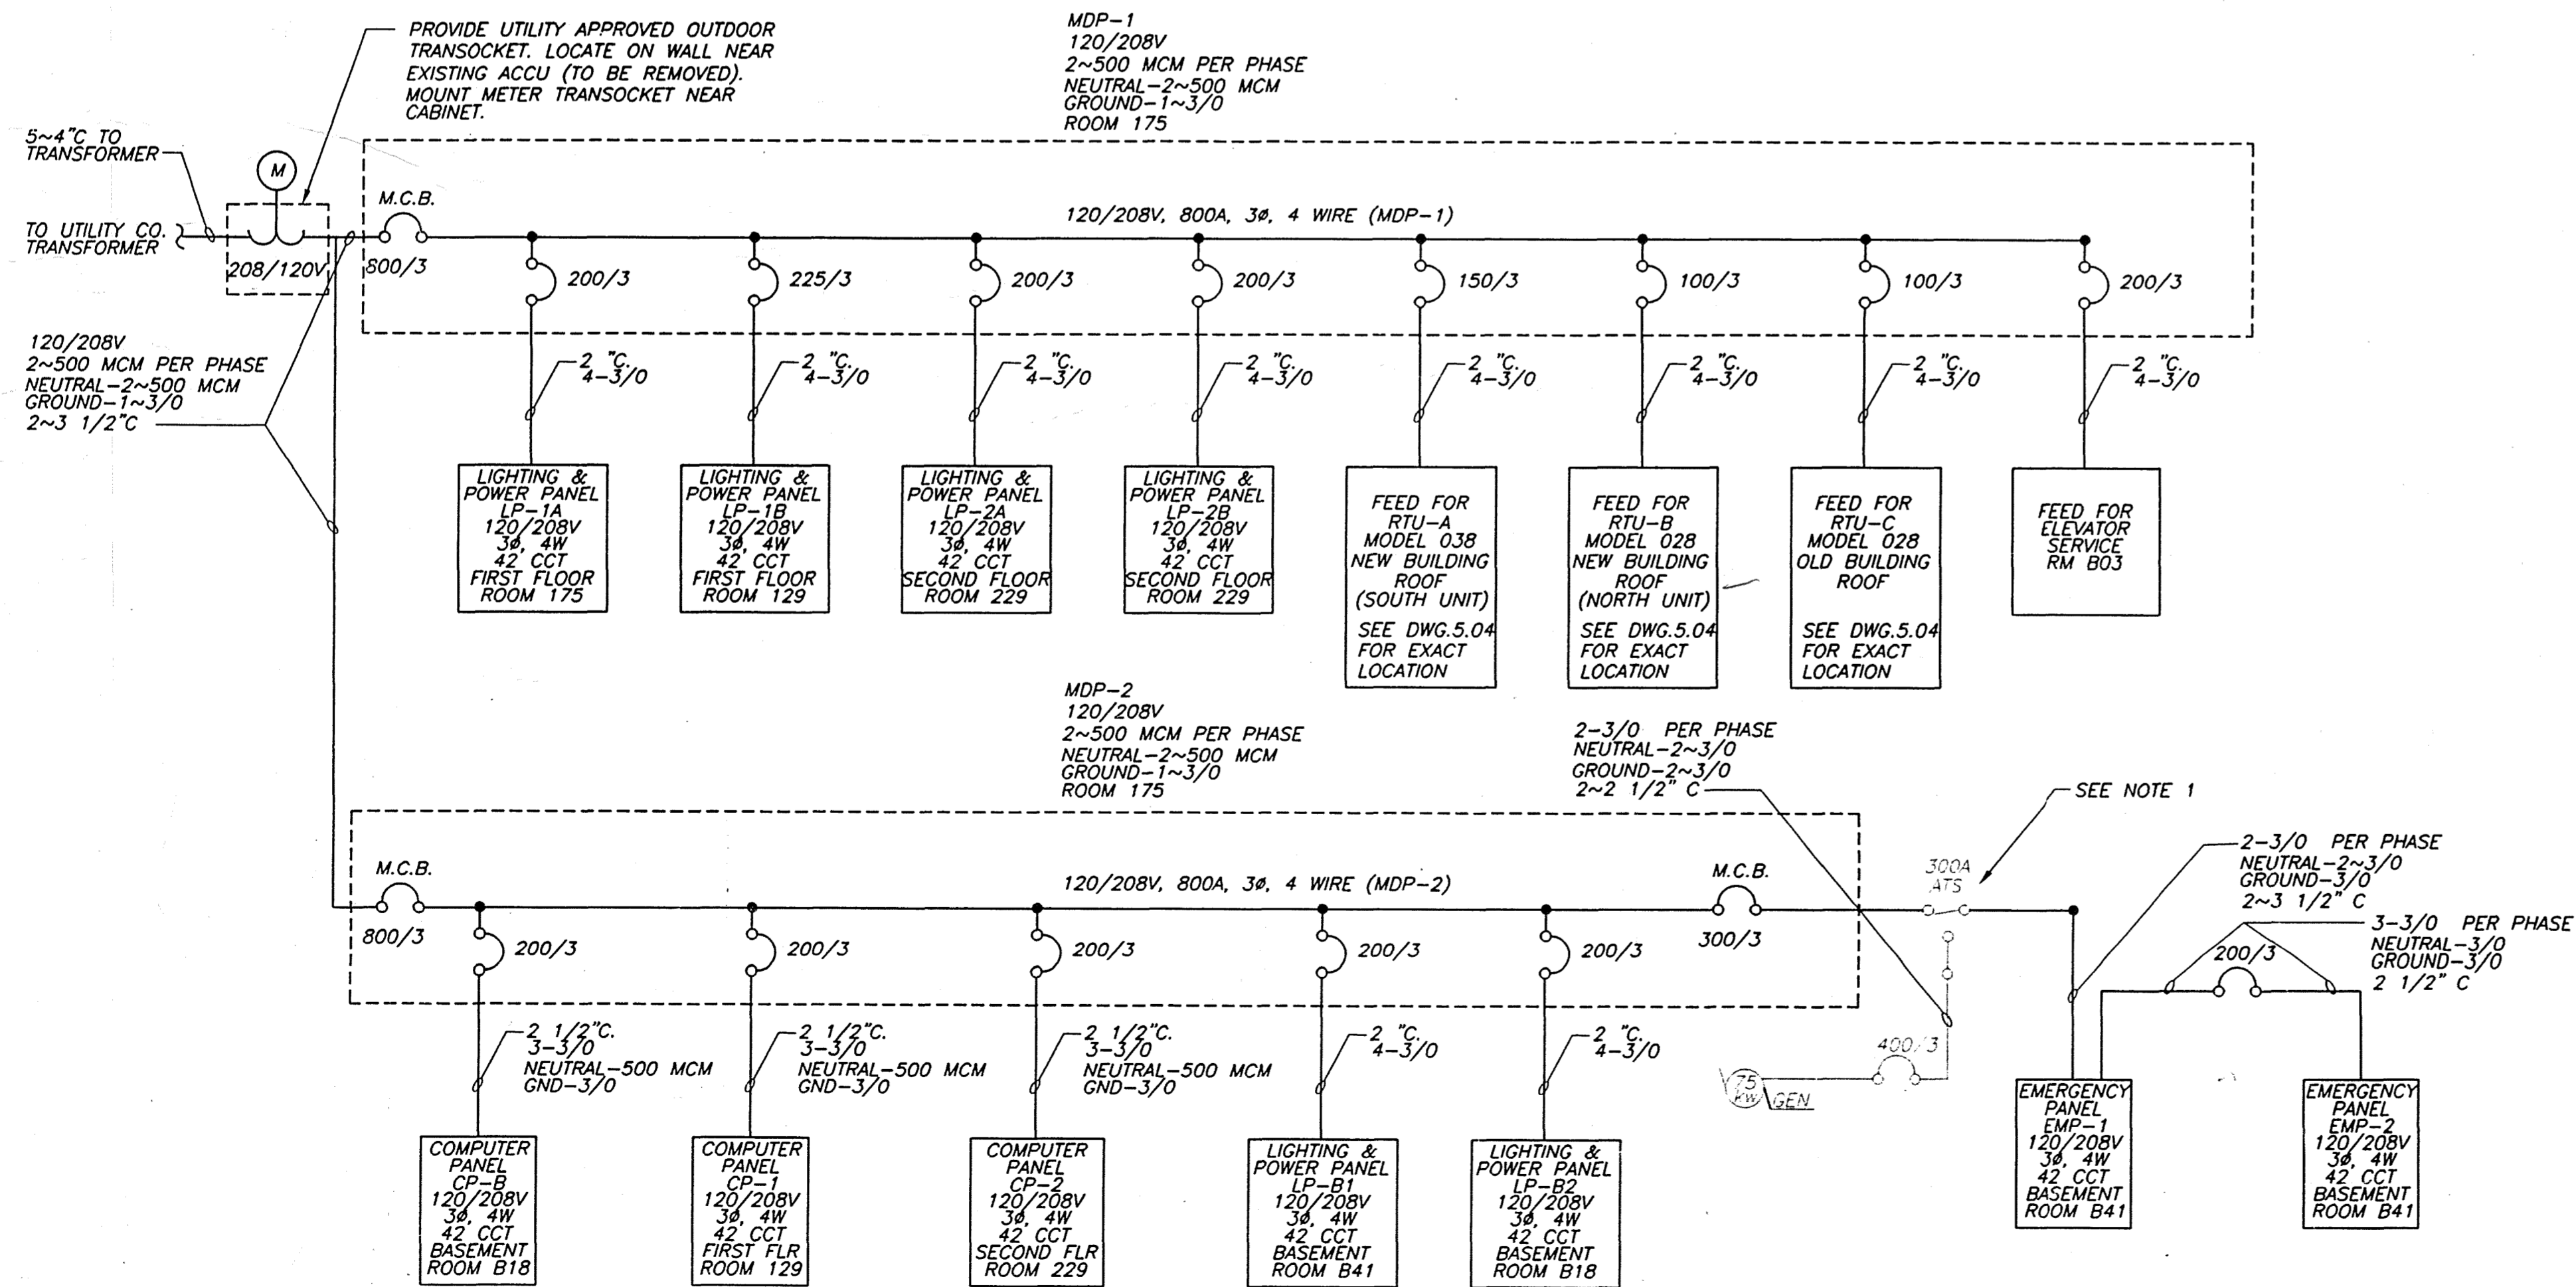

SOD
 HCW 3686-8M, HC 4286 T,
 HC 4286 DB OR EQUAL

PROVIDE BREAKER AS LISTED:
 200A - TYPE KA
 225A - TYPE KA
 300A - TYPE LA
 100A - TYPE KA
 150A - TYPE KA

MAIN PANEL LAYOUT
 NO SCALE

Potter Lawson
 Architects Engineers Interiors



GENERAL PLAN NOTES:

8/29/96	ISSUED FOR BIDDING	
Date	Issuance/Revisions	Symbols

WHITWATER MUNICIPAL BUILDING
 ALTERATIONS & ADDITIONS

WHITWATER, WISCONSIN

Drawing Title:
FIRST FLOOR ELECTRICAL SCHEDULES AND ONE-LINE DIAGRAM

Project Number: 9501700	Sheet No.:
Drawn By: BJH	

10.09

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