

WHITEWATER SOUTH SITE NAME:

SITE GENERAL ARRANGEMENT PLANS

OVERALL UTILITY PLAN

UTILITY PLAN

UTILITY DETAILS GROUNDING DETAILS

GROUNDING DETAILS GROUNDING DETAILS

ELECTRICAL DETAILS

RFE REPORT - PENDING

NOTE: DRAWING SCALES ARE FOR 11"X17" & 22"X34" SHEETS UNLESS OTHERWISE NOTED.

SITE NUMBER: 765538

STRUCTURE TYPE: WATER TANK

FUZE PROJECT ID: 15104581

MDG ID: 5000916433

> THESE PLANS ARE BASED ON RFDS LAST MODIFIED 03/19/2024, GENERAL CONTRACTOR TO VERIFY AND INCORPORATE MOST RECENT VERSION OF RFDS WITH VERIZON PRIOR TO CONSTRUCTION.

> > SHEET INDEX

2025 NEW SITE DEVELOPMENT

PROJECT INFORMATION

SITE NAME: WHITEWATER SOUTH SITE NUMBER: 765538

911 ADDRESS: 797 INDIAN MOUND PARKWAY WHITEWATER, WI 53190

LATITUDE: 42.821264° / 42° 49' 16.55" N LONGITUDE: -88.762231° / 88° 45' 44.03" W GROUND FLEVATION: 872.14' AMSI

JURISDICTION: CITY OF WHITEWATER STRUCTURE TYPE: WATER TANK

FROM APPLETON INTERNATIONAL AIRPORT:

DRIVING DIRECTIONS

GET ON I-41/US-41 S IN MENASHA FROM COUNTY HWY CB/COUNTY RD CB AND W PROSPECT AVE/FOLLOW I-41/US-41 S TO WI-26 S/WI-26 TRUNK S/I-41 ALT IN OSHKOSH. TAKE EXIT 113 FROM I-41/US-41 S/GET ON US-151 S/WI-26 S IN WAUPUN/MERGE ONTO US-151 S/WI-26 S/FOLLOW CO RD A TO WI-26 S/WI-26 TRUNK S IN CLYMAN/FOLLOW WI-26 S/WI-26 TRUNK S AND US-12 E TO COUNTY HWY S IN WHITEWATER/DRIVE TO INDIAN MOUND PKWY IN WHITEWATER/ARRIVE ON SITE.

SCOPE OF WORK

THE WIRELESS COMMUNICATIONS FACILITY IS NOT INTENDED FOR HUMAN

- INSTALLATION OF (3) NEW KRE105281/1 PANEL
- ANTENNAS/RADIO
- INSTALLATION OF (3) NEW AIR 6419 PANEL ANTENNAS/RADIO INSTALLATION OF (6) NEW NHH-65C-R2B PANEL ANTÉNNAS
- INSTALLATION OF (3) NEW HYBRID CABLES
 INSTALLATION OF (3) NEW SURGE PROTECTORS
- INSTALLATION OF (6) NEW REMOTE RADIO UNITS
- INSTALLATION OF (3) NEW ALARM

INSTALLATION OF 11'-0"X4'-0" CONCRETE PAD WITH CABINETS INSTALLATION OF NEW EXTERIOR DIESEL GENERATOR

APPLICABLE CODES & STANDARDS

ALL WORK AND MATERIALS SHALL BE PERFORMED AND INSTALLED IN ACCORDANCE WITH THE CURRENT EDITIONS OF THE FOLLOWING CODES AS ADOPTED WITH ANY LOCAL AMENDMENTS BY THE LOCAL GOVERNING AUTHORITIES:

- 2015 WISCONSIN BUILDING CODE
- 2017 WISCONSIN ELECTRICAL CODE
- 2015 WISCONSIN FIRE CODE
- 2015 WISCONSIN FUEL GAS CODE 2015 WISCONSIN MECHANICAL CODE
- 2015 WISCONSIN ENERGY CONSERVATION CODE

FOR ANY CONFLICTS BETWEEN SECTIONS OF LISTED CODES AND STANDARDS, THE MOST RESTRICTIVE REQUIREMENT SHALL GOVERN.



FIBER COMPANY:

TO BE DETERMINED

POWER COMPANY:

WE ENERGIES 800-972-8856

CONTACTS

APPLICANT: CHICAGO SMSA LIMITED PARTNERSHIP D/B/A VERIZON WIRELESS

701 GOLF ROAD TOWER 2, SUITE 400 ROLLING MEADOWS, IL 60008 CONTACT: OCTAVIO HERRERA

Octavio.herrera.verizonwireless.com

PROPERTY OWNER:

CITY OF WHITEWATER 312 WHITEWATER STREET CONTACT: BRAD MARQUARDT

bmarquardt@whitewater-wi.gov

262-473-0139

ARCHITECT/ENGINEER:

MOUNTAIN LTD. ENGINEERING CONTACT: LUIS MENDOZA (949) 338-6143

luis.mendoza@mountainltd.com



AERIAL MAP

VICINITY MAP

TITLE SHEET 0 N1.0 GENERAL SPECIFICATIONS N1.1 GENERAL SPECIFICATIONS Ω SITE SURVEY (BY OTHERS, PENDING) SITE GRADING AND EROSION CONTROL PLAN Ω $A \cap \cap$ OVERALL SITE PLAN A1.0 PROPOSED COMPOUND PLAN 0 ENLARGED EQUIPMENT PLAN A2.0 TOWER ELEVATION Ω A2.1 PROPOSED ANTENNA PLAN A2.2 ANTENNA MOUNT AND INSTALLATION DETAILS 0 A2.3 TOWER BELL SECTION & TOWER BELL HYBRID ROUTING A3.0 RF SUMMARY 0 RF SUMMARY A3.2 ANTENNA PLUMBING DIAGRAM 0 A4.0 ANTENNA DETAILS 0 A4.1 EQUIPMENT DETAILS 0 A4.2 FOUIPMENT DETAILS 0 1_{44.3} ICE BRIDGE AND GPS DETAILS 0 A4 4 GROUND EQUIPMENT SPECIFICATIONS Ω A4.5 GROUND EQUIPMENT SPECIFICATIONS 0 A4.6 GROUND EQUIPMENT SPECIFICATIONS 0 A4.7 EQUIPMENT PAD ELEVATIONS 0 A4.8 EQUIPMENT PAD FOUNDATION DETAILS 0 A4 9 GENERATOR SPECIFICATIONS 0 GENERATOR PAD FOUNDATION DETAILS 0 A4.11 FENCE DETAILS 0 A4.12 SIGNAGE DETAILS Ω SITE DETAILS COMPOUND GROUNDING PLAN 0

PREPARED FOR-SITE NAME

WHITEWATER

SOUTH SITE NUMBER:

765538

SITE ADDRESS: 797 INDIAN MOUND PARKWAY WHITEWATER, WI 53190 WALWORTH COUNTY

REVISION





	DRAV	VN BY:	DP		
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GENERAL

THE CONSTRUCTION DRAWINGS AND SPECIFICATIONS ARE INTERRELATED WHEN PERFORMING THE WORK. EACH CONTRACTOR MUST REFER TO ALL DRAWINGS. COORDINATION IS THE RESPONSIBILITY OF THE GENERAL CONTRACTOR.

DIVISION 1: GENERAL REQUIREMENTS

SECTION 01700 - PROJECT CLOSEOUT

PART 1 - GENERAL

- OBTAIN AND SUBMIT RELEASES ENABLING THE OWNER UNRESTRICTED USE OF THE WORK AND ACCESS TO SERVICES AND UTILITIES. INCLUDE OCCUPANCY PERMITS. OPERATING CERTIFICATES. AND SIMILAR RELEASES.
- 2. SUBMIT RECORD DRAWINGS, DAMAGE, OR SETTLEMENT SURVEY, PROPERTY SURVEY, AND SIMILAR FINAL RECORD INFORMATION.
- 3. COMPLETE FINAL CLEAN-UP REQUIREMENTS, INCLUDING TOUCH-UP PAINTING.
 TOUCH-UP AND OTHERWISE REPAIR AND RESTORED MARRED EXPOSED
 FINISHES.

PART 2 - FINAL CLEANING/PROJECT CLOSEOUT

- COMPLETE THE FOLLOWING OPERATIONS BEFORE REQUESTING INSPECTION FOR CERTIFICATE OF COMPLETION:
 - A. CLEAN THE PROJECT SITE, YARD AND GROUNDS IN AREAS DISTURBED BY CONSTRUCTION ACTIVITIES, INCLUDING LANDSCAPE DEVELOPMENT, AREAS OF RUBBISH, WASTE MATERIALS, LITTER AND FOREIGN SUBSTANCES. SWEEP PAVED AREAS BROOM CLEAN. REMOVE PETRO-CHEMICAL SPILLS, STAINS AND OTHER FOREIGN DEPOSITS. RAKE GROUND THAT ARE NEITHER PLANTED NOR PAVED TO A SMOOTH, EVEN-TEXTURED SURFACE.
 - B. REMOVE TOOLS, CONSTRUCTION EQUIPMENT, MACHINERY, AND SURPLUS MATERIAL FROM THE SITE.
 - C. REMOVE SNOW AND ICE TO PROVIDE SAFE ACCESS TO THE SITE AND EQUIPMENT BUILDING.
 - D. CLEAN EXPOSED EXTERIOR AND INTERIOR HARD—SURFACED FINISHES TO A DIRT—FREE CONDITION, FREE OF STAINS, FILMS AND SIMILAR FOREIGN SUBSTANCES. AVOID DISTURBING NATURAL WEATHERING OF EXTERIOR SURFACES.
 - E. REMOVE DEBRIS FROM LIMITED ACCESS SPACES, INCLUDING ROOFS, EQUIPMENT BUILDING, MANHOLES AND SIMILAR SPACES.
 - F. REMOVE LABELS THAT ARE NOT PERMANENT LABELS.
 - G. TOUCH-UP AND OTHERWISE REPAIR AND RESTORE MARRED EXPOSED FINISHES AND SURFACES. REPLACE FINISHES AND SURFACES THAT CAN NOT BE SATISFACTORILY BE REPAIRED OR RESTORED, OR THAT SHOW EVIDENCE OF REPAIR OR RESTORATION. DO NOT PAINT OVER "UL" AND SIMILAR LABELS, INCLUDING ELECTRICAL NAME PLATES.
 - H. LEAVE THE PROJECT CLEAN AND READY FOR OCCUPANCY.
 - I. DUST OFF ALL EQUIPMENT, INCLUDING BATTERY PACKS, WITHIN EQUIPMENT BUILDING.
 - J. GENERAL CONTRACTOR TO CLEAN AND APPLY STATIC—FREE WAX TO THE FLOORS ONCE FINAL SHELTER EQUIPMENT AND ACCESSORIES ARE COMPLETED.

2. REMOVE OF PROTECTION

REMOVE TEMPORARY PROTECTION AND FACILITIES INSTALLED DURING CONSTRUCTION TO PROTECT PREVIOUSLY COMPLETED INSTALLATIONS DURING THE REMAINDER OF THE CONSTRUCTION PERIOD.

DIVISION 2: SITE WORK

SECTION 02200 - EARTHWORK AND DRAINAGE

PART 1 - GENERAL

- 1. WORK INCLUDED SEE SITE PLAN
- 2. DESCRIPTIONS

ACCESS DRIVE WITH TURN—AROUND AREA, LEASE AREA, AND, IF APPLICABLE, UNDERGROUND UTILITY EASEMENTS ARE TO BE CONSTRUCTED TO PROVIDE A WELL—DRAINED, EASILY MAINTAINED, EVEN SURFACE FOR MATERIAL AND EQUIPMENT DELIVERIES AND MAINTENANCE PERSONNEL ACCESS.

- 3. QUALITY ASSURANCE
- A. APPLY SOIL STERILIZER IN ACCORDANCE WITH MANUFACTURER'S RECOMMENDATIONS (AS NEEDED).
- B. APPLY AND MAINTAIN GRASS SEED AS RECOMMENDED BY THE SEED PRODUCER (AS NEEDED).
- C. PLACE AND MAINTAIN VEGETATION LANDSCAPING, IF INCLUDED WITHIN THE CONTRACT, AS RECOMMENDED BY NURSERY INDUSTRY STANDARDS.

4. SEQUENCING

- A. CONFIRM SURVEY STAKES AND SET ELEVATIONS STAKES PRIOR TO ANY CONSTRUCTION.
- B. COMPLETELY GRUB THE ACCESS DRIVE WITH TURN—AROUND, UNDERGROUND UTILITY EASEMENTS (IF APPLICABLE), AND LEASE AREA PRIOR TO FOUNDATION CONSTRUCTION, PLACEMENT OF BACKFILL AND SUB—BASE MATERIAL.
- C. CONSTRUCT TEMPORARY CONSTRUCTION AREA ALONG ACCESS DRIVE.
- D. BRING THE LEASE AREA AND ACCESS DRIVE WITH TURN—AROUND TO BASE COURSE ELEVATION PRIOR TO INSTALLING FOUNDATION.
- E. APPLY SOIL STERILIZER PRIOR TO PLACING BASE MATERIALS SUCH THAT THE STERILIZER ONLY COMES IN CONTACT WITH PROPOSED GRAVEL SURFACES.
- F. GRADE, SEED, FERTILIZE, AND MULCH ALL AREAS DISTURBED BY CONSTRUCTION (INCLUDING UNDERGROUND UTILITY EASEMENTS) IMMEDIATELY AFTER BRINGING LEASE AND ACCESS DRIVE WITH TURN—AROUND TO BASE COURSE ELEVATION. WATER TO ENSURE GROWTH.
- G. REMOVE GRAVEL FROM TEMPORARY CONSTRUCTION ZONE TO AN AUTHORIZED AREA OR AS DIRECTED BY THE PROJECT MANAGER.
- H. AFTER APPLICATIONS OF FINAL SURFACES, APPLY SOIL STERILIZER TO STONE SURFACES.

5. SUBMITTALS

A. BEFORE CONSTRUCTION

IF LANDSCAPING IS APPLICABLE TO THE CONTRACT, SUBMIT TWO (2) COPIES OF THE LANDSCAPE PLAN UNDER NURSERY LETTERHEAD. IF LANDSCAPE ALLOWANCE WAS INCLUDED IN THE CONTRACT, PROVIDE AN ITEMIZED LISTING OF PROPOSED COSTS ON NURSERY LETTERHEAD. REFER TO PLANS FOR LANDSCAPING REQUIREMENTS.

B. PLACE FILL OR STONE IN SIX (6) INCH MAXIMUM LIFTS, AND COMPACT BEFORE PLACING NEXT LIFT.

C. AFTER CONSTRUCTION

- 1. MANUFACTURER'S DESCRIPTION OF PRODUCT AND WARRANTY STATEMENT ON SOIL STERILIZED.
- 2. MANUFACTURER'S DESCRIPTION OF PRODUCT ON GRASS SEED AND FERTILIZER.
- 3. LANDSCAPING WARRANTY STATEMENT.

6. WARRANTY

- A. IN ADDITION TO THE WARRANTY ON ALL CONSTRUCTION COVERED IN THE CONTRACT DOCUMENTS, THE CONTRACTOR SHALL REPAIR ALL DAMAGE AND RESTORE AREA AS CLOSE TO ORIGINAL CONDITION AS POSSIBLE AT SITE AND SURROUNDINGS.
- B. SOIL STERILIZATION APPLICATION TO GUARANTEE VEGETATION FREE ROAD AND SITE AREAS FOR ONE YEAR FROM THE DATE OF FINAL INSPECTION.
- C. DISTURBED AREAS WILL REFLECT GROWTH OF NEW GRASS PRIOR TO FINAL INSPECTION.
- D. LANDSCAPING, IF INCLUDED WITHIN THE SCOPE OF THE CONTRACT, WILL BE GUARANTEED FOR ONE YEAR FROM THE DATE OF FINAL INSPECTION.

DIVISION 2: SITE WORK (CONTINUED)

SECTION 02200 - EARTHWORK AND DRAINAGE (CONTINUED)

PART 2 - PRODUCTS

MATERIALS

A. SOIL STERILIZER SHALL BE AN EPA REGISTERED, PRE-EMERGENCE LIQUID:

TOTAL KILL PHASAR CORPORATION PRODUCT 910 P.O. BOX 5123 EPA 10292-7 DEARBORN, MI 48128

313.563.8000

AMBUSH HERBICIDE FRAMAR INDUSTRIAL PRODUCTS

EPA REGISTERED 1435 MORRIS AVENUE UNION, NJ 07083 800.526.4924

B. ROAD AND SITE MATERIALS SHALL CONFORM TO DOT SPECIFICATIONS (UNLESS OTHERWISE NOTE). ACCEPTABLE SELECT FILL SHALL BE IN ACCORDANCE WITH STATE DEPARTMENT OF HIGHWAY AND TRANSPORTATION STANDARD SPECIFICATIONS.

C. SOIL STABILIZED FABRIC SHALL BE MIRAFI-500X.

PART 3 - EXECUTION

PREPARATION

- A. CLEAR TREES, BRUSH AND DEBRIS FROM LEASE AREA, ACCESS DRIVE WITH TURN—AROUND, AND UNDERGROUND UTILITY EASEMENTS AS REQUIRED FOR CONSTRUCTION.
- B. PRIOR TO OTHER EXCAVATION AND CONSTRUCTION, GRUB ORGANIC MATERIAL TO A MINIMUM OF SIX (6) INCHES BELOW GRADE.
- C. UNLESS OTHERWISE INSTRUCTED BY LESSEE, TRANSPORT ALL REMOVED TREES, BRUSH AND DEBRIS FROM THE PROPERTY TO AN AUTHORIZED LANDFILL.
- D. PRIOR TO PLACEMENT OF FILL OR BASE MATERIALS, ROLL THE SOIL.
- E. WHERE UNSTABLE SOIL CONDITIONS ARE ENCOUNTERED, LINE THE AREA WITH A STABILIZED MAT PRIOR TO PLACEMENT OF FILL OR BASE MATERIAL.
- F. PRIOR TO PLACEMENT OF FILL OR BASE MATERIALS. REMOVE SOFT SPOTS, PLACE SELECT FILL, AND COMPACT TO 95% MODIFIED PROCTOR.

2. INSTALLATION

- A. GRADE OR FILL THE LEASE AREA AND ACCESS DRIVE WITH TURN—AROUND AS REQUIRED IN ORDER THAT UPON DISTRIBUTION OF SPOILS RESULTING FROM EXCAVATIONS, THE RESULTING GRADE WILL CORRESPOND WITH SAID SUB—BASE COURSE. ELEVATIONS ARE TO BE CALCULATED FROM BENCHMARK, FINISHED GRADES, OR INDICATED SLOPES.
- B. CLEAR EXCESS SPOILS, IF ANY, FROM JOB SITE AND DO NOT SPREAD BEYOND THE LIMITS OF PROJECT AREA UNLESS AUTHORIZED BY PROJECT MANAGER AND AGREED TO BY LANDOWNER.
- C. BRING THE ACCESS DRIVE WITH TURN—AROUND TO BASE COURSE ELEVATION TO FACILITATE CONSTRUCTION AND OBSERVATION DURING CONSTRUCTION OF THE SITE
- D. AVOID CREATING DEPRESSIONS WHERE WATER MAY POND.
- E. THE CONTRACT SHALL INCLUDE GRADING, BANKING, AND DITCHING, UNLESS OTHERWISE NOTED.
- F. WHEN IMPROVING AN EXISTING ACCESS DRIVE, GRADE THE EXISTING DRIVE TO REMOVE ANY ORGANIC MATTER AND SMOOTH THE SURFACE BEFORE PLACING FILL OR STONE.
- G. THE TOP SURFACE COURSE SHALL EXTEND A MINIMUM OF ONE (1) FOOT BEYOND THE SITE FENCE, UNLESS OTHERWISE NOTED, AND SHALL COVER THE AREA AS INDICATED.
- H. NO SLOPES ARE TO BE GREATER THAN 3:1.
- I. APPLY RIP—RAP TO THE SIDES OF DITCHES AND DRAINAGE SWALES WHERE INDICATED ON THE DRAWINGS.
- J. RIP-RAP ENTIRE DITCH FOR SIX (6) FEET IN ALL DIRECTIONS AT CULVERT OPENINGS (WHEN APPLICABLE)
- K. APPLY SEED, FERTILIZER, AND STRAW COVER TO ALL OTHER DISTURBED AREAS, DITCHES, AND DRAINAGE SWALES, NOT OTHERWISE RIP—RAPPED.
- L. UNDER NO CIRCUMSTANCES WILL DITCHES, SWALES, OR CULVERTS BE PLACED SO THAT THEY DIRECT WATER TOWARDS, OR PERMIT STANDING WATER IMMEDIATELY ADJACENT TO SHELTER OR EQUIPMENT. IF DESIGNS OR ELEVATIONS ARE IN CONFLICT WITH THIS, ADVISE CONSTRUCTION MANAGER IMMEDIATELY.

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PREPARED FOR:

CHICAGO SMSA LIMITED PARTNERSHIP D/B/A VERIZON WIRELESS 1701 GOLF ROAD TOWER 2, SUITE 400 POLITING MEADOWS II 60008


SITE NAME:

WHITEWATER SOUTH

T65538

SITE ADDRESS:
797 INDIAN MOUND PARKWAY
WHITEWATER, WI 53190
WAI WORTH COUNTY

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05/08/2

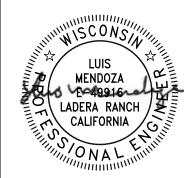

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SHEET TITLE:

GENERAL SPECIFICATIONS

SHEET NUMBER

N1.0

DIVISION 2: SITE WORK (CONTINUED)

SECTION 02200 - EARTHWORK AND DRAINAGE (CONTINUED)

PART 2 - PRODUCTS (CONTINUED)

- 2. INSTALLATION (CONTINUED)
 - M. IN DITCHES WITH SLOPES GREATER THAN 10%, MOUND DIVERSIONARY HEADWALLS IN THE DITCH AT AN ANGLE NO GREATER THAN 60° OFF THE DITCH LINE, RIP RAP THE UPSTREAM SIDE OF THE HEADWALL AS WELL AS DITCH FOR SIX (6) FEET ABOVE THE CULVERT ENTRANCE.
 - N. APPLY SEED AND FERTILIZER TO SURFACE CONDITIONS WHICH WILL ENCOURAGE ROOTING, RAKE AREAS TO BE SEEDED TO EVEN THE SURFACE AND LOOSEN THE SOIL.
 - O. SOW SEED IN TWO DIRECTIONS IN TWICE THE QUANTITY RECOMMENDED BY THE SEED PRODUCER.
 - P. ENSURE GROWTH OF SEEDED AND LANDSCAPED AREAS BY WATERING UP TO THE POINT OF RELEASE FROM THE CONTRACT. CONTINUE TO REWORK THE BARE AREAS UNTIL COMPLETE COVERAGE IS OBTAINED.
- 3. FIELD QUALITY CONTROL

COMPACT SOILS TO MAXIMUM DENSITY IN ACCORDANCE WITH ASTM D-1557. AREAS OF SETTLEMENT WILL BE EXCAVATED AND REFILLED AT CONTRACTOR'S EXPENSE. INDICATE PERCENTAGE OF COMPACTION ACHIEVED ON AS-BUILT DRAWINGS.

- 4. PROTECTION
 - A. PROTECT SEEDED AREAS FROM EROSION BY SPREADING STRAW TO A UNIFORM LOOSE DEPTH OF 1-2 INCHES, STAKE AND TIE DOWN AS REQUIRED. USE OF EROSION CONTROL MESH OR MULCH NET WILL BE AN ACCEPTABLE ALTERNATE.
 - B. ALL TREES PLACED IN CONJUNCTION WITH A LANDSCAPE CONTRACT WILL BE WRAPPED, TIED WITH HOSE PROTECTED WIRE, AND SECURED TO 2" x 2" x 4'-0" WOODEN STAKES EXTENDING TWO-FEET INTO GROUND ON FOUR SIDES OF THE TREE.
 - C. PROTECT ALL EXPOSED AREAS AGAINST WASHOUTS AND SOIL EROSION. ALL EROSION CONTROL METHODS SHALL CONFORM TO APPLICABLE BUILDING CODE

DIVISION 16: UTILITY

SECTION 16050 - BASIC UTILITY MATERIALS AND METHODS

- 1. CONTRACTOR SHALL REVIEW THE CONTRACT DOCUMENTS PRIOR TO ORDERING THE UTILITY EQUIPMENT AND STARTING THE ACTUAL CONSTRUCTION. CONTRACTOR SHALL ISSUE A WRITTEN NOTICE OF ALL FINDINGS TO THE ARCHITECT/ENGINEER LISTING ANY DISCREPANCIES OR CONFLICTING INFORMATION.
- 2. UTILITY PLANS, DETAILS AND DIAGRAMS ARE DIAGRAMMATIC ONLY. VERIFY EXACT LOCATIONS AND MOUNTING HEIGHTS OF UTILITY EQUIPMENT WITH OWNER PRIOR TO INSTALLATION.
- 3. EACH CONDUCTOR OF EVERY SYSTEM SHALL BE PERMANENTLY TAGGED IN EACH PANELBOARD, PULLBOX, JUNCTION BOX, SWITCH BOX, ETC. THE TYPE OF TAGGING METHODS SHALL BE COMPLIANCE WITH OCCUPATIONAL SAFETY AND HEALTH ADMINISTRATION (O.S.H.A.).
- 4. ALL MATERIALS AND EQUIPMENT SHALL BE NEW AND IN GOOD WORKING CONDITION WHEN INSTALLED AND SHALL BE OF THE BEST GRADE AND OF THE SAME MANUFACTURER THROUGHOUT FOR EACH CLASS OR GROUP OF EQUIPMENT. MATERIALS SHALL BE LISTED "J" WHERE APPLICABLE. MATERIALS SHALL MEET WITH APPROVAL OF ALL GOVERNING BODIES HAVING JURISDICTION. MATERIALS SHALL BE MANUFACTURED IN ACCORDANCE WITH APPLICABLE STANDARDS ESTABLISHED BY ANSI, NEMA, NBFU AND "UL" LISTED.
- 5. ALL CONDUIT SHALL HAVE A PULL CORD.
- 6. PROVIDE PROJECT MANAGER WITH ONE SET OF COMPLETE UTILITY "AS INSTALLED" DRAWINGS AT THE COMPLETION OF THE JOB, SHOWING ACTUAL DIMENSIONS, ROUTINGS, AND CIRCUITS.

PREPARED FOR:

LIMITED PARTNERSHIP | WIRELESS

SITE NAME:

WHITEWATER SOUTH

SITE NUMBER:

765538

SITE ADDRESS: 797 INDIAN MOUND PARKWAY WHITEWATER, WI 53190 WALWORTH COUNTY

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GENERAL SPECIFICATIONS

SHEET NUMBER:

EROSION CONTROL CONSTRUCTION SEQUENCE:

- 1. THE CONTRACTOR SHALL DESIGNATE AN ESC COORDINATOR FOR THE SITE AND COMMUNICATE TO THE OWNER AND ENGINEER.
- SOIL EROSION AND SEDIMENT CONTROL MEASURES SHALL BE PROVIDED, AND SHALL INCLUDE SILT FENCES AT DOWNSLOPE PERIMETERS OF THE DISTURBED AREA AND A STABILIZED CONSTRUCTION ENTRANCE, APPROXIMATELY TWELVE (12') FEET WIDE AND TWENTY (20') LONG, CONSISTING OF A SIX (6") INCH THICK STONE APRON (2" AGGREGATE — ASTM SIZE No. 2).
- 3. COMMENCE WITH TREE REMOVAL AND GRADING ACTIVITIES.
- 4. INSTALL ADDITIONAL EROSION CONTROL MEASURES AFTER GRADING BEGINS AS REQUIRED.
- 5. SEED ALL MULCH DENUDED AREAS WITH 7 DAYS AFTER ANY PHASE OF GRADING, ALSO COVER ALL EXPOSED AREA BEFORE MAJOR STORM EVENTS.
- 6. MAINTAIN SOIL EROSION CONTROL MEASURES UNTIL PERMANENT GROUND COVER AND/OR STAND OF GRASS IS ESTABLISHED.
- 7. REQUEST FINAL APPROVAL FROM OWNER.
- 8. REMOVE SOIL EROSION CONTROL MEASURES AND STABILIZE THE AREAS.


EROSION CONTROL AND DRAINAGE NOTES:


- 1. THE CONTRACTOR SHALL COMPLY WITH ALL APPLICABLE RULES AND REGULATIONS FOR EROSION AND SEDIMENT CONTROL FOR THE AGENCY(IES) HAVING JURISDICTION OVER CLEARING AND GRADING OPERATIONS. AS A MINIMUM, ALL WORK SHALL COMPLY WITH THE LATEST PROVISIONS OF THE INTERNATIONAL BUILDING CODE. UTILIZE BEST MANAGEMENT PRACTICES (BMP) PRESCRIBED BY IBC TO PREVENT EROSION OF ON-SITE SOILS AND TRANSPORT OF THESE SOILS TO DOWNSTREAM PROPERTIES OR WATER BODIES. SPECIFIC BMP'S TO BE EMPLOYED INCLUDE, BUT ARE NOT LIMITED TO, A TEMPORARY CONSTRUCTION ENTRANCE, SILT FENCE AT THE BASE OF FILL SLOPES AND AROUND STOCKPILE AREA, CHECK DAMS IN THE FLOW LINE OF SWALES AND DITCHES, AND TEMPORARY AND PERMANENT SEEDING.
- 2. CONTRACTOR AND/OR DEVELOPER SHALL BE RESPONSIBLE FOR THE INSTALLATION AND MAINTENANCE OF EROSION AND SEDIMENTATION CONTROLS AS NECESSARY DURING CONSTRUCTION ACTIVITIES TO ENSURE THE PROTECTION OF ADJACENT PROPERTIES AND WATERWAYS. EXCEPT AS MAY BE REQUIRED TO INSTALL THE MEASURES, NO GRADING SHALL BE PERFORMED UNTIL THE TEMPORARY CONSTRUCTION ENTRANCE, SILT FENCE AND OTHER APPROPRIATE MEASURES ARE IN PLACE
- 3. FOLLOWING INITIAL SOIL DISTURBANCE OR RE-DISTURBANCE, PERMANENT OR TEMPORARY STABILIZATION SHALL BE COMPLETED WITHIN:
 - A. SEVEN CALENDAR DAYS OF THE SURFACING OF ALL PERIMETER DIKES, SWALES, DITCHES, PERIMETER SLOPES AND ALL SLOPES GREATER THAN 3 HORIZONTAL TO 1 VERTICAL (3:1);
 - B. FOURTEEN DAYS OF ALL OTHER DISTURBED OR GRADED AREAS ON THE PROJECT SITE.
- 4. THE CONTRACTOR IS RESPONSIBLE FOR MONITORING DOWNSTREAM CONDITIONS THROUGHOUT THE CONSTRUCTION PERIOD AND CLEARING ANY DEBRIS AND SEDIMENT CAUSED BY CONSTRUCTION.
- 5. ALL EROSION CONTROL MEASURES WILL BE CHECKED PERIODICALLY, ESPECIALLY AFTER RAIN, AND ANY DEFICIENCIES NOTED SHALL BE PROMPTLY CORRECTED AND ANY DEFICIENCIES NOTED WILL BE CORRECTED. ADDITIONAL EROSION AND SEDIMENT CONTROL MEASURES WILL BE INSTALLED IF DEEMED NECESSARY AFTER ON—SITE INSPECTION.

NOTES:

- 1. THIS GRADING PLAN WAS PREPARED PRIOR TO RECEIPT OF TOWER FOUNDATION DESIGN AND GEOTECHNICAL REPORT. PROPOSED GRADES, ELEVATIONS AND CORRESPONDING SOIL COVER MAY REQUIRE FINAL ADJUSTMENT ONCE THE ABOVE NOTED DOCUMENTS ARE AVAILABLE. RECOMMENDATIONS IN THIS GRADING PLAN SHOULD NOT SUPERCEDE ANY REQUIREMENTS SPECIFIED IN THE FOUNDATION DESIGN.
- 2. NO VEHICULAR TRAFFIC OR SOIL DISTURBANCE TO OCCUR BEYOND SILT FENCE, CONTRACTOR TO INSTALL SILT FENCE BARRIER PRIOR TO ALL CONSTRUCTION ACTIVITIES AND MAINTAIN SILT FENCE THROUGHOUT THE LIFE OF THE PROJECT,
- 3. CONTRACTOR RESPONSIBLE FOR ALL REPAIR/REMEDIATION OF AREAS BEYOND SILT FENCE DUE TO CONSTRUCTION ACTIVITIES.



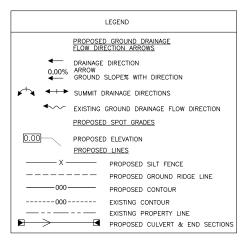

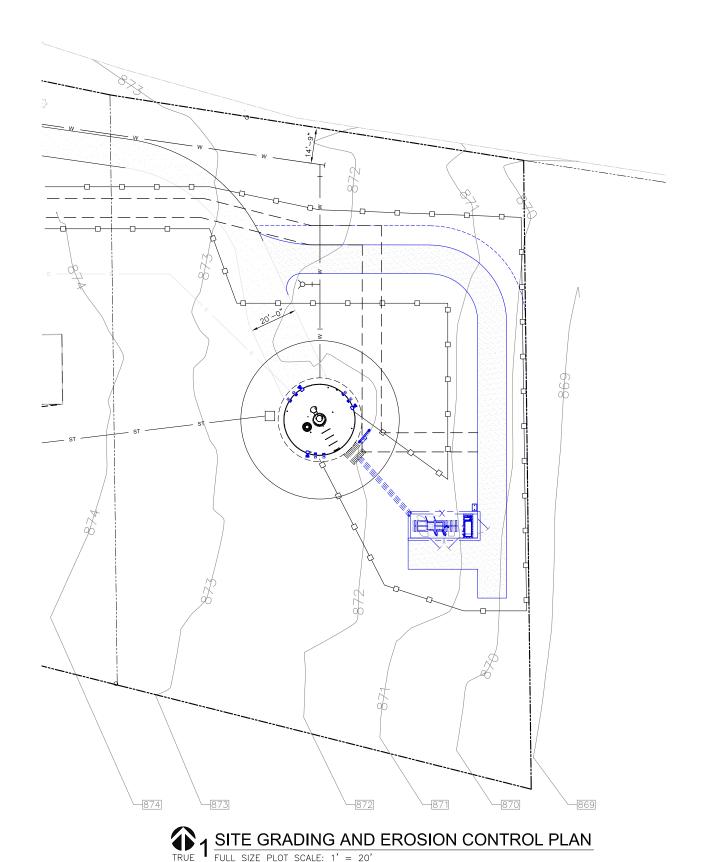

NORTH HALF SIZE PLOT SCALE: 1' = 40'

PREPARED FOR:

CHICAGO SMSA LIMITED P
D/B/A VERIZON WIRELESS
1701 GOLF ROAD
TOWER 2, SUITE 400
ROLLING MEADOWS. IL 60

SITE NAME:

WHITEWATER

SOUTH

765538

SITE ADDRESS:
797 INDIAN MOUND PARKWAY
WHITEWATER, WI 53190
WALWORTH COUNTY

STAMP:






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APP	ROVED BY:	LM		
DATE	DRAWN:	04/30/2	4	
		REVISION		
NO	DESCRIPTIO	N	BY	DATE
Α	ISSUED FO	R REVIEW	DP	05/06/24
0	ISSUED FOR C	ONSTRUCTION	DD	05/08/24
SHEE	T TITLE:			

SITE GRADING AND EROSION CONTROL PLAN

SHEET NUMBER

C1.0

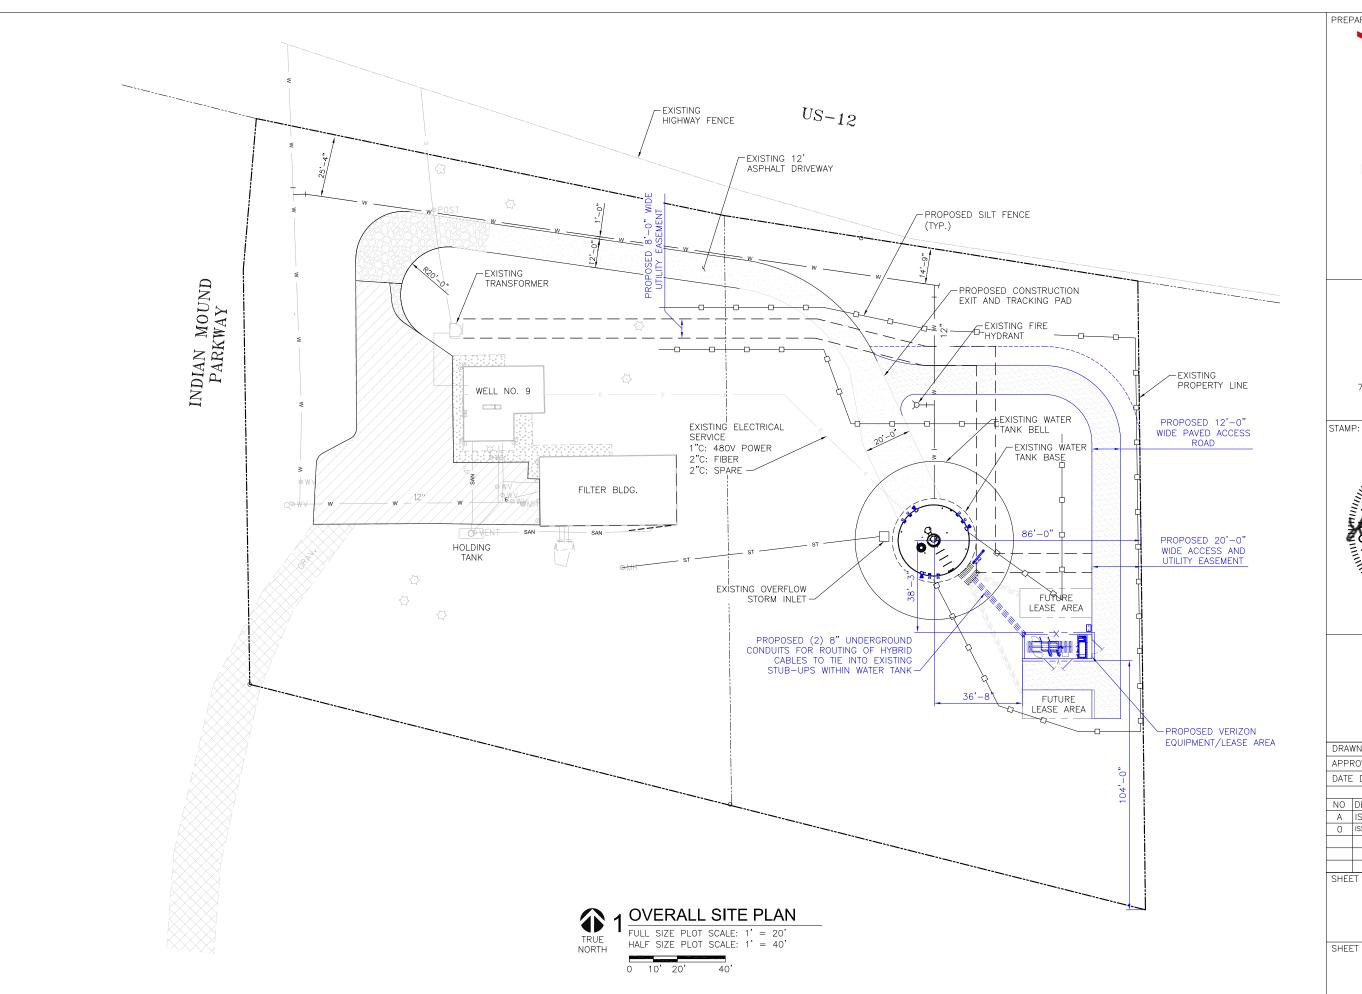



CHICAGO SMSA LIMITED PARTNERSHIP D/B/A VERIZON WIRELESS 1701 GOLF ROAD TOWER 2, SUITE 400 ROLLING MEADOWS, IL 60008

SITE NAME:


WHITEWATER

SOUTH

SITE NUMBER:

765538

SITE ADDRESS: 797 INDIAN MOUND PARKWAY WHITEWATER, WI 53190 WALWORTH COUNTY

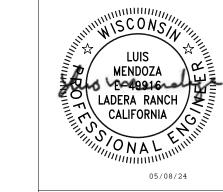


MOUNTAIN, LTD. ENGINEERING


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APPR	OVED BY:	LM		
DATE	DRAWN:	04/30/2	4	
		REVISION		
NO	DESCRIPTIC	N	BY	DATE
Α	ISSUED FO	R REVIEW	DP	05/06/2
0	ISSUED FOR C	ONSTRUCTION	DD	05/08/2
SHEE	T TITLE:			

OVERALL SITE PLAN

SHEET NUMBER:

A0.0

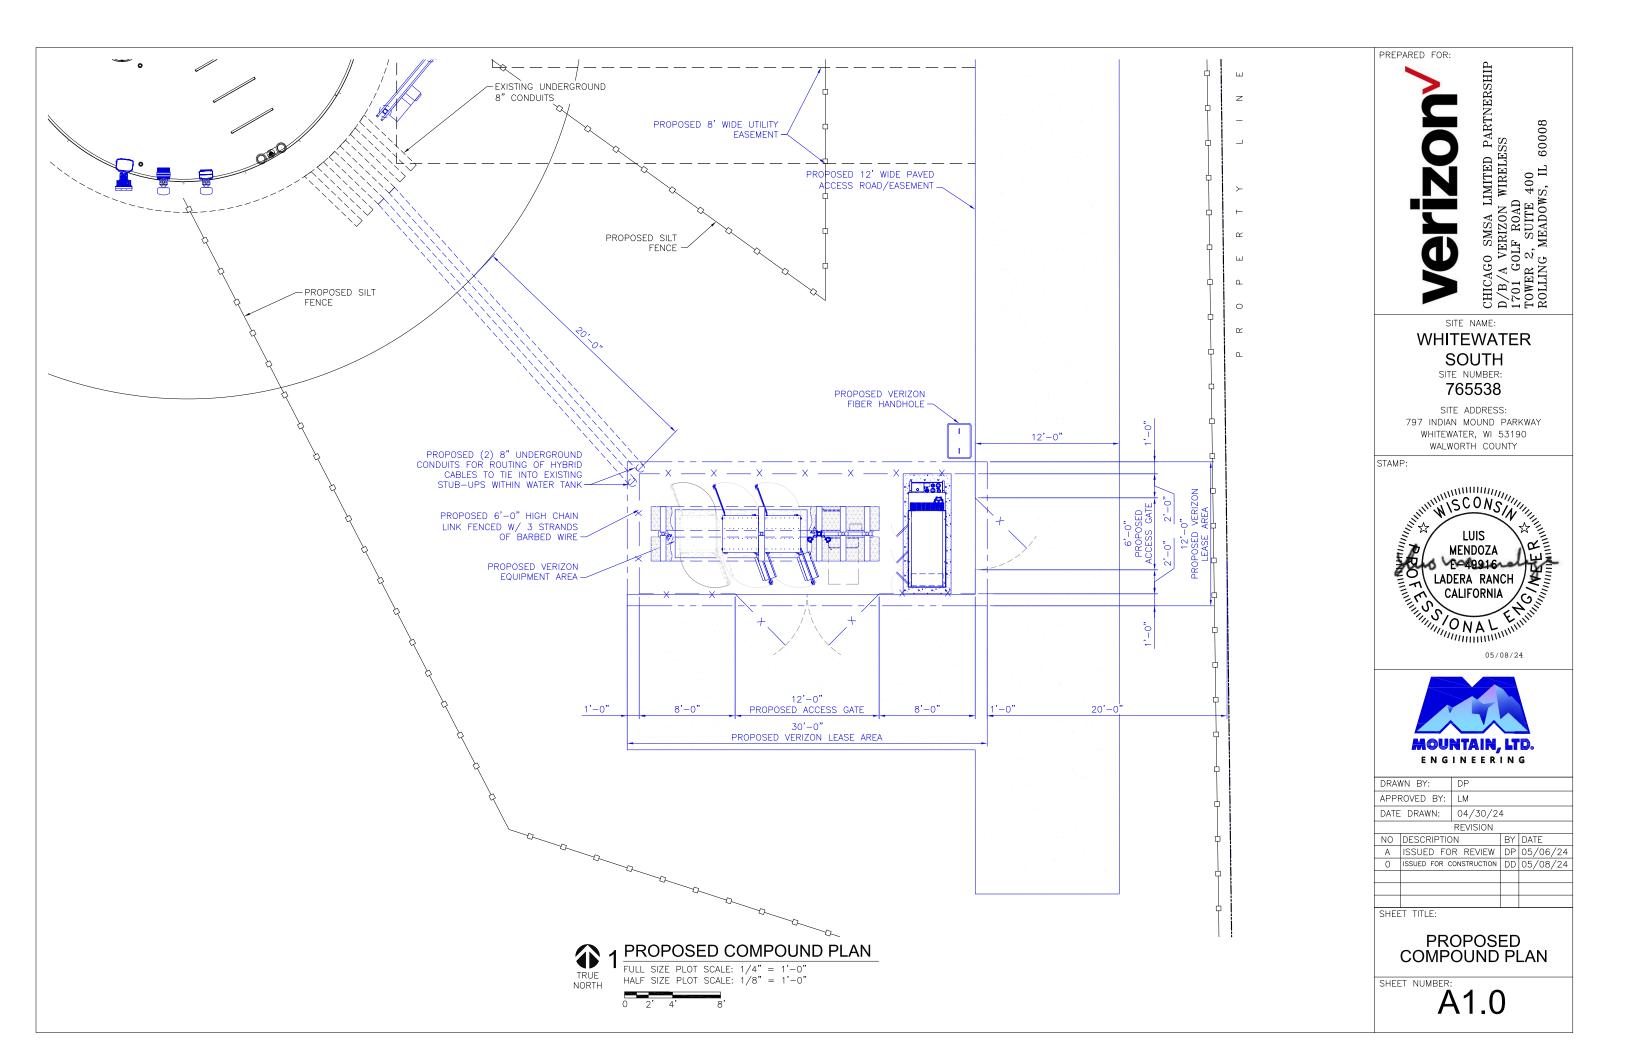

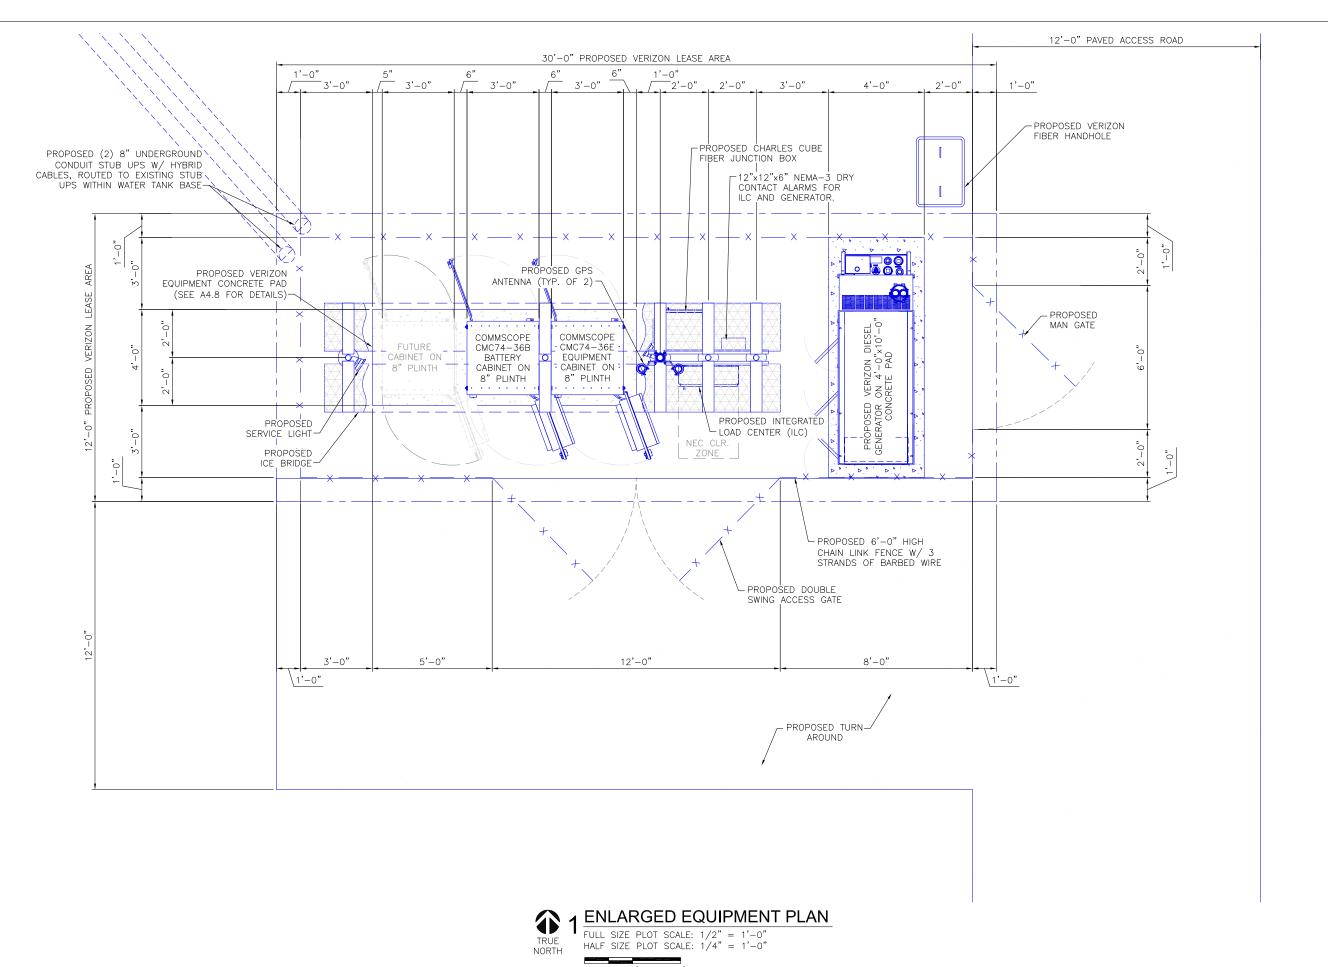

PREPARED FOR:

CHICAGO SMSA LIMITED PARTNERSHIP D/B/A VERIZON WIRELESS 1701 GOLF ROAD TOWER 2, SUITE 400 ROLLING MEADOWS, IL 60008

SITE NAME:

WHITEWATER

SOUTH

SITE NUMBER:

765538

SITE ADDRESS: 797 INDIAN MOUND PARKWAY WHITEWATER, WI 53190 WALWORTH COUNTY

STAMP:






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DATE	DRAWN:	04/30/2	4	
		REVISION		
NO	DESCRIPTIO	N	BY	DATE
Α	ISSUED FO	R REVIEW	DP	05/06/24
0	ISSUED FOR C	ONSTRUCTION	DD	05/08/24
SHEE	ET TITLE:			

ENLARGED EQUIPMENT PLAN

SHEET NUMBER:

A1.1

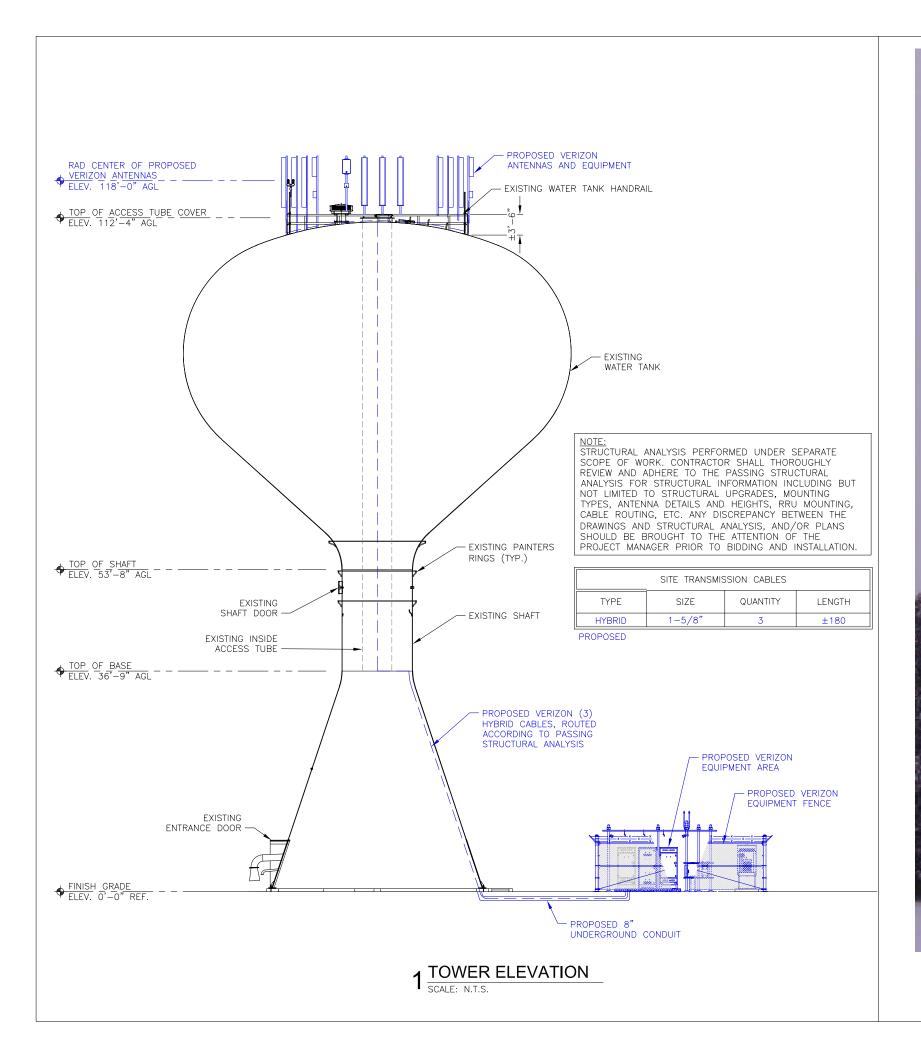



2 EXISTING SITE ELEVATION SCALE: N.T.S.

PREPARED FOR:

CHICAGO SMSA LIMITED PARTNERSHIP D/B/A VERIZON WIRELESS 1701 GOLF ROAD TOWER 2, SUITE 400 ROLLING MEADOWS, IL 60008

SITE NAME:

WHITEWATER

SOUTH

SITE NUMBER: **765538**

SITE ADDRESS:
797 INDIAN MOUND PARKWAY
WHITEWATER, WI 53190
WALWORTH COUNTY

STAMP:



05/08/24




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0	ISSUED FOR C	ONSTRUCTION	DD	05/08/24
SHEE	T TITLE:			•

TOWER ELEVATION

SHEET NUMBER:

A2.0

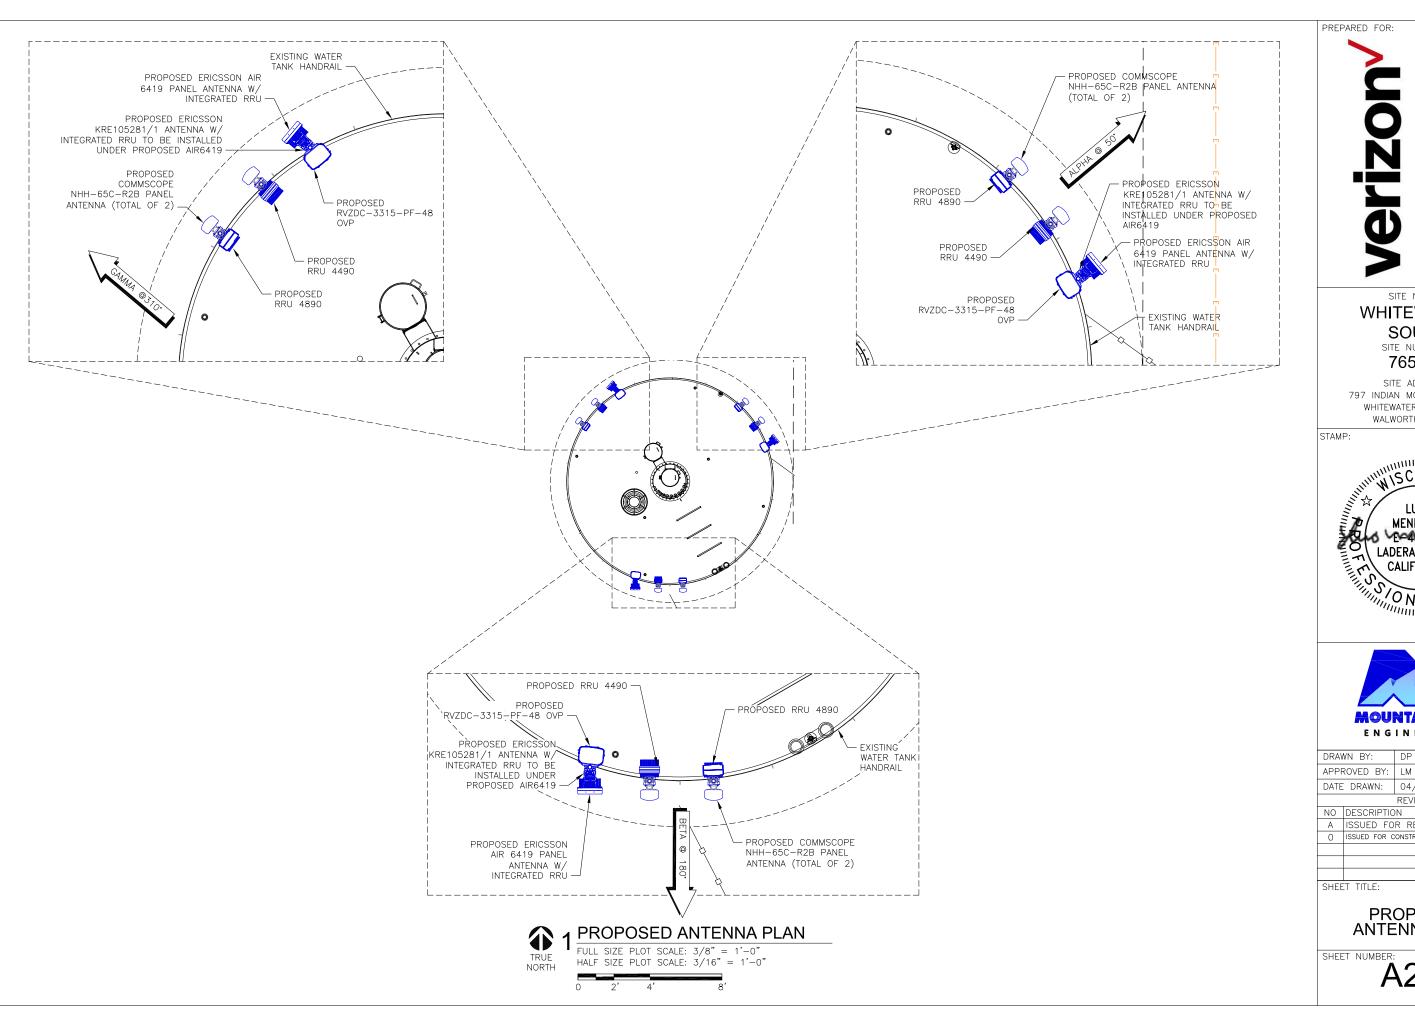

80009

SITE NAME:

WHITEWATER

SOUTH SITE NUMBER:

765538

SITE ADDRESS: 797 INDIAN MOUND PARKWAY WHITEWATER, WI 53190 WALWORTH COUNTY






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0	ISSUED FOR C	ONSTRUCTION	DD	05/08/2
SHEE	ET TITLE:			

PROPOSED **ANTENNA PLAN**

SHEET NUMBER:

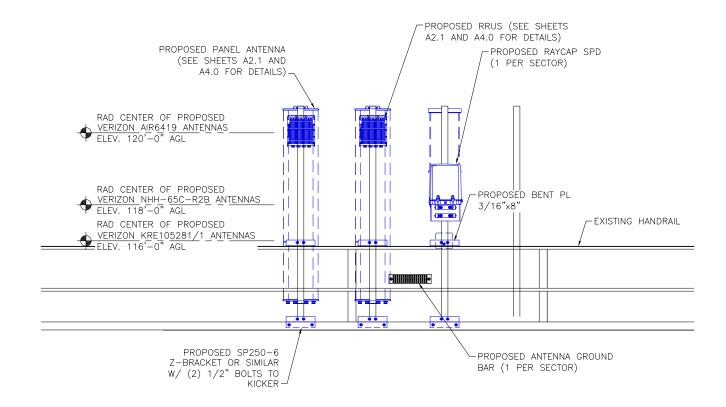

- NOTES:
 1. THIS DETAIL IS A GENERAL SCHEMATIC. SEE ANTENNA CONFIG. FOR ACTUAL TOWER ORIENTATION AND EQUIPMENT
- 2. CONTRACTOR TO VERIFY EXISTING AIR TERMINAL EXTENDS 2' MIN. ABOVE ALL ANTENNAS AND EQUIPMENT; CONTRACTOR TO RAISE IF NECESSARY.
- 3. CONTRACTOR TO INSTALL RAYCAP SPD AND REMOTE RADIO MOUNTS TO AVOID PEGS/SAFETY CLIMB AS NECESSARY.
- 4. PER TIA STANDARDS: FALL PROTECTION ANCHORAGES SHALL BE AVAILABLE AT A MAXIMUM SPACING OF FOUR (4)
 FEET OVER THE HEIGHT NOT EQUIPPED WITH SAFETY CLIMB SYSTEM OR OVER THE LENGTH OF THE OBSTRUCTION TO THE CLIMBING FACILITY.

PREPARED FOR:

CHICAGO SMSA LIMITED PARTNERSHIP D/B/A VERIZON WIRELESS 1701 GOLF ROAD TOWER 2, SUITE 400 ROLLING MEADOWS, IL 60008

SITE NAME:

WHITEWATER

SOUTH

SITE NUMBER:

765538

SITE ADDRESS: 797 INDIAN MOUND PARKWAY WHITEWATER, WI 53190 WALWORTH COUNTY

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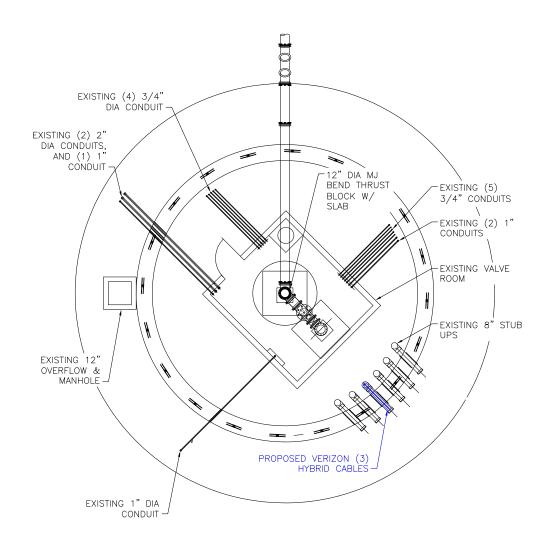




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Α	ISSUED FO	R REVIEW	DP	05/06/24
0	ISSUED FOR C	ONSTRUCTION	DD	05/08/24
SHEE	T TITLE:			

ANTENNA AND EQUIPMENT MOUNTING

SHEET NUMBER:





PREPARED FOR:

CHICAGO SMSA LIMITED PARTNERSHIP
D/B/A VERIZON WIRELESS
1701 GOLF ROAD
TOWER 2, SUITE 400
ROLLING MEADOWS, IL 60008

SITE NAME:

WHITEWATER

SOUTH

SITE NUMBER: 765538

SITE ADDRESS:
797 INDIAN MOUND PARKWAY
WHITEWATER, WI 53190
WALWORTH COUNTY

STAMP:



MOUNTAIN, LTD.
ENGINEERING

DRAV	VN BY:	DP		
APPF	ROVED BY:	LM		
DATE	DRAWN:	04/30/2	4	
		REVISION		
NO	DESCRIPTIO	N	BY	DATE
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0	ISSUED FOR C	ONSTRUCTION	DD	05/08/24
SHEE	T TITLE:			

TOWER BELL SECTION & TOWER BELL HYBRID ROUTING

SHEET NUMBER:

A2.3

1 TOWER BELL SECTION SCALE: N.T.S.

 $2^{\frac{\text{PROPOSED TOWER BELL HYBRID ROUTING}}{\text{SCALE: N.T.S.}}}$

Antenna Summary

Added														
700	1900	AWS	AWS3	CBRS	CBAND	Make	Atoll Model	Item Description	Centerline	Tip Height	Azimuth	Inst. Type	Quantity	Item ID
				LTE		ERICSSON	KRE105281/1	ANTENNA 6524, 4T4R MICRO DLRECTIONAL 340	116	116.3	50(19) 180(20) 310(21)	PHYSICAL	3	1900055217
					5G	Ericsson	AIR6419	AIR 6419 B77D Radio Unit	120	121.2	50(1) 180(2) 310(3)	PHYSICAL	3	1900483699
LTE	LTE	LTE	LTE			COMMSCOPE	NHH-65C-R2B	HEX PORT, AWS/PCS/700/850, 8 FT, 65 HBW,	118	122	50(1) 180(2) 310(3)	PHYSICAL	6	1900056293
Remo	red													
700	1900	AWS	AWS3	CBRS	CBAND	Make	Atoll Model	Item Description	Centerline	Tip Height	Azimuth	Inst. Type	Quantity	Item ID
								No data ava	ilable.					
Retair	ed													
700	1900	AWS	AWS3	CBRS	CBAND	Make	Atoli Model	Item Description	Centerline	Tip Height	Azimuth	Inst. Type	Quantity	Item ID
								No data avai	ilable.					

Equipment Summary

Added: 12 Removed: 0 Retained: 0

Added															
Equipment Type	Location	700	1900	AWS	AWS3	CBRS	CBAND	Make	Atoll Model	Item Description	Cable Length	Cable Size	Install Type	Quantity	Item ID
RRU	Tower		LTE	LTE				ERICSSON INC	4890	DB Radio 4890HP B2+B66- Rem Radio Unit			PHYSICAL	3	1900483775
RRU	Tower						5G	Ericsson	AIR6419	AIR 6419 B77D Radio Unit			PHYSICAL	0	1900483699
RRU	Tower					LTE		ERICSSON INC	4408 B48 DC	RADIO 4408 B48 HW 1			PHYSICAL	3	1900068745
RRU	Tower	LTE						ERICSSON INC	4490	DB Radio 4490HP B5+B13- Rem Radio Unit			PHYSICAL	3	1900483084
Alarm	Tower							RAYCAPINC-001	3315-ALM-RS485	RETROFIT FOR THE 60VP DIST BOX			PHYSICAL	3	00000001900070
Hybrid Cable	Tower							COMMSCOPET- 001	HFT1206-24SV4-xxxG			1-5/8 inch	PHYSICAL	3	
OVP Box	Tower							RAYCAPINC-001	RVZDC-3315-PF-48	TOWER TOP AND BASE POWER PROTECTION FIBE			PHYSICAL	3	000000001900422
Removed															
Equipment Type	Location	700	1900	AWS	AWS3	CBRS	CBAND	Make	Atoli Model	Item Description	Cable Length	Cable Size	Install Type	Quantity	Item ID
									No data available	e.					
Retained															
Equipment Type	Location	700	1900	AWS	AWS3	CBRS	CBAND	Make	Atoll Model	Item Description	Cable Length	Cable Size	Install Type	Quantity	Item ID
No data available.															

PREPARED FOR:

WHITEWATER

SITE NAME:

SOUTH

SITE NUMBER:

765538

SITE ADDRESS: 797 INDIAN MOUND PARKWAY WHITEWATER, WI 53190 WALWORTH COUNTY





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Α	ISSUED FO	R REVIEW	DP	05/06/24
0	ISSUED FOR C	ONSTRUCTION	DD	05/08/24
SHFF	T TITLE:			

RF SUMMARY

SHEET NUMBER:

Service Info Sector
Account NHH-65C-R2B Ericsson 4890 4,4 Ericsson 4890 4,4 15896850 ATOLL_API Sector
Activath
Cell Elixobs Bi Di
Anterna Mode
Anterna Centernia Mode
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Anterna Mode Ericsson 4490 4,4 Ericsson 4408 B48 DC 4,4 NHH-65C-R2B Ericsson 4890 4,4 Ericsson 4408 B48 DC 4,4 Ericsson 4408 B48 DC 4,4 10 34.26 Ericsson 4408 B48 DC 4,4 15896852 ATOLL_API 15896482 ATOLL_API

NOTE:

1. RF DESIGN AND DETAILS ON THIS SHEET PROVIDED BY VERIZON AND AR INCLUDED FOR CONVENIENCE ONLY. FINAL RF DESIGN TO BE VERIFIED WITH VERIZON PRIOR TO CONSTRUCTION. IF SIGNIFICANT CHANGES OR DISCREPANCIES ARE IDENTIFIED. CONTACT ENGINEER PRIOR TO INSTALLATION.





SITE NAME:

WHITEWATER

SOUTH SITE NUMBER:

765538

SITE ADDRESS: 797 INDIAN MOUND PARKWAY WHITEWATER, WI 53190 WALWORTH COUNTY






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SHEE	SHEET TITLE:			

RF SUMMARY

SHEET NUMBER:

A3.1

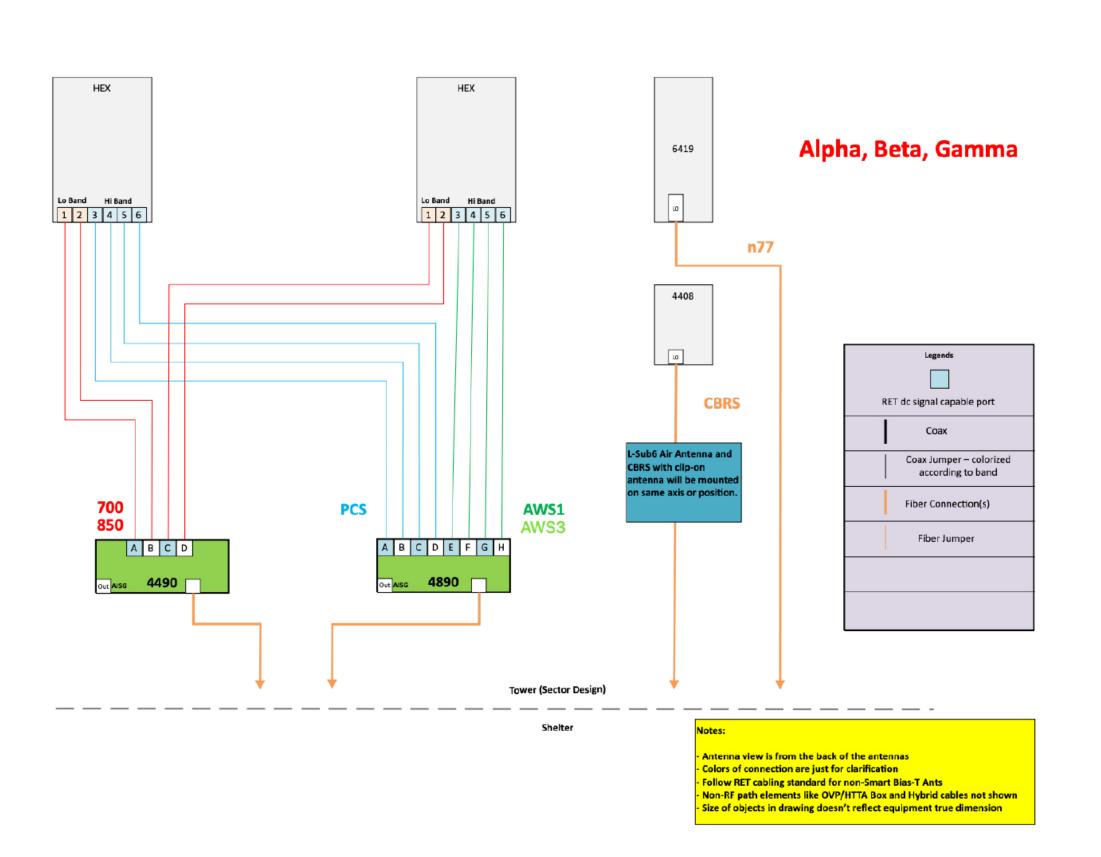

PREPARED FOR:

SITE NAME:

WHITEWATER

SOUTH

SITE NUMBER:

765538

SITE ADDRESS: 797 INDIAN MOUND PARKWAY WHITEWATER, WI 53190 WALWORTH COUNTY

STAMP:





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		REVISION	REVISION	
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Α	ISSUED FO	R REVIEW		05/06/24
0	ISSUED FOR C	ONSTRUCTION	DD	05/08/24
SHEE	T TITLE:			

ANTENNA PLUMBING DIAGRAM

SHEET NUMBER: A3.2

NOTE:

1. RF DESIGN AND DETAILS ON THIS SHEET PROVIDED BY VERIZON AND ARE

1. RF DESIGN TO BE VERIFIED WITH THE PROVIDED BY VERIZON AND ARE

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NHH-65C-R2B



6-port sector antenna, 2x 698–896 and 4x 1695–2360 MHz, 65° HPBW, 2x RET. Both high bands share the same electrical tilt.

- Interleaved dipole technology providing for attractive, low wind load mechanical package
 Internal SBT on low and high band allow remote RET control from the radio over the RF jumper
- cable $\,$ Separate R5-485 RET input/output for low and high band $\,$ One RET for low band and one RET for both high bands to ensure same tilt level for 4x Rx or 4x

General Specifications

Multiband Light gray

RF connector body grounded to reflector and mounting bracket Grounding Type Performance Note Outdoor usage | Wind loading figures are validated by wind tunnel measurements described in white paper WP-112534-EN

Radome Material Fiberglass, UV resistant Radiator Material Copper | Low loss circuit board Reflector Material Aluminum

4.3-10 Female RF Connector Quantity, low band RF Connector Quantity, total

Remote Electrical Tilt (RET) Information

RET Interface 8-pin DIN Female | 8-pin DIN Male

RET Interface, quantity 2 female | 2 male Input Voltage 10-30 Vdc Internal Bias Tee Port 1 | Port 3 High band (1) | Low band (1)



NHH-65C-P2R


NHH-65C-R2B						
Polarization			±45°			
Total Input Power, maximum			900 W @ 50 °C			
Electrical Specificati	ons					
Frequency Band, MHz	698-806	806-896	1695-1880	1850-1990	1920-2200	2300-2360
Gain, dBi	16	16.1	17.3	17.7	18.3	18.2
Beamwidth, Horizontal, degrees	65	62	74	66	62	59
Beamwidth, Vertical, degrees	9	7.9	5.6	5.2	4.9	4.5
Beam Tilt, degrees	0-11	0-11	0-7	0-7	0-7	0-7
USLS (First Lobe), dB	21	18	19	20	22	18
Front-to-Back Ratio at 180°, dB	35	31	33	29	29	30
Isolation, Cross Polarization, dB	25	25	25	25	25	25
Isolation, Inter-band, dB	30	30	30	30	30	30
VSWR Return loss, dB	1.5 14.0	1.5 14.0	1.5 14.0	1.5 14.0	1.5 14.0	1.5 14.0
PIM, 3rd Order, 2 x 20 W, dBc	-153	-153	-153	-153	-153	-153
Input Power per Port, maximum, watts	400	400	350	350	350	300
Electrical Specificati	ons, BAS	TA				
Frequency Band, MHz	698-806	806-896	1695-1880	1850-1990	1920-2200	2300-2360
Gain by all Beam Tilts, average, dBi	15.8	15.9	16.9	17.5	18	17.9
Gain by all Beam Tilts Tolerance, dB	±0.4	±0.4	±0.4	±0.3	±0.6	±0.4
Gain by Beam Tilt, average, dBi	0 ° 15.9 5 ° 15.9 11 ° 15.5	0° 15.8 5° 16.0 11° 15.7	0 * 16.9 4 * 17.0 7 * 16.9	0 ° 17.4 4 ° 17.5 7 ° 17.4	0* 17.9 4* 18.0 7* 18.0	0* 17.8 4* 17.9 7* 17.9
Beamwidth, Horizontal Tolerance, degrees	±1.2	±1.6	±5.3	±3.4	±6	±3.1
Beamwidth, Vertical Tolerance, degrees	±0.6	±0.4	±0.3	±0.2	±0.2	±0.2
USLS, beampeak to 20° above beampeak, dB	15	14	17	16	17	15
Front-to-Back Total Power at 180° ± 30°, dB	25.6	23.8	28	25	25	24

COMMSCOPE®

NHH-65C-R2B

3GPP/AISG 2.0 (Single RET) Dimensions Width 301 mm | 11.85 in 180 mm | 7.087 in 2438 mm | 95.984 in

Array Layout

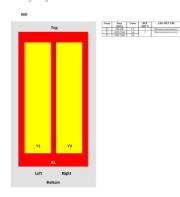

Electrical Specifications

1695 - 2360 MHz | 698 - 896 MHz

COMMSCOPE®

NHH-65C-R2B

CPR at Sector, dB	15	9	11	10	8	2
Mechanical Specifica	tions					
Effective Projective Area (EPA),	frontal		0.37 m² 3.983	ft²		
Effective Projective Area (EPA),	lateral		0.31 m² 3.337	ft²		

Wind Loading @ Velocity, lateral 330.0 N @ 150 km/h (74.2 lbf @ 150 km/h) 757.0 N @ 150 km/h (170.2 lbf @ 150 km/h) Wind Loading @ Velocity, maximum 398.0 N @ 150 km/h (89.5 lbf @ 150 km/h) Wind Loading @ Velocity, rear 241 km/h | 149.75 mph Wind Speed, maximum

Packaging and Weights

Width, packed 380 mm | 14.961 in Depth, packed 295 mm | 11.614 in Length, packed 2571 mm | 101.221 in 35.9 kg | 79.146 lb Weight, gross

Regulatory Compliance/Certifications

Agency	Classifica
DHINA-ROHS	Above ma

naximum concentration value ISO 9001:2015 Designed, manufactured and/or distributed under this quality management system Compliant/Exempted

150 9001 2015



Included Products

BSAMNT-3

- Wide Profile Antenna Downtilt Mounting Kit for 2.4 - 4.5 in (60 - 115 mm) OD round members. Kit contains one scissor top bracket set and one bottom bracket set

* Footnotes

Severe environmental conditions may degrade optimum performance

COMMSCOPE"

1 NHH-65C-R2B ANTENNA DETAIL SCALE: N.T.S.

Optional integrated antenna

Item	Description
KRE105280/1	Antenna 6523;4T4R Micro directional 1710- 2200 MHz (Radio 4402)
KRE105281/1	Antenna 6524; 4T4R Micro directional 3400- 3800 MHz (Radio 4408)



Radio specifics

4TX/4RX FDD

IBW up to 90 MHz

Up to 6 LTE carriers

2 external alarm

IP 65

2x 2.5/5/9.8/10.1Gbps CPRI

AC or -48 VDC Support Units



- Operating Bands: B48/ CBRS
- Up to 6 LTE carriers, IBW up to 150 MHz (ENM dependency) 2x 2.5/5/9.8/10.1Gbps CPRI AC or -48 VDC Support Units
- RF Connector: NEX10
- IP 65

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DIMENSIONS (LxWxD): 9"x8"x5" 20 LBS

2 KRE105281/1 ANTENNA/RRU DETAIL


AIR 6419 B77D/ C-Band **■**



- 64TX/64RX with 192 AE, (3x1)x(4x8) x-pol
- Up to 320W , PSD 4W/MHz
- EIRP up to 79 dBm
- Up to 200 MHz IBW
- · Max total carrier BW: 200MHz for NR
- Support number of layers: DL/UL 16/8

AIR 6419 B77D/ C-Band	Height	Width	Depth	Weight
wo protruding items	28.3 In (717 mm)	16.1 In (408 mm)	8.0 In (202 mm)	71 lbs
w protruding items	31.3 ln (793 mm)	16.1 In (408 mm)	9.8 In (248 mm)	(32 Kg)

- 3 x 25 Gbps eCPRI
- -48 VDC (3-wire or 2-wire), Fuse Minimum 40 A, maximum 50 A
- Power consumption: TBD
- 40 to +55°C

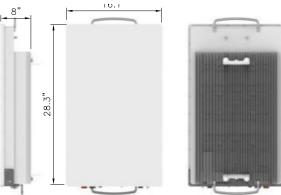

 $3^{\frac{\text{AIR}6419 \text{ ANTENNA DETAIL}}{\text{SCALE: N.T.S.}}}$



PREPARED FOR:

SITE NAME:

WHITEWATER

SOUTH SITE NUMBER:

765538

SITE ADDRESS: 797 INDIAN MOUND PARKWAY WHITEWATER, WI 53190 WALWORTH COUNTY






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APPI	ROVED BY:	LM						
DATE	DRAWN:	04/30/24						
	REVISION							
NO	DESCRIPTION		BY	DATE				
Α	ISSUED FO	ISSUED FOR REVIEW		05/06/24				
0	ISSUED FOR C	ONSTRUCTION	DD	05/08/24				
CITE	T TITLE.		CUEET TITLE					

SHEET TITLE:

ANTENNA DETAILS

SHEET NUMBER:

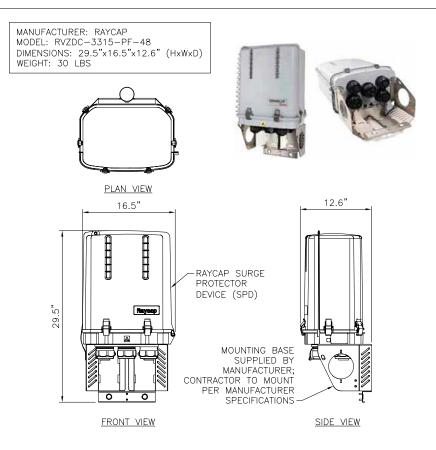


1 RAYCAP SURGE PROTECTOR DEVICE (SPD)

MANUFACTURER: ERICSSON MODEL: RRU 4490 DIMENSIONS: 17.5"x15.2"x6.8" (HxWxD) WEIGHT: 68.4 LBS




 $3^{\frac{\text{REMOTE RADIO UNIT (RRU)}}{\text{SCALE: N.T.S.}}}$

MANUFACTURER: ERICSSON MODEL: RRU 4890 DIMENSIONS: 17.5"x15.2"x7.0" (HxWxD) WEIGHT: 69.5 LBS

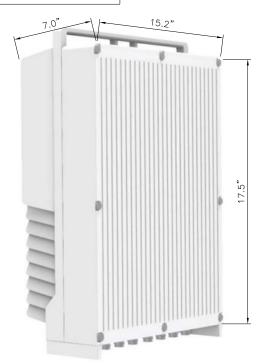

$2^{\frac{REMOTE\ RADIO\ UNIT\ (RRU)}{SCALE:\ N.T.S.}}$

MANUFACTURER: RAYCAP MODEL: 3315-ALM-RS485 DIMENSIONS: 9.51" X 3.60" X .83" (HXWXD) WEIGHT: 1.1 LBS (.50 KG)

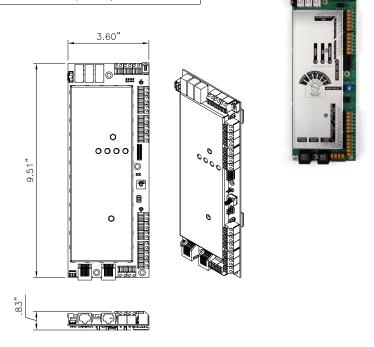

4 ALARM 3315-ALM-RS485 SCALE: N.T.S.

PREPARED FOR:

CHICAGO SMSA LIMITED PARTNI D/B/A VERIZON WIRELESS 1701 GOLF ROAD TOWER 2, SUITE 400 ROLLING MEADOWS, IL 60008

SITE NAME:


WHITEWATER

SOUTH

SITE NUMBER:

765538

SITE ADDRESS: 797 INDIAN MOUND PARKWAY WHITEWATER, WI 53190 WALWORTH COUNTY

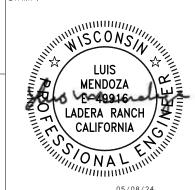



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APPF	ROVED BY:	LM		
DATE	DRAWN:	04/30/24		
		REVISION		
NO	DESCRIPTION		¥	DATE
Α	ISSUED FO	R REVIEW	DP	05/06/24
0	ISSUED FOR C	ONSTRUCTION	DD	05/08/24
SHEE	SHEET TITLE:			

EQUIPMENT DETAILS

SHEET NUMBER:



MANUFACTURER: ERICSSON MODEL: SXK 109 1973/2 WEIGHT: 3.75 LBS

BRACKET FOR ATTACHING TWO STANDARD OR HEAVY ERS UNITS WITH A HOLE PATTERN OF CC 30 MM AND/OR CC 80 MM., EITHER TO A POLE, WALL, ANGLÉ TOWER OR SQUARE TUBE.

BOLTS FOR ATTACHING TWO ERS UNITS ARE SUPPLIED IN THE PACKAGE.

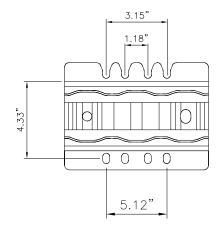


PLATE MOUNTING PATTERN

DUAL RADIO ATTACHMENT



ISOMETRIC VIEW


2 DUAL ERS BRACKET SCALE: N.T.S.


1 RAYCAP SURGE PROTECTOR DEVICE (SPD) MOUNT SCALE: N.T.S.

MANUFACTURER: ERICSSON MODEL: SXK 109 2064/1 (SWIVEL ANGLE) SXK 109 2065/1 (SWIVEL ANGLE AND TILT ANGLE) WEIGHT: 9.7 LBS. (SWIVEL ANGLE) 13.0 LBS. (SWIVEL ANGLE AND TILT ANGLE)

MANUFACTURER: RAYCAP


POLE	CIRCULAR	SQUARE	90° ANGLE
MIN. OUTER DIMENSION	3" DIA.	2" × 2"	2" × 2"
MAX. OUTER DIMENSION	4.5" DIA.	3.15" x 3.15"	3.15" x 3.15"

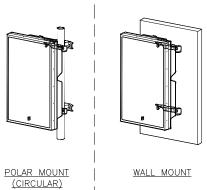


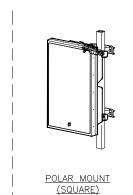





POLAR MOUNT (90° ANGLE)

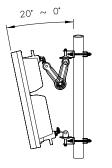

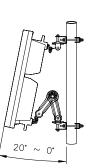

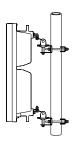

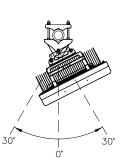

3 ERICSSON SWIVEL MOUNT KIT SCALE: N.T.S.

PREPARED FOR:

LIMITED PARTNERSHIP
I WIRELESS 80009

SITE NAME:


WHITEWATER

SOUTH SITE NUMBER:

765538

SITE ADDRESS: 797 INDIAN MOUND PARKWAY WHITEWATER, WI 53190 WALWORTH COUNTY

STAMP:

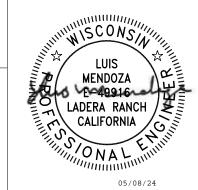





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	APPROVED BY: DATE DRAWN:		LM 04/30/24		
			REVISION		
	NO	DESCRIPTION ISSUED FOR REVIEW		BY	DATE
	Α			DP	05/06/24
	0	ISSUED FOR C	ONSTRUCTION	DD	05/08/24
	SHEE	T TITLE:			

EQUIPMENT DETAILS

SHEET NUMBER:

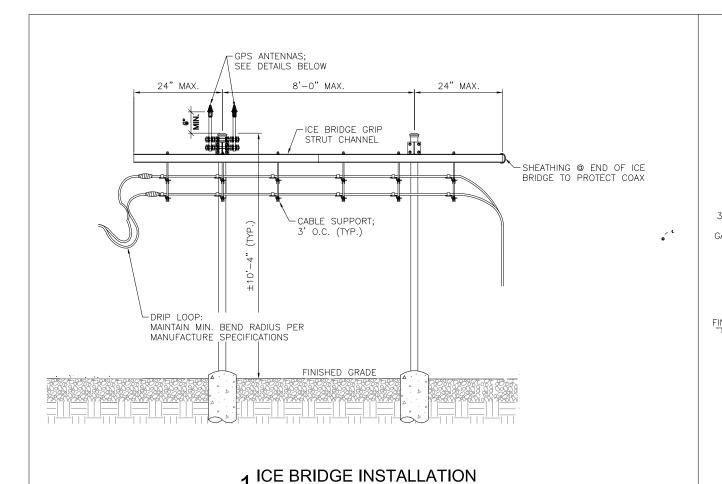

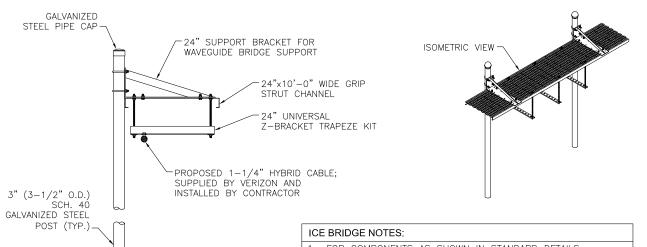

CONCRETE PIER (TYP.);


SEE DETAIL BELOW

- FOR COMPONENTS AS SHOWN IN STANDARD DETAILS, MAXIMUM ALLOWABLE SPAN BETWEEN SUPPORTS ON A CONTINUOUS SINGLE SECTION OF BRIDGE CHANNEL SHALL BE 8' FIR A 10' SECTION.
- 2. SPLICES IN SECTIONS OF BRIDGE CHANNEL SHALL BE INSTALLED AT SUPPORTS, WHERE POSSIBLE, OR AT MOST 2' FROM A SUPPORT.
- 3. FREE ENDS OF ICE BRIDGE CHANNELS SHALL NOT EXCEED
- A CANTILEVER DISTANCE OF 2' FROM A SUPPORT.

 4. CUT BRIDGE CHANNEL SECTIONS SHALL HAVE RAW EDGES TREATED WITH COLD GALVANIZING SPRAY.


 5. DEVIATIONS FROM STANDARDS FOR COMPONENT
- INSTALLATIONS ARE PERMITTED WITH MANUFACTURER'S AND ENGINEER'S APPROVAL
- 6. DEVIATIONS FROM ICE BRIDGE FOUNDATIONS SHOWN ON SITE SPECIFIC DRAWINGS OR STANDARD DETAILS REQUIRE ENGINEERING APPROVAL.

2 ICE BRIDGE SCALE: N.T.S.

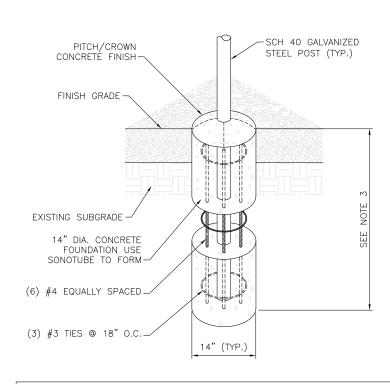

- MAINTAIN 3" MINIMUM REBAR COVER WITH CONCRETE IN ALL DIRECTIONS.
- CONCRETE MIX TO BE 4,000 PSI @ 28 DAYS.
- 3. FOUNDATION DEPTH TO EXCEED LOCAL FROST DEPTH, OR 48" MINIMUM.

3 PIER FOUNDATION SCALE: N.T.S.

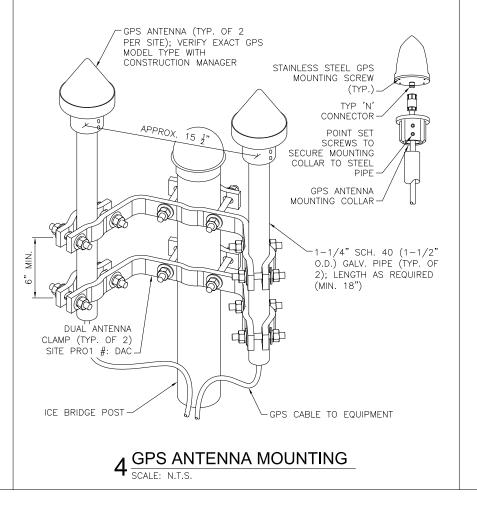

 $5\frac{\text{NOT USED}}{\text{SCALE: N.T.S.}}$

PREPARED FOR:

LIMITED PARTNERSHIP WIRELESS 60008 CHICAGO SMSA LIMITED D/B/A VERIZON WIRELE 1701 GOLF ROAD TOWER 2, SUITE 400 ROLLING MEADOWS, IL 6

SITE NAME:

WHITEWATER

SOUTH SITE NUMBER:

765538

SITE ADDRESS: 797 INDIAN MOUND PARKWAY WHITEWATER, WI 53190 WALWORTH COUNTY

STAMP:






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APP	ROVED BY:	LM		
DATE	DRAWN:	04/30/24		
		REVISION		
NO	DESCRIPTION		BY	DATE
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0	ISSUED FOR C	ONSTRUCTION	DD	05/08/24
SHEET TITLE:				
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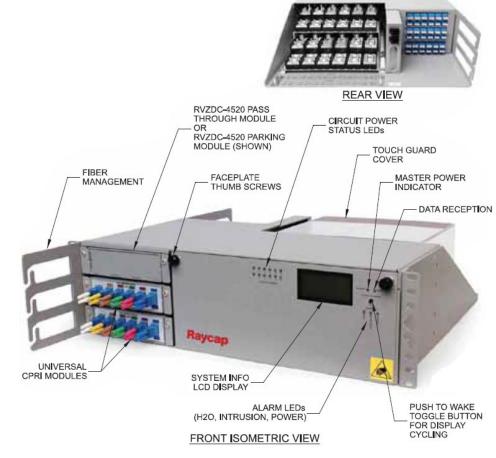
ICE BRIDGE AND **GPS DETAILS**

SHEET NUMBER:

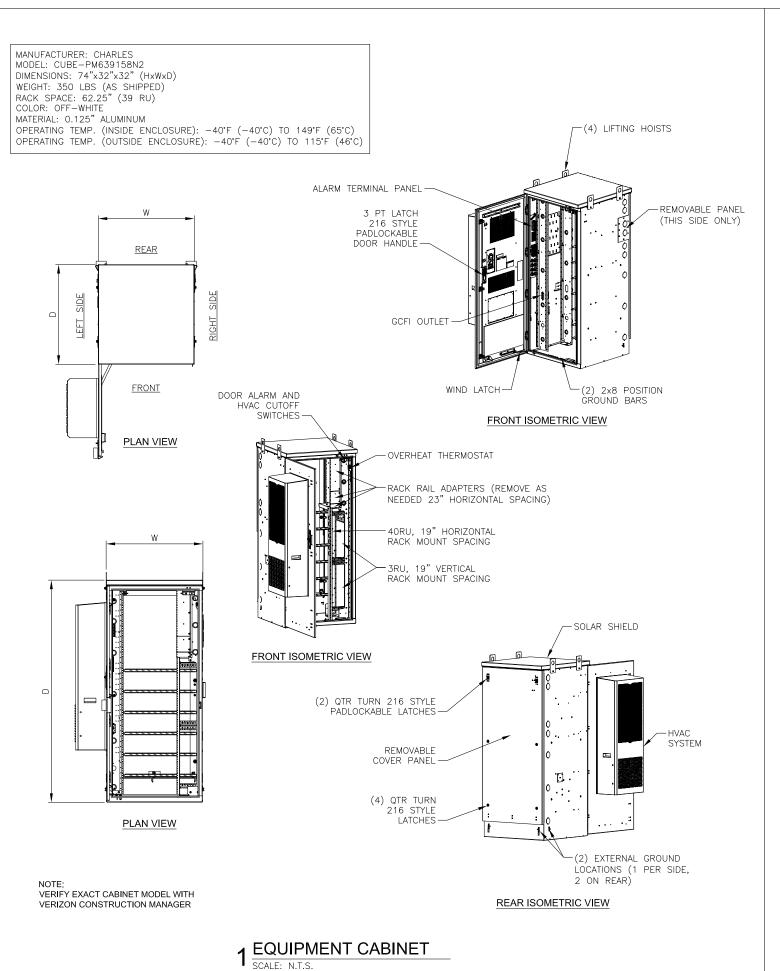

MANUFACTURER: RAYCAP MODEL: RCMDC-4520-RM-48 DIMENSIONS: 5.18"x18.32"x15.80" (HxWxD) WEIGHT: 22.10 LBS RACK SPACE: 3 RU

RACK MOUNTED DISTRIBUTION SURGE PROTECTION FOR (12) RRH DC CIRCUITS.



PREPARED FOR:

CHICAGO SMSA LIMITED PARTNERSHIP D/B/A VERIZON WIRELESS 1701 GOLF ROAD TOWER 2, SUITE 400 ROLLING MEADOWS, IL 60008

SITE NAME:

WHITEWATER SOUTH

SITE NUMBER:

765538

SITE ADDRESS:
797 INDIAN MOUND PARKWAY
WHITEWATER, WI 53190
WALWORTH COUNTY

STAMP:






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APP	ROVED BY:	LM		
DATE DRAWN:		04/30/24		
		REVISION		
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Α	ISSUED FO	R REVIEW	DP	05/06/24
0	ISSUED FOR C	CONSTRUCTION	DD	05/08/24
SHEET TITLE:				


GROUND EQUIPMENT SPECIFICATIONS

SHEET NUMBER:

A4.4


2 RACK MOUNTED SURGE PROTECTION SCALE: N.T.S.

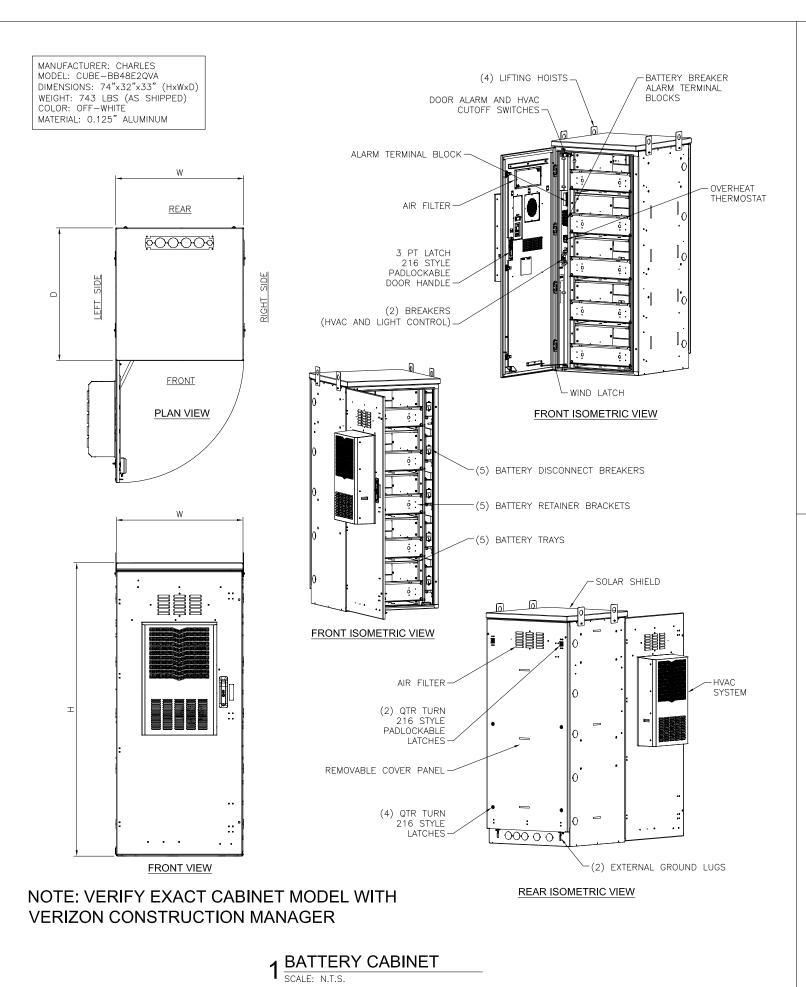

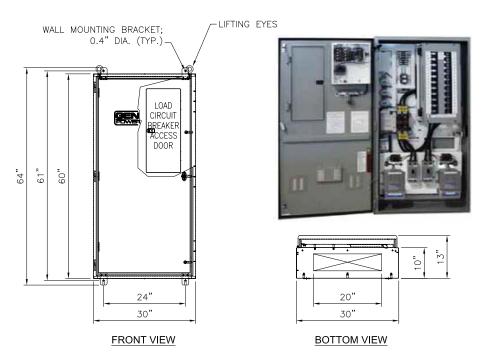

ILC RATED AMPS	VOLTAGE	PHASE	ENCLOSURE HEIGHT	ENCLOSURE WIDTH	ENCLOSURE DEPTH	WEIGHT
200	120/240	1	60"	30"	10"	350 LBS
200	120/240	3	60"	30"	10"	350 LBS

2 INTEGRATED LOAD CENTER SCALE: N.T.S.

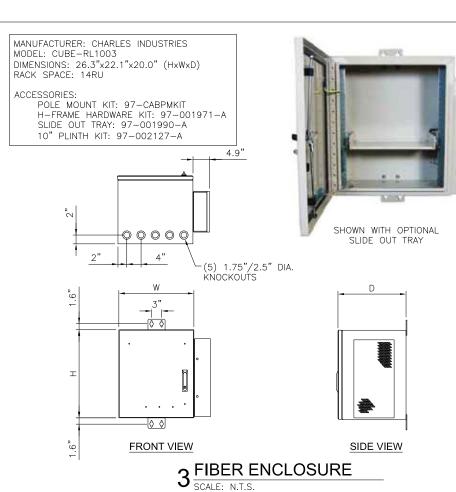

PREPARED FOR:

CHICAGO SMSA LIMITED PARTNERSHIP
D/B/A VERIZON WIRELESS
1701 GOLF ROAD
TOWER 2, SUITE 400
ROLLING MEADOWS, IL 60008

SITE NAME:

WHITEWATER

SOUTH SITE NUMBER:

SITE NUMBER: **765538**

SITE ADDRESS:
797 INDIAN MOUND PARKWAY
WHITEWATER, WI 53190
WALWORTH COUNTY

STAMP:





MOUNTAIN, LTD.
ENGINEERING


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			LM		
	DATE	DRAWN:	04/30/24		
			REVISION		
	NO	DESCRIPTION		BY	DATE
	Α	ISSUED FO	R REVIEW	DP	05/06/24
	0	ISSUED FOR C	ONSTRUCTION	DD	05/08/24
	SHEE	T TITLE:			

GROUND EQUIPMENT SPECIFICATIONS

SHEET NUMBER:

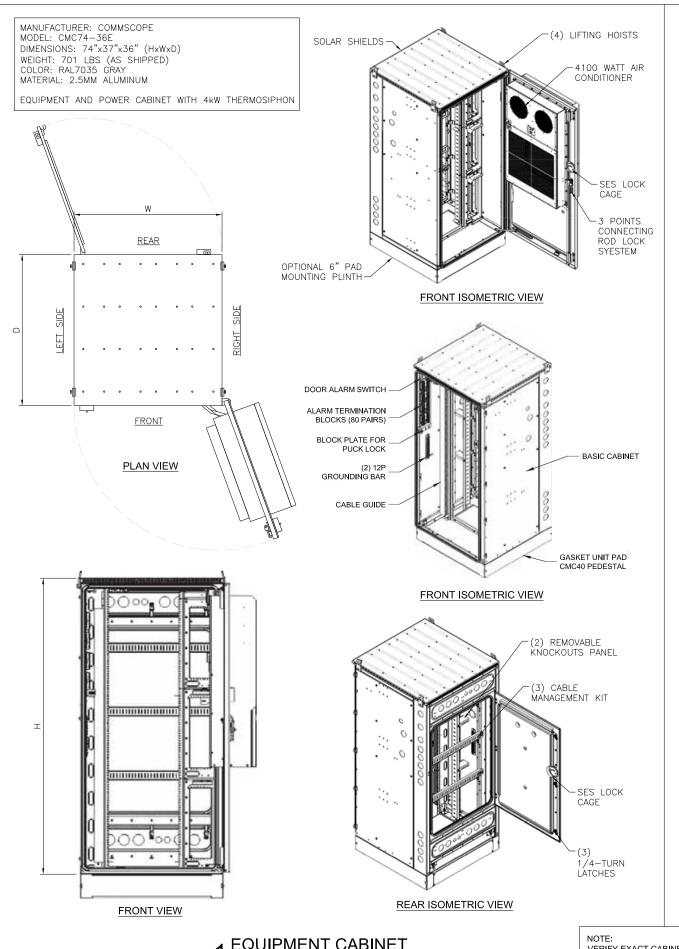

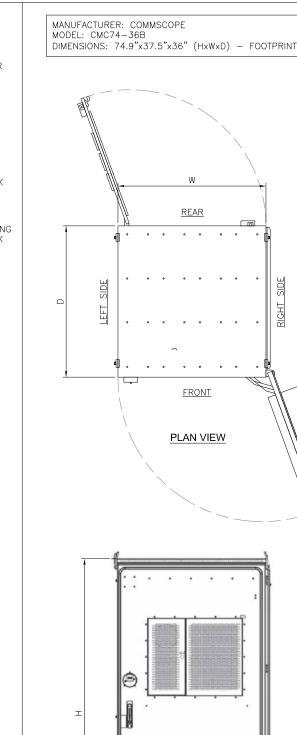

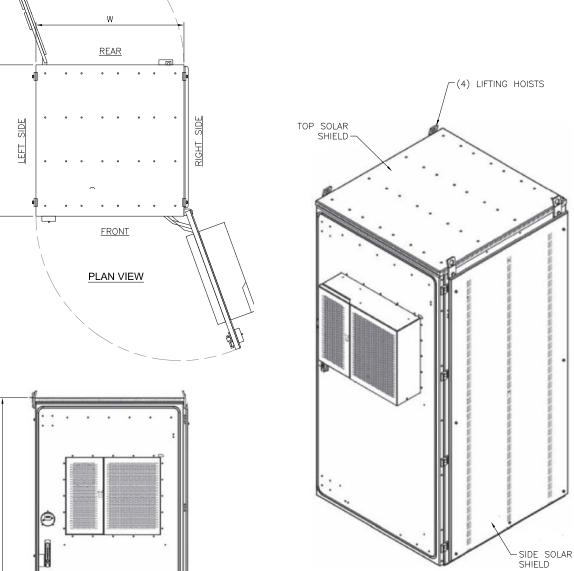



CHICAGO SMSA LIMITED PARTNI D/B/A VERIZON WIRELESS 1701 GOLF ROAD TOWER 2, SUITE 400 ROLLING MEADOWS, IL 60008

SITE NAME:

WHITEWATER

SOUTH SITE NUMBER:

765538

SITE ADDRESS: 797 INDIAN MOUND PARKWAY WHITEWATER, WI 53190 WALWORTH COUNTY

STAMP:



05/08/24



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DA	DATE DRAWN:		04/30/24		
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0		ISSUED FOR C	ONSTRUCTION	DD	05/08/24
SHEET TITLE:					

GROUND EQUIPMENT SPECIFICATIONS


SHEET NUMBER: A4.6

1 EQUIPMENT CABINET SCALE: N.T.S.

VERIFY EXACT CABINET MODEL WITH VERIZON CONSTRUCTION MANAGER

FRONT VIEW

2 BATTERY CABINET SCALE: N.T.S.

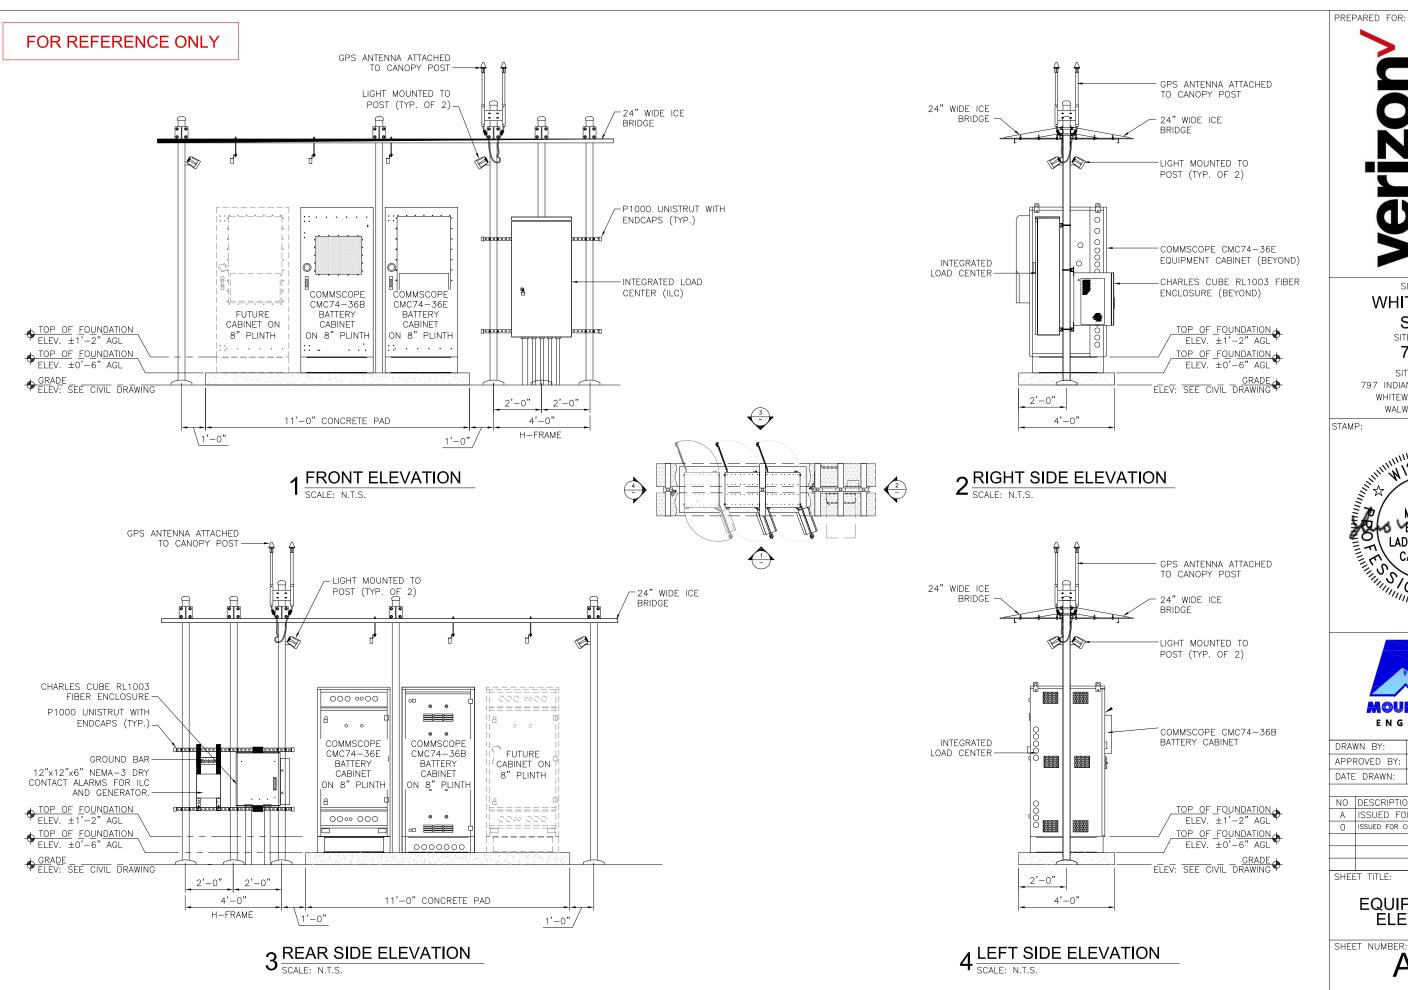



LIMITED PARTNERSHIP I WIRELESS 80009 CHICAGO SMSA LIMITED D/B/A VERIZON WIRELE 1701 GOLF ROAD TOWER 2, SUITE 400 ROLLING MEADOWS, IL &

SITE NAME:


WHITEWATER

SOUTH SITE NUMBER:

765538

SITE ADDRESS: 797 INDIAN MOUND PARKWAY WHITEWATER, WI 53190 WALWORTH COUNTY

STAMP:

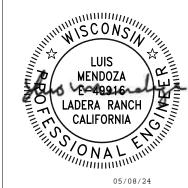




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APP	ROVED BY:	LM				
DATE	DRAWN:	04/30/24				
		REVISION				
NO	DESCRIPTION		BY	DATE		
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0	ISSUED FOR C	ONSTRUCTION	DD	05/08/24		
SHEET TITLE:						

EQUIPMENT PAD ELEVATIONS

SHEET NUMBER:

- CONCRETE CONSTRUCTION SHALL BE IN COMPLIANCE WITH THE AMERICAN CONCRETE INSTITUTE - ACI 318 BUILDING CODE REQUIREMENTS FOR STRUCTURAL CONCRETE, AND ACI 301 INDUSTRY SPECIFICATION FOR STRUCTURAL CONCRETE.
- ALL CONCRETE WORK SHALL BE PERFORMED IN ACCORDANCE WITH ACI301, ACI318, ACI336, ASTM A184, ASTM A185, AND THE DESIGN AND CONSTRUCTION SPECIFICATION FOR COST-IN-PLACE CONCRETE.
- MINIMUM ALLOWABLE CONCRETE COMPRESSIVE STRENGTH SHALL BE 4000 PSI AT 28 DAYS WHEN TESTED IN ACCORDANCE WITH THE
 AMERICAN SOCIETY FOR TESTING AND MATERIALS
 METHODS STANDARDS ASTM C172, ASTM C31, AND ASTM C39 UNLESS NOTED OTHERWISE.
- REINFORCING STEEL SHALL CONFORM TO ASTM A615, GRADE 60 KSI DEFORMED BAR UNLESS NOTED OTHERWISE. WELDING WIRE FABRIC SHALL CONFORM TO ASTM A185 WELDED STEEL WIRE FABRIC. SPLICES SHALL BE CLASS "B" AND ALL HOOKS SHALL BE STANDARD.
- REINFORCING STEEL SHALL BE ACCURATELY PLACED AND ADEQUATELY SECURED IN POSITION. LOCATION OF REINFORCEMENT SHALL BE AS INDICATED ON THE DRAWINGS. CONCRETE COVER SHALL BE AS SHOWN.
- TOP OF FOUNDATION TO HAVE A "BRUSH FINISH" EXPOSED FINISHED SURFACE IS NOT TO HOLD WATER.
- ALL SURFACES ARE TO BE CLEANED OF ANY RESIDUAL CONCRETE FROM SPLASHING OR SPILLS.

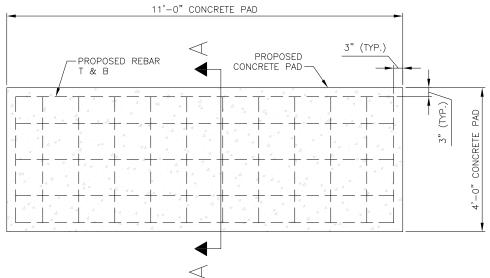

PLAN VIEW

- SLAB TO BE LEVEL (±) 1/4"
- FOUNDATION SHALL HAVE A MINIMUM 4" PROJECTION ABOVE GRADE
- THE EXISTING SUB-BASE SHALL BE FIELD REVIEWED TO QUALIFY AS UNDISTURBED & NON-ORGANIC STRATUM TO RESIST MINIMUM 500 PSF GRAVITY LOAD WITHOUT
- IF THE FIELD REVIEW OF THE LOCAL SOIL INDICATES FILL OR SUB—STANDARD SOIL MATERIAL WITHIN BASE OR SUB—BASE, THE CONTRACTOR SHALL EXTEND EXCAVATION TO A DEPTH WHERE THE NATURAL SOIL CAN BE REACHED. THEN WILL REPLACE THE EXISTING WITH WELL GRADED STRUCTURAL FILL TO BE
- IN LIEU OF THE PROPER SOIL INVESTIGATION AND GEOTECHNICAL

CONCRETE STRENGTH SHALL BE A MINIMUM OF 4000 PSI @ 28DAYS

REPLACE OR IMPROVE THE EXISTING SOIL WITHIN THE BASE IF IT CONTAINS NON-GRANULAR, WET, ORGANIC, OR NON-COMPACTABLE MATERIALS BEFORE ATTEMPTING TO PROCEED TO COMPACTION.

DIFFERENTIAL SETTLEMENT.

COMPACTED AS INDICATED.

THE FOUNDATION CONSTRUCTION WORK SHALL BE COORDINATED AND APPROVED BY THE JURISDICTION & THE PROJECT OWNER AS APPLICABLE.

RECOMMENDATIONS THAT ARE FOLLOWED BY THE CONSTRUCTION, A NOMINAL DIFFERENTIAL SETTLEMENT MAY BE EXPECTED.

PREPARED FOR:

LIMITED PARTNERSHIP WIRELESS CHICAGO SMSA LIMITED D/B/A VERIZON WIRELE 1701 GOLF ROAD TOWER 2, SUITE 400 ROLLING MEADOWS, IL 6

80009

SITE NAME:

WHITEWATER

SOUTH SITE NUMBER:

765538

SITE ADDRESS: 797 INDIAN MOUND PARKWAY WHITEWATER, WI 53190 WALWORTH COUNTY

STAMP.







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	0	ISSUED FOR C	ONSTRUCTION	DD	05/08/24
	SHEET TITLE:				

EQUIPMENT PAD

DETAILS

SHEET NUMBER A4.8

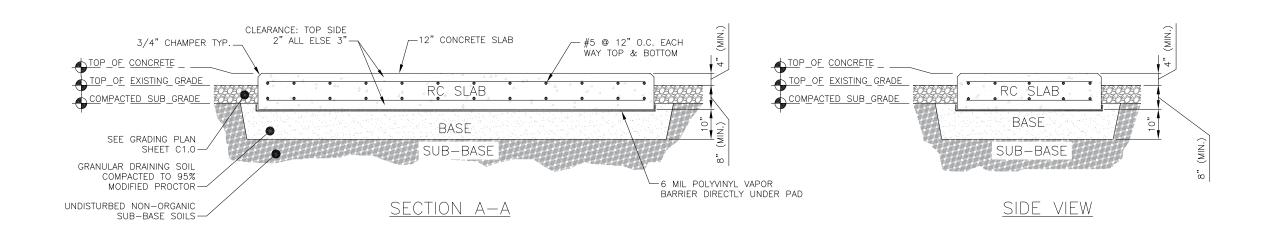

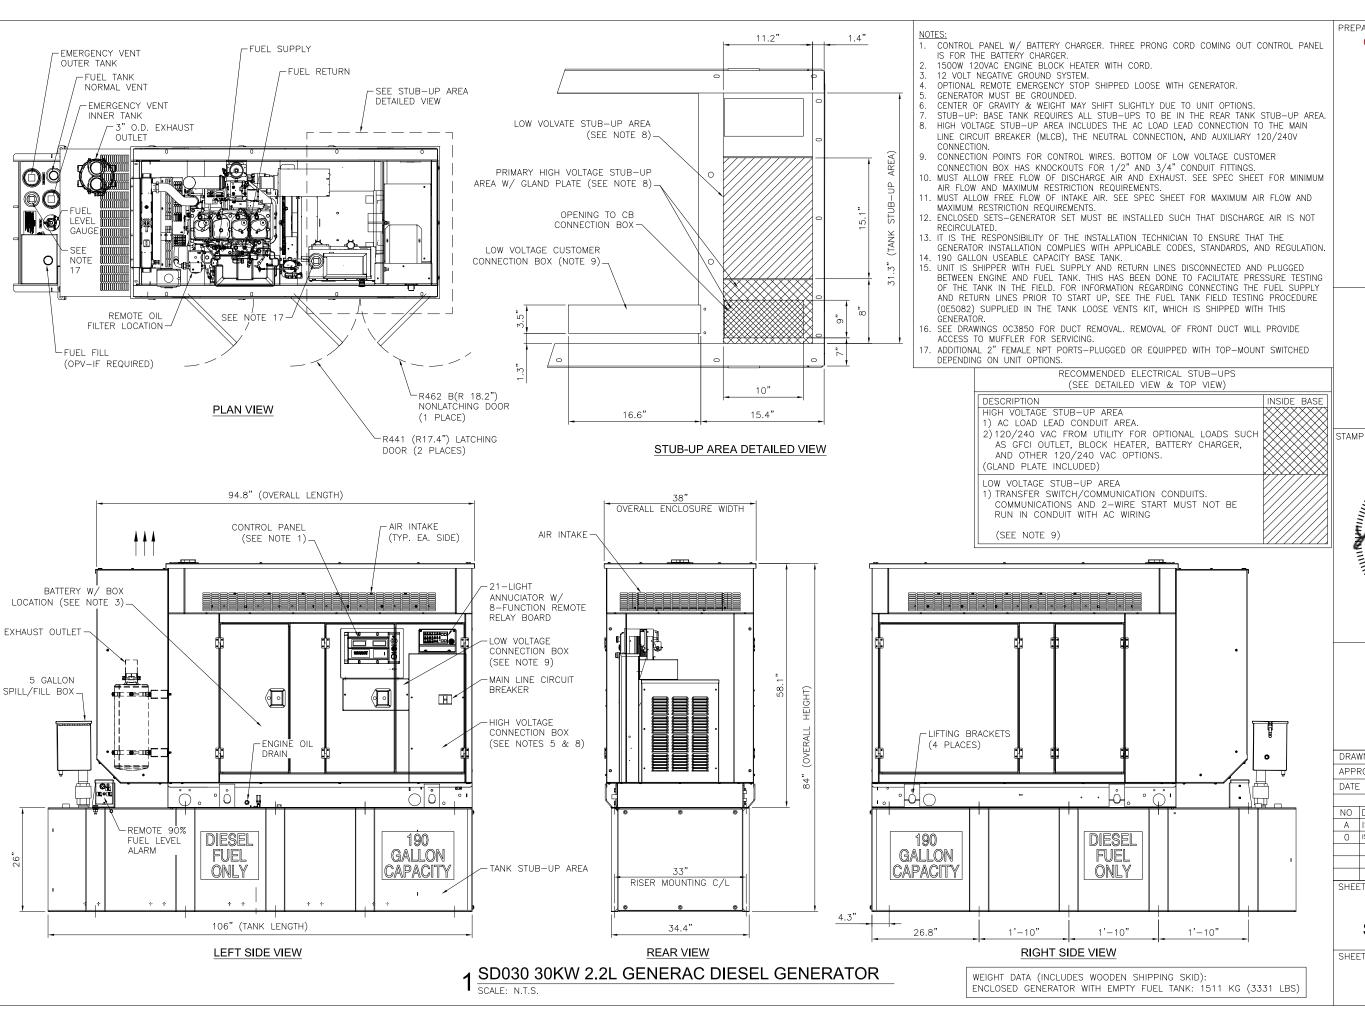

PREPARED FOR:

LIMITED PARTNERSHIP | WIRELESS CHICAGO SMSA LIMITED D/B/A VERIZON WIRELE 1701 GOLF ROAD TOWER 2, SUITE 400 ROLLING MEADOWS, IL

SITE NAME:

WHITEWATER

SOUTH SITE NUMBER:

765538


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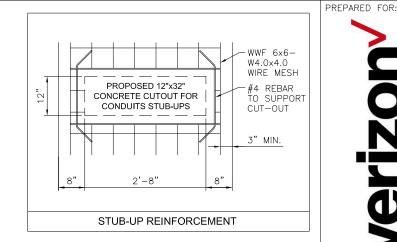




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APP	ROVED BY:	LM				
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		REVISION				
NO	DESCRIPTION	N	BY	DATE		
Α	ISSUED FOR REVIEW		DΡ	05/06/24		
0	ISSUED FOR C	ONSTRUCTION	DD	05/08/24		
SHEE	SHEET TITLE:					

GENERATOR SPECIFICATIONS



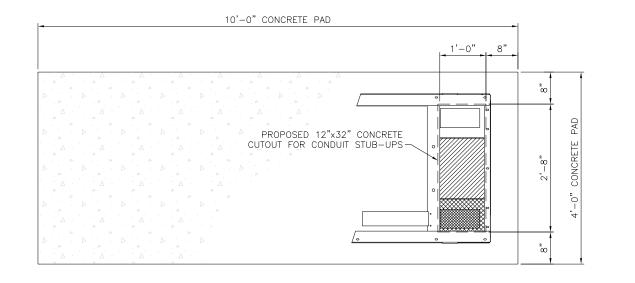

VERIFY EXACT CONDUIT STUB-UP LOCATIONS WITH GENSET PLANS

LIMITED PARTNERSHIP | WIRELESS CHICAGO SMSA LIMITED D/B/A VERIZON WIRELE 1701 GOLF ROAD TOWER 2, SUITE 400 ROLLING MEADOWS, IL 6

SITE NAME:

WHITEWATER

SOUTH SITE NUMBER:

765538

SITE ADDRESS: 797 INDIAN MOUND PARKWAY WHITEWATER, WI 53190 WALWORTH COUNTY



AOUNTAIN, LTD. ENGINEERING

		0.		
APPF	ROVED BY:	LM		
DATE	DRAWN:	04/30/24		
		REVISION		
NO	DESCRIPTIO	DESCRIPTION		DATE
Α	ISSUED FO	R REVIEW		05/06/24
0	ISSUED FOR C	ONSTRUCTION	DD	05/08/24
SHEE	T TITLE:			

GENERATOR PAD FOUNDATION **DETAILS**

SHEET NUMBER:

DRAWN BY: DP

A4.10

1 GENERAC DIESEL GENERATOR FOUNDATION LAYOUT

GENERATOR CLEARANCE NOTE:


- MINIMUM OF 10' OF CLEARANCE FROM COMBUSTIBLE WALL
- MINIMUM OF 5' OF CLEARANCE FROM NON-COMBUSTIBLE WALL MINIMUM OF 20' OF CLEARANCE FROM AN OUTDOOR ELECTRICAL
- TRANSFORMER OR NORMAL POWER DISTRIBUTION FOUIPMENT

SEE GENERATOR MANUFACTURER'S DRAWING FOR PHYSICAL LOCATION OF FUEL LINES, CONTROL AND POWER INTERCONNECTIONS AND OTHER INTERFACES THAT ARE TO BE CAST INTO THE CONCRETE. THE PREFERRED METHOD IS TO BRING THE CONDUIT THROUGH THE CONCRETE PAD TO THE UNDERSIDE OF THE GENERATOR (MINIMIZES RODENT DAMAGE). FINISH CONNECTIONS WITH FLEXIBLE CONDUIT PER GENERATOR MANUFACTURER'S SPECIFICATIONS. RIGID CONDUITS SHALL BE SECURED TO THE EXISTING SLAB, THEN BURIED BETWEEN SLAB AND PLATFORM.

NOTE:

SLAB NOT SUITABLE AT SITES WITH ORGANIC SOIL, UNCOMPACTED FILL, EXPANSIVE SOIL, OR SOILS SUSCEPTIBLE TO FROST HEAVE.


REMOVE ALL ORGANIC MATERIAL, SOFT AREA, AND POOR SOILS BENEATH CONCRETE PAD TO A DEPTH OF AT LEAST 4'-0" BELOW CONCRETE PAD.

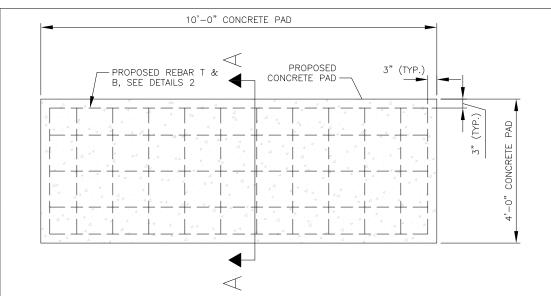


PLAN VIEW

NOTE:

- ALL CONCRETE CONSTRUCTION SHALL BE IN COMPLIANCE WITH THE AMERICAN CONCRETE INSTITUTE ACI 318 BUILDING CODE REQUIREMENTS FOR STRUCTURAL CONCRETE, AND ACI 301 INDUSTRY SPECIFICATION FOR STRUCTURAL CONCRETE.
- ALL CONCRETE WORK SHALL BE PERFORMED IN ACCORDANCE WITH ACI301, ACI318, ACI336, ASTM A184, ASTM A185, AND THE DESIGN AND CONSTRUCTION SPECIFICATION FOR COST-IN-PLACE CONCRETE.
- MINIMUM ALLOWABLE CONCRETE COMPRESSIVE STRENGTH SHALL BE 4000 PSI AT 28 DAYS WHEN TESTED IN ACCORDANCE WITH THE AMERICAN SOCIETY FOR TESTING AND MATERIALS METHODS STANDARDS ASTM C172, ASTM C31, AND ASTM C39 UNLESS
- REINFORCING STEEL SHALL CONFORM TO ASTM A615, GRADE 60 KSI DEFORMED BAR UNLESS NOTED OTHERWISE. WELDING WIRE FABRIC SHALL CONFORM TO ASTM A185 WELDED STEEL WIRE FABRIC. SPLICES SHALL BE CLASS "B" AND ALL HOOKS SHALL
- REINFORCING STEEL SHALL BE ACCURATELY PLACED AND ADEQUATELY SECURED IN POSITION. LOCATION OF REINFORCEMENT SHALL BE AS INDICATED ON THE DRAWINGS. CONCRETE COVER SHALL BE AS SHOWN.
- TOP OF FOUNDATION TO HAVE A "BRUSH FINISH"
- EXPOSED FINISHED SURFACE IS NOT TO HOLD WATER.
- ALL SURFACES ARE TO BE CLEANED OF ANY RESIDUAL CONCRETE FROM SPLASHING
- CONCRETE PAD FOR GENERATOR SHALL BE 12" THICK.
- 10. GENERATOR PAD CONCRETE SHALL BE POURED NEAT AGAINST TOTALLY CLEANED EXCAVATION & FORMED SURFACES WITH 6MIL POLYVINYL VAPOR BARRIER BASE.

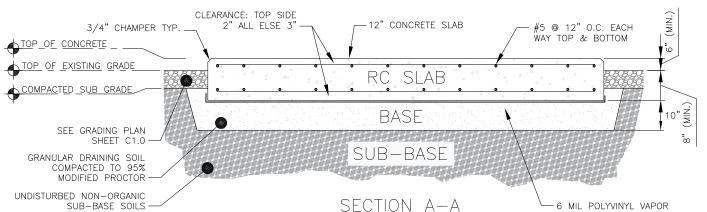


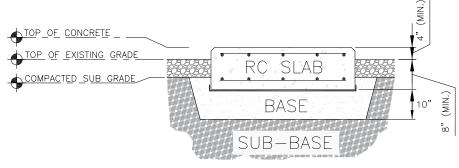

SIDE VIEW

 $2^{\underbrace{\text{GENERAC DIESEL GENERATOR FOUNDATION DETAIL}}_{\text{SCALE: N.T.S.}}$

BARRIER DIRECTLY UNDER PAD

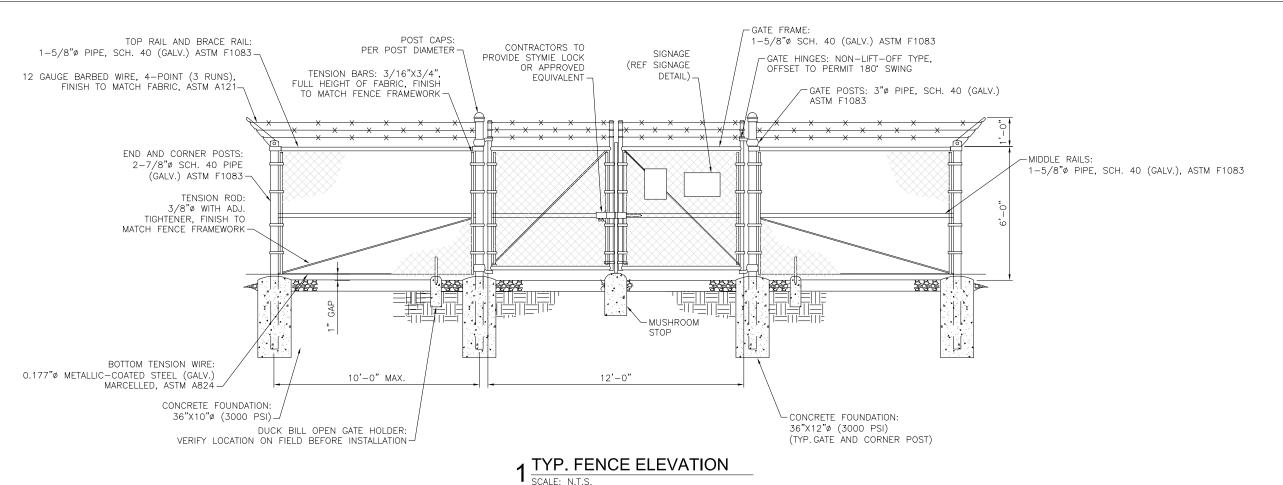

-FINISH GRADE MUSHROOM STOP, INSTALL WITH SLOT PARALLEL W/ CLOSED GATES 10"ø CONCRETE FOOTING 24" DEEP

USE 3,000-PSI CONCRETE, FULLY CONSOLIDATED AROUND THE POST.

- 2. WHERE THE POST IS SET IN ROCK OR CONCRETE, CORE A HOLE 12" DEEP AND 1" LARGER IN DIAMETER THAN THE POST. SET THE POST AND GROUT IN PLACE USING NON-SHRINK GROUT.
- NON—SHRINK GROUI.

 ALL POSTS MUST BE PLUMB AND ALIGNED WITH ONE ANOTHER IN BOTH HORIZONTAL AND VERTICAL PLANES.


 CORNERS AND GATES POSTS FOR CHAIN LINK FENCE SHALL EXTEND ABOVE THE TOP STRAND OF BARBED WIRE TO PROVIDE TENSIONING FOR THE BARBED WIRE.

 PROVIDE MIDRAILS AND BRACING AT ALL CORNER POSTS WHERE THE FENCE CHANGES DIRECTION BY MORE THAN 30 DEGREES.


- THE GRADE OF THE SITE AND INSTALLATION OF THE FENCE SHALL PROVIDE FOR NO MORE THAN A 1" GAP BETWEEN THE BOTTOM OF THE FENCE MATERIAL AND FINISH
- 7. CONTRACTOR SHALL PROVIDE HOLD OPEN DEVICES FOR ALL GATES AT THE SPECIFIED OPEN POSITIONS, DRIVEN PIPE TYPE RECEIVERS ARE NOT AUTHORIZED.

 8. CONTRACTOR SHALL ALSO PROVIDE A MUSHROOM TYPE RECEIVER AT THE CLOSE POSITION.

 $2^{\frac{\text{MUSHROOM STOP}}{\text{SCALE: N.T.S.}}}$

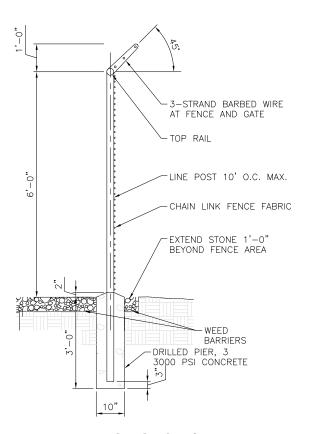

2 TYP. FENCE SECTION

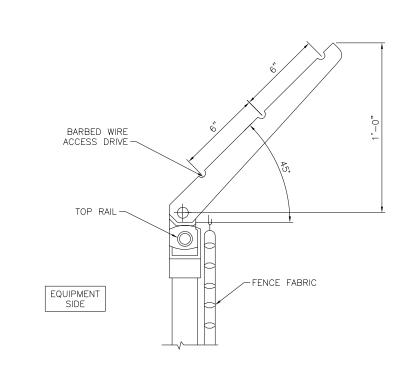

TYP. BARBED WIRE DETAIL

PREPARED FOR:

LIMITED PARTNERSHIP I WIRELESS 80009

SITE NAME:


WHITEWATER

SOUTH SITE NUMBER:

765538

SITE ADDRESS: 797 INDIAN MOUND PARKWAY WHITEWATER, WI 53190 WALWORTH COUNTY

STAMP:

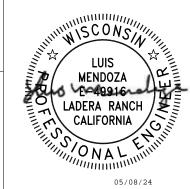



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APPF	ROVED BY:	LM					
DATE	DRAWN:	04/30/2	4				
		REVISION					
NO	DESCRIPTIO	N	BY	DATE			
Α	ISSUED FO	R REVIEW	DP	05/06/24			
0	ISSUED FOR C	ONSTRUCTION	DD	05/08/24			
SHEE	T TITLE:						

FENCE DETAILS

A NOTICE A

GUIDELINES FOR WORKING IN RADIO FREQUENCY ENVIRONMENTS

- All personnel should have electromagnetic energy (EME)
- awareness training. All personnel entering this must be authorized

- All personnel entering this must be authorized.

 Cibey all posted signs.

 Assume all antennas are active.

 Before working on antennas, notify owners and disable appropriate transmitters.

 Maintain minimum 3 feet clearance from all antennas.

 Bo not stop in front of antennas.

 Use personal RF monitors while working near antennas.

 Never operate transmitters without shielding during normal operation.
- Do not operate base state antennas in equipment room.

RF GUIDELINES SIGN LOCATION ON:

- ANTENNA ENCLOSURE ENTRANCE
- EQUIPMENT ENCLOSURE GATE

INFORMATION

This is a Verizon Wireless Antenna Site

Site ID

For information, call:

800-264-6620

vertzon


NOC INFORMATION SIGN LOCATION ON: - EQUIPMENT ENCLOSURE GATE

PROVIDE ADHESIVE VINYL SIGNS IF LOCATION ALLOWS FOR IT METAL SIGN SPECIFICATIONS:

UV RESISTANT FOR OUTDOOR USE
ROUNDED CORNERS WITH PRE-DRILLED HOLES
NO OFFICIAL EME REPORT HAS BEEN PROVIDE. SIGNAGE SHOWN IS APPROXIMATE. WILL VERIFY WHEN REPORT IS GIVEN.

- SIGNAGE NOTES:

 1. SIGNS SHALL BE FABRICATED FROM CORROSION RESISTANT PRESSED METAL, AND PAINTEDS WITH LONG LASTING UV RESISTANT COATINGS.
- SIGNS (EXCEPT WHERE NOTED OTHERWISE) SHALL BE MOUNTED TO THE TOWER, GATE, AND FENCE USING A MINIMUM OG 9 GAUGE ALUMINUM WIRE, HOG RINGS (AS UTILIZED IN FENCE INSTALLATIONS) OR BRACKETS WHERE NECESSARY. BRACKETS SHALL BE OF SIMILAR METALS AS THE STRUCTURE TO AVOID GALVANIC CORROSION.

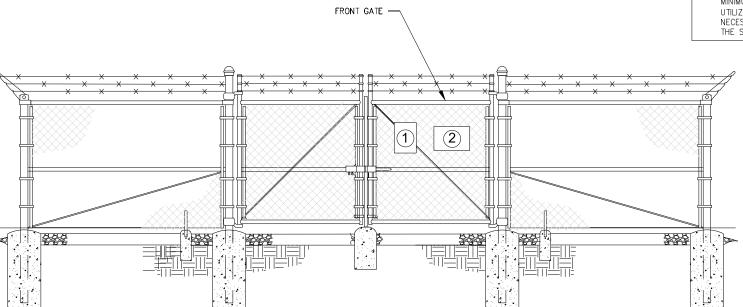



PREPARED FOR:

LIMITED PARTNERSHIP
I WIRELESS 80009

SITE NAME:


WHITEWATER

SOUTH SITE NUMBER:

765538

SITE ADDRESS: 797 INDIAN MOUND PARKWAY WHITEWATER, WI 53190 WALWORTH COUNTY

STAMP:

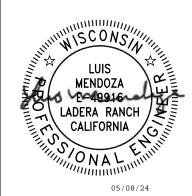





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	SHEE	T TITLE:			

SIGNAGE DETAILS

SHEET NUMBER: A4.12

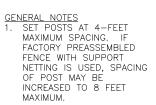

- 2. WHEN TWO SECTIONS OF FILTER FABRIC ADJOIN EACH OTHER, OVERLAP 6 INCHES AT THE POST, FOLD TOGETHER, AND ATTACH TO THE POSTS.
- 3. REMOVE SEDIMENT
 DEPOSITS WHEN SILT
 DEPTH REACHES
 ONE—THIRD OF THE HEIGHT
 OF THE FENCE.

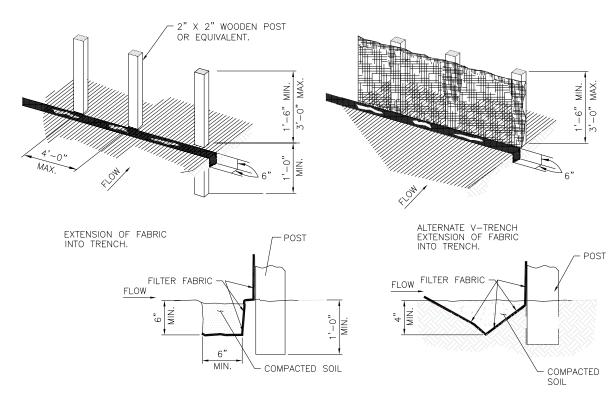



CHICAGO SMSA LIMITED PARTNERSHIP D/B/A VERIZON WIRELESS 1701 GOLF ROAD TOWER 2, SUITE 400 ROLLING MEADOWS, IL 60008

SITE NAME:

WHITEWATER


SOUTH

SITE NUMBER:

765538

SITE ADDRESS: 797 INDIAN MOUND PARKWAY WHITEWATER, WI 53190 WALWORTH COUNTY

STAMP:

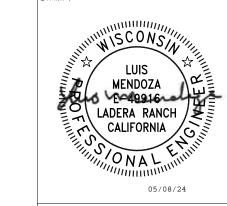



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			LM		
	DATE	DRAWN:	04/30/24		
	REVISION				
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	SHEET TITLE:				

SITE DETAILS

SHEET NUMBER: A4.13

KEY NOTES:


- $\begin{picture}(60,0)\put(0,0){\line(0,0){100}}\end{picture}$ ROUND RING #2 AWG SOLID TINNED COPPER GROUND LEAD MIN. 4'-6" BURY OR 6" BELOW FROST WHICH EVER IS GREATER
- (B) MAINTAIN 2-FOOT CLEARANCE
- © MASTER GROUND BAR (MGB) MOUNTED VERTICALLY TO FIRST ICE BRIDGE POST ON INSULATORS
- \bigcirc 5/8" DIAMETER x 10'-0" LONG COPPER CLAD GROUND ROD; SPACED AT 8' O.C.
- (E) BOND EQUIPMENT GROUND RING TO THE TOWER GROUND RING WITH (2) #2 SOLID BARE TINNED COPPER GROUND LEADS
- F EQUIPMENT CABINET GROUND; SEE SHEET E2.0 FOR DETAILS
- (ILC) GROUND; SEE SHEET E2.0 FOR DETAILS
- H FIBER ENCLOSURE GROUND; SEE SHEET E2.0 FOR DETAILS
- GENERATOR GROUND; SEE SHEET E2.0 FOR DETAILS
- (J) ICE BRIDGE POST GROUND; SEE SHEET E2.0 FOR DETAILS
- K EQUIPMENT PAD REBAR GROUND; SEE SHEET E2.1 FOR DETAILS
- GPS GROUND TO ICE BRIDGE POST; SEE SHEET E2.0 FOR DETAILS
- (M) GROUND FENCE POSTS WITHIN 6-FEET TO EQUIPMENT
- (N) INSPECTION WELL (TYP.); SEE SHEET E2.2 FOR DETAILS
- (O) EXISTING TOWER GROUND BAR

NOTES:

- THE GROUNDING SHALL BE TESTED PRIOR TO FINAL BACKFILLING. DOCUMENTATION OF 5 OHN OR LESS RESISTANCE TO BE PROVIDED TO PROJECT
- 2. ALL NON-INSULATED GROUND LEADS EXTENDING ABOVE GROUND LEVEL SHALL BE ENCASED IN 3/4" PVC & SEALED WITH SILICONE. PVC SHALL BE MIN. 16" INTO EARTH & EXTEND MIN. 6" ABOVE GROUND.
- 3. INSTALL 18"x18" COPPER PLATES IN LIEU OF GROUND RODS WHEN INSTALLING OVER TOWER FOUNDATION OR WHERE DRIVING GROUND RODS IS NOT FEASIBLE.

GROUNDING LEGEND:

- EXOTHERMIC OR UL RATED IRREVERSIBLE CONNECTION
- MECHANICAL CONNECTION
- GROUND LEAD
- INSPECTION WELL ⊗
 - 5/8" DIA. x 10'-0" LONG, STEEL CLAD W/ A PURE COPPER JACKET (10' MAX SEPARATION); TOP OF EACH GROUND ROD SHALL EXTEND NO
- MORE THAN 6" ABOVE BOTTOM OF TRENCH
- \otimes 18"x18"x0.32" THK COPPER PLATE (10' MAX SEPARATION)

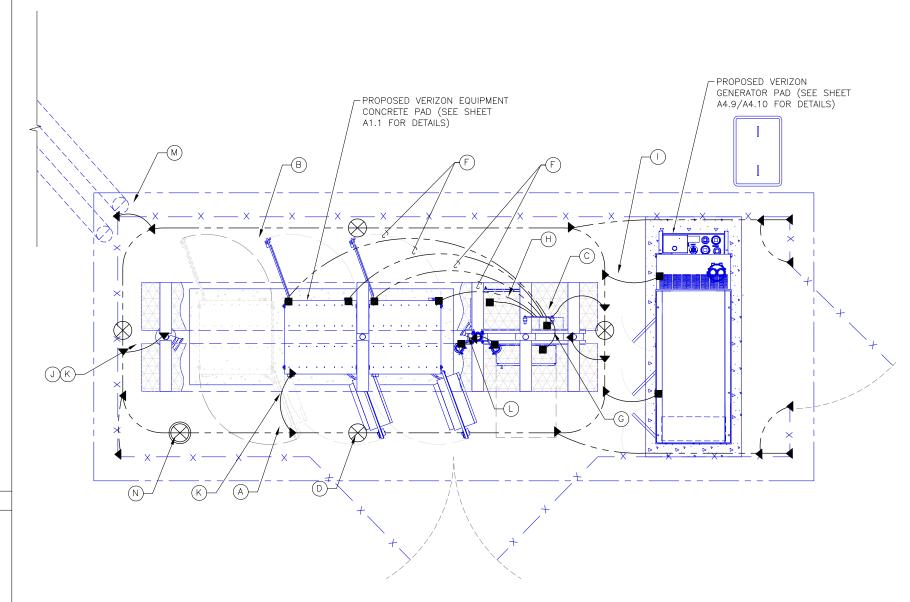

COMPOUND GROUNDING PLAN

FULL SIZE PLOT SCALE: 1/2" = 1'-0"

HALF SIZE PLOT SCALE: 1/4" = 1'-0"

TRUF

NORTH

PREPARED FOR:

SITE NAME:


WHITEWATER

SOUTH SITE NUMBER:

765538

SITE ADDRESS:

797 INDIAN MOUND PARKWAY WHITEWATER, WI 53190 WALWORTH COUNTY

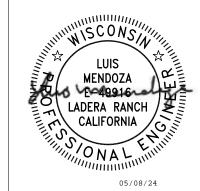





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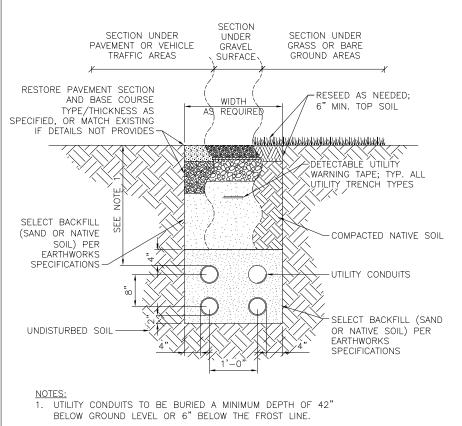
COMPOUND **GROUNDING PLAN**

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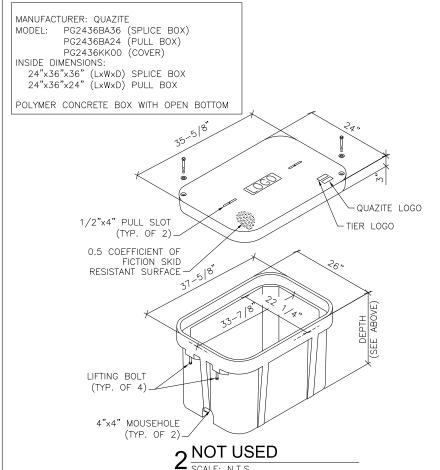
E1.0





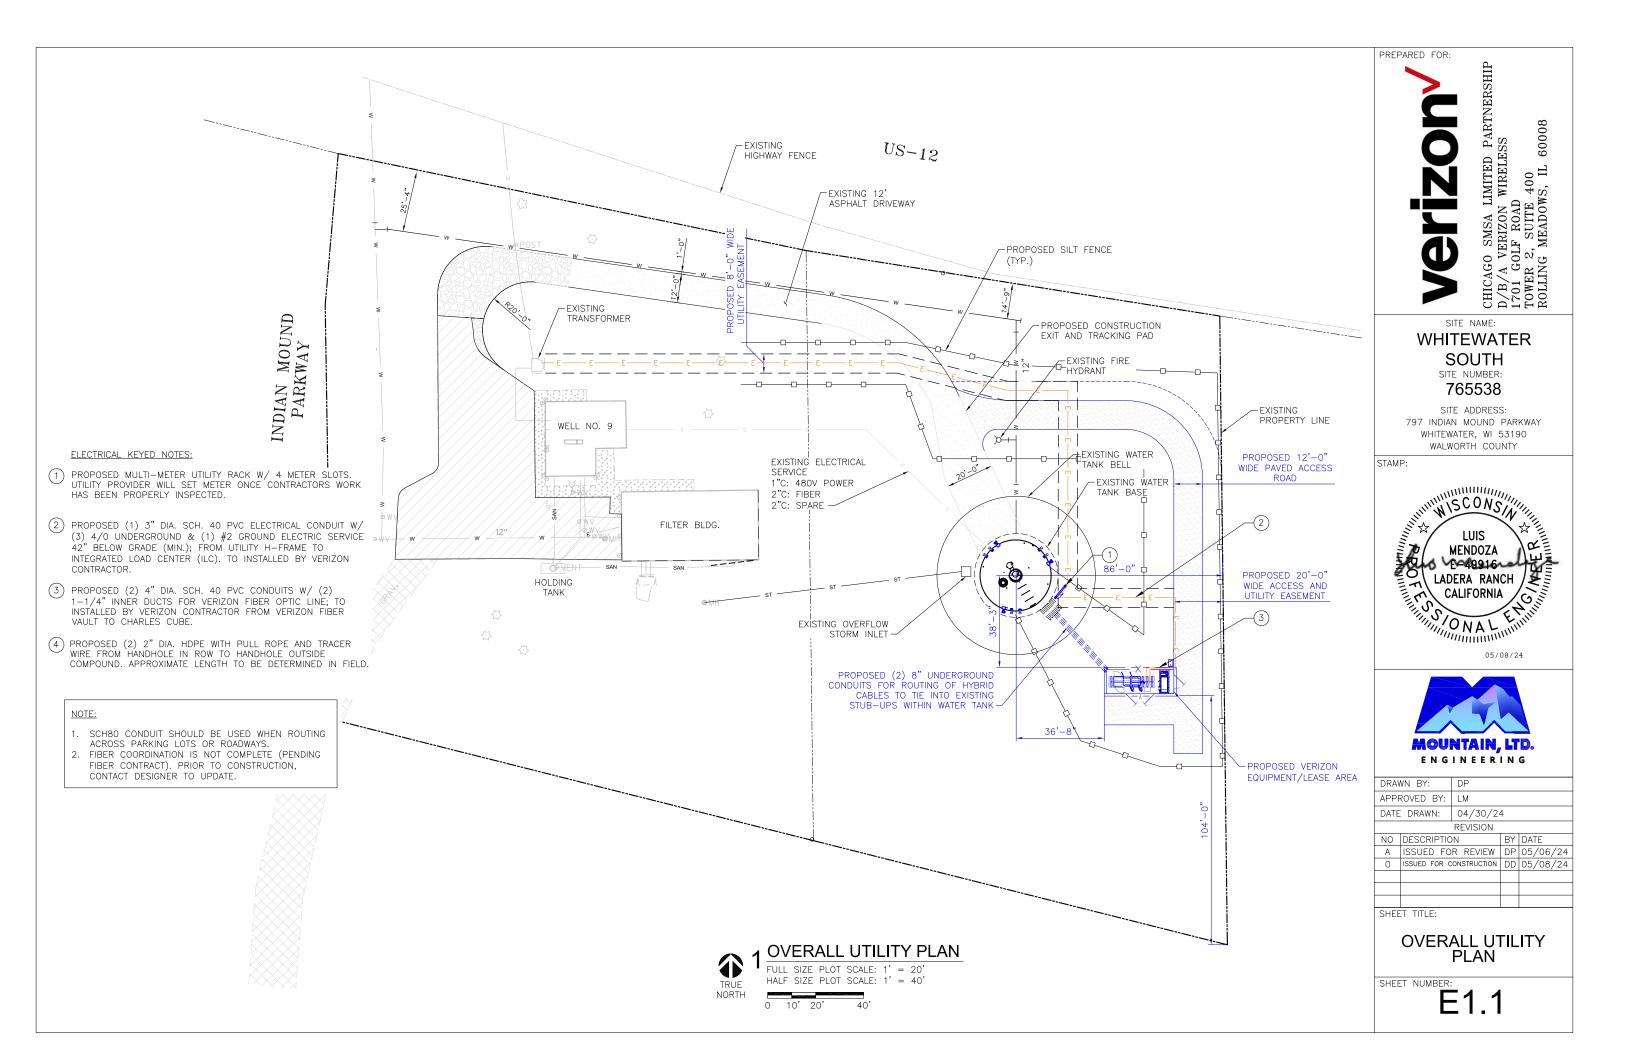

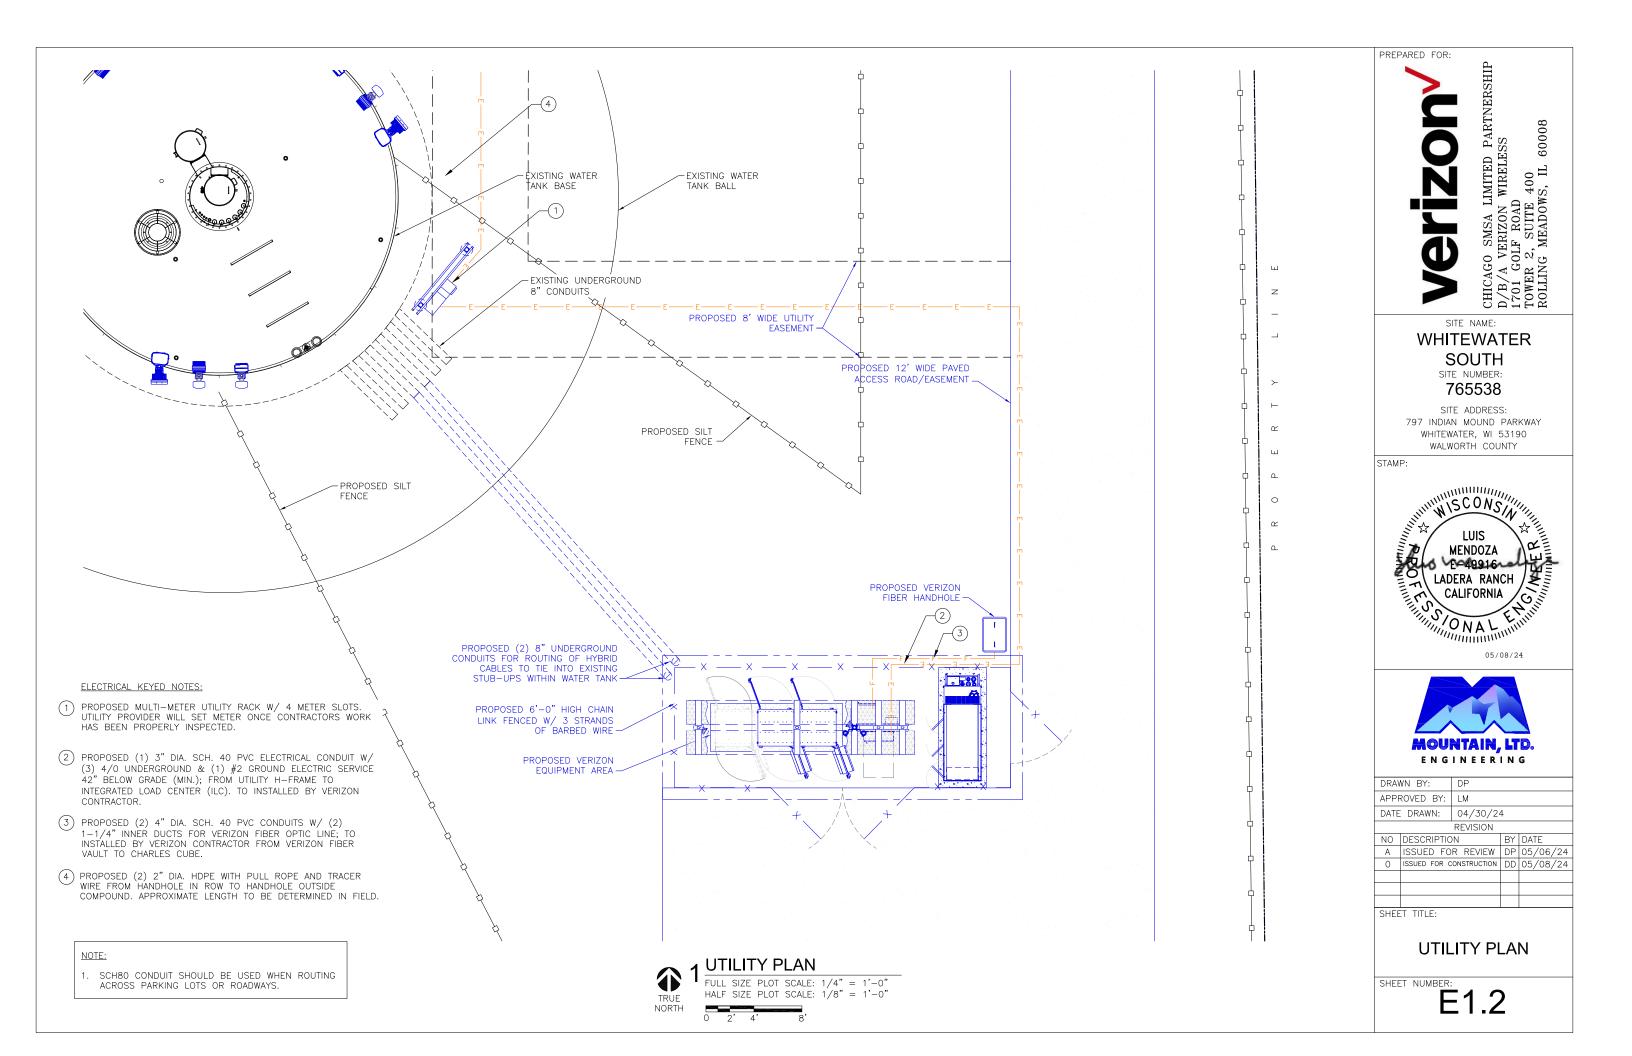UTILITY TRENCH



WARNING TAPE & TRACE WIRE NOTES:

THE TOP OF THE CONDUITS.

- WARNING TAPE TO BE INSTALLED ABOVE THE ELECTRICAL RUN FROM THE GENERATOR TO THE PLATFORM AND ABOVE THE FUEL LINE BETWEEN THE GENERATOR AND FUEL SOURCE.
- WARNING TAPE SHALL BE RUN CONTINUOUSLY ALONG THE ENTIRE LENGTH AND INSTALLED 12 INCHES ABOVE THE TOP OF THE CONDUITS
- TRACER WIRE SHALL RUN CONTINUOUSLY ALONG THE ENTIRE LENGTH OF
- THE BURIED GAS AND ELECTRIC CONDUITS. TRACER WIRE SHALL BE SECURED TO THE CONDUIT AND MAINTAINED ABOVE THE CONDUIT CENTERLINE DURING TRENCH BACKFILLING.
- TRACER WIRE TO EXTEND TO THE TOP OF PVC ABOVE CONCRETE ON BOTH ENDS - LOOP AND WRAP AROUND APPROPRIATE CONDUIT
- TRACER WIRE SHALL CONSIST OF 14GA. SOLID COPPER WIRE WITH A CORROSION PROTECTIVE COATING.
- INSTALL TRACER WIRE WITH SPACER AND SECURE PER MNFG. RECOMMENDATIONS — AT A MIN. EVERY 10' AND AT ALL BENDS. — DO NOT WRAP BURIED CONDUIT WITH TRACER WIRE TO AVOID UNNECESSARY STRESS ON TRACER. - CONTRACTOR TO CHECK CONTINUITY OF TRACER WIRE BEFORE AND AFTER BURIAL AND DOCUMENT RESULTS. 12" ABOVE

PREPARED FOR:

LIMITED PARTNERSHIP WIRELESS 80009 CHICAGO SMSA LIMITED D/B/A VERIZON WIRELE 1701 GOLF ROAD TOWER 2, SUITE 400 ROLLING MEADOWS, IL 6

SITE NAME:

WHITEWATER

SOUTH SITE NUMBER:

765538

SITE ADDRESS: 797 INDIAN MOUND PARKWAY WHITEWATER, WI 53190 WALWORTH COUNTY

STAMP



05/08/24




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SHEET TITLE:					

UTILITY **DETAILS**

E1.3

- KEYED NOTES: (4) NEW 200A 103W 120/240V METER IN METER BASE, BY ELECTRIC SERVICE PROVIDER.
- (4) NEW SERVICE ENTRANCE RATED DISCONNECT, 200A, 1ø3W 120/240V. INSTALL (4) 200A BREAKERS, ONE PER METER
- NEW MAIN TELCO ENCLOSURE. INSTALL GROUND STRIP AND NEMA 5-20R GFCI.
- 4" SCH 40 CONDUIT WITH (3) 1" CORRUGATED INNER DUCTS W/ PULL STRINGS FROM THE TELCO ENCLOSURE TO THE
- VERIZON TO INSTALL (1) 3" SCH 40 (ELBOWS SCH 80) CONDUIT FROM THE VÈRIZON H-FRAMÈ TO THE UTILITY POLE.

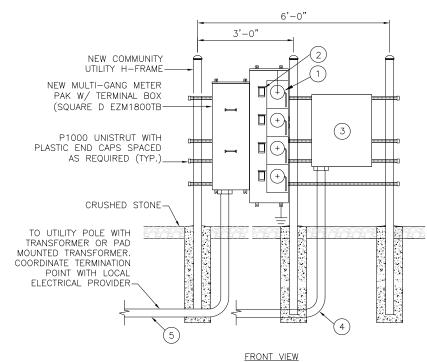

2 MULTI-TENANT UTILITY H-FRAME DETAIL SCALE: N.T.S.

CONFIGURATION OF SERVICE LATERAL SHOWN FOR REFERENCE. COORDINATE EXACT REQUIREMENTS WITH UTILITY PROVIDER.


- VERIFY ALL EXISTING UNDERGROUND UTILITIES BEFORE TRENCHING.
- 2. ELECTRICAL CONTRACTOR SHALL CONTACT POWER CO. & TELE. CO. AND VERIFY EXACT ROUTING, SIZES AND CONDITIONS BEFORE TRENCHING.
- 3. INSTALL ALL CONDUITS & EQUIPMENT AS SPECIFIED BY POWER CO. & TELE. CO.
- 4. PROVIDE NYLON PULL STRINGS ON ALL EMPTY CONDUITS.
 5. ONLY CONDUITS DIRECTLY SERVING VERIZON EQUIPMENT SHALL BE ROUTED SHEET NUMBER. THROUGH VERIZON LEASE AREA
- ADD E911 ADDRESS TO THE METER BANK. THE LETTERING NEEDS TO BE A MINIMUM OF 2" TALL.
- 7. LABEL EACH METER PER UTILITY COMPANY REQUIREMENTS.

KEY NOTES:

- (A) 1/4"x4"x12" COLLECTOR GROUND BAR (CGB) FOR CONNECTIONS OF MULTIPLE GROUND KITS AT ONE LEVEL
- (B) CGB GROUND #2 AWG GREEN-INSULATED STRANDED COPPER LEAD WITH 2 HOLE LONG BARREL AND UL LISTED BONDING CLAMP TO LOWER STEEL AND/OR MOUNT STEEL
- © ANCILLARY EQUIPMENT GROUND KIT #2 AWG STRANDED INSULATED LEAD TO GROUND BAR WITH 2 HOLE LONG BARREL
- (D) CABLE GROUND #2 AWG STRANDED INSULATED TO GROUND BAR WITH 2 HOLE LONG BARREL LUG (TYP.)
- (E) 1/4"x4"x20" MASTER GROUND BAR (MGB) MOUNTED VERTICALLY TO FIRST ICE BRIDGE POST ON INSULATORS
- F EQUIPMENT CABINET GROUND #2 AWG SOLID TINNED COPPER LEAD ENCASE IN LIQUID-TIGHT FLEXIBLE NON-METALLIC CONDUIT TO 24" BELOW GRADE TO EQUIPMENT PAD GROUND RING (TYP. OF 2 PER CABINET)
- © INTEGRATED LOAD CENTER (ILC) GROUND #2 AWG SOLID TINNED COPPER LEASE ENCASED IN LIQUID—TIGHT FLEXIBLE NON-METALLIC CONDUIT TO 24" BELOW GRADE TO EQUIPMENT
- (H) FIBER ENCLOSURE GROUND #2 AWG SOLD TINNED COPPER LEAD ENCASE IN LIQUID—TIGHT FLEXIBLE NON—METALLIC CONDUIT TO 24" BELOW GRADE TO EQUIPMENT PAD GROUND RING
- GENERATOR GROUND #2 AWG SOLID TINNED COPPER LEAD ENCASE IN LIQUID—TIGHT FLEXIBLE NON—METALLIC CONDUIT TO 24" BELOW GRADE TO EQUIPMENT PAD GROUND RING (TYP. OF
- O CANOPY POST GROUND #2 AWG SOLID TINNED COPPER LEAD ENCASED IN LIQUID—TIGHT FLEXIBLE NON—METALLIC CONDUIT TO 24" BELOW GRADE (TYP. OF 4)
- (K) CANOPY TO POST GROUND #2 AWG GREEN-INSULATED STRANDED COPPER LEAD WITH 2 HOLE LONG BARREL ON EACH
- © EQUIPMENT PAD REBAR GROUND #2 AWG SOLID TINNED COPPER LEASE ENCASE IN LIQUID—TIGHT FLEXIBLE NON—METALLIC CONDUIT TO 24" BELOW GRADE
- (M) CONDUIT GROUND #2 AWG SOLID TINNED COPPER LEAD
- N GPS GROUND TO ICE BRIDGE POST #2 AWG GREEN-INSULATED STRANDED COPPER LEAD
- ① ICE BRIDGE POST GROUND #2 AWG SOLID TINNED COPPER LEAD ENCASED IN LIQUID—TIGHT FLEXIBLE NON—METALLIC CONDUIT TO 24" BELOW GRADE (TYP.)
- (P) ICE BRIDGE SECTION GROUND #2 AWG GREEN-INSULATED STRANDED COPPER LEAD WITH 2 HOLE LONG BARREL ON EACH
- (Q) ICE BRIDGE SECTION TO POST GROUND #2 AWG SOLID TINNED COPPER LEAD (TYP.); ORIENT LEAD WITH HIGH SIDE TOWARDS TOWER
- (R) 14"x4"x20" TOWER GROUND BAR (TGB) INSTALLED ON TOWER; FOR LATTICE TOWERS, MOUNT TGB DIAGONALLY AT 12" ABOVE ICE BRIDGE FOR EASIER HOOK-UP OF GROUNDING KIT LEADS
- (S) TGB GROUND #2 AWG SOLID TINNED COPPER LEAD ENCASED IN LIQUID-TIGHT FLEXIBLE NON-METALLIC CONDUIT TO 24" BELOW GRADE FROM TGB TO TOWER GROUND RING (TYP. OF 2)
- TGB GROUND #2 AWG GREEN-INSULATED STRANDED COPPER LEAD WITH 2 HOLE LONG BARREL AND UL LISTED BONDING CLAMP TO FLAT METAL
- U SECURE GROUND LEADS TO TOWER WITH BAND STRAPS OR SNAP-IN HANGERS AT GENERAL CONTRACTOR'S DISCRETION. USE MULTIPLE LEVELS OF ATTACHMENT IF GROUND BAR IS ATTACHED HIGH ABOVE GRADE.

GROUNDING LEGEND:

- EXOTHERMIC OR UL RATED IRREVERSIBLE CONNECTION
- MECHANICAL CONNECTION
- ----- GROUND LEAD

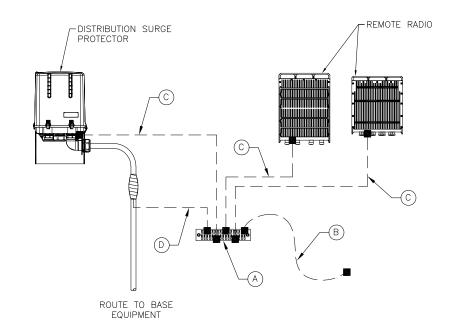

- ALL CABLING AND/OR GROUNDING RUNS SHALL BE INSTALLED IN A NEAT AND ORDERLY FASHION.
- CONTRACTOR SHALL INSTALL PER LATEST EDITION OF THE N.E.C. SCHEMATIC DETAIL ONLY. REFER TO ANTENNA AND EQUIPMENT CONFIGURATION FOR EQUIPMENT QUANTITY AND LOCATION.
- ALL GROUND LEADS TO BE ROUTED IN A DOWNWARD FASHION

ANTENNA LEVEL GROUNDING

NOTES:

- 1. ALL BELOW-GRADE CONNECTIONS AREA TO BE EXOTHERMICALLY WELDED A MINIMUM OF 48" BELOW GRADE.
- 2. ALL LEADS EXTENDING ABOVE GRADE TO BE ENCASE IN 3/4" CONDUIT AND EXTEND A MINIMUM OF 6" ABOVE FINISHED GRADE AND 24" BELOW FINISHED GRADE.
- 3. APPLY COLD GALVANIZATION TO ALL ABOVE-GROUND EXOTHERMICALLY WELDED CONNECTIONS.
- 4. APPLY ANTI OXIDANT COMPOUND TO ALL MECHANICAL CONNECTIONS.
- 6. AIR TERMINAL TO EXTEND 2" ABOVE HIGHEST ANTENNA MIN. OR MAST PIPE MECHANICALLY FASTEN AIR TERMINAL TO MAST PIPE MAST PIPE TO BE MECHANICALLY CONNECTED TO TOWER STEEL.

- 5. UPPER AND LOWER TOWER GROUND BARDS TO BE BONDED DIRECTLY TO TOWER STEEL WITH #2 CONDUCTORS.

PREPARED FOR:

SITE NAME:

LIMITED PARTNERSHIP WIRELESS

WHITEWATER SOUTH

SITE NUMBER:

765538

SITE ADDRESS: 797 INDIAN MOUND PARKWAY WHITEWATER, WI 53190 WALWORTH COUNTY

STAMP:







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GROUNDING DETAILS


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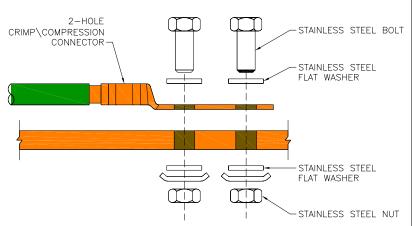


GROUND AND BUSS BAR

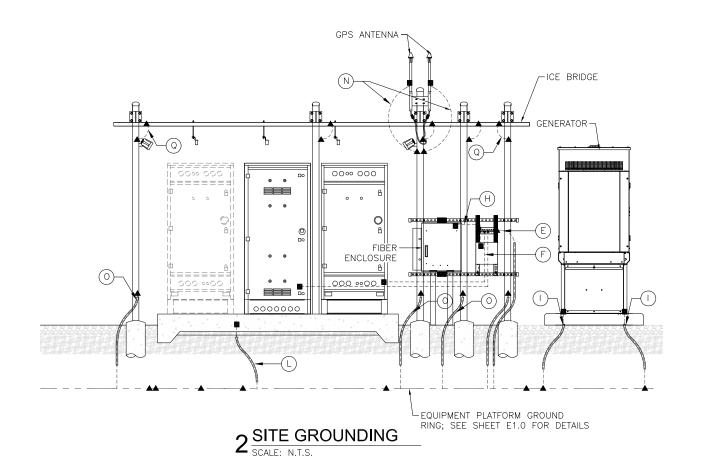

CABLE SIZE & TYPE	LENGTH	LUG	WEIGHT
1/2" CORRUGATED	5'	UNATTACHED	1.50 LB.
7/8" CORRUGATED	5'	UNATTACHED	1.65 LB.
1-1/4" CORRUGATED	5'	UNATTACHED	1.70 LB.
1-5/8" CORRUGATED	5'	UNATTACHED	1.80 LB.
2-1/4" CORRUGATED	5'	UNATTACHED	1.50 LB.
	1/2" CORRUGATED 7/8" CORRUGATED 1-1/4" CORRUGATED 1-5/8" CORRUGATED	1/2" CORRUGATED 5' 7/8" CORRUGATED 5' 1-1/4" CORRUGATED 5' 1-5/8" CORRUGATED 5'	1/2" CORRUGATED 5' UNATTACHED 7/8" CORRUGATED 5' UNATTACHED 1-1/4" CORRUGATED 5' UNATTACHED 1-5/8" CORRUGATED 5' UNATTACHED

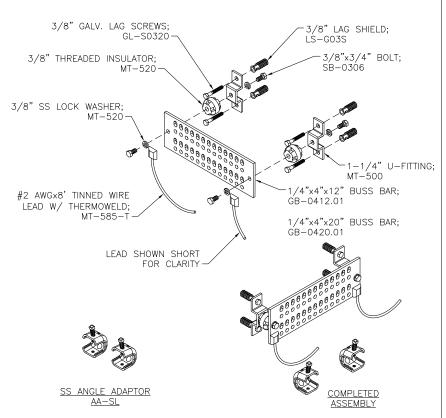
4 CLIP ON GROUND KIT SCALE: N.T.S.

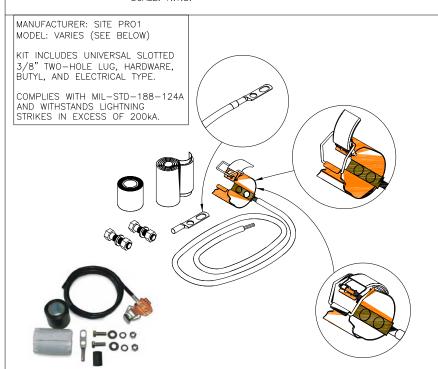

NOTES:

- 1. ALL OUTDOOR HARDWARE (BOLTS, SCREWS, NUTS, WASHERS) SHALL BE 18-8 STAINLESS STEEL TYPE GRADE. INDOORS, GRADE 5 STEEL HARDWARE MAY BE USED.
 2. CHOOSE BOLT LENGTH TO ALLOW THE EXPOSURE OF AT LEAST TWO THREADS.
- BACK TO BACK LUG CONNECTIONS ARE AN ACCEPTABLE PRACTICE WHEN BONDED TO
- A GROUND BAR OR STEEL OBJECTS. AT CONNECTIONS MADE TO STEEL OR ANY OTHER DISSIMILAR METALS, A DRAGON TOOTH WASHER MEETING VZW PRACTICES SHALL BE USED BETWEEN THE CONNECTOR
- 5. IF NOT USING DRAGON TOOTH WASHERS, THOROUGHLY REMOVE A SECTION OF PAINT OR COATING APPROXIMATELY THE SAME SIZE AS CONNECTOR. REMOVE THE PAINT FROM SURFACE USING A DREMEL TYPE TOOL.
- 6. USE AN APPROVED ANTI-OXIDATION COMPOUND ON ALL GROUNDING CONNECTIONS. A COPPER COSMOLINE GREASE BASED COMPOUND (NO OX-ID) SHALL BE USED ON ALL COPPER TO COPPER CONNECTIONS. A ZINC BASED (GREY COLORED) COMPOUND SHALL BE USED ON ALL COPPER TO STEEL CONNECTIONS.
- WHEN BONDING TO A METALLIC OBJECT WHERE ACCESS IS LIMITED TO ONLY ONE SURFACE, DRILLING & TAPPING OR SELF DRILLING SCREWS ARE THE PREFERRED AND ACCEPTABLE MEANS OF CONNECTIONS. SHEET METAL SCREWS SHALL NOT BE USED

2 GROUNDING LUG SCALE: N.T.S.

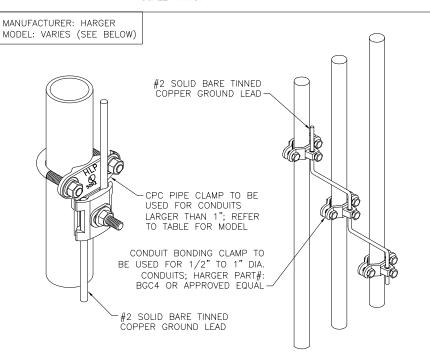

PART#	NOMINAL PIPE SIZE RANGE	PIPE OUTSIDE DIAMETER
CPC1/1.25	1"-1.25"	0.9375"-1.7"
CPC1.5/2	1.5"-2"	1.25"-2.4"
CPC2.5/3	2.5"-3"	2.5"-3.5"
CPC3.5/4	3.5"-4"	3.375"-4.5"
CPC5/6	5"-6"	4.75-6.63"


$5\tfrac{\text{CONDUIT GROUNDING}}{\text{SCALE: N.T.S.}}$

TO TOWER STEEL -TOWER STEEL 2-HOLE CONNECTOR WITH; HARGER UPCXL UNIVERSAL PIPE CLAMPS FOR ROUND MEMBERS HARGER #223T HEAVY DUTY TINNED FLANGE BONDING PLATE-

JUMPER CONNECTION

FROM GROUND BAR

3 GROUND BAR CONNECTION TO TOWER STEEL

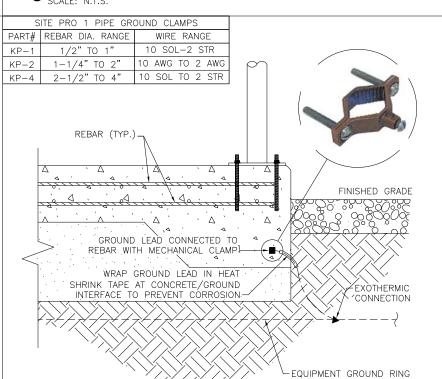

- FOUNDATION SHOWN INS TYPICAL. SEE TOWER FOUNDATION PLANS FOR REINFORCEMENT
- 2. FOUNDATION GROUNDING PER NEC 250.52(3)(A). GROUNDING CONNECTIONS TO BE COVERED BY A MINIMUM OF 3" CONCRETE AND BE MADE TO A MIN. 20' CONTINUOUS

6 EQUIP. PAD FOUNDATION GROUNDING

PREPARED FOR: LIMITED PARTNERSHIP | WIRELESS

80009

SITE NAME:


WHITEWATER

SOUTH SITE NUMBER:

765538

SITE ADDRESS: 797 INDIAN MOUND PARKWAY WHITEWATER, WI 53190 WALWORTH COUNTY

STAMP.

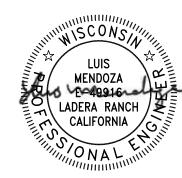




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APP	ROVED BY:	LM		
DATE	DRAWN:	04/30/24		
REVISION				
NO	DESCRIPTION			DATE
Α	ISSUED FO	R REVIEW	DΡ	05/06/24
0	ISSUED FOR C	ONSTRUCTION	DD	05/08/24
SHEET TITLE:				

GROUNDING DETAILS

SHEET NUMBER:

E2.1

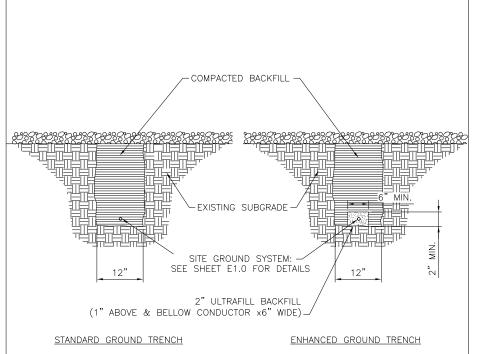


NOTES:

1. GROUNDING TRENCHES TO BE BACK FILLED WITH NATIVE SOIL.


2. COMPACT BACK FILL TO 95% MODIFIED PROCTOR.

CONTACT PSC MINIMUM 24HRS NOTICE PRIOR TO BACK FILLING TO ALLOW FOR

1 GROUND TRENCH SCALE: N.T.S.

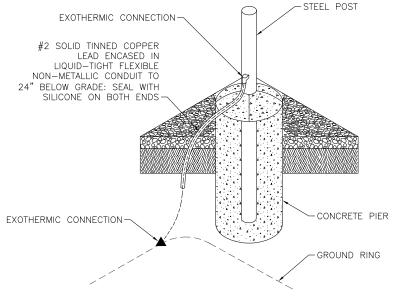

 $2^{\frac{POST\ GROUNDING}{SCALE:\ N.T.S.}}$

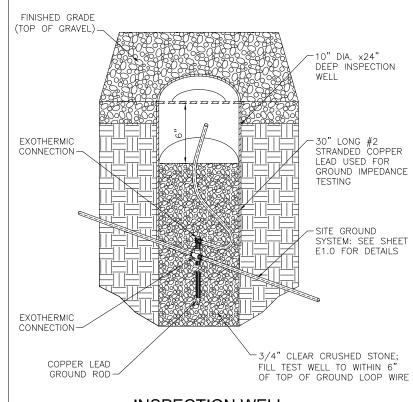

 $3^{\frac{INSPECTION\ WELL}{SCALE:\ N.T.S.}}$

LIMITED PARTNERSHIP WIRELESS

PREPARED FOR:

SITE NAME:

WHITEWATER

SOUTH SITE NUMBER:

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SITE ADDRESS: 797 INDIAN MOUND PARKWAY WHITEWATER, WI 53190 WALWORTH COUNTY

STAMP:






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APPF	ROVED BY:	LM				
DATE	DRAWN:	04/30/24				
		REVISION				
NO	DESCRIPTIO	N	BY	DATE		
Α	ISSUED FO	R REVIEW		05/06/24		
0	ISSUED FOR C	ONSTRUCTION	DD	05/08/24		
SHEET TITLE:						

GROUNDING **DETAILS**

SHEET NUMBER:

E2.2

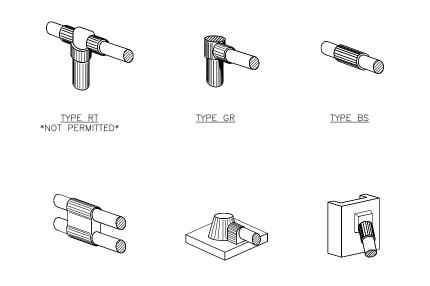

TYPE PT


1. EXOTHERMIC "TYPES" SHOWN ARE EXAMPLES. CONSULT WITH PROJECT MANAGER FOR OTHER POSSIBLE TYPES OF EXOTHERMIC CONNECTIONS THAT CAN BE USED IN STANDARD OR SPECIALLY DESIGNED GROUNDING PLANS.

TYPE HD

TYPE VA

2. CONTRACTOR TO PROVIDE ALL REQUIRED EXOTHERMIC CONNECTIONS.


4 EXOTHERMIC CONNECTIONS SCALE: N.T.S.

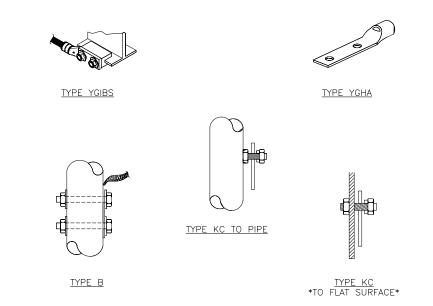


- 1. MECHANICAL "TYPES" SHOWN AREA EXAMPLES. CONSULT WITH PROJECT MANAGER FOR OTHER POSSIBLE TYPES OF MECHANICAL CONNECTIONS THAT CAN BE USED IN STANDARD OR SPECIALLY DESIGNED GROUNDING PLANS.
- 2. CONTRACTOR TO PROVIDE ALL REQUIRED MECHANICAL CONNECTIONS.

5 MECHANICAL CONNECTIONS SCALE: N.T.S.


 $6^{\frac{NOT\ USED}{SCALE:\ N.T.S.}}$

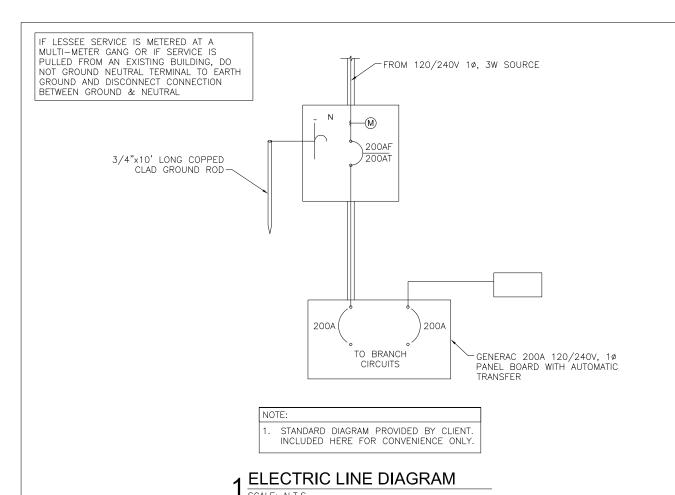

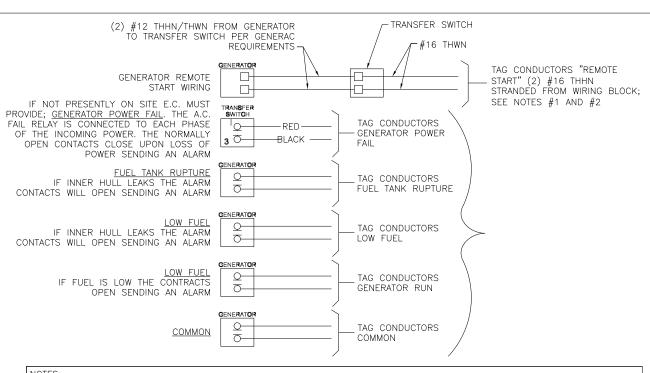

- STANDARD DIAGRAM PROVIDED BY CLIENT, INCLUDED HERE FOR CONVENIENCE ONLY.
- ELECTRICAL CONTRACTOR TO PULL (1)#16 AWG SOLID RED AND (1)#16 AWG SOLID BLACK FROM THE TRANSFER SWITCH TO ALARM WIRING BLOCK FOR REMOTE START.
- 3. ELECTRICAL CONTRACTOR TO PULL ALL ALARM LEADS TO EXISTING ALARM WIRING BLOCK. LEAVE A MINIMUM OF 24" PIGTAILS AT ALARM WIRING BLOCK AND TAG CONDUCTORS AS INDICATED. TERMINATIONS ON ALARM POINT WIRING BLOCK BY OTHER. CONDUCTORS CAN BE RUN EXPOSED. THEY SHALL BE BUNDLED NEATLY USING TIES AND SUPPORTED AT 24" INTERVALS FOR NEAT INSTALLATION.

3 GENERATOR ALARM WIRING SCALE: N.T.S.

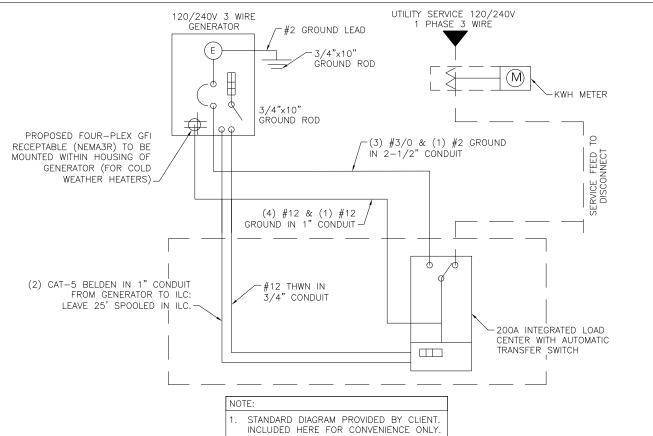

GENERATOR SINGLE LINE DIAGRAM

AC POWER PANEL No. 1 (PROPOSED)											
120/240 V, 1-PH, 3W, 200A											
LOCATION PLATFORM MOUNTING SURFACE ENCLOSURE: NEMA				NEMA 3RA							
	MA	IN BRE	AKER RAT	ING (A):	20	00		S	YSTEM '	VOLTAGE:	240
	AV	AILABL	E FAULT C	URRENT	7.6	kA		SHORT CIF	RCUIT W	S RATING	65 Ka
DESCRIPTION	VA	C/NC	BKR	POS. #	L1	L2	POS. #	BKR	C/NC	VA	DESCRIPTION
RECTIFIER 1	1250		40/2	1	2500		2	40/2		1250	RECTIFIER 5
RECTIFIER 1	1250		40/2	3		2500	4	40/2		1250	RECTIFIER 5
RECTIFIER 2	1250		40/2	5	2500		6	40/2		1250	RECTIFIER 6
RECTIFIER 2	1250		40/2	7		2500	8	40/2		1250	
RECTIFIER 3	1250		40/2	9	2500		10	40/2		1250	RECTIFIER 7
RECTIFIER 5	1250		40/2	11		2500	12	40/2		1250	
RECTIFIER 4	1250		40/2	13	2500		14	40/2		1250	RECTIFIER 8
RECTIFIER 4	1250		40/2	15		2500	16	40/2		1250	RECTIFIER 8
LIGHTS	300		20/1	17	660		18	20/1		360	CHARLES GFCI
GENERATOR BATTERY	1000		20/1	19		1360	20	20/1		360	GENERATOR GFCI
BLANK				21	0		22				BLANK
BLANK				23		0	24				BLANK
		PH	ASE TOTA	LS (VA):	10660	11360					
		CURREN	NT PER PH	ASE (A):	89	95		AMPS/PHASE CANNOT EXCEED MCB RATING			
		P	ANEL TOTA	AL (VA):	220	020		LEGEND: C=	CONTIN	IUOUS, NC	= NON CONTINUOUS

SURFACE MOUNTED NEMA 3R W/ DOOR

22K AIC BREAKERS

(CONTRACTOR SHALL VERIFY AIC RATINGS WITH LOCAL POWER CO.)

4 PANEL SCHEDULE SCALE: N.T.S.

PREPARED FOR:	
verizon	CHICAGO SMSA LIMITED PARTNERSHIP D/B/A VERIZON WIRELESS 1701 GOLF ROAD TOWER 2, SUITE 400 ROLLING MEADOWS, IL 60008

SITE NAME:

WHITEWATER

SOUTH SITE NUMBER:

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SITE ADDRESS: 797 INDIAN MOUND PARKWAY WHITEWATER, WI 53190 WALWORTH COUNTY

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0	ISSUED FOR CONSTRUCTION			05/08/24
SHEE				

ELECTRICAL DETAILS

SHEET NUMBER:

E2.3