**TILLMAN OPP NUMBER: TI-OPP-23028** SITE NAME: STRITZEL RENTAL **SITE ADDRESS: 312 ELKHORN ROAD** WHITEWATER, WI 53190

> PID: A91900003 FA#: 15887152

### SCAN FOR DRIVING DIRECTIONS



### SITE INFORMATION

312 ELKHORN ROAD WHITEWATER, WI 53190 SITE ADDRESS:

LONGITUDE (NAD 83): -88°42'39.2480" (-88.71090223)

GROUND ELEVATION: 829.94' (AMSL) JURISDICTION: CITY OF WHITEWATER

JURISDICTION CONTACT: CHRIS BENNETT

EMAIL: CBENNETT@WHITEWATER-WI.GOV

PARCEL/MAP NUMBER:

PARCEL OWNER: STRITZEL RENTAL PROPERTIES LLC

TILLMAN INFRASTRUCTURE

A91900003

NEW YORK NEW YORK 10019

STRUCTURE TYPE: SELF SUPPORT TOWER STRUCTURE HEIGHT 195'-0" (AGL)

POWER SUPPLIER: WE ENERGIES

800-242-9137

FIBER SUPPLIER

TOWER OWNER:

### PROJECT TEAM

APPLICANT: TILLMAN INFRASTRUCTURE

NEW YORK NEW YORK 10019

PROJECT MANAGEMENT FIRM: LCC TELECOM SERVICES


10700 HIGGINS ROAD, SUITE 240

ROSEMONT, IL 60018


ARCHITECT ENGINEERING:

604 FOX GLEN BARRINGTON, IL 60010 CONTACT: JOHN M. BANKS PHONE: (847) 277-0070 EMAIL: JBANKS@WESTCHESTERSERVICES.COM

**VICINITY MAP** 

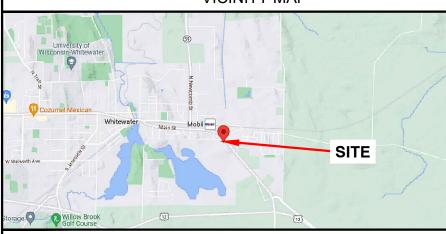

### **LOCATION MAP**

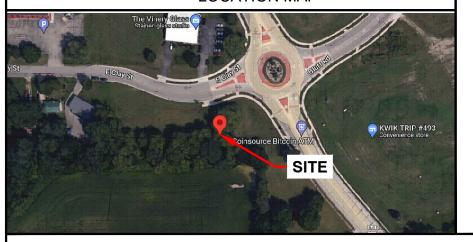

### **CODE COMPLIANCE**

ALL WORK AND MATERIALS SHALL BE PERFORMED AND INSTALLED IN ACCORDANCE WITH THE CURRENT EDITIONS OF THE FOLLOWING CODES AS ADOPTED BY THE LOCAL GOVERNING AUTHORITIES. NOTHING IN THESE PLANS IS TO BE CONSTRUED TO PERMIT WORK NOT CONFORMING TO THE LATEST EDITIONS OF THE FOLLOWING CODES.

- 2023 WISCONSIN STATE BUILDING CODE 2023 WISCONSIN STATE ELECTRICAL CODE
- 2023 WISCONSIN STATE MECHANICAL CODE 2023 WISCONSIN UNIFORM PLUMBING CODE
- 2023 WISCONSIN STATE FIRE CODE
- AMERICAN CONCRETE INSTITUTE
- AMERICAN INSTITUTE OF STEEL CONSTRUCTION
- MANUAL OF STEEL CONSTRUCTION 13TH EDITION

- INSTITUTE FOR ELECTRICAL & ELECTRONICS
- ENGINEERING 81
- IEEE C2 NATIONAL ELECTRIC SAFETY CODE
- LATEST EDITION
- TELECORDIA GR-1275

### DRAWING INDEX

- TITLE SHEET
- SITE SURVEY
- OVERALL SITE PLAN C-1
- ENLARGED SITE PLAN
- ELEVATION C-3
- CONSTRUCTION DETAILS
- FENCE DETAILS C-5
- FENCE DETAILS
- C-6 SITE SIGNAGE
- C-7 GRADING PLAN
- **EROSION CONTROL DETAILS** C-8
- I ANDSCAPE PLAN C-9
- ENLARGED UTILITY PLAN E-2
- ELECTRICAL DIAGRAM
- GROUNDING PLAN & DETAILS
- GROUNDING PLAN AND RISER DIAGRAM

### DRAWING SCALE

THESE DRAWINGS ARE SCALED TO FULL SIZE AT 22"X34" AND HALF SIZE AT 11"X17 CONTRACTOR SHALL VERIFY ALL PLANS AND EXISTING DIMENSIONS AND CONDITIONS ON THE JOB SITE AND SHALL IMMEDIATELY NOTIFY THE DESIGNER / ENGINEER IN WRITING OF ANY DISCREPANCIES REFORE PROCEEDING WITH THE WORK OR MATERIAL ORDERS. OR BE RESPONSIBLE FOR THE SAME. CONTRACTOR SHALL USE BEST MANAGEMENT PRACTICE TO PREVENT STORM WATER POLLUTION DURING CONSTRUCTION.

### SCOPE OF WORK

- CONSTRUCTION OF A NEW UNMANNED TELECOMMUNICATIONS FACILITY
- SITE WORK: NEW TOWER, UNMANNED EQUIPMENT CABINET ON PLATFORM, AND UTILITY



TO OBTAIN LOCATION OF PARTICIPANTS UNDERGROUND FACILITIES BEFORE YOU DIG IN WISCONSIN, CALL LOCAL STATE ONE CALL

TOLL FREE: 1-800-242-8511 OR www.diggershotline.com

WISCONSIN STATUTE REQUIRES MIN OF 2 WORKING DAYS NOTICE Call before you dig. BEFORE YOU EXCAVATE





### JOHN M. BANKS **ARCHITECT**

604 FOX GLEN
BARRINGTON, IL 60010
TELEPHONE: 847-277-0070
FAX: 847-277-0080
NL: JBANKS@WESTCHESTERSERVICES.COM



**DWM** 

MC

604 FOX GLEN BARRINGTON, IL 60010
PHONE: 847-277-0070
EMAIL: AE©Westchesterservices.com

CHECKED BY:

1	REV	DATE	DESCRIPTION
	A	08/29/23	PRELIMINARY CD
L			

I HEREBY CERTIFY THAT THESE PLANS WERE PREPARED BY ME OR UNDER MY DIRECT SUPERMISION AND THAT I AM A DULY REGISTERED ARCHITECT UNDER THE LAWS OF THE STATE OF WISCONS

TILLMAN OPP# TI-OPP-23028 FA# : 15887152 SITE NAME: STRITZEL RENTAL SITE ADDRESS: 312 ELKHORN ROAD WHITEWATER, WI 53190

SHEET TITLE

TITLE SHEET

SHEET NUMBER



### VICINITY MAP NOT TO SCALE

#### **★ FAA COORDINATE POINT**

NAD 83

LATITUDE: 42\*49'50.10234" (42.83056204) LONGITUDE: -88\*42'39.2480" (-88.71090223)

ELEVATIONS: 829.94'± AMSL

#### **◆TEMPORARY BENCHMARK**

LATITUDE: 42'49'50.7028" (42.83075077)
LONGITUDE: -88'42'39.6899" (-88.71102498)
ELEVATION: 832.784'

LOCATION: 632.784

LOCATION: CUT 'X' IN SIDEWALK

### GLOBAL POSITIONING SYSTEMS NOTE

- 1. RANDOM TRAVERSE CONTROL MONUMENTS WERE SET USING GPS METHODS. A PORTION OF THE TOPOGRAPHY AND FOUND BOUNDARY MONUMENTS WERE ALSO LOCATED USING GPS METHODS.
- 2. THE TYPE OF GPS UTILIZES AS NETWORK ADJUSTED REAL TIME KINEMATIC (TOPCON VRS NETWORK), NAD 83 WISCONSIN STATE PLANE (SOUTH).
- 3. TOPCON HIPER SR RECEIVERS WERE USED TO PERFORM THE SURVEY.

### **GENERAL NOTES**


NO SEARCH OF PUBLIC RECORDS HAS BEEN COMPLETED BY XCEL CONSULTANTS TO DETERMINE ANY DEFECTS AND/OR AMBIGUITIES IN THE TITLE OF THE PARENT PARCEL.

THIS SURVEY IS FOR THE PROPOSED LEASE AREA AND THE PROPOSED EASEMENTS ONLY, AND ONLY A PARTIAL BOUNDARY SURVEY OF THE PARENT PARCEL HAS BEEN PERFORMED.

THIS PLAT IS NOT INTENDED FOR LAND TRANSFER.

THIS PROPERTY IS SUBJECT TO ANY RECORDED EASEMENTS AND/OR RIGHTS OF WAY SHOWN HEREON OR NOT.

THIS SURVEY WAS COMPLETED WITH THE AID OF TITLE WORK PREPARED BY WESTCOR LAND TITLE INSURANCE COMPANY, COMMITMENT DATE OF MARCH 10, 2023, BEING COMMITMENT NO. TIL-149417-C, FOR THE SUBJECT PROPERTY, TO DETERMINE THE IMPACTS OF EXISTING TITLE EXCEPTIONS.

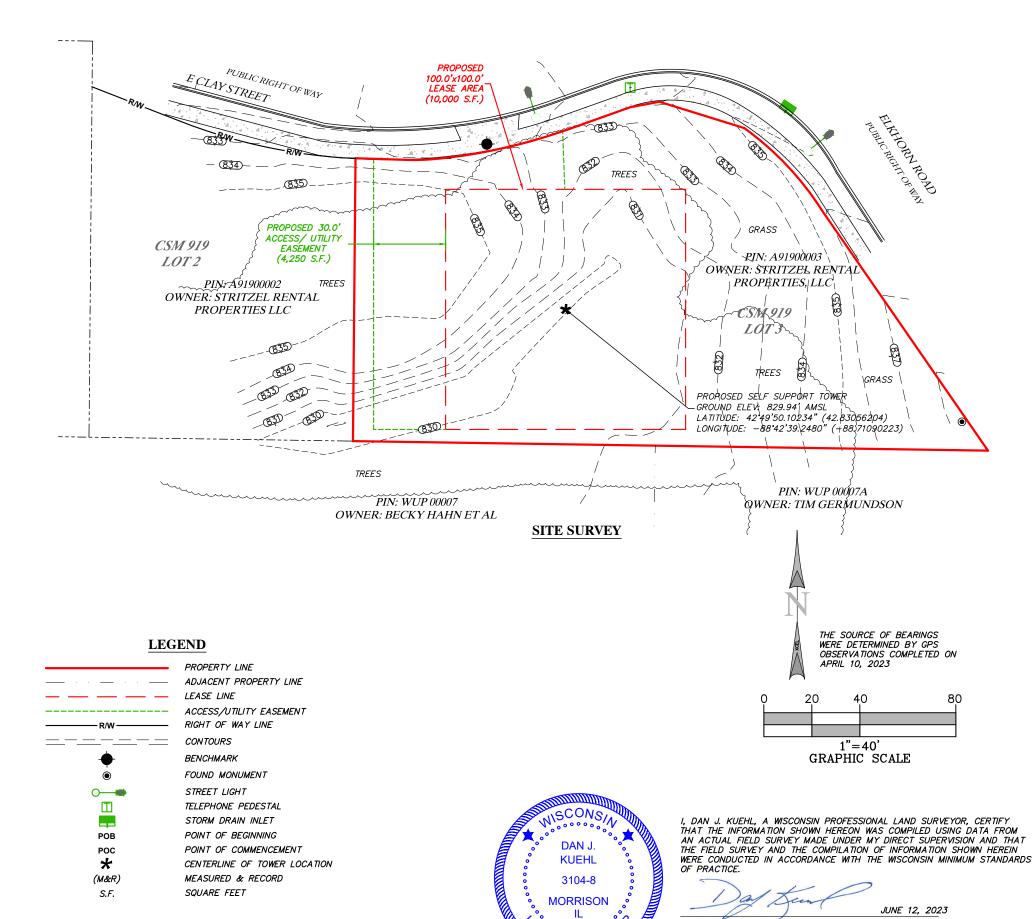

DAN J. KUEHL

LICENSE NUMBER 3104-8

MY LICENSE RENEWAL DATE IS JANUARY 31, 2024 SHEETS COVERED BY THIS SEAL B-1, B-1.1, AND B-1.2

SURVE



PREPARED FOR:

SURVEYED BY:



Consultants
8300 42ND STREET WEST
ROCK ISLAND, IL 61201
(0) 309-787-9988
(f) 309-756-5540
(g) XCEL®XCELCONSULTANTSINC.COI

XCEL PROJECT NUMBER: 234614

#### SITE SURVEY

REV.	DATE	DESCRIPTION
Α	6/12/23	FINAL ISSUE WITH TITLE

### SITE INFORMATION: STRITZEL RENTAL

312 ELKHORN ROAD WHITEWATER, WI 53190 WALWORTH COUNTY

TAX PARCEL NUMBER: A91900003

PROPERTY OWNER: STRITZEL RENTAL PROPERTIES LLC 530 S JANESVILLE AVE WHITEWATER. WI 53190

> SITE NUMBER: TI-OPP-23028

DRAWN BY: KJM
CHECKED BY: BCH
SURVEY DATE: 4/10/2023
PLAT DATE: 6/12/2023

SHEET TITLE:

### SITE SURVEY


THIS DOES NOT REPRESENT A BOUNDARY SURVEY OF THE PARENT PARCEL

SHEET NUMBER:

B-1




THE SOURCE OF BEARINGS WERE DETERMINED BY GPS OBSERVATIONS COMPLETED ON APRIL 10, 2023

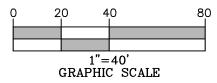


AERIAL PER MICROSOFT BING MAPS ON APRIL 12, 2013

### **LEGEND**

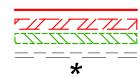

PROPERTY LINE LEASE AREA ACCESS/UTILITY EASEMENT CONTOURS CENTERLINE OF TOWER LOCATION

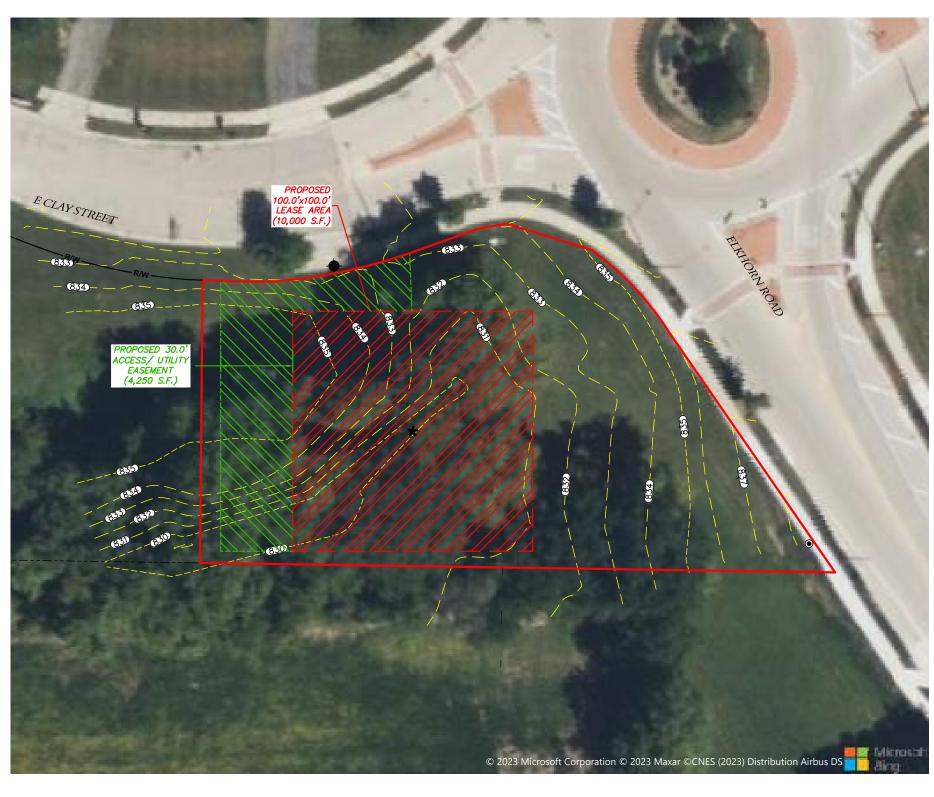



I, DAN J. KUEHL, A WISCONSIN PROFESSIONAL LAND SURVEYOR, CERTIFY THAT THE INFORMATION SHOWN HEREON WAS COMPILED USING DATA FROM AN ACTUAL FIELD SURVEY MADE UNDER MY DIRECT SUPERVISION AND THAT THE FIELD SURVEY AND THE COMPILATION OF INFORMATION SHOWN HEREIN WERE CONDUCTED IN ACCORDANCE WITH THE WISCONSIN MINIMUM STANDARDS OF PRACTICE.

JUNE 12, 2023

DAN J. KUEHL LICENSE NUMBER 3104-8

MY LICENSE RENEWAL DATE IS JANUARY 31, 2024
SHEETS COVERED BY THIS SEAL B-1, B-1.1, AND B-1.2

**AERIAL SURVEY** 



BARRINGTON, IL 60010 TELEPHONE: 847.277.0070 FAX: 847.277.0080 ae@westchesterservices.com

PREPARED FOR:

SURVEYED BY:



XCEL Consultants ROO 42ND STREET WEST
ROCK ISLAND, IL 61201
(0) 309-787-9988
(F) 309-756-5540
(E) XCEL®XCELCONSULTANTSINC.COM

XCEL PROJECT NUMBER: 234614

### **SITE SURVEY**

REV.	DATE	DESCRIPTION			
Α	6/12/23	FINAL ISSUE WITH TITLE			

### SITE INFORMATION:

### STRITZEL RENTAL

312 ELKHORN ROAD WHITEWATER, WI 53190 WALWORTH COUNTY

TAX PARCEL NUMBER: A91900003

PROPERTY OWNER: STRITZEL RENTAL PROPERTIES LLC 530 S JANESVILLE AVE WHITEWATER, WI 53190

SITE NUMBER: TI-OPP-23028

DRAWN BY: KJM CHECKED BY: SURVEY DATE: 4/10/2023 PLAT DATE: 6/12/2023

SHEET TITLE:

### SITE SURVEY

THIS DOES NOT REPRESENT A **BOUNDARY SURVEY OF THE** PARENT PARCEL

SHEET NUMBER:

B-1.1

#### **REPORT OF TITLE:**

THIS SURVEY DOES NOT CONSTITUTE A TITLE SEARCH BY XCEL CONSULTANTS, INC. AND AS SUCH WE ARE NOT RESPONSIBLE FOR THE INVESTIGATION OR INDEPENDENT SEARCH FOR EASEMENT OF RECORD FNCUMBRANCES RESTRICTIVE COVENANTS OWNERSHIP TITLE EVIDENCE. UNRECORDED EASEMENT, AUGMENTING EASEMENT, IMPLIES OR PRESCRIPTIVE EASEMENTS, OR ANY OTHER FACTS THAT AN ACCURATE AND CURRENT TITLE SEARCH MAY DISCLOSE.

THIS SURVEY WAS COMPLETED WITH THE AID OF TITLE WORK PREPARED BY WESTCOR LAND TITLE INSURANCE COMPANY, COMMITMENT DATE OF MARCH 10, 2023, BEING COMMITMENT NO. TIL-149417-C, FOR THE SUBJECT PROPERTY, TO DETERMINE THE IMPACTS OF EXISTING TITLE

SURVEY MATTERS OR EASEMENTS LISTED IN SCHEDULE 'B':

- 11. ANY AND ALL MATTERS DISCLOSED ON THE MAP ENTITLED "SURVEY MAP" DATED FEBRUARY 28, 1979 AND RECORDED APRIL 9, 1979 IN (BOOK) 4 (PAGE) 152, (INSTRUMENT) 46392 IN WALWORTH COUNTY, WISCONSIN. REFERS TO PARENT TRACT - NOTHING TO
- 12. ANY AND ALL MATTERS DISCLOSED ON THE MAP ENTITLED "PLAT" DATED JANUARY 6, 2016 AND RECORDED JANUARY 7, 2016 IN (BOOK) D (PAGE) 191, (INSTRUMENT) 918305 IN WALWORTH COUNTY, WISCONSIN. REFERS TO PARENT TRACT - NOTHING TO

### PARENT PARCEL, LEGAL DESCRIPTION (NOT FIELD SURVEYED) PER TITLE

THE FOLLOWING DESCRIBED REAL ESTATE, TOGETHER WITH THE RENTS, PROFITS, FIXTURES AND OTHER APPURTENANT INTERESTS, IN WALWORTH COUNTY, STATE OF WISCONSIN:

LOT 3. CERTIFIED SURVEY NO. 919. RECORDED IN VOL. 4 CS. PAGE 152. WALWORTH COUNTY REGISTER OF DEEDS, BEING PART OF THE SE 1/4 SW 1/4 OF SECTION 3, TAN, R15E, CITY OF WHITEWATER, WISCONSIN. EXCEPT PARCEL CONVEYED FOR STREET PURPOSES AS CONTAINED IN DEED RECORDED AS DOCUMENT NO. 710998. FURTHER EXCEPTING A PARCEL CONVEYED TO THE STATE OF WISCONSIN FOR HICHWAY PURPOSES AS CONTAINED IN PARCEL 22 IN TPP 3110-02-21-4.03.

PARCEL ID: /A 91900003

THIS BEING THE SAME PROPERTY CONVEYED TO STRITZEL RENTAL PROPERTIES, LLC, AN UNDIVIDED 1/4 INTEREST IN A DEED FROM TERRENCE L. STRITZEL, DATED 12/30/2016 AND RECORDED 1/3/2017 AS INSTRUMENT NO. 939063.

FURTHER BEING DESCRIBED IN:

THIS BEING THE SAME PROPERTY CONVEYED TO STRITZEL RENTAL PROPERTIES, LLC, AN UNDIVIDED 1/4 INTEREST IN A DEED FROM DANIEL J. STRITZEL, DATED 12/30/2016 AND RECORDED 1/3/2017 AS INSTRUMENT NO.939062.

FURTHER BEING DESCRIBED IN:


THIS BEING THE SAME PROPERTY CONVEYED TO STRITZEL RENTAL PROPERTIES, LLC, AN UNDIVIDED 1/4 INTEREST IN A DEED FROM STEVEN J. STRITZEL, DATED 12/30/2016 AND RECORDED 1/3/2017 AS INSTRUMENT NO.939061.


FURTHER BEING DESCRIBED IN:

THIS BEING THE SAME PROPERTY CONVEYED TO STRITZEL RENTAL PROPERTIES, LLC, AN UNDIVIDED 1/4 INTEREST IN A DEED FROM JANICE R STRITZEL, DATED 12/30/2016 AND RECORDED 1/3/2017 AS INSTRUMENT NO.939060.

#### PROPOSED LEASE AREA:

A PART OF LOT 3. CERTIFIED SURVEY NO. 919, RECORDED IN VOL. 4 CS. PAGE 152, WALWORTH COUNTY REGISTER OF DEEDS, CITY OF WHITEWATER, WALWORTH COUNTY, WISCONSIN, MORE PARTICULARLY DESCRIBED AS: COMMENCING AT THE SW CORNER OF SAID LOT 3; THENCE NOO'30'32"E, ALONG THE WEST LINE OF SAID LOT 3, 117.86 FEET TO THE SOUTH LINE OF E. CLAY STREET; THENCE S88'07'22"E, ALONG THE SAID SOUTH LINE OF E. CLAY STREET, 7.55 FEET; THENCE S00'00'00"W, 112.74 FEET; THENCE N90°00'00"E, 30.00 FEET TO THE POINT OF BEGINNING FOR THE LEASE AREA HEREIN INTENDED TO BE DESCRIBED; THENCE NOO'00'00"E, 100.00 FEET; THENCE N90°00'00"E, 100.00 FEET; THENCE S00°00'00"W, 100.00 FEET; THENCE S90°00'00"W, 100.00 FEET TO THE POINT OF BEGINNING, CONTAINING 10.000 SQUARE FEET.

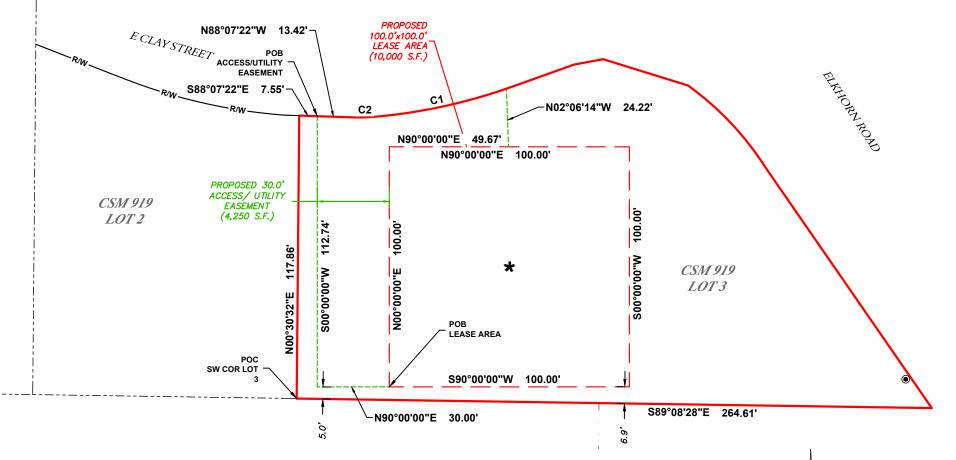

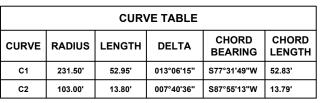

OBSERVATIONS COMPLETED ON APRIL 10, 2023 80 1"=40'GRAPHIC SCALE

THE SOURCE OF BEARINGS

WERE DETERMINED BY GPS

### PROPOSED ACCESS/UTILITY EASEMENT:

A PART OF LOT 3, CERTIFIED SURVEY NO. 919, RECORDED IN VOL. 4 CS, PAGE 152, WALWORTH COUNTY REGISTER OF DEEDS, CITY OF WHITEWATER, WALWORTH COUNTY, WISCONSIN, MORE PARTICULARLY DESCRIBED AS: COMMENCING AT THE SW CORNER OF SAID LOT 3; THENCE NOO'30'32"E, ALONG THE WEST LINE OF SAID LOT 3, 117.86 FEET TO THE SOUTH LINE OF E. CLAY STREET; THENCE S88'07'22"E, ALONG THE SAID SOUTH LINE OF E. CLAY STREET, 7.55 FEET TO THE POINT OF BEGINNING FOR THE EASEMENT AREA HEREIN INTENDED TO BE DESCRIBED; THENCE S00'00'00"W, 112.74 FEET; THENCE N90°00'00"E. 30.00 FEET: THENCE N00°00'00"E. 100.00 FEET: THENCE N90°00'00"E. 49.67 FEET: THENCE NO2'06'14"W. 24.22 FEET TO THE SAID SOUTH LINE OF E. CLAY STREET: THENCE SOUTHWESTERLY, ALONG THE SAID SOUTH LINE OF E. CLAY STREET, BEING THE ARC OF A CURVE CONCAVE NORTHERLY, HAVING A RADIUS OF 231.50 FEET, AN ARC LENGTH OF 52.95 FEET, CHORD OF SAID ARC BEARS S77'31'49"W, 52.83 FEET; THENCE WESTERLY, ALONG THE SAID SOUTH LINE OF E. CLAY STREET, BEING THE ARC OF A CURVE CONCAVE NORTHERLY, HAVING A RADIUS OF 103.00 FEET, AN ARC LENGTH OF 13.80 FEET, CHORD OF SAID ARC BEARS S87°55'13"W, 13.79 FEET; THENCE N88°07'22"W, ALONG THE SAID SOUTH LINE OF E. CLAY STREET, 13.42 FEET TO THE POINT OF BEGINNING, CONTAINING 4,250 SQUARE FEET.



I, DAN J. KUEHL, A WISCONSIN PROFESSIONAL LAND SURVEYOR, CERTIFY THAT THE INFORMATION SHOWN HEREON WAS COMPILED USING DATA FROM AN ACTUAL FIELD SURVEY MADE UNDER MY DIRECT SUPERVISION AND THAT THE FIELD SURVEY AND THE COMPILATION OF INFORMATION SHOWN HEREIN WERE CONDUCTED IN ACCORDANCE WITH THE WISCONSIN MINIMUM STANDARDS

JUNE 12, 2023

DAN J. KUEHL LICENSE NUMBER 3104-8 MY LICENSE RENEWAL DATE IS JANUARY 31, 2024 SHEETS COVERED BY THIS SEAL B-1, B-1.1, AND B-1.2



PREPARED FOR:



SURVEYED BY CEI Consultants 8300 42ND STREET WEST ROCK ISLAND, IL 61201 (O) 309-787-9988 (F) 309-756-5540 XCFI @XCFI CONSULTANTSING COM

XCEL PROJECT NUMBER: 234614

#### SITE SURVEY

REV.	DATE	DESCRIPTION
Α	6/12/23	FINAL ISSUE WITH TITLE

### SITE INFORMATION: STRITZEL RENTAL

312 ELKHORN ROAD WHITEWATER, WI 53190

WALWORTH COUNTY TAX PARCEL NUMBER: A91900003

PROPERTY OWNER: STRITZEL RENTAL PROPERTIES LLC 530 S JANESVILLE AVE WHITEWATER, WI 53190

> SITE NUMBER: TI-OPP-23028

DRAWN BY: KJM CHECKED BY: SURVEY DATE: 4/10/2023 PLAT DATE: 6/12/2023


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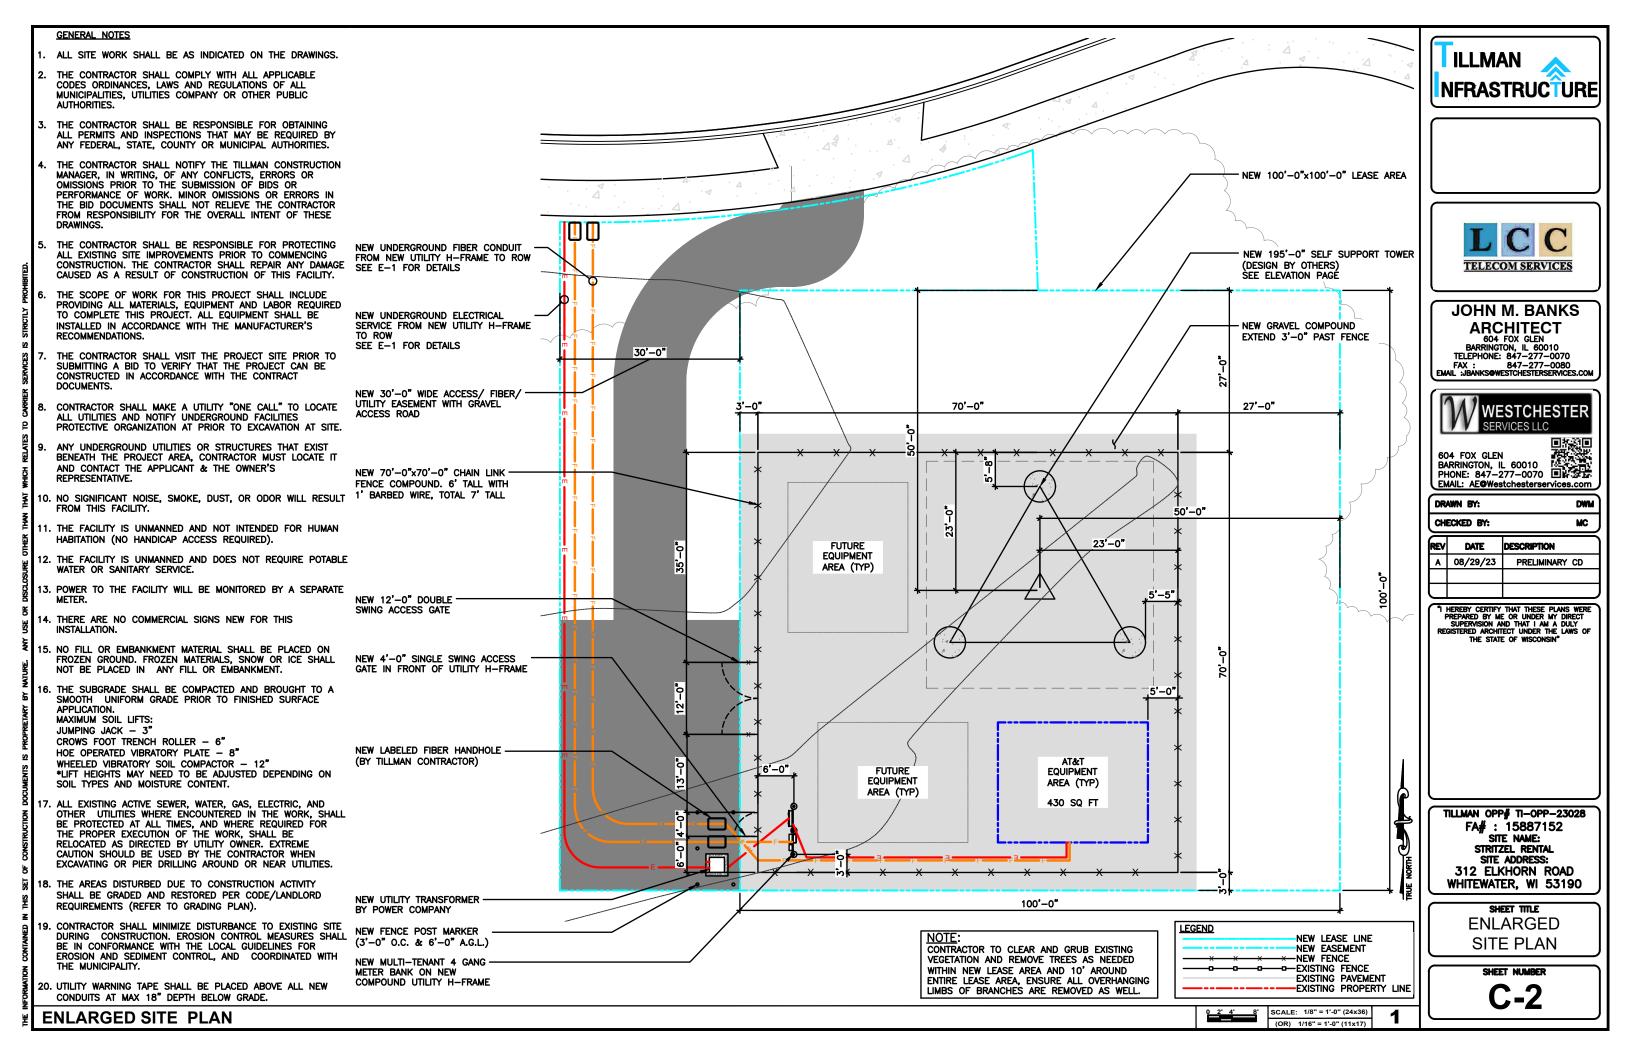
### SITE SURVEY


THIS DOES NOT REPRESENT A **BOUNDARY SURVEY OF THE** PARENT PARCEL


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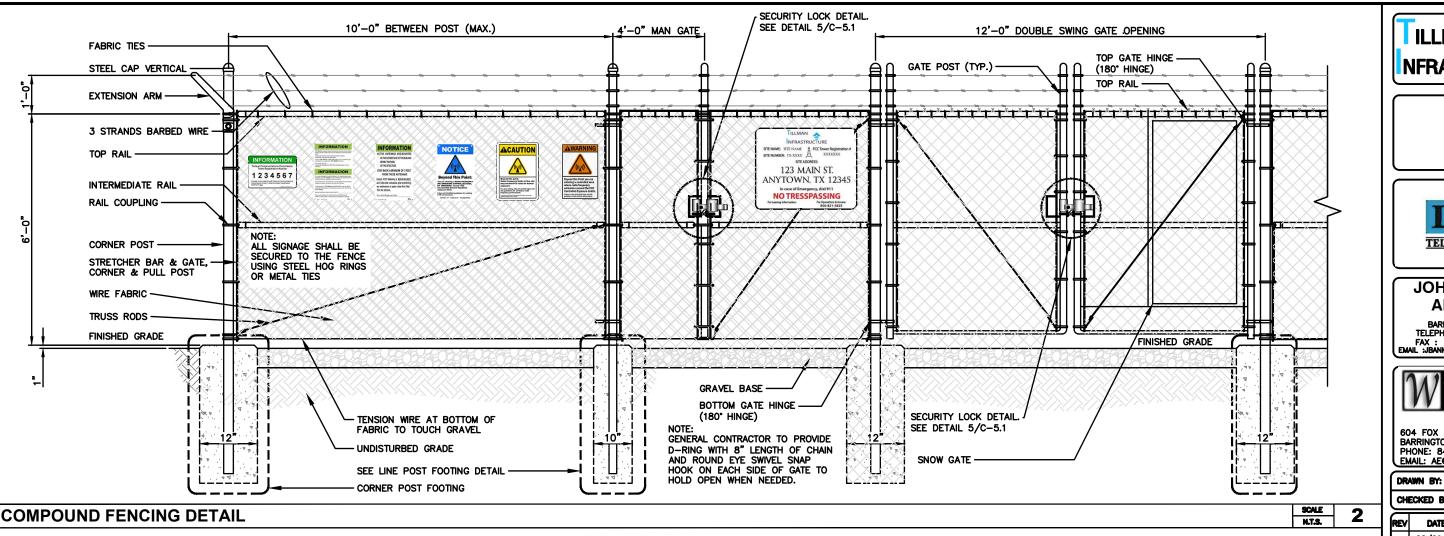
B-1.2





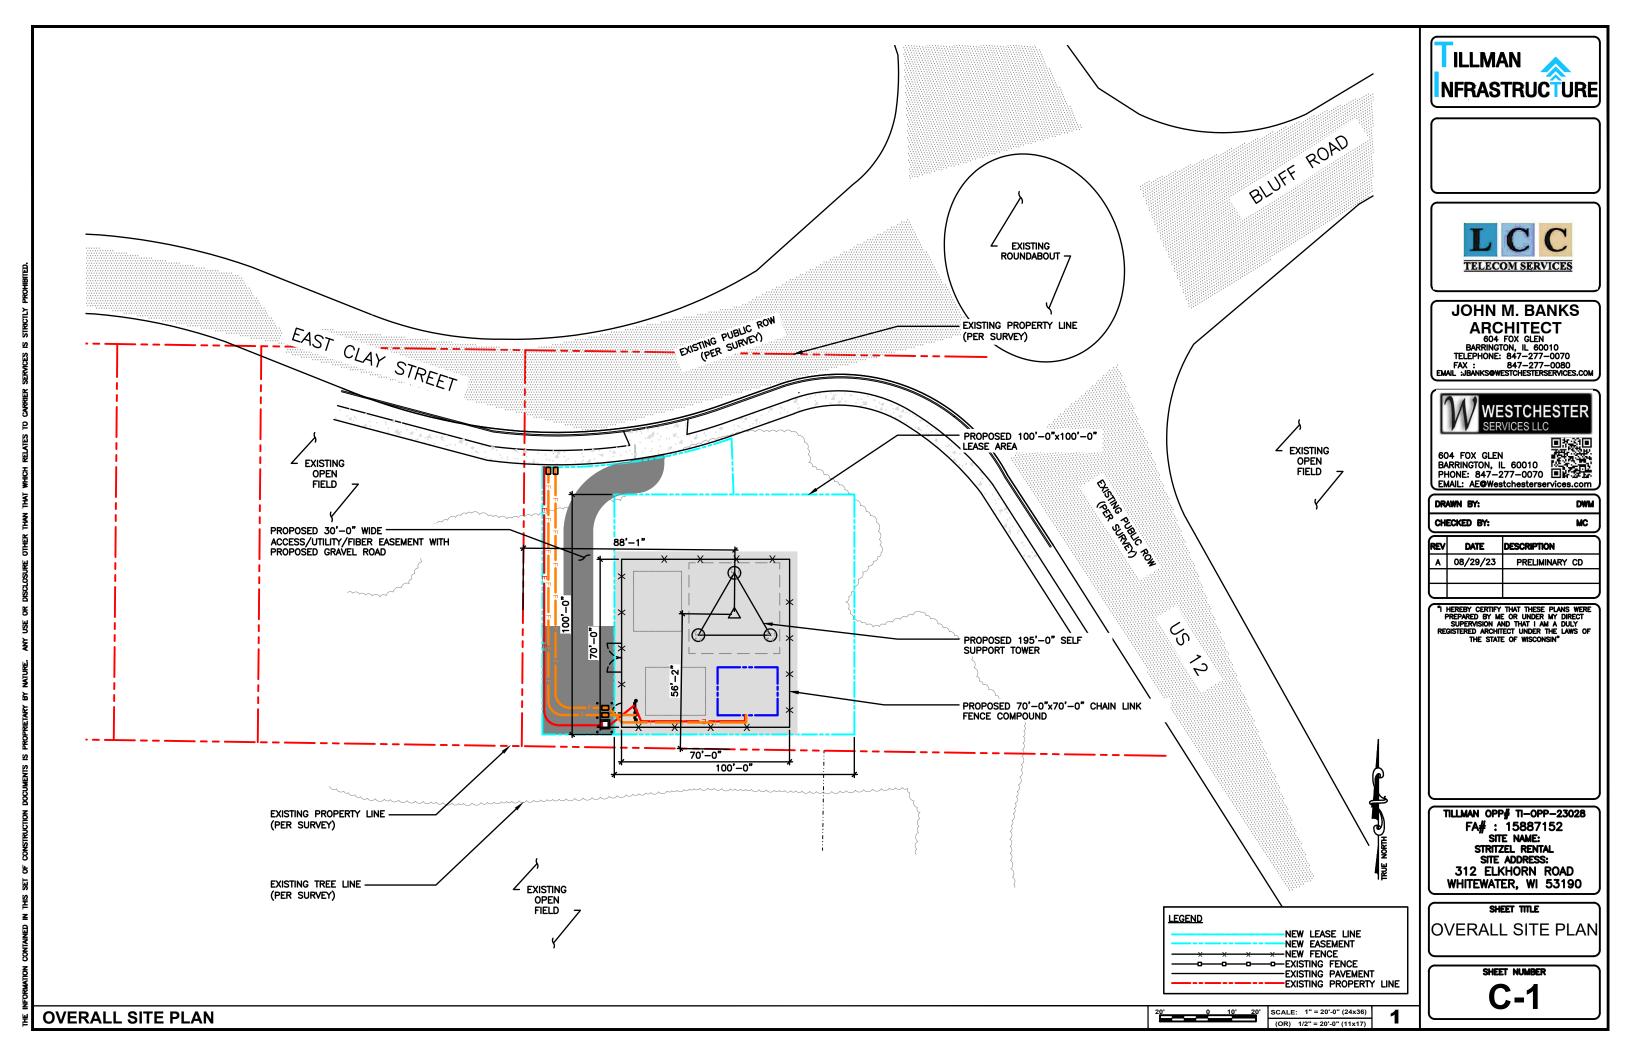

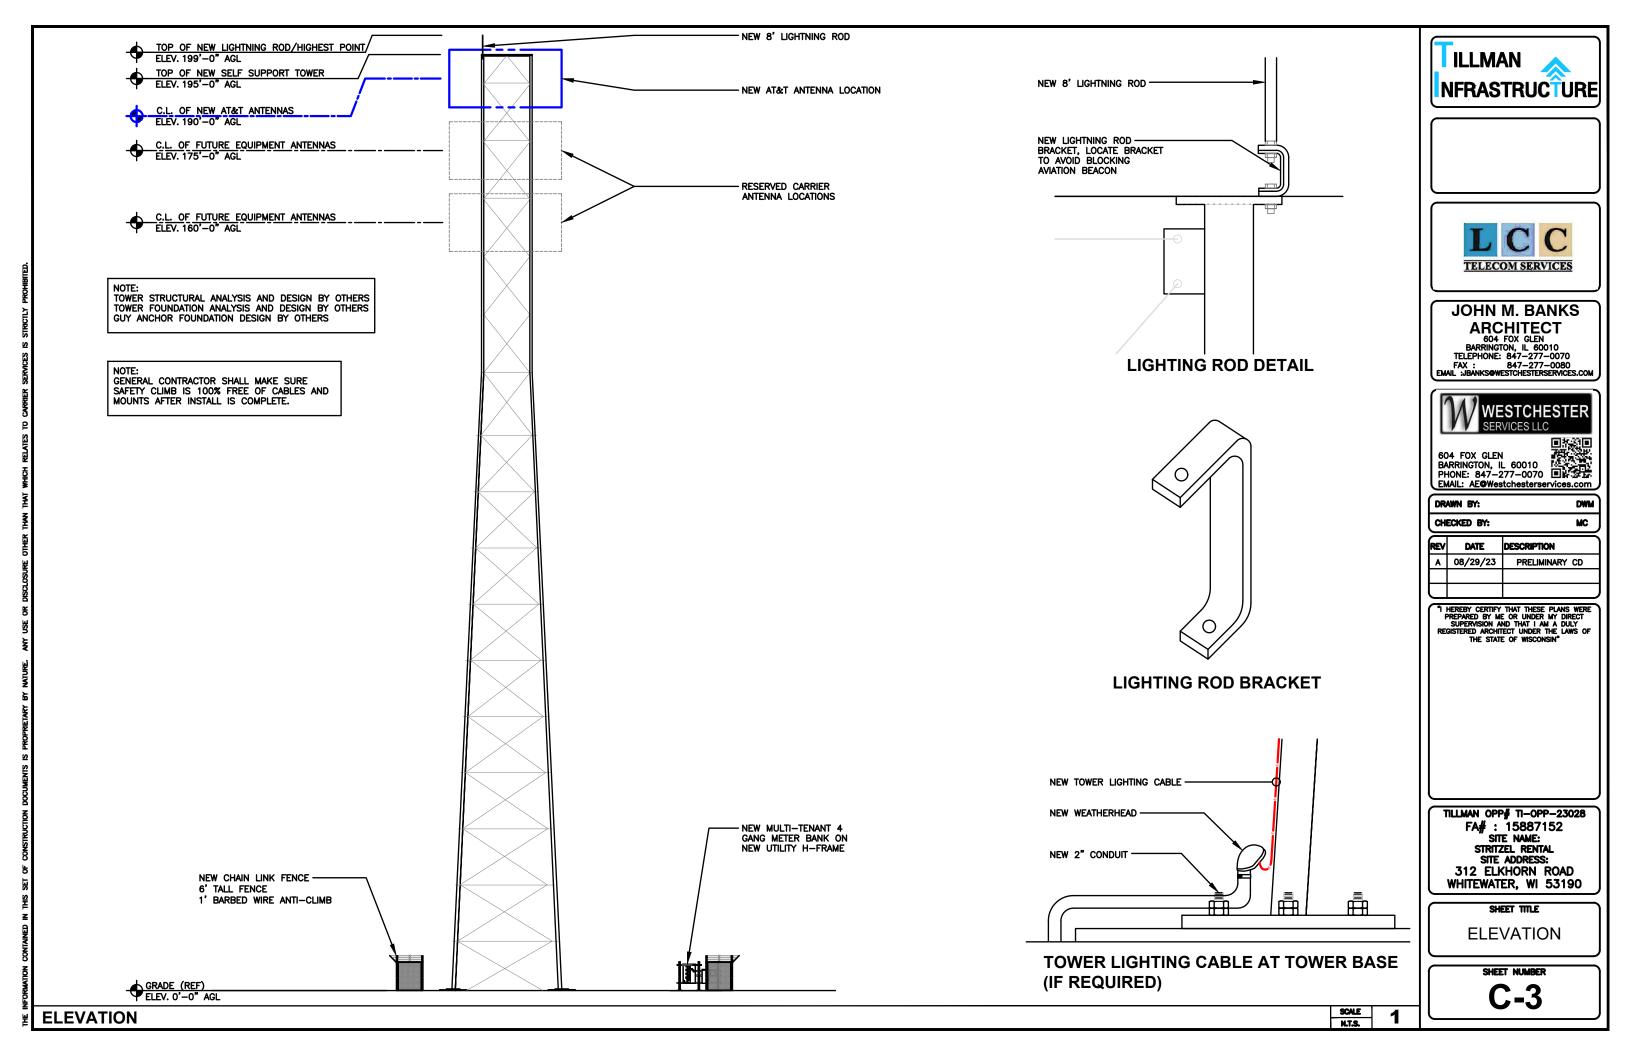

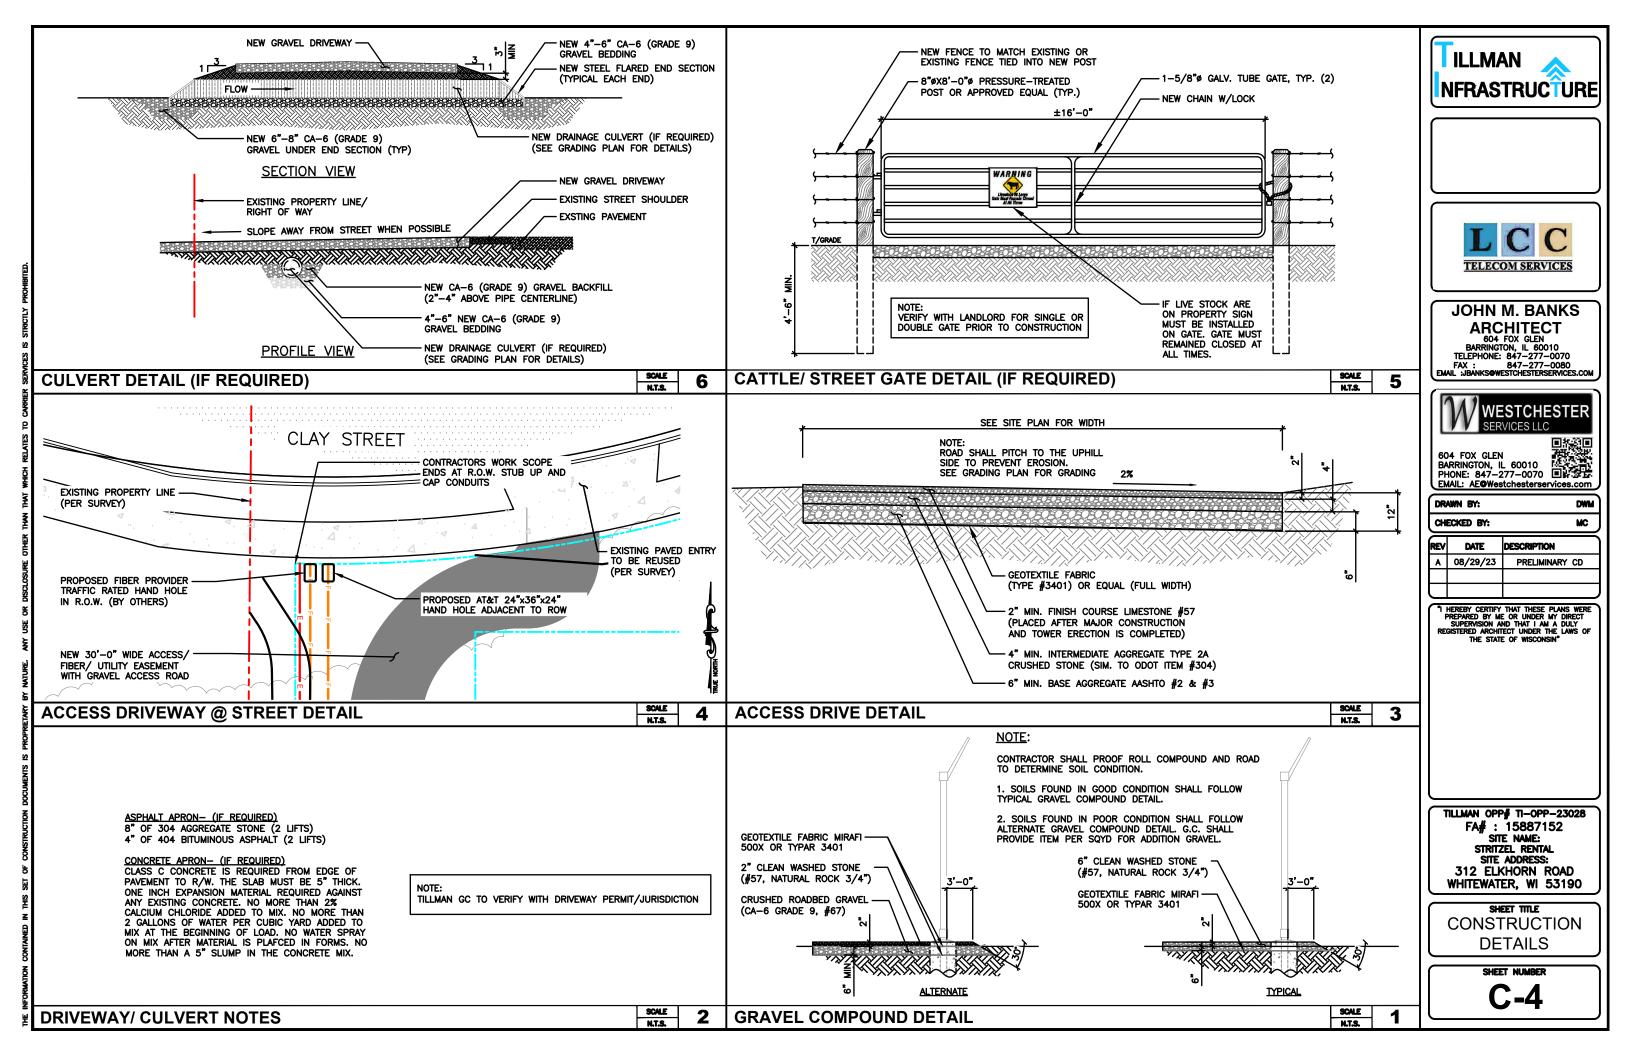





ARCHITECT
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BARRINGTON, IL 60010
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EMAIL :JBANKS@WESTCHESTERSERVICES.COM



DWM

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BARRINGTON, IL 60010
PHONE: 847-277-0070
EMAIL: AE©Westchesterservices.com

CHECKED BY: MC REV DATE DESCRIPTION A 08/29/23 PRELIMINARY CD

"I HEREBY CERTIFY THAT THESE PLANS WERE PREPARED BY ME OR UNDER MY DIRECT SUPERVISION AND THAT I AM A DULY REGISTERED ARCHITECT UNDER THE LAWS OF THE STATE OF WISCONSIN"

TILLMAN OPP# TI-OPP-23028 FA# : 15887152 SITE NAME: STRITZEL RENTAL SITE ADDRESS: 312 ELKHORN ROAD WHITEWATER, WI 53190

> SHEET TITLE **FENCE DETAILS**

SHEET NUMBER

SCALE

**NOT USED** 


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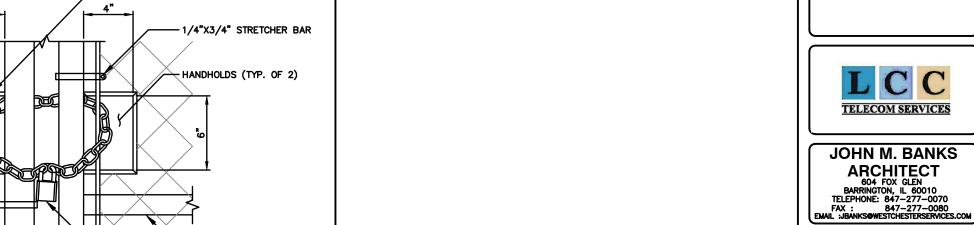
### WOVEN WIRE FENCE NOTES:

(INSTALL FENCING PER ASTM F-567) (SWING GATES PER ASTM F-900)

- GATE POSTS, CORNER, TERMINAL OR PULL POSTS SHALL BE 2 7/8" DIA. SCHEDULE 40 FOR GATE WIDTHS UP THROUGH 6 FEET OR 12 FEET FOR DOUBLE SWING GATE PER ASTM-F1083.
- 2. LINE POSTS: 2 3/8" DIA. SCHEDULE 40 PIPE PER ASTM-F1083
- 3. GATE FRAME: 1 1/2" DIA. SCHEDULE 40 PIPE PER ASTM-F1083
- 4. TOP RAIL AND BRACE RAIL: 1 1/4" SCHEDULE 40 PIPE PER ASTM-F1083
- 5. FABRIC: 9 GA. CORE WIRE SIZE 2" MESH, CONFORMING TO ASTM-A392 CLASS 1
- TIE WIRE: MINIMUM 11 GA. GALVANIZED STEEL. INSTALL A SINGLE WRAP TIE WIRE AT POSTS AND RAILS AT MAX. 24" INTERVALS. INSTALL HOG RINGS ON TENSION WIRE AT 24" **INTERVALS**
- 7. TENSION WIRE: 7 GA. GALVANIZED STEEL
- 8. BARBED WIRE: 3 STRANDS OF DOUBLE STRAND 12-1/2 GAUGE TWISTED WIRE. 4 POINT BARBS SPACED ON APPROXIMATELY 5" CENTERS
- 9. LOCAL ORDINANCE FORR BARB WIRE PERMIT SHALL **GOVERN INSTALLATION**
- 10. HEIGHT = 6' VERTICAL + 1' BARBED WIRE VERTICAL **DIMENSION**
- 11. ALL WORK SHALL CONFORM WITH THE PROJECT **SPECIFICATIONS**

GENERAL CONTRACTOR TO PROVIDE
(2) NEW LOCKS FOR MAIN GATE COMBINATION WITH TILLMAN CONSTRUCTION MANAGER.



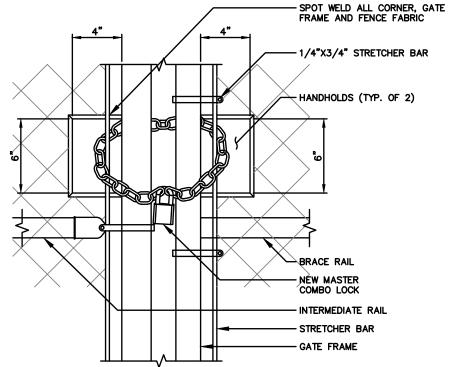





# **JOHN M. BANKS**



604 FOX GLEN
BARRINGTON, IL 60010
PHONE: 847-277-0070
EMAIL: AE©Westchesterservices.com

CHECKED BY: MC REV DATE DESCRIPTION A 08/29/23 PRELIMINARY CD


"I HEREBY CERTIFY THAT THESE PLANS WERE PREPARED BY ME OR UNDER MY DIRECT SUPERVISION AND THAT I AM A DULY REGISTERED ARCHIECT UNDER THE LAWS OF THE STATE OF WISCONSIN"

BARBED WIRE (TYP.) 45° TOP RAIL BARBED WIRE DETAIL

TILLMAN OPP# TI-OPP-23028 FA# : 15887152 SITE NAME: STRITZEL RENTAL SITE ADDRESS: 312 ELKHORN ROAD WHITEWATER, WI 53190

> SHEET TITLE **FENCE DETAILS**

C-5.1

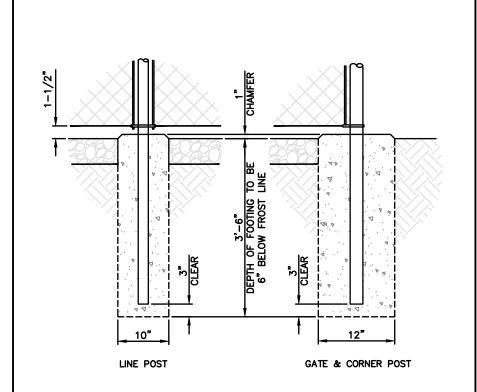

STRONGHOLD LATCH DETAIL

SCALE 3 POST FOOTING DETAIL

SCALE 2

SCALE

N.T.S.

5

**NOT USED** 

FENCING NOTES


DETAILS

SCALE

SCALE

N.T.S.

4

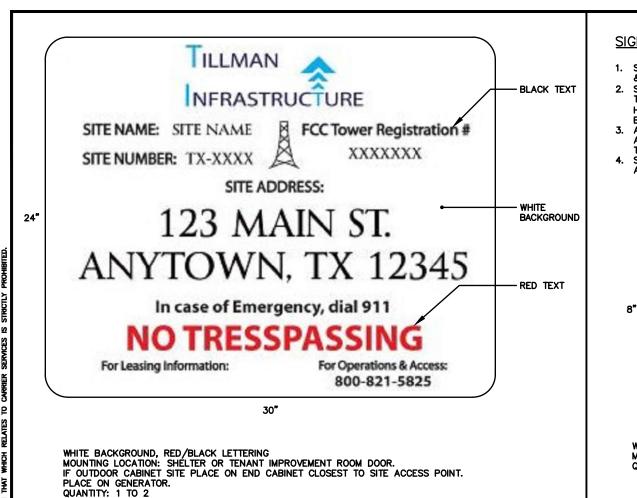

**BLACK TEXT** 


BACKGROUND

BACKGROUND


GREEN

### **SIGNAGE NOTES:**

- SIGNS SHALL BE FABRICATED FROM CORROSION RESISTANT PRESSED METAL & PAINTED WITH LONG LASTING UV RESISTANT COATING.
- 2. SIGNS (EXCEPT WHERE NOTED OTHERWISE) SHALL BE MOUNTED TO THE TOWER, GATE & FENCE USING A MINIMUM OF 9 GAUGE ALUMINUM WIRE, HOG RINGS (FENCE) OR BRACKETS, WHERE NECESSARY. BRACKETS SHALL BE OF SIMILAR METAL AS THE STRUCTURE TO AVOID GALVANIC CORROSION.
- ADDITIONAL E911 ADDRESS & FCC REGISTRATION SIGNS SHALL BE MOUNTED AT EACH ACCESS ROAD GATE LEADING TO THE COMPOUND AS WELL AS THE COMPOUND GATE ITSELF.
- SIGNS NEED NOT BE PLACED IF ACCURATE AND APPROPRIATE SIGNAGE ALREADY EXISTS.

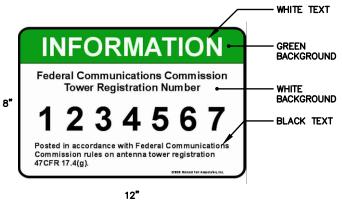

WHITE/GREEN BACKGROUND, WHITE/BLACK LETTERING MOUNTING LOCATION: GATE & BASE OF TOWER

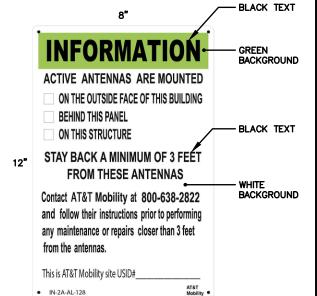

WHITE/GREEN BACKGROUND, WHITE/BLACK LETTERING MOUNTING LOCATION: GATE & BASE OF TOWER

WARNING

RF EXPOSURE INFORMATION SIGN





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CHECKED BY: MC scale n.t.s. 5 REV DATE DESCRIPTION 08/29/23 PRELIMINARY CD

**BLACK TEXT** 

BACKGROUND

**BACKGROUND** 

BACKGROUND

**BLACK TEXT** 

WHITE

DWM

I HEREBY CERTIFY THAT THESE PLANS WERE PREPARED BY ME OR UNDER MY DIRECT SUPERMISION AND THAT I AM A DULY REGISTERED ARCHITECT UNDER THE LAWS OF THE STATE OF WISCONSIN

TILLMAN OPP# TI-OPP-23028 FA# : 15887152 SITE NAME: STRITZEL RENTAL SITE ADDRESS: 312 ELKHORN ROAD WHITEWATER, WI 53190

SHEET TITLE

SITE SIGNAGE

SHEET NUMBER



FCC REGISTRATION SIGN

NOTICE BACKGROUND BACKGROUND BACKGROUND

En esta propiedad se ubican antenas de telecomunicaciones operadas por AT&T Mobility. Favor mantener una distancia de no menos de 3 pies y obedecer todos los avisos

INFORMATION

Contact the owner(s) of the antenna(s) before working closer than 3 feet from the antenna(s).

This is Site USID #

Contact AT&T Mobility at 800-638-2822 prior to performing any maintenance or repairs near AT&T Mobility antennas.

Contact the management office if this door/hatch/gate is found

INFORMACION

Comuniquese con el propietario o los propietarios de las antes de trabajar o caminar de menos de 3 pies de la antena Comuniquese con AT&T Mobility 800-638-2822 antes de realizar

cualquier mantenimiento o reparaciones cerca de las antenas de AT&T Mobility. Esta es la estacion base numero USID #\_\_\_

Favor comunicarse con la oficina de la administracion del

See 1 INSI-1A-AL-128

WHITE/GREEN BACKGROUND, WHITE/BLACK LETTERING MOUNTING LOCATION: GATE & BASE OF TOWER

WHITE TEXT BLACK TEXT **Beyond This Point:** You are entering a RADIO FREQUENCY (RF) EMISSIONS CONTROLLED AREA. RF EMISSIONS exceed FCC **Uncontrolled General Population** Follow all FCC/OSHA guidelines for working

WHITE/BLUE BACKGROUND, WHITE/BLACK LETTERING MOUNTING LOCATION: GATE & BASE OF TOWER

BLACK TEXT YELLOW **ACAUTIÓI** BACKGROUND WHITE BACKGROUND YELLOW BACKGROUND 12" BLACK TEXT **Beyond this point:** Radio frequency fields at this sit may exceed FCC rules for human For your safety, obey all posted signs and site guidelines for working in radio

WHITE/YELOW BACKGROUND, WHITE/BLACK LETTERING MOUNTING LOCATION: GATE & BASE OF TOWER

WHITE/ORANGE BACKGROUND, WHITE/BLACK LETTERING MOUNTING LOCATION: GATE & BASE OF TOWER

**Beyond this Point you are** 

entering a controlled area

emissions exceed the FCC

Failure to obey all posted signs and site

guidelines could result in serious injury.

**Controlled Exposure Limits.** 


where radio frequency

RF EXPOSURE INFORMATION SIGN | SCALE | 4 | RF EXPOSURE NOTICE SIGN


RF EXPOSURE CAUTION SIGN


2 RF EXPOSURE WARNING SIGN

12"

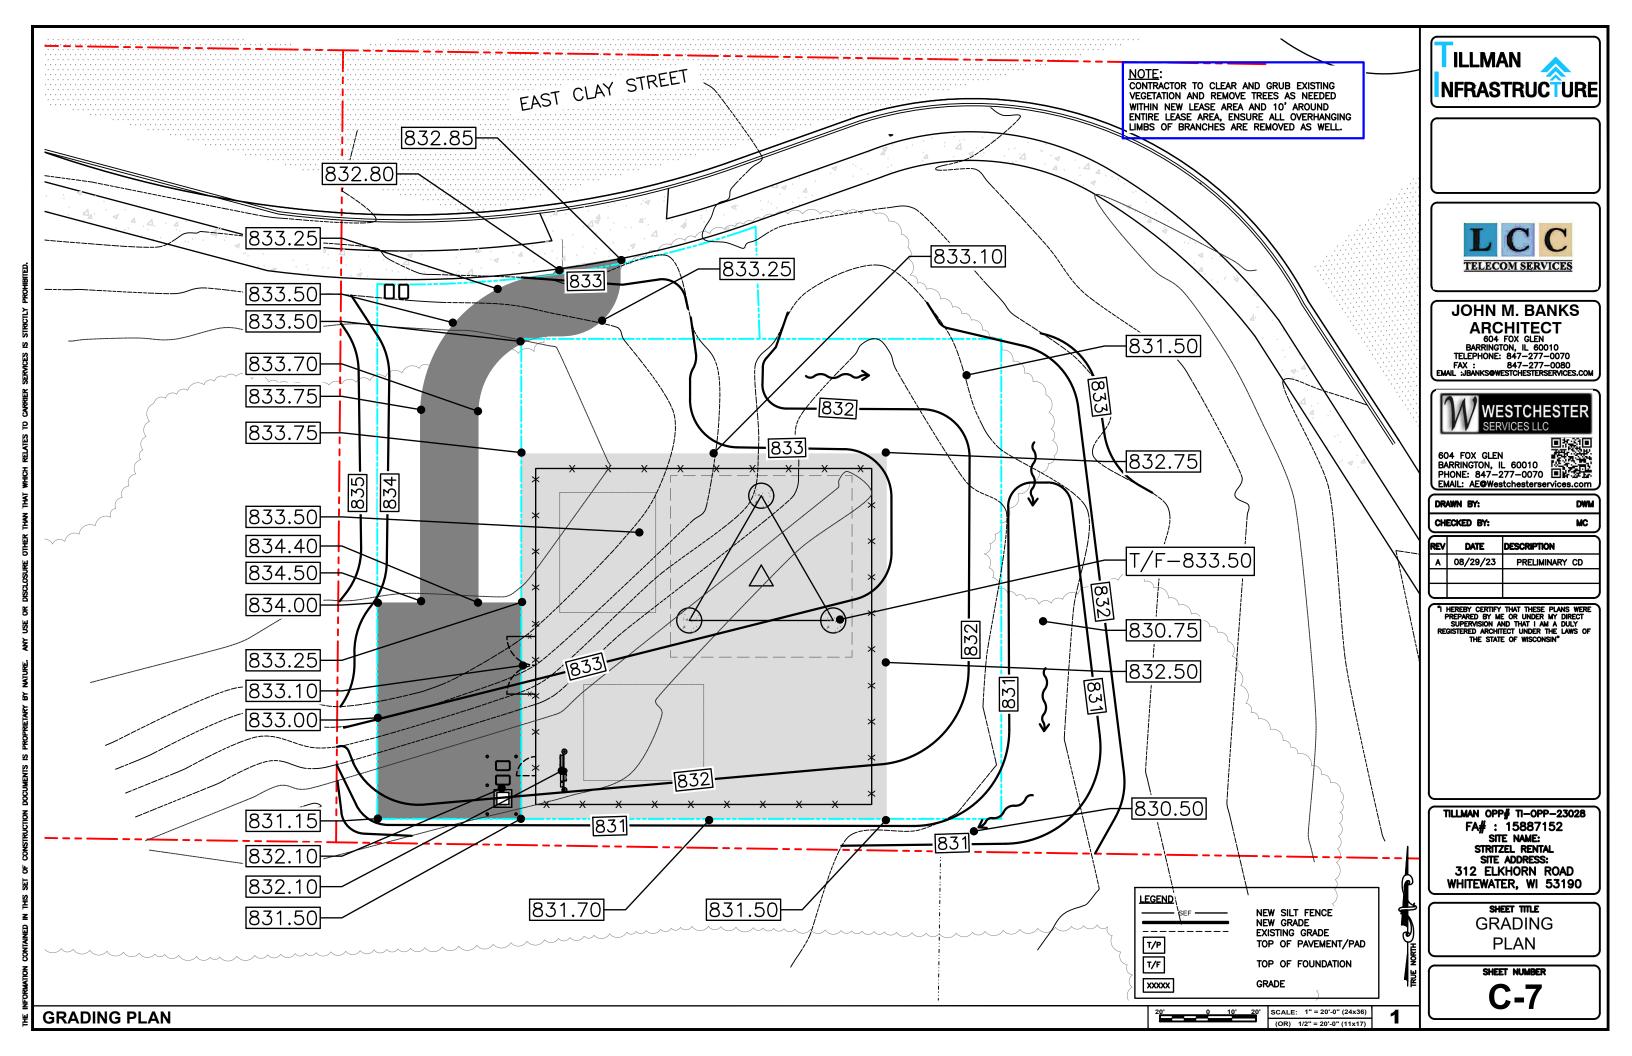

- 1. ALL VEGETATIVE AND STRUCTURAL EROSION CONTROL PRACTICES SHALL BE CONSTRUCTED AND MAINTAINED IN ACCORDANCE WITH THE MINIMUM STANDARDS AND SPECIFICATIONS OF THE APPLICABLE STATE ADOPTED "PROCEDURES AND STANDARDS FOR URBAN SOIL EROSION AND SEDIMENTATION CONTROL" AND THE "STANDARDS AND SPECIFICATIONS FOR SOIL EROSION AND SEDIMENT CONTROL" OF THE STATE ENVIRONMENTAL PROTECTION AGENCY.
- 2. A SOIL EROSION CONTROL FENCE SHALL BE INSTALLED BEFORE DISTURBING THE GROUND AND SHALL BE PROVIDED AS SHOWN ON THE PLAN. THE CONDITION OF THE FENCE SHALL BE INSPECTED REGULARLY AND AFTER EVERY RAINSTORM THAT MIGHT PRODUCE RUNOFF. DAMAGED OR DETERIORATED ITEMS SHALL BE REPLACED AND MAINTAINED IN AN EFFECTIVE
- 3. SOIL EROSION CONTROL MEASURES SHALL BE INCLUDED IN CONTRACTOR BID AND PRICING
- THE ENTIRE SITE SHALL BE GRADED SO THAT NO STORM WATER RUNOFF AND LIKEWISE SOIL SEDIMENT CAN FLOW UNRESTRICTED FROM THE SITE
- 5. ALL INLETS, STRUCTURES, PIPES, SWALES, AND ROADS SHALL BE KEPT CLEAN AND FREE OF DIRT AND SILT
- MAINTAIN SOIL EROSION CONTROL MEASURES THROUGH THE DURATION OF THIS PROJECT
- SEDIMENT DEPOSITS SHALL BE REMOVED WHEN REACHING ONE HALF THE HEIGHT OF THE
- ALL SOIL EROSION CONTROL MEASURES SHALL REMAIN IN PLACE UNTIL ALL DISTURBED EARTH HAS BEEN PAVED OR VEGETATED
- ANY EXCESS TOPSOIL THAT IS TO BE STOCKPILED FOR A PERIOD LONGER THAN 2 WEEKS SHALL BE PROTECTED BY EXCAVATING A TRENCH COMPLETELY AROUND THE STOCKPILE TO PREVENT THE ESCAPE OF SOIL MATERIAL THROUGH STORM WATER RUNOFF. STOCKPILES THAT ARE TO REMAIN LONGER THAN 14 DAYS SHALL BE SEEDED WITH AN APPROPRIATE **GROUND COVER**
- 10. TO PREVENT SOIL FROM LEAVING THE SITE ON CONSTRUCTION VEHICLE WHEELS, TEMPORARY GRAVEL ROADS AT WORK ENTRANCES SHALL BE CONSTRUCTED AND SHALL EXTEND INTO JOB SITE. THE EXISTING PAVEMENT SURFACES SHALL BE INSPECTED DAILY FOR SOIL DEBRIS AND SHALL BE CLEANED WHEN NECESSARY
- 11. REPLACE SOIL EROSION CONTROL MEASURES WITH SEED, SOD AND TOPSOIL AT THE COMPLETION OF THE PROJECT
- 12. SOIL EROSION CONTROL MEASURES SHALL BE REMOVED AND PROPERLY DISPOSED OF WHEN PROJECT IS COMPLETED

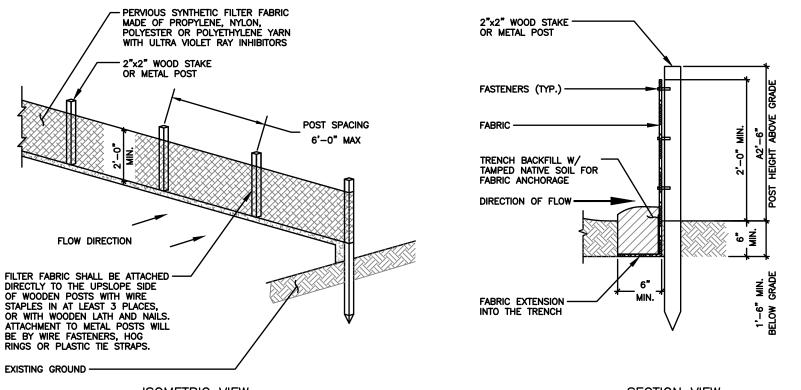

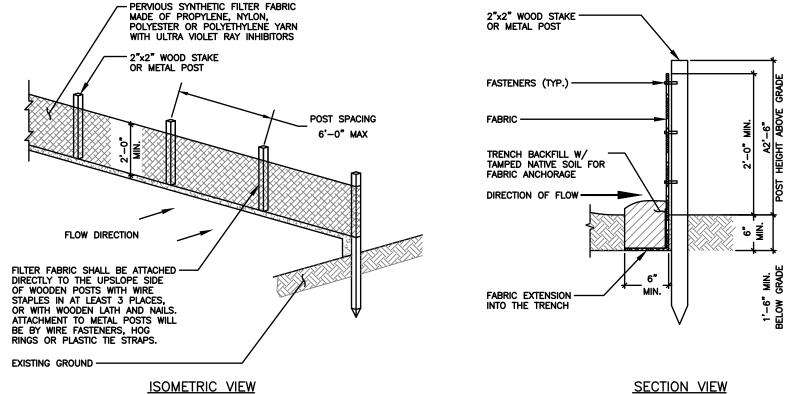





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SCALE

N.T.S.

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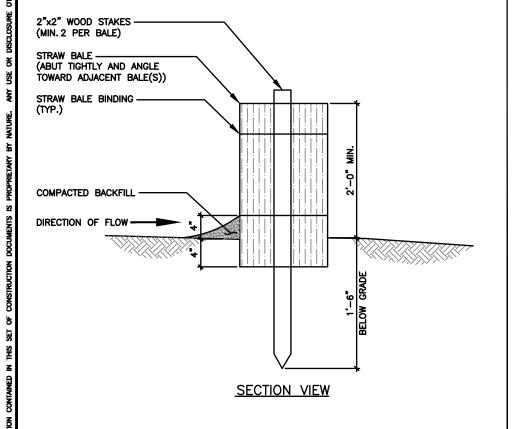
TILLMAN OPP# TI-OPP-23028 FA#: 15887152 SITE NAME: STRITZEL RENTAL SITE ADDRESS: 312 ELKHORN ROAD WHITEWATER, WI 53190

**EROSION CONTROL** DETAILS


SOIL EROSION & SEDIMENT CONTROL NOTES

SCALE

**EROSION CONTROL - SILT FENCE** 




EROSION CONTROL - STRAW BALE (OPTIONAL) SOLE

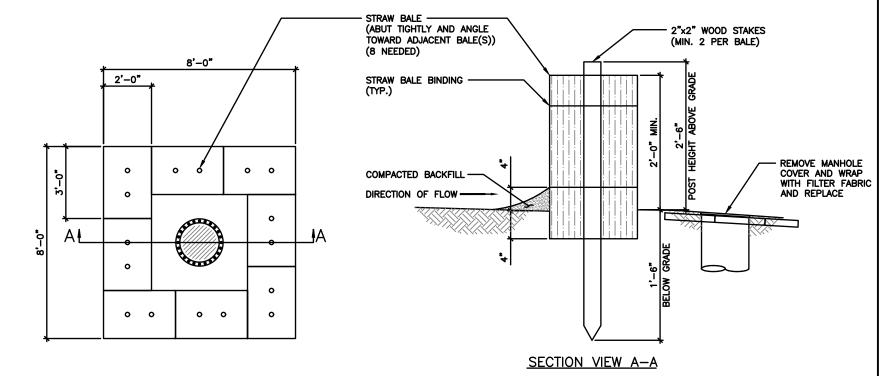

EROSION CONTROL - STRAW BALE AT STORM INLET MANHOLE (IF NEEDED SEE PLANS)

SCALE

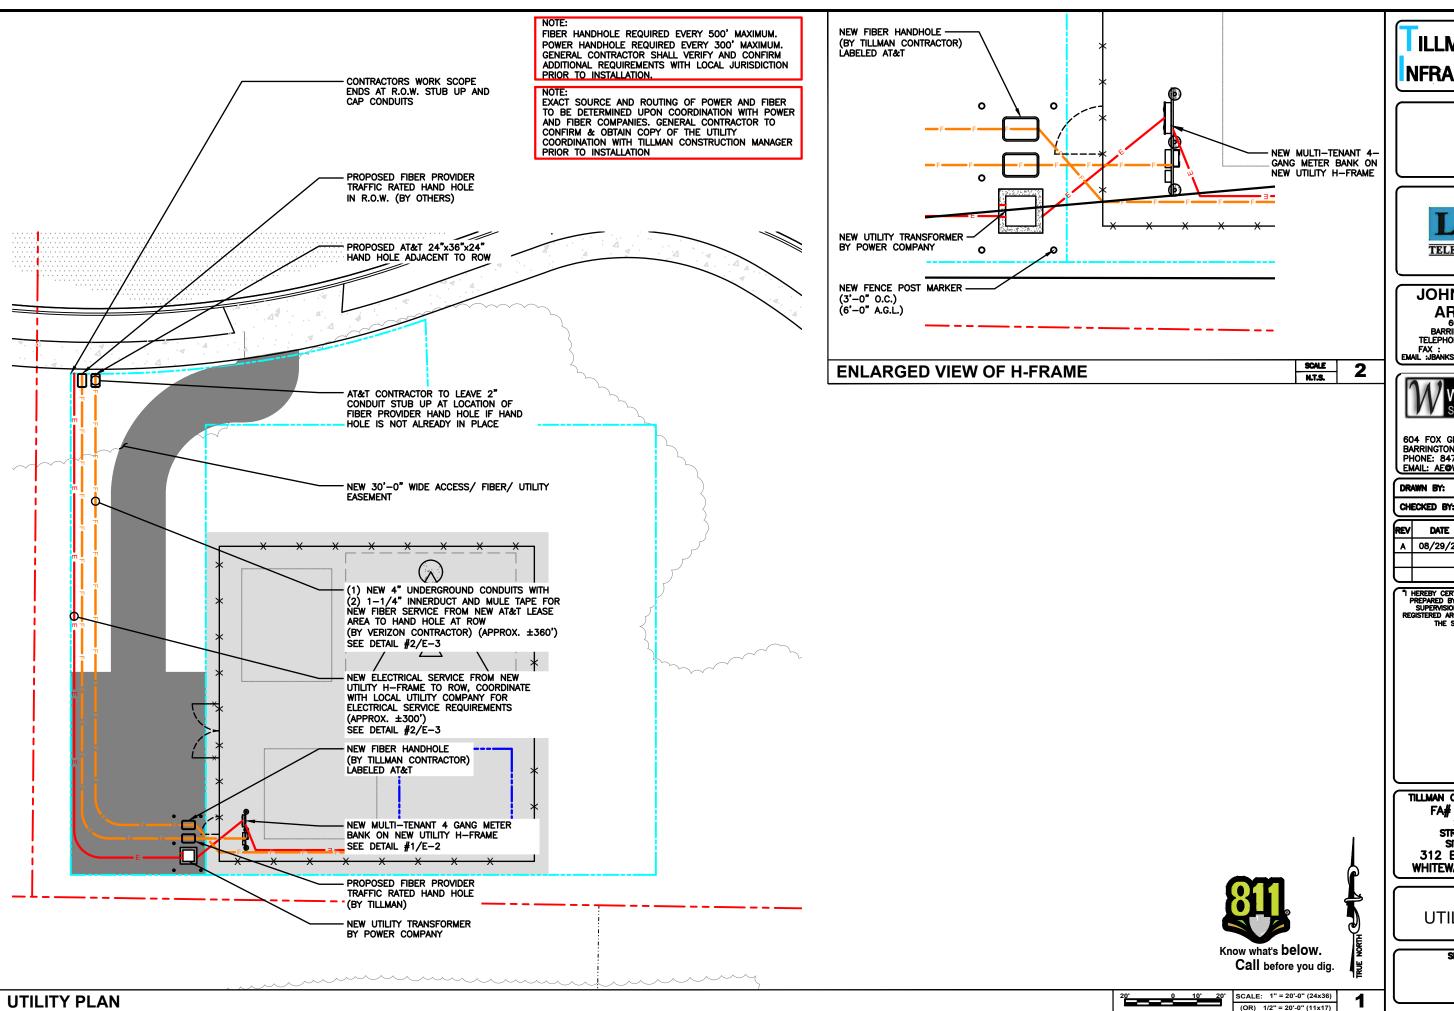





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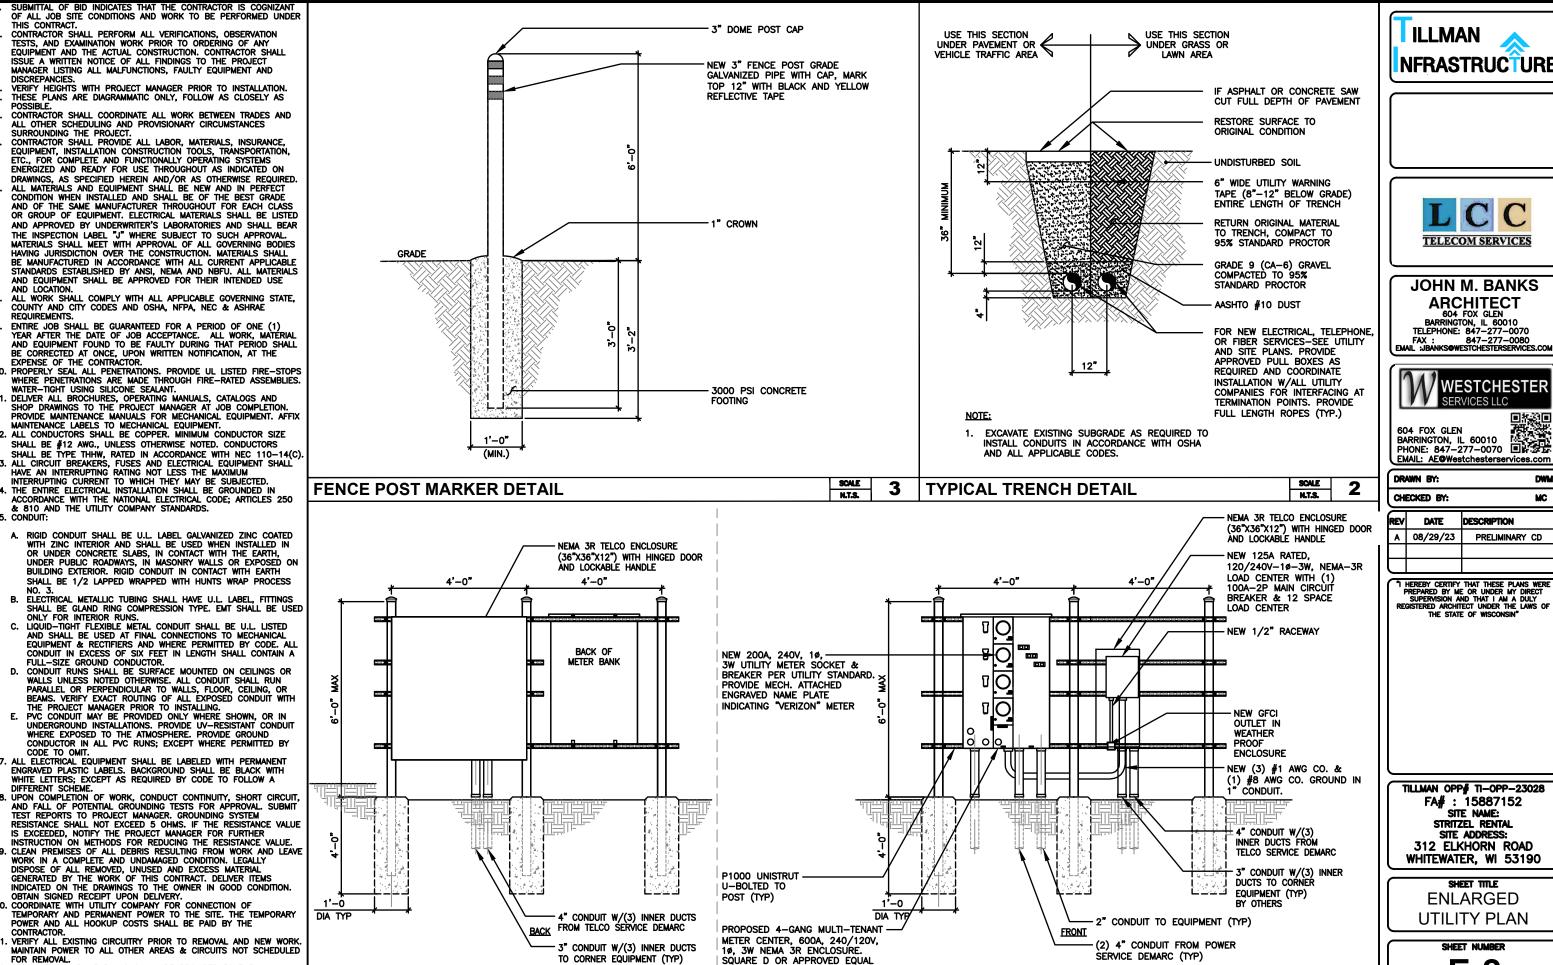
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SHEET TITLE

**UTILITY PLAN** 

SHEET NUMBER



BY OTHERS

2. RED LINED AS-BUILT PLANS SHALL BE PROVIDED TO THE

4

**UTILITY FRAME DETAIL** 

CONSTRUCTION MANAGER

**ELECTRICAL NOTES** 

ILLMAN NFRASTRUCTURE



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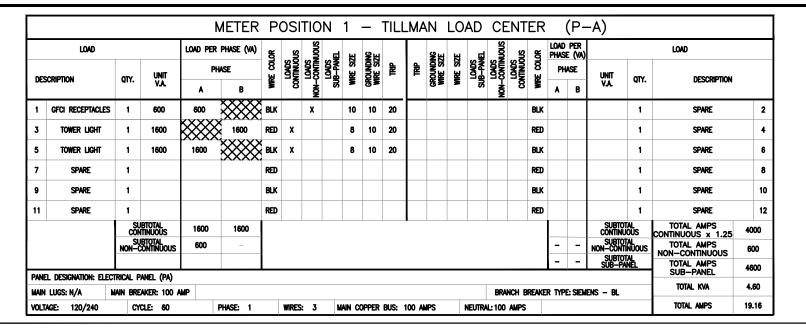
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SHEET TITLE **ENLARGED** UTILITY PLAN

SCALE

**E-2** 







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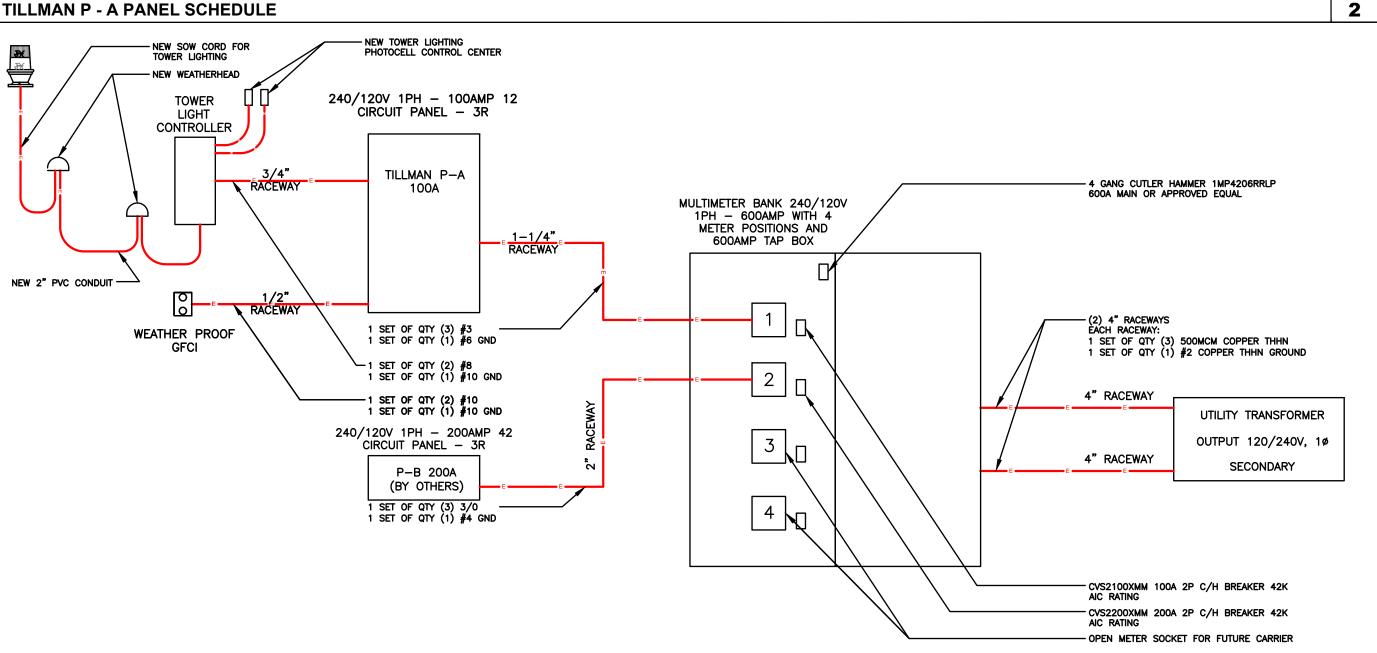
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TILLMAN OPP# TI-OPP-23028 FA# : 15887152 SITE NAME: STRITZEL RENTAL SITE ADDRESS: 312 ELKHORN ROAD WHITEWATER, WI 53190

> SHEET TITLE **ELECTRICAL** DIAGRAM

1

**E-3** 




**ELECTRICAL SINGLE LINE DIAGRAM** 

### GROUNDING NOTES:

- GROUNDING SHALL COMPLY WITH ARTICLE 250 OF THE NATIONAL ELECTRICAL CODE.
- ALL GROUNDING DEVICES SHALL BE U.L. APPROVED OR LISTED FOR THEIR INTENDED USE.
- ALL WIRES SHALL BE AWG THHN/THWN COPPER UNLESS NOTED OTHERWISE.
- GROUNDING CONNECTIONS TO GROUND RODS, GROUND RING WIRE, TOWER BASE AND FENCE POSTS SHALL BE EXOTHERMIC ("CADWELDS") UNLESS NOTED OTHERWISE. CLEAN SURFACES TO SHINY METAL. WHERE GROUND WIRES ARE CADWELDED TO GALVANIZED SURFACES, SPRAY CADWELD WITH GALVANIZING PAINT.
- GROUNDING CONNECTIONS TO GROUND BARS ARE TO STAINLESS STEEL HARDWARE (INCLUDING SCREW SET)
  CLEAN GROUND BAR TO SHINY METAL AFTER
  MECHANICAL CONNECTION, TREAT WITH PROTECTIVE
  ANTIOXIDANT COATING.
- GROUND COAXIAL CABLE SHIELDS AT BOTH ENDS WITH MANUFACTURER'S GROUNDING KITS.
- ROUTE GROUNDING CONDUCTORS THE SHORTEST AND STRAIGHTEST PATH POSSIBLE. BEND GROUNDING LEADS WITH A MINIMUM 12" RADIUS.
- INSTALL #2 AWG GREEN-INSULATED STRANDED WIRE FOR ABOVE GRADE GROUNDING AND #2 BARE TINNED COPPER WIRE FOR BELOW GRADE GROUNDING UNLESS
- REFER TO GROUNDING PLAN FOR GROUND BAR LOCATIONS. GROUNDING CONNECTIONS SHALL BE EXOTHERMIC TYPE ("CADWELDS") TO ANTENNA MOUNTS AND GROUND RING. REMAINING GROUNDING CONNECTIONS SHALL BE COMPRESSION FITTINGS. CONNECTIONS TO GROUND BARS SHALL BE MADE WITH TWO-HOLE LUGS.
- 10. THE GROUND ELECTRODE SYSTEM SHALL CONSIST OF DRIVEN GROUND RODS POSITION ACCORDING TO GROUNDING PLAN. THE GROUND RODS SHALL BE 5/8"X10"-0" COPPER CLAD STEEL INTERCONNECTED WITH #2 BARE TINNED COPPER WIRE BURIED 36" BELOW GRADE. BURY GROUND RODS A MAXIMUM OF
- 1. IF ROCK IS ENCOUNTERED GROUND RODS SHALL BE PLACED AT AN OBLIQUE ANGLE NOT TO EXCEED 45°.
- 12. EXOTHERMIC WELDS SHALL BE MADE IN ACCORDANCE WITH ERICO PRODUCTS BULLETIN A-AT.
- 13. CONSTRUCTION OF GROUND RING AND CONNECTIONS TO EXISTING GROUND RING SYSTEM SHALL BE DOCUMENTED WITH PHOTOGRAPHS PRIOR TO BACKFILLING SITE. PROVIDE PHOTOS TO THE VERIZON WIRELESS CONSTRUCTION MANAGER.
- ALL GROUND LEADS EXCEPT THOSE TO THE EQUIPMENT ARE TO BE #2 BARE TINNED COPPER WIRE. ALL EXTERIOR GROUND BARS TINNED COPPER.
- 5. PRIOR TO INSTALLING LUGS ON GROUND WIRES, APPLY THOMAS & BETTS KOPR-SHIELD (TM OF JET LUBE INC.). PRIOR TO BOLTING GROUND WIRE LUGS TO GROUND BARS, APPLY KOPR-SHIELD OR EQUAL.
- 6. ENGAGE AN INDEPENDENT ELECTRICAL TESTING FIRM TO TEST AND VERIFY THAT IMPEDANCE DOES NOT EXCEED FIVE OHMS TO GROUND BY MEANS OF "FALL OF POTENTIAL TEST". TEST SHALL BE WITNESSED BY A METROPCS REPRESENTATIVE, AND RECORDED ON THE "GROUND RESISTANCE TEST" FORM.
- 17. WHERE BARE COPPER GROUND WIRES ARE ROUTED FROM ANY CONNECTION ABOVE GRADE TO GROUND RING, INSTALL WIRE IN 3/4" PVC SLEEVE, FROM 1' BELOW GRADE AND SEAL TOP WITH SILICONE MATERIAL
- PREPARE ALL BONDING SURFACES FOR GROUNDING CONNECTIONS BY REMOVING ALL PAINT AND CORROSION DOWN TO SHINY METAL. FOLLOWING CONNECTION, APPLY APPROPRIATE ANTI-OXIDIZATION PAINT.
- 9. ANY SITE WHERE THE EQUIPMENT (BTS, CABLE BRIDGE, PPC, GENERATOR, ETC.) IS LOCATED WITHIN 6 FEET OF METAL FENCING, THE GROUND RING SHALL BE BONDED TO THE NEAREST FENCE POST USING (3) RUNS OF #2 BARE TINNED COPPER WIRE.

GROUNDING NOTES

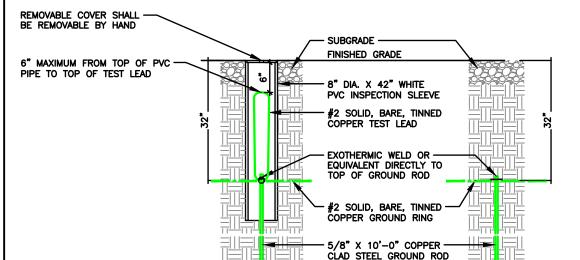

A LARGER CONDUCTOR SHALL BE REQUIRED IN AREAS HIGHLY PRONE TO LIGHTNING AND/OR AREAS W/HIGHLY ACIDIC SOIL

GROUND RODS MAY BE COPPER CLAD STEEL OR SOLID COPPER

GROUND RODS SHALL HAVE A RECOMMENDED SPACING TWICE THE LENGTH OF THE ROD

SEE RESISTIVITY REPORT FOR VERIFICATION AS AVAILABLE

GROUND RODS INSTALLED WITHIN CLOSE PROXIMITY TO TOWER OR WHEN SOIL IS AT OR BELOW 2,000 OHM-CM, SHALL BE GALVANIZED TO PREVENT GALVANIC CORROSION OF TOWER





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2

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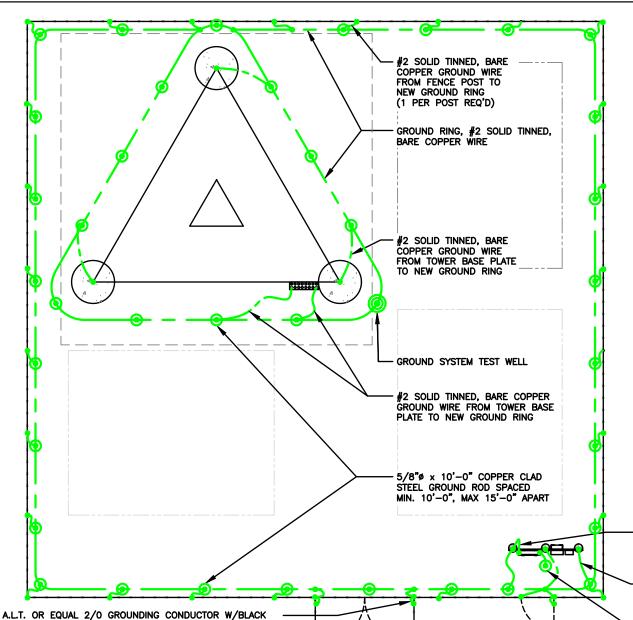
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TILLMAN OPP# TI-OPP-23028 FA# : 15887152 SITE NAME: STRITZEL RENTAL SITE ADDRESS: 312 ELKHORN ROAD WHITEWATER, WI 53190

**GROUNDING PLAN** & DETAILS

**GROUND WELL, ROD, AND TEST WELL DETAIL** 



MECHANICAL CONNECTION COMPRESSION FITTING CONNECTION

**()** 

GROUNDING TO BE INSTALLED WITHIN 2'-0' OF FENCE LINE WHENEVER POSSIBLE

**NEW GROUND WIRING** 

MAIN GROUND BAR

WITH INSPECTION WELL

**EXOTHERMIC WELD CONNECTION** 

5/8"X10' COPPER-CLAD STEEL GROUND ROD

5/8"X10' COPPER-CLAD STEEL GROUND ROD

**GROUNDING LEGEND** 

**EXISTING GROUND WIRING** TINNED COPPER GROUND BAR

1/4"X4"X12" OR 1/4"X4"X20" COLLECTOR GROUND BAR

SEE COMPOUND PLAN FOR COMPOUND ORIENTATION, UTILITY H-FRAME, GATE AND TOWER LOCATION.

REFER TO SPECIFIC CARRIER EQUIPMENT GROUNDING PLAN FOR NEW CARRIER EQUIPMENT GROUNDING.

### OBJECTIVE:

- RING AROUND TOWER WITH ALL TOWER LEGS GROUNDED, MONOPOLE SHALL HAVE AT LEAST TWO GROUNDS TO EARTH.
- CONNECTION TO FENCE POSTS AT ALL CORNERS OR CHANGES IN FENCE DIRECTION GREATER THE 45°.
- CONNECTIONS TO EACH SIDE OF ANY GATE
- CONNECTIONS TO UTILITY H-FRAME.
- INSTALL ENOUGH GROUND RODS TO ENSURE 5 OHMS OR LESS RESISTANCE.

#2 SOLID TINNED, BARE COPPER GROUND WIRE FROM ELECTRICAL SERVICE GROUND TO LIGHTNING PROTECTION GROUND RING

#2 SOLID TINNED, BARE COPPER GROUND WIRE, BOND UTILITY POST W/ VS TYPE CADWELD. (1 PER POST REQ'D)

5/8" x 10'-0" COPPER CLAD STEEL GROUND ROD FOR ELECTRICAL SERVICE GROUND


**GROUNDING PLAN AND DETAILS** 


INSTALL W/ WELDS 18" ABOVE FINISH GRADE


GATE POST AND GATE FRAME W/ VS TYPE EXOTHERMIC.

NEOPRENE INSULATION & PRE-CAPPED ENDS ATTACHED TO

SCALE

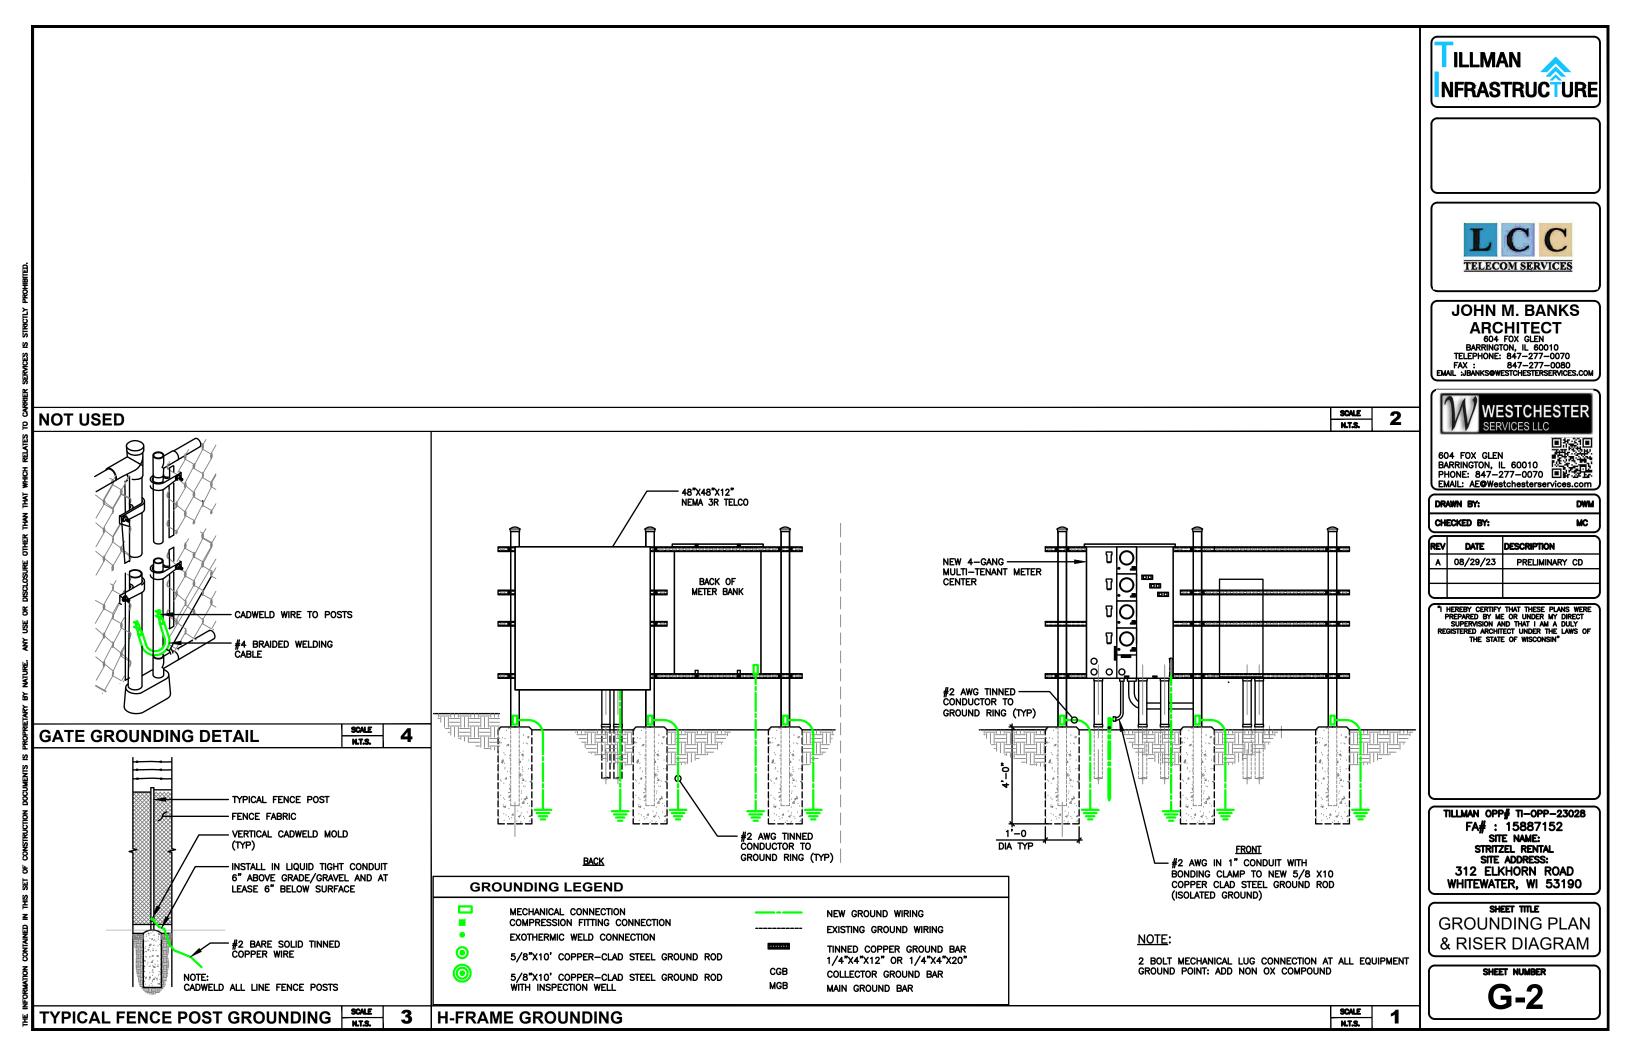

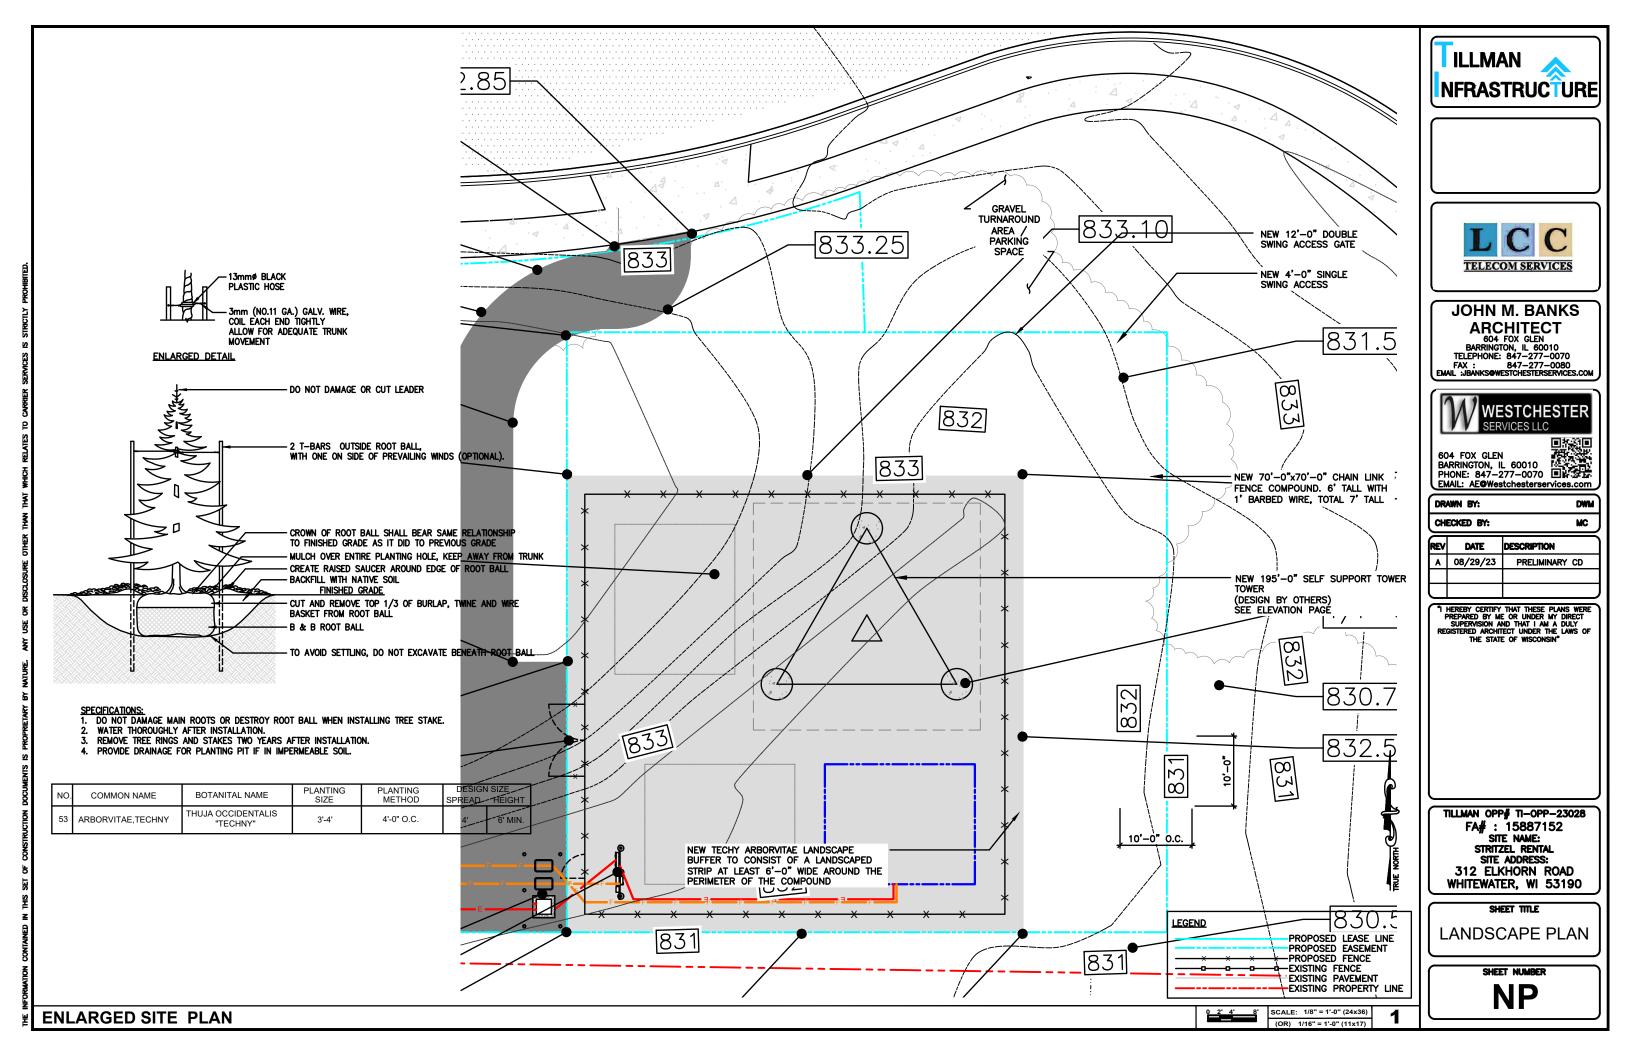

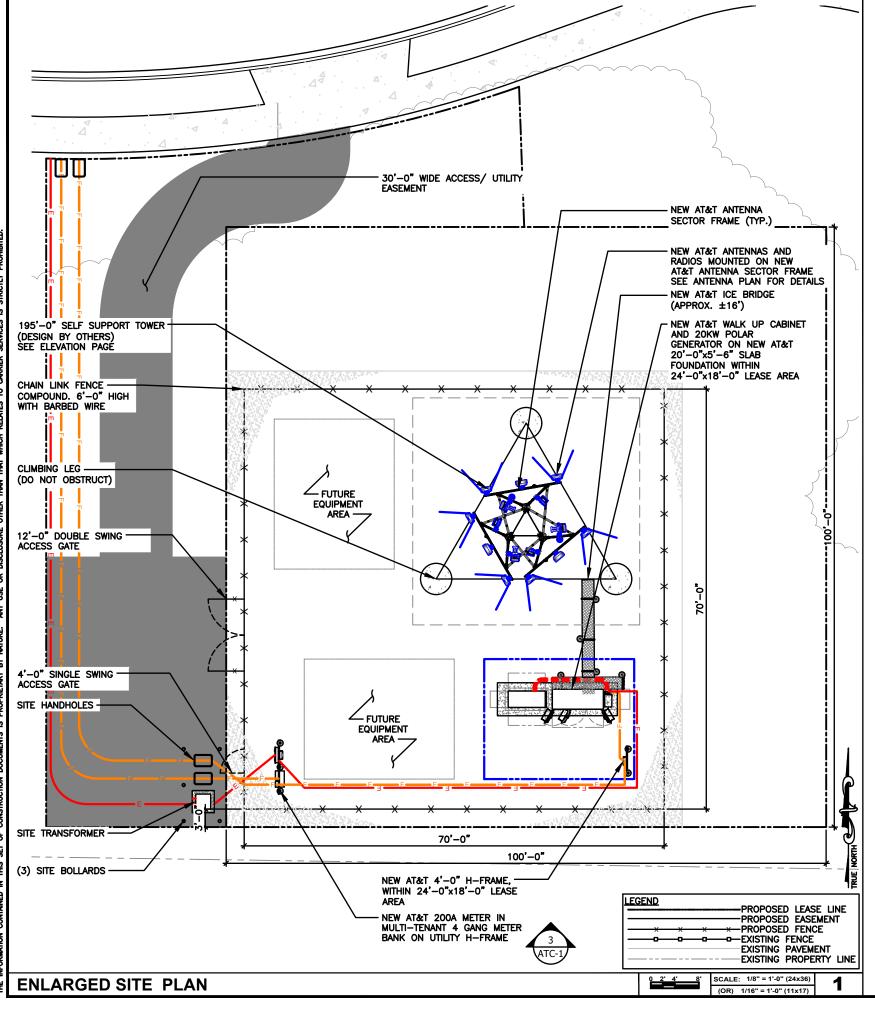



**AT&T SITE NUMBER: TI-OPP-23028** AT&T SITE NAME: STRITZEL RENTAL **FA CODE: 15887152 SITE ADDRESS: 312 ELKHORN ROAD** WHITEWATER, WI 53190 **TILLMAN SITE # TI-OPP-23028** 

### SITE INFORMATION

SITE ADDRESS: 312 ELKHORN ROAD LANDLORD OWNER: CITY OF ASHLEY PARCEL 011427400026 LATITUDE (NAD 83): 38°19'09.7530" N (42.83056204°) TILLMAN INFRASTRUCTURE LONGITUDE (NAD 83): 89°11'01.3798" W (-88.71090223°) TOWER OWNER: 152 W. 57TH STREET NEW YORK, NEW YORK 10019

GROUND ELEVATION: 829.94' (AMSL)

JURISDICTION: CITY OF WHITEWATER STRUCTURE TYPE:

PARCEL/MAP NUMBER: STRUCTURE HEIGHT: 195'-0" (AGL)

TILLMAN SITE #:

#### PROJECT TEAM DRAWING INDEX

APPLICANT TILL MAN INFRASTRUCTURE NEW YORK, NEW YORK 10019

PROJECT MANAGEMENT FIRM:

ARCHITECT

LCC TELECOM SERVICES 10700 HIGGINS ROAD, SUITE 240 ROSEMONT, IL 60018

JOHN M. BANKS 604 FOX GLEN

BARRINGTON, IL 60010 CONTACT: JOHN M. BANKS PHONE: (847) 277-0070 EMAIL: JBANKS@WESTCHESTERSERVICES.COM

TITLE SHEET & OVERALL SITE PLAN AT-C-1

SELF SUPPORT TOWER TOWER

ELEVATION. ANTENNA PLAN & SCHEDULE WALK UP CABINET PAD DETAILS

AT-C-2.1 WALK UP CABINET PAD DETAILS CONSTRUCTION DETAILS

AT-C-3 1 CONSTRUCTION DETAILS CONSTRUCTION DETAILS

RRH, ANTENNA & EQUIPMENT SPECIFICATIONS AT-C-4

AT-E-1 ENLARGED UTILITY PLAN

ELECTRICAL PANEL SCHEDULE, DIAGRAM & NOTES AT-E-2

AT-E-4 DC WIRING DIAGRAM

AT-G-1 GROUNDING PLAN & RISER DIAGRAM

DC/FIBER SYSTEM DIAGRAM

AT-G-2 GROUNDING DETAILS & NOTES

### **CODE COMPLIANCE**

ALL WORK AND MATERIALS SHALL BE PERFORMED AND INSTALLED IN ACCORDANCE WITH THE CURRENT EDITIONS OF THE FOLLOWING CODES AS ADOPTED BY THE LOCAL GOVERNING AUTHORITIES. NOTHING IN THESE PLANS IS TO BE CONSTRUED TO PERMIT WORK NOT CONFORMING TO THE LATEST EDITIONS OF THE FOLLOWING CODES

- 2023 WISCONSIN STATE BUILDING CODE
- 2023 WISCONSIN STATE ELECTRICAL CODE
- 2023 WISCONSIN STATE MECHANICAL CODE 2023 WISCONSIN UNIFORM PLUMBING CODE
- 2023 WISCONSIN STATE FIRE CODE
- AMERICAN CONCRETE INSTITUTE
- AMERICAN INSTITUTE OF STEEL CONSTRUCTION
- MANUAL OF STEEL CONSTRUCTION 13TH EDITION

AT-E-3

- INSTITUTE FOR ELECTRICAL & ELECTRONICS ENGINEERING 81
- IEEE C2 NATIONAL ELECTRIC SAFETY CODE
- LATEST EDITION TELECORDIA GR-1275







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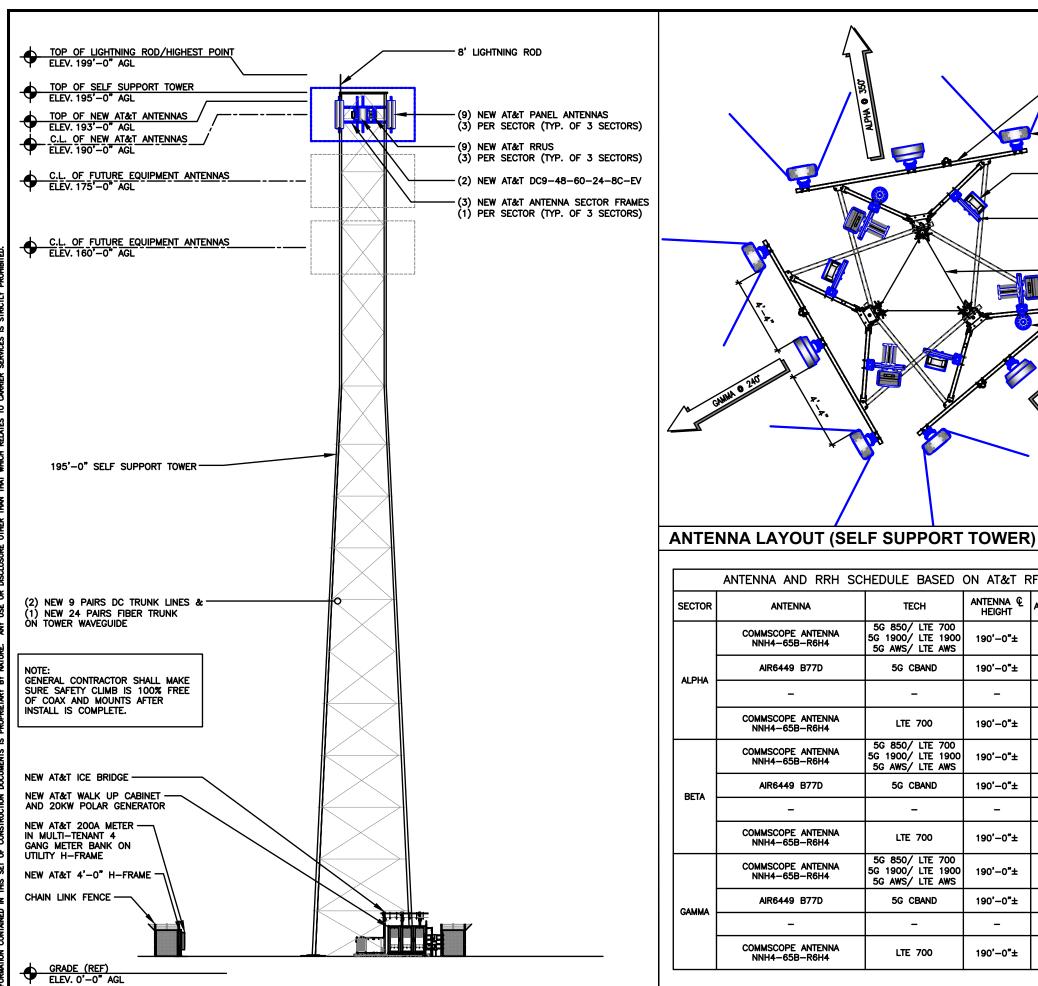
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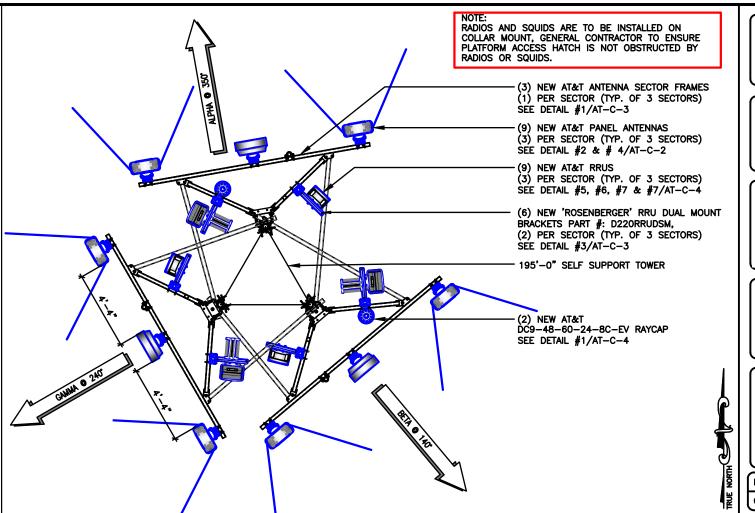
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SHEET TITLE TITLE SHEET & OVERALL SITE PLAN



**ELEVATION** 



		ANTENNA AND RRH SC	HEDULE BASED	ON AT&T F	RFDS DA	ATED: 01/31/23	CA	Œ
s	ECTOR	ANTENNA	ANTENNA TECH ANTI		ANTENNA © AZIMUTH	RRU MODEL	QUANTITY	Ī
		COMMSCOPE ANTENNA NNH4-65B-R6H4	5G 850/ LTE 700 5G 1900/ LTE 1900 5G AWS/ LTE AWS	190'-0"±	350°	RRUS 4449 B5/B12 RRUS 8843 B2/B66A	2	t
	ALPHA	AIR6449 B77D	5G CBAND	190'-0 <b>"</b> ±	350°	-	1	ł
'	ALFIIA	-	_	-	-	-	2	ł
		COMMSCOPE ANTENNA NNH4-65B-R6H4	LTE 700	190'-0"±	350°	RRUS 4478 B14		L
		COMMSCOPE ANTENNA NNH4-65B-R6H4	5G 850/ LTE 700 5G 1900/ LTE 1900 5G AWS/ LTE AWS	190'-0"±	140°	RRUS 4449 B5/B12 RRUS 8843 B2/B66A	1	
	BETA	AIR6449 B77D	5G CBAND	190'-0"±	140°	-	İ	
	DEIA	-	_	-	-	-	İ	
		COMMSCOPE ANTENNA NNH4-65B-R6H4	LTE 700	190'-0"±	140°	RRUS 4478 B14	l	
	GAMMA	COMMSCOPE ANTENNA NNH4-65B-R6H4	5G 850/ LTE 700 5G 1900/ LTE 1900 5G AWS/ LTE AWS	190'-0"±	240°	RRUS 4449 B5/B12 RRUS 8843 B2/B66A	1	
		AIR6449 B77D	5G CBAND	190'-0"±	240°	-	l	1
`		-	_	-	_	-	ı	
		· ·	<u>"</u>	·		, and the second		

LTE 700

240°

190'-0"±

RRUS 4478 B14







# JOHN M. BANKS

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DWM

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"I HEREBY CERTIFY THAT THESE PLANS WERE PREPARED BY ME OR UNDER MY DIRECT SUPERVISION AND THAT I AM A DULY REGISTERED ARCHITECT UNDER THE LAWS OF THE STATE OF WISCONSIN

AT&T SITE# TI-OPP-23028 AT&T SITE NAME: STRITZEL RENTAL FA # 15887152 SITE ADDRESS: 312 ELKHORN ROAD WHITEWATER, WI 53190

SHEET TITLE **ELEVATION, ANT.** PLAN & SCHEDULE

AT-C-

**ANTENNA AND RRH SCHEDULE** 

SCALE

COMMSCOPE ANTENNA

NNH4-65B-R6H4

SCALE N.T.S.

SCALE


N.T.S.

CABLE TYPE

4 CONDUCTOR (9 PR) 3/4" DC CABLE 36 FIBER (24 PR) 10MM FIBER

DC9 SQUIDS

CABLE COUNT

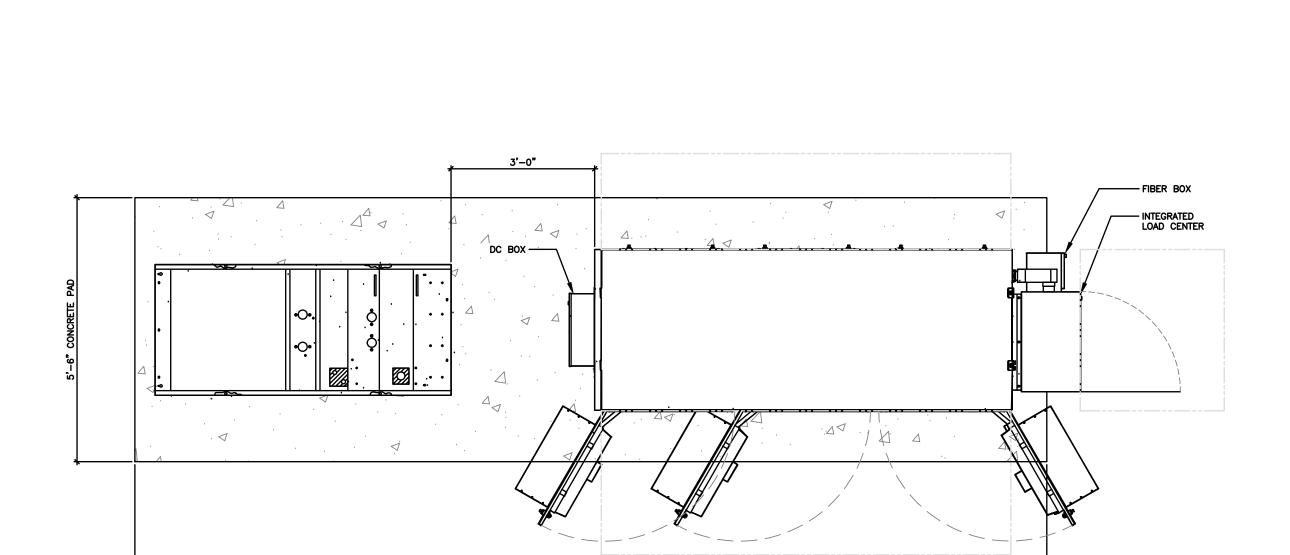

19'-0" CONCRETE PAD







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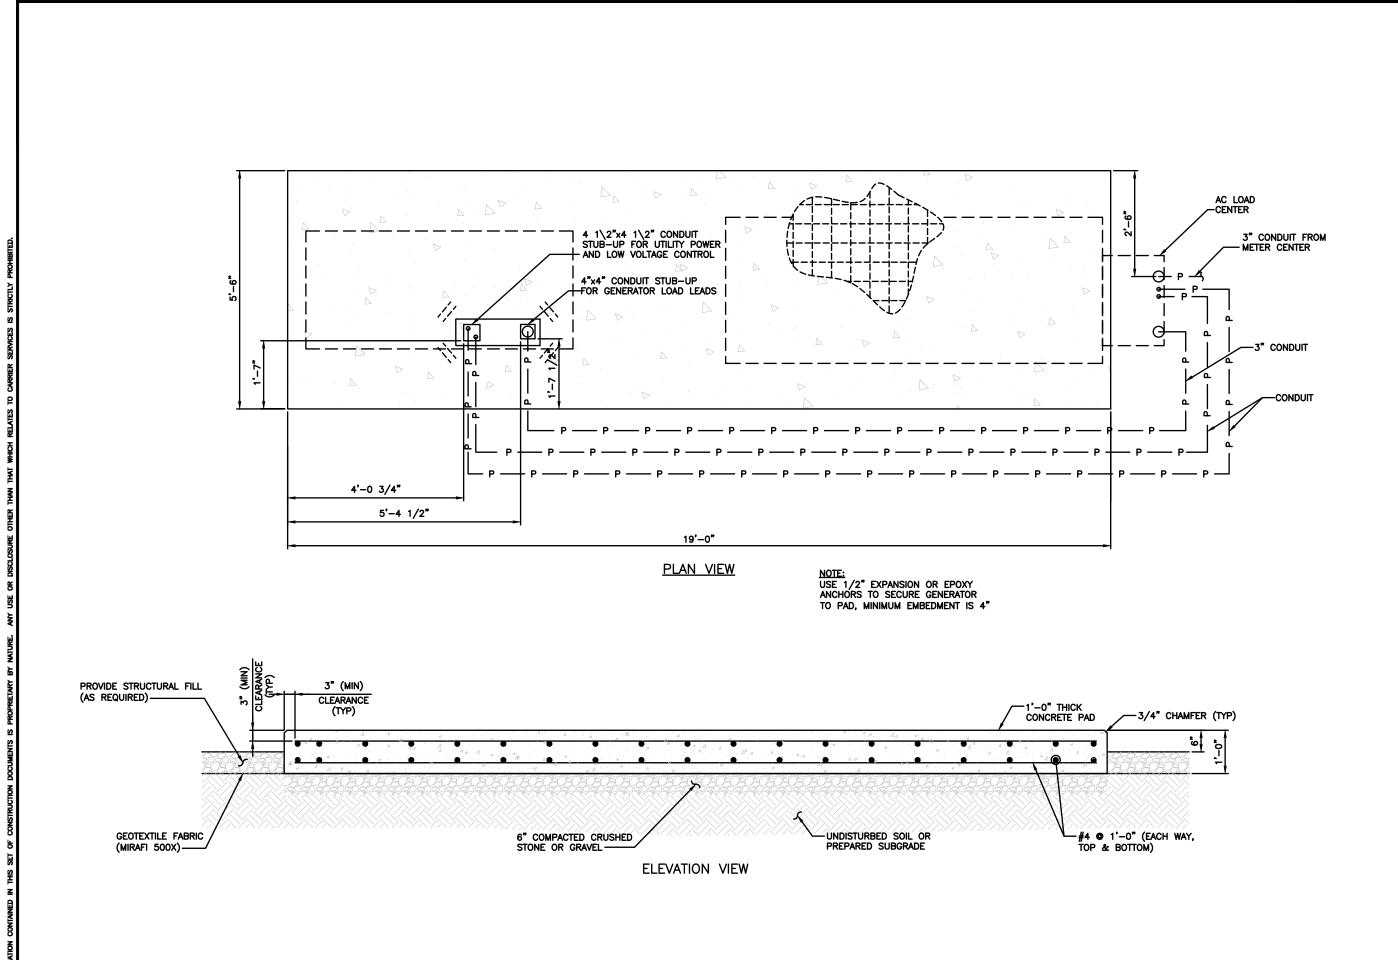
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312 ELKHORN ROAD
WHITEWATER, WI 53190

SHEET TITLE
WALK UP CABINET PAD DETAILS

AT-C-2

AT&T EQUIPMENT LAYOUT



**CONCRETE PAD DETAILS** 







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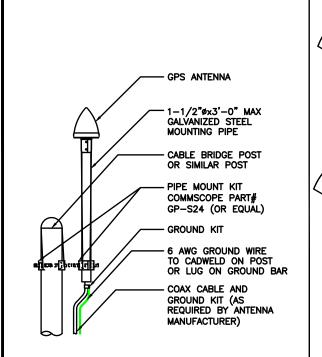
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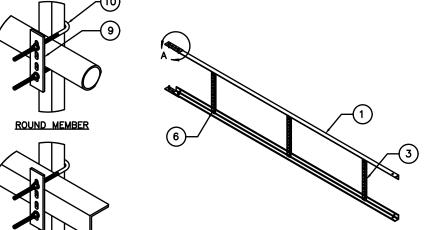
DWM

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SHEET TITLE WALK UP CABINET PAD DETAILS




ICE BRIDGE DETAIL



ITEM	PART NO.	DESCRIPTION	QTY.	WEIGHT
1	CL20.01	20' ANGLE SIDE RAIL	2	49.38 LB
2	CL0620UH	HARDWARE KIT (ITEMS 3-10)	1	-
3	CL06R.01	20" LADDER RUNG	6	1.69 LBS
4	CL20H	HARDWARE KIT (ITEMS 5-7)	1	-
5	HKCLU.02	BACKING PLATE	2	0.95 LBS
6	GB-03145	3/8" X 1-1/2" GALV BOLT KIT	16	0.07 LBS
7	GWF-03	3/8" GALV FLAT WASHER	4	0.01 LBS
8	HKCLU	LADDER HARDWARE KIT (ITEMS 9-10)	2	_
9	HKCLU.02	BACKING PLATE	4	0.95 LBS
10	JB-8K	8" GALV J-BOLT	8	0.36 LBS


DETAIL A SCALE 3 **GPS ANTENNA DETAIL** 5 CABLE LADDER DETAIL N.T.S.

ANGLE MEMBER

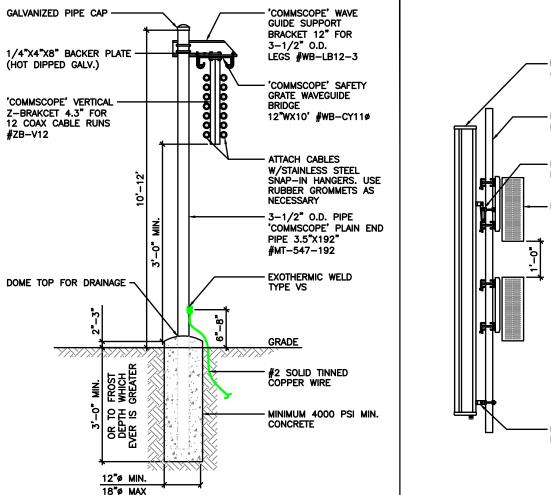


SCALE


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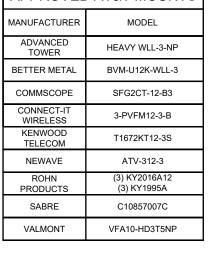


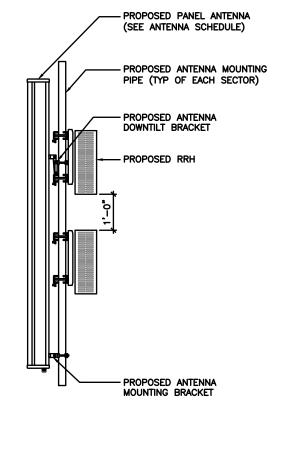
RRH MOUNTING DETAIL

SCALE



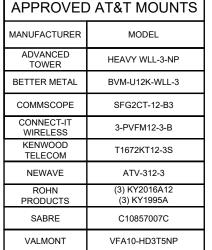

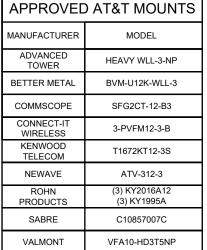

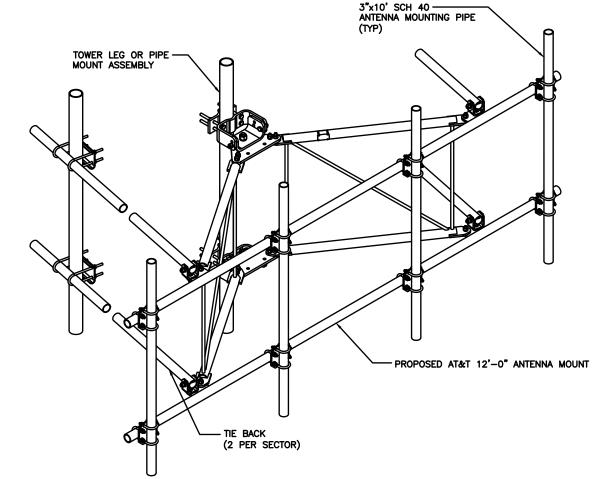







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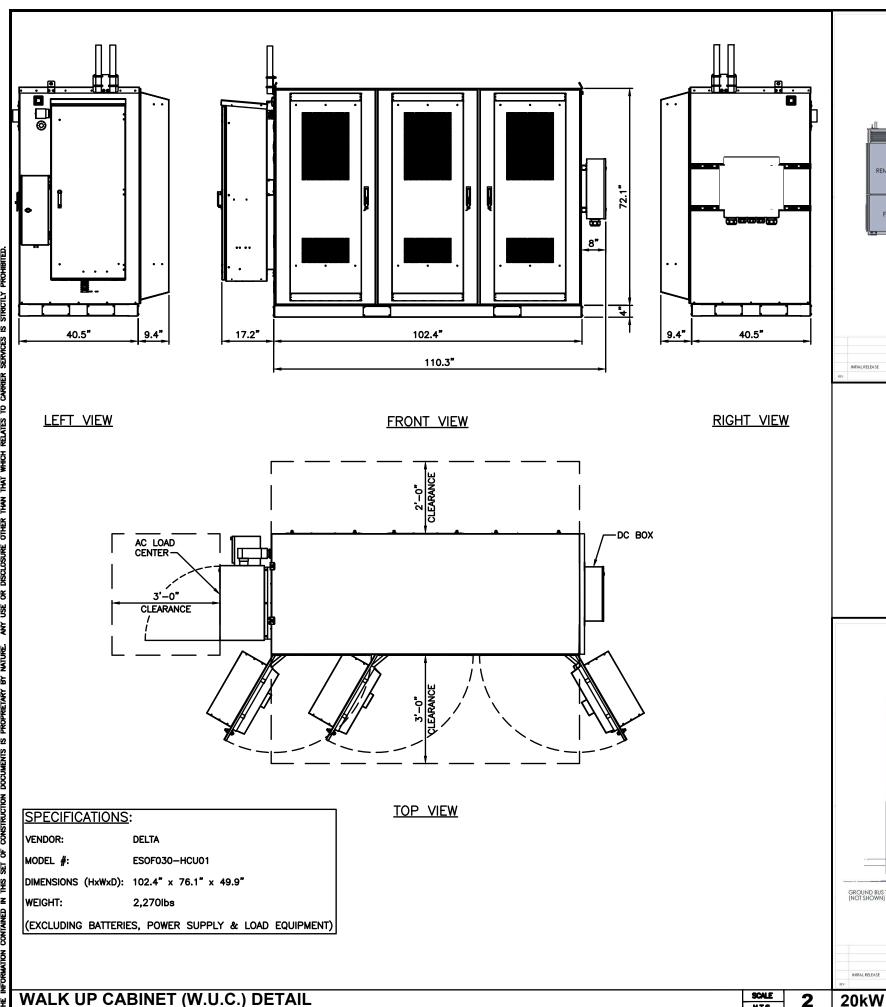
СН	ECKED BY:	MC
REV	DATE	DESCRIPTION
Α	08/29/23	PRELIMINARY CD


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SHEET TITLE CONSTRUCTION **DETAILS** 

**ANTENNA FRAME DETAIL** 







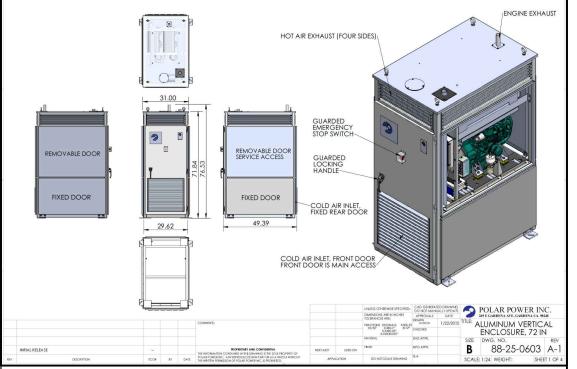



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SHEET TITLE CONSTRUCTION **DETAILS** 

SERVICE ACCESS FRONT DETAIL A SCALE 1:4 BOTTOM TYP ELECTRICAL PENETRATION POLAR POWER INC.
249 E GARDENA AVE, GARDENA CA 90248 LE ALUMINUM VERTICAL ENCLOSURE, 72 IN **B** 88-25-0603 A-1


INSTALLATION FOOTPRINT, BOTTOM VIEW

20kW POLAR DC GENERATOR DETAIL

ERICSSON RRH RRUS-4478 B14 18.1"X13.4"X8.26" DIMENSIONS, HXWXD:

WEIGHT, WITHOUT MOUNTING: 59.4 LBS. FREQ: 700

**CONNECTORS:** 4.3-10 FEMALE

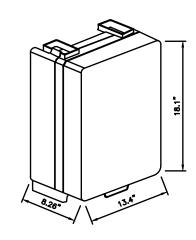


ISOMETRIC VIEW

### REMOTE RADIO HEAD DETAIL

ERICSSON RRH RRUS-4449 B5/B12 17.9"X13.19"X9.44" DIMENSIONS, HXWXD:

WEIGHT, WITHOUT MOUNTING: 71 LBS. 700/850 FREQ: CONNECTORS: 4.3-10 FEMALE

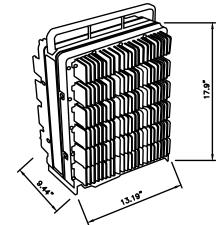


ISOMETRIC VIEW

### REMOTE RADIO HEAD DETAIL


ERICSSON RRH RRUS-8843 B2/B66


WEIGHT, WITHOUT MOUNTING: 72 LBS.

- GROUND EQUIPMENT AND MOUNTS PER MANUFACTURER RECOMMENDATIONS AND ATACT STANDARDS.
- CONFIRM REQUIRED EQUIPMENT WITH LATEST RFDS.

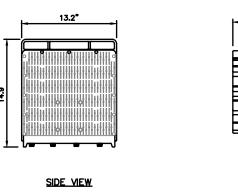



14.9"X13.2"X10.9"

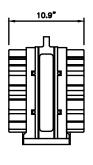

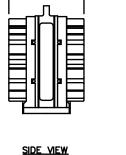

MANUFACTURER: ERICSSON MODEL NO.: AIR 6449 WEIGHT: 81.6 LBS BAND: MULTI-BAND POLARIZATION: DUAL FREQUENCIES: 3700-3980MHz

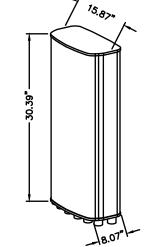

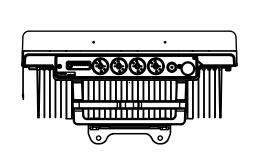

BOTTOM VIEW

ISOMETRIC VIEW

### **NOT USED**


**DUAL RRU MOUNT** 


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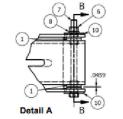
6

### Rosenberger Rosenberger Site Solutions, LLC **Product Installation**


# D220RRUDSM



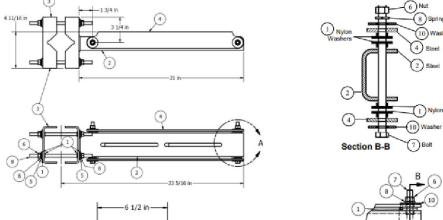

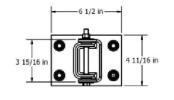

	PARTS LIST					
ITEM	QUANTITY PER BRACKET	TOTAL QUANTITY REQUIRED *	DESCRIPTION			
1	16	32	NYLON SHOULDER WASHER			
2	1	2	MOUNTING ARM WELDMENT			
3	1	2	BENT CLAMP PLATE			
4	1	2	SWIVEL MOUNT PLATE			
5	8	16	3/8" DIA. GALVANIZED WASHER			
6	10	20	3/8" DIA. GALVANIZED NUT			
7	2	4	3/8" DIA. X 5" LONG A-307 GRADE C GALVANIZED BOLT			
8	10	20	3/8" DIA. GALVANIZED SPRING WASHER			
9	4	8	3/8" DIA. X 8" LONG A-36 THREADED ROD			
10	12	24	3/8" DIA. F436 GALVANIZED WASHER			
* TWO BI	* TWO BRACKETS ARE REQUIRED TO SUPPORT (2) RRU ASSEMBLIES					

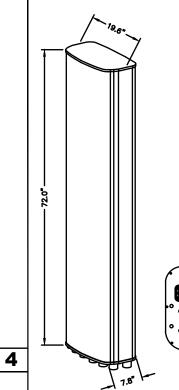

ISOMETRIC VIEW

**ANTENNA DETAIL** 

9.70"

MANUFACTURER: COMMSCOPE MODEL NO.: 82 LBS POLARIZATION: 1695-2360MHz CONNECTOR: 12 X 4.3-10 DIN-

RAYCAP DC9 OVER VOLTAGE PROTECTOR WITH DOME COVER

CLIP FOR ATTACHING DC6 (OVP)

RAYCAP SUPPLIED BASE ASSEMBLY

POWER CABLE INGRESS PORTS

RAYCAP SUPPLIED MOUNTING BRACKETS

DOME SECURING BAND

TO BASE ASSEMBLY (TYP)

CABLE TIE BAR



TILLMAN





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2

HEREBY CERTIFY THAT THESE PLANS WERE PREPARED BY ME OR UNDER MY DIRECT SUPERVISION AND THAT I AM A DULY REGISTERED ARCHITECT UNDER THE LAWS OF

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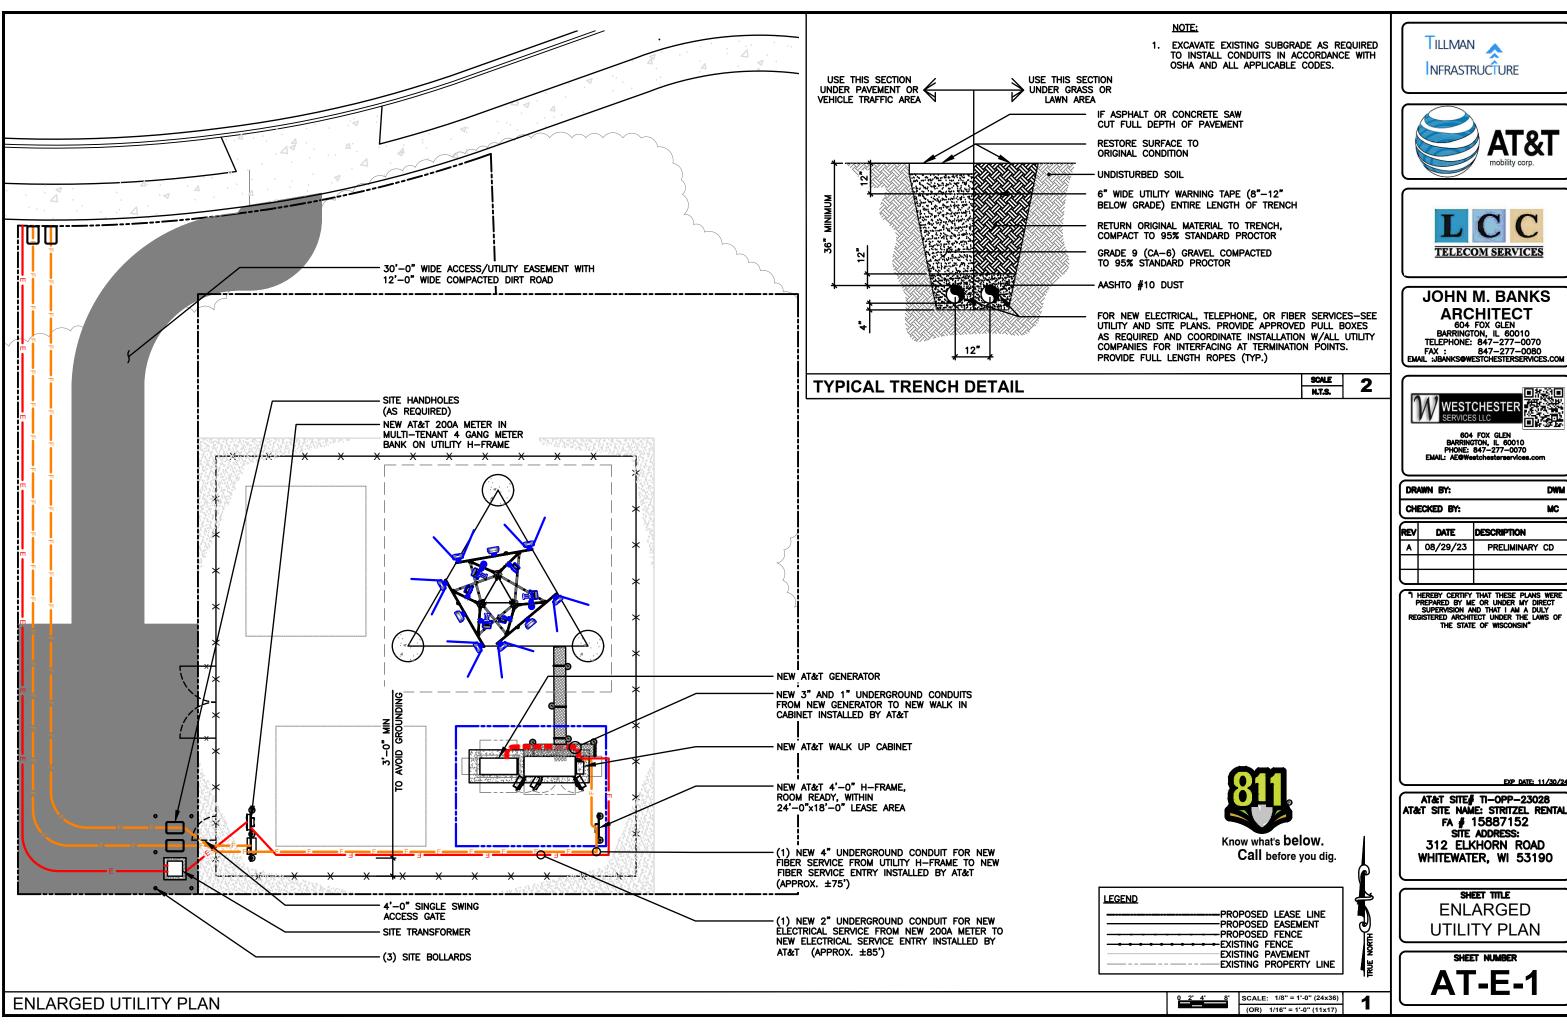
SHEET TITLE RRH, ANTENNA & EQUIPMENT SPECS

3 RAYCAP DC9-48-60-24-8C-EV (SQUID) 1

DUAL RRUS MOUNTING DETAIL

DIMENSIONS, HXWXD:

REMOTE RADIO HEAD DETAIL










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Α	08/29/23	PRELIMINARY CD

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BACK OF

METER BANK

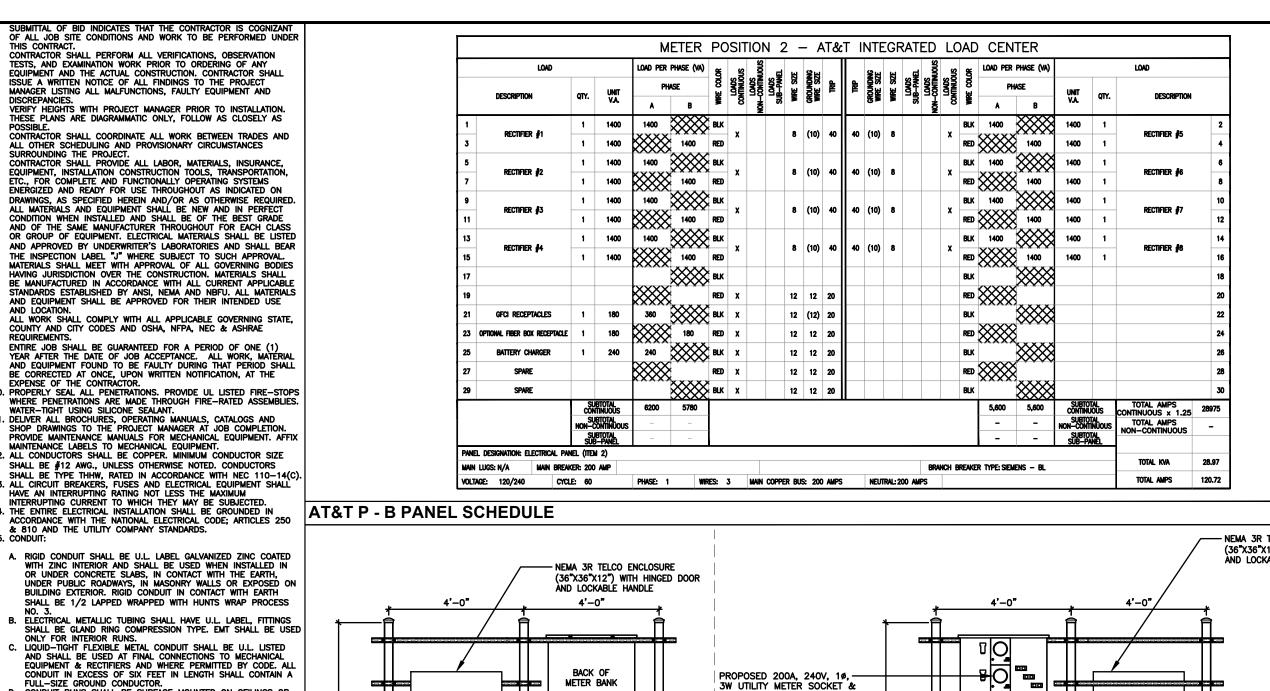4" CONDUIT W/(3) INNER DUCTS


3" CONDUIT W/(3) INNER DUCTS

FROM TELCO SERVICE DEMARC

TO CORNER EQUIPMENT (TYP)

BY OTHERS

BACK

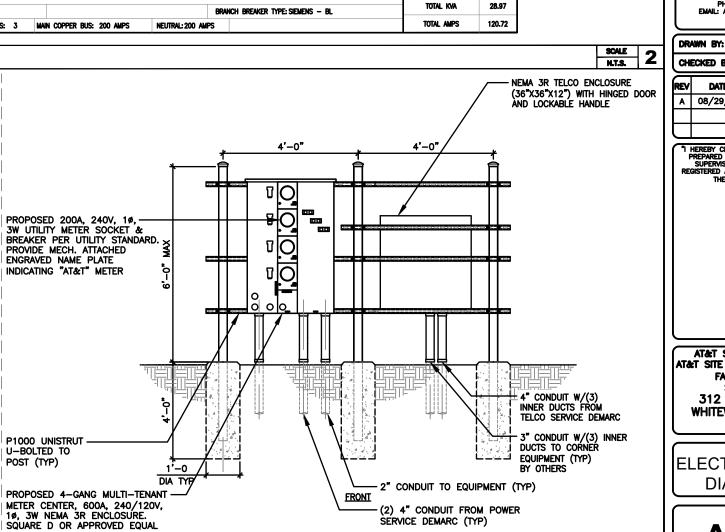







### JOHN M. BANKS **ARCHITECT**

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SHEET TITLE ELECTRICAL SCHD **DIA & NOTES** 

22. RED LINED AS-BUILT PLANS SHALL BE PROVIDED TO THE CONSTRUCTION MANAGER **ELECTRICAL NOTES** 

4 N.T.S.

DIA TYP

UTILITY FRAME DETAIL

SCALE N.T.S.

IS EXCEEDED, NOTIFY THE PROJECT MANAGER FOR FURTHER INSTRUCTION ON METHODS FOR REDUCING THE RESISTANCE VALUE. CLEAN PREMISES OF ALL DEBRIS RESULTING FROM WORK AND LEAVE WORK IN A COMPLETE AND UNDAMAGED CONDITION. LEGALLY DISPOSE OF ALL REMOVED, UNUSED AND EXCESS MATERIAL
GENERATED BY THE WORK OF THIS CONTRACT. DELIVER ITEMS
INDICATED ON THE DRAWINGS TO THE OWNER IN GOOD CONDITION.

OBTAIN SIGNED RECEIPT UPON DELIVERY.

D. COORDINATE WITH UTILITY COMPANY FOR CONNECTION OF TEMPORARY AND PERMANENT POWER TO THE SITE. THE TEMPORARY POWER AND ALL HOOKUP COSTS SHALL BE PAID BY THE

CONDUIT RUNS SHALL BE SURFACE MOUNTED ON CEILINGS OR WALLS UNLESS NOTED OTHERWISE. ALL CONDUIT SHALL RUN

PARALLEL OR PERPENDICULAR TO WALLS, FLOOR, CEILING, OR BEAMS. VERIFY EXACT ROUTING OF ALL EXPOSED CONDUIT WITH


BEAMS. VERTY EXACT ROUTING OF ALL EXPOSED CONDUIT WITH THE PROJECT MANAGER PRIOR TO INSTALLING.
PVC CONDUIT MAY BE PROVIDED ONLY WHERE SHOWN, OR IN UNDERGROUND INSTALLATIONS. PROVIDE UY-RESISTANT CONDUIT WHERE EXPOSED TO THE ATMOSPHERE. PROVIDE GROUND CONDUCTOR IN ALL PVC RUNS; EXCEPT WHERE PERMITTED BY

CODE TO OMIT.

ALL ELECTRICAL EQUIPMENT SHALL BE LABELED WITH PERMANENT ENGRAVED PLASTIC LABELS. BACKGROUND SHALL BE BLACK WITH WHITE LETTERS; EXCEPT AS REQUIRED BY CODE TO FOLLOW A

UPON COMPLETION OF WORK, CONDUCT CONTINUITY, SHORT CIRCUIT, AND FALL OF POTENTIAL GROUNDING TESTS FOR APPROVAL. SUBMIT TEST REPORTS TO PROJECT MANAGER. GROUNDING SYSTEM RESISTANCE SHALL NOT EXCEED 5 OHMS. IF THE RESISTANCE VALUE

VERIFY ALL EXISTING CIRCUITRY PRIOR TO REMOVAL AND NEW WORK.
MAINTAIN POWER TO ALL OTHER AREAS & CIRCUITS NOT SCHEDULED FOR REMOVAL.

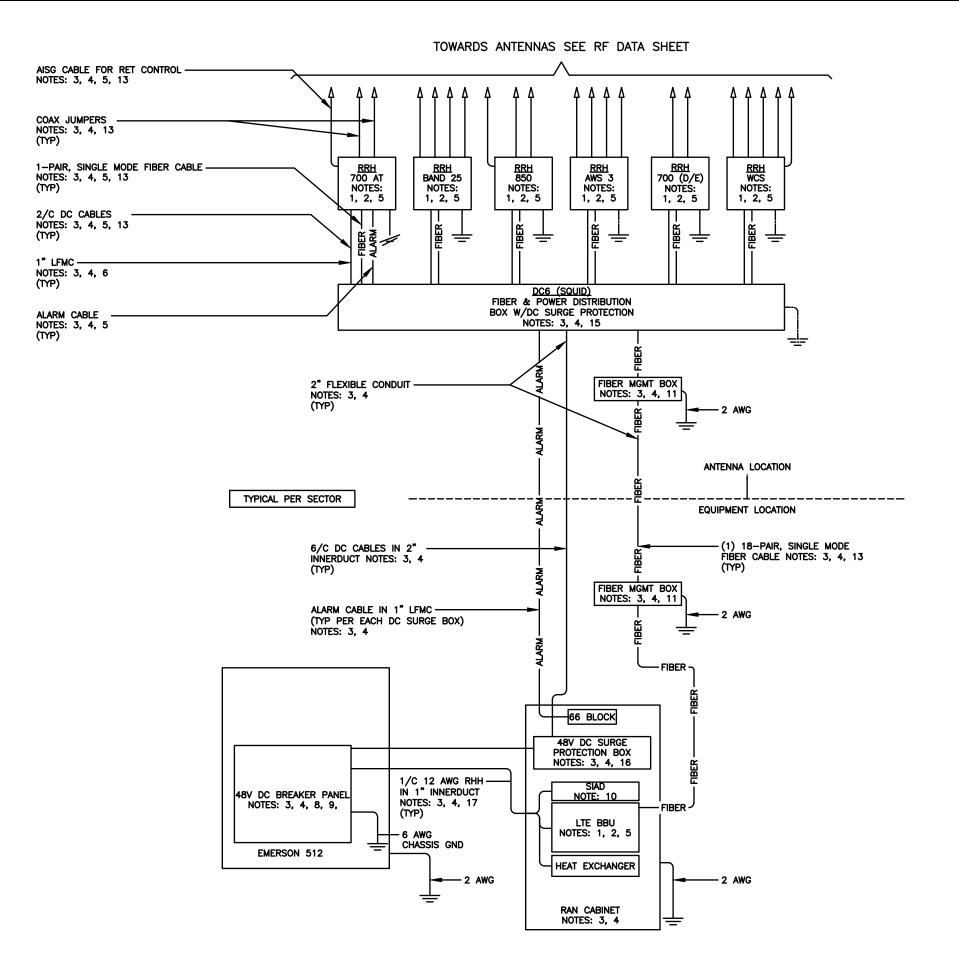

### NOTES:

- 1. FURNISHED BY OEM/AT&T.
- 2. INSTALLED BY OEM OR AS SCOPED BY MARKET.
- 3. FURNISHED BY OTHERS
- 4. INSTALLED BY OTHERS
- 5. FINAL CONNECTION BY OEM OR AS SCOPED BY MARKET.
- 6. OPEN END OF LFMC TO BE LEFT WEATHERPROOFED UNTIL
- 7. DELETED.
- 8. BREAKERS SPECIFIED SOLD SEPERATELY.
- 9. BREAKERS TO BE TAGGED AND LOCKED OUT.
- 10. SIAD IS FURNISHED AND INSTALLED BY OTHERS AND INCLUDES POWER CONNECTIONS AND FIBER TO THE UNIT OR AS SCOPED BY MARKET. INSTALL 10 AWG CHASSIS GROUND, PROVIDE (2) 10A BREAKERS FROM A 24V DC POWER SOURCE OR (2) 5A BREAKERS FROM A 48V DC POWER SOURCE AND CONNECT USING MFR POWER CABLE WITH SPECIAL CONNECTOR.
- 11.FIBER MANAGEMENT BOX IS J-SOURCE MODEL 12126FM4SEC.
- 12.LEC TO FURNISH AND INSTALL NETWORK INTERFACE DEVICE.
- 13.LEAVE COILED AND PROTECTED UNTIL TERMINATED.
- 14.SEE DETAIL 1408 FOR DC POWER CABLE SIZES.
- 15.FIBER AND POWER DISTRIBUTION BOX 4/48V SURGE SHALL BE RAYCAP MODEL DC6-48-60-18-8F.
- 16.POWER DISTRIBUTION W/DC SURGE PROTECTION BOX SHALL BE RAYCAP MODEL DC6-48-60-0-18.
- 17.SINGLE—CONDUCTOR DC POWER CABLES SHALL BE TELCOFLEX OR KS24194, COPPER, UL LISTED RHH NON—HALOGEN, LOW SMOKE WITH BRAIDED COVER, TYPE TC (1/O AND LARGER). UNLESS OTHERWISE NOTED, STRANDING SHALL BE CLASS B (TYPE III) FOR CABLES SIZES 14, 12 & 10 AWG AND CLASS 1 (TYPE IV) FOR SIZES 8 AWG AND LARGER. CABLES SHALL BE COLOR CODED RED FOR +24V, BLUE FOR —48V AND GRAY FOR 24V AND 48V RETURN CONDUCTORS. MULTI—CONDUCTOR DC POWER CABLES SHALL COPPER, CLASS B STRANDED WITH FLAME RETARDANT PVC JACKET, TYPE TC, UL LISTED FOR 90°C DRY/ 75°C WET INSTALLATION.
- 18.10A FUSE FOR HEAT EXCHANGER FURNISHED AND INSTALLED BY OTHERS.
- 19.DELETED
- 20.GROUNDING WIRES SHALL BE COPPER, GREEN THHN/THWN UL LISTED FOR 90°C DRY/75°C WET INSTALLATION. MINIMUM SIZE IS 6 AWG UNLESS NOTED OTHERWISE.
- 21.RET CONTROL FROM THE RRH IS AN OPTIONAL METHOD OF CONNECTION. REFER TO RF DATA SHEET FOR APPLICABILITY.
- 22.DELETED.
- 23.FIBER AND POWER DISTRIBUTION BOX 4/48V SURGE SHALL BE RAYCAP MODEL DC6-48-60-0-1E.
- 24.FIBER MANAGEMENT BOX IS COMMSCOPE MODEL FB 18188.
- 25.FIBER AND POWER DISTRIBUTION BOX 4/48V SURGE SHALL BE RAYCAP MODEL DC12-48-60-0-25E.







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EMAIL: AE@Westchesterservices.com

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DRAWN BY:

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EXP DATE: 11/30/

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WHITEWATER, WI 53190


SHEET TITLE
DC/FIBER SYSTEM
DIAGRAM


SHEET NUMBER

**DC/FIBER SYSTEM DIAGRAM** 

SCALE N.T.S.

| 1

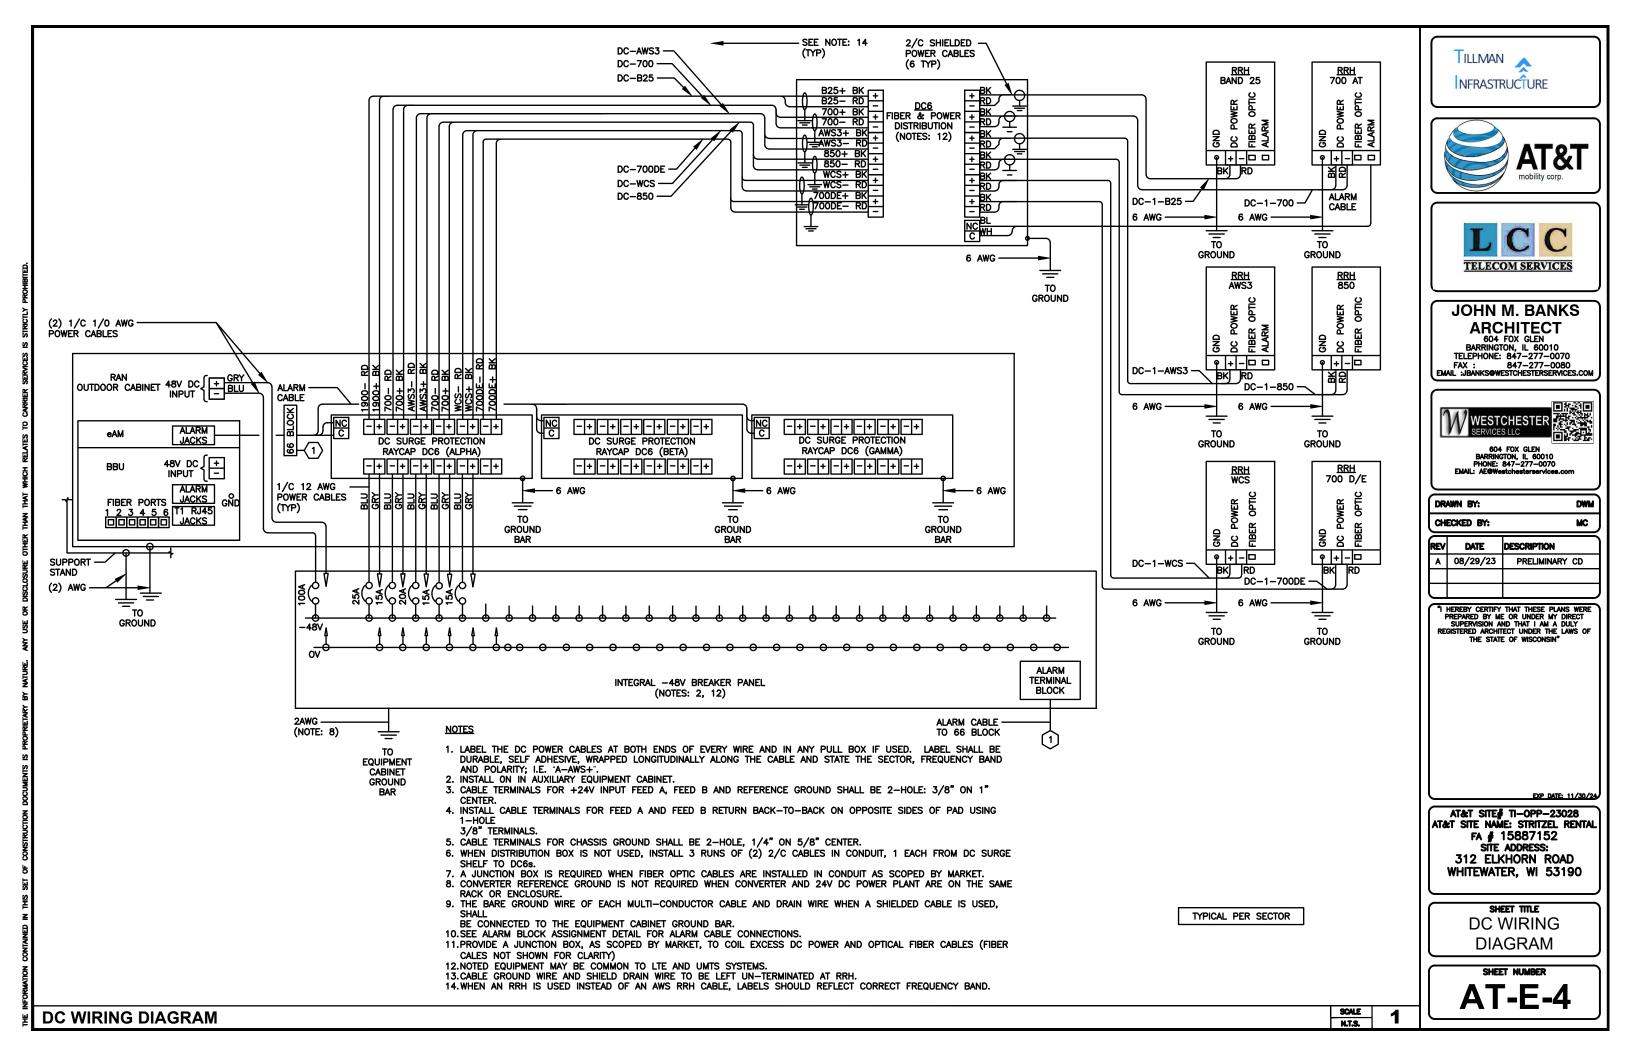

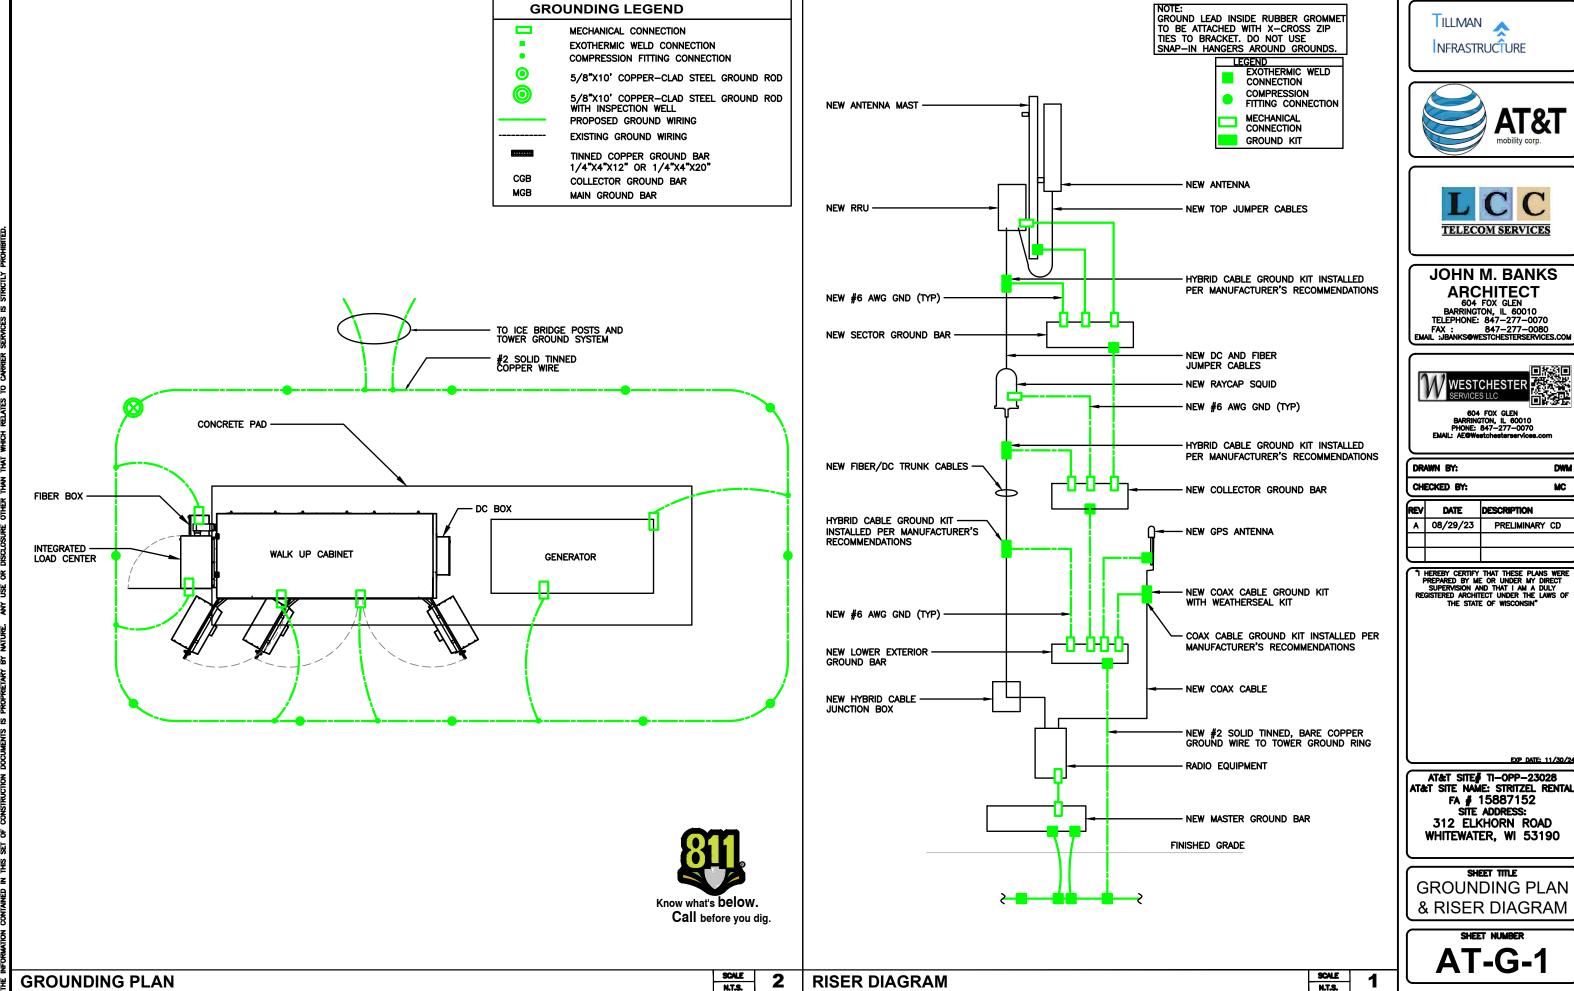









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**GROUNDING PLAN** & RISER DIAGRAM

#### GROUNDING NOTES:


- GROUNDING SHALL COMPLY WITH ARTICLE 250 OF THE NATIONAL ELECTRICAL CODE.
- ALL GROUNDING DEVICES SHALL BE U.L. APPROVED OR LISTED FOR THEIR INTENDED USE.
- ALL WIRES SHALL BE AWG THHN/THWN COPPER UNLESS NOTED OTHERWISE.
- GROUNDING CONNECTIONS TO GROUND RODS, GROUND RING WIRE, TOWER BASE AND FENCE POSTS SHALL BE EXOTHERMIC ("CADWELDS") UNLESS NOTED OTHERWISE. CLEAN SURFACES TO SHINY METAL. WHERE GROUND WIRES ARE CADWELDED TO GALVANIZED SURFACES, SPRAY CADWELD WITH GALVANIZING PAINT.
- GROUNDING CONNECTIONS TO GROUND BARS ARE TO BE TWO-HOLE BRASS MECHANICAL CONNECTORS WITH STAINLESS STEEL HARDWARE (INCLUDING SCREW SET) CLEAN GROUND BAR TO SHINY METAL. AFTER MECHANICAL CONNECTION, TREAT WITH PROTECTIVE
- GROUND COAXIAL CABLE SHIELDS AT BOTH ENDS WITH MANUFACTURER'S GROUNDING KITS.
- ROUTE GROUNDING CONDUCTORS THE SHORTEST AND STRAIGHTEST PATH POSSIBLE. BEND GROUNDING LEADS WITH A MINIMUM 12" RADIUS.
- INSTALL #2 AWG GREEN-INSULATED STRANDED WIRE FOR ABOVE GRADE GROUNDING AND #2 BARE TINNED COPPER WIRE FOR BELOW GRADE GROUNDING UNLESS OTHERWISE NOTED.
- REFER TO GROUNDING PLAN FOR GROUND BAR LOCATIONS. GROUNDING CONNECTIONS SHALL BE EXOTHERMIC TYPE ("CADWELDS") TO ANTENNA MOUNTS AND GROUND RING, REMAINING GROUNDING CONNECTIONS SHALL BE COMPRESSION FITTINGS.
  CONNECTIONS TO GROUND BARS SHALL BE MADE WITH TWO—HOLE
- 10. THE GROUND ELECTRODE SYSTEM SHALL CONSIST OF DRIVEN GROUND RODS POSITION ACCORDING TO GROUNDING PLAN. THE GROUND RODS SHALL BE 5/8"X10"-0" COPPER CLAD STEEL INTERCONNECTED WITH #2 BARE TINNED COPPER WIRE BURIED 36" BELOW GRADE. BURY GROUND RODS A MAXIMUM OF 15' APART, AND A MINIMUM OF 8' APART.
- IF ROCK IS ENCOUNTERED GROUND RODS SHALL BE PLACED AT AI OBLIQUE ANGLE NOT TO EXCEED 45°.
- 12. EXOTHERMIC WELDS SHALL BE MADE IN ACCORDANCE WITH ERICO PRODUCTS BULLETIN A-AT.
- 13. CONSTRUCTION OF GROUND RING AND CONNECTIONS TO EXISTING GROUND RING SYSTEM SHALL BE DOCUMENTED WITH PHOTOGRAPHS PRIOR TO BACKFILLING SITE. PROVIDE PHOTOS TO THE VERIZON WIRELESS CONSTRUCTION MANAGER.
- 4. ALL GROUND LEADS EXCEPT THOSE TO THE EQUIPMENT ARE TO BE #2 BARE TINNED COPPER WIRE. ALL EXTERIOR GROUND BARS TINNED COPPER.
- 5. PRIOR TO INSTALLING LUGS ON GROUND WIRES, APPLY THOMAS & BETTS KOPR-SHIELD (TM OF JET LUBE INC.). PRIOR TO BOLTING GROUND WIRE LUGS TO GROUND BARS, APPLY KOPR-SHIELD OR
- 16. ENGAGE AN INDEPENDENT ELECTRICAL TESTING FIRM TO TEST AND VERIFY THAT IMPEDANCE DOES NOT EXCEED FIVE OHMS TO GROUND BY MEANS OF "FALL OF POTENTIAL TEST". TEST SHALL BE WITNESSED BY A METROPCS REPRESENTATIVE, AND RECORDED ON THE "GROUND RESISTANCE TEST" FORM.
- WHERE BARE COPPER GROUND WIRES ARE ROUTED FROM ANY CONNECTION ABOVE GRADE TO GROUND RING, INSTALL WIRE IN 3/4" PVC SLEEVE, FROM 1' BELOW GRADE AND SEAL TOP WITH
- 8. PREPARE ALL BONDING SURFACES FOR GROUNDING CONNECTIONS BY REMOVING ALL PAINT AND CORROSION DOWN TO SHINY METAL FOLLOWING CONNECTION, APPLY APPROPRIATE ANTI-OXIDIZATION
- 9. ANY SITE WHERE THE EQUIPMENT (BTS, CABLE BRIDGE, PPC, GENERATOR, ETC.) IS LOCATED WITHIN 6 FEET OF METAL FENCING THE GROUND RING SHALL BE BONDED TO THE NEAREST FENCE POST USING (3) RUNS OF #2 BARE TINNED COPPER WIRE.


### CABLE COLOR CODING NOTES:


- SECTOR ORIENTATION/AZIMUTH WILL VARY FROM REGION AND IS SITE SPECIFIC. REFER TO RF REPORT FOR EACH SITE TO DETERMINE THE ANTENNA LOCATION AND FUNCTION OF EACH TOWER SECTOR FACE.
- THE ANTENNA SYSTEM CABLES SHALL BE LABELED WITH VINYL TAPE EXCEPT IN LOCATIONS WHERE ENVIRONMENTAL CONDITIONS CAUSE PHYSICAL DAMAGE, THEN PHYSICAL TAGS ARE PREFERRED.
- THE STANDARD IS BASED ON EIGHT COLORED TAPES RED, BLUE, GREEN, YELLOW, ORANGE, BROWN, WHITE & VIOLET. THESE TAPES MUST BE 3/4" WIDE & UV RESISTANT SUCH AS SCOTCH 35 VINYL ELECTRICAL COLOR CODING TAPE AND SHOULD BE READILY AVAILABLE TO THE ELECTRICIAN OR SUBCONTRACTOR ON SITE.
- USING COLOR BANDS ON THE CABLES, MARK ALL RF CABLES BY SECTOR AND NUMBER AS SHOWN ON "CABLE MARKING COLOR CONVENTION TABLE".
- WHEN AN EXISTING COAXIAL LINE THAT IS INTENDED TO BE A WHEN AN EXISTING COAXIAL LINE THAT IS INTENDED TO BE A SHARED LINE BETWEEN GSM/3G AND IS—136 TDMA IS ENCOUNTERED, THE SUBCONTRACTOR SHALL REMOVE THE EXISTING COLOR CODING SCHEME AND REPLACE IT WITH THE COLOR CODING AND TAGGING STANDARD THAT IS OUTLINED IN THE CURRENT VERSION OF ND—00027. IN THE ABSENCE OF AN EXISTING COLOR CODING TAGGING SCHEME, OR WHEN INSTALLING PROPOSED COAXIAL CABLES, THIS GUIDELINE SHALL BE IMPLEMENTED AT THAT SITE PEGARDIES OF TECHNOLOGY.
- all color code tape shall be 3m-35 and shall be a minimum or (3) wraps of tape and shall be neatly trimmed and smoothed out so as to avoid unrayeling.
- ALL COLOR BANDS INSTALLED AT THE TOP OF TOWER SHALL BE A MINIMUM OF  $3^{\ast}$  WIDE AND SHALL HAVE A MINIMUM OF  $3/4^{\ast}$  OF SPACE IN BETWEEN EACH COLOR.
- ALL COLOR CODES SHALL BE INSTALLED AS TO ALIGN NEATLY WITH ONE ANOTHER FROM SIDE TO SIDE.
- IF EXISTING CABLES AT THE SITE ALREADY HAVE A COLOR CODING SCHEME AND THEY ARE NOT INTENDED TO BE REUSED OR SHARED WITH THE GSM TECHNOLOGY, THE EXISTING COLOR CODING SCHEME

#### CABLE MARKING TAGS:

When using the alternative labeling method, each RF cable shall be identified with a metal id tag made of stainless steel or brass. The tag shall be  $1-1/2^{\circ}$  in diameter with  $1/4^{\circ}$  stamped letters and numbers indication the sector, antenna position and cable number. Id marking locations should be as per "cable marking locations table". The tag should be ATTACHED WITH CORROSION PROOF WIRE AROUND THE CABLE AT THE SAME LOCATION AS DEFINED ABOVE. THE TAG SHOULD BE LABELED AS SHOWN ON THE "GSM AND UMTS LINE TAG" DETAIL.

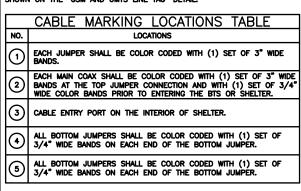

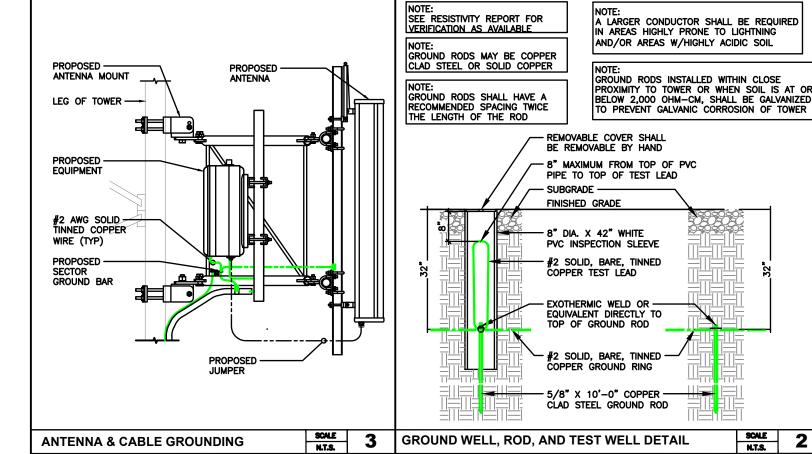

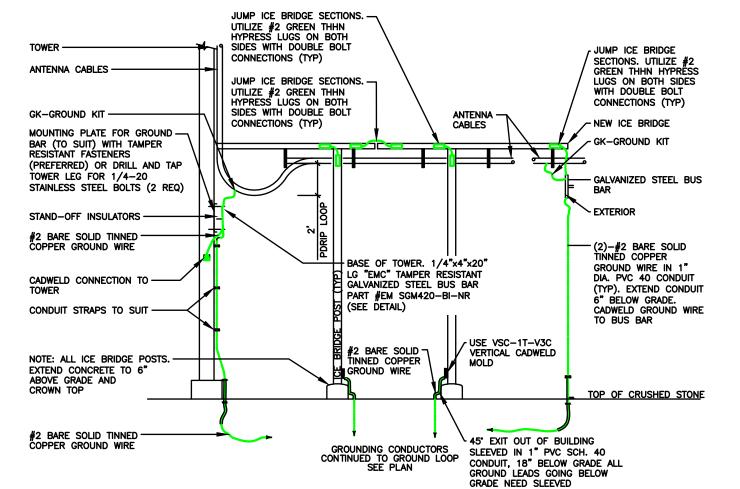







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**DWM** CHECKED BY: MC REV DATE DESCRIPTION 08/29/23 PRELIMINARY CD

DRAWN BY:

SCALE

N.T.S.

SCALE

N.T.S.

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THEREBY CERTIFY THAT THESE PLANS WERE PREPARED BY ME OR UNDER MY DIRECT SUPERMISION AND THAT I AM A DULY REGISTERED ARCHITECT UNDER THE LAWS OF THE STATE OF WISCONSIN

AT&T SITE# TI-OPP-23028 AT&T SITE NAME: STRITZEL RENTAL FA # 15887152 SITE ADDRESS: 312 ELKHORN ROAD WHITEWATER, WI 53190

SHEET TITLE **GROUNDING** DETAILS & NOTES

SCALE SCALE **CABLE COLOR CODING NOTES** GROUNDING NOTES **COAXIAL GROUNDING AT ICE BRIDGE**