
PRELIMINARY SITE PLAN LASTING IMPRESSIONS

PART OF SECTION 1, T3N, R8E, WHITE LAKE TOWNSHIP, OAKLAND COUNTY, MICHIGAN

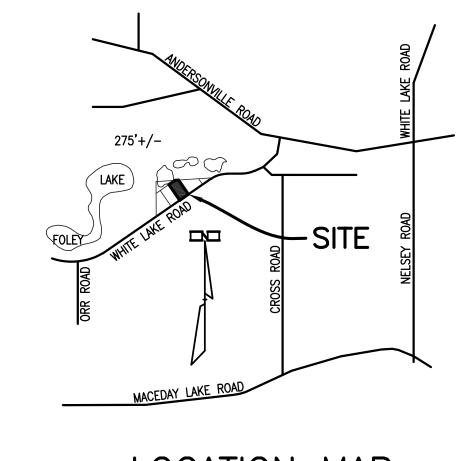

LOCATION MAP

SCALE: 1" = 2000'



SHEET INDEX

GO.01 COVER SHEET

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C1.21 PRELIMINARY GRADING PLA

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A2.0 NEW FIRST FLOOR PLAN

A3.0 NEW ELEVATIONS
A3.1 NEW ELEVATIONS
A4.0 WALL SECTION

WHITE LAKE TOWNSHIP STANDARD SITE CONSTRUCTION NOTES:

1. ALL CONSTRUCTION SHALL BE IN ACCORDANCE WITH THE CURRENT STANDARDS AND SPECIFICATIONS OF WHITE LAKE CHARTER TOWNSHIP.

- 2. THE DEVELOPER SHALL CONTACT THE TOWNSHIP PLANNING DEPARTMENT, AT (248) 698-3300, TO SCHEDULE A PRE-CONSTRUCTION MEETING. THE DEVELOPER'S PRIME SITE CONTRACTOR SHALL ATTEND. A COPY OF ALL PERMITS MUST BE SUBMITTED TO THE PLANNING DEPARTMENT PRIOR TO SCHEDULING THE MEETING.
- THE CONTRACTOR SHALL CONTACT THE TOWNSHIP ENGINEER, AT (248) 681-7800, 48 HOURS PRIOR TO THE BEGINNING OF CONSTRUCTION. THE CONTRACTOR SHALL KEEP THE INSPECTOR APPRAISED OF THE NEED FOR INSPECTION ON A DAY BY DAY BASIS. LACKING SPECIFIC SCHEDULING WITH THE INSPECTOR, THE CONTRACTOR SHALL GIVE 48 HOURS NOTICE TO THE TOWNSHIP ENGINEER PRIOR TO RE-COMMENCING WORK REQUIRING INSPECTION. FAILURE TO INFORM THE INSPECTOR OR THE TOWNSHIP ENGINEER OF A WORK CANCELLATION MAY RESULT IN A ONE HALF DAY INSPECTION CHARGE TO THE DEVELOPER. THE CONTRACTOR SHALL CALL (248) 844-5400 TO SCHEDULE SANITARY SEWER MAIN LINE INSPECTION.
- 4. ALL WATER MAIN OR SANITARY SEWER WORK WILL REQUIRE FULL TIME INSPECTION. FULL TIME INSPECTION WILL GENERALLY BE REQUIRED FOR UNDERGROUND STORM SEWER CONSTRUCTION, CONCRETE CURBING, AND PAVING OPERATIONS. SITE GRADING AND DETENTION BASIN CONSTRUCTION WILL GENERALLY BE INSPECTED ON AN INTERMITTENT BASIS.
- 5. THE CONTRACTOR SHALL CONTACT MISS DIG, AT (800) 482-7171, 72 HOURS IN ADVANCE OF CONSTRUCTION TO HAVE EXISTING UNDERGROUND FACILITIES LOCATED. CONTRACTOR SHALL CONTACT THE WHITE LAKE TOWNSHIP WATER DEPARTMENT, AT (248) 698-3300 EXT 165, SEPARATELY 72 HOURS IN ADVANCE OF CONSTRUCTION TO HAVE WATER UTILITIES LOCATED.
- 6. ALL OFF—SITE IMPROVEMENTS WILL BECOME PUBLIC PROPERTY.

	REVISION INDEX															
			SHEET NUMBERS													
RE	/. DESCRIPTION	DATE	CO.01	V1.01	CO.01	C1.01	C1.02	C1.21	C1.31	C5.01	C1.02					
C	SURVEY ISSUED	07/19/2023		X												
1	OWNER REVIEW	10/03/2023				X										
2	PRE-APP MEETING	11/13/2023				X										
3	FIRE SAFETY	11/29/2023				X										
4	PRELIMINARY SITE PLAN	04/19/2024	X		X	X	X		X	X	X					
5	PSP REV. 1	06/21/2024	X	X	X	X	X	X	X							

APPROVALS

N.P.D.E.S. NOTICE TO COVER

DESCRI

WHITE LAKE TOWNSHIP — PLANNING & ENGINEERING
WHITE LAKE TOWNSHIP — PLANNING COMMISSION
WHITE LAKE TOWNSHIP — TOWNSHIP BOARD
WHITE LAKE TOWNSHIP — ZONING BOARD OF APPEALS
WHITE LAKE TOWNSHIP — PLANNING COMMISSION
WHITE LAKE TOWNSHIP — DLZ

WHITE LAKE TOWNSHIP — BUILDING DEPARTMENT
WHITE LAKE TOWNSHIP — COMMUNITY DEVELOPMENT DIRECTOR
OAKLAND COUNTY — WATER RESOURCE COMMISSIONER

OAKLAND COUNTY — WATER RESOURCE COUNTY — HEALTH DIVISION
OAKLAND COUNTY — HEALTH DIVISION
STATE OF MICHIGAN — EGLE

AGENCY

DESCRIPTION

PRE-APPLICATION MEETING

PRELIMINARY SITE PLAN APPROVAL & SPECIAL LAND USE

PRELIMINARY SITE PLAN APPROVAL

VARIANCE REQUESTS

FINAL SITE PLAN APPROVAL

ENGINEERING APPROVAL

FENCE PERMIT

SIGN PERMIT

PART 91 SESC PERMIT

ONSITE SEWAGE DISPOSAL SYSTEM (SEPTIC) PERMIT

TYPE III DRINKING WATER WELL PERMIT

NOT REQUIRED FOR DISTURBANCE < 5 ACRES

PROPRIETOR

HOPSON HOLDINGS, LLC
2255 PORTER ROAD
WHITE LAKE, MI 48386
PH: (248) 830-2828
CONTACT: NICHOLAS HOPSON
EMAIL: LASTINGIMPRESSIONSLANDSCAPE@YAHOO.COM

ARCHITECT

J&A ARCHITECTURAL ENGINEERING 3250 W. BIG BEAVER RD., STE. 510 TROY, MI 48084 PH: (248) 282-6475 CONTACT: JAY NOONAN, R.A. EMAIL: JNOONAN@JAARCHENG.COM

ENGINEER & SURVEYOR

KIEFT ENGINEERING, INC. 5852 S. MAIN ST., STE. 1 CLARKSTON, MI 48346 PH:(248) 884-8224 CONTACT: CASEY LEACH, P.E. EMAIL: CLEACH@KIEFTENG.COM

CASEY LEACH SOFESS



KIEFT ENGINEERING, INC.

PROFESSIONAL ENGINEERS AND PROFESSIONAL SURVEYORS
5852 SOUTH MAIN STREET, SUITE 1, CLARKSTON, MICHIGAN 48346
PHONE (248) 625-5251 www.kiefteng.com FAX (248) 625-7

DATE: 04/01/24	CKD. BY	DATE	
DRAWN: CL	CL	04/01/24	
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SECTION: 1	T- 3 -N.	R- 8 -E.	9
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72 HOURS
(3 WORKING DAYS) |
BEFORE YOU DIG
CALL MISS DIG
800-482-7171
(TOLL FREE)

EXPIRATION

COVER SHEET
LASTING IMPRESSIONS


PART OF THE NORTH 1/2 OF SECTION 1, T3N, R8E, WHITE LAKE TOWNSHIP, OAKLAND COUNTY, MICHIGAN

SCALE: AS SHOWN

SHEET NO: G0.01

KE 2023.104

STING IMPRESSIONS

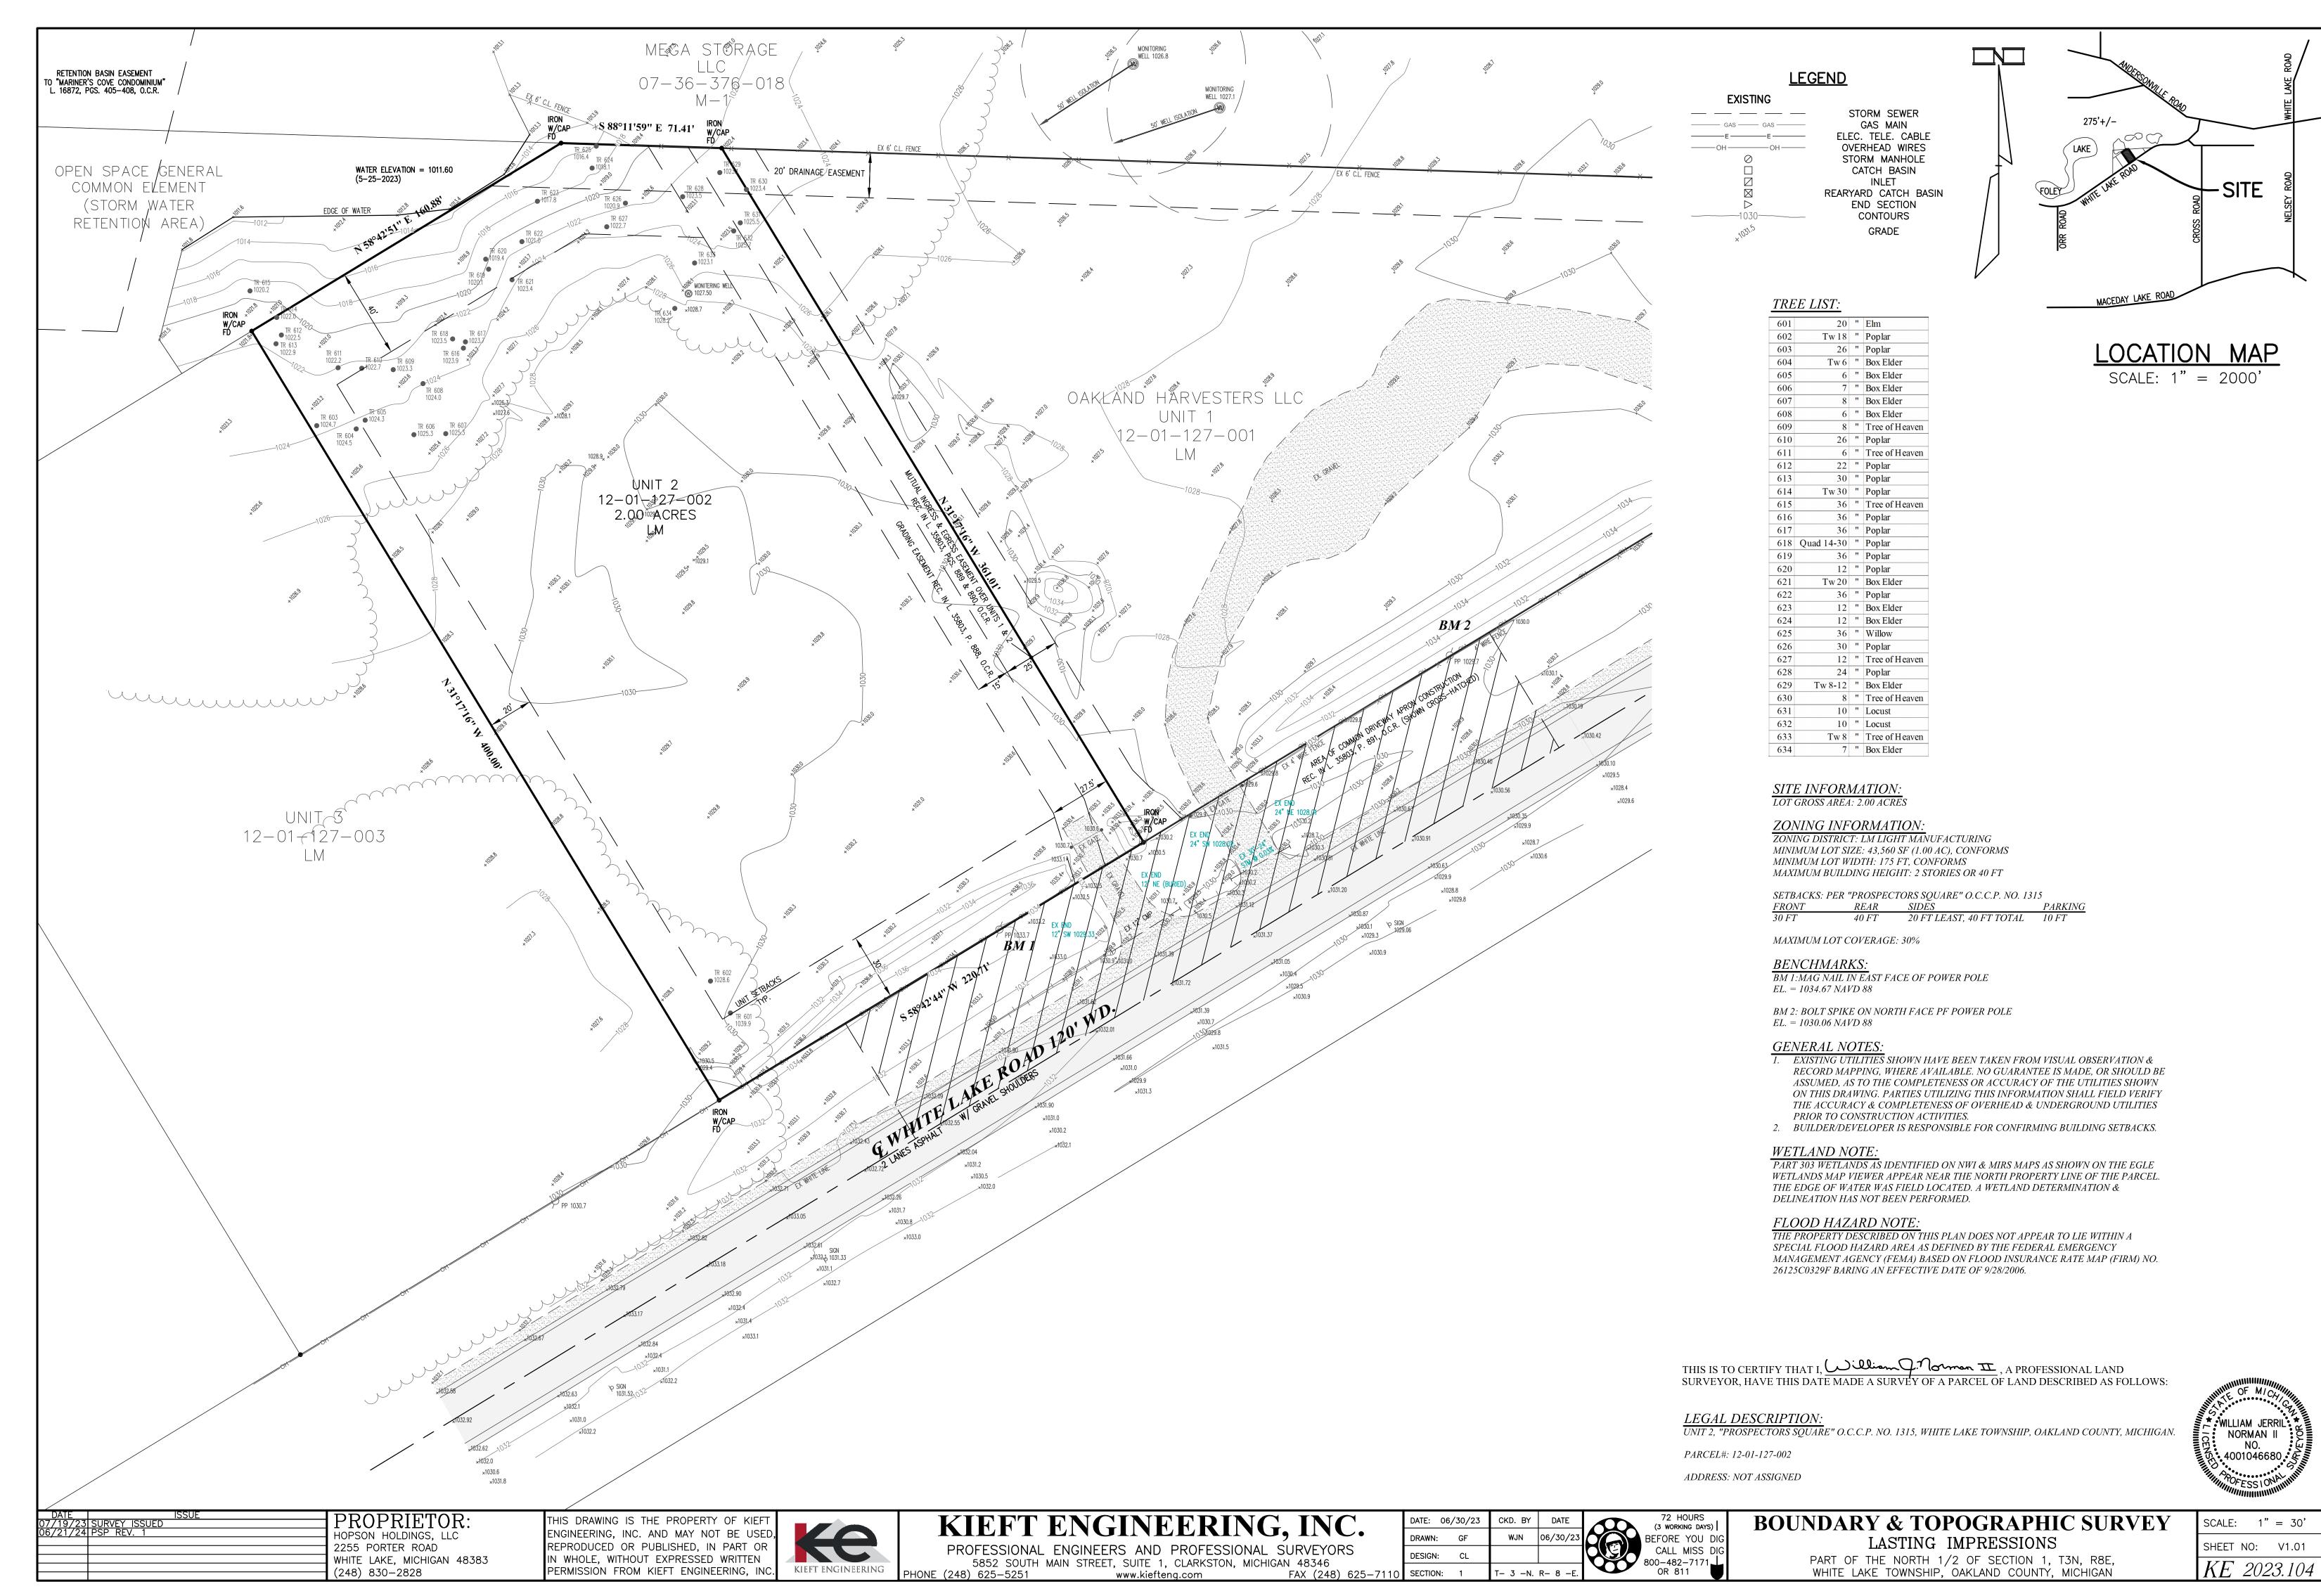

LASTING IMPRESSIONS

- 2. CONTRACTOR TO FURNISH ALL NECESSARY LABOR, MATERIAL, EQUIPMENT & FACILITIES TO FURNISH, FABRICATE & PERFORM THE REQUIRED CIVIL WORK.
- 3. ANY EXISTING CONSTRUCTION TO BE MODIFIED AS A PART OF THIS CONTRACT SHALL BE REBUILT
- 4. EXISTING CONSTRUCTION NOT UNDERGOING ALTERATION IS TO REMAIN UNDISTURBED. WHERE SUCH CONSTRUCTION IS DISTURBED AS A RESULT OF THE OPERATIONS OF THIS CONTRACT, THE EXISTING CONSTRUCTION SHALL BE REPAIRED OR REPLACED BY THE CONTRACTOR AS REQUIRED & TO THE SATISFACTION OF THE OWNER/ENGINEER.
- 5. ALL WORK SHOWN ON THESE DRAWINGS MAY BE CHECKED BY AN INDEPENDENT TESTING AGENCY RETAINED BY OWNER TO ENSURE COMPLIANCE WITH THE REQUIREMENTS SHOWN ON THE DRAWINGS. THE CONTRACTOR SHALL PROVIDE ACCESS AS REQUIRED FOR TESTING PURPOSES.
- 6. CONTRACTOR SHALL MAKE ALL NECESSARY FIELD VISITS FOR INSPECTION, MEASUREMENTS & VERIFICATION OF EXISTING CONDITIONS.
- 7. THE GENERAL CIVIL NOTES ARE INTENDED TO AUGMENT THE DRAWINGS & SPECIFICATIONS. SHOULD CONFLICTS EXIST BETWEEN THE DRAWINGS, SPECIFICATION, &/OR THE GENERAL CIVIL NOTES, THE STRICTEST PROVISION AS DETERMINED BY THE ENGINEER SHALL GOVERN.
- 8. WORK THE CIVIL DRAWINGS IN CONJUNCTION WITH ANY ARCHITECTURAL, STRUCTURAL, MECHANICAL, PLUMBING, LANDSCAPING, & ELECTRICAL DRAWINGS.
- ALL WORK SHALL CONFORM TO APPLICABLE STATE & LOCAL CODES.

AS REQUIRED TO THE SATISFACTION OF THE OWNER/ENGINEER.

- 11. THE CONTRACTOR SHALL COMPLY WITH THE CONSTRUCTION SAFETY STANDARDS & THE OCCUPATIONAL SAFETY STANDARDS (OSHA) AS ISSUED BY THE U.S. DEPARTMENT OF LABOR & THE MICHIGAN DEPARTMENT OF LABOR (MIOSHA).
- 12. MATERIALS & WORKMANSHIP SHALL COMPLY WITH APPLICABLE CODES, SPECIFICATIONS, LOCAL ORDINANCES, INDUSTRY STANDARDS, & UTILITY COMPANY REGULATIONS.
- 13. THE CONTRACTOR SHALL FAMILIARIZE THEMSELVES WITH ALL THE EXISTING CONDITIONS AT THE SITE INCLUDING UTILITIES, SERVICES, ETC. & SHALL BE FULLY RESPONSIBLE FOR ANY DAMAGES THEY CAUSE TO BOTH EXISTING, NEW CONSTRUCTION, PROPERTY & ANY UNAUTHORIZED DISRUPTION TO ADJACENT OWNERS NORMAL USE OF UTILITIES, SERVICES, & THE SURROUNDING FACILITIES.
- 14. THE CONTRACTOR SHALL OBTAIN AUTHORIZATION PRIOR TO MAKING CHANGES TO, OR INTERRUPTIONS OF UTILITIES & SHALL COMPLY WITH SPECIAL INSTRUCTIONS FROM THE OWNER TO MINIMIZE THE EFFECT ON THEIR OPERATIONS. PRIOR TO ANY EXCAVATION, EARTH MOVING WORK OR REMOVAL OF ANY PIPE FROM SERVICE, THE CONTRACTOR SHALL REVIEW WITH THE OWNER'S REPRESENTATIVE THE LOCATION OF THE UNDERGROUND UTILITIES, SERVICE & STRUCTURES IN THE AREA WHERE THE WORK IS BEING PERFORMED. PROVIDE FULL TIME SUPERVISION DURING ALL EXCAVATION & EARTH MOVING OPERATIONS & TAKE ALL RESPONSIBLE PRECAUTIONS TO PROTECT EXISTING UTILITIES, SERVICES & OPERATIONS FROM DAMAGE OR DISRUPTION.
- 15. PROVIDE BARRIER PROTECTION FOR VEHICULAR & PEDESTRIAN TRAFFIC AT EXCAVATIONS. TEMPORARY FENCING, BARRICADING & PEDESTRIAN ROUTING SHALL BE COORDINATED WITH & APPROVED BY THE OWNER'S REPRESENTATIVE PRIOR TO CONSTRUCTION.
- 16. FOR PROTECTION OF UNDERGROUND UTILITIES THE CONTRACTOR SHALL CALL "MISS DIG" AT 800-482-7171 OR 811, A MINIMUM OF THREE DAYS PRIOR TO EXCAVATION ON THE SITE. ALL "MISS DIG" PARTICIPATING MEMBERS WILL THUS ROUTINELY BE NOTIFIED. THIS DOES NOT RELIEVE THE CONTRACTOR OF NOTIFYING UTILITY OWNER'S WHO MAY NOT BE A PART OF THE "MISS DIG" ALERT SYSTEM.
- 17. DISPOSE OF ALL EXCAVATED SOILS & WASTE MATERIALS (NEW & EXISTING) OFF SITE IN A LEGAL
- 18. PERFORM FINAL CLEANUP OF WORK AREAS TO THE SATISFACTION OF THE OWNER.

CONTROL

- TOPOGRAPHIC INFORMATION: EXISTING INFORMATION IS BASED ON A TOPOGRAPHIC SURVEY BY KIEFT ENGINEERING, INC. DATED JULY 19, 2023, SUPPLEMENTED BY RECORD DRAWINGS & FIELD OBSERVATIONS.
- 2. VERTICAL CONTROL: ELEVATIONS SHOWN ARE BASED ON NAVD 88 DATUM. THE BENCH MARKS USED ARE SHOWN ON THE TOPOGRAPHIC SURVEY.
- 5. LAYOUT: LOCATE NEW CONSTRUCTION BY MEASUREMENTS FROM CONNECTING AREAS OF EXISTING BUILDINGS, & ENGAGE THE SERVICES OF A PROFESSIONAL SURVEYOR TO ASSIST IN LAYOUT, & CONSTRUCTION STAKING. CONFIRM HORIZONTAL & VERTICAL CONTROL POINTS PRIOR TO CONSTRUCTION.

CLEARING, GRUBBING, & EARTHWORK

- AT THE START OF EARTHWORK OPERATIONS, ALL SURFACE VEGETATION SHALL BE CLEARED & THE EXISTING TOPSOIL & ANY OTHER ORGANIC SOILS SHALL BE REMOVED IN THEIR ENTIRETY FROM BELOW THE PROPOSED BUILDING & PAVEMENT AREAS. EXISTING RANDOM CONCRETE & OTHER DEBRIS SHALL BE REMOVED FROM WITHIN THE BUILDING AREA. REMOVE STUMPS TO 12 INCHES BELOW FINAL GRADE IN FUTURE LAWN AREAS, & REMOVE STUMPS ENTIRELY FROM FUTURE PAVED & BUILDING AREAS. DISPOSE OF VEGETATIVE MATTER & DEBRIS OFFSITE.
- 2. ALL COMPACTED SUBGRADE SHALL BE THOROUGHLY PROOF—ROLLED WITH A HEAVY RUBBER-TIRED VEHICLE SUCH AS A LOADED SCRAPER OR LOADED DUMP TRUCK. ANY AREAS THAT EXHIBIT EXCESSIVE PUMPING & YIELDING DURING PROOF-ROLLING SHALL BE STABILIZED BY AERATION, DRYING & COMPACTION IF WEATHER CONDITIONS ARE FAVORABLE, OR REMOVAL & REPLACEMENT WITH ENGINEERED FILL. ALL COMPACTED SUBGRADE SHALL BE COMPACTED TO 95% OF ITS MAXIMUM DENSITY AS DETERMINED BY THE MODIFIED PROCTOR METHODS (ASTM D-1557).
- 3. ALL EXCAVATIONS ARE SUBJECT TO THE APPROVAL OF THE OWNER'S REPRESENTATIVE WHO SHALL BE CONSULTED WHEN POOR SOIL, WATER, OBSTRUCTIONS, PIPING, EXISTING FOOTINGS, EXCAVATIONS, ETC., ARE ENCOUNTERED.
- CONTRACTOR SHALL FURNISH ALL REQUIRED DEWATERING EQUIPMENT TO MAINTAIN A DRY EXCAVATION UNTIL BACKFILL IS COMPLETE.
- 5. MATERIAL FOR BACKFILL OR ENGINEERED FILL REQUIRED TO ACHIEVE DESIGN GRADES SHOULD CONSIST OF NON-ORGANIC SOILS. THE ON-SITE SOILS THAT ARE FREE OF ORGANIC MATTER & DEBRIS MAY BE USED FOR ENGINEERED FILL WITH ENGINEER'S APPROVAL.
- 5. BACKFILL MATERIAL SHALL BE COMPACTED TO 95% OF ITS MAXIMUM DENSITY AS DETERMINED BY ASTM D-1557, IN LIFTS NOT EXCEEDING 8-INCHES IN LOOSE THICKNESS.
- FROZEN MATERIAL SHALL NOT BE USED AS FILL, NOR SHALL FILL BE PLACED ON FROZEN SUB-GRADE.

CLEARING, GRUBBING & EARTHWORK CONT.

EARTH BANKS 4:1 OR FLATTER.

AS PAVEMENTS & WALKS.

- 8. DO NOT PLACE BACKFILL AGAINST FOUNDATION WALLS UNTIL FIRST FLOOR LEVEL SLABS ARE IN PLACE & HAVE REACHED 75% OF THEIR SPECIFIED DESIGN STRENGTH. SHORE & BRACE WALLS AS REQUIRED IF BACKFILLING OPERATIONS ARE TO BE CARRIED OUT PRIOR TO PLACEMENT OF FLOOR
- 9. PLACE BACKFILL AGAINST BOTH SIDES OF GRADE BEAMS & FOUNDATIONS AT EQUAL ELEVATIONS OF FILL, EXCEPT AS SHOWN ON THE DRAWINGS.
- 10. CONSTRUCTION DRAINAGE: STORM WATER ACCUMULATED IN THE PROJECT SITE EXCAVATIONS IS TO DRAIN BY NATURAL PERCOLATION. PROVIDE PUMPING ONLY AS NECESSARY.
- 11. SLOPE SMOOTHLY BETWEEN INDICATED ELEVATIONS TO ACHIEVE POSITIVE DRAINAGE. SLOPE ALL
- 12. NEW GRADES SHOWN ARE FINISHED GRADES & INCLUDES TOP OF TOPSOIL OR SURFACES SUCH
- 13. PROVIDE 6 INCHES OF TOPSOIL, SEED, & MULCH AT DISTURBED LAWN AREAS, EXCEPT AS NOTED
- 14. TREES: TREES NOT INDICATED TO BE REMOVED OR TRANSPLANTED SHALL BE FENCED OFF WITH 4'
- 15. GREAT CARE SHALL BE TAKEN BY CONTRACTORS TO AVOID DAMAGE TO VEGETATION OUTSIDE THE LIMITS OF CONSTRUCTION & TO KEEP THE CONSTRUCTION AREAS TO A MINIMUM. DRIVING SHALL
- 16. 17. TOPSOIL (REUSE EXISTING), SEED, FERTILIZE & MULCH LAWN AREAS DISTURBED BY NEW CONSTRUCTION. SEE LANDSCAPING PLANS FOR NEW LAWN SPECIES.

HIGH ORANGE CONSTRUCTION FENCE 10' FROM THE DRIP LINE OF THE TREE.

NOT BE PERMITTED OUTSIDE THE LIMITS OF CONSTRUCTION.

1. MINIMUM COVER OF UNDERGROUND UTILITIES:

NATURAL GAS 2.5 FT SANITARY SEWERS 4.0 FT STORM SEWER 3.5 FT

PRESSURE UTILITIES MAY BE LAID APPROXIMATELY PARALLEL TO FINISH GRADE WITH NO HIGH POINTS, EXCEPT AS INDICATED, WITH LOCAL DEEPENING TO AVOID OTHER UTILITIES OR OBSTRUCTIONS. MAINTAIN COVER BELOW DITCHES & SURFACE DEPRESSIONS. PROVIDE TEMPORARY PROTECTION AS REQUIRED UNTIL COVER IS COMPLETED. INFORM OWNER'S REPRESENTATIVE IF AVAILABLE COVER, AT INDICATED ELEVATIONS, IS LESS THAN MINIMUM. VERTICAL CLEARANCE FOR ALL PIPES SHALL BE 18" MINIMUM FROM THE OUTSIDE OF PIPE.

- 2. EXISTING UTILITIES: INFORMATION HAS BEEN OBTAINED FROM EXISTING AVAILABLE DRAWINGS & SURFACE FEATURES SHOWN ON THE TOPOGRAPHIC SURVEY. VERIFY THE INFORMATION BEFORE CONSTRUCTION. NOTIFY THE OWNER'S REPRESENTATIVE OF DISCREPANCIES OR INTERFERENCES.
- 3. EXISTING UNDERGROUND ELECTRICAL LINES: THE CONTRACTOR SHALL BE RESPONSIBLE TO TRACE, FLAG, & MARK ALL UNDERGROUND ELECTRICAL LINES IN THE VICINITY OF THE AREA OF WORK PRIOR TO BEGINNING ANY DEMOLITION, EARTH MOVING, OR EXCAVATION. ALL BUILDING & UNDERGROUND STRUCTURES, ELECTRICAL MANHOLES, HAND HOLES, LIGHTS, PARKING METERS, GATES, SIGNS, MONUMENTS, & ALL OTHER SITE ITEMS THAT CAN REASONABLY BE OBSERVED FROM THE SURFACE SHALL BE INVESTIGATED TO DETERMINE THE PRESENCE OF ELECTRICAL LINES. THE CONTRACTOR SHALL BE RESPONSIBLE TO REPAIR OR REPLACE ANY ELECTRICAL LINES DAMAGED DUE TO CONTRACT OPERATIONS TO THE SATISFACTION OF THE ENGINEER AT NO ADDITIONAL COST TO THE OWNER.
- 4. THE LOCATIONS & ELEVATIONS OF EXISTING UNDERGROUND UTILITIES AS SHOWN ON THESE DRAWINGS ARE ONLY APPROXIMATE. NO GUARANTEE IS EITHER EXPRESSED OR IMPLIED AS TO THE COMPLETENESS OR ACCURACY THEREOF. THE CONTRACTOR SHALL BE EXCLUSIVELY RESPONSIBLE FOR DETERMINING THE EXACT UTILITY LOCATIONS & ELEVATIONS PRIOR TO THE START OF CONSTRUCTION.
- 5. PRIOR TO CONSTRUCTION, EXISTING UTILITIES AT PROPOSED CONNECTIONS & CROSSINGS SHALL BE FIELD EXCAVATED TO VERIFY LOCATIONS, ELEVATION & SIZE. THE OWNER'S REPRESENTATIVE MAY CONFIRM, ADJUST OR REVISE DESIGN ELEVATIONS OF THE PROPOSED UTILITIES.
- UNDERDRAIN: PROVIDE TYPICAL UNDERDRAIN UNDER PAVEMENT AT NEW CATCH BASINS, INLETS & OUTLET CONTROL STRUCTURES RECEIVING SURFACE DRAINAGE. UNDERDRAIN SHALL HAVE A MINIMUM OF 2'-6" COVER & A MINIMUM SLOPE OF 0.5%. SEE DETAIL ON (_____).

GENERAL PAVING & CURBING NOTES

- 1. ALL HOT MIX ASPHALT & CONCRETE PAVEMENT SHALL CONFORM TO THE 2020 MDOT SPECIFICATIONS FOR CONSTRUCTION.
- 2. SURFACE RESTORATION: RESTORE PAVEMENT & OTHER SURFACES DISTURBED BY CONTRACT OPERATIONS TO THEIR ORIGINAL CONDITION OR BETTER.
- 3. PAVEMENT STRIPING: PROVIDE 4 INCH WIDE WHITE PAINT STRIPING STANDARD PARKING STRIPING, & 4 INCH WIDE HANDICAP BLUE FOR ALL ACCESSIBLE PARKING STRIPING. ALL PARKING SPACE STRIPING SHALL BE DOUBLE STRIPED, MEETING THE ZONING ORDINANCE OF WHITE LAKE TOWNSHIP ALL PAVEMENT LANE MARKINGS SHALL MEET THE REQUIREMENTS. ALL PAINT SHALL BE APPLIED PER MANUFACTURERS RECOMMENDATIONS.
- 4. PROVIDE TEMPORARY INTERMITTENT MARKING FOR NEW PARKING AREA WHILE PAVEMENT CURES & SEALING COATING IS APPLIED.
- 5. EXISTING PAVEMENT TO BE REMOVED SHALL BE SAW CUT, FULL DEPTH, & RECTANGULAR.
- 6. WHEN PLACING NEW PAVEMENTS, MAINTAIN SLOPE OF EXISTING SURROUNDING SURFACES.
- 7. ALL NEW CURB SHALL BE PLACED ON 4" MIN. THICK BASE OF 21AA LIMESTONE COMPACTED TO 95% MAX. DENSITY PER ASTM D1557. BASE SHALL EXTEND 12" BEYOND BACK OF CURB. SUBGRADE SHALL BE PROOF-ROLLED/COMPACTED TO 95% MAX. DENSITY PER ASTM D-1557.

ASPHALT

- 1. AFTER FINAL ROLLING, PROTECT PAVEMENT FROM VEHICULAR TRAFFIC UNTIL THE SURFACE HAS COOLED SUFFICIENTLY TO ELIMINATE SURFACE ABRASION.
- 2. PAVEMENT SEALER PROVIDE FOR ALL NEW ASPHALT PAVEMENT
 - A. PAVEMENT SEALER SHALL BE TARCONITE BY NEYRA INDUSTRIES, INC., OR APPROVED SUBSTITUTE. SEALER SHALL MEET FS R-P-355e PITCH, COAL TAR EMULSION (COATING FOR BITUMINOUS PAVEMENTS).

ALTERNATE NO. 1: PAVEMENT SEALER SHALL BE JENNITE BY

NEYRA INDUSTRUES INC. OR APPROVED SUBSTITUTE SEALER SHALL BE MIXED WITH 6 POUNDS OF SAND PER GALLON OF SEALER. SURFACE CLEANING, PRIMING & NUMBER OF APPLICATIONS SHALL BE AS SPECIFIED FOR BASE BID. SEALER SHALL EXCEED FS R-P-355e.

PHONE (248) 625-5251

ASPHALT CONT.

- A. PRIMER SHALL BE POLYPRIME PENETRATING PRIMER BY NEYRA INDUSTRIES, INC. OR APPROVED SUBSTITUTE.
- B. CLEAN EXISTING SURFACES FREE FROM ALL LOOSE OR FOREIGN MATTER. COAT OIL SPOTS
- WITH ACRYLIC OIL SPOT PRIMER. C. APPLY PRIMER AT MINIMUM RATE OF .015 GAL. OF CONCENTRATED POLYPRIMER PER SQUARE YARD. ALLOW PRIMER TO CURE FOR A MINIMUM OF ONE HOUR PRIOR TO
- APPLICATION OF TARCONITE D. SEALER SHALL BE FIELD MIXED WITH 5 POUNDS OF SAND PER 1 GALLON OF TARCONITE TO
- FORM HOMOGENEOUS SLURRY. SAND SHALL BE WASHED DRY SILICA SAND. E. APPLICATION SYSTEM FOR MODERATE TRAFFIC: ONE COAT OF POLYPRIME PENETRATING
- PRIMER & TWO SAND-SLURRY COATS OF TARCONITE. APPLICATION SPECIFICATION JV-S2. F. NEW PAVEMENTS SHALL BE ALLOWED TO CURE AT LEAST 30 DAYS PRIOR TO APPLICATION.
- G. APPLICATION OF PAVEMENT SEALER SHALL BE IN ACCORDANCE WITH MANUFACTURERS RECOMMENDATIONS.
- H. BARRICADE COATED AREAS UNTIL COATING IS DRIED SUFFICIENTLY FOR TRAFFIC.

CAST-IN-PLACE CONCRETE & CONCRETE PAVING

- 1. ALL CAST IN PLACE CONCRETE WORK SHALL CONFORM TO THE REQUIREMENTS OF ACI 301-LATEST REVISION, "SPECIFICATIONS FOR STRUCTURAL CONCRETE FOR BUILDING", EXCEPT AS NOTED ON THE DRAWINGS.
- 2. ALL CONCRETE PAVEMENT WORK SHALL CONFORM TO THE REQUIREMENTS OF ACI 330- LATEST REVISION, "GUIDE FOR THE DESIGN AND CONSTRUCTION OF CONCRETE PARKING LOTS", EXCEPT AS NOTED ON THE DRAWINGS.
- 3. ALL CONCRETE SHALL HAVE A MINIMUM 28-DAY COMPRESSIVE STRENGTH OF 4000 psi.
- 4. ALL EXTERIOR CONCRETE INCLUDING WALLS SHALL BE AIR ENTRAINED 5% + /- 1%.
- 5. ALL EXTERIOR CONCRETE EXPOSED TO WEATHER SHALL HAVE A MAXIMUM WATER TO CEMENTITIOUS RATIO OF 0.45.
- 6. UNLESS NOTED OTHERWISE, MINIMUM CONCRETE COVER SHALL BE: 3 IN CONCRETE CAST AGAINST EARTH CONCRETE EXPOSED TO EARTH OR WEATHER 2 IN CONCRETE NOT EXPOSED TO EARTH OR WEATHER (SLABS, JOISTS, WALLS) 3/4 IN CONCRETE NOT EXPOSED TO EARTH OR WEATHER (BEAMS, COLUMNS, PEDESTALS) 1 1/2 IN
- 7. THE CONTRACTOR SHALL FOLLOW THE JOINTING LAYOUT ON THE DRAWINGS, AND SHALL CONFORM TO ACI 330 GUIDE FOR DESIGN & CONSTRUCTION OF CONCRETE PARKING LOTS, LATEST EDITION AS WELL AS WHITE LAKE TOWNSHIP STANDARDS. ALL JOINTS SHALL BE SEALED W/ NON-SAG SILICONE JOINT SEALANT. SEE PAVING DETAILS FOR JOINT AND SEALANT DETAILS.
- 8. THE CONTRACTOR SHALL SUBMIT THE CONCRETE MIX DESIGN(S) TO THE ENGINEER FOR REVIEW. PROPORTION MIX DESIGNS AS DEFINED IN ACI 301 SECTION 4. THE SUBMITTAL SHALL INCLUDE AS A MINIMUM CEMENT TYPE & SOURCE, CEMENT CUBE STRENGTH, AGGREGATE GRADATIONS, WATER TESTS, AD-MIXTURE CATALOG INFORMATION & CYLINDER STRENGTH TEST RESULTS FOR THE
- 9. ALL REINFORCEMENT TO BE DETAILED, FABRICATED & ERECTED ACCORDING TO THE ACI STANDARDS: "DETAILS & DETAILING OF CONCRETE REINFORCEMENT", ACI 315 - LATEST REVISION & "MANUAL OF ENGINEERING & PLACING DRAWINGS FOR REINFORCED CONCRETE STRUCTURES", ACI 315R - LATEST REVISION.
- 10. LAPS, ANCHORAGES & SPLICES SHALL COMPLY WITH THE REQUIREMENTS OF ACI 318-LATEST REVISION, SECTIONS 12.2 & 12.15. LOCATIONS & SPLICES SHALL BE IN ACCORDANCE WITH THE CONSTRUCTION JOINT LOCATIONS, DETAILS & AS SHOWN ON THE REINFORCING STEEL SHOP
- 11. ALL CONSTRUCTION JOINTS SHALL BE FURNISHED WITH KEYWAY CENTERED ON MEMBERS. WHERE THE SIZE OF KEY IS NOT SHOWN ON THE DRAWINGS, THE KEY DEPTH SHALL BE 10% OF THE CROSS SECTION DIMENSION OF THE MEMBER - MINIMUM 3/4".
- 12. PROVIDE 3/4" CHAMFER STRIP AT ALL EXPOSED CORNERS OF CONCRETE WALLS, INCLUDING EXPOSED CORNERS OF CONCRETE PIERS.
- 13. LOCATE ALL SLEEVES, OPENINGS, EMBEDDED ITEMS, ETC., AS INDICATED ON THE DRAWINGS. THE CONCRETE CONTRACTOR SHALL CHECK WITH ALL OTHER TRADES TO MAKE SURE THE SLEEVES, OPENINGS & EMBEDDED ITEMS THAT ARE TO BE PROVIDED & SET BY THEM ARE IN PLACE PRIOR TO PLACING OF CONCRETE IN THE AREA INVOLVED.
- 14. ALL INTERIOR SLABS ON GRADE SHALL BE PLACED ON A VAPOR BARRIER WITH A MINIMUM OF 4-INCHES MDOT CLASS II GRANULAR MATERIAL (SAND). MINIMUM REINFORCEMENT SHALL BE IN ACCORDANCE WITH CRSI ENGINEERING DATA REPORT NUMBER 37. OR AS DETAILED. ALL EXTERIOR SLABS ON GRADE SHALL BE PLACED ON A MINIMUM OF 4-INCHES CLEAN SAND. MINIMUM REINFORCEMENT SHALL BE IN ACCORDANCE WITH ACI 318 SECTION 7.12 - SHRINKAGE & TEMPERATURE REINFORCEMENT, OR AS DETAILED.
- 15. CONTRACTORS SHALL OBTAIN APPROVAL FROM THE ENGINEER. PRIOR TO PLACING OPENINGS OR SLEEVES. NOT SHOWN ON THE DRAWINGS, THROUGH ANY STRUCTURAL MEMBERS, ROOF, WALLS OR FOUNDATIONS. REVIEW ARCHITECTURAL, MECHANICAL & ELECTRICAL DRAWINGS FOR BASES. OPENINGS, SLEEVES, ANCHORS, INSERTS, CONDUITS, RECESSES & OTHER DEVICES IN CONCRETE WORK BEFORE CASTING CONCRETE.
- 16. PROVIDE POCKETS OR RECESSES IN CONCRETE WORK FOR STEEL COLUMNS & BEAMS AS REQUIRED &/OR AS CALLED FOR IN THE SPECIFICATIONS EVEN IF NOT SHOWN ON THE DRAWINGS. PROVIDE CONCRETE FILL AFTER STEEL ERECTION TO SEAL OPENINGS
- 17. REFER TO ARCHITECTURAL DRAWINGS FOR SLAB RECESSES &/OR FLOOR FINISH MATERIALS.
- 18. WELDING OF REINFORCING STEEL IS PROHIBITED UNLESS SPECIFICALLY DETAILED. WELDING SHALL CONFORM TO AWS D1.4 SPECIFICATION.
- 19. CONCRETE SHALL BE THOROUGHLY COMPACTED BY VIBRATION SUPPLEMENTED BY SPADING. PUDDLING OR AGITATION. TO PREVENT HONEYCOMBING & TO INSURE THE ELIMINATION OF VOIDS. VIBRATION MUST BE DIRECT ACTION IN THE CONCRETE & NOT AGAINST FORMS OR REINFORCEMENT. HONEYCOMBING, VOIDS & LARGE AIR POCKETS WILL NOT BE ACCEPTABLE.

SYMBOLS LEGEND **EXISTING** PROPOSED _____ STORM SEWER SEPTIC SERVICE LINE _____ ——— GAS ——— GAS MAIN OR SERVICE —— GAS —— GAS —— WATER SERVICE LINE _____ ELEC. TELE. CABLE _____UGF _____ OVERHEAD LINES ____OH____ _____OH____ DRAINAGE AREAS PRETREATMENT STRUCTURE STORM MANHOLE CATCH BASIN INLET REARYARD CATCH BASIN END SECTION SANITARY MANHOLE GATE VALVE AND WELL HYDRANT GRADE CONTOUR ---(40)-----

DRAINAGE ARROW

FAX (248) 625-7110


SOIL EROSION & SEDIMENTATION CONTROL

- 1. COMPLY WITH THE REQUIREMENTS OF THE OAKLAND COUNTY WATER RESOURCE COMMISSIONER EROSION & SEDIMENTATION CONTROL PERMIT ALONG WITH ALL APPLICABLE FEDERAL, STATE, COUNTY, & CITY LAWS, CODES, & REGULATIONS PERTAINING TO THE IMPLEMENTATION, MAINTENANCE, & DOCUMENTATION OF SEDIMENTATION & EROSION CONTROL PRACTICES.
- 2. THE CONTRACTOR SHALL BE RESPONSIBLE FOR IMPLEMENTATION, MAINTENANCE, & DOCUMENTATION OF SEDIMENTATION & EROSION CONTROL & STORM WATER QUALITY ISSUES RELATED TO THE PROJECT, AS REQUIRED & AS NECESSARY TO COMPLY WITH APPLICABLE LAWS, CODES, &
- 3. INSPECTIONS SHALL BE MADE WEEKLY & AFTER RAIN EVENTS TO DETERMINE THE EFFECTIVENESS OF EROSION & SEDIMENT CONTROL MEASURES. ANY NECESSARY IMPROVEMENTS OR REPAIRS SHALL BE PERFORMED WITHOUT DELAY.
- 4. SEDIMENT & EROSION FROM ALL WORK AREAS SHALL BE CONTAINED ON THE SITE, AWAY FROM WETLANDS, OUTFALLS, WATERWAYS, & ENVIRONMENTALLY SENSITIVE AREAS. WATERWAYS INCLUDE BOTH NATURAL & MAN-MADE OPEN DITCHES, STREAMS, STORM DRAINS, LAKES, & PONDS.
- 5. MAINTAIN EROSION CONTROL MEASURES UNTIL CONSTRUCTION IS COMPLETE & LAWN AREAS ARE
- 6. PROVIDE JUTE MATTING OR NETTED MULCH ON TEMPORARY SLOPES 2:1 OR STEEPER. SEED & MULCH OTHER SLOPES TO REMAIN UNFINISHED FOR MORE THAN 14 DAYS.
- 7. REMOVE SEDIMENTATION & EROSION CONTROL MEASURES UPON COMPLETION OF PROJECT.

SEQUENCE OF EROSION & SEDIMENTATION CONTROL OPERATIONS:


- 1. A PERIMETER DEFENSE WILL BE INSTALLED PRIOR TO CONSTRUCTION TO CONTAIN RUNOFF FROM ALL PROPOSED DISTURBED AREAS. SEDIMENT CONTROL WILL BE INITIATED WHICH WILL CONSIST OF MAINTAINING ALL EXISTING VEGETATION & DIRECTING ALL RUNOFF ON SITE.
- 2. DURING CONSTRUCTION THE ENDS OF ALL OPEN PIPES WILL BE PROTECTED BY FILTER FABRIC, STONE FILTERS OR OTHER APPROVED MEANS.
- 3. ANY REMAINING DENUDED AREA SHALL BE SEEDED & MULCHED DAILY, UPON COMPLETION OF FINAL
- 4. AT THE COMPLETION OF THE CONSTRUCTION, TEMPORARY CONTROL MEASURES WILL BE REMOVED & CONVERTED TO PERMANENT CONTROLS. FINAL GRADING WILL BE COMPLETED & THE GROUND WILL BE PERMANENTLY STABILIZED. FILTER FABRIC FENCES SHALL BE REMOVED & ANY BARE SPOTS WILL BE SEEDED. CATCH BASINS & DRAIN INLETS WILL BE CAREFULLY UNCOVERED & ANY SEDIMENT OR DEBRIS WILL BE REMOVED.
- 5. CONTRACTOR IS TO SEED CRITICAL AREAS IDENTIFIED BY OWNER OR OWNER'S REPRESENTATIVE DAILY, WHEN THOSE AREAS ARE SUBJECT TO EARTH CHANGES. CONTRACTOR IS ALSO RESPONSIBLE FOR REGULAR MAINTENANCE OF PLANT COVER IN THESE AREAS. COVER SHALL BE MAINTAINED SO AS TO CONTROL SOIL EROSION.
- 6. AT THE CONCLUSION OF CONSTRUCTION, THE OWNER WILL ASSUME THE RESPONSIBILITY FOR PERMANENT MAINTENANCE OF THE EROSION & SEDIMENTATION CONTROL MEASURES.
- 7. PROVIDE DUST CONTROL WITH AN ON-SITE WATER WAGON. WATER SHALL BE IMPLEMENTED AS NEEDED & AT THE DIRECTION OF THE CITY AGENT.

LEGEND OF ABBREVIATIONS

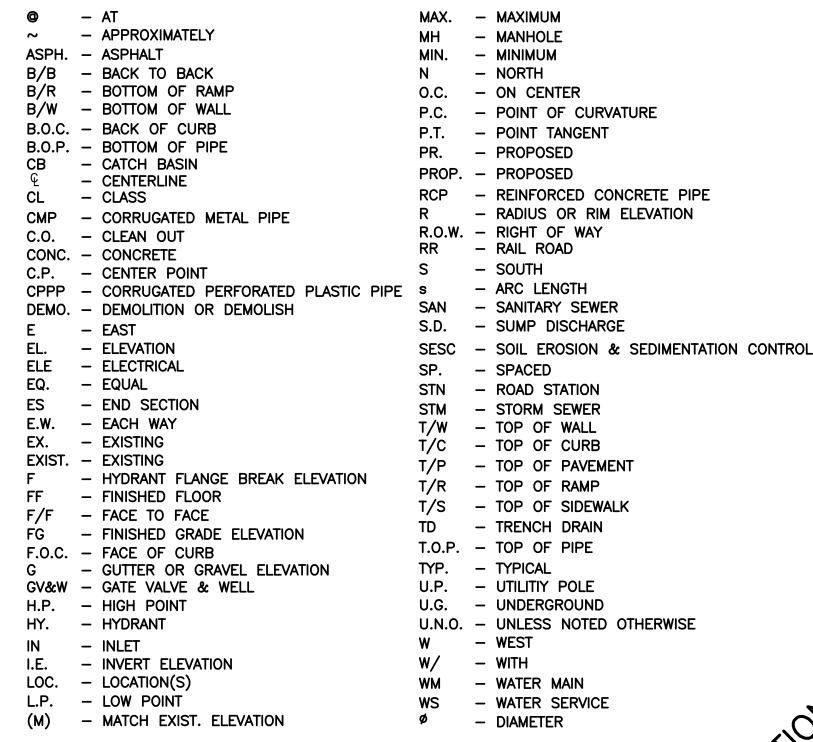

PIPE SIZE DESIGNATION XX' - XX"- FEET

EX. 89' - 12" MEANS 89 FEET OF 12" PIPE

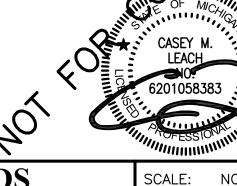

PROPRIETOR: HOPSON HOLDINGS, LLC 2255 PORTER ROAD WHITE LAKE, MICHIGAN 48383 (248) 830-2828

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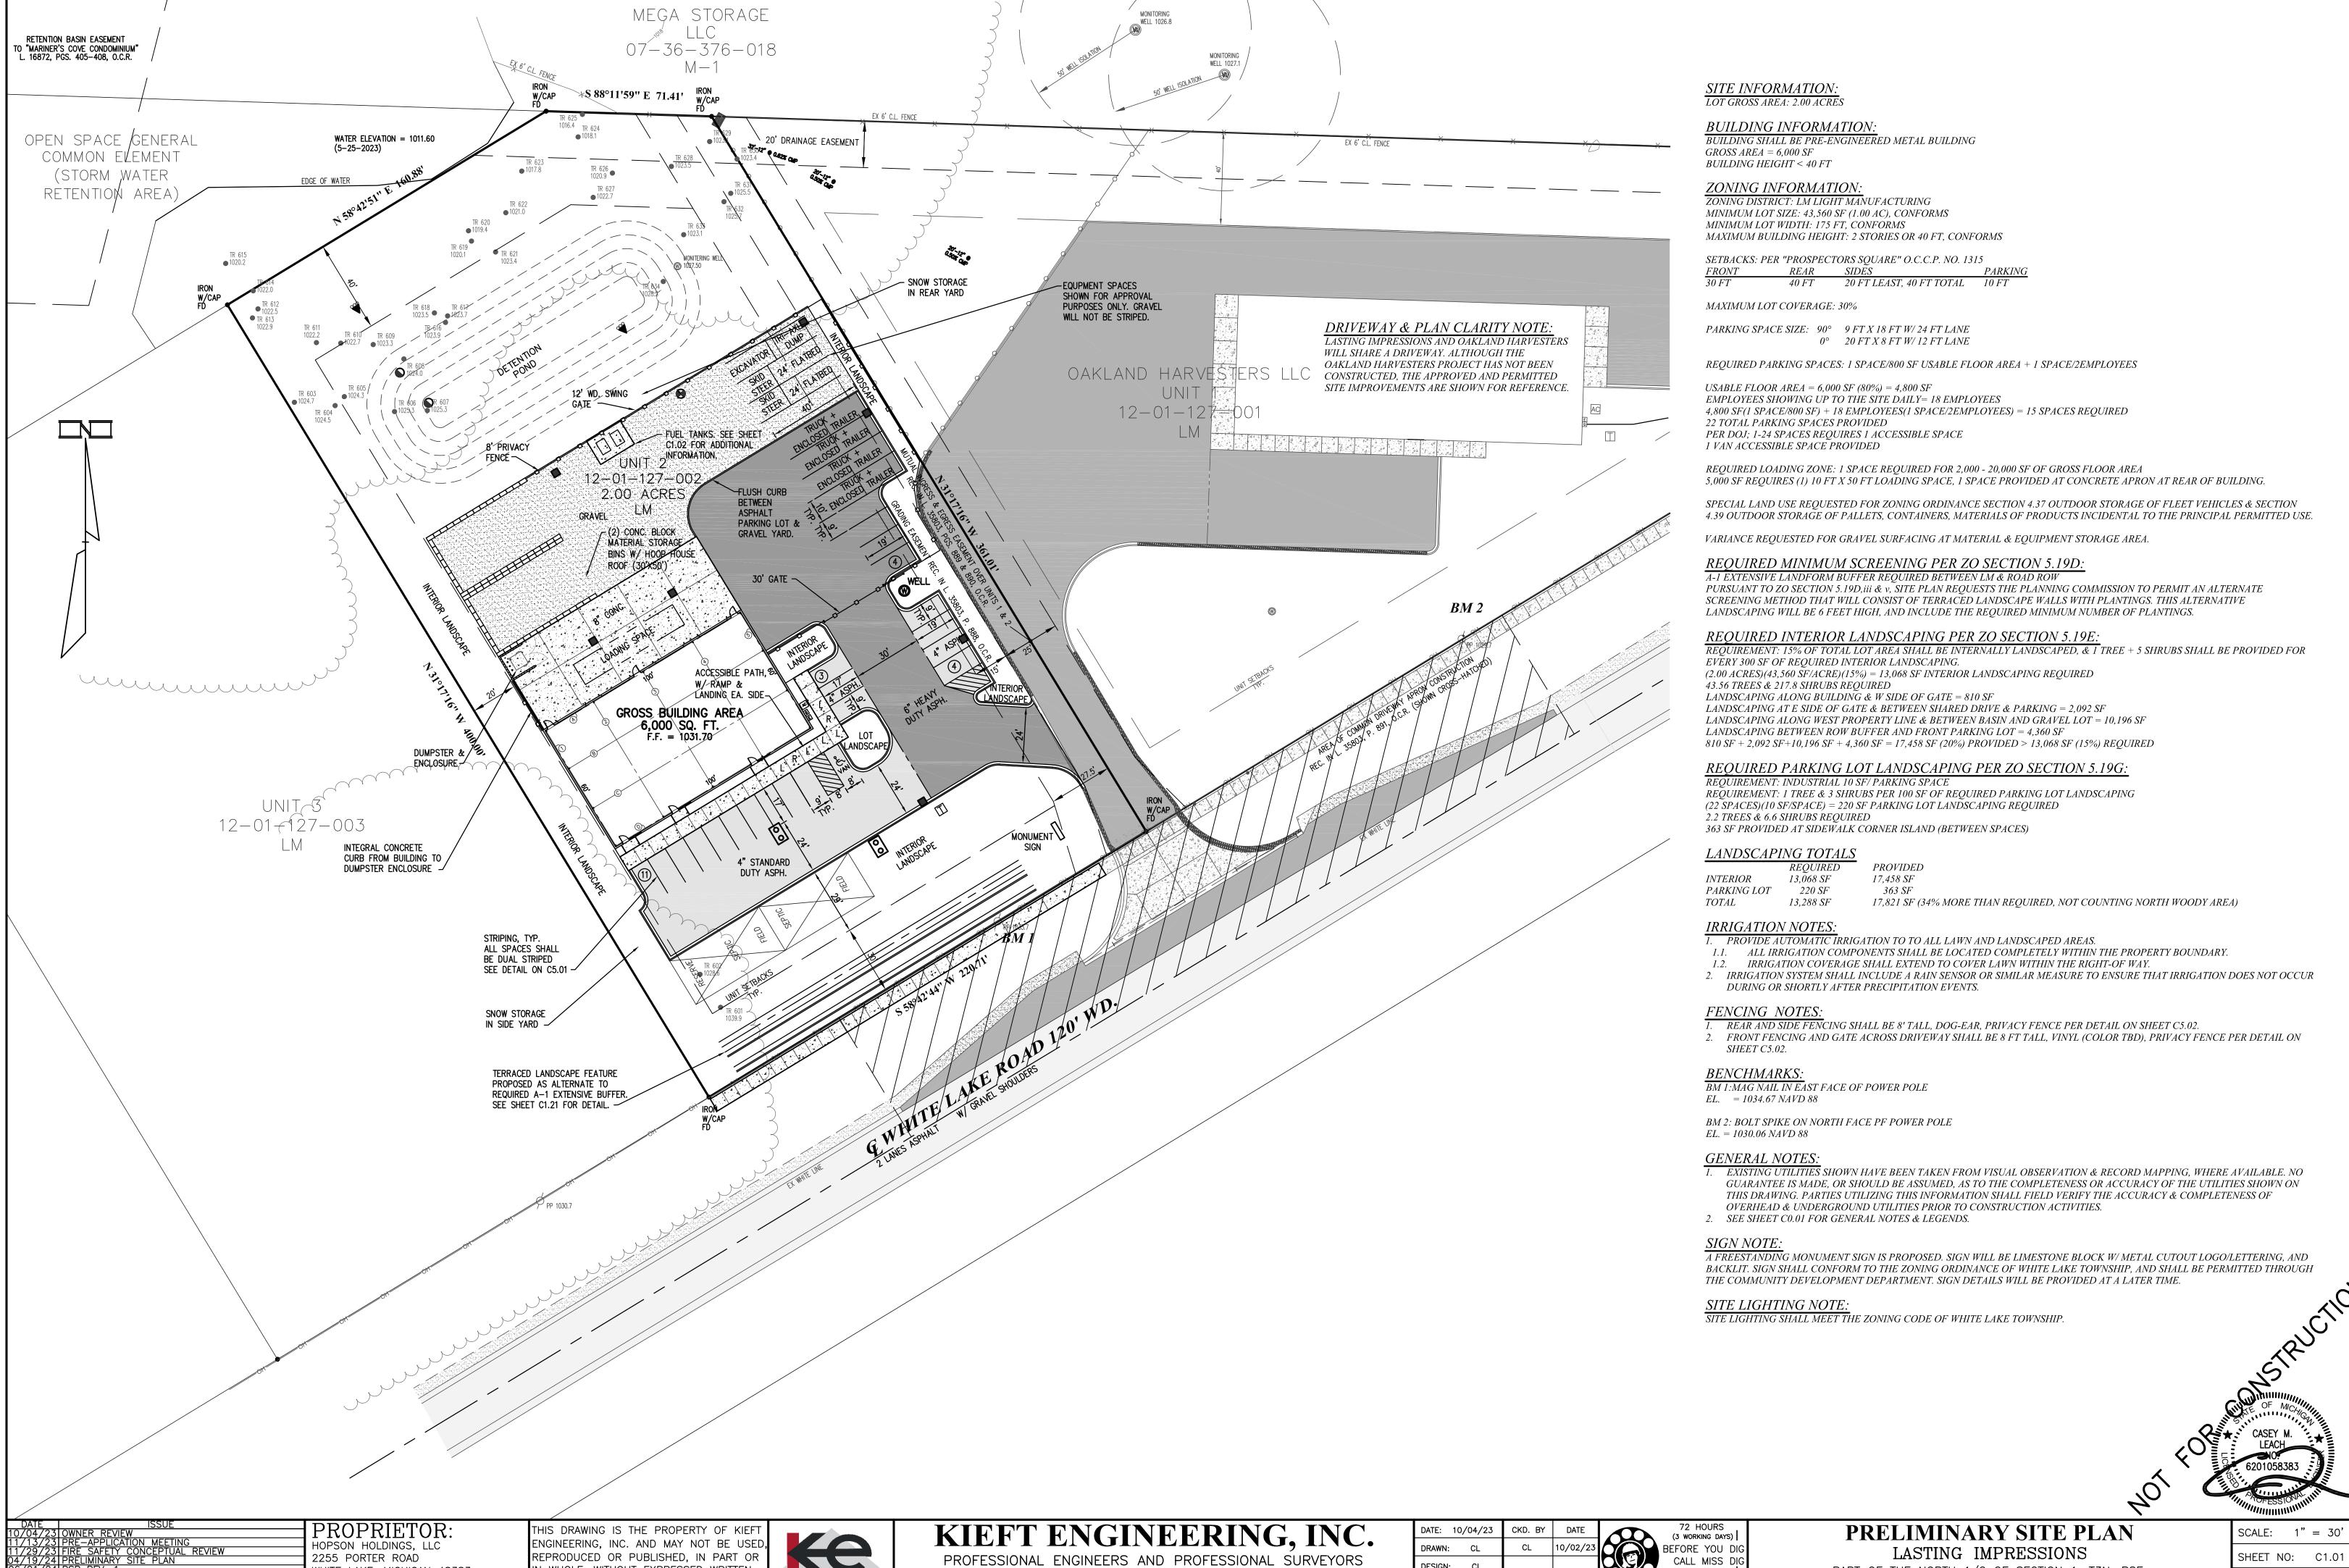
(3 WORKING DAYS) BEFORE YOU DIG CALL MISS DIG 800-482-7171**_** (TOLL FREE)

GENERAL NOTES & LEGENDS LASTING IMPRESSIONS

PART OF THE NORTH 1/2 OF SECTION 1, T3N, R8E,

WHITE LAKE TOWNSHIP, OAKLAND COUNTY, MICHIGAN

NONE SHEET NO: CO.01



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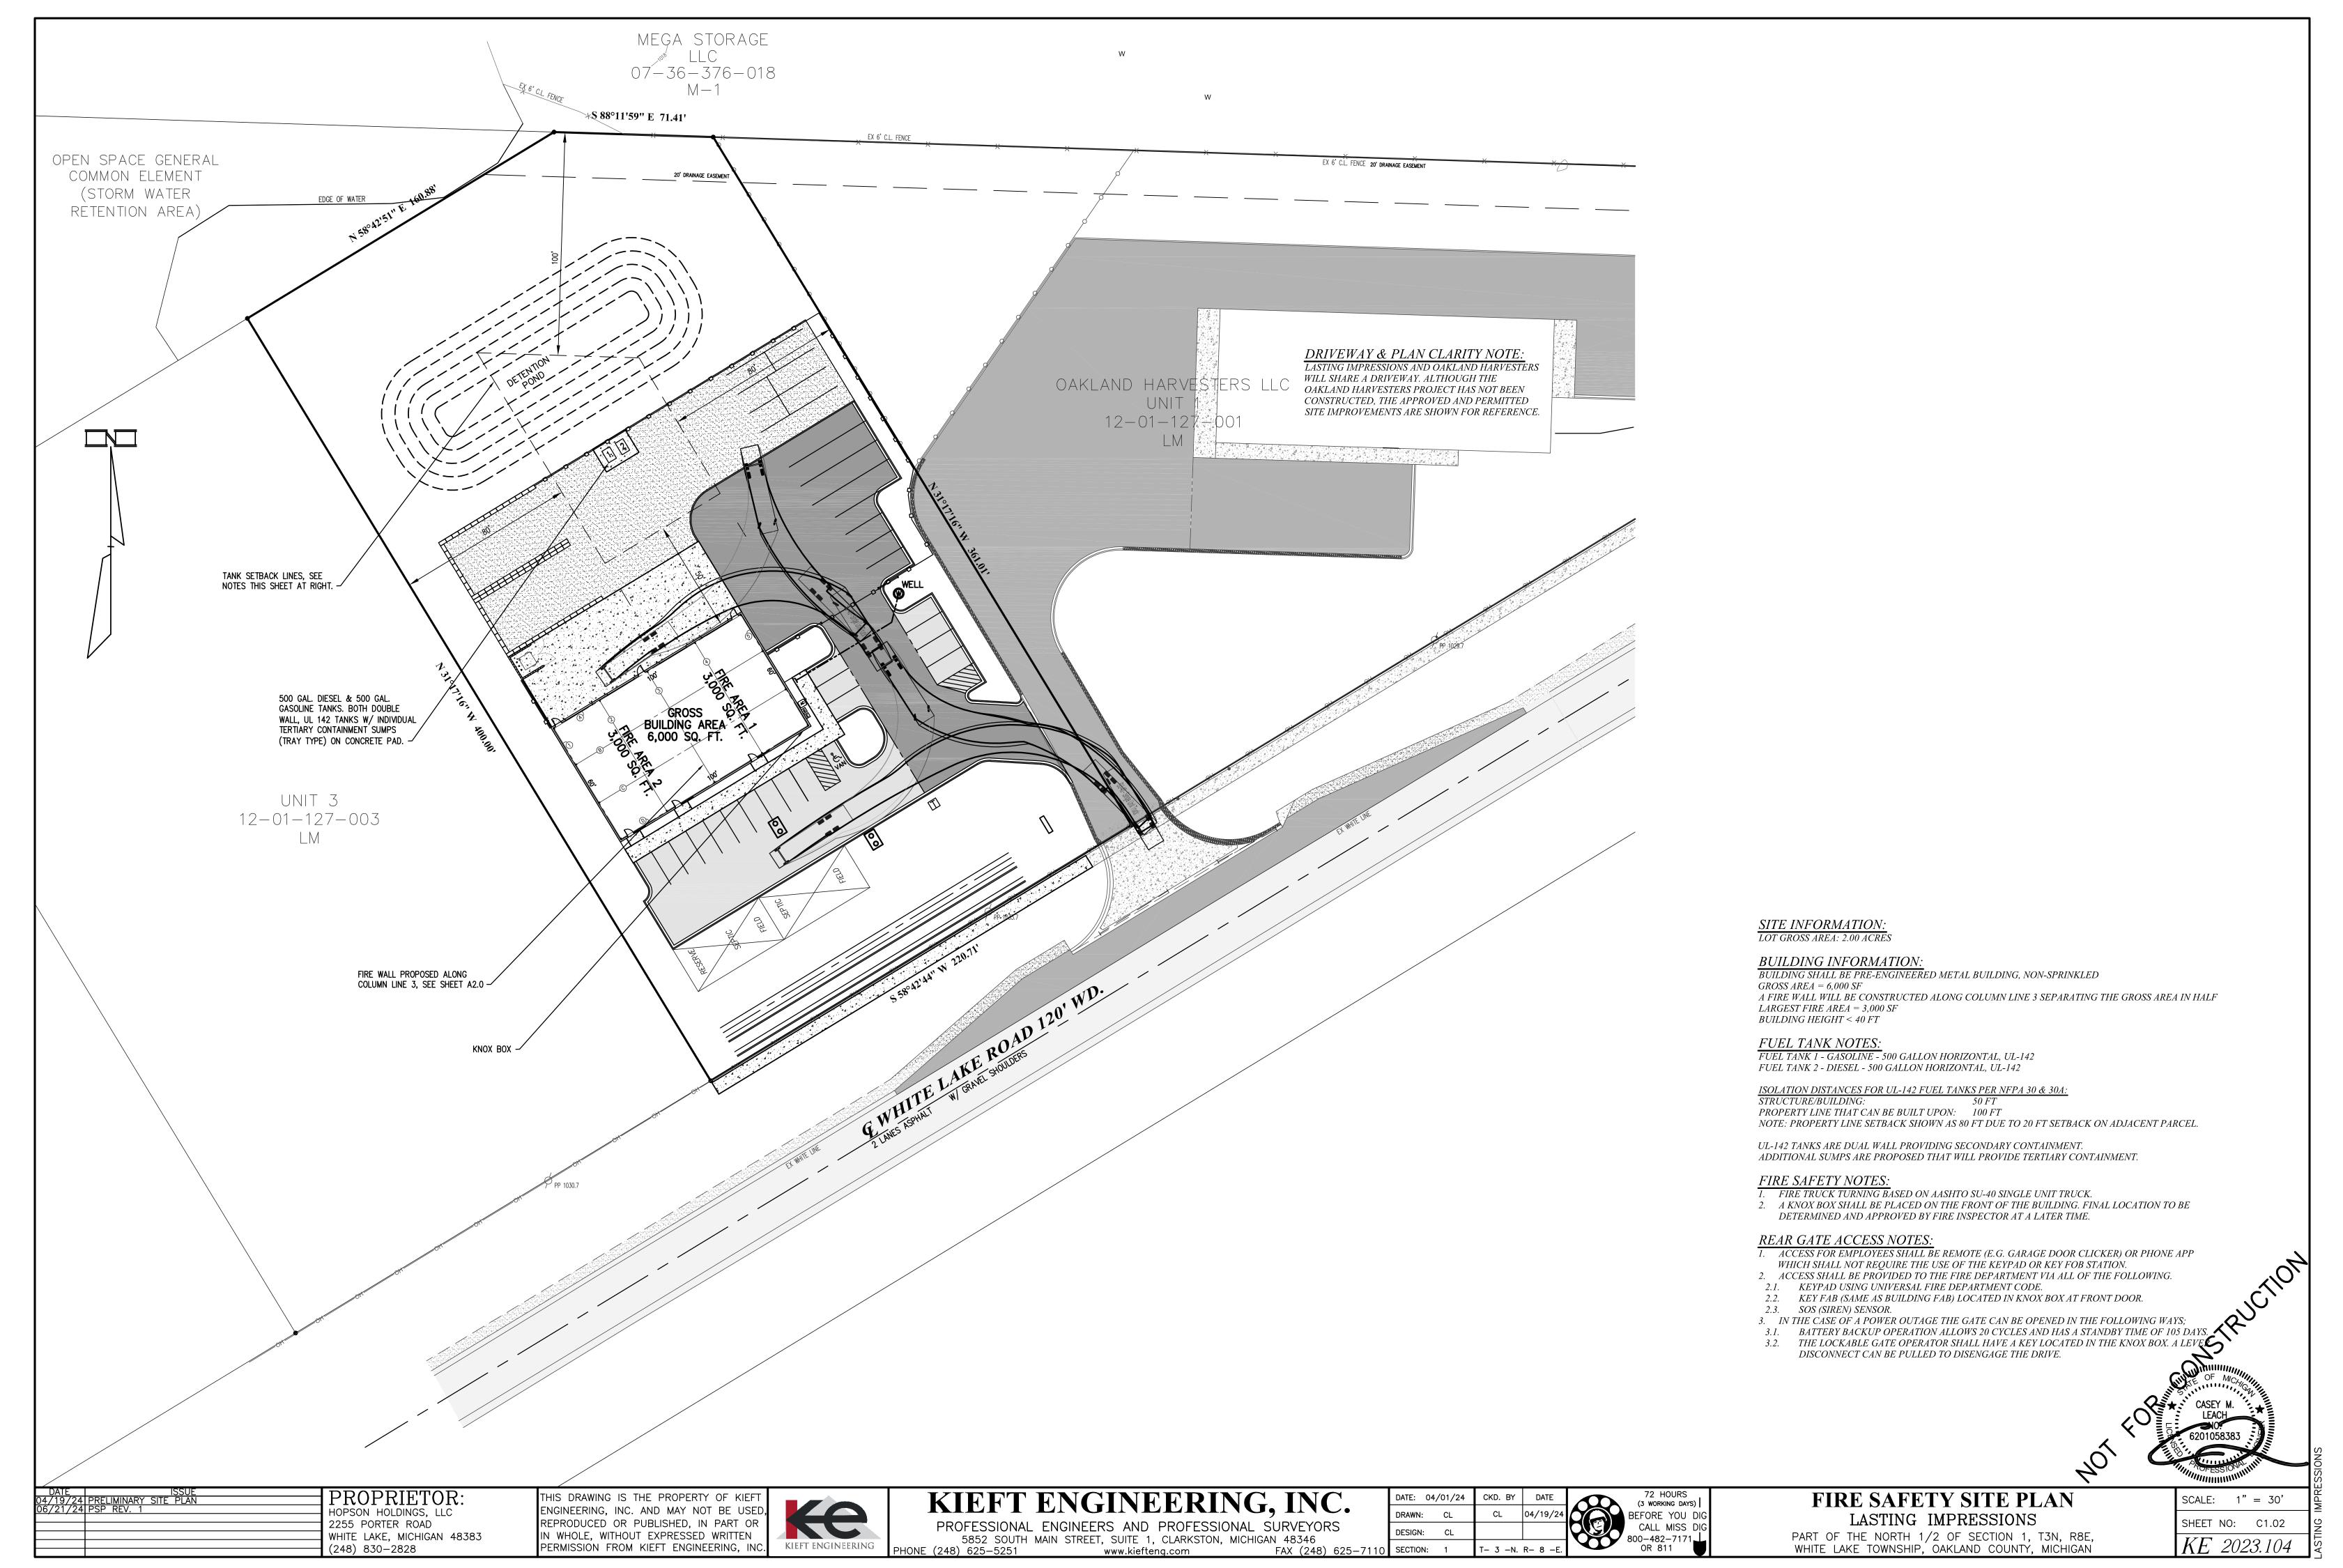
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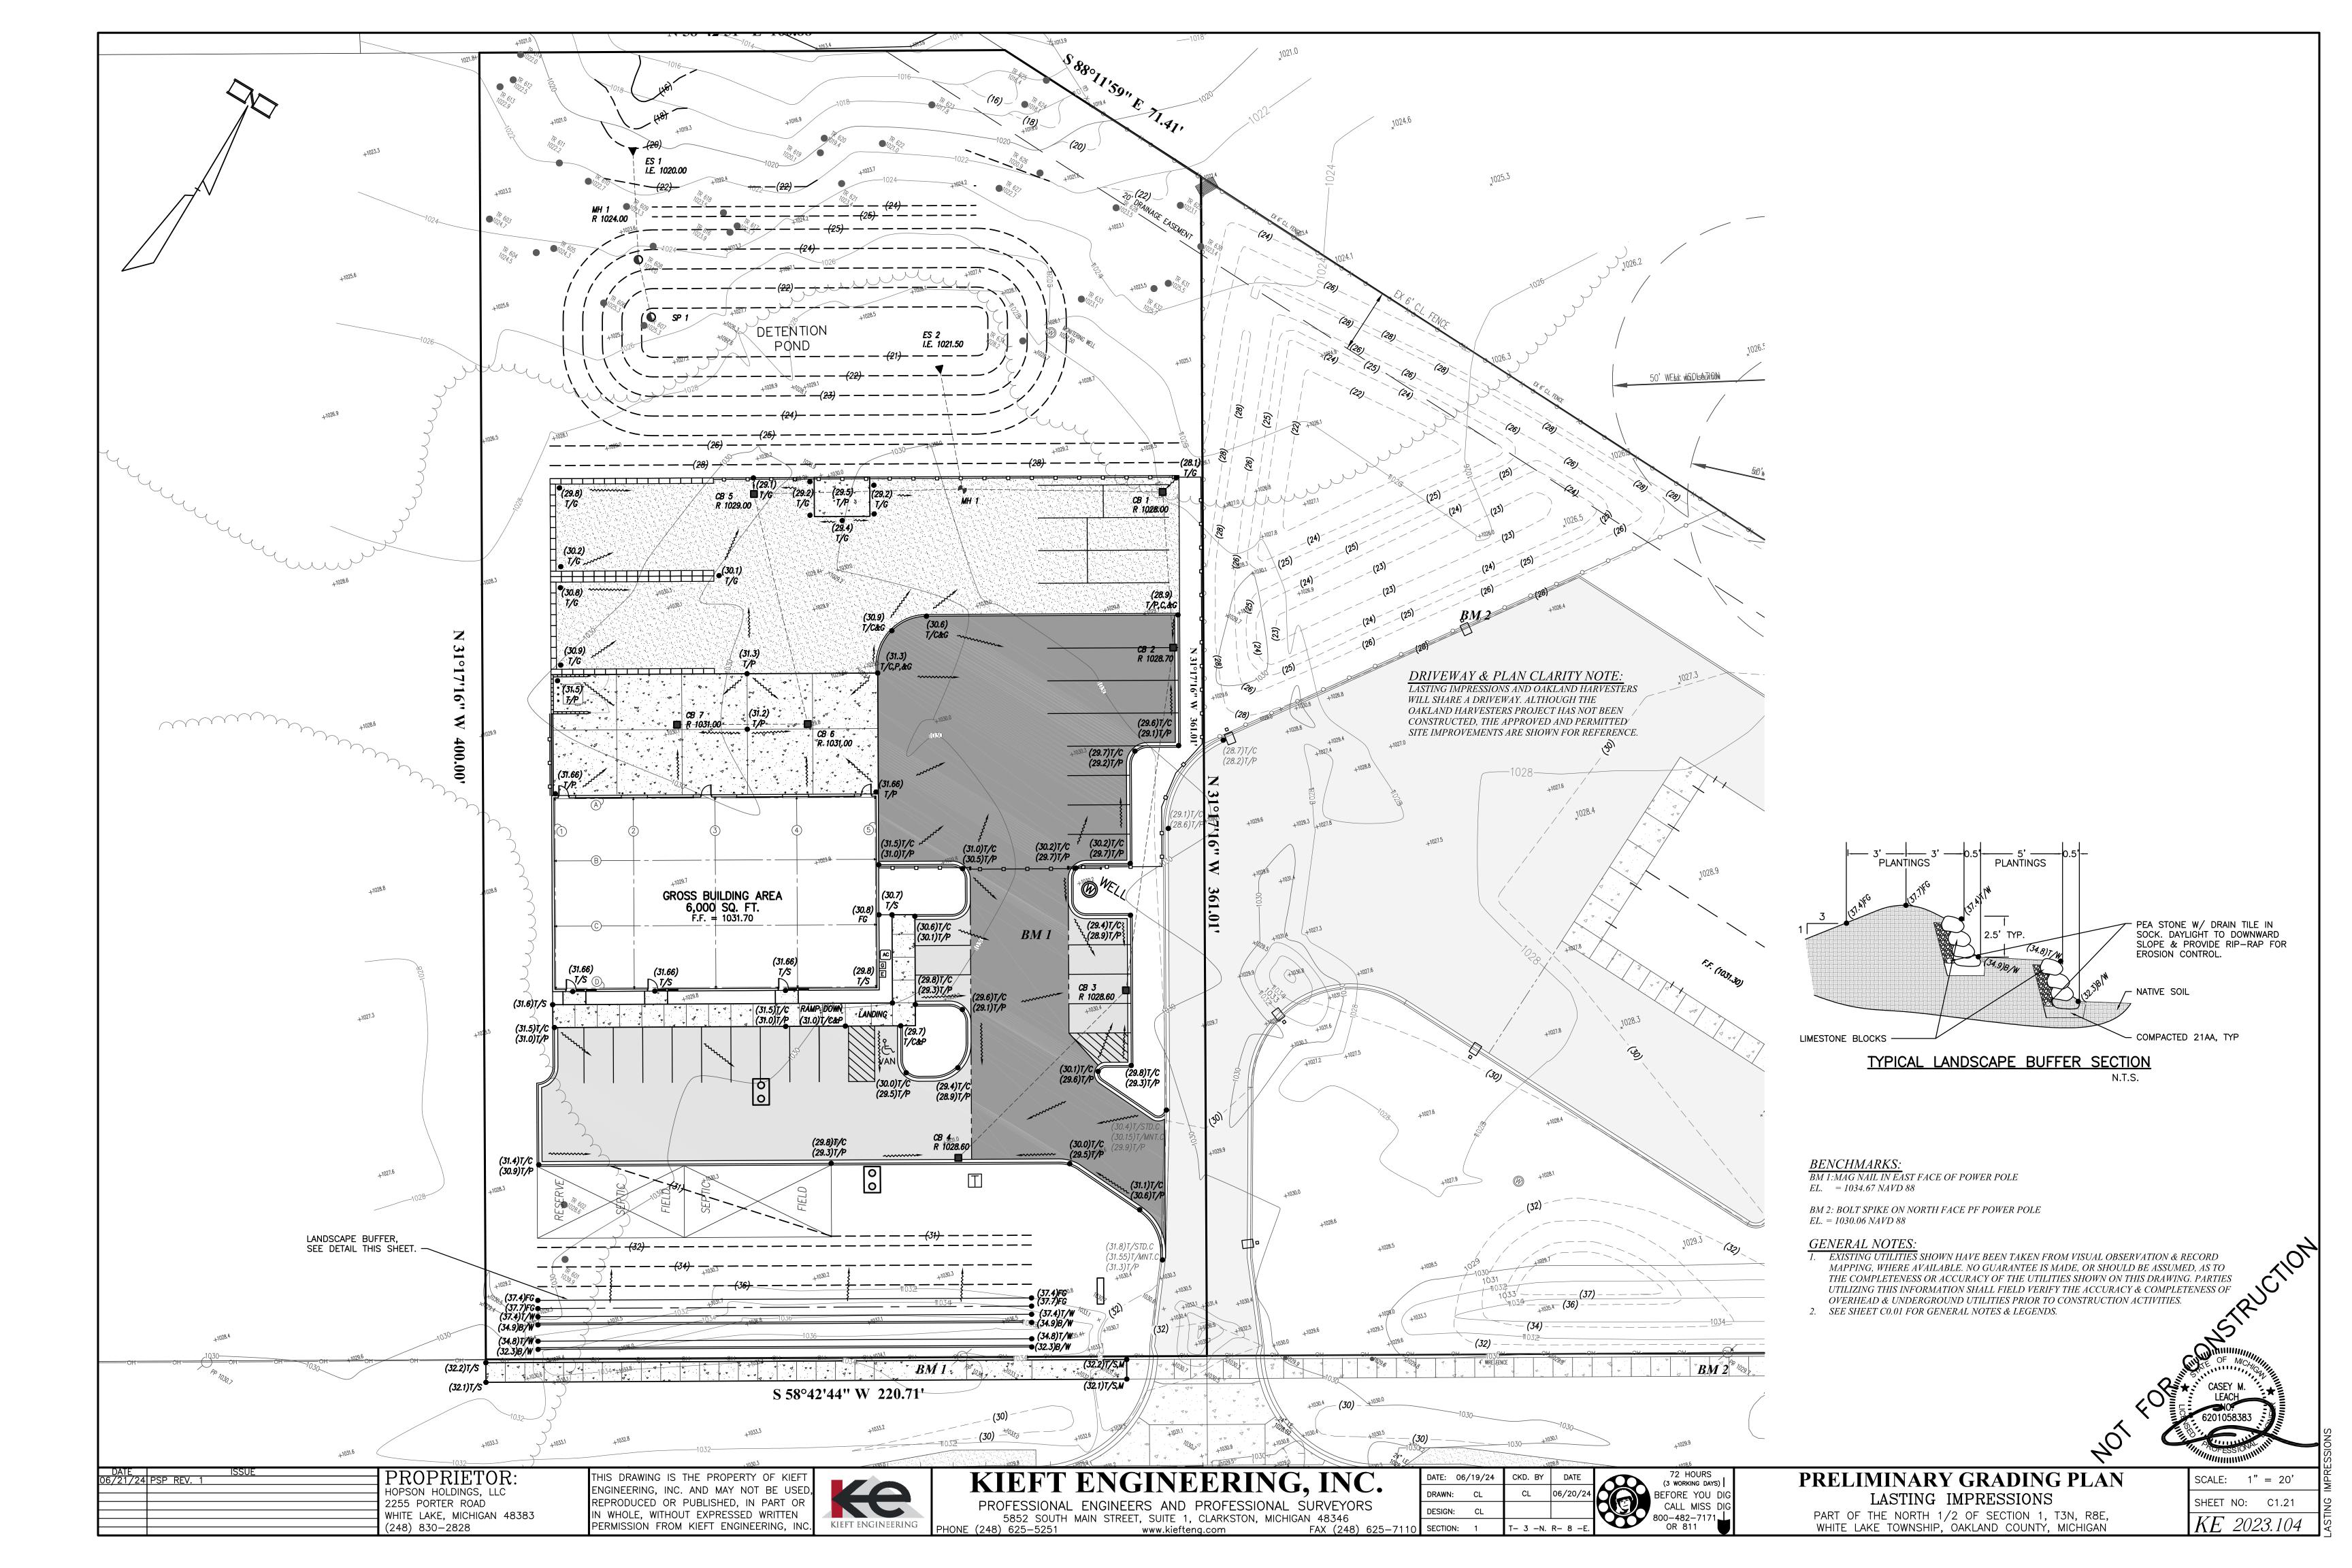
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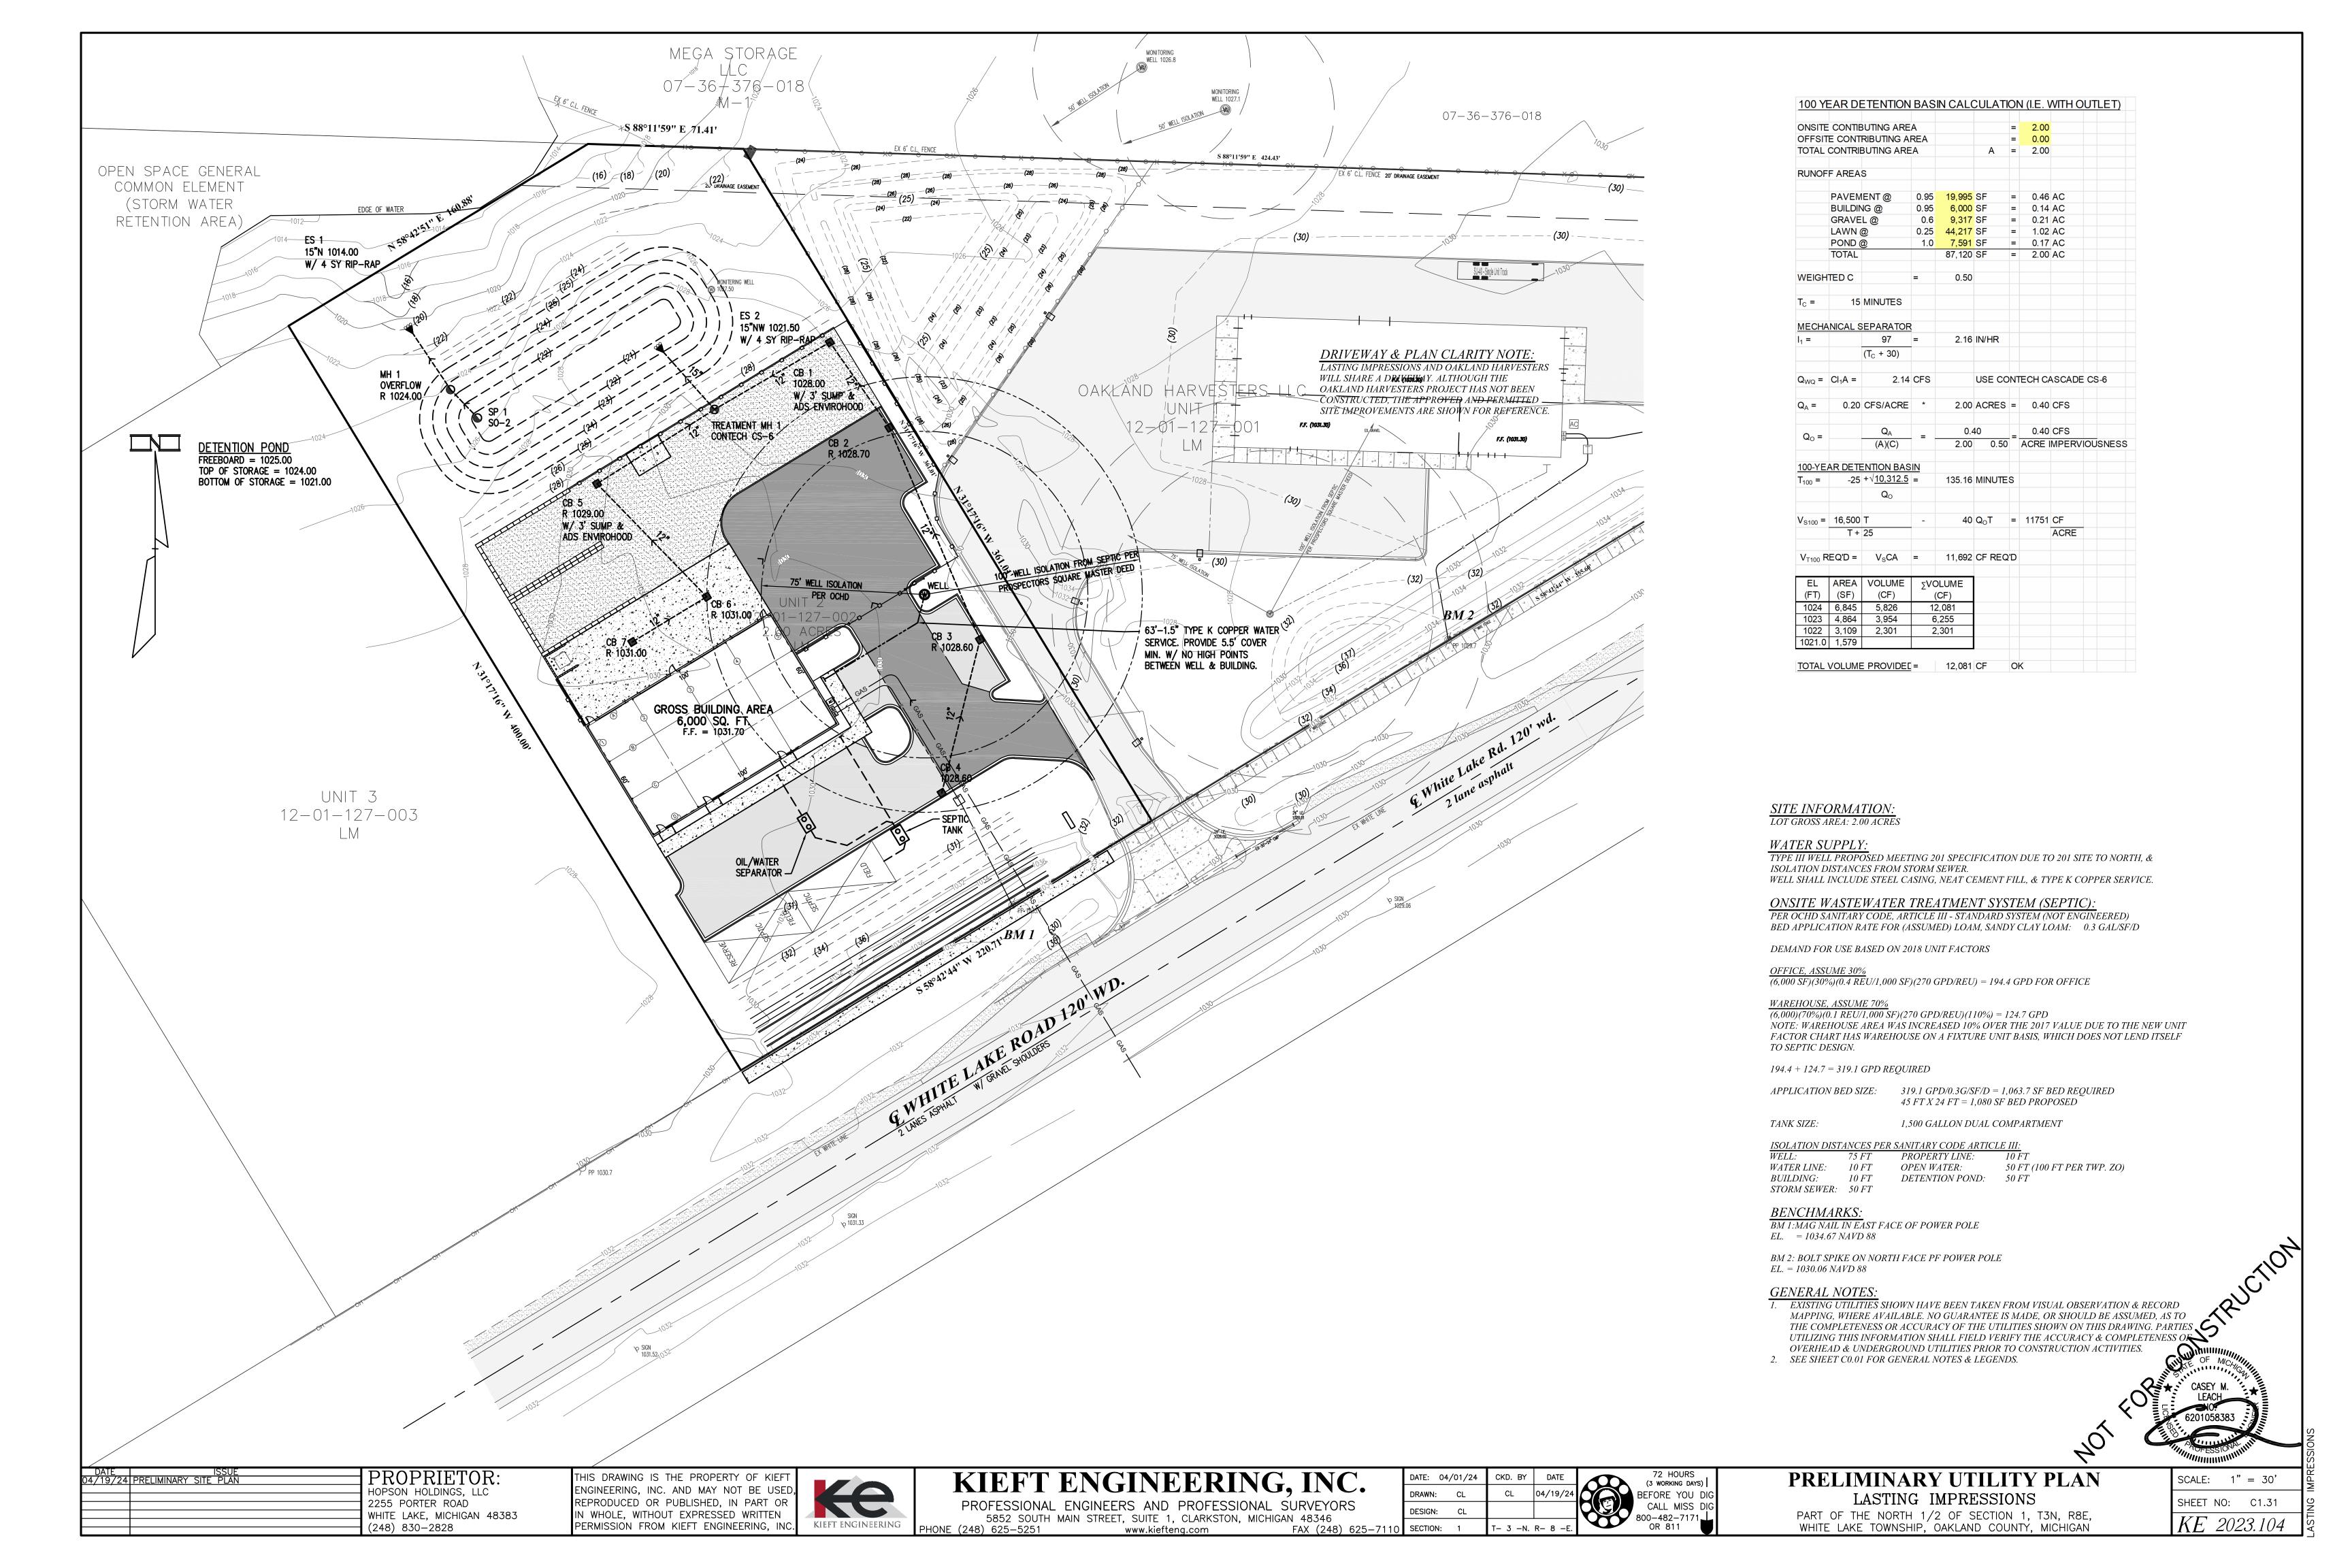
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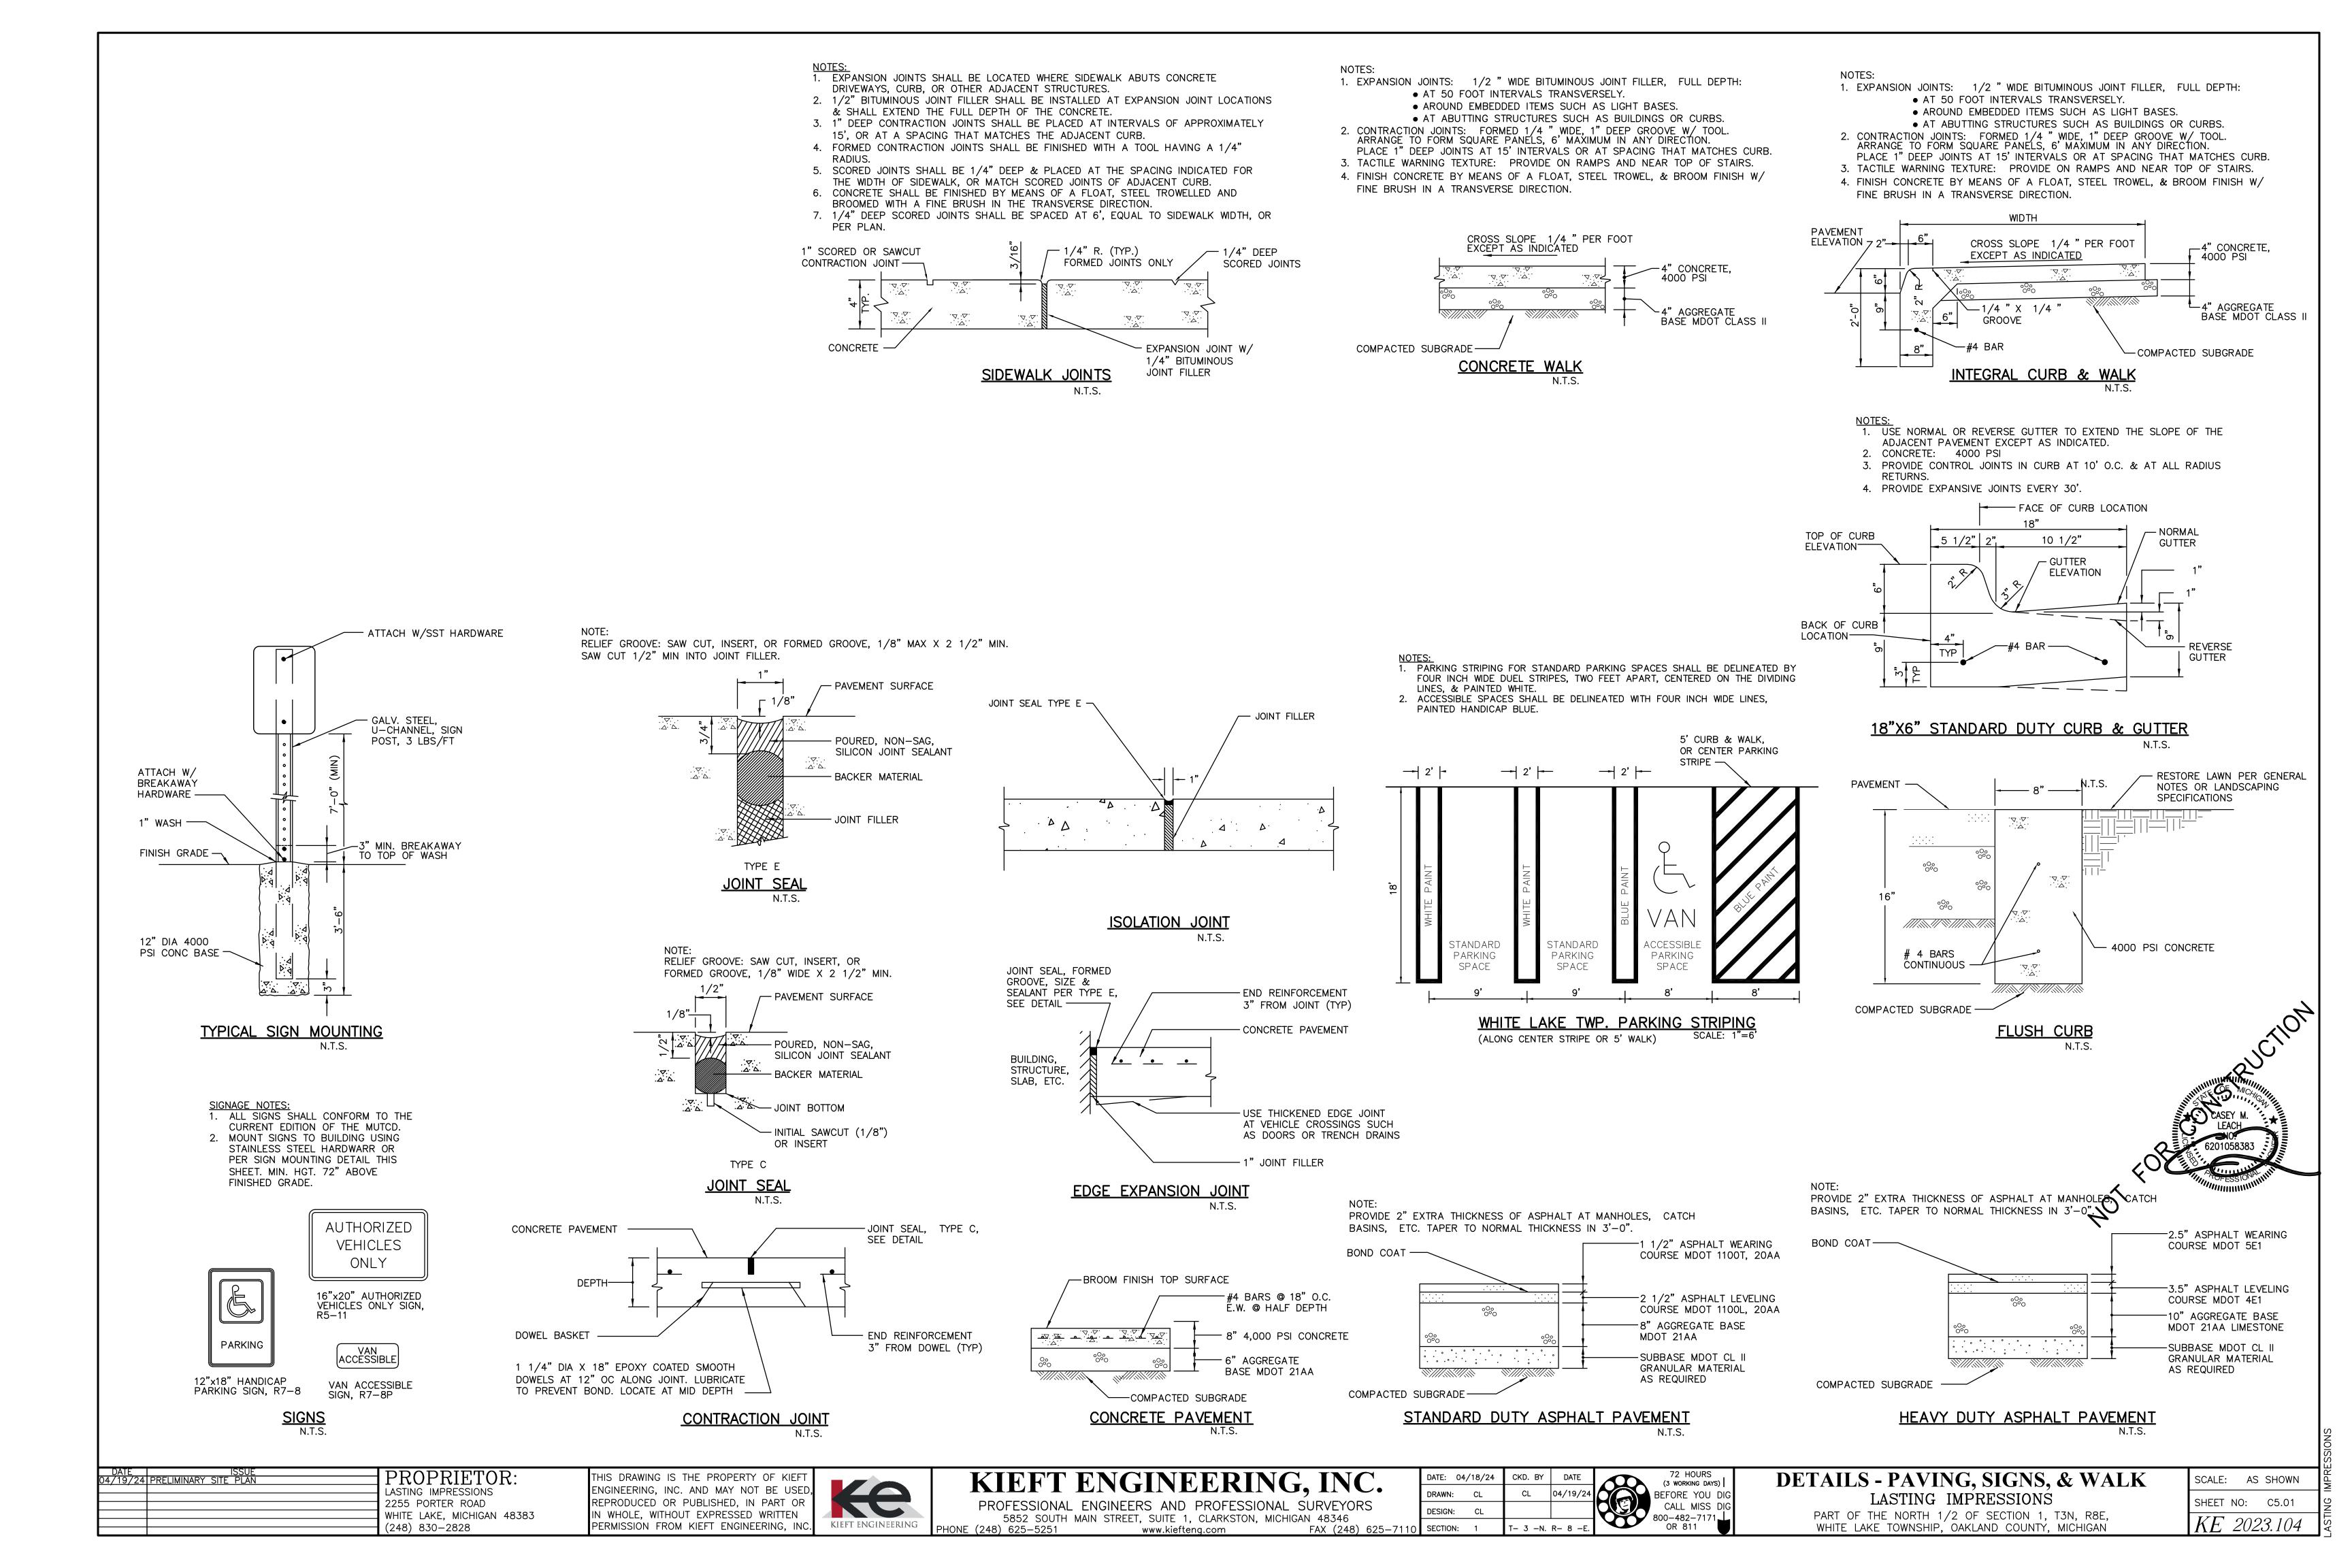
KE 2023.104


PART OF THE NORTH 1/2 OF SECTION 1, T3N, R8E, WHITE LAKE TOWNSHIP, OAKLAND COUNTY, MICHIGAN










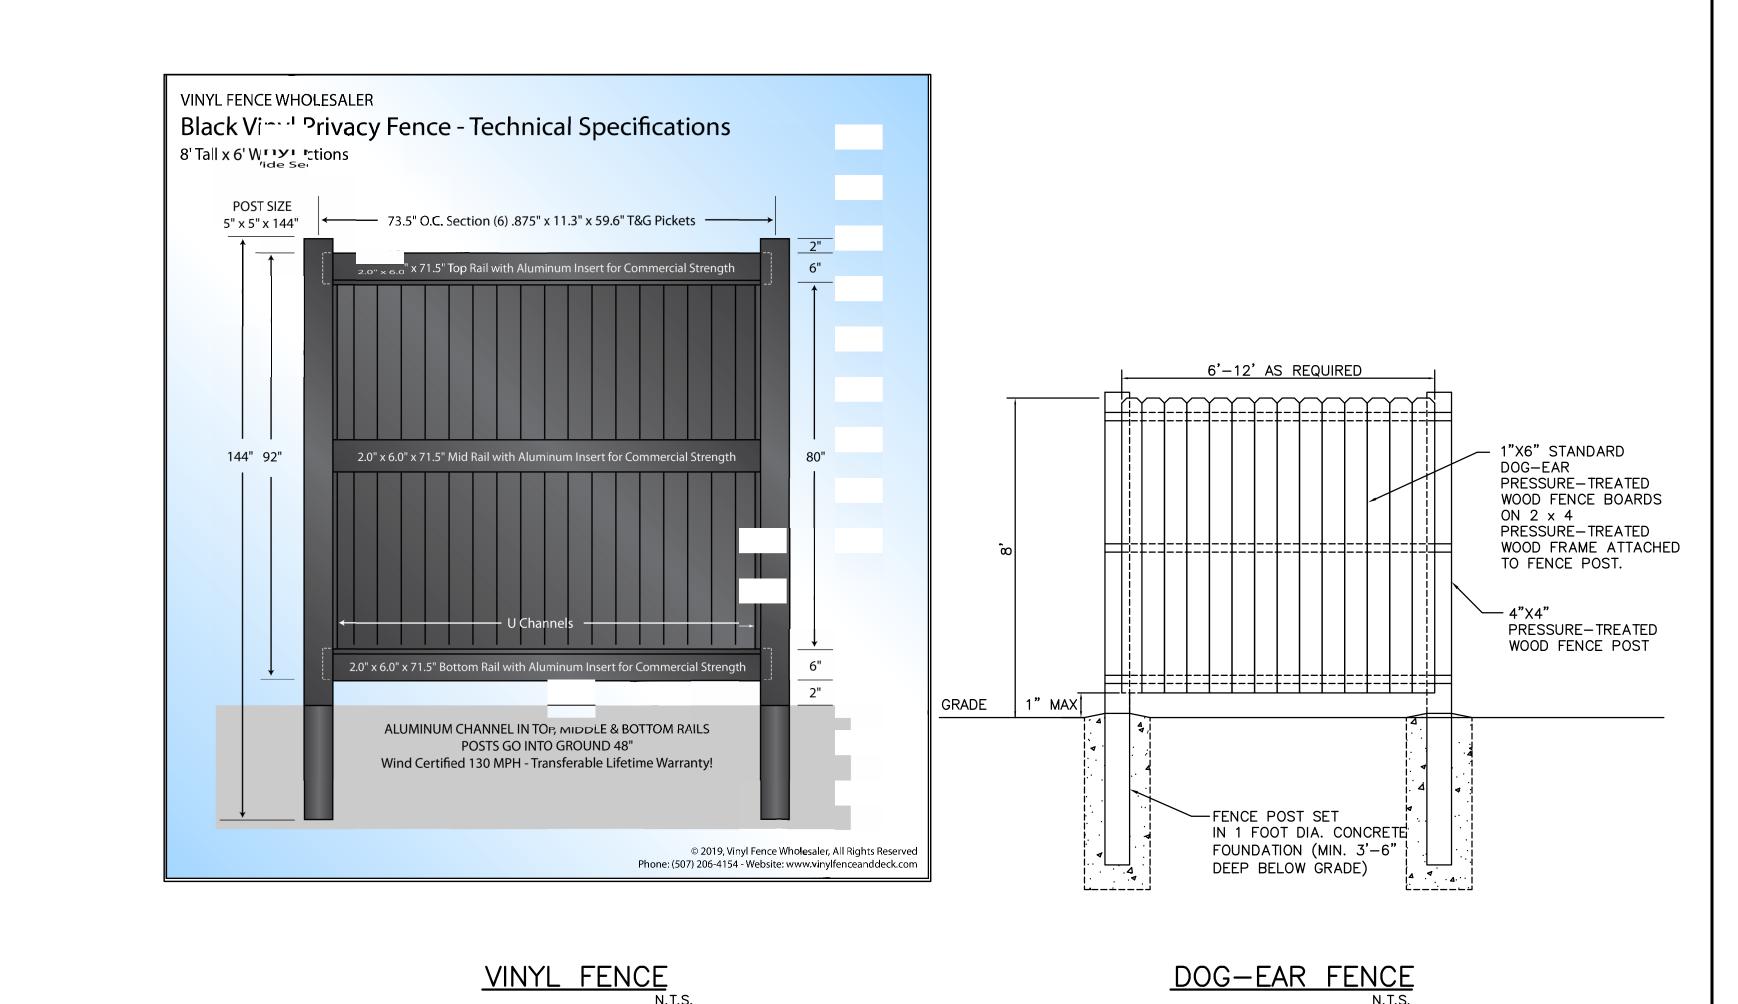

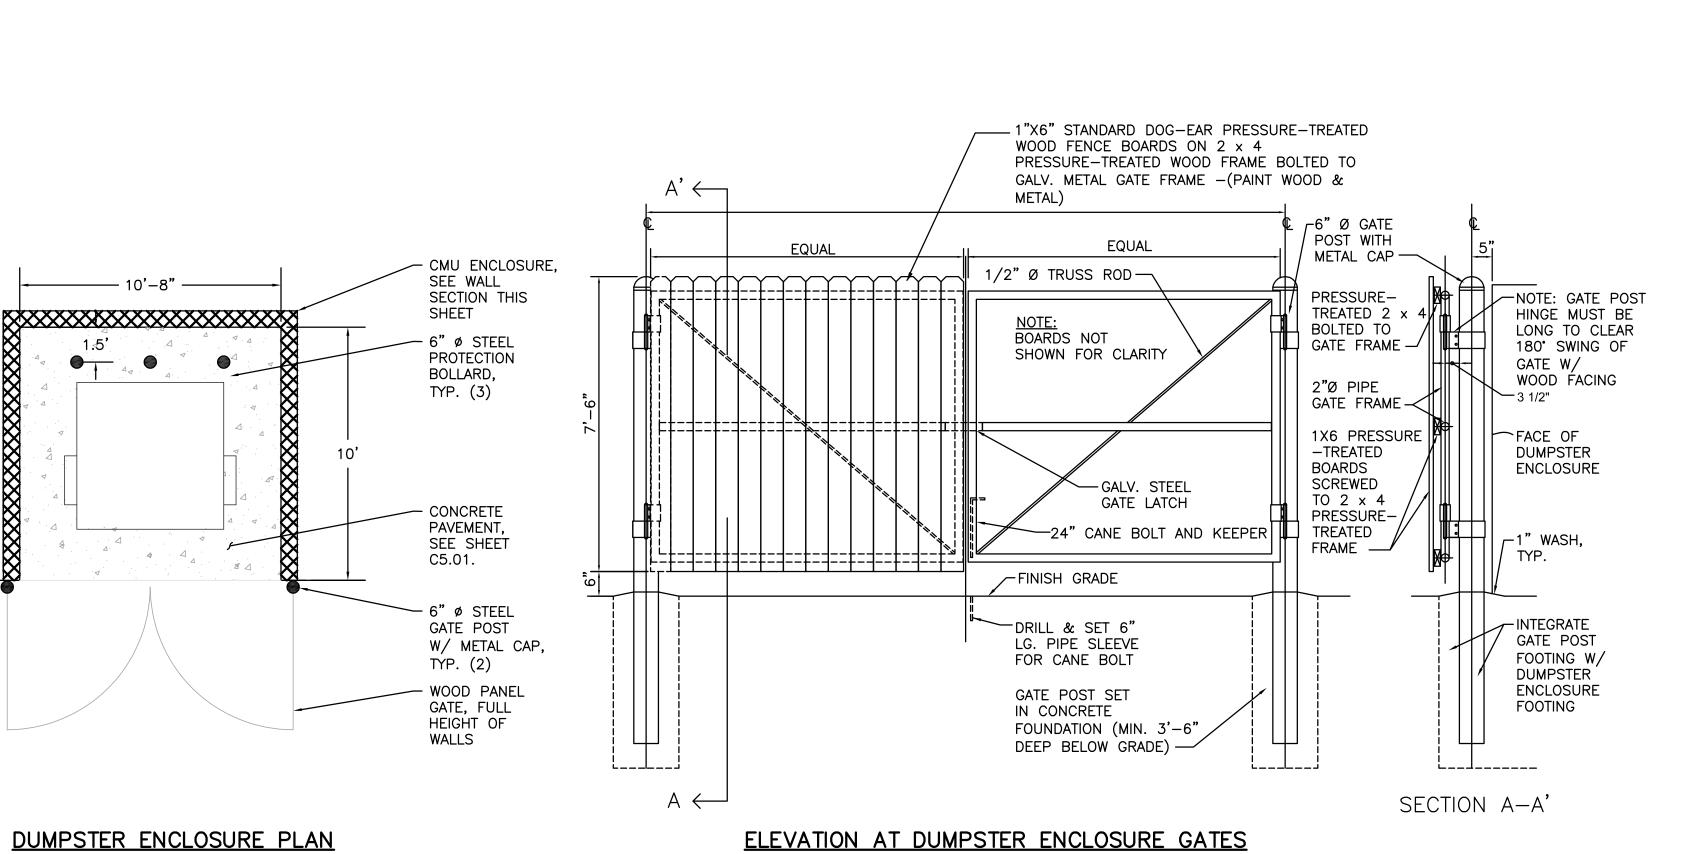

—<u>NOTE:</u> PROVIDE MIN. (1) HORIZONTAL SEALANT JOINT 20'-0" O.C. -STONE CAP W/CAST DRIP EDGE BOTH SIDES AND S.S. DOWELS AT 32" O.C. FLASHING UNDER STONE CAP & SEALANT BOTH -8" SPLIT FACE C.M.U. BLOCK GROUT SOLID INCLUDING COLLAR JT. FULL HT., SHALL MATCH BUILDING TYPE. -GROUT CELL SOLID DOWEL INTO FOOTING #5 VERT. REINFORCING AT 32" O.C. __EDGE EXPANSION JOINT, SEE DETAIL THIS SHEET. -CONCRETE PAVEMENT FINISH GRADE ─GROUT SOLID BELOW -CONCRETE FOUNDATION WITH (2) — #5 CONT. TOP AND BOTTOM

1 1/2 " HIGH CAP, OVERLAP METAL EDGES — GRIND METAL EDGES SMOOTH 6" SCHEDULE 40 STEEL PIPE FILLED WITH CONCRETE EXPANSION JOINT-1" WASH-GRADE-COURSE-ASPHALT PAVEMENT CONCRETE PAVEMENT 18" DIAMETER 4000 PSI CONCRETE BASE -EARTH OR AGGREGATE CASEY M. LEACH TYPICAL SECTIONS PROTECTION BOLLARD

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DUMPSTER ENCLOSURE WALL SECTION

(3 WORKING DAYS) BEFORE YOU DIG CALL MISS DIG 800-482-7171 OR 811


DETAILS - DUMPSTER ENCLOSURE & FENCING | SCALE: LASTING IMPRESSIONS


AS SHOWN SHEET NO: C5.02 PART OF THE NORTH 1/2 OF SECTION 1, T3N, R8E, KE 2023.104 WHITE LAKE TOWNSHIP, OAKLAND COUNTY, MICHIGAN

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ARCHITECTURAL ENGINEERING

J & A ARCHITECTURAL **ENGINEERING** 3250 W. BIG BEAVER RD. SUITE 233 TROY, MI 48084 P. 248.282.6475 F. 248.590.0257 azhermatty@gmail.com

OWNER NICK HOPSON, 248-930-2828

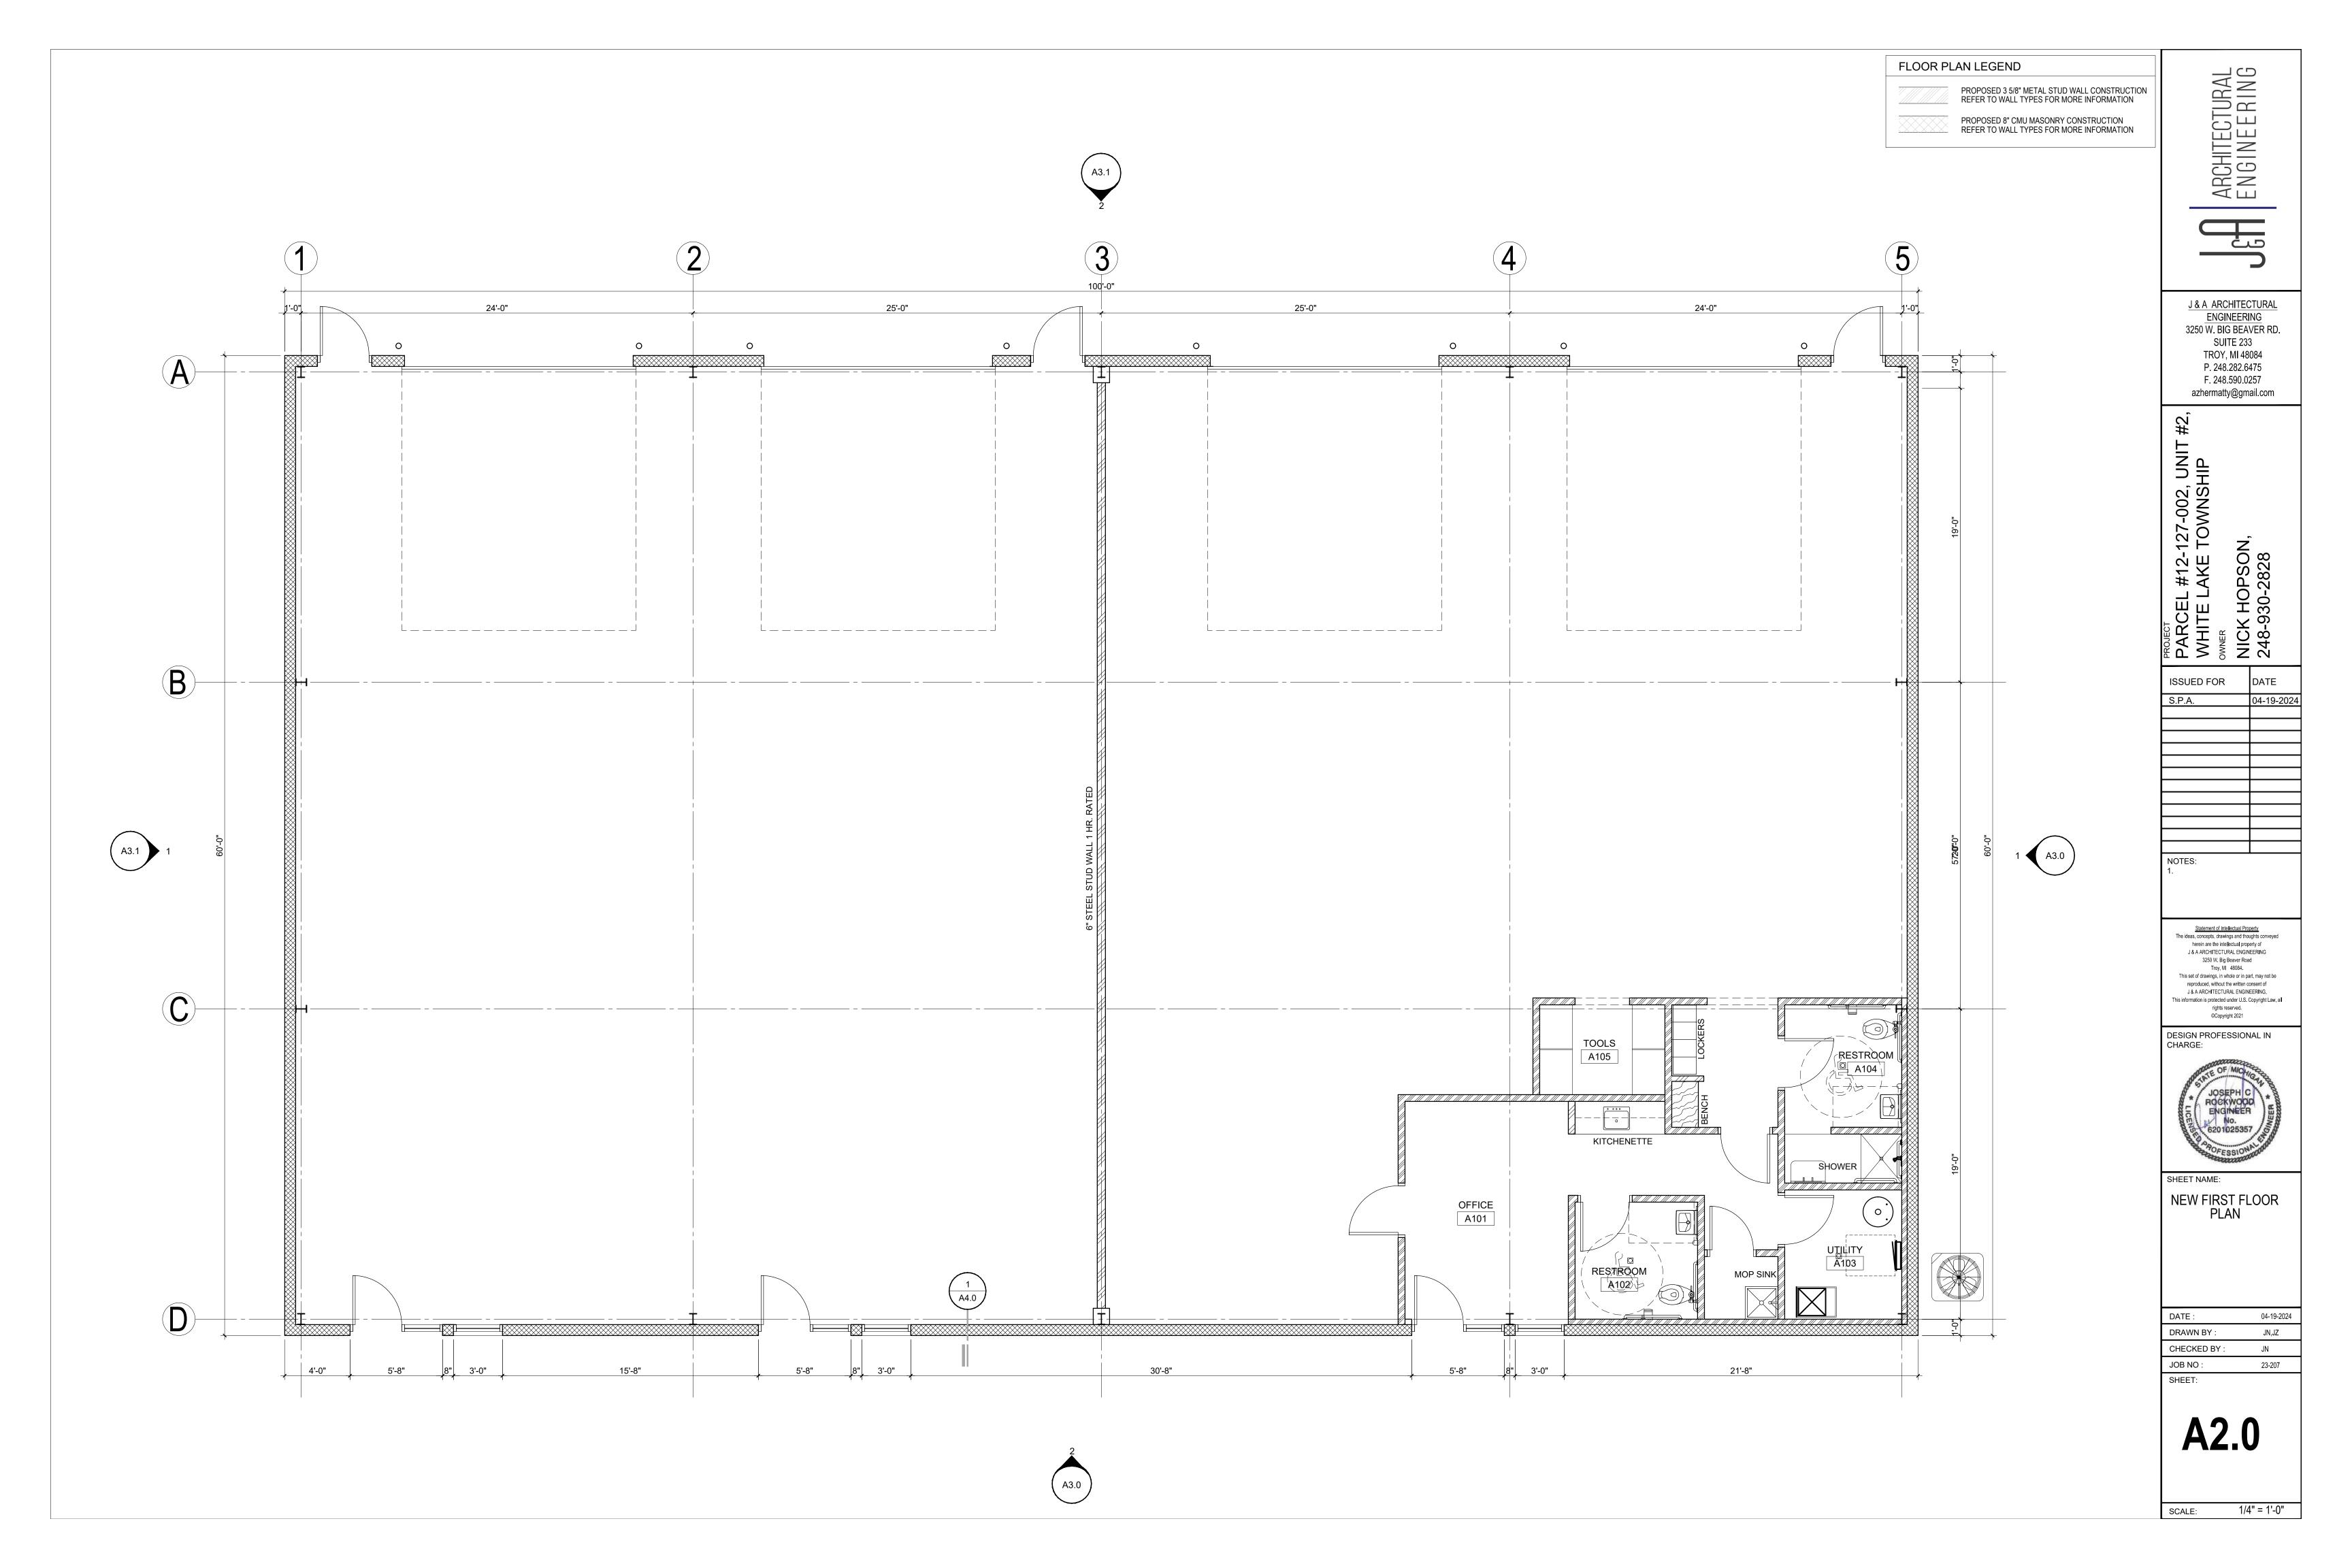04-19-2024
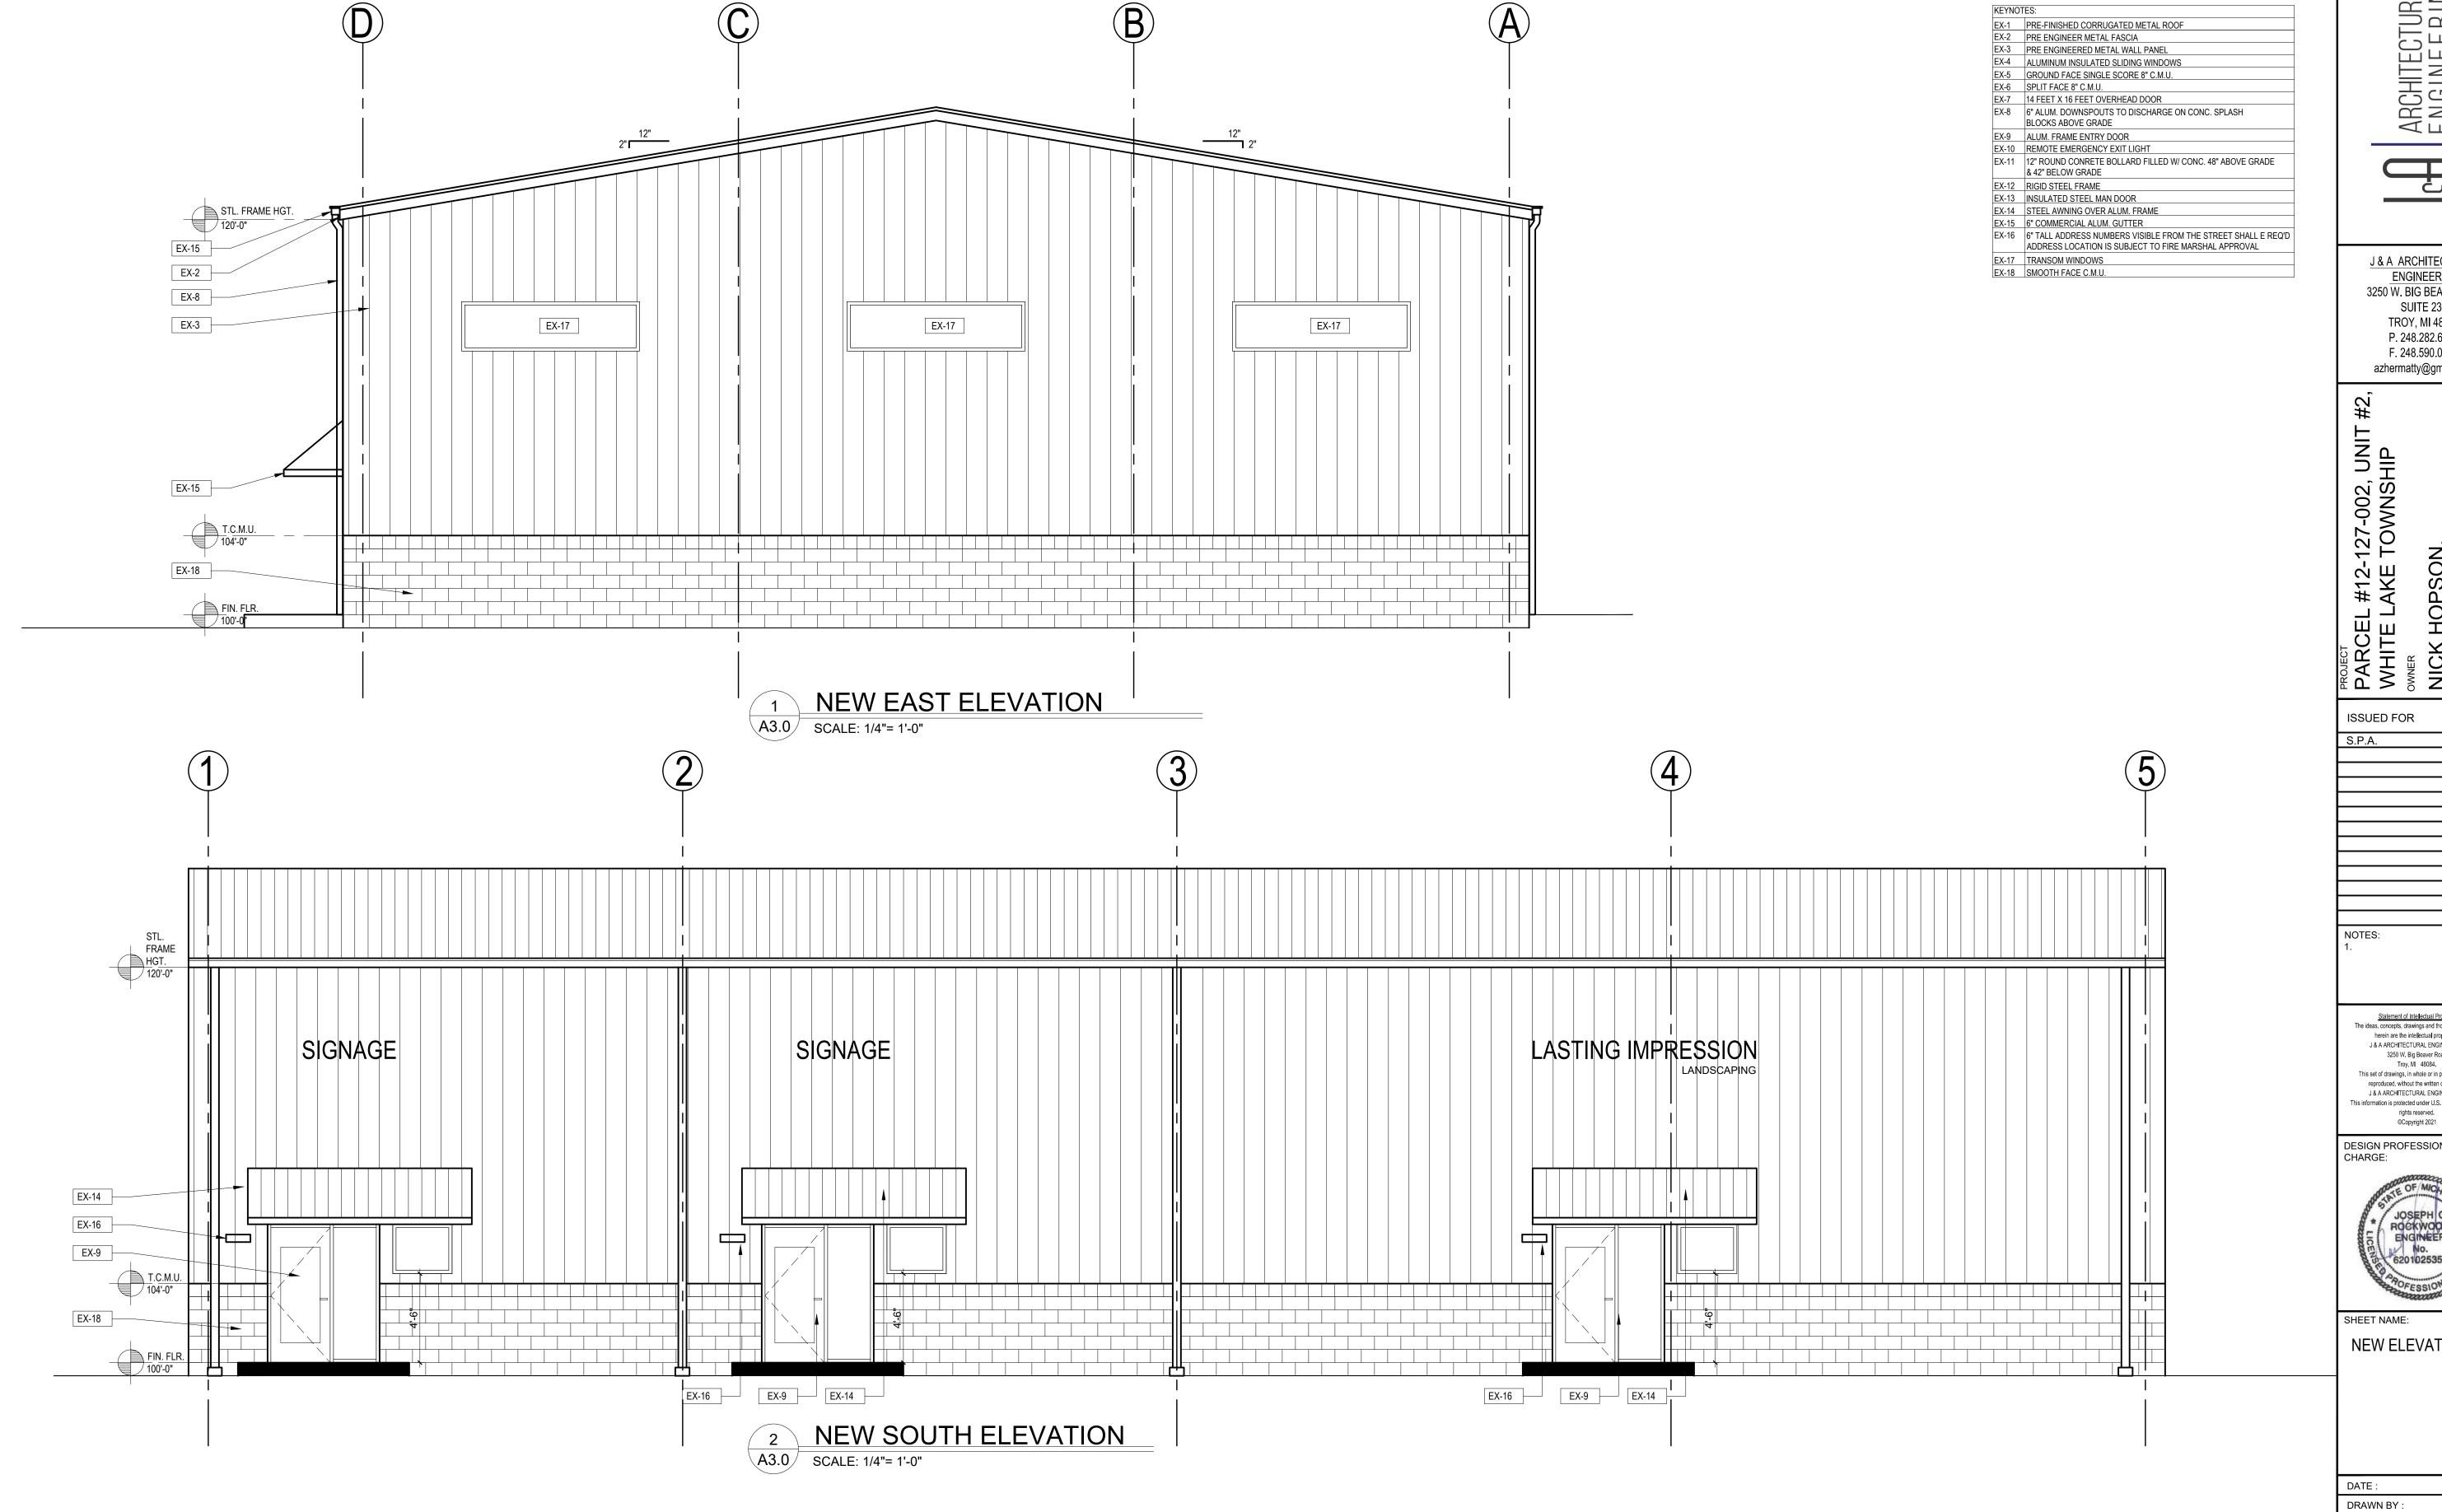
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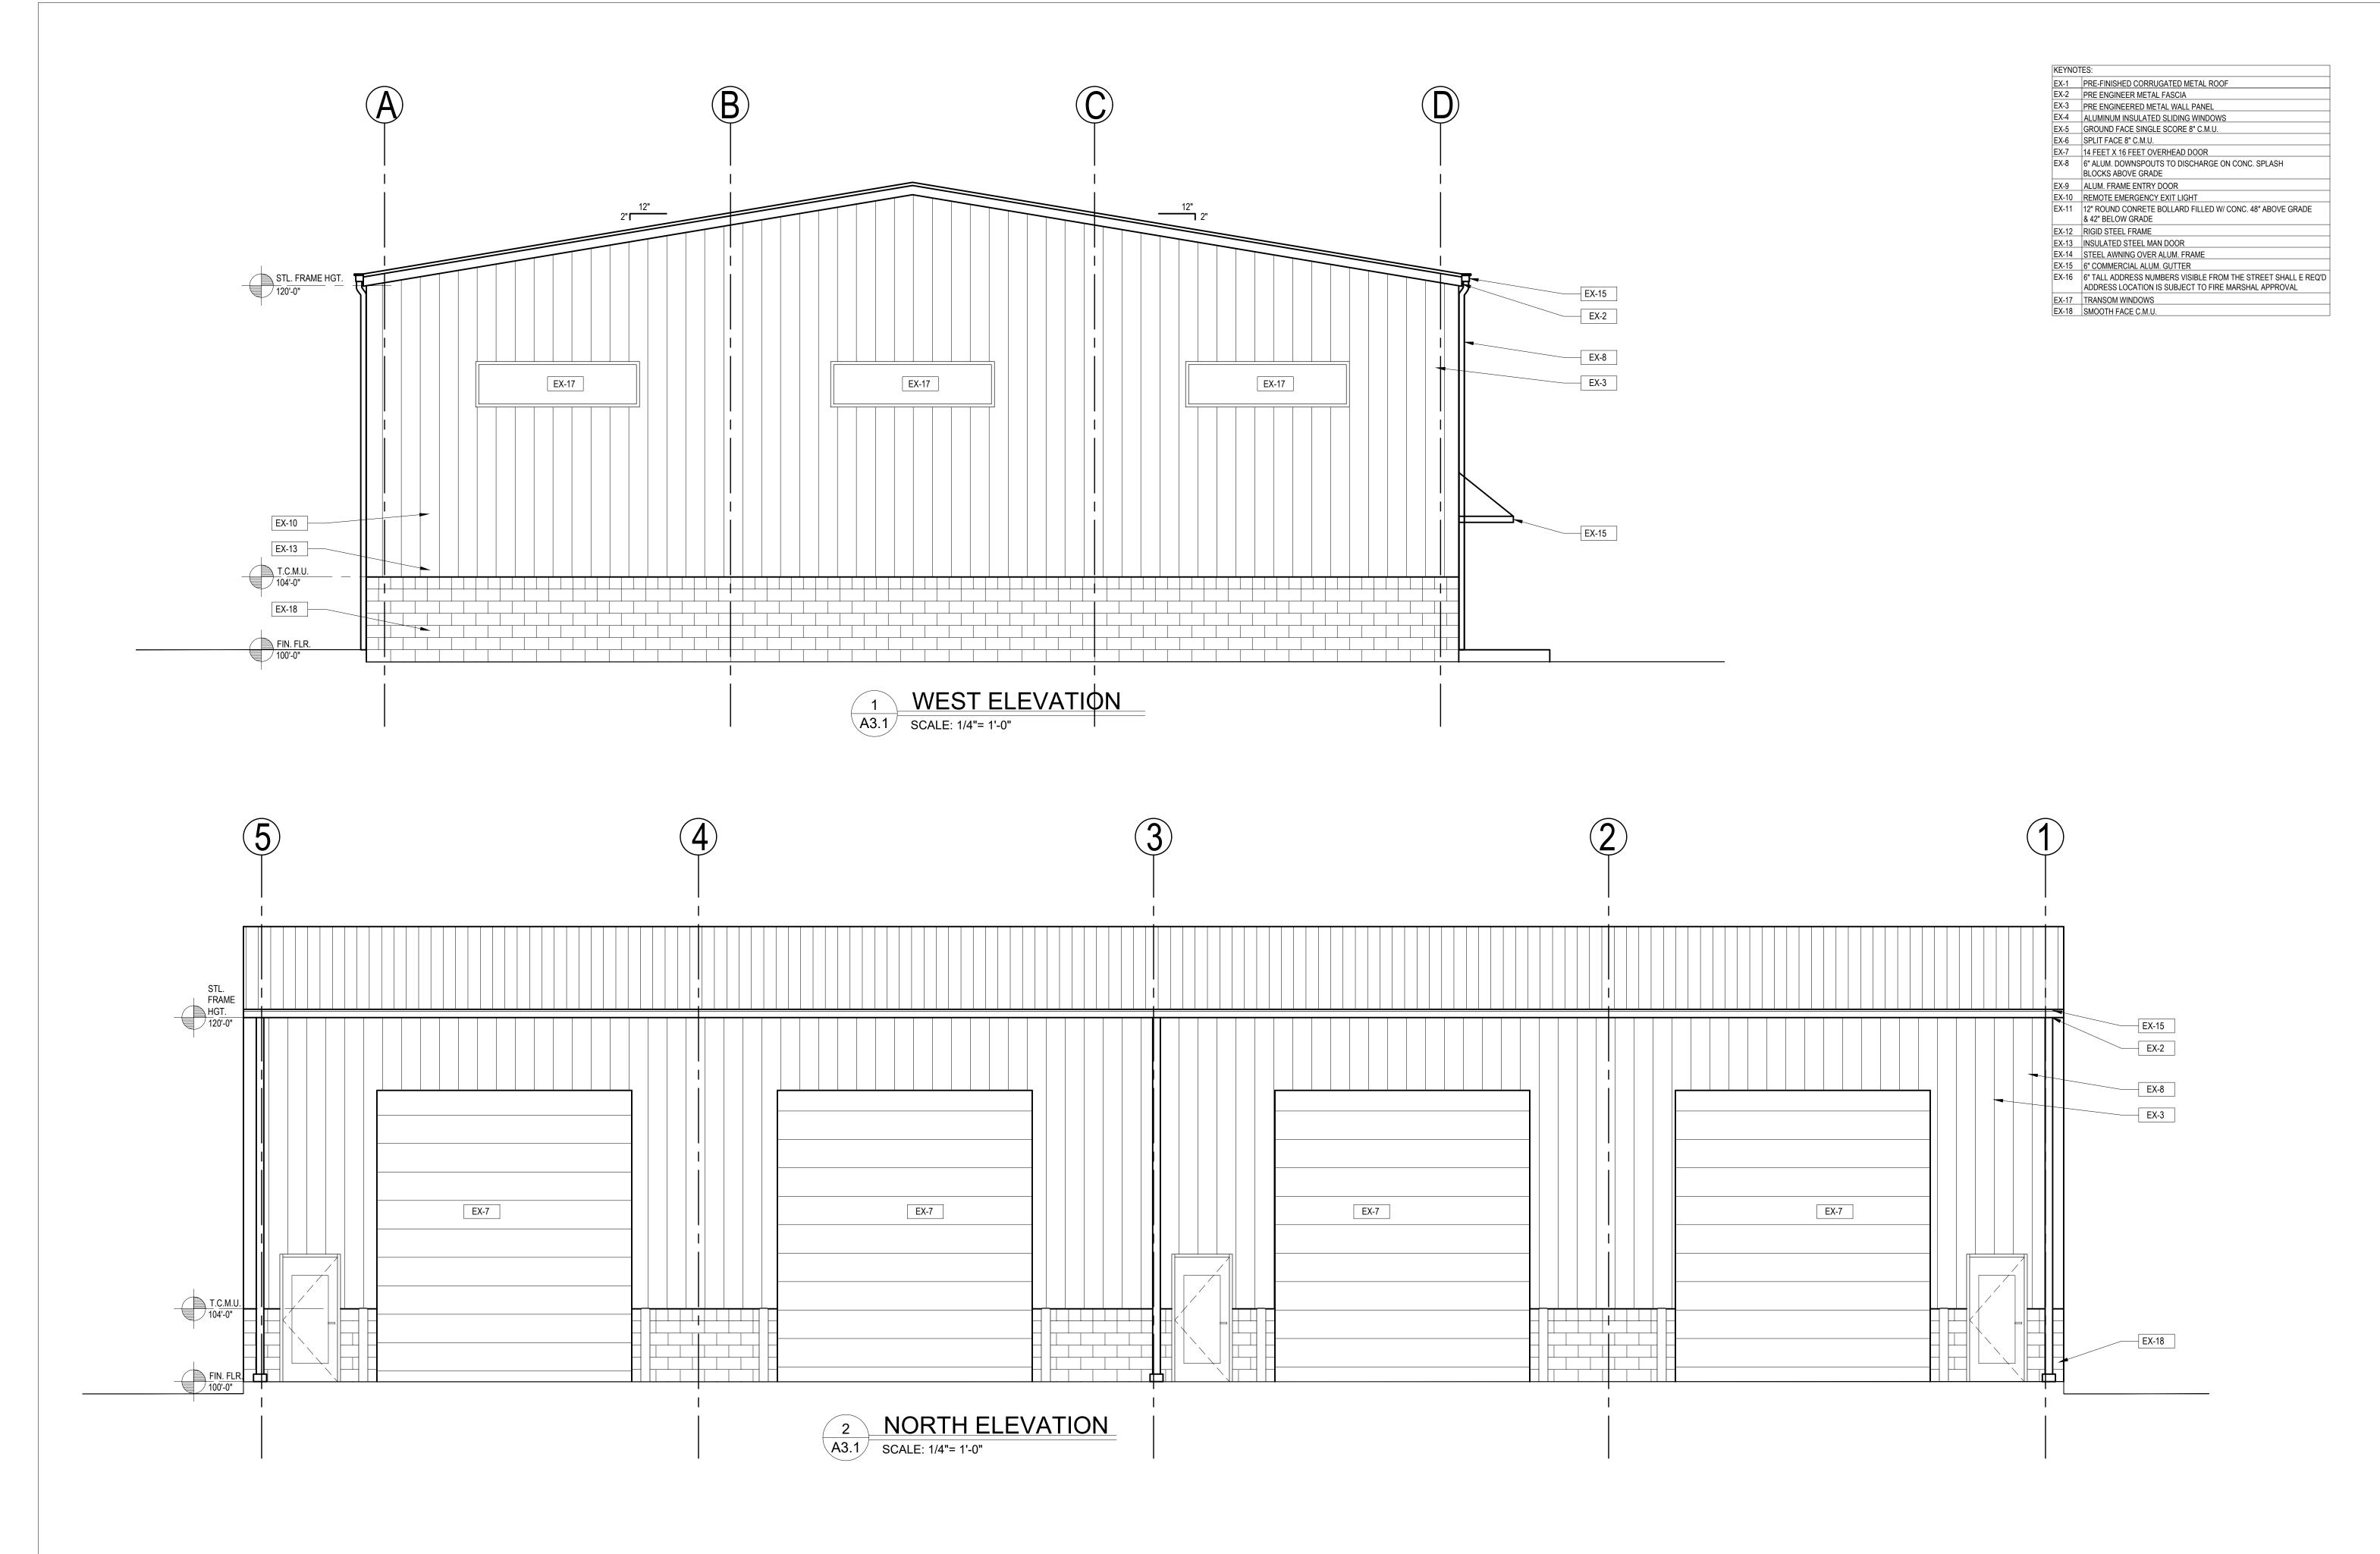


NEW ELEVATIONS

DATE :	04-19-2024
DRAWN BY :	JN,JZ
CHECKED BY:	JN
JOB NO :	23-207

A3.0

1/4" = 1'-0" SCALE:



ARCHITECTURAL ENGINEERING

J & A ARCHITECTURAL
ENGINEERING
3250 W. BIG BEAVER RD.
SUITE 233
TROY, MI 48084
P. 248.282.6475
F. 248.590.0257
azhermatty@gmail.com

PARCEL #12-127-002, UNIT #
WHITE LAKE TOWNSHIP
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NICK HOPSON,
248-930-2828

ISSUED FOR	DATE
S.P.A.	04-19-2024
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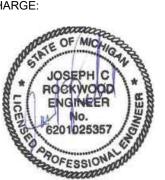
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ELEVATIONS

DATE :	04-19-2024
DRAWN BY :	JN,JZ
CHECKED BY:	JN
JOB NO :	23-207
SHEET:	

A3.1

SCALE: 1/4" = 1'-0"

ARCHITECTURAL ENGINEERING

J&A ARCHITECTURAL
ENGINEERING
3250 W. BIG BEAVER RD.
SUITE 233
TROY, MI 48084
P. 248.282.6475
F. 248.590.0257
azhermatty@gmail.com

LASTING IMPRESSIONS
LANDSCAPING, WHITE LAKE
TOWNSHIP

ISSUED FOR	DATE
REVIEW	04-13-2024

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SHEET:

WALL SECTION

DATE :	01-29-2024
DRAWN BY :	JZ
CHECKED BY:	AM
JOB NO :	23-207

A4.0

SCALE: 1/2" = 1'-0"