WHITE LAKE TOWNSHIP INTER-OFFICE MEMORANDUM

COMMUNITY DEVELOPMENT DEPARTMENT

DATE: August 19, 2024

TO: Rik Kowall, Supervisor

Township Board Members

FROM: Sean O'Neil, AICP

Planning Director

SUBJECT: Lakepointe

Final Site Plan Re-approval

Revised Planned Development Agreement Approval

Located on the northeast corner of Union Lake Road and Carpathian, consisting of approximately 13.32 acres. The property is currently zoned PD (Planned Development). Identified as parcel number 12-36-177-008.

The above request is now ready for Township Board Consideration. The matter was be considered by the Planning Commission at their regular meeting of August 15, 2024, at which time the Planning Commission recommended the Township approve the revised planned development agreement.

Please find the related documents:

- Draft minutes of the August 15, 2024 Planning Commission meeting
- Review letter prepared by the Township's engineer, Mr. Michael Leuffgen, dated April 10, 2024.
- Review letter prepared by the Township's former staff Planner, Justin Quagliata, dated April 2, 2024
- Review letter prepared by WLT Fire Chief, John Holland, dated March 26, 2024.
- □ Lakepointe's final engineering and site plans.
- Review letter prepared by the Township's engineer, Mr. Michael Leuffgen, dated August 7, 2024.
- □ Review letter prepared by the Township' attorney, Lisa Hamameh, dated July 30, 2024.
- □ Lakepointe's planned development agreement.

Please place this matter on the next available Township Board agenda. Do not hesitate to contact me should you need any additional information.

WHITE LAKE TOWNSHIP PLANNING COMMISSION AUGUST 15, 2024

CALL TO ORDER

Chairperson Seward called the meeting to order at 6:30 P.M. He then led the Pledge of Allegiance.

ROLL CALL

Present:

T. Joseph Seward, Chairperson
Debby Dehart
Scott Ruggles, Township Board Liaison
Merrie Carlock, Vice Chairperson
Mona Sevic
Robert Seeley
Pete Meagher
Matt Slicker
Steve Anderson

Others:

Sean O'Neil, Community Development Director Andrew Littman, Staff Planner Mike Leuffgen, DLZ Hannah Kennedy-Galley, Recording Secretary

APPROVAL OF AGENDA

MOTION by Commissioner Seeley, seconded by Commissioner Carlock to approve the agenda as presented. The motion carried with a voice vote: (9 yes votes).

APPROVAL OF MINUTES

A. <u>June 20, 2024</u>

Chairperson Seward wanted "round a bout" on the last page of the minutes to read "round-a-bout." MOTION by Commissioner Anderson, seconded by Commissioner Sevic to approve the minutes of June 20, 2024 as amended. The motion carried with a voice vote: (9 yes votes).

CALL TO THE PUBLIC (FOR ITEMS NOT ON THE AGENDA)

None.

PUBLIC HEARING

None.

CONTINUING BUSINESS

A. Lakepointe

Location: Located on the northeast corner of Union Lake Road and Carpathian, consisting of approximately 13.32 acres. The property is currently zoned PD (Planned Development). Identified as parcel numbers 12-36-177-008.

Request: i) Final site plan re approval

ii) Revised Planned development agreement approval

Applicant: Fairview Construction Company

Director O'Neil briefly went over the applicant's requests. Director O'Neil noted that the applicant's community benefit would be of a monetary nature due to the neighbor to the north of the site being unresponsive in regards to the previously proposed sidewalk extension.

Commissioner Carlock asked Director O'Neil if the pathway could be put in the right of way. Jason Emerine, Seiber Keast Lehner, said the right of way in front of Independence Village was not deeded and would require an easement from Independence Village. Independence Village was not aimable to an easement. There would be an additional \$7,500.00 donation to the Park fund from the applicant as well.

Commissioner Anderson asked staff if the money would be held for a future pathway in the area. Director O'Neil said no, the money allocation would go to make other connections, the funds would be used in a meaningful way.

Mr. Leuffgen briefly went over his engineering review. There were discrepancies regarding the estimated costs for the sidewalk donation.

Commissioner Anderson asked Mr. Emerine if a TIS was waived. Mr. Emerine stated that RCOC had requested a TIS, and it was done. The results from the study said that there was no impact to the traffic, and RCOC agreed with the findings from the study.

Commissioner Anderson asked staff if they felt all the outstanding items would be addressed prior to construction. Director O'Neil said all of the outstanding comments had to be addressed prior to a preconstruction meeting.

Commissioner Dehart said the proposed bypass lane was no longer shown on the plan. Mr. Emerine said the bypass lane was not warranted by the RCOC, so it was not included, and the previous FSP was approved without the plan.

Commissioner Meagher said all three developments (West Valley, Comfort Care, and Lakepointe) were dependent on West Valley for storm sewer. Mr. Emerine said Lakepointe had a detention basin, as did West Valley, and would outlet storm water by Cedar Island Road. Comfort Care had a retention basin, so stormwater would be absorbed by the ground. DPS Director Aaron Potter wanted each development to have their own easements with their own stormwater management agreements. Mr. Leuffgen added that West Valley had been issued a permit from EGLE for stormwater discharge.

WHITE LAKE TOWNSHIP PLANNING COMMISSION AUGUST 15, 2024

Michael Furnari, developer, said he was excited to get the project going and agreed to a \$8,700.00 donation to the pathway fund in lieu of the previously proposed offsite sidewalk community benefit.

MOTION by Commissioner Meagher, seconded by Commissioner Sevic, to re-approve the final site plan for Lakepointe, parcel identified as 12-36-177-008, subject to the review letters included in the packet being addressed and subject to addressing the comments made by the Township Attorney. The motion carried with a voice vote: (8 yes votes | Seeley no).

MOTION by Commissioner Meagher, seconded by Commissioner Anderson, to recommend approval to the Township Board for Lakepointe's revised planned development agreement, parcel identified as identified as 12-36-177-008 subject to addressing the remaining outstanding staff and consultant comments and subject to replacing the community benefit contribution off an offsite sidewalk with a monetary contribution for pathways in the amount of \$8,700.00, as agreed to by the developer this evening. The motion carried with a voice vote: (8 yes votes | Seeley no).

NEW BUSINESS

A. Review and discussion of the 2025-2030 draft Capital Improvement Plan (CIP)

Staff Planner Littman briefly went over the draft CIP. He summarized the increased cost estimates for each department's projects.

Commissioner Carlock asked staff if there was a list of completed projects. Staff Planner Littman said the projects that were completed were Triangle Trail, the Bogie Lake Water Extension, and the Aspen Meadows Wellhouse. He added that he would include these in the final CIP.

Commissioner Ruggles asked staff where the request for the backhoe machine was requested from. Director O'Neil said it was a request from the DPS department.

Commissioner Anderson asked staff if rating or cost drove the priority of a project. Director O'Neil said there were variables, but highly rated projects indicated a high need for a project.

Staff Planner said a water supply project from last year's CIP was removed from this year's report. The project was no longer necessary due to the anticipated Township Hall construction.

Commissioner Sevic asked for clarification regarding the amounts listed on the CIP Components table. The numbers listed in parentheticals was the number of sets requested, and a edit needed to be made to clarify the notation.

Commissioner Slicker stated that the backhoe machine project should have clarification regarding the cost sharing.

Commissioner Anderson said the overall funding statement was missing a figure that was referenced in the text. Staff said the text would be clarified.

WHITE LAKE TOWNSHIP PLANNING COMMISSION AUGUST 15, 2024

Commissioner Slicker noted that the Sewer Fund projects were listed to be paid by the General Fund. Director O'Neil said that would need to be clarified as well.

Commissioner Seeley asked if there were any other emergency water connections in the Township. Mr. Leuffgen confirmed, and said the one included in the CIP would be on Williams Lake Road, near Hess-Hathaway Park. Commissioner Seeley spoke highly to emergency water connections.

LIAISON'S REPORT

Commissioner Dehart said the August ZBA meeting was canceled, but the ZBA did meet in July. There were five cases heard. Three were approved, one was denied, and one was tabled.

Commissioner Carlock stated that Parks and Rec met for the first time in a few months. The contractor for Stanley Park was delaying, and the Township was considering asking the State to use the next lowest bidder. Director O'Neil authorized Beckett & Raeder to reach out to the next lowest bidder. The Fisk Farm Festival would be held September 7 and 8, 2024, and Trunk or Treat was scheduled for October 19, 2024. She added that the Parks and Rec millage passed, and she thanked the voters.

Commissioner Ruggles said the Township Board met today at special Board meeting to discuss the budget and approve the 2025 millage rates. He congratulated Commissioner Anderson on his election win.

PLANNING CONSULTANT'S REPORT

None.

DIRECTOR'S REPORT

Director O'Neil said the Planning Commission would meet on September 5, 2024 for the CIP public hearing as well as a public hearing for the Lasting Impressions special land use. There was a potential of a couple other items being eligible for the agenda too.

OTHER BUSINESS

Commissioner Sevic said the Fisk Farm festival was looking for volunteers.

COMMUNICATIONS

None

NEXT MEETING DATE: September 5, 2024

ADJOURNMENT

MOTION by Commissioner Carlock, seconded by Commissioner Sevic, to adjourn at 7:44 P.M. The motion carried with a voice vote: (9 yes votes).

April 10, 2024

Sean O' Neil, Director Community Development Department Charter Township of White Lake 7525 Highland Road White Lake, Michigan 48383

Lake Pointe – Final Site Plan and Final Engineering Plan –7th Review RE:

DLZ# 1745-0385-00

Dear Mr. O' Neil,

Our office has reviewed the above-mentioned revised plans prepared by Seiber, Keast, Lehner Engineering and dated February 13, 2024. These plans were reviewed for conformance with the Township Engineering Design Standards. We offer the following comments for your consideration:

Please note that comments from our December 21, 2023 review are listed in italics. Responses to those comments are listed in **bold**. New comments are listed in standard type.

Preliminary Site Plan Comments-The following comments from our Preliminary Site Plan review letter dated January 7, 2020 will need to be addressed:

Grading/Paving

1. The proposed bypass lane on the west side of the Union Lake Road has been removed from this submittal. We defer to Oakland County Road Commission regarding the requirements for this bypass lane. Comment remains as a notation.

Storm Sewer & Storm Water Management

1. The plans have been revised to utilize detention instead of retention. A detention basin outlet has been provided which will leave the site, cross Union Lake Road, and discharge through the West

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Valley site which is currently under common ownership. The FEP plans for both developments will need to be coordinated to ensure capacity is available in the West Valley development and proposed outlet. Condo Documents will need to be clarified for both developments regarding shared maintenance responsibility. The Road Commission for Oakland County will need to approve and permit the proposed storm sewer outlet crossing. Comment remains as a notation. We also note that the FEP plans for both developments have been coordinated and that

We also note that the FEP plans for both developments have been coordinated and that capacity is available in and accounted for in the West Valley storm sewer system. A supplemental sheet (Overall Storm Water Management System "West Valley & Lake Pointe") has been included in the FEP sets for both developments.

Final Site Plan/Final Engineering Plan Comments-

Grading/Paving

- 1. An off- site easement will be required from Independence Village for construction of proposed sidewalk should the area for construction fall outside the existing Union Lake Road right of way. Please verify location of right of way relative to proposed sidewalk. Comment remains. Design engineer has indicated that the applicant will be sending an easement request to the Independence Village owner requesting an easement for the sidewalk that is proposed across the Independence Village frontage. Comment remains as a notation.
- 2. Note that the grading plan has been reviewed for general conformance with the Township's requirements for grading. More detailed grading reviews will be conducted on individual buildings at time of plot plan submittal. **Comment remains as a notation.**

Sanitary Sewer

- 1. The sanitary sewer proposed along the Union Lake Road frontage is proposed to be constructed as part of the proposed West Valley development. Note that approval of this development is subject to the approval of that offsite sanitary sewer, and it must be available for use by this development. In addition, an off-site easement will be required from Independence Village granted to West Valley for construction of proposed sanitary sewer should the area for construction fall outside the existing Union Lake Road right of way. Please verify location of right of way relative to proposed sanitary sewer. Design engineer has noted that the existing sanitary sewer to the northwest along Union Lake Road is within the future 60' half right of way for Union Lake Road. Comment remains as a notation in regard to West Valley approval requirements.
- 2. It should be noted that the REU unit assignment factor of 0.6 REU per unit is acceptable for the purpose of capacity calculations however the Township Ordinance requires 1.0 REU per unit for the purpose of capital connection charges. **Comment remains as a notation.**

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3. Approvals/permits will be required from OCWRC and EGLE. Once sanitary sewer revisions have been addressed, please provide signed & sealed electronic set for submittal to WRC along with a completed part 41 Permit Application. Easement exhibits have been submitted for review and comments were provided in our April 6, 2021 review letter. Please provide revised easement exhibits for review. Comment addressed. Revised easement exhibits were submitted, and outstanding comments have been addressed. Please reference our April 28, 2021 PDA review letter. In addition, a signed and sealed electronic set for sanitary sewer permit application and a Part 41 permit application have recently been provided. We note that EGLE held the previous permit submittal until the sanitary sewer plans and permit application were submitted for West Valley. No sanitary sewer permit has been issued for Lake Pointe. Resubmittal of plans and permit application to EGLE is currently in process. Comment remains as a notation.

Watermain

- 1. The plans show a 20-foot-wide watermain easement which is acceptable. Easement exhibits shall be provided for review as attachments to the Township standard conveyance document. Easement exhibits have been submitted for review and comments were provided in our April 6, 2021 review letter. Please provide revised easement exhibits for review. Comment addressed. Revised easements exhibits were submitted, and outstanding comments have been addressed. Please reference our April 28, 2021, PDA review letter. Comment remains as a notation.
- 2. A permit will be required from EGLE for the watermain portion of the project. Once the watermain items have been addressed, please provide 5 signed & sealed hard copies of applicable plan sheets along with a completed, electronic Act 399 permit application for Township signature and submittal to EGLE. Comment outstanding; An EGLE Act 399 permit was issued April 14, 2021 and is valid for 2 years, so it is now expired. The permit will need to be renewed. Comment addressed. Signed and sealed plans and permit application for watermain permit renewal have been submitted electronically to our office; submittal to the appropriate agencies for permit renewal is currently in process.

Comment remains as a notation.

Stormwater Management

1. A Storm Water Management Facilities Easement, Maintenance Agreement and Lien document will need to be completed and exhibits provided for review. Easement exhibits have been submitted for review and comments were provided in our April 6, 2021 review letter. Please provide revised easement exhibits for review. Comment addressed. Revised easements exhibits were submitted, and

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April 10, 2024

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outstanding comments have been addressed. Please reference our April 28, 2021, PDA review letter. **Comment remains as a notation.**

- 2. Flows from the proposed detention basin for this development are proposed to be routed through proposed storm sewer in the proposed West Valley development to the southeast on the south side of Union Lake Road. Note that the West Valley development will require Final Engineering Plan approval prior to approval of Lake Pointe, since the feasibility of Lake Pointe will depend on installation of storm sewer within the West Valley development. Comment remains as a notation.
- 3. The footings for the proposed retaining wall along the east and southeast part of the property will need to be placed such that the footings have no negative influence with respect to vertical or lateral stresses on the adjacent storm sewer. Please verify this will not occur. Comment partially addressed. The design engineer has stated that "The retaining wall has not yet been designed. The retaining wall has been shifted so the face of wall is at least 10 feet away (horizontally) from the storm sewer. Given that the depth of the storm sewer is less than 10 feet and that the retaining wall will have some sort of buried foundation depth, the retaining wall foundation loads on underlying soils should not have an influence on the storm sewer." We request that the engineer who will design the wall provide an analysis of the loads and potential impacts the wall may have on surrounding utilities. Please provide completed analysis to our office. Comment addressed; signed & sealed wall design calculations have been provided. Note the wall calculations have not been reviewed by this office but will be filed with the project documents for future reference. Comment remains as a notation.
- 4. Since Lake Pointe is dependent on West Valley for conveyance of stormwater flows from the Lake Pointe site, we are requesting confirmation from EGLE that they are aware of Lake Pointe's stormwater contribution to West Valley's ultimate stormwater outlet and that EGLE has evaluated and approves of this. This confirmation shall be required prior to final engineering approval for Lake Pointe.

Required Permits and Approvals

The following permits and approvals will be required:

- 1. Permit from the Road Commission for all work within the Union Lake Road Right-Of-Way including the proposed storm sewer crossing.
- 2. SESC permit from OCWRC. Permit #000698-2021-CO issued 2021.
- 3. A Notice of Coverage for Stormwater Discharge under the NPDES program as administered by EGLE is required.
- 4. Watermain permit from EGLE (Expired)- Renewal of permit in progress.

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- 5. Sanitary sewer permit from OCWRC (We found record of approval from May 17, 2021; OCWRC Job #S21-0125 CW). It will have to be determined if this is still valid or if resubmittal is required.
- 6. Sanitary sewer permit from EGLE (We recall EGLE was holding their review of plans until West Valley plans were submitted for review concurrently)
- 7. Executed Stormwater Maintenance Agreement
- 8. Easements for Sanitary Sewer and Watermain
- 9. Sidewalk easement from Independence Village

Recommendation

The plans are approvable subject to the applicant acquiring the approvals/permits referenced above, and the related West Valley approvals including that mentioned in Comment 4 under Stormwater Management above.

Please contact our office should you have any questions.

Sincerely,

DLZ Michigan

Michael Leuffgen, P.E. Department Manager

M feeg

Victoria Loemker, P. E.

Senior Engineer

Cc:

Justin Quagliata, Community Development, via email Hannah Kennedy-Galley, Community Development, via email Aaron Potter, DPS Director, White Lake Township, via email Jason Hanifen, Fire Marshall, White Lake Township, via email

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Rik Kowall, Supervisor Anthony L. Noble, Clerk Mike Roman, Treasurer



Trustees Scott Ruggles Liz Fessler Smith Andrea C. Voorheis Michael Powell

WHITE LAKE TOWNSHIP

7525 Highland Road • White Lake, Michigan 48383-2900 • (248) 698-3300 • www.whitelaketwp.com

April 2, 2024

JMF White Lake, LLC 1700 W. Big Beaver Road, Suite 120 Troy, MI 48084

ATTN: Michael Furnari

RE: Lake Pointe – Final Site Plan Backcheck #4

Parcel Number 12-36-177-003

Dear Mr. Furnari:

Community Development Department staff have completed the second backcheck for the above referenced project. The following comments from the previous backcheck dated December 26, 2023 are listed below. Responses to those comments are provided in (green).

- All required landscape areas in excess of 200 square feet shall be irrigated to assist in maintaining a healthy condition for all plantings and lawn areas. An irrigation plan shall be provided. (Comment outstanding). (Comment addressed. Sheet LS-3 has been revised accordingly). (Note: an irrigation plan dated February 3, 2024 (revision date February 21, 2024) has been provided).
- All required site irrigation systems shall include a rain sensor or similar measure to ensure irrigation does not occur during or shortly after precipitation events. All site plans shall note installation of required irrigation.
 Add note to landscape plan. (Comment addressed. A note has been added to Sheet LS-3).
- Trees shall not be planted closer than four feet to a property line. Add note to landscape plan. (Comment partially addressed. Note 22 has been added to Sheet LS-1. However, the spelling of the word "planted" is incorrect and shall be addressed). (Comment addressed. Note 22 has been revised).
- Trees identified for protection during construction and the means of protection shall be identified prior to final site plan. No construction shall occur until tree protection has been installed and approved by the Community Development Director. Add note to landscape plan. (Comment addressed. A note has been added to Sheet LS-3).
- Austrian Pine and White Pine are not an acceptable evergreen tree. Pine trees are prohibited in the Township. Revise landscape plan to provide an acceptable species of evergreen tree and remove all references to pine trees. (Comment partially addressed. The landscape legend on Sheet LS-2 still lists pine species. Revise the landscape legend accordingly). (Comment remains outstanding). (Comment outstanding. Contrary to the response letter, the landscape legend on Sheet LS-2 still needs revision).

- No more than two planted trees in a row shall be of the same species. <u>Revise landscape plan.</u> (<u>Comment outstanding</u>). (<u>Comment addressed</u>. <u>Tree cluster/grouping planting notes have been added to Sheet LS-2</u>).
- The landscape plan mentions mulch. Per the Zoning Ordinance, the mulch product itself shall be at least doubled-shredded quality. Revise landscape plan. (Comment partially addressed. The tree planting, evergreen planting, and shrub planting details on Sheet LS-2 still do not note double-shredded mulch. Revise accordingly). (Comment addressed. The details on Sheet LS-3 have been revised accordingly).
- As stated in previous correspondence (dated February 22, 2021), the building materials shall be labeled on the building elevations, Sheets A201 and A203. (Comment outstanding). (Comment remains outstanding). (Comment addressed. Material notations have been added to the elevations).
- As stated in previous correspondence (dated February 22, 2021), <u>elevations and building material details</u> <u>shall be provided for the clubhouse building.</u> (Comment addressed. Community building elevations have been provided).
- Architectural plan sheets A101, A102, A200, A201, A203 all list West Valley list in the title block. While the residential buildings proposed between both projects are the same, plans in the Lake Pointe plan set shall be titled as such. Revise accordingly. (Comment outstanding). (Comment addressed. The title blocks on the aforementioned sheets have been revised).
- As stated in previous correspondence (dated February 22, 2021), Sheet LS-5 indicates a decorative street light is proposed adjacent to the entrance of the development, and pedestrian bollard lighting is proposed at several places along the internal sidewalk network. Neither of the lighting types are full cutoff luminaries as required for outdoor lighting. However, the Zoning Ordinance permits non-cutoff fixtures if they are decorative pedestrian fixtures less than 100 watts and pedestrian fixtures shall not use clear globes. Wattage for each luminaire shall be noted on Sheet LS-5, and lighting fixture specification sheets (cut sheets) shall be submitted for the two aforementioned luminaries. (Comment outstanding). (Comment remains outstanding). (Comment addressed. Luminaire wattage has been added to Sheet LS-5 and cut sheets have been provided for both of the aforementioned luminaries).
- The lighting fixture specification sheet (cut sheet) shall be submitted for the proposed entrance sign panel "uplighting." The method of sign illumination is subject to review and approval by the Planning Division. Note uplighting is prohibited in the Township and the sign panel uplighting detail on Sheet LS-4 shall be removed. (Comment addressed. The sign panel uplighting detail on Sheet LS-5 have been removed).

Prior to scheduling a pre-construction meeting, the following items shall be addressed: (Comments outstanding). (Comments remain outstanding).

- Planned Development Agreement (PDA) review and approval. (A revised PDA, submitted April 1, 2024, is currently under review).
- Final Engineering Plan (FEP) review and approval (completed administratively).
- Provide documentation satisfactory to the Township Attorney evidencing ownership of the property.

- Submit-reciprocal access pathway/sidewalk easement agreement (must be reviewed, approved, and executed prior to scheduling a pre-construction meeting).
- Submit required utility (water, sewer, storm sewer) easement agreements (must be reviewed, approved, and executed prior to scheduling a pre-construction meeting).
- Provide a construction cost estimate sealed by the design engineer.
- Provide inspection fees (payable at the pre-construction meeting).
- Provide Certificates of Insurance listing DLZ and the Township as Additional Insured. Note XCU (Explosion, Collapse, and Underground) coverage must be provided.
- Provide a copy of all applicable agency permits to Township (must be submitted prior to scheduling a preconstruction meeting).
- Five (5) hard copies of the final plans must be brought to the pre-construction meeting for signing/stamping.

If you have any questions regarding this matter, please contact me at (248) 698-3300 ext. 177 or by email at justing@whitelaketwp.com.

Sincerely,

Justin Quagliata Staff Planner

Justin Quagliata

cc: Sean O'Neil, Community Development Director Nick Spencer, Building Official

Michael Leuffgen, DLZ Victoria Loemker, DLZ

Jason Emerine, Seiber Keast Lehner, Inc.



Site / Construction Plan Review

To: Sean O'Neil, Planning Department Director

Date: 03/26/24

Project: Lake Pointe

File #: Not Shown

Date on Plans: 02/13/24 (revision)

The Fire Department has the following comments with regard to the revised plans for the project known as Lake Pointe:

The Fire Department has no further comments regarding this project as submitted.

John Holland Fire Chief Charter Township of White Lake (248)698-3993 jholland@whitelaketwp.com

Plans are reviewed using the International Fire Code (IFC), 2015 Edition and Referenced NFPA Standards.

LEGAL DESCRIPTION

LEGAL DESCRIPTION - OVERALL PARCEL RECOMBINATION: A PARCEL OF LAND BEING A PART OF THE SOUTHEAST 1/4 OF THE NORTHWEST 1/4 OF SECTION 36, T.3N., R.8E., WHITE LAKE TOWNSHIP, OAKLAND COUNTY, MICHIGAN, BEING MORE PARTICULARLY DESCRIBED AS FOLLOWS:

COMMENCING AT THE NORTH 1/4 POST OF SAID SECTION 36, T.3N., R.8E., OAKLAND COUNTY, MICHIGAN, THENCE PROCEEDING ALONG THE NORTH AND SOUTH 1/4 LINE OF SAID SECTION 36, SOUTH 00 DEGREES 03 MINUTES 47 SECONDS EAST, 1315,77 FEET TO THE NORTHEAST CORNER OF THE SOUTHEAST 1/4 OF THE NORTHWEST 1/4 OF SAID SECTION, THENCE IN PART ALONG THE WESTERLY LINE OF BOCOVINA COUNTRYSIDE HOMES, OAKLAND COUNTY PLAN NO. 755, MASTER DEED AS RECORDED IN LIBER 12457, PAGES 419 THROUGH 492, 1ST AMENDMENT AS RECORDED IN LIBER 13514 PAGES 811 THROUGH 817 OAKLAND COUNTY RECORDS, SOUTH 00 DEGREES 1 MINUTES 25 SECONDS EAST, 475.18 FEET; THENCE ALONG THE NORTHWESTERLY LINE OF CARPATHIAN DRIVE AS RECORDED IN BOCOVINA HOMESITES, OAKLAND PLAN NO 754, MASTER DEED AS RECORDED IN LIBER 12457, PAGES 493 THROUGH 563, 1 COUNTY RECORDS, SOUTH 46 DEGREES 03 MINUTES 08 SECONDS WEST, 590.14 FEET TO THE CENTERLINE OF UNION LAKE ROAD, THENCE ALONG THE ARC OF A CURVE T THE RIGHT, RADIUS 1432.69 FEET, CENTRAL ANGLE 12 DEGREES 18 MINUTES SECONDS, (THE CHORD OF SAID CURVE BEARS NORTH 42 DEGREES 30 MINUTES 0 THENCE CONTINUING ALONG SAID CENTERLINE THE FOLLOWING TWO COURSES NORTH 36 DEGREES 21 MINUTES 05 SECONDS WEST, 21.54 FEET AND NORTH 3 DEGREES 44 MINUTES 42 SECONDS WEST, 468.27 FEET: THENCE NORTH 21 DEGREES 07 MINUTES 22 SECONDS EAST, 307.10 FEET: THENCE SOUTH 88 DEGREES 3 MINUTES 43 SECONDS EAST 812.20 FEET TO THE POINT OF BEGINNING OF TH PARCEL HEREIN DESCRIBED. CONTAINING 580,140 GROSS SQUARE FEET OR 13.32 GROSS ACRES OF LAND, MORE OR LESS. ALSO BEING SUBJECT TO THE RIGHTS OF THE PUBLIC AND/OR ANY OTHER GOVERNMENTAL UNIT IN ANY PART OF UNION LAKE ROAD TAKEN, USED OR DEEDED FOR STREET, ROAD, HIGHWAY OR PUBLIC UTILITY PURPOSES. ALSO BEING SUBJECT TO ANY OTHER EASEMENTS, RESTRICTIONS OR CONDITIONS OF RECORD. SIDWELL NOS.: 12-36-177-003, 12-36-177-002.

- AT (248) 334-9901 48 HOURS PRIOR TO BEGINNING OF CONSTRUCTION. THE CONTRACTOR SHALL KEEP THE INSPECTOR APPRAISED OF THE NEED FOR INSPECTION ON A DAY TO DAY BASIS. LACKING SPECIFIC SCHEDULING WITH THE INSPECTOR, THE CONTRACTOR SHALL GIVE 48 HOURS NOTICE TO THE TOWNSHIP ENGINEER PRIOR TO RECOMMENCING WORK REQUIRING INSPECTION. FAILURE TO INFORM THE INSPECTOR OR THE TOWNSHIP ENGINEER OF A WORK CANCELLATION MAY RESULT IN A ONE HALF DAY INSPECTION CHARGE TO THE DEVELOPER.
- 2. THE DEVELOPER SHALL CONTACT THE TOWNSHIP PLANNING DEPARTMENT AT (248) 698-3300 TO SCHEDULE A PRE-CONSTRUCTION MEETING. THE DEVELOPER'S PRIME SITE CONTRACTOR SHALL ATTEND. A COPY OF ALL PERMITS MUST BE SUBMITTED TO THE PLANNING DEPARTMENT PRIOR TO SCHEDULING THE MEETING.
- CONTRACTOR SHALL CONTACT MISS DIG AT 1-800-482-7171 72 HOURS IN ADVANCE OF CONSTRUCTION, FOR EXISTING UNDERGROUND UTILITY LOCATIONS.
- CONTAINED ON-SITE.
- UNDER OR WITHIN 1 ON 1 INFLUENCE OF ANY PAVEMENT (INCLUDING SIDEWALKS), EXISTING OR PROPOSED, OR WHERE SAND BACKFILL IS CALLED FOR ON THE PLAN, SHALL BE BACKFILLED AND COMPACTED WITH GRANULAR MATERIAL (SAND) MDOT CLASS II TO 95 PERCENT MAXIMUM UNIT DENSITY (ALL OTHERS 90 PERCENT).
- EXPOSE EXISTING UTILITIES AT THE PROPOSED UTILITY CROSSINGS PRIOR TO THE START OF UNDERGROUND IMMEDIATELY REPORTED TO THE PROJECT ENGINEER.
- 8. WHERE TWO UTILITIES CROSS, INCLUDING SANITARY SEWER LEADS, PROVIDE POROUS GRADE "B" BACKFILL MATERIAL
- 10. ANY MUD TRACKED ONTO UNION LAKE ROAD SHALL BE
- THE RESPONSIBILITY OF THE CONTRACTOR TO IDENTIFY THE AREA TO BE DEWATERED, SUBMIT A DEWATERING PLAN TO THE WHITE LAKE TOWNSHIP ENGINEERING DIVISION FOR REVIEW, TO MONITOR AND TO DETERMINE THAT THERE WILL NOT BE ANY IMPACT TO ANY ADJOINING OR OFFSITE PROPERTIES DEWATERING PROCEDURES SHALL BE IN COMPLIANCE WITH WHITE LAKE TOWNSHIP.
- ROAD RIGHTS-OF-WAY (OR ANY PUBLIC ROAD
- PARKING SIGNS SHALL COMPLY WITH THE DESIGN AND ON UNIFORM TRAFFIC CONTROL DEVICES.
- 15. WHITE LAKE TOWNSHIP HAS NO RESPONSIBILITY TO IMPROVE OR MAINTAIN THE PRIVATE STREETS CONTAINED WITHIN OR PRIVATE STREETS PROVIDING ACCESS TO THE PROPERTY
- FULL-TIME CONSTRUCTION OBSERVATION WILL GENERALLY BE REQUIRED DURING ALL PHASES OF UNDERGROUND SITE CONSTRUCTION INCLUDING INSTALLATION OF SANITARY SEWER. STORM SEWERS, DRAINS, WATER MAINS AND APPURTENANCES AS WELL AS PRIVATE STREET CURBING AND PAVING CONSTRUCTION. INTERMITTENT OBSERVATIONS WILL BE MADE FOR SITE GRADING, PARKING LOT CURBING AND PAVING, RETAINING WALL CONSTRUCTION AND OTHER SURFACE


A MULTI FAMILY DEVELOPMENT SECTION 36, TOWN 3 NORTH, RANGE 8 EAST, WHITE LAKE TOWNSHIP, OAKLAND COUNTY, MICHIGAN PREPARED FOR:

ENGINEERING CONSTRUCTION PLANS FOR

LAKE POINTE

JMF, WHITE LAKE, LLC

1700 W. BIG BEAVER ROAD, STE. 120 TROY, MI 48084 PHONE: (248) 602-2220

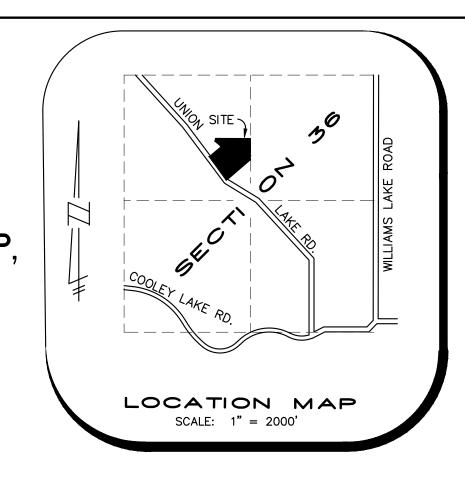

BENCHMARKS

BM#1 - CONCRETE MONUMENT AT SOUTHWEST CORNER OF ELEVATION: 948.29 NAVD88

BM#2 - TELECOM MANHOLE COVER AT NORTHEAST CORNER OF CARPATHIAN DRIVE AND UNION LAKE ROAD. ELEVATION: 984.75 NAVD88

BM#3 - TELECOM MANHOLE COVER ±485' WSET OF CENTER OF SECTION 36 ALONG THE SOUTH PROPERTY LINE. ELEVATION: 962.72 NAVD88

NGS PID DI6198 ELEVATION 966.63 NAVD88

GENERAL NOTES

- THE CONTRACTOR SHALL CONTACT THE TOWNSHIP ENGINEER
- 3. ALL CONSTRUCTION MUST CONFORM TO THE CURRENT STANDARDS AND SPECIFICATIONS ADOPTED BY WHITE LAKE
- 5. ALL SOIL EROSION AND SILTATION MUST BE CONTROLLED AND
- 6. ALL EXCAVATION, INCLUDING ALL UTILITIES AND LEADS,
- 7. THE CONTRACTOR IS RESPONSIBLE FOR ANY DAMAGE TO EXISTING UTILITIES AND FACILITIES. THE CONTRACTOR SHALL CONSTRUCTION. ANY CONFLICTS WITH UTILITIES SHALL BE
- COMPACTED TO THE UNDERSIDE OF THE HIGHER UTILITY OR AS SPECIFIED ON THE DETAIL SHEET.
- 9. DUST CONTROL SHALL BE MAINTAINED AT ALL TIMES.
- 11. IF DEWATERING IS DETERMINED TO BE REQUIRED, IT WILL BE
- 12. A ROAD COMMISSION FOR OAKLAND COUNTY RIGHT-OF-WAY PERMIT IS REQUIRED FOR ANY WORK WITHIN THE UNION LAKE RIGHT-OF-WAY) AND/OR ANY TOWNSHIP EASEMENT
- 13. CONTRACTOR SHALL FIELD VERIFY ALL EXISTING UTILITY LOCATIONS, INVERTS AND GRADES PRIOR TO THE START OF
- 14. ALL PAVEMENT MARKINGS, TRAFFIC CONTROL SIGNS, AND PLACEMENT REQUIREMENTS OF THE 2011 MICHIGAN MANUAL
- 16. IN ORDER TO VERIFY COMPLIANCE WITH APPROVED PLANS,

LAKE POINTE Quantity Summary SANITARY SEWER **QUANTITY** 1 6" PVC SDR 23.5 HOUSE LEAD 1,506 L.F. 2 8" PVC TRUSS SANITARY SEWER 1,387 L.F. 3 4' DIA. MANHOLE **WATER MAIN** 1 8" WATER MAIN D.I. CL 54 2,216 L.F. 2 HYDRANT, VALVE & BOX 7 EA. 3 8" G.V.&W. 3 EA. 4 8"x12" TAPPING SLEEVE, VALVE & WELL 2 EA. 5 1" WATER SERVICE 1,101 L.F. STORM SEWER QUANTITY <u>ITEM</u> 1 12" C-76 CL. 4 1,886 L.F. 2 15" C-76 CL. 4 **611** L.F. 3 18" C-76 CL. 4 592 L.F. 4 21" C-76 CL. 4 543 L.F. 5 24" C-76 CL. 4 47 L.F. 6 2' DIA. INLET 9 EA. 7 4' DIA. CATCH BASIN 21 EA. 8 6' DIA. CATCH BASIN 1 EA. 5 EA. 9 4' DIA. MANHOLE 10 6' DIA. OVERFLOW MANHOLE 1 EA. 11 24" CONC. END SECTION W/ RIP RAP 1 EA. 12 6' DIA. CONTECH CS-6 1 EA. 13 36" STANDPIPE 1 EA. QUANTITY 1 INTERNAL ASPH. PAVEMENT (4" ON 10") 5,124 S.Y. 2 R.C.O.C. ROW ASPHALT PAVEMENT 511 S.Y. 3 CONCRETE SIDEWALK 22,880 S.F. 4 THICKENED EDGE CONCRETE WALK 537 L.F. 5 24" MOUNTABLE CONC.& STANDARD GUTTER 2,922 L.F. 6 F4 CONC. CURB& GUTTER 396 L.F.

ESTIMATED QUANTITIES ARE FOR REFERENCE ONLY. CONTRACTOR SHALL DETERMINE THE QUANTITIES OF WORK REQUIRED TO COMPLETE THE PROJECT.

121 L.F.

7 B2 ROLL CURB WITH GUTTER

SEIBER KEAST LEHNER **ENGINEERING | SURVEYING** CLINTON TOWNSHIP OFFICE FARMINGTON HILLS OFFICE 17001 NINETEEN MILE ROAD, SUITE 3 39205 COUNTRY CLUB DRIVE, SUITE C8 FARMINGTON HILLS, MI 48331 CLINTON TOWNSHIP, MI 48038

586,412,7050

SCALE (IN FEET)

Scale: 1 inch = 100 ft.

ARCHITECTURAL PLANS PROVIDED BY: ALEXANDER V. BOGAERTS AND ASSOCIATES, P.C. 2445 FRANKLIN ROAD

BLOOMFIELD HILLS, MICHIGAN 48302

PHONE: 248.334.5000

LANDSCAPE PLANS PROVIDED BY: FELINO PASCUAL & ASSOCIATES LANDSCAPE ARCHITECTURE 24333 ORCHARD LAKE ROAD, SUITE G FARMINGTON, MICHIGAN 48336 PHONE: 248.557.5588

248,308,3331

SURVEY PROVIDED BY: ALPINE ENGINEERING, INC. 46892 WEST ROAD, SUITE 109

NOVI, MICHIGAN 48377 PHONE: 248.926.3765

SHEET INDEX

- COVER SHEET
- COMPOSITE UTILITY AND OVERALL SITE PLAN EXISTING CONDITIONS AND DEMOLITION PLAN
- GRADING & S.E.S.C. PLAN
- GRADING & S.E.S.C. PLAN
- GRADING & S.E.S.C. PLAN PROPOSED CONTOUR PLAN
- 7A. DETAILED GRADING PLAN FOR ADA PATHWAYS
- ROAD AND SANITARY SEWER PLAN
- ROAD AND SANITARY SEWER PROFILES
- WATERMAIN PLAN
- 10A. WATER MAIN PROFILES 11. STORM SEWER PLAN
- 12. STORM SEWER PROFILES
- 13. STORM SEWER PROFILES
- 14. CONTECH CS-6 DETAILS
- DETENTION BASIN PLAN, CALCULATIONS AND PROFILE 16. DRAINAGE DISTRIBUTION PLAN & STORM SEWER
- CALCULATIONS
- 16A. OVERALL STORM WATER MANAGEMENT SYSTEM "WEST VALLEY & LAKE POINTE"
- 17. APPROACH PLAN
- ND1. NOTES AND DETAILS
- ND2. NOTES AND DETAILS

DETAILS:

WHITE LAKE TOWNSHIP

SANITARY SEWER STANDARD DETAILS

WATER MAIN STANDARD DETAILS

STORM SEWER STANDARD DETAILS

OAKLAND COUNTY SOIL EROSION AND SEDIMENTATION CONTROL DETAILS

LANDSCAPE PLANS:

LS-1 OVERALL LANDSCAPE PLAN

LS-2 GENERAL LANDSCAPE PLANTING DETAIL

LS-3 PLANT MATERIAL LIST AND PLANT DETAILS

LS-4 BLDG. FOUNDATION, CLUBHOUSE AND ENTRY PLANTINGS

LS-5 SITE AMENITY, PERGOLA AND ENTRY SIGN DETAILS

LS-6 POOL DECK PLAN

LS-7 POOL PERGOLA/TRELLIS ELEVATIONS & DETAILS

IRRIGATION PLANS:

IRR-1 IRRIGATION PLAN

IRR-2 IRRIGATION PLAN

IRR-3 IRRIGATION PLAN

IRR-4 IRRIGATION NOTES & DETAILS

ARCHITECTURE PLANS:

BUILDING PLANS A101

UNIT ELEVATIONS BUILDING PLANS

A200

BUILDING ELEVATIONS BUILDING PLANS

A203 BUILDING ELEVATIONS

A204 BUILDING PLANS A205 BUILDING ELEVATIONS

AS-1SITE PLAN

COMMUNITY BUILDING ELVATIONS CB4.0

	REVI	SION	1 S	ENGINEER'S SEAL
2. F 3. 4. 5. A 6. R 7. R	ITEM REVISE PER OWNER REVISE GRADES ON UNIT REV PER 11—20—20 W. REVISE PER WHITE LAK ADD WATER MAIN PROFIL REVISED PER TOWNSHIP REVISED PER AGENCIES	TWP LETTER E TWP	03-03-21	JASON M. JASON M. EMERINE 6201054218 PROFESSIONAL
	TT 04 00 0000	DESIGNED	BY: A.A	JOB NUMBER: 19-039
DA'	TE: 04-08-2020	CHECKED	BY: P.K.	DRAWING FILE: 19039CV.dwg



STAND PIPE

CONTECH

SEE DETAIL ON SHEET 15

SEE DETAIL ON SHEET 14

1. ON-SITE SANITARY SEWERS, AND WATER MAINS SHALL BE CENTERED IN A 20-FOOT WIDE EASEMENT.

- 2. ALL OFF-SITE SANITARY AND WATER MAIN
- 4. PERIODIC MAINTENANCE OF THE STORM WATER
- OF THE STREET.
- 7. PROPOSED GRADES WILL MATCH EXISTING ELEVATIONS AT THE PROPERTY LINE UNLESS RETAINING WALLS ARE PROVIDED OR GRADING EASEMENTS OBTAINED.
- WORK IN THE UNION LAKE ROAD RIGHT-OF-WAY.
- GATE WELLS.
- MINIMUM OF FOUR FEET IN DIAMETER.
- 12. THE CONSTRUCTION TYPE OF THE PROPOSED
- 13. THE FRONT PORCH LIGHTS AND THE COACH

THE SUBJECT PROPERTY LIES WITHIN A ZONE "X" FLOOD HAZARD AREA - "AREAS OF MINIMAL FLOODING", PER THE NATIONAL FLOOD INSURANCE PROGRAM, FLOOD INSURANCE RATE MAP, MAP NUMBER 26125C0477F, MAP EFFECTIVE SEPTEMBER 29, 2006.

= 0.56 Ac.

- IMPROVEMENTS WILL BECOME PUBLIC PROPERTY.
- 3. CRITICAL STORM STRUCTURES WILL BE FITTED
- DETENTION BASIN WILL BE REQUIRED.
- 5. PROVISIONS PURSUANT TO OAKLAND COUNTY DRAIN COMMISSION EROSION CONTROL MANUAL WILL BE UNDERTAKEN INCLUDING, BUT NOT LIMITED TO, SILT FENCE AND INLET FILTERS.
- 6. "NO PARKING FIRE LANE" SIGNAGE SHALL BE INSTALLED PROHIBITING PARKING ON ONE SIDE
- OAKLAND COUNTY WILL BE REQUIRED FOR ALL
- 9. ALL WATER MAIN SHALL BE CLASS 54 DUCTILE IRON. ALL GATE VALVES SHALL BE PLACED IN
- 10. ALL STRUCTURES EXCEPT FOR INLETS WHICH CONNECT TO CATCH BASINS WILL BE A
- 11. THE DEVELOPMENT SHALL BE CONSTRUCTED AS A SINGLE PHASE.
- BUILDINGS IS WOOD CONSTRUCTION WITH BRICK VENEER AND SLAB ON GRADE.
- LIGHTS WILL UTILIZE 75 WATT BULBS.

WETLANDS

FLOODPLAIN INFORMATION

LEGEND

LOCATED ON THE FRONT OF EACH HOME.

EXISTING PROPOSED PAVEMENT (ASPHALT) SIDE WALK (CONCRETE) CONCRETE CURB AND GUTTER SANITARY SEWER --- WATER MAIN MANHOLE CATCH BASIN W/INLET FILTER (ST-38) CURB INLET W/SILT SAC (ST-4A) END SECTION W/RIP-RAP GATE VALVE HYDRANT FLOOD PLAIN — 1000 — CONTOURS SPOT ELEVATION SURFACE DRAINAGE ___ OVERFLOW ROUTE ----x----- TREE FENCE ——//———— SILT FENCE

Scale: 1 inch = 50 ft.

PARKING CALCULATIONS

138 BEDROOMS/4 = 34.5 SPACES

TOTAL SPACES REQUIRED = 172.5

2 SPACES PER GARAGE = 138

2 SPACES PER DRIVEWAY = 138

TOTAL SPACES PROVIDED = 307

Total Parking Spaces (Excluding Garages)= 169

Per 2010 ADA (208.2.3 Residential Facilities)

Total Required (Minimum 2% of the tot

Standard Accessible Spaces

Van Accessible Spaces

. EXISTING ZONING: R1-C/SINGLE FAMILY RESIDENTIAL

2. SITE AREA: 13.32 ACRES GROSS, 12.76 ACRES NET

5. DENSITY: 69 UNITS/12.76 ACRES = 5.41 UNITS/ACRE

7. INTERNAL SETBACK = 30 FEET FROM BACK OF CURB.

B. SIDE YARD SETBACK: MIN. 20 FEET BETWEEN BUILDINGS

LIGHTING SHALL BE PROVIDED BY PHOTOCELL OPERATED LIGHTS

4. ALL PROPOSED UNITS ARE 2-BEDROOMS

6. PROPERTY LINE SETBACK = FRONT 40 FEET

9. DWELLING UNITS: 69 - (2 BEDROOM UNITS)

10. TRASH DISPOSAL SHALL BE BY CURB SIDE PICKUP

AND LB/LOCAL BUSINESS

3. PROPOSED LAND USE: ATTACHED SINGLE FAMILY DEVELOPMENT

APARTMENTS- MULTI FAMILY

SIDE 25 FEET

REAR 25 FEET

Accessible Parking Spaces

Accessible Spaces

Total Provided

SITE DATA

ADDITIONAL PARKING SPACES = 31

2 SPACES FOR EACH UNIT, PLUS 1/4 SPACE FOR

2 SPACES FOR EACH UNIT = 138 SPACES

SPACES REQUIRED:

SPACES PROVIDED:

EACH BEDROOM.

LIST OF ALL REQUIRED STATE

(5.41 UNITS / ACRE)

AND FEDERAL PERMITS <u>STATUS</u> AGENCY NOT FILED NOT FILED 2. SANITARY SEWER MDEQ

MDEQ NOT FILED

LOT COVERAGE:

BUILDING AREA

= 13.32 Ac.= 3.05 Ac.

= 555,826 S.F.

= 57,063 S.F.

PROPOSED LOT COVERAGE = 3.05 / 13.32= 22.89%

OPEN SPACE

ROADS SIDEWALKS DRIVEWAYS

FOR SUCH USE.

(NOT TO SCALE)

= 31,908 S.F. = 24,358 S.F. BUILDINGS = 132,860 S.F.CLUBHOUSE & POOL = 132,860 S.F. LAWN AREA = 366,700 S.F. = 8.42 AC.

LAKE POINTE

SECTION 36, TOWN 3 NORTH, RANGE 8 EAST WHITE LAKE TWP., OAKLAND COUNTY, MICHIGAN

).	ITEM	DATE
	REVISE PER OWNER	6-3-20
	REVISE GRADES ON UNITS 2 AND 6	11-9-20
	REV PER 11-20-20 W.L. TWP LETTER	02-02-21
	REVISE PER WHITE LAKE TWP	03-03-21
	REVISED PER TOWNSHIP	04-25-23
	REVISED PER TOWNSHIP	7-27-23
١.	REVISE PER AGENCIES	02-13-24

REVISIONS

UNDERGROUND UTILITY LOCATIONS AS SHOWN ON THE PLAN, WERE OBTAINED FROM UTILITY OWNER AND NOT FIELD Know what's below.

UTILITY WARNING

PROPOSED DRIVEWAY LOCATION

LIMIT OF DISTURBANCE

Call before you dig. THE CONTRACTOR SHALL BE RESPONSIE FOR THE PROTECTION OF AND/OR RELOCATION OF ALL UTILITIES THAT MAY INTERFERE WITH CONSTRUCTION


DATE: 04-08-2020 DESIGNED BY: A.A. JOB NUMBER: 19-039

COMPOSITE UTILITY AND OVERALL SITE PLAN





SEIBER KEAST LEHNER ENGINEERING | SURVEYING FARMINGTON HILLS OFFICE 205 COUNTRY CLUB DRIVE, SUITE C8 FARMINGTON HILLS, MI 48331 248.308.3331

SHEET

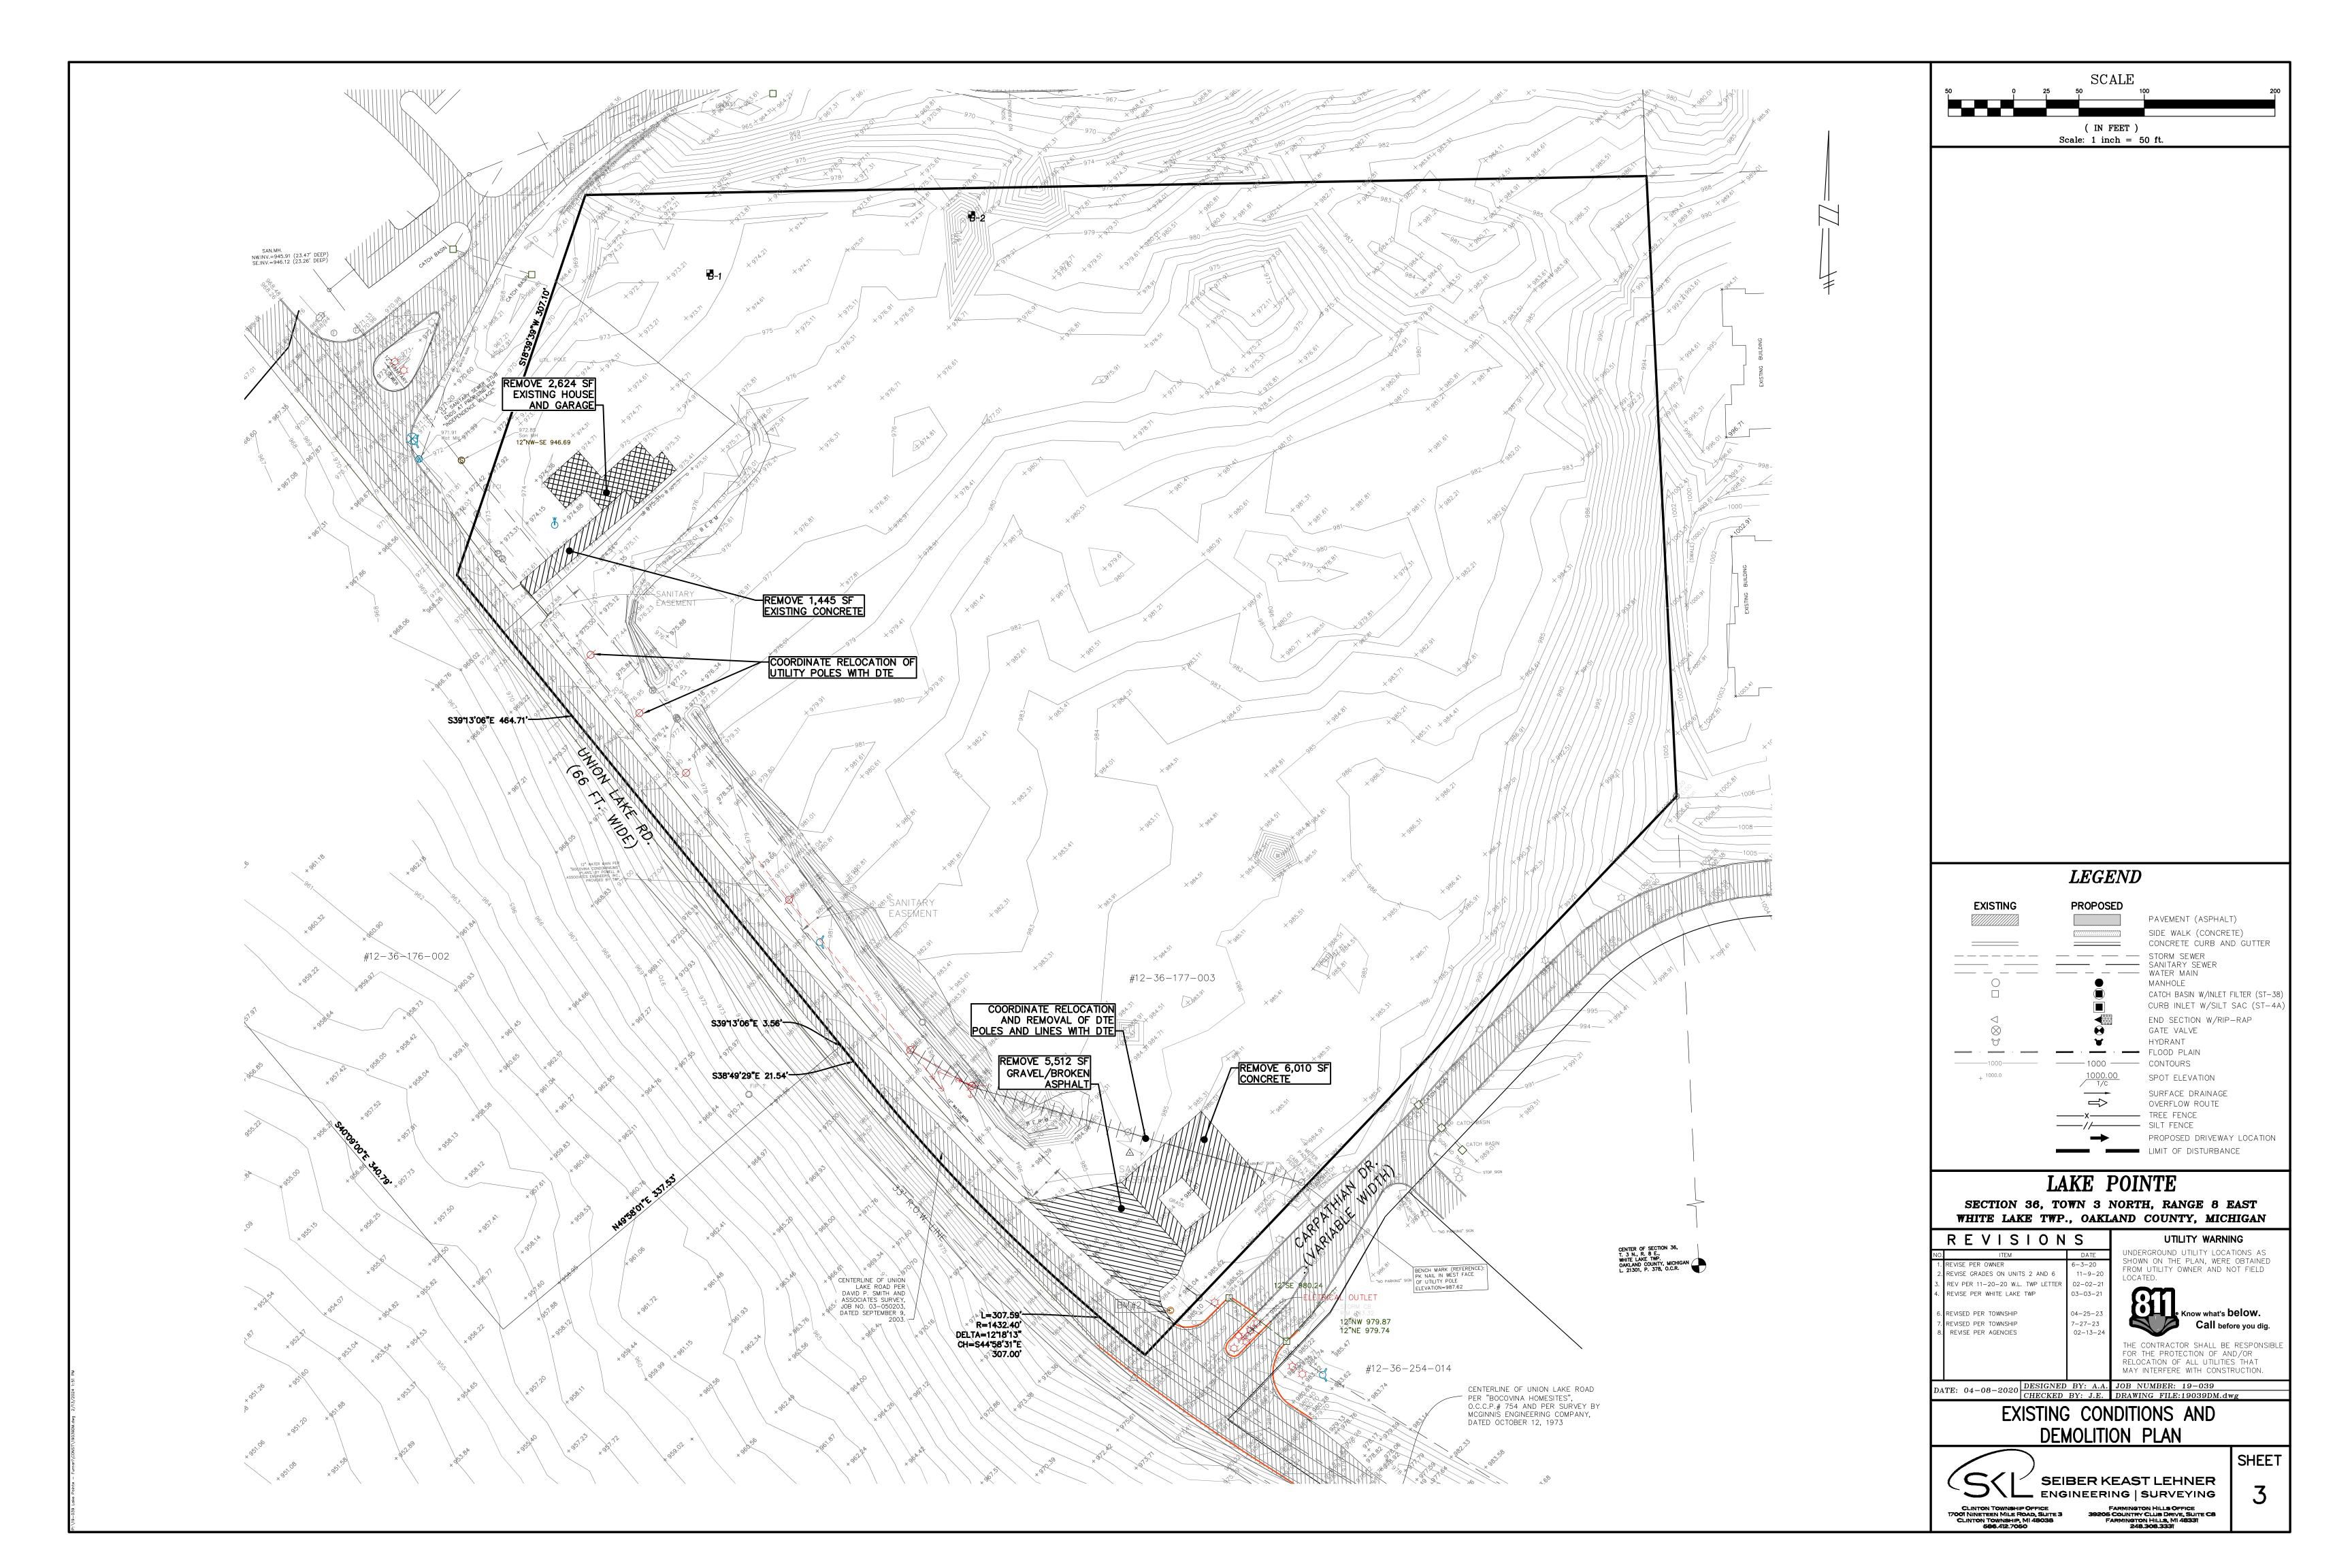





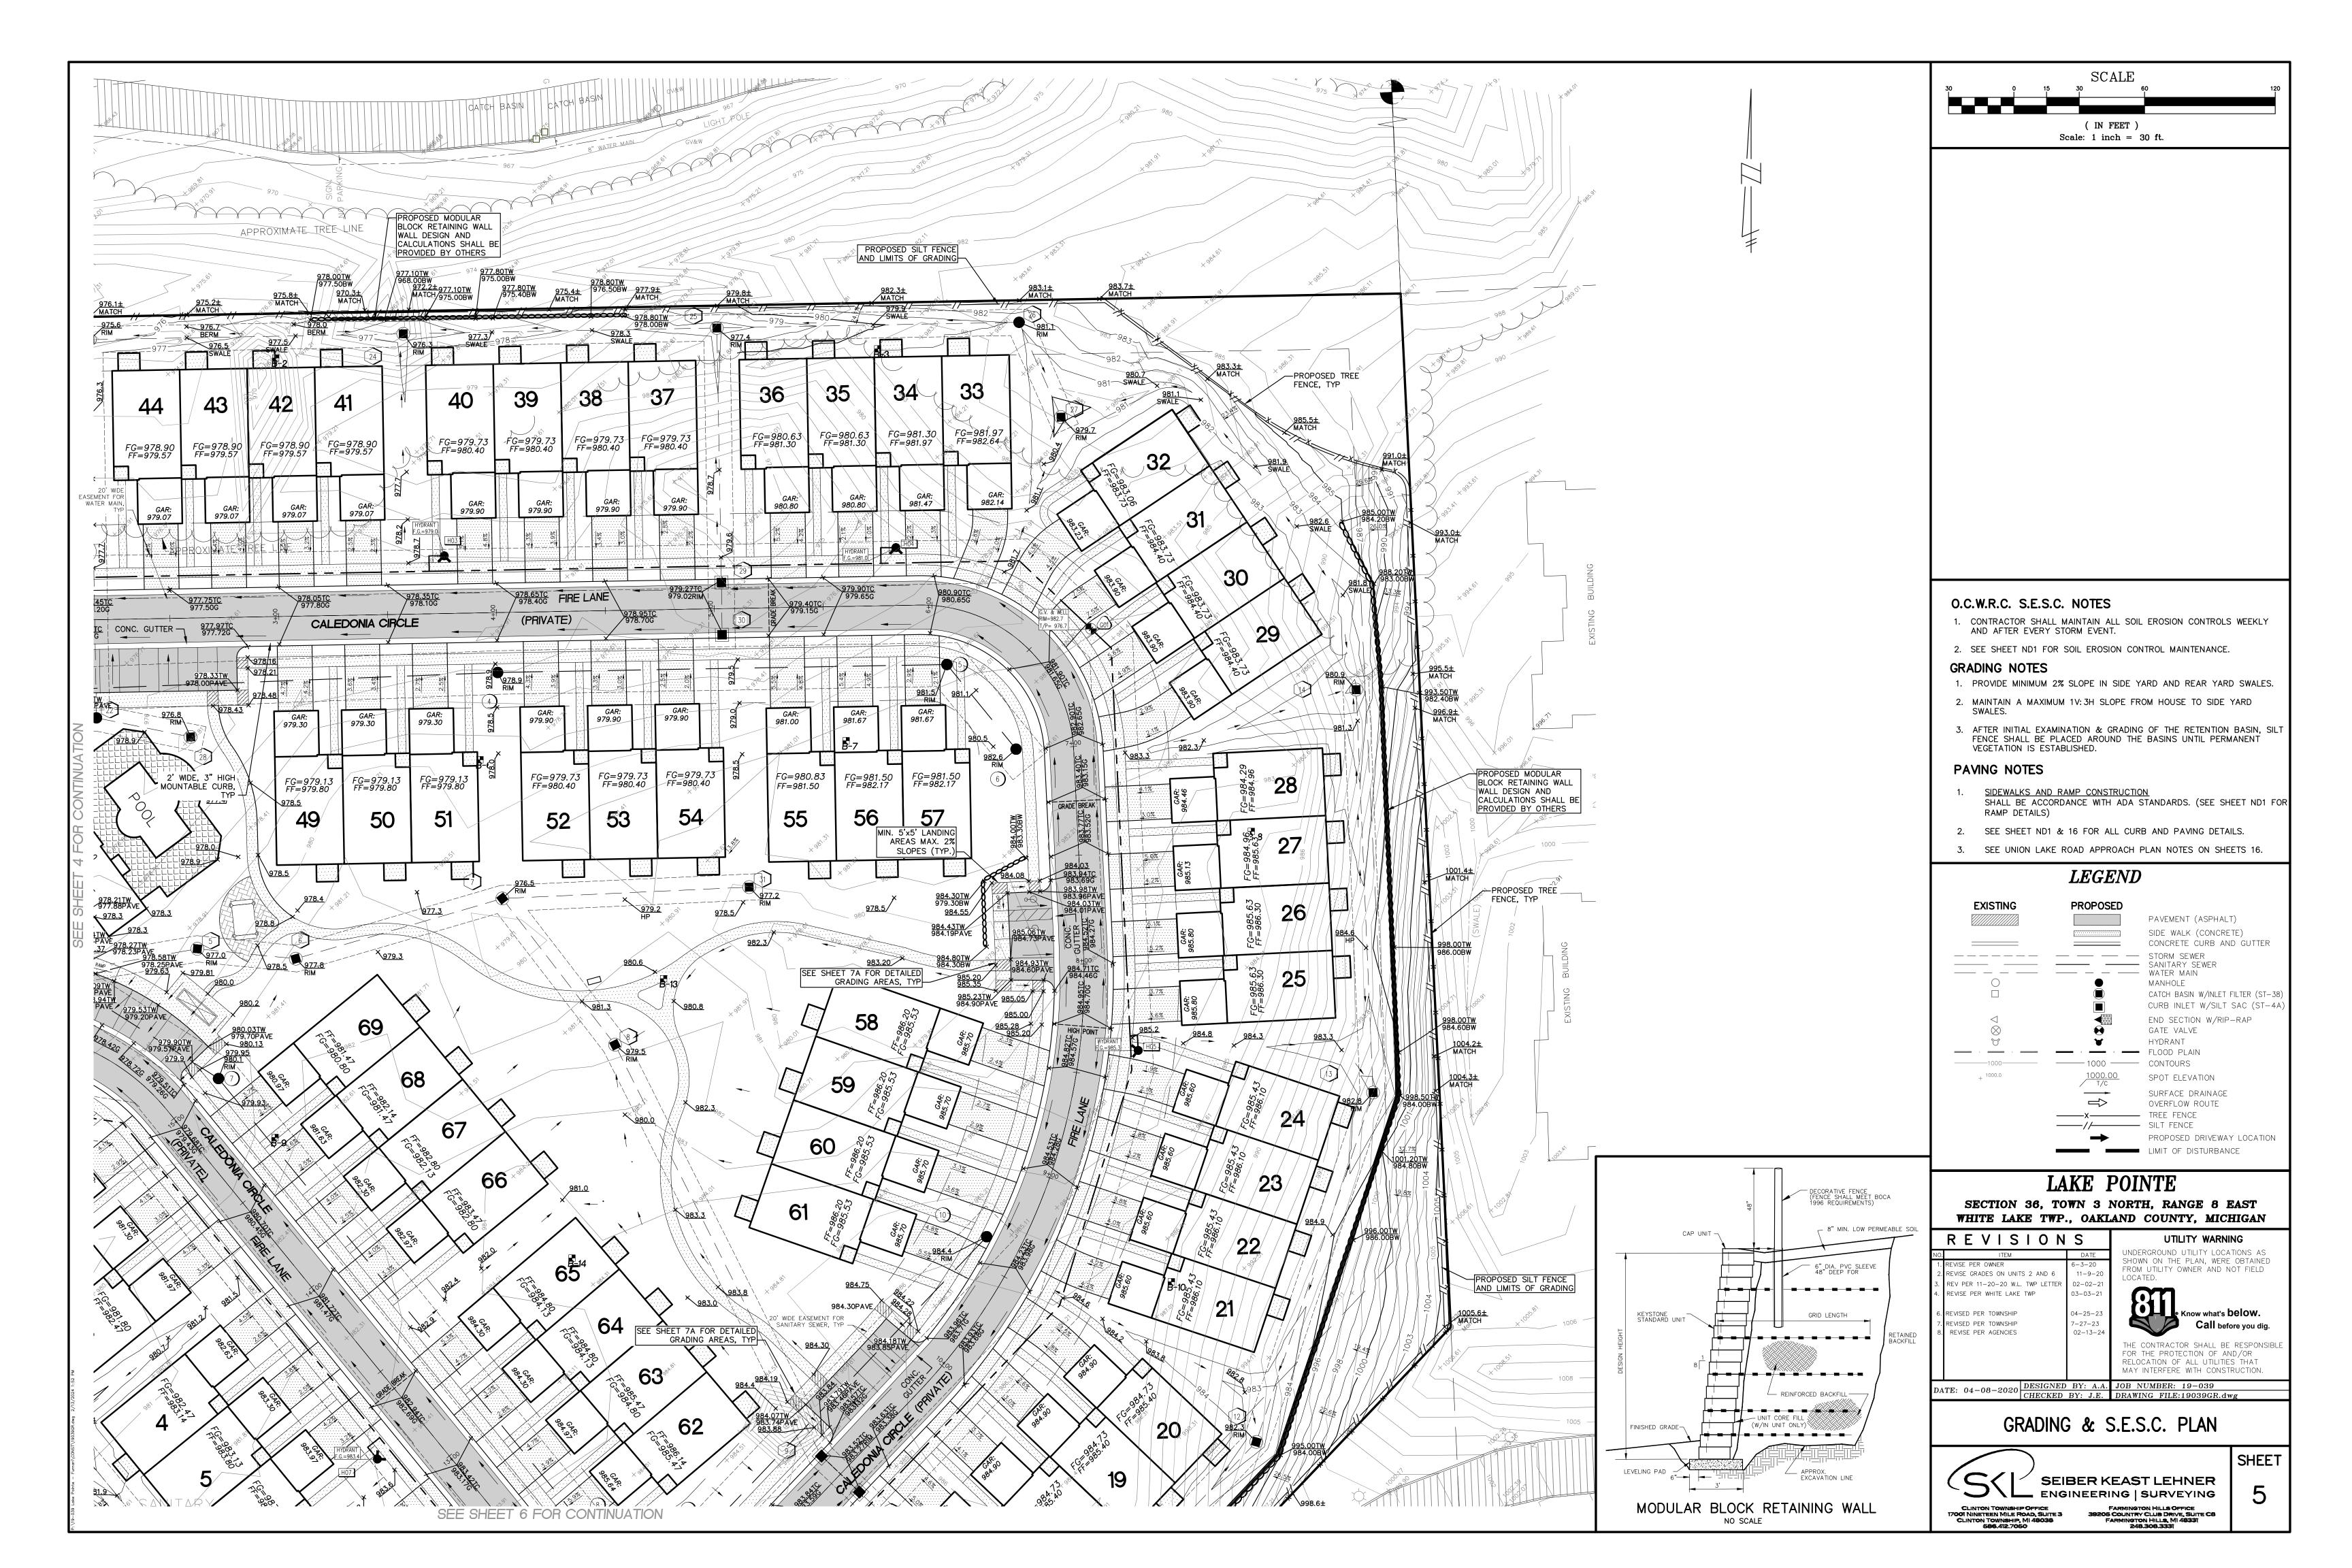


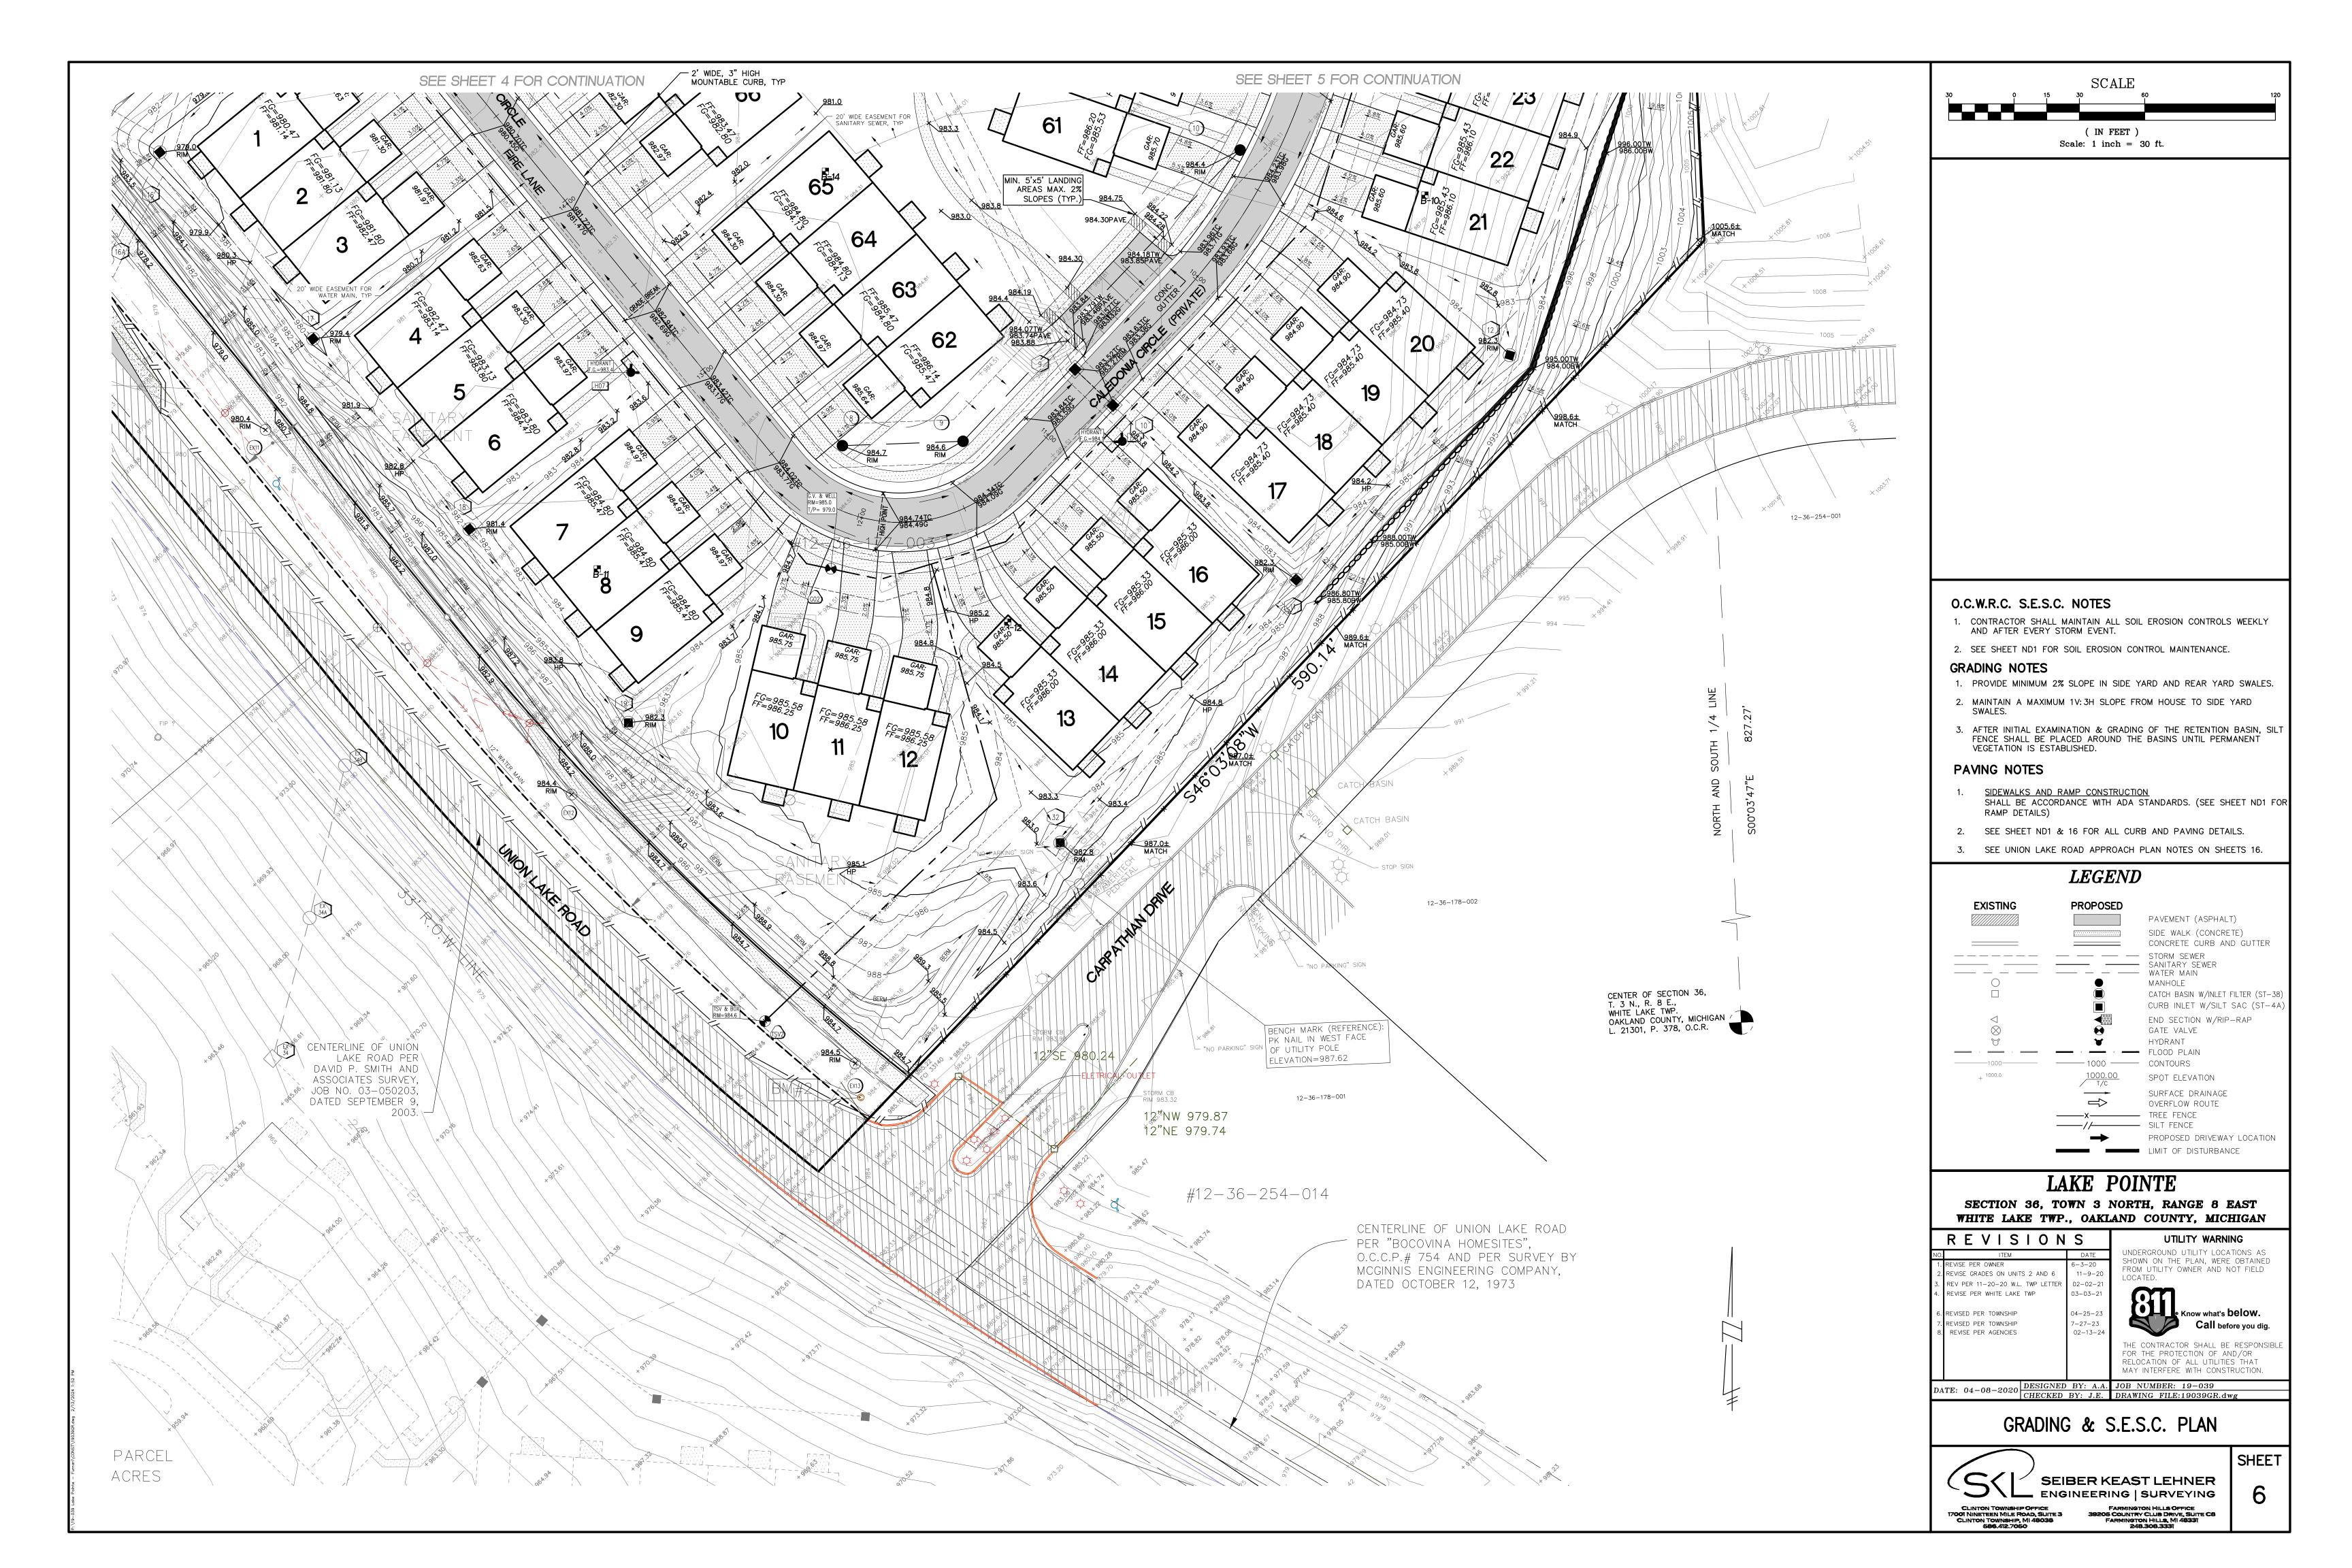





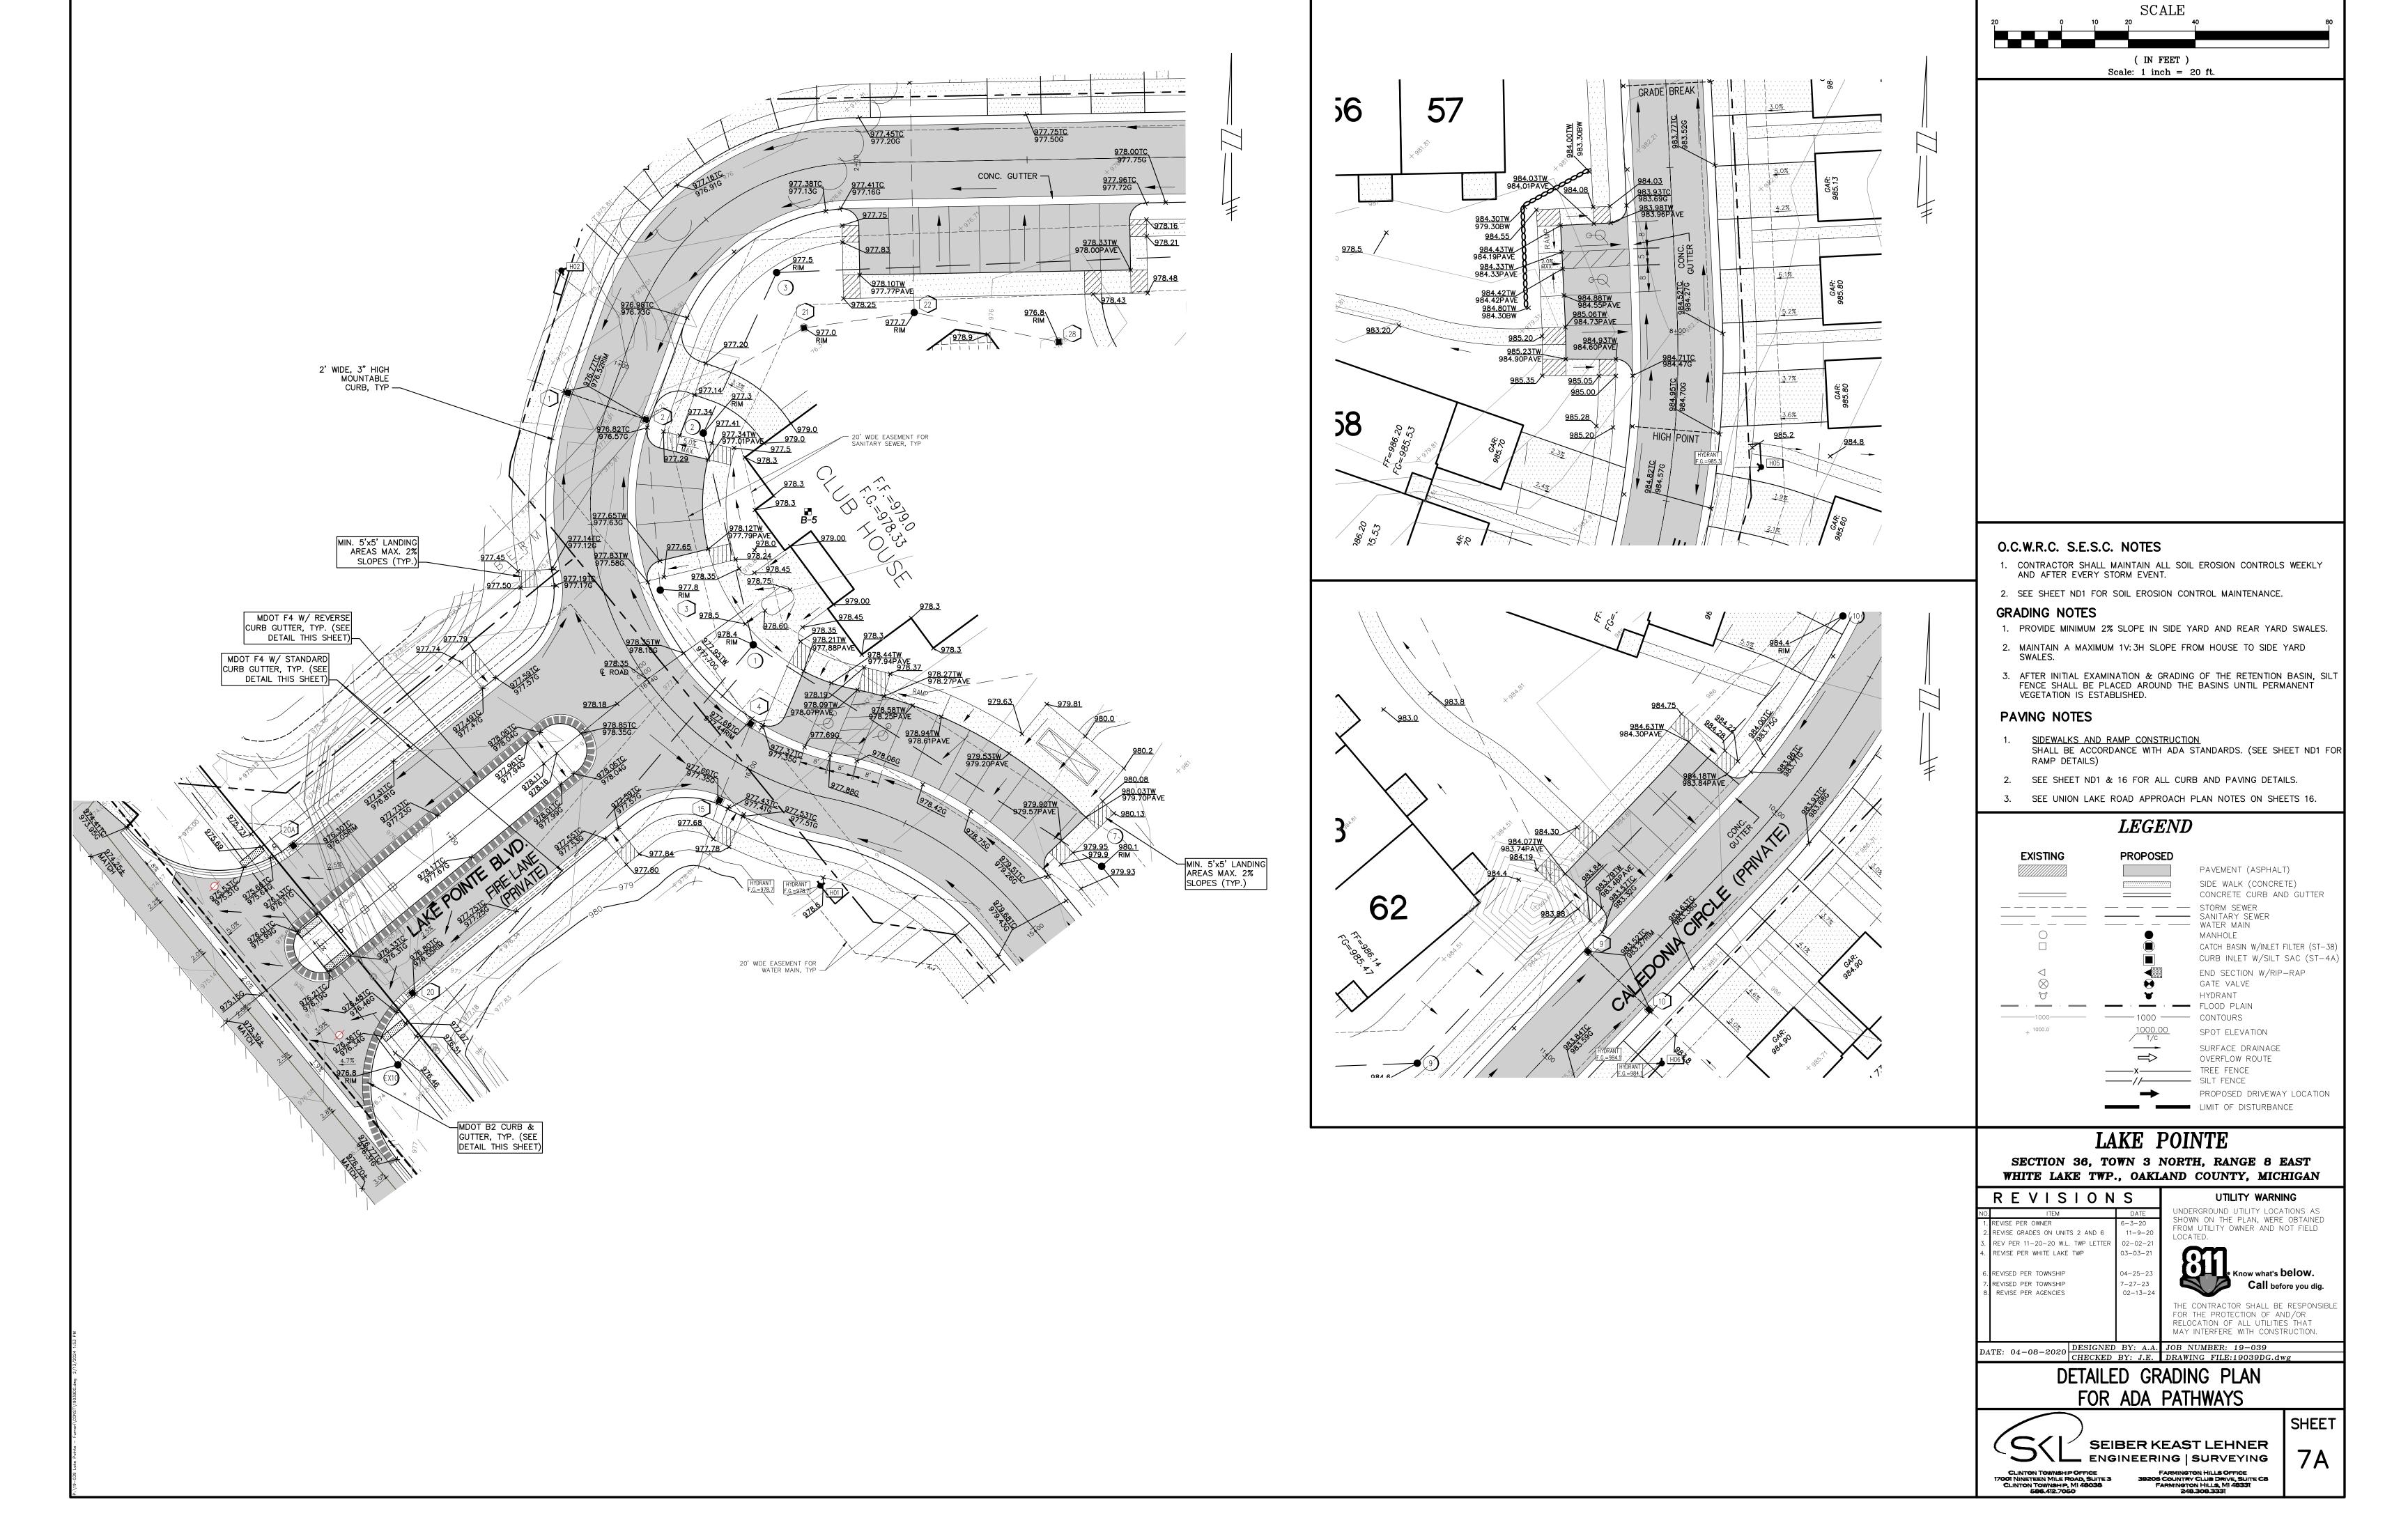

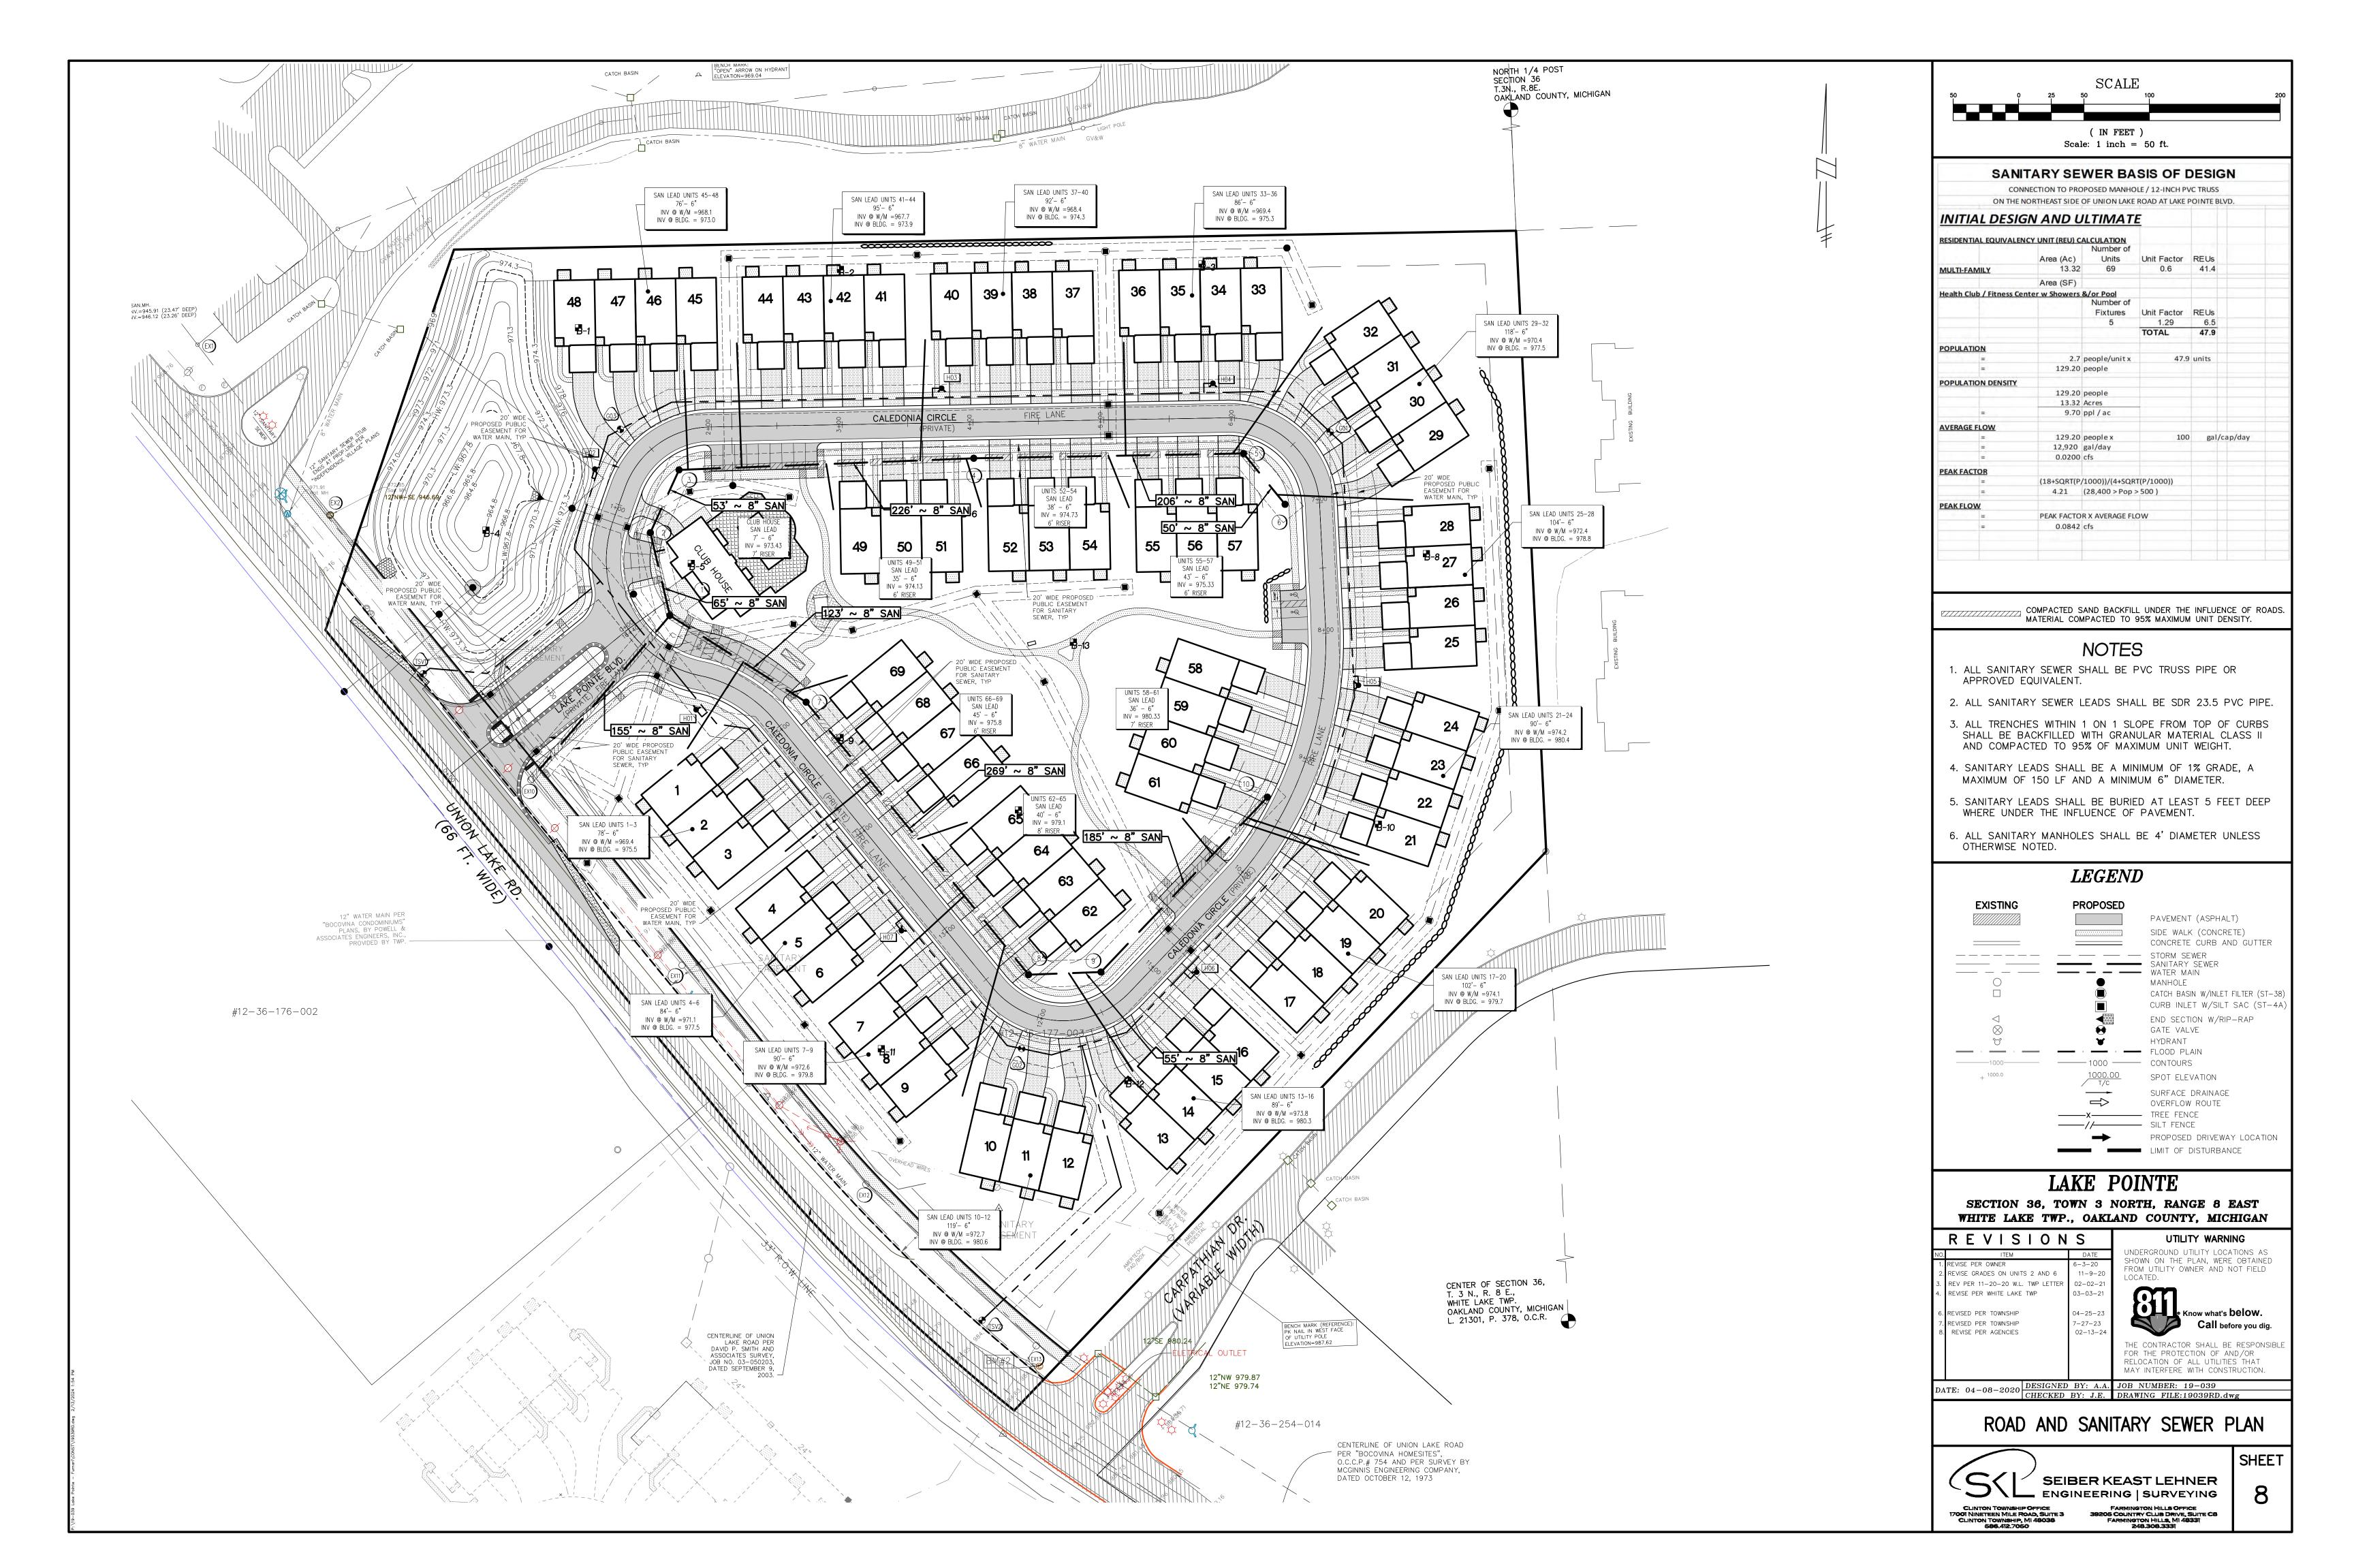

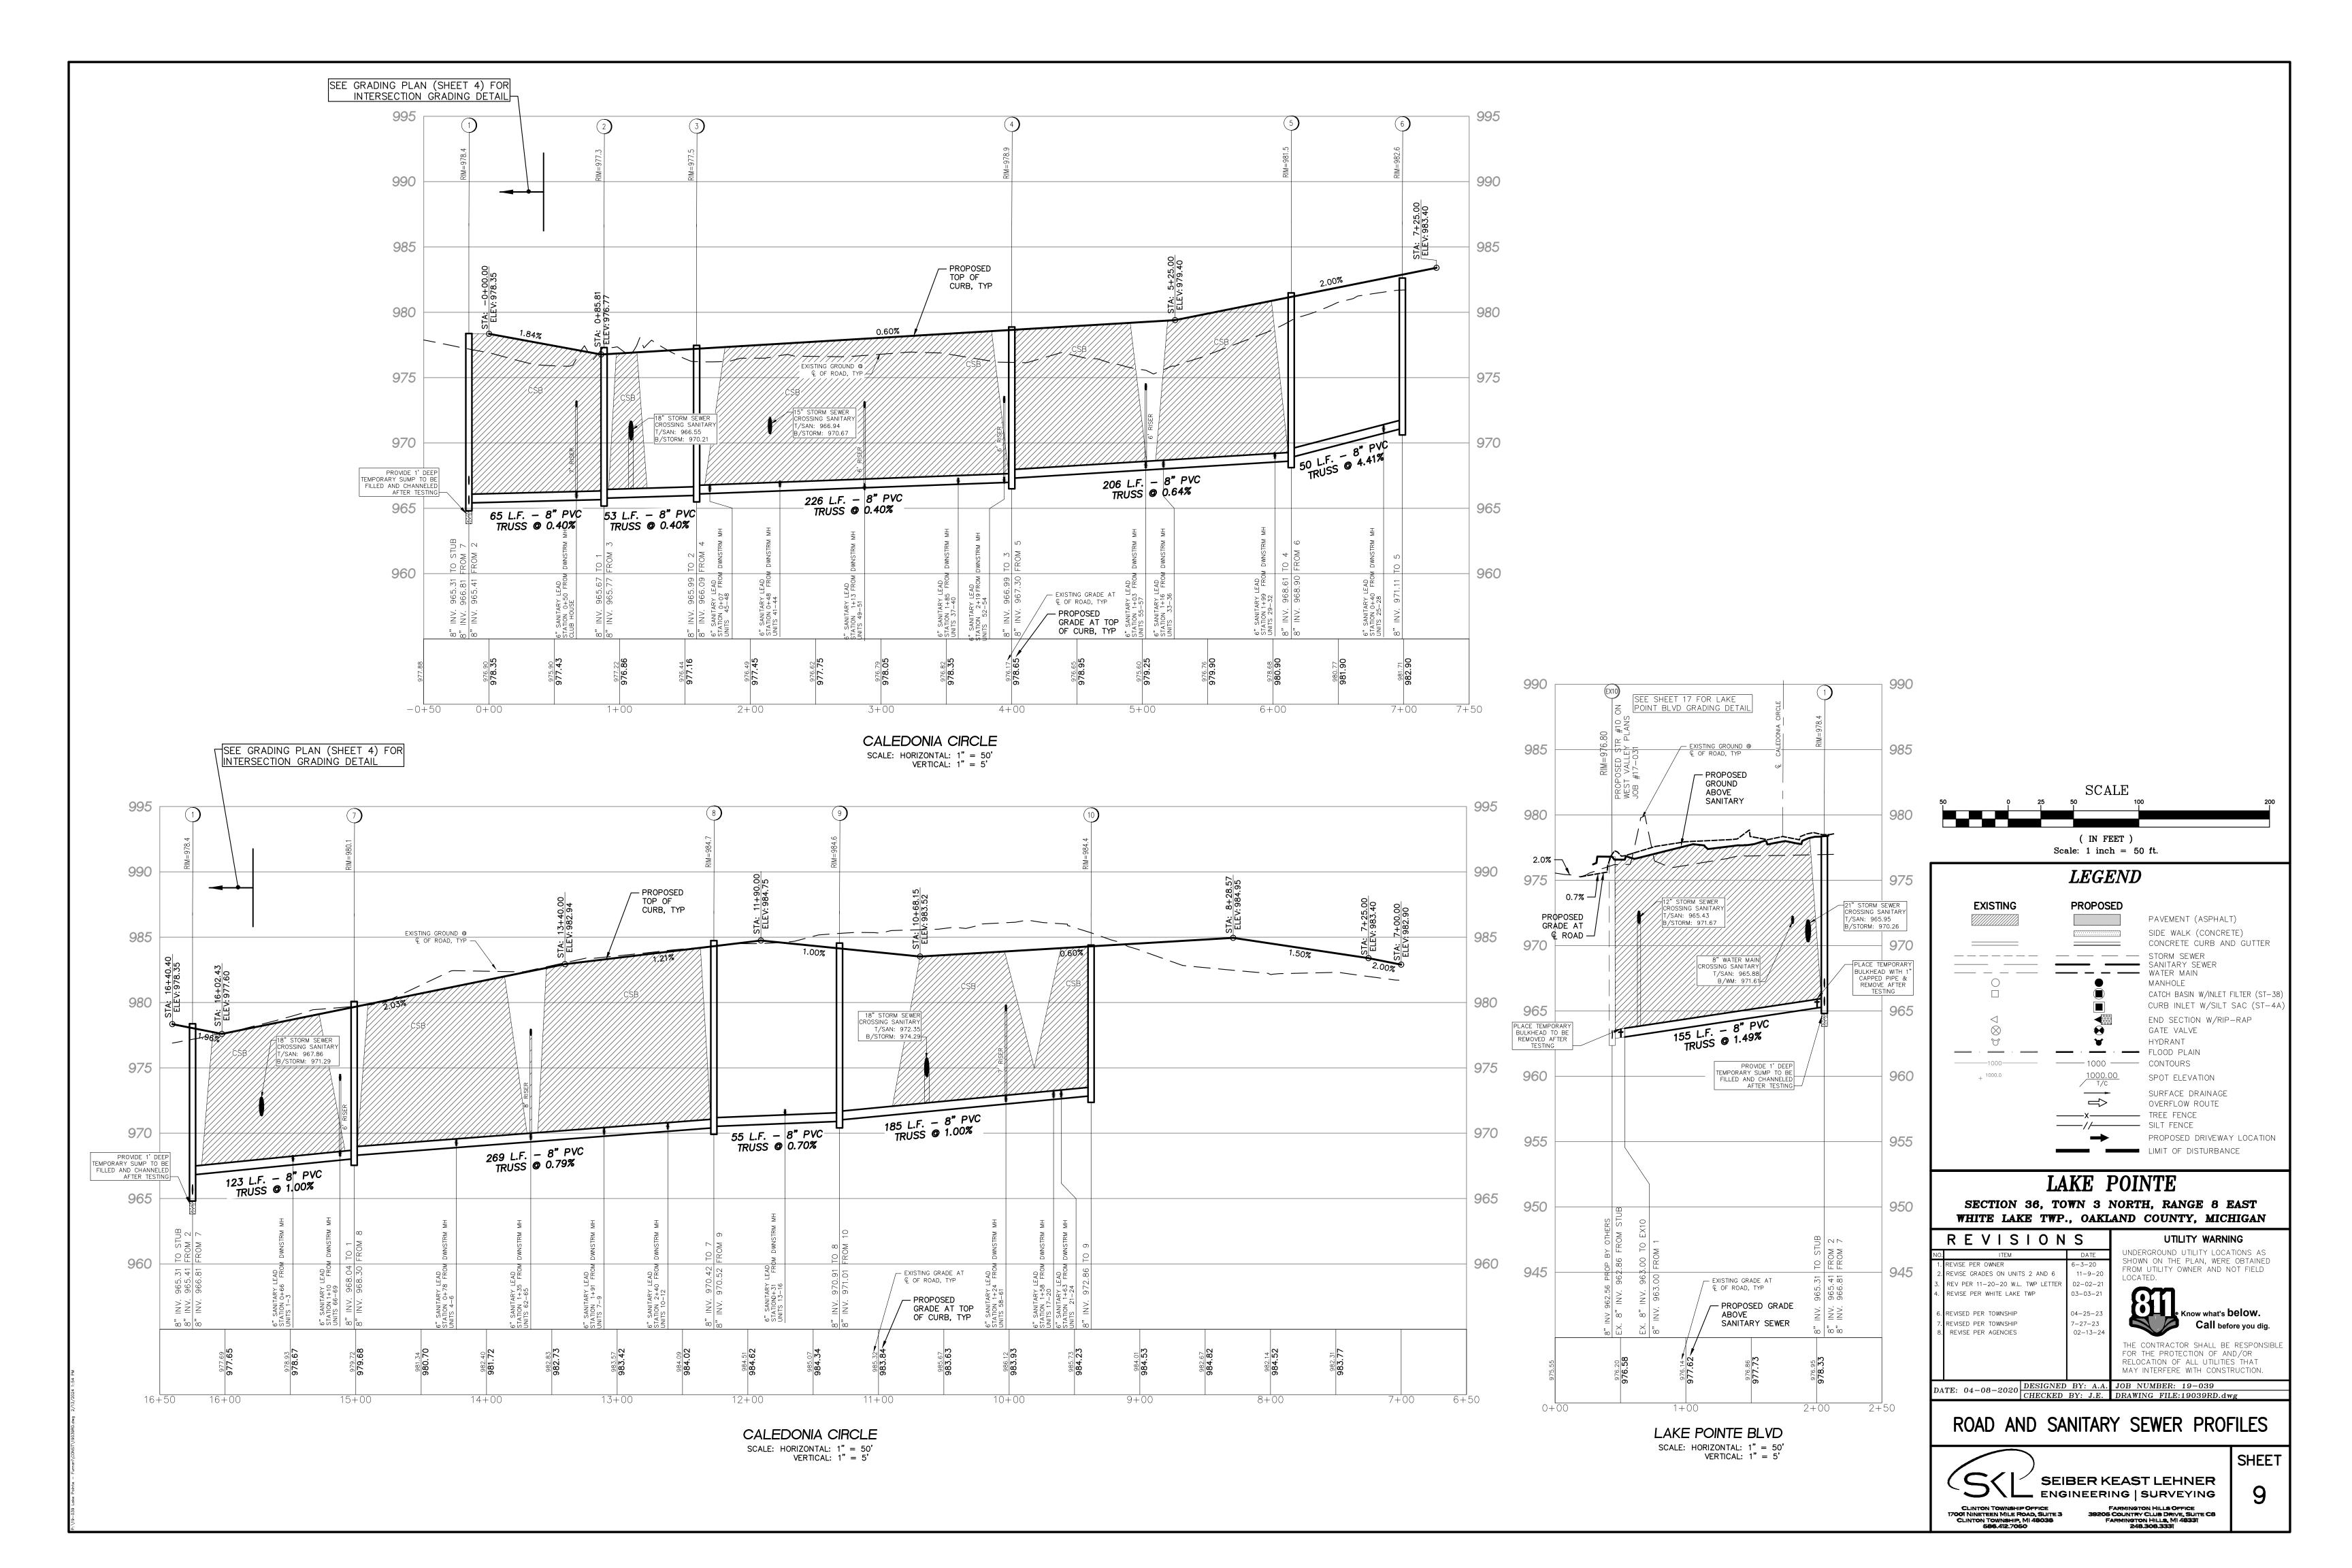

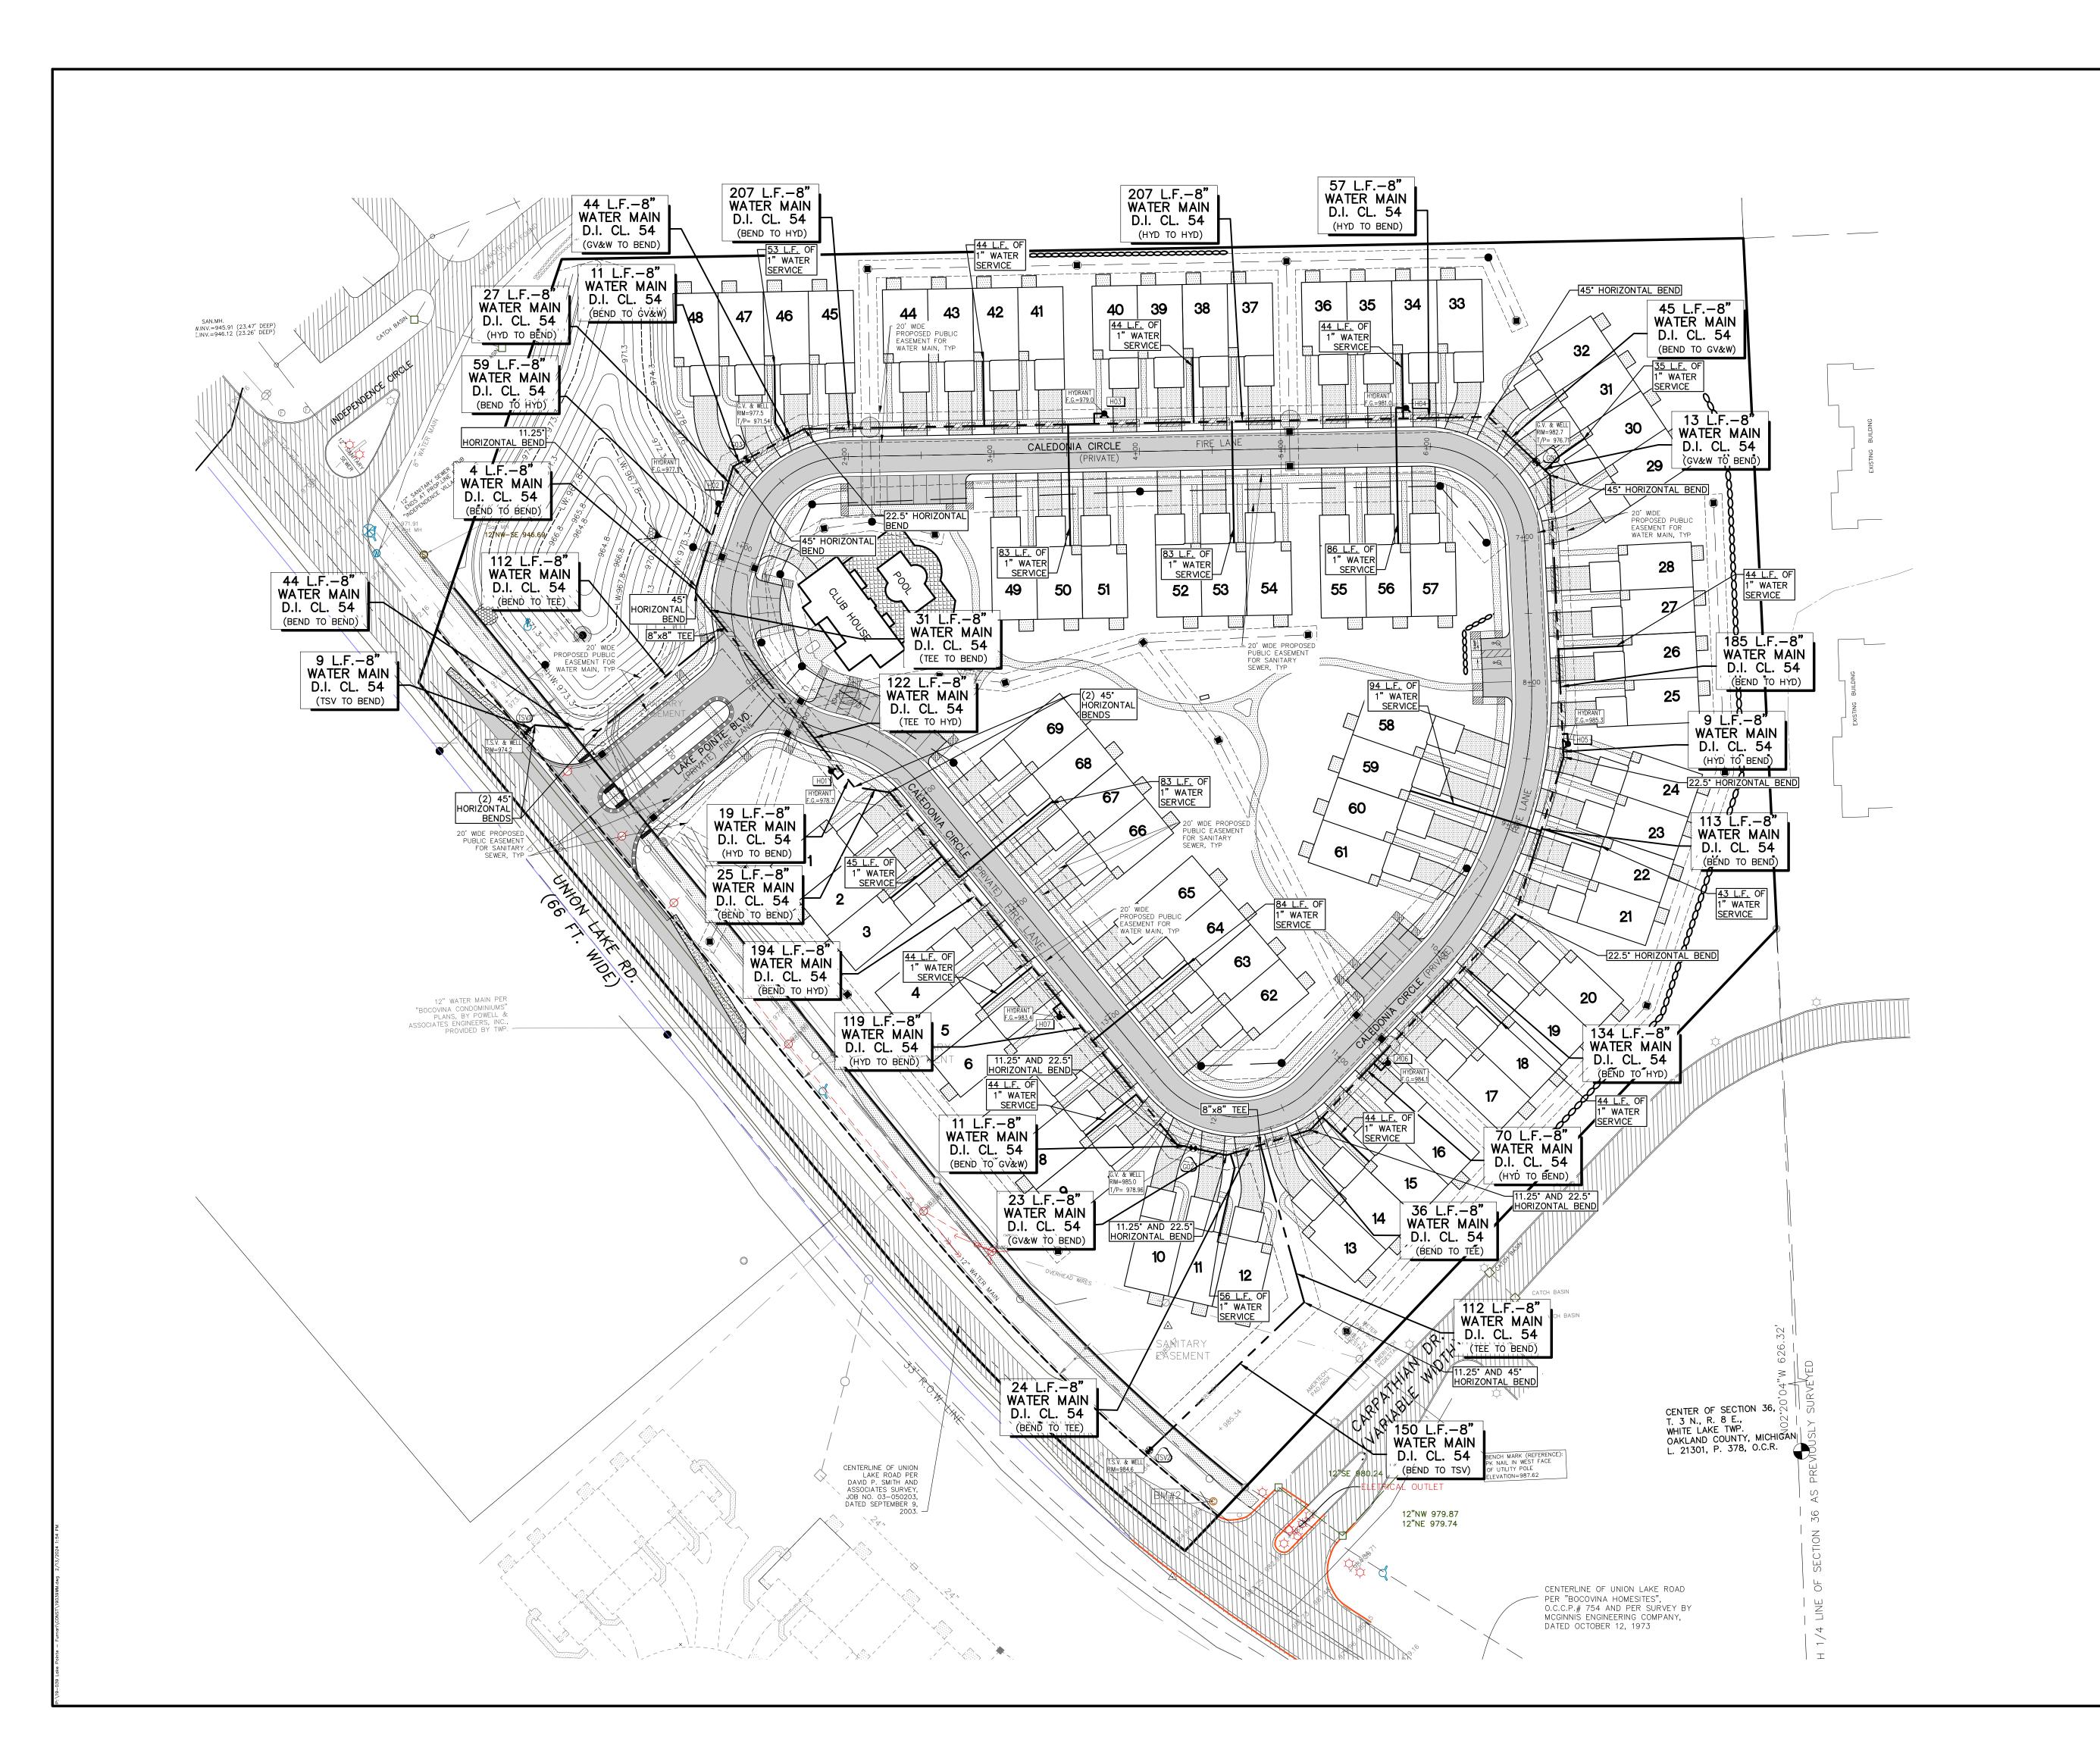


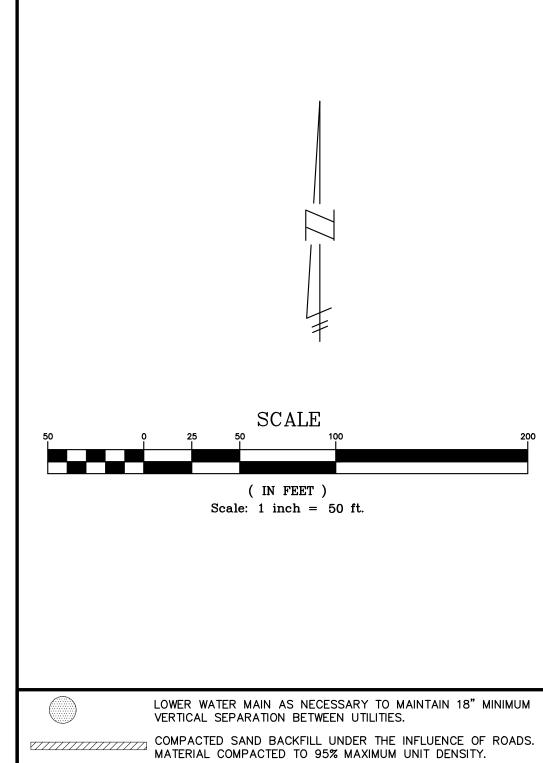

NOTES

- 1. ALL TRENCHES WITHIN 1 ON 1 SLOPE FROM TOP OF CURBS SHALL BE BACKFILLED WITH GRANULAR MATERIAL CLASS II AND COMPACTED TO 95% OF MAXIMUM UNIT WEIGHT.
- 2. WATER MAINS SHALL BE INSTALLED WITH A MINIMUM OF 6'-0" OF COVER EXCEPT AT GATE WELLS WHERE THEY SHALL BE INSTALLED WITH A 5' DEPTH OF COVER.
- 3. ALL WATER MAIN SHALL BE DUCTILE IRON, CLASS 54, CEMENT LINED.
- 4. ALL HYDRANTS MUST BE A MINIMUM OF 6' (FROM CENTER) OFF THE BACK OF CURB.
- 5. HYDRANT LEADS ARE 6". LENGTH OF LEAD IS 13' UNLESS OTHERWISE NOTED.
- 6. ALL WATER SERVICES ARE TO BE 1" DIAMETER. ALL WATER SERVICES SHALL BE COPPER K OR 200 PSI BLUE POLY SDR9 TUBING WITH TRACER WIRE, OR APPROVED EQUAL.

LEGEND

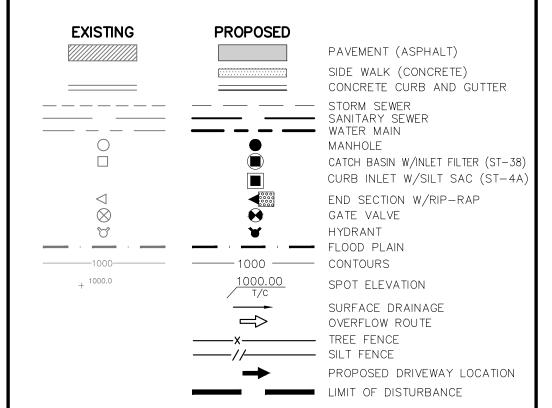

LAKE POINTE

SECTION 36, TOWN 3 NORTH, RANGE 8 EAST WHITE LAKE TWP., OAKLAND COUNTY, MICHIGAN

NO.	ITEM	DATE
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8.	REVISE PER AGENCIES	02-13-24

UTILITY WARNING UNDERGROUND UTILITY LOCATIONS AS SHOWN ON THE PLAN, WERE OBTAINED FROM UTILITY OWNER AND NOT FIELD

Know what's below. Call before you dig. THE CONTRACTOR SHALL BE RESPONSIBL FOR THE PROTECTION OF AND/OR


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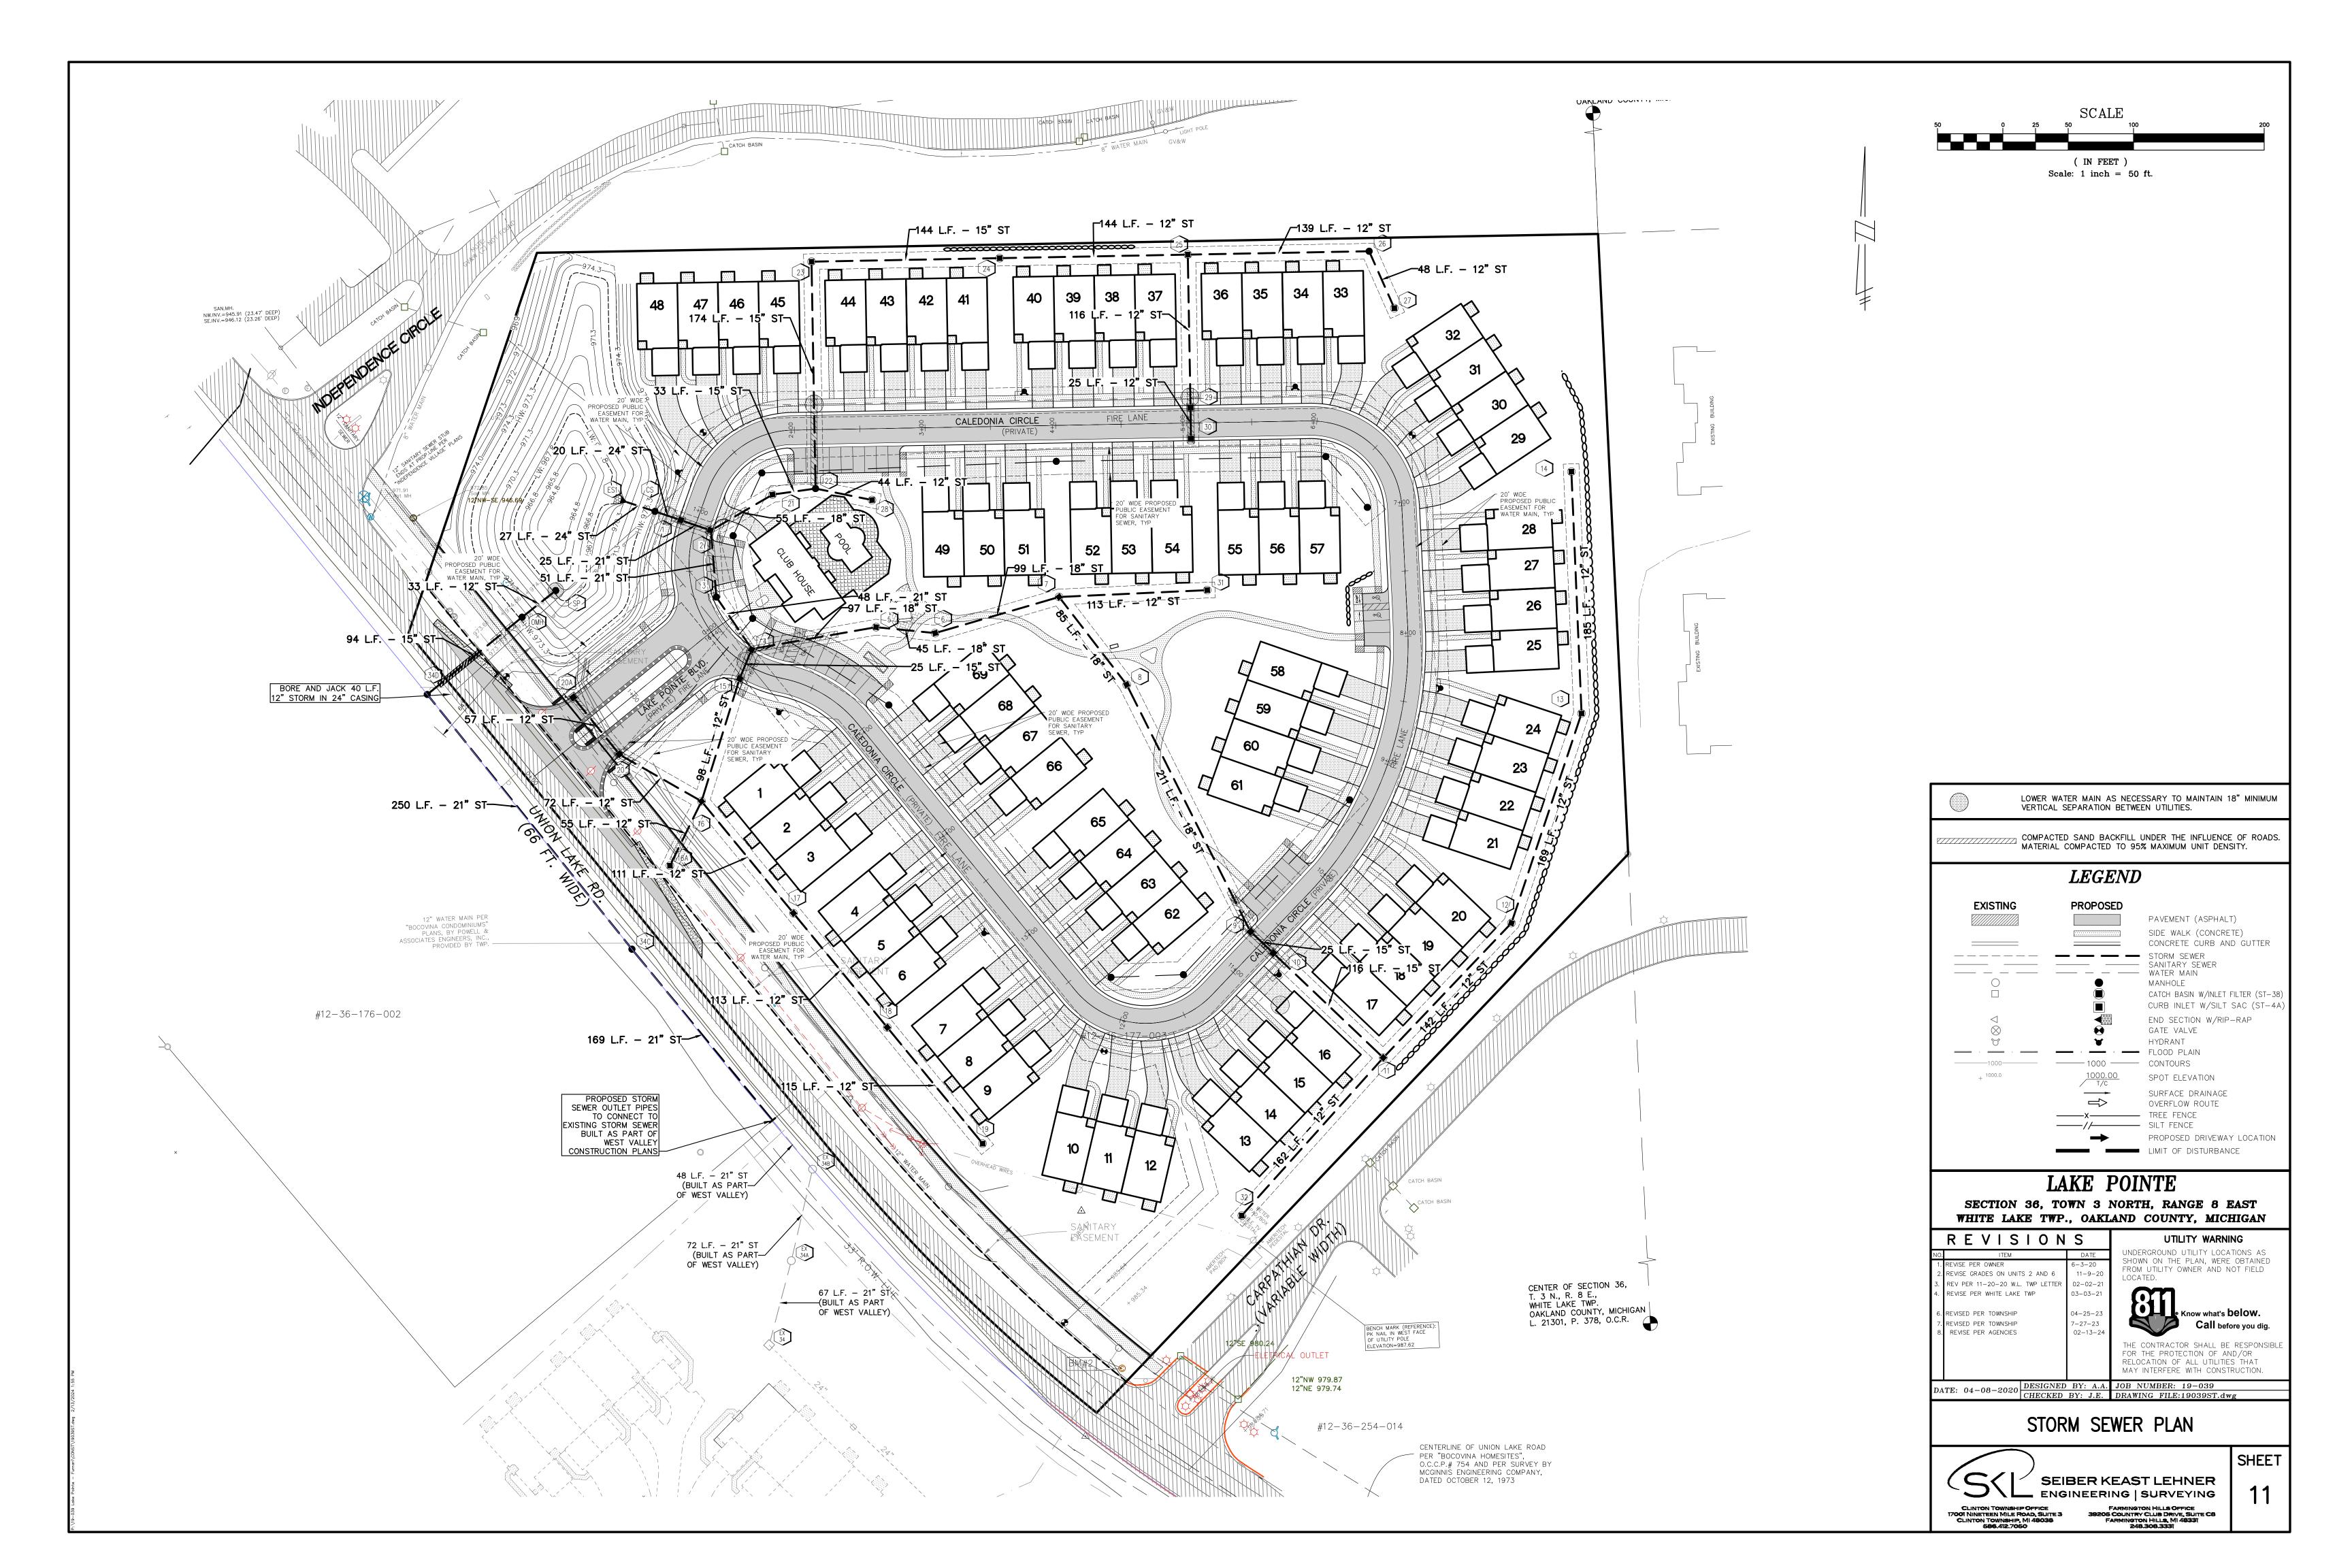
RELOCATION OF ALL UTILITIES THAT MAY INTERFERE WITH CONSTRUCTION. DATE: 04-08-2020 DESIGNED BY: A.A. JOB NUMBER: 19-039


WATERMAIN PLAN





SEIBER KEAST LEHNER ENGINEERING | SURVEYING FARMINGTON HILLS OFFICE 39205 COUNTRY CLUB DRIVE, SUITE C8 FARMINGTON HILLS, MI 48331 248.308.3331



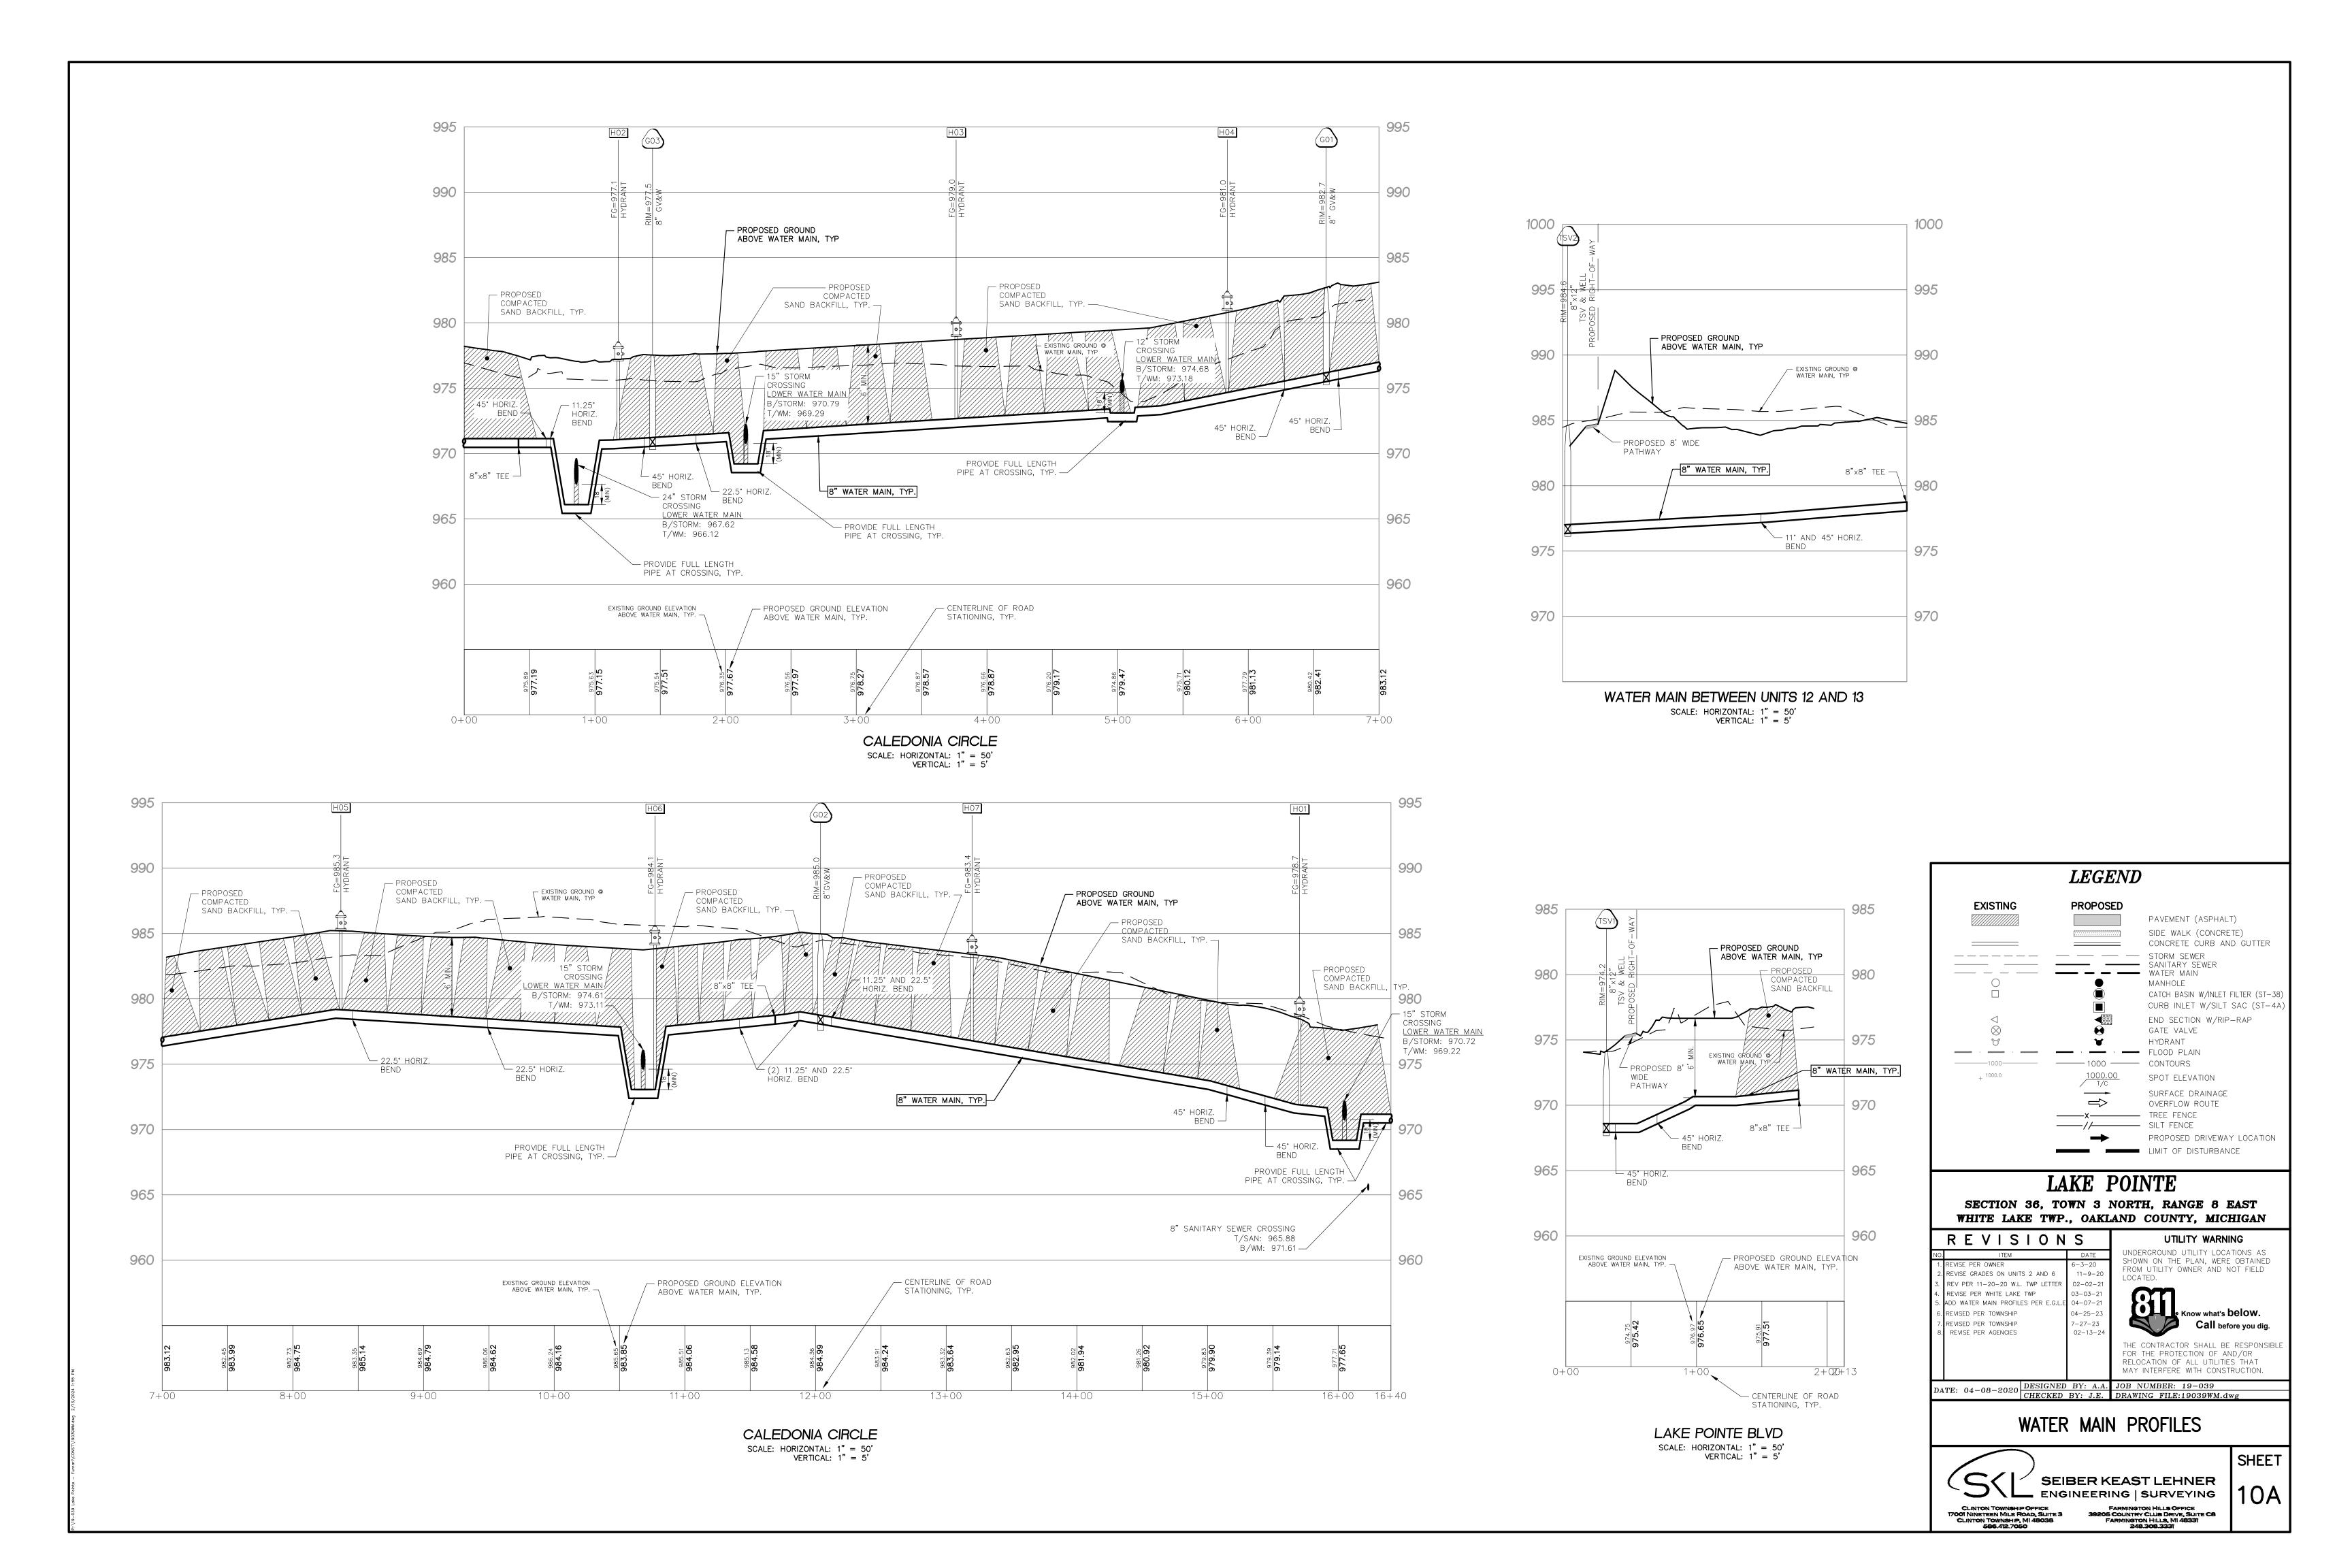

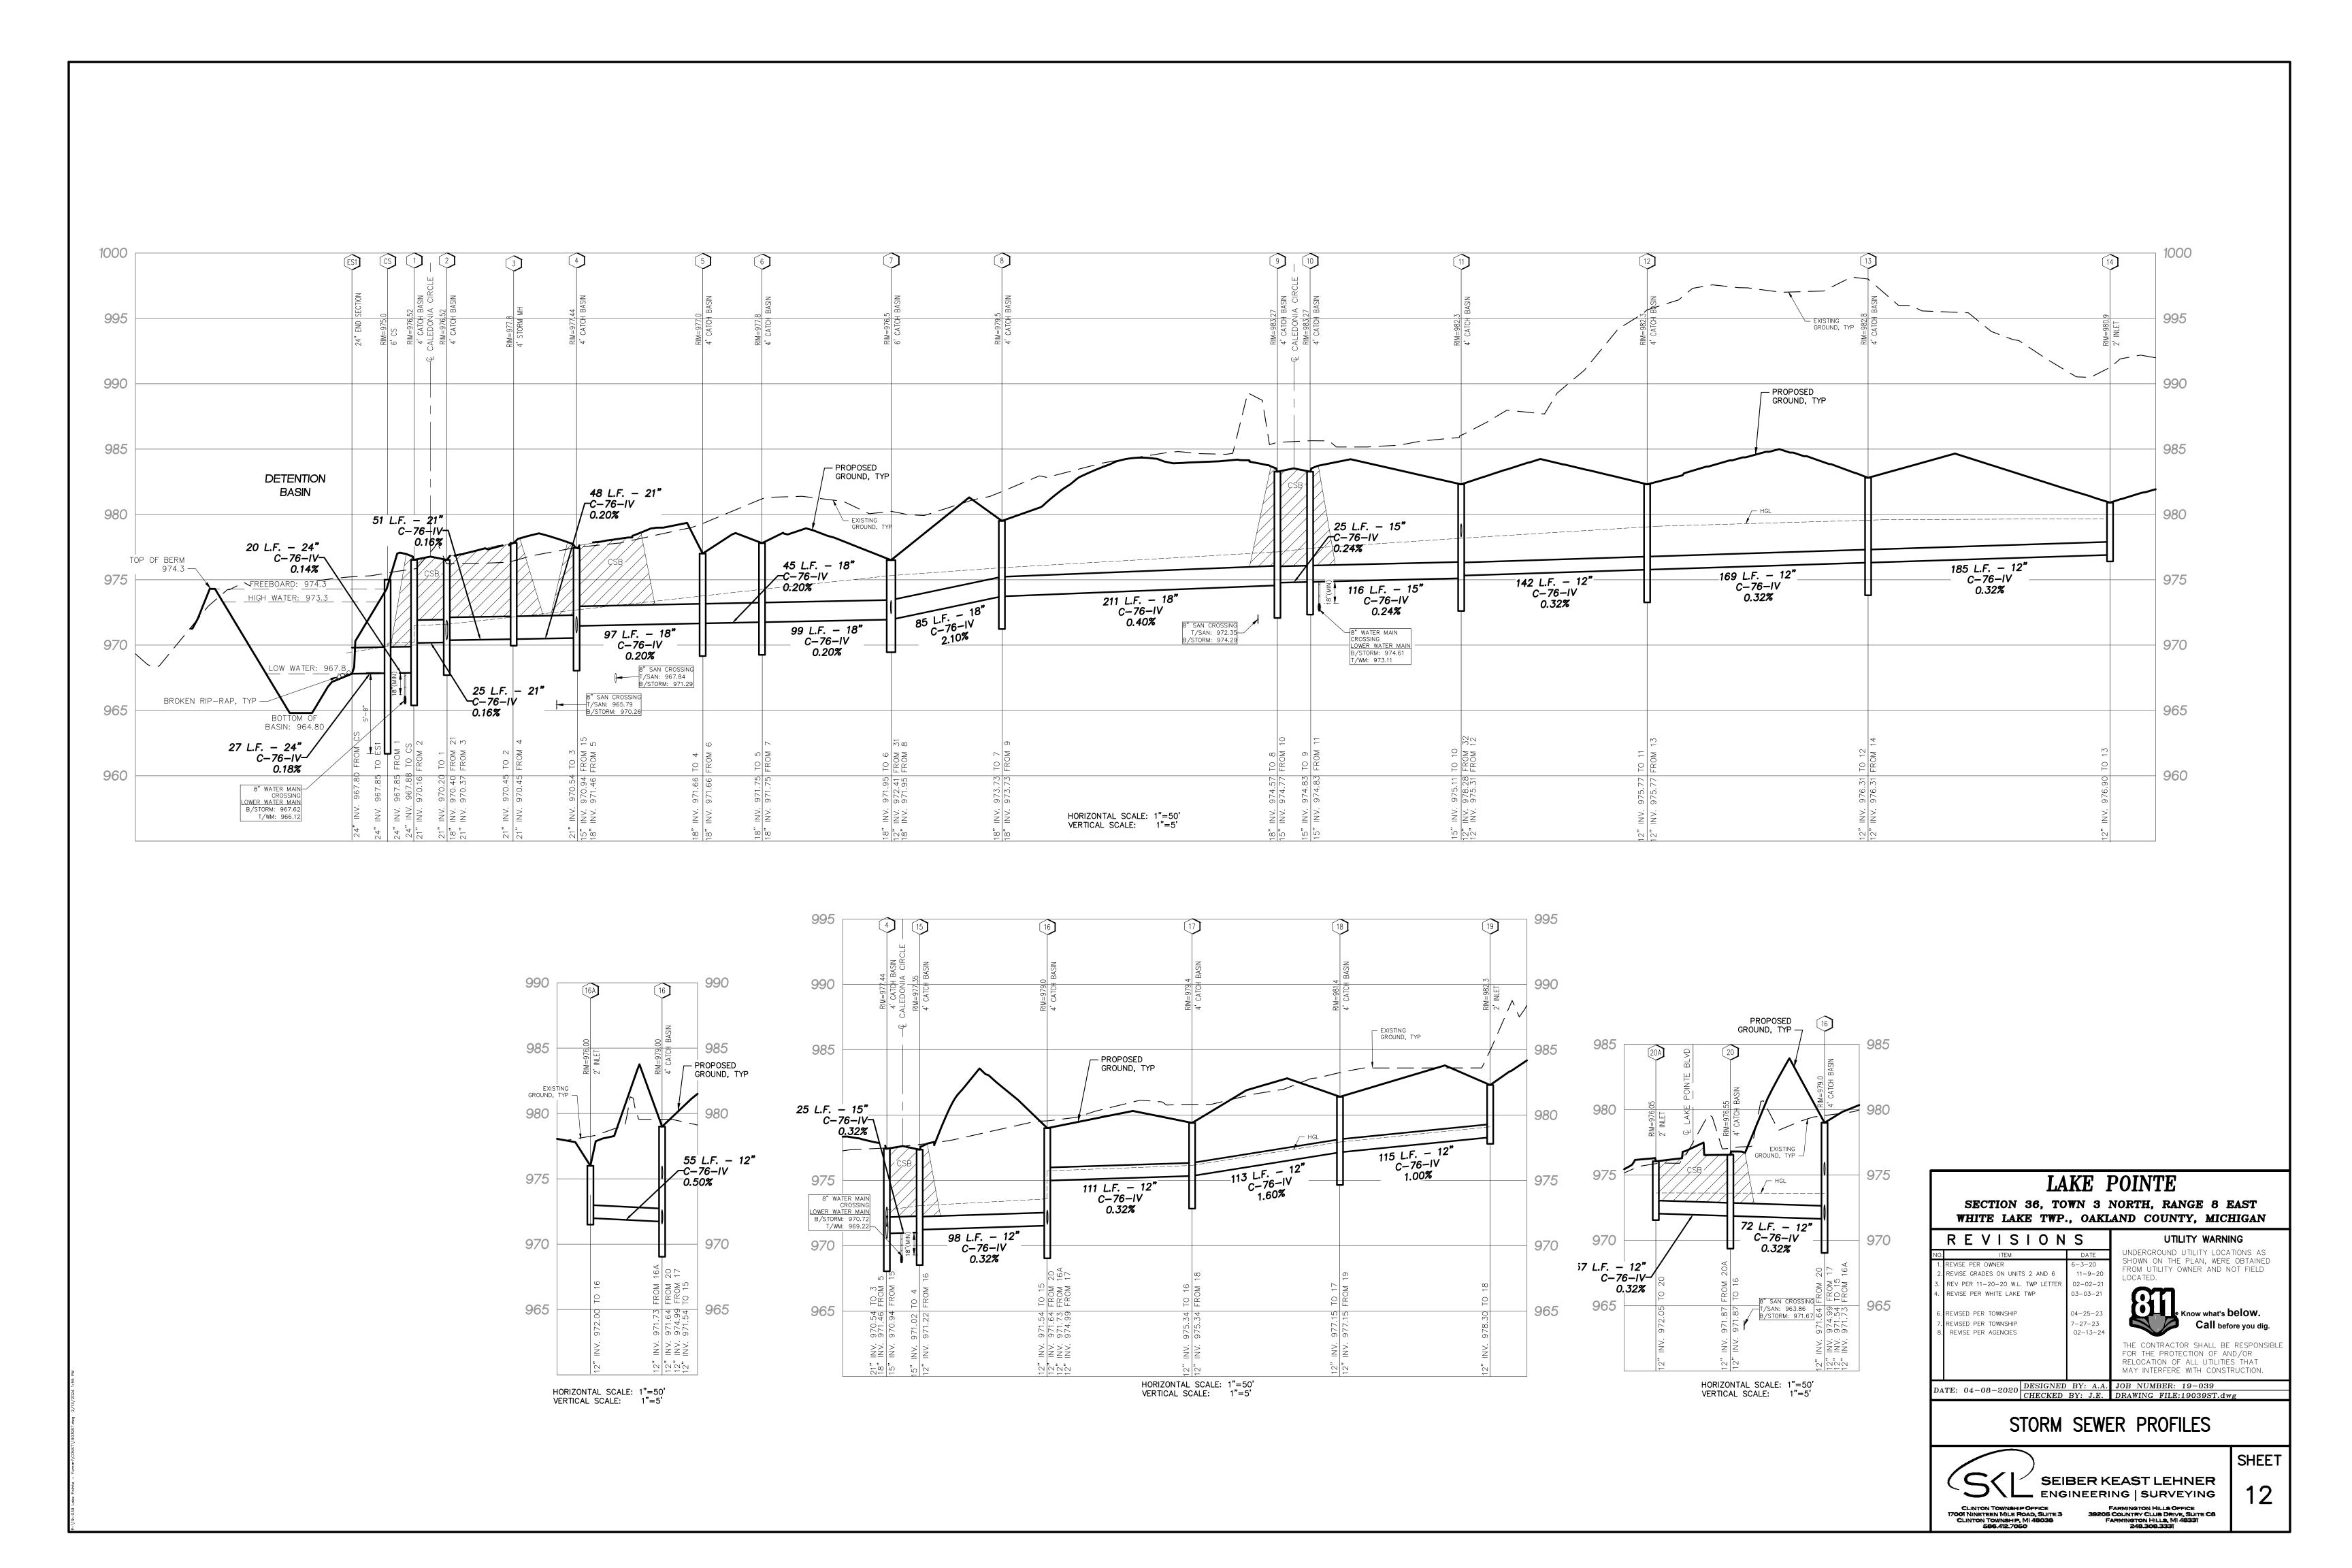

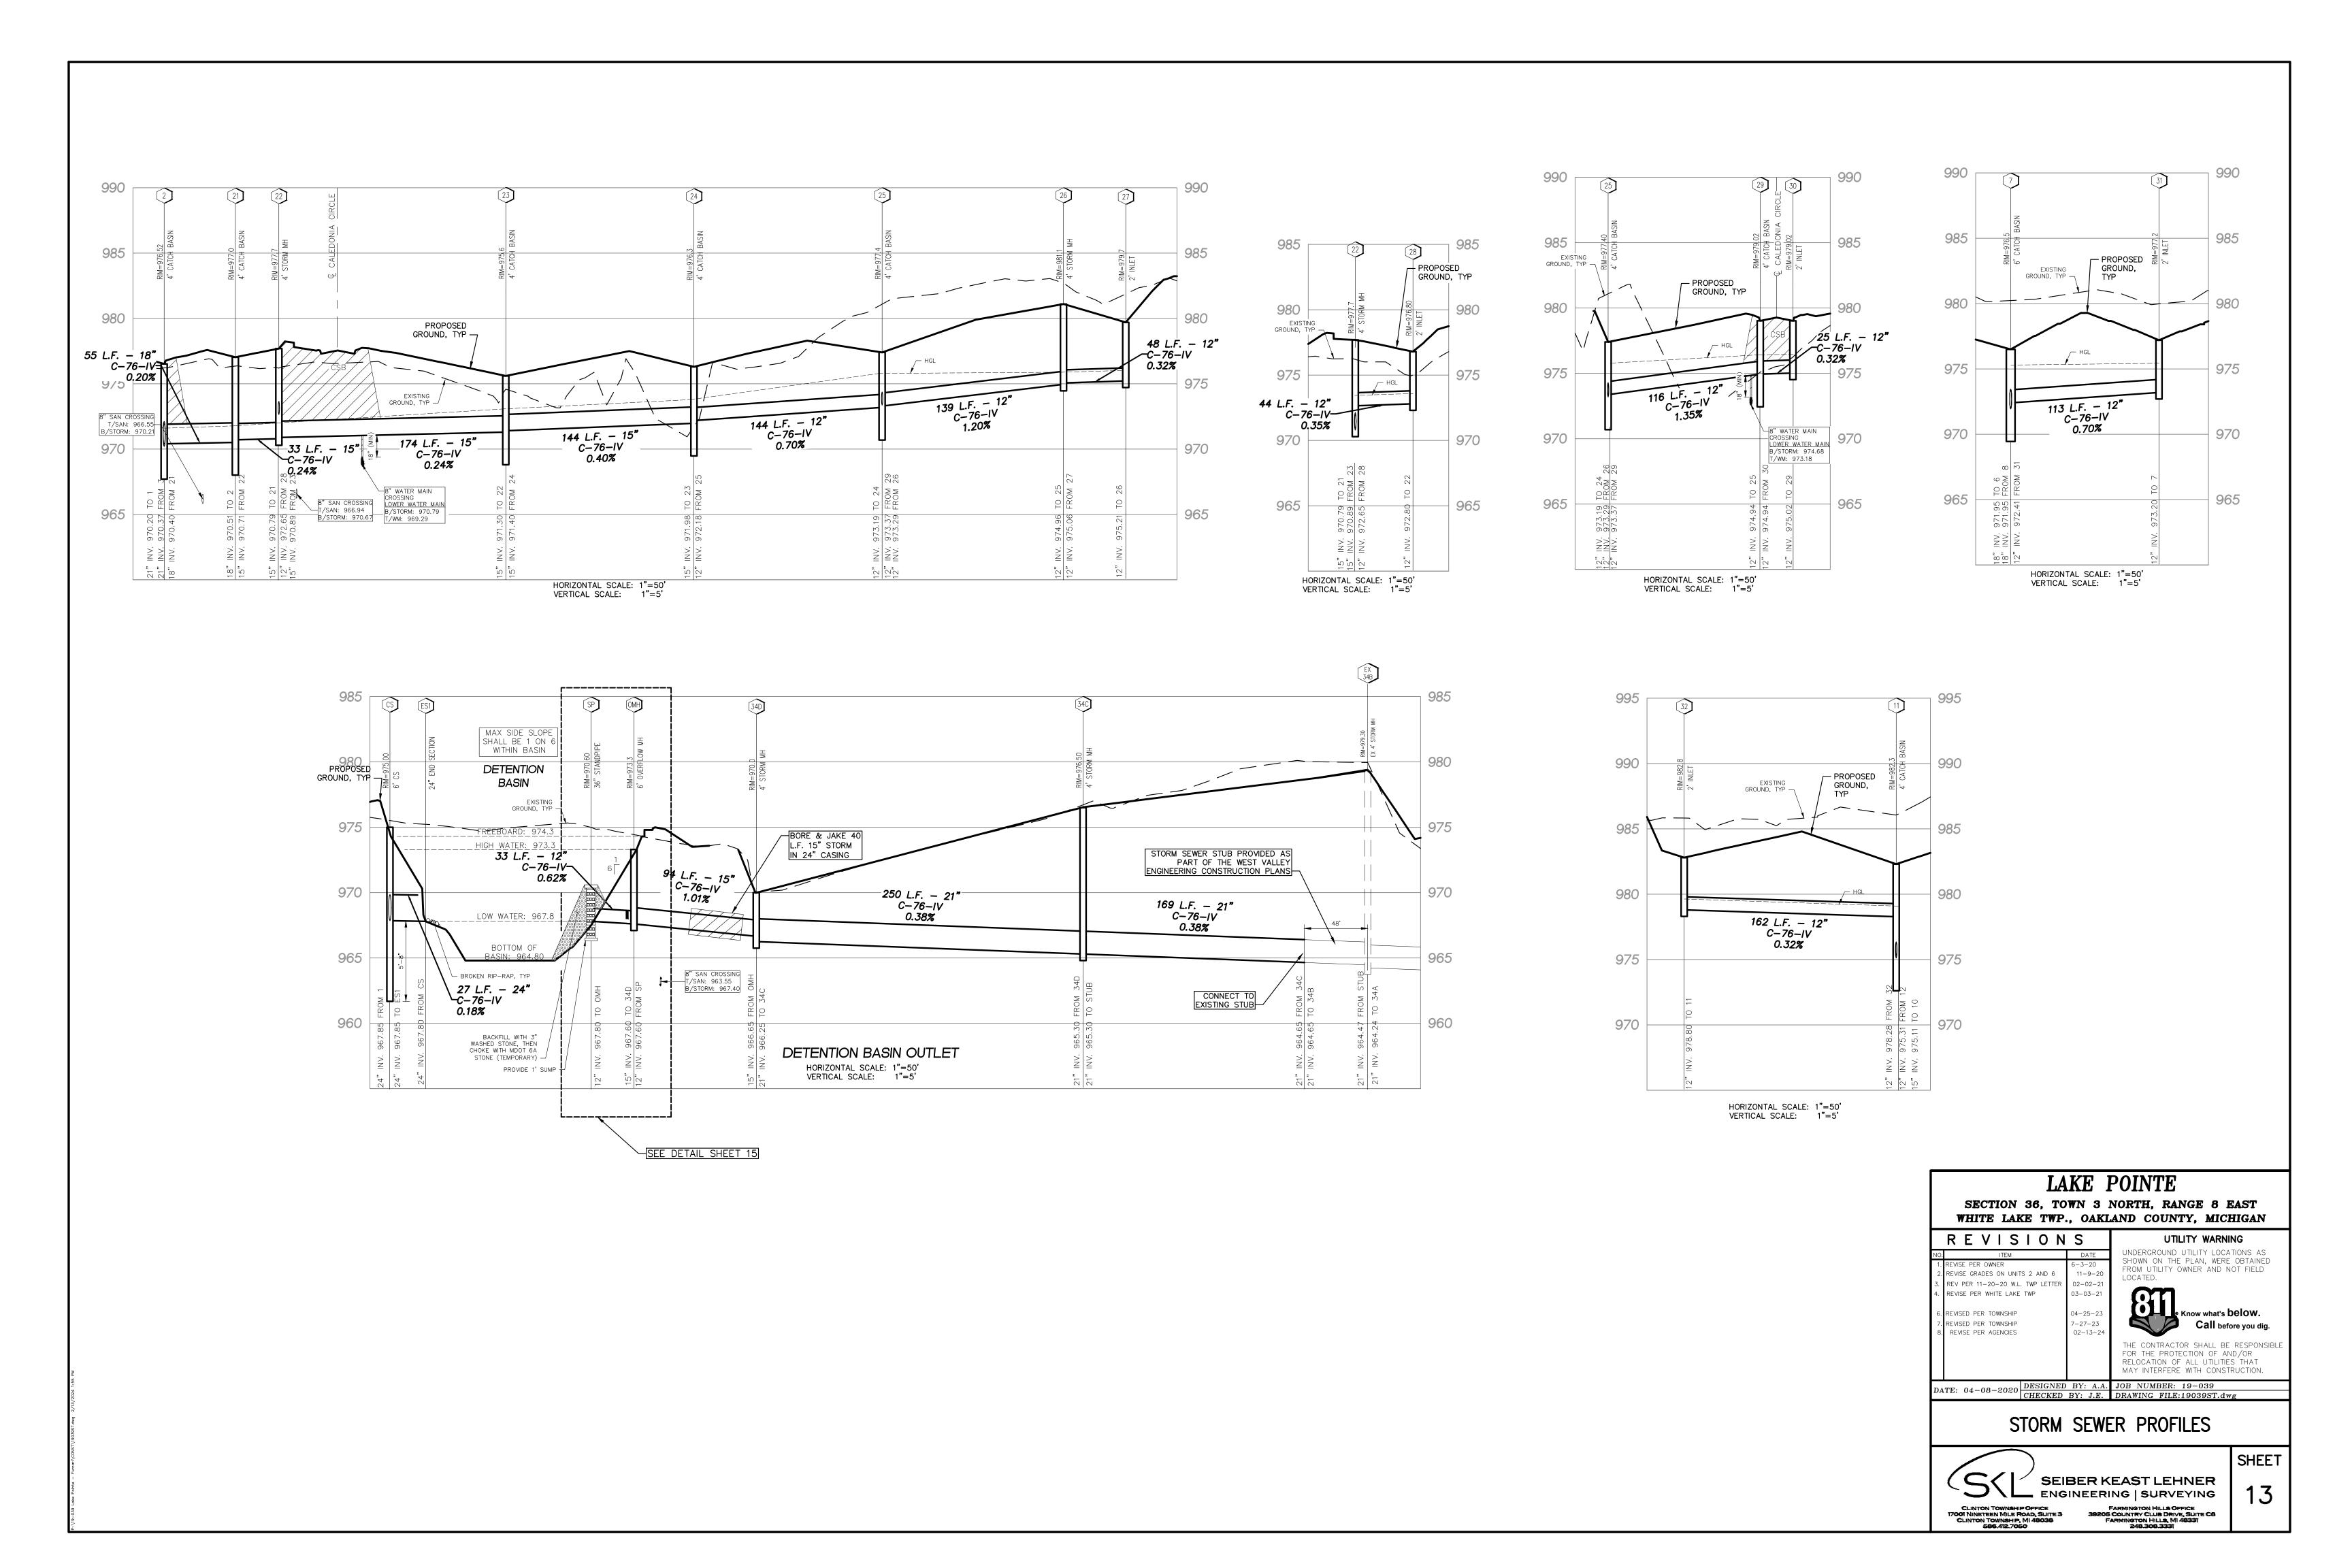

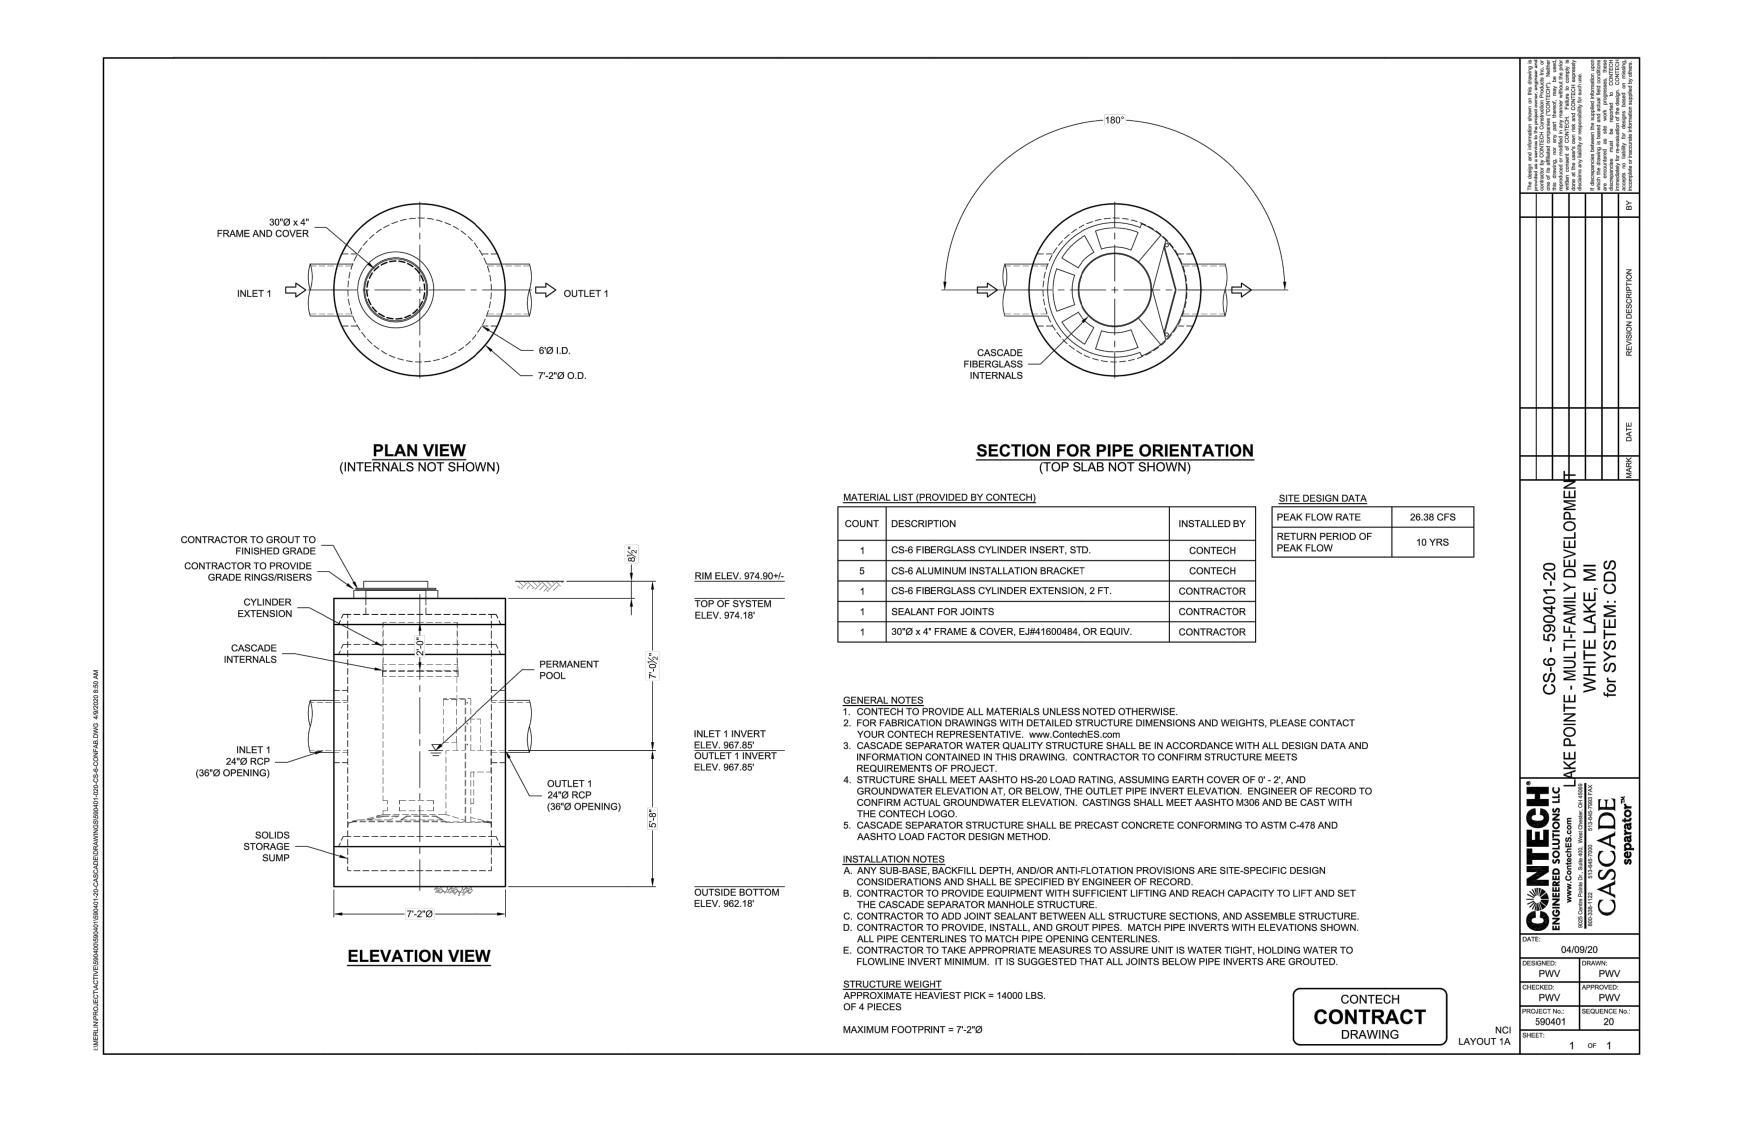

Estimated Net Annual Solids Load Reduction Based on the Rational Rainfall Method

Lake Pointe

White Lake Twp., MI **Water Quality Unit**

CASCADE MODEL AREA 11.89 acres WEIGHTED C 0.53 PARTICLE SIZE TC 21.14 minutes

110 microns RAINFALL STATION

CS-6

Rainfall Intensity ¹ (in/hr)	Percent Rainfall	Cumulative Rainfall Volume	% Rainfall Volume	Total Flowrate (cfs)	Removal Efficiency (%)	Incremental Removal (%)
(11171117	Volume ¹	raman volume	Treated	(6.5)	Efficiency (70)	The mover (70)
0.02	13.13%	13.1%	13.1%	0.13	100.0	13.1
0.04	11.36%	24.5%	11.4%	0.25	100.0	11.4
0.06	10.08%	34.6%	10.1%	0.38	100.0	10.1
0.08	7.49%	42.1%	7.5%	0.50	100.0	7.5
0.10	7.01%	49.1%	7.0%	0.63	100.0	7.0
0.12	5.37%	54.4%	5.4%	0.76	100.0	5.4
0.14	4.73%	59.2%	4.7%	0.88	98.7	4.7
0.16	4.13%	63.3%	4.1%	1.01	96.9	4.0
0.18	3.53%	66.8%	3.5%	1.13	95.0	3.4
0.20	2.99%	69.8%	3.0%	1.26	93.1	2.8
0.25	5.50%	75.3%	5.5%	1.58	88.4	4.9
0.30	4.47%	79.8%	4.5%	1.89	83.7	3.7
0.35	3.85%	83.6%	3.9%	2.21	79.0	3.0
0.40	2.16%	85.8%	2.2%	2.52	74.3	1.6
0.45	2.09%	87.9%	2.1%	2.84	69.6	1.5
0.50	1.31%	89.2%	1.3%	3.15	64.9	0.8
0.75	5.07%	94.3%	5.1%	4.73	41.4	2.1
1.00	2.58%	96.9%	2.3%	6.30	25.2	0.6
1.50	2.50%	99.4%	1.5%	9.45	16.8	0.4
2.00	0.51%	99.9%	0.2%	12.60	12.6	0.1
2.54	0.15%	100.0%	0.1%	16.01	9.9	0.0
						88.0
				Removal Effici	ency Adjustment ² =	6.5%
				Predicted % Annua	al Rainfall Treated =	91.8%
			Predicted	l Net Annual Load R	emoval Efficiency =	81.5%

1 - Based on 5.5 years of 15 minute precipitation data form NCDC station 2102 at Detroit City Airport in Detroit, MI

- Reduction due to use of 60-minute data for a site that has a time of concentration less than 30-minutes.

LAKE POINTE SECTION 36, TOWN 3 NORTH, RANGE 8 EAST WHITE LAKE TWP., OAKLAND COUNTY, MICHIGAN

REVISIONS REVISE GRADES ON UNITS 2 AND 6 REV PER 11-20-20 W.L. TWP LETTER 02-02-21 REVISE PER WHITE LAKE TWP . REVISED PER TOWNSHIP

7. REVISED PER TOWNSHIP B. REVISE PER AGENCIES

UTILITY WARNING UNDERGROUND UTILITY LOCATIONS AS SHOWN ON THE PLAN, WERE OBTAINED FROM UTILITY OWNER AND NOT FIELD

Know what's below.

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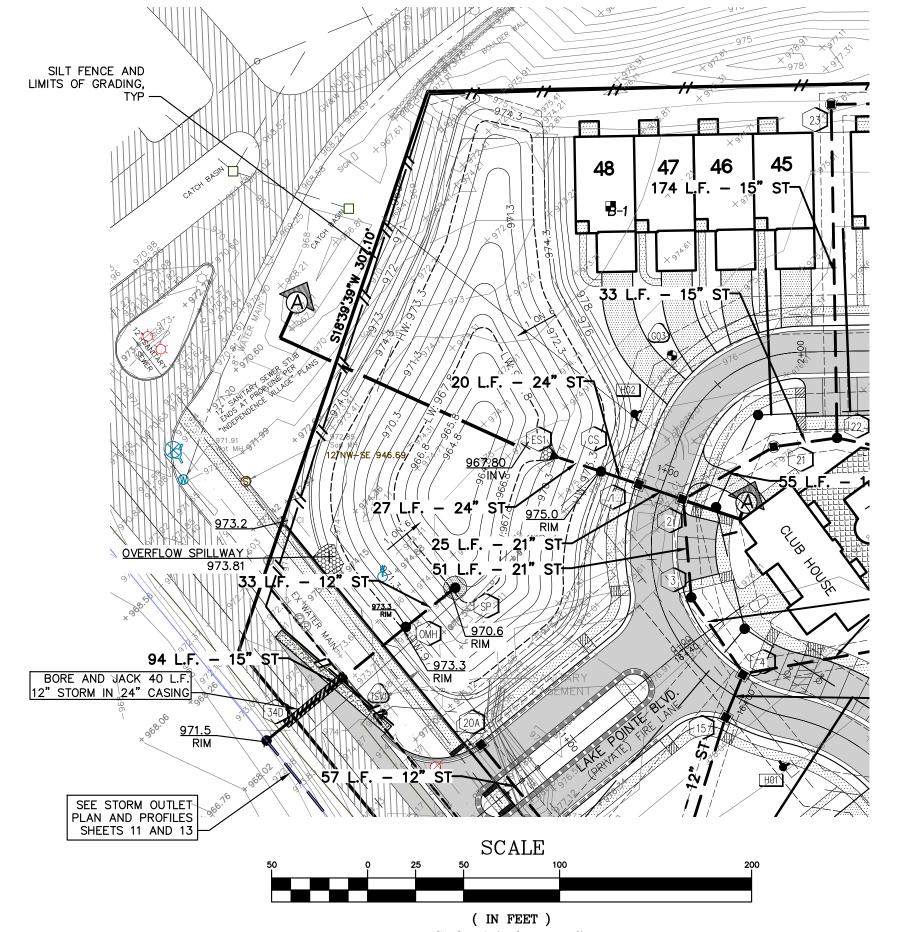
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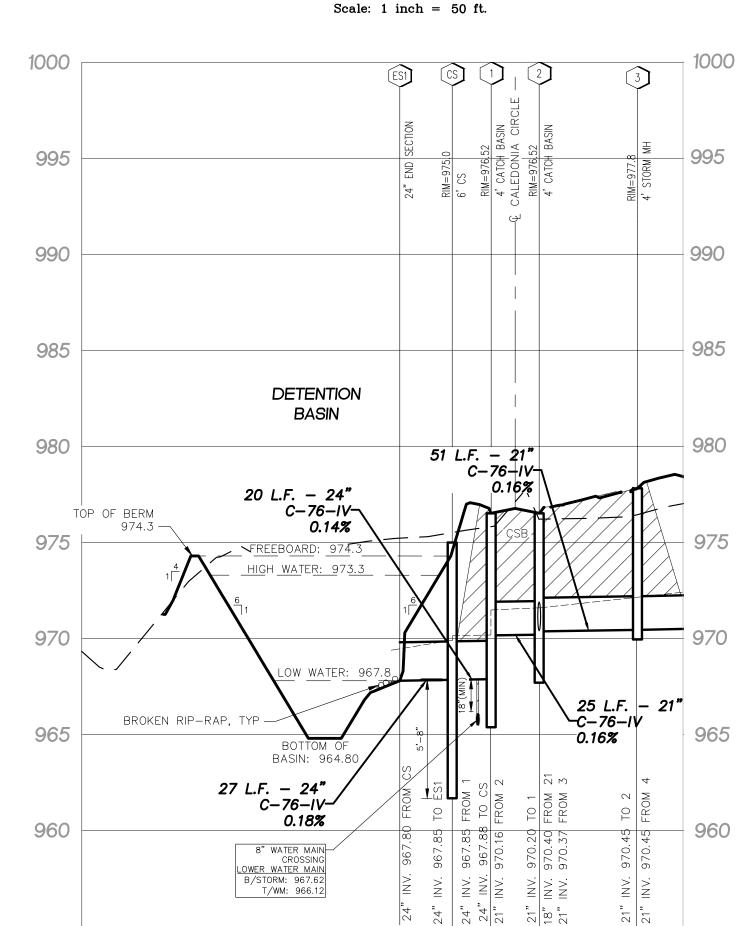
DATE: 04-08-2020 DESIGNED BY: A.A. JOB NUMBER: 19-039
CHECKED BY: J.E. DRAWING FILE:19039CDS.dwg

CONTECH CS-6 DETAILS



SEIBER KEAST LEHNER L ENGINEERING | SURVEYING FARMINGTON HILLS OFFICE 39205 COUNTRY CLUB DRIVE, SUITE C8 FARMINGTON HILLS, MI 48331 248.308.3331






	Ac=	11.64	Ac	Developed ON-SITE area trib	utary to the [Detention I
	Q _{all} =	2.33	cfs	Allowable Outflow (Total Ar	•	
	C =	0.53	CIS	ranowabie outnow (rotarra	Cu x 0.2 0.3/1	. (0.)
	C -	0.33				
	$Q_o = Q_{all} / ($	(Ac * C) =			0.38	cfs/Ac. Im
		grt (10312.5/Q _o) =				
			··-		139.88	min
	Vs = (1650	0*T)/(T+25)-40*Q _o	* =		11876	cf/Ac. Imp
	Vt = Vs * A	\c. * C =			72,880	ft ³ req'd
			QUIREMEN	ITS (1-YEAR STORM)		
OCWRC Vol		·				- 3
	Vr = 4320 °	* C * A =			26,511	ft
DETERMAN		F DDO\#DED FOD	1 VEAD AA	ID 400 VEAD STODIAS		
DETERIVITIN	E VOLUIVI	E PROVIDED FOR	1 TEAR AI	ND 100-YEAR STORMS		
	Elevation	Area	Vol (ft ³)			
Low Water	967.8	6,248	voi (it)			
2011 11 410.	968.3	7,336	3,396			
	969.3	9,785	11,957	1 Year Strom EL. =	970.60	ft
	970.3	12,665	23,182	Volume provided =	27,517	
	970.3	16,238	37,633	volume provided =	27,317	I L
	971.3	20,112	55,808	100 Year Strom EL. =	973.30	ft
					77,932	
High Water	973.3	24,135	77,932	Volume provided =	77,932	π
DETERMIN	F OUTLET	SIZE TO DEWAT	FR 1 VFΔR	STORM IN 48 HOURS		
DETERMINA	LOOILLI	SIZE TO DEWAT	LIVITEAN	310NW IN 481100N3		
	Volumo o	f Storage =	27,517	f+3		
		ırface Area =	9,827	f+ ²		
		ea Required =	0.038			
		diameter hole =	0.00545			
		f holes required =				
		herefore use				
			7	1 'INDMATAR HAIAC		
		nereiore use	7	- 1" Diameter Holes		
	I	nerefore use	7	- 1" Diameter Holes		
<u>DETERMIN</u>	E 100-YEA	AR DETENTION BA	ASIN OUTL	ET SIZE		
DETERMIN	E 100-YEA		ASIN OUTL	ET SIZE H)		
<u>DETERMIN</u>	E 100-YEA Orifice For	AR DETENTION BA rmula, Q = 0.625*A	ASIN OUTL	ET SIZE		
<u>DETERMIN</u>	E 100-YEA Orifice For Q _{all} = Outlet Size	AR DETENTION B rmula, Q = 0.625*A e =	ASIN OUTL *sqrt(64.4*) 2.33 6.000	ET SIZE H) cfs in		
<u>DETERMIN</u>	E 100-YEA Orifice For Qall = Outlet Size Invert Elev	AR DETENTION BA rmula, Q = 0.625*A e = vation =	*sqrt(64.4* 2.33 6.000 967.80	ET SIZE H) cfs in ft		
DETERMIN	E 100-YEA Orifice For Q _{all} = Outlet Size Invert Elev Springline	AR DETENTION BA rmula, Q = 0.625*A e = vation =	*sqrt(64.4*) 2.33 6.000 967.80 968.05	ET SIZE H) cfs in ft ft		
<u>DETERMIN</u>	E 100-YEA Orifice For Qall = Outlet Size Invert Elev Springline H =	kR DETENTION BA rmula, Q = 0.625*A e = vation = EL. =	*sqrt(64.4* 2.33 6.000 967.80 968.05 5.25	ET SIZE H) cfs in ft ft ft		
DETERMIN	E 100-YEA Orifice For Q _{all} = Outlet Size Invert Elev Springline H = Area Req'o	AR DETENTION BA rmula, Q = 0.625*A e = vation = EL. = d = A =	*sqrt(64.4*) 2.33 6.000 967.80 968.05 5.25 0.2026	ET SIZE H) cfs in ft ft ft sf		
DETERMIN	E 100-YEA Orifice For Qall = Outlet Size Invert Elev Springline H = Area Req'o	AR DETENTION BA rmula, Q = 0.625*A e = vation = e EL. = d = A = utlet Used	*sqrt(64.4* 2.33 6.000 967.80 968.05 5.25 0.2026 0.1963	ET SIZE H) cfs in ft ft ft sf		
DETERMIN	E 100-YEA Orifice For Q _{all} = Outlet Size Invert Elev Springline H = Area Req'o	AR DETENTION BA rmula, Q = 0.625*A e = vation = EL. = d = A = utlet Used Req'd =	*sqrt(64.4*) *sqrt(64.4*) 2.33 6.000 967.80 968.05 5.25 0.2026 0.1963 6.000	ET SIZE H) cfs in ft ft ft sf sf in		
DETERMIN	E 100-YEA Orifice For Qall = Outlet Size Invert Elect Springline H = Area Req'or Area of Outline Diameter	e = vation = d = A = utlet Used Req'd = USE	*sqrt(64.4* 2.33 6.000 967.80 968.05 5.25 0.2026 0.1963 6.000 6.000	ET SIZE H) cfs in ft ft ft sf sf in in Dia Outlet		
DETERMIN	E 100-YEA Orifice For Qall = Outlet Size Invert Elev Springline H = Area Req'o	e = vation = d = A = utlet Used Req'd = USE	*sqrt(64.4*) *sqrt(64.4*) 2.33 6.000 967.80 968.05 5.25 0.2026 0.1963 6.000	ET SIZE H) cfs in ft ft ft sf sf in		
	E 100-YEA Orifice For Qall = Outlet Size Invert Elect Springline H = Area Req'or Area of Out Diameter Q Discharg	AR DETENTION BA rmula, Q = 0.625*A e = vation = e EL. = d = A = utlet Used Req'd = USE ge =	*sqrt(64.4* 2.33 6.000 967.80 968.05 5.25 0.2026 0.1963 6.000 6.000	ET SIZE H) cfs in ft ft ft sf sf in in Dia Outlet		
	E 100-YEA Orifice For Qall = Outlet Size Invert Elect Springline H = Area Req'o Area of Out Diameter Q Discharg	AR DETENTION BA rmula, Q = 0.625*A e = vation = EL. = d = A = utlet Used Req'd = USE ge =	*sqrt(64.4* 2.33 6.000 967.80 968.05 5.25 0.2026 0.1963 6.000 6.000	ET SIZE H) cfs in ft ft ft sf sf in in Dia Outlet	6	fa
	E 100-YEA Orifice For Qall = Outlet Size Invert Elev Springline H = Area Req'or Area of Out Diameter Q Discharg RY OVERFL Size of Ov	e = vation = e EL. = d = A = utlet Used Req'd = USE ge = OW STRURCTURE erflow MH =	*sqrt(64.4*) *sqrt(64.4*) 2.33 6.000 967.80 968.05 5.25 0.2026 0.1963 6.000 6.000 2.26	ET SIZE H) cfs in ft ft ft sf sf in in Dia Outlet		ft 94
	E 100-YEA Orifice For Qall = Outlet Size Invert Elev Springline H = Area Req'o Area of Ou Diameter Q Discharge RY OVERFL Size of Ov % of MH th	AR DETENTION BA rmula, Q = 0.625*A e = vation = EL. = d = A = utlet Used Req'd = USE ge = OW STRURCTURE erflow MH = hat can be used as	*sqrt(64.4*) 2.33 6.000 967.80 968.05 5.25 0.2026 0.1963 6.000 6.000 2.26 (OMH) a Weir =	ET SIZE H) cfs in ft ft ft sf sf in in Dia Outlet	50	%
	E 100-YEA Orifice For Qall = Outlet Size Invert Elev Springline H = Area Req'o Area of Ou Diameter Q Discharg RY OVERFL Size of Ov % of MH th Calculated	e = vation = e EL. = d = A = utlet Used Req'd = USE ge = OW STRURCTURE erflow MH = hat can be used as d Length of Weir =	*sqrt(64.4* 2.33 6.000 967.80 968.05 5.25 0.2026 0.1963 6.000 2.26 (OMH) a Weir = L =	ET SIZE H) cfs in ft ft ft sf sf in in Dia Outlet cfs	50 9.42	% ft
	E 100-YEA Orifice For Qall = Outlet Size Invert Elect Springline H = Area Req'o Area of Ou Diameter Q Discharg RY OVERFL Size of Ov % of MH th Calculated Acerage Ti	e = vation = et L. = d = A = utlet Used Req'd = USE ge = erflow MH = hat can be used as d Length of Weir = ributry to Overflow	*sqrt(64.4* 2.33 6.000 967.80 968.05 5.25 0.2026 0.1963 6.000 6.000 2.26 (OMH) a Weir = L = v (onsite + c	ET SIZE H) cfs in ft ft ft sf sf in in Dia Outlet cfs	50 9.42 12.58	% ft Ac
SIZE PRIMA	E 100-YEA Orifice For Qall = Outlet Size Invert Elev Springline H = Area Req'o Area of Ou Diameter Q Discharg RY OVERFL Size of Ov % of MH th Calculated Acerage To	e = vation = e EL. = d = A = utlet Used Req'd = USE ge = erflow MH = hat can be used as d Length of Weir = ributry to Overflov e Runoff Coefficie	*sqrt(64.4* 2.33 6.000 967.80 968.05 5.25 0.2026 0.1963 6.000 6.000 2.26 (OMH) a Weir = L = v (onsite + c	ET SIZE H) cfs in ft ft ft sf sf in in Dia Outlet cfs	50 9.42	% ft Ac
	E 100-YEA Orifice For Qall = Outlet Size Invert Elev Springline H = Area Req'o Area of Ou Diameter Q Discharg RY OVERFL Size of Ov % of MH tl Calculated Acerage Ti Composite Flow Calcu	AR DETENTION BA rmula, Q = 0.625*A e = vation = EL. = d = A = utlet Used Req'd = USE ge = erflow MH = hat can be used as d Length of Weir = ributry to Overflow e Runoff Coefficie lations)	*sqrt(64.4* 2.33 6.000 967.80 968.05 5.25 0.2026 0.1963 6.000 2.26 (OMH) a Weir = L = v (onsite + cont =	ET SIZE H) cfs in ft ft ft sf sf in in Dia Outlet cfs	50 9.42 12.58 0.53	% ft Ac
SIZE PRIMA	E 100-YEA Orifice For Qall = Outlet Size Invert Elev Springline H = Area Req'o Area of Ou Diameter Q Discharg RY OVERFL Size of Ov % of MH th Calculated Acerage To Composite Flow Calcul Longest Ti	e = vation = e EL. = d = A = utlet Used Req'd = USE ge = erflow MH = hat can be used as d Length of Weir = ributry to Overflov e Runoff Coefficie	*sqrt(64.4*) 2.33 6.000 967.80 968.05 5.25 0.2026 0.1963 6.000 6.000 2.26 (OMH) a Weir = L = v (onsite + cont =	ET SIZE H) cfs in ft ft ft sf sf in in Dia Outlet cfs	50 9.42 12.58 0.53 21.19	% ft Ac min
SIZE PRIMA	E 100-YEA Orifice For Qall = Outlet Size Invert Elev Springline H = Area Req'o Area of Ou Diameter Q Discharg RY OVERFL Size of Ov % of MH th Calculated Acerage To Composite Flow Calcul Longest Ti Sum of all	e = vation = e EL. = d = A = utlet Used Req'd = USE ge = own STRURCTURE erflow MH = hat can be used as d Length of Weir = ributry to Overflow e Runoff Coefficien lations) me of Flow to Basi	*sqrt(64.4* 2.33 6.000 967.80 968.05 5.25 0.2026 0.1963 6.000 6.000 2.26 (OMH) a Weir = L = v (onsite + cont =	ET SIZE H) cfs in ft ft ft sf sf in in Dia Outlet cfs	50 9.42 12.58 0.53 21.19 23.74	% ft Ac min cfs
SIZE PRIMA	E 100-YEA Orifice For Qall = Outlet Size Invert Eleve Springline H = Area Req'or Area of Out Diameter Q Discharge RY OVERFL Size of Ov % of MH to Calculated Acerage To Composite Flow Calcul Longest Ti Sum of all Volume or	e = vation = EL. = d = A = utlet Used Req'd = USE ge = hat can be used as d Length of Weir = ributry to Overflow e Runoff Coefficie lations) me of Flow to Basi Flow into the Basi f Baisn (Det Calcs)	*sqrt(64.4* 2.33 6.000 967.80 968.05 5.25 0.2026 0.1963 6.000 6.000 2.26 (OMH) a Weir = L = v (onsite + cont =	ET SIZE H) cfs in ft ft ft sf sf in in Dia Outlet cfs	50 9.42 12.58 0.53 21.19 23.74 77,932	% ft Ac min cfs ft³
SIZE PRIMA	E 100-YEA Orifice For Qall = Outlet Size Invert Elev Springline H = Area Req'o Area of Ou Diameter Q Discharg RY OVERFL Size of Ov % of MH tl Calculated Acerage Tr Composite Flow Calcu Longest Ti Sum of all Volume or Storage El	e = vation = e EL. = d = A = utlet Used Req'd = USE ge = erflow MH = hat can be used as d Length of Weir = ributry to Overflow e Runoff Coefficie lations) me of Flow to Basi f Baisn (Det Calcs) evation =	*sqrt(64.4* 2.33 6.000 967.80 968.05 5.25 0.2026 0.1963 6.000 6.000 2.26 (OMH) a Weir = L = v (onsite + cont =	ET SIZE H) cfs in ft ft ft sf sf in in Dia Outlet cfs	50 9.42 12.58 0.53 21.19 23.74 77,932 973.30	% ft Ac min cfs ft³ ft
SIZE PRIMA	E 100-YEA Orifice For Qall = Outlet Size Invert Eleve Springline H = Area Req'or Area of Out Diameter Q Discharge RY OVERFL Size of Ov % of MH the Calculated Acerage To Composite Flow Calculated Longest Ti Sum of all Volume or Storage El Freeboard	e = vation = e EL. = d = A = utlet Used Req'd = USE ge = cow STRURCTURE erflow MH = hat can be used as d Length of Weir = ributry to Overflow e Runoff Coefficie lations) me of Flow to Basi Flow into the Basi f Baisn (Det Calcs) evation = d Elevation =	*sqrt(64.4*) 2.33 6.000 967.80 968.05 5.25 0.2026 0.1963 6.000 6.000 2.26 (OMH) a Weir = L = v (onsite + cont = n = n =	ET SIZE H) cfs in ft ft ft sf sf sf in in Dia Outlet cfs	50 9.42 12.58 0.53 21.19 23.74 77,932 973.30 974.30	% ft Ac min cfs ft³ ft
SIZE PRIMA	E 100-YEA Orifice For Qall = Outlet Size Invert Elev Springline H = Area Req'o Area of Ou Diameter Q Discharg RY OVERFL Size of Ov % of MH tl Calculated Acerage Tr Composite Flow Calcu Longest Ti Sum of all Volume or Storage El Freeboard Time to Fi	rmula, Q = 0.625*A e = vation = EL. = d = A = utlet Used Req'd = USE ge = OW STRURCTURE erflow MH = hat can be used as d Length of Weir = ributry to Overflow e Runoff Coefficie lations) me of Flow to Basi f Baisn (Det Calcs) evation = d Elevation = ll Basin Vprov / Flo	*sqrt(64.4*) 2.33 6.000 967.80 968.05 5.25 0.2026 0.1963 6.000 6.000 2.26 (OMH) a Weir = L = v (onsite + cont = n = n =	ET SIZE H) cfs in ft ft ft sf sf sf in in Dia Outlet cfs	50 9.42 12.58 0.53 21.19 23.74 77,932 973.30 974.30 54.71	% ft Ac min cfs ft³ ft ft min.
SIZE PRIMA	E 100-YEA Orifice For Qall = Outlet Size Invert Elev Springline H = Area Req'o Area of Ou Diameter Q Discharg RY OVERFL Size of Ov % of MH th Calculated Acerage To Composite Flow Calcul Longest Ti Sum of all Volume of Storage El Freeboard Time to Fi I = 175 / (T	AR DETENTION BA rmula, Q = 0.625*A e = vation = EL. = d = A = utlet Used Req'd = USE ge = OW STRURCTURE erflow MH = hat can be used as d Length of Weir = ributry to Overflow e Runoff Coefficien lations) me of Flow to Basi f Baisn (Det Calcs) evation = d Elevation = ll Basin Vprov / Flo f+25) =	*sqrt(64.4*) 2.33 6.000 967.80 968.05 5.25 0.2026 0.1963 6.000 6.000 2.26 (OMH) a Weir = L = v (onsite + cont = n = n =	ET SIZE H) cfs in ft ft ft sf sf sf in in Dia Outlet cfs	50 9.42 12.58 0.53 21.19 23.74 77,932 973.30 974.30 54.71 1.73	% ft Ac min cfs ft³ ft ft min. ln/hr
SIZE PRIMA	E 100-YEA Orifice For Qall = Outlet Size Invert Eleve Springline H = Area Req'o Area of Outline Diameter Q Discharge RY OVERFL Size of Ov % of MH the Calculated Acerage To Composite Flow Calculated Longest Ti Sum of all Volume or Storage El Freeboard Time to Fi I = 175 / (T Qexp = C*	rmula, Q = 0.625*A e = vation = e EL. = d = A = utlet Used Req'd = USE ge = cow strurcture erflow MH = hat can be used as d Length of Weir = ributry to Overflow e Runoff Coefficie lations) me of Flow to Basi f Baisn (Det Calcs) evation = d Elevation = ll Basin Vprov / Flo (+25) = l*A =	*sqrt(64.4*) 2.33 6.000 967.80 968.05 5.25 0.2026 0.1963 6.000 6.000 2.26 (OMH) a Weir = L = v (onsite + cont = n = n =	ET SIZE H) cfs in ft ft ft sf sf sf in in Dia Outlet cfs	50 9.42 12.58 0.53 21.19 23.74 77,932 973.30 974.30 54.71	% ft Ac min cfs ft³ ft ft min. ln/hr
SIZE PRIMA	E 100-YEA Orifice For Qall = Outlet Size Invert Eleve Springline H = Area Req'o Area of Outline Diameter Q Discharge RY OVERFL Size of Ov % of MH the Calculated Acerage To Composite Flow Calculated Longest Ti Sum of all Volume or Storage El Freeboard Time to Fi I = 175 / (T Qexp = C*	rmula, Q = 0.625*A e = vation = EL. = d = A = utlet Used Req'd = USE ge = OW STRURCTURE erflow MH = hat can be used as d Length of Weir = ributry to Overflow e Runoff Coefficien lations) me of Flow to Basi f Baisn (Det Calcs) evation = d Elevation = ll Basin Vprov / Flo f+25) = l*A = 33*(L)*(h ^{3/2})	*sqrt(64.4* 2.33 6.000 967.80 968.05 5.25 0.2026 0.1963 6.000 6.000 2.26 (OMH) a Weir = L = v (onsite + cont = n = =	ET SIZE H) cfs in ft ft ft sf sf sf in in Dia Outlet cfs	50 9.42 12.58 0.53 21.19 23.74 77,932 973.30 974.30 54.71 1.73	% ft Ac min cfs ft³ ft ft min. ln/hr
SIZE PRIMA	E 100-YEA Orifice For Qall = Outlet Size Invert Eleve Springline H = Area Req'o Area of Outline Diameter Q Discharge RY OVERFL Size of Ov % of MH the Calculated Acerage To Composite Flow Calculated Longest Ti Sum of all Volume or Storage El Freeboard Time to Fi I = 175 / (T Qexp = C*	rmula, Q = 0.625*A e = vation = e EL. = d = A = utlet Used Req'd = USE ge = cow strurcture erflow MH = hat can be used as d Length of Weir = ributry to Overflow e Runoff Coefficie lations) me of Flow to Basi Flow into the Basi f Baisn (Det Calcs) evation = d Elevation = ll Basin Vprov / Flo f+25) = l*A = 33*(L)*(h ^{3/2}) Calculate how hig	*sqrt(64.4* 2.33 6.000 967.80 968.05 5.25 0.2026 0.1963 6.000 2.26 (OMH) a Weir = L = v (onsite + cont = n = = ew into Basi h the water	ET SIZE H) cfs in ft ft ft ft sf sf in in Dia Outlet cfs offsite) =	50 9.42 12.58 0.53 21.19 23.74 77,932 973.30 974.30 54.71 1.73	% ft Ac min cfs ft³ ft ft min. ln/hr
SIZE PRIMA	E 100-YEA Orifice For Qall = Outlet Size Invert Elect Springline H = Area Req'o Area of Oct Diameter Q Discharg RY OVERFL Size of Ov % of MH the Calculated Acerage To Composite Flow Calculated Longest Ti Sum of all Volume of Storage El Freeboard Time to Fi I = 175 / (T Qexp = C* Qweir = 3.	rmula, Q = 0.625*A e = vation = EL. = d = A = utlet Used Req'd = USE ge = OW STRURCTURE erflow MH = hat can be used as d Length of Weir = ributry to Overflow e Runoff Coefficien lations) me of Flow to Basi f Baisn (Det Calcs) evation = d Elevation = ll Basin Vprov / Flo f+25) = l*A = 33*(L)*(h ^{3/2})	*sqrt(64.4* 2.33 6.000 967.80 968.05 5.25 0.2026 0.1963 6.000 2.26 (OMH) a Weir = L = v (onsite + cont = n = = ew into Basi h the water	ET SIZE H) cfs in ft ft ft ft sf sf in in Dia Outlet cfs offsite) =	50 9.42 12.58 0.53 21.19 23.74 77,932 973.30 974.30 54.71 1.73 11.50	% ft Ac min cfs ft³ ft min. ln/hr cfs
SIZE PRIMA	E 100-YEA Orifice For Qall = Outlet Size Invert Eleve Springline H = Area Req'o Area of Outline Diameter Q Discharge RY OVERFL Size of Ov % of MH the Calculated Acerage To Composite Flow Calculated Longest Ti Sum of all Volume or Storage El Freeboard Time to Fi I = 175 / (T Qexp = C*	rmula, Q = 0.625*A e = vation = e EL. = d = A = utlet Used Req'd = USE ge = OW STRURCTURE erflow MH = hat can be used as d Length of Weir = ributry to Overflow e Runoff Coefficie lations) me of Flow to Basi Flow into the Basi f Baisn (Det Calcs) evation = d Elevation = ll Basin Vprov / Flo f+25) = l*A = 33*(L)*(h ^{3/2}) Calculate how hig Overflow Structur	*sqrt(64.4* 2.33 6.000 967.80 968.05 5.25 0.2026 0.1963 6.000 2.26 (OMH) a Weir = L = v (onsite + cont = n = = ew into Basi h the water	ET SIZE H) cfs in ft ft ft ft sf sf in in Dia Outlet cfs offsite) =	50 9.42 12.58 0.53 21.19 23.74 77,932 973.30 974.30 54.71 1.73	% ft Ac min cfs ft³ ft min. In / hr cfs

Elevation of Water during Overflow Condition is Less than

Detention Basin Calculations

DETERMINE DETENTION VOLUME REQUIREMENTS (100-YEAR STORM)

Determine "C" Factor for Detention	Dasın					
DETERMINE "C" FACTOR		Area			С	
AREA TRIBUTARY TO ON-SITE STORM SEWER		10.95	Ac.			
AREA TRIBUTARY TO CB 16A		0.94	Ac.			
AREA OF DETENTION BASIN		0.69	Ac.			
TOTAL AREA TRIBUTARY TO DETENTION BASIN	=	12.58	Ac			\vdash
DETENTION BASIN LOW WATER	=	0.17	Ac	@	1.00	=
PAVING AREA (WALKS, DRIVE, ROAD)	=	3.14	Ac	@	0.80	=
BUILDING AREA	=	3.19	Ac	@	0.90	=
LAWN AREA INCLUDING DETENTION BASIN AREA	=	6.25	Ac	@	0.20	=
TOTAL AREA	=	12.58	Ac	@		
	. 4 . / -	OT41 460			0.50	-
Cavg = /	4 * C / I	OTAL ACR	F2 =		0.53	\vdash
Determine On-Site Area to be Detain	ed for	in				
Detention Basin Caluclations						
(Note: Exclude ROW Area Tributary to CB 16A)						
TOTAL AREA TRIBUTARY TO DETENTION BASIN	=	12.58	Ac			
AREA TRIBUTARY TO CB 16A	=	-0.94	Ac			

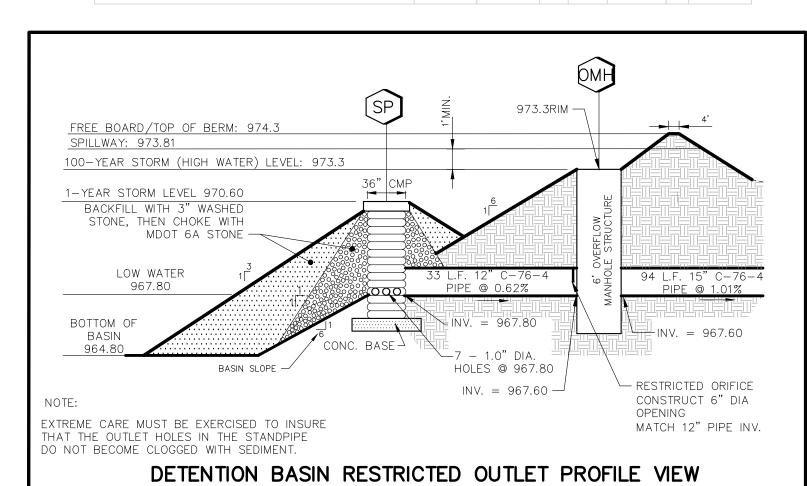


FREEBOARD ELEV.= 974.3 6"-8" DIA. COBBLESTONE (PLACE OVER GEOTEXTILE FABRIC) TOE IN FABRIC ON ALL 4 SIDES

OVERFLOW SPILLWAY
(NOT TO SCALE)

NOTES:

- 1. ALL TRENCHES WITHIN 1 ON 1 SLOPE FROM TOP OF CURBS SHALL BE BACKFILLED WITH GRANULAR MATERIAL CLASS II AND COMPACTED TO 95% OF MAXIMUM UNIT WEIGHT.
- ALL END SECTIONS SHALL BE CONSTRUCTED ACCORDING TO THE "END SECTION AND BAR SCREEN DETAIL" ON SHEET ND.

LEGEND

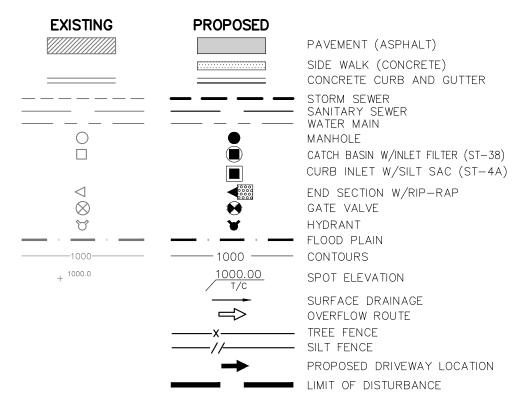

LAKE POINTE

SECTION 36, TOWN 3 NORTH, RANGE 8 EAST WHITE LAKE TWP., OAKLAND COUNTY, MICHIGAN

	REVISION	S	
NO.	ITEM	DATE	UNDE
1.	REVISE PER OWNER	6-3-20	SHOW FROM
2.	REVISE GRADES ON UNITS 2 AND 6	11-9-20	LOCA
3.	REV PER 11-20-20 W.L. TWP LETTER	02-02-21	20071
4.	REVISE PER WHITE LAKE TWP	03-03-21	
			*
6.	REVISED PER TOWNSHIP	04-25-23	
7.	REVISED PER TOWNSHIP	7-27-23	
8.	REVISE PER AGENCIES	02-13-24	
			THE
			FOR
			RELO

UTILITY WARNING

UNDERGROUND UTILITY LOCATIONS AS SHOWN ON THE PLAN, WERE OBTAINED FROM UTILITY OWNER AND NOT FIELD LOCATED.

Know what's below.

Call before you dig.

THE CONTRACTOR SHALL BE RESPONSIBLE FOR THE PROTECTION OF AND/OR RELOCATION OF ALL UTILITIES THAT MAY INTERFERE WITH CONSTRUCTION.

DATE: 04-08-2020 DESIGNED BY: A.A. JOB NUMBER: 19-039
CHECKED BY: J.E. DRAWING FILE:19039DB

DETENTION BASIN PLAN,


CALCULATIONS AND PROFILE



15

Section Sect						ke Poir					05.55	D KEAST	T 0 4000	O INIO								
Mail Mail Ma											SEIBE											
Mill Mill Mi																						
Second S		10.00	year desig	jn - =	175	/T+25	n = 0	0.013		C =	0.53											
	МН-МН		С			T min	l in/hr															T/Pipe - RIM
9.25 0.68	28-22	0.14	0.53	0.07	0.07	15.00	4.38	0.32	12	0.01	2.68	44			972.65			0.35	3.20	4.00	3.00	4.05
19-25 19-26 19-25 19-26 19-2																						
Transfer																			1			3.08
18-25	29-25	0.69	0.53	0.36	0.55	15.16	4.36	2.38	12	0.45	5.27	116			9/3.3/			1.35	3.28	4.08	3.08	3.03
28-24 Q.26	27-26	0.40	0.53	0.21	0.21	15.00	4.38	0.92	12	0.07	2.57	48	0.31	975.21	975.06	979.70	976.01	0.32	3.69	4.49	3.49	5.04
+6w 28	26-25	0.00	0.53	0.00	0.21											981.10		_	-	-	_	3.11
2423 0.20 0.50 0.50 0.10 1.00 16.27 4.24 4.29 15 0.43 3.44 1.14 0.70 971.88 971.40 97240 97240 0.42 4.76 4.30 3.05 5. 24221 0.00 0.50 0.00 1.13 1.1607 4.17 4.70 15 0.53 9.89 174 0.76 971.98 971.40 97240 97240 4.27 4.27 3.05 9.5 9.22 1.22 1.00 0.00 0.50 0.00 1.13 1.0		0.26	0.53			15 78	4 29	3 83	12	1 15	4 87	144	0.49	973 19	972 18	977 40	975 12	0.70	2 28	4 21	3 21	3.12
18-12 18-1		0.20	0.53																			2.9
+6wz88						16.97	4.17	4.70	15	0.53	3.83	174	0.76	971.30	970.89	975.60	972.84	0.24	2.76	4.30	3.05	5.56
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19-18													0.47	971.87		977.05	974.44					4.18 6.36
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+flow 20						15.75	4.29	1.71	12	0.23	2.57	111	0.72	975.34	974.99	979.40	976.14	0.32	3.26	4.06	3.06	3.01
15-4		1.00	0.53			16.47	4.22	4.53	12	1.62	5.77	98	0.28	971.54	971.22	979.00	974.42	0.32	4.58	7.46	6.46	5.13
11-7		0.78	0.53										0.08	971.02		977.35	972.84					5.25
14-13	32-11	0.39	0.53	0.20	0.20	15.00	4.38	0.89	12	0.06	2.57	162			978.28			0.32	3.20	4.00	3.00	3.02
13-12	31-7	0.48	0.53	0.25	0.25	15.00	4.38	1.11	12	0.10	3.80	113			972.41			0.70	2.78	4.00	3.00	3.09
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Downstream Data - 967.80 969.40		0.94 0.00	0.53 0.53										0.04 0.06	967.88 967.85		976.52 975.00	969.92 969.70		_	_		4.61 5.15 (2.00
		ORM SE	<u>WER</u>																			
UNION LAKE STORM SEWER	MH-MH							Q cfs	Dia in	Hyd.Gr. %	Vel. ft/sec	Length ft	Tr Time min	Inv. upst.	Inv. dnst.	Grnd. upst.	HGL upst.	Pipe slope-%	RIM - HGL	Rim - inv	T/Pipe - RIM	T/Pipe - RIM
MH-MH Q Dia Hyd.Gr. Vel. Length Tr Time Inv. Inv. Grnd. HGL Pipe RIM Rim T/Pipe T/Pip								2.26	12	0.40	3.57	33	0.15	967.80	967.60	970.50	971.89	0.62			1.70	4.70
MH-MH Q Dia Hyd.Gr. Vel. Length Tr Time Inv. Inv. Grnd. HGL Pipe RIM Rim T/Pipe T/Pip cfs in % ft/sec ft min upst. dnst. upst. upst. upst. slope-% -HGL -inv -RIM -RIM SP-OMH (Q actual from Detention Basin Calculations) 2.26 12 0.40 3.57 33 0.15 967.80 967.60 970.50 971.89 0.62 (1.39) 2.70 1.70 4.7	OMH- 34D 34D-34C 34C-STUB	Q exp fro	m Detentio	n Basin C	alculations)		11.50 11.50 11.50	15 21 21	3.17 0.53 0.53	9.37 4.78 4.78	94 250 169	0.17 0.87 0.59	967.60 966.25 965.30	966.65 965.30 964.65	973.30 970.00 976.50	971.76 968.78 967.46	1.01 0.38 0.38	1.54 1.22 9.04	5.70 3.75 11.20	4.45 2.00 9.45	9.45



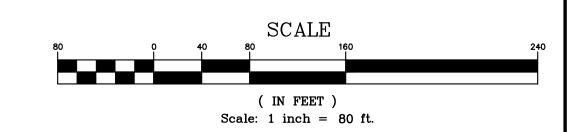

LAKE POINTE

SECTION 36, TOWN 3 NORTH, RANGE 8 EAST WHITE LAKE TWP., OAKLAND COUNTY, MICHIGAN

3. REV PER 11-20-20 W.L. TWP LETTER 4. 02-02-2 4. REVISE PER WHITE LAKE TWP 03-03-21 6. REVISED PER TOWNSHIP 04-25-23 7. REVISED PER TOWNSHIP 7-27-23			
1. REVISE PER OWNER 6-3-20 2. REVISE GRADES ON UNITS 2 AND 6 11-9-20 3. REV PER 11-20-20 W.L. TWP LETTER 02-02-2 4. REVISE PER WHITE LAKE TWP 03-03-21 6. REVISED PER TOWNSHIP 04-25-23 7. REVISED PER TOWNSHIP 7-27-23		REVISION	S
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3. REV PER 11-20-20 W.L. TWP LETTER 02-02-2 4. REVISE PER WHITE LAKE TWP 03-03-21 6. REVISED PER TOWNSHIP 04-25-23 7. REVISED PER TOWNSHIP 7-27-23	1.	REVISE PER OWNER	6-3-20
 4. REVISE PER WHITE LAKE TWP 03-03-21 6. REVISED PER TOWNSHIP 04-25-23 7. REVISED PER TOWNSHIP 7-27-23 	2.	REVISE GRADES ON UNITS 2 AND 6	11-9-20
6. REVISED PER TOWNSHIP 04-25-23 7. REVISED PER TOWNSHIP 7-27-23	3.	REV PER 11-20-20 W.L. TWP LETTER	02-02-21
7. REVISED PER TOWNSHIP 7-27-23	4.	REVISE PER WHITE LAKE TWP	03-03-21
	6.	REVISED PER TOWNSHIP	04-25-23
8. REVISE PER AGENCIES 02-13-2	7.	REVISED PER TOWNSHIP	7-27-23
	8.	REVISE PER AGENCIES	02-13-24
			i

UTILITY WARNING UNDERGROUND UTILITY LOCATIONS AS SHOWN ON THE PLAN, WERE OBTAINED FROM UTILITY OWNER AND NOT FIELD LOCATED. Know what's below.
Call before you dig.

THE CONTRACTOR SHALL BE RESPONSIBLE FOR THE PROTECTION OF AND/OR RELOCATION OF ALL UTILITIES THAT MAY INTERFERE WITH CONSTRUCTION.


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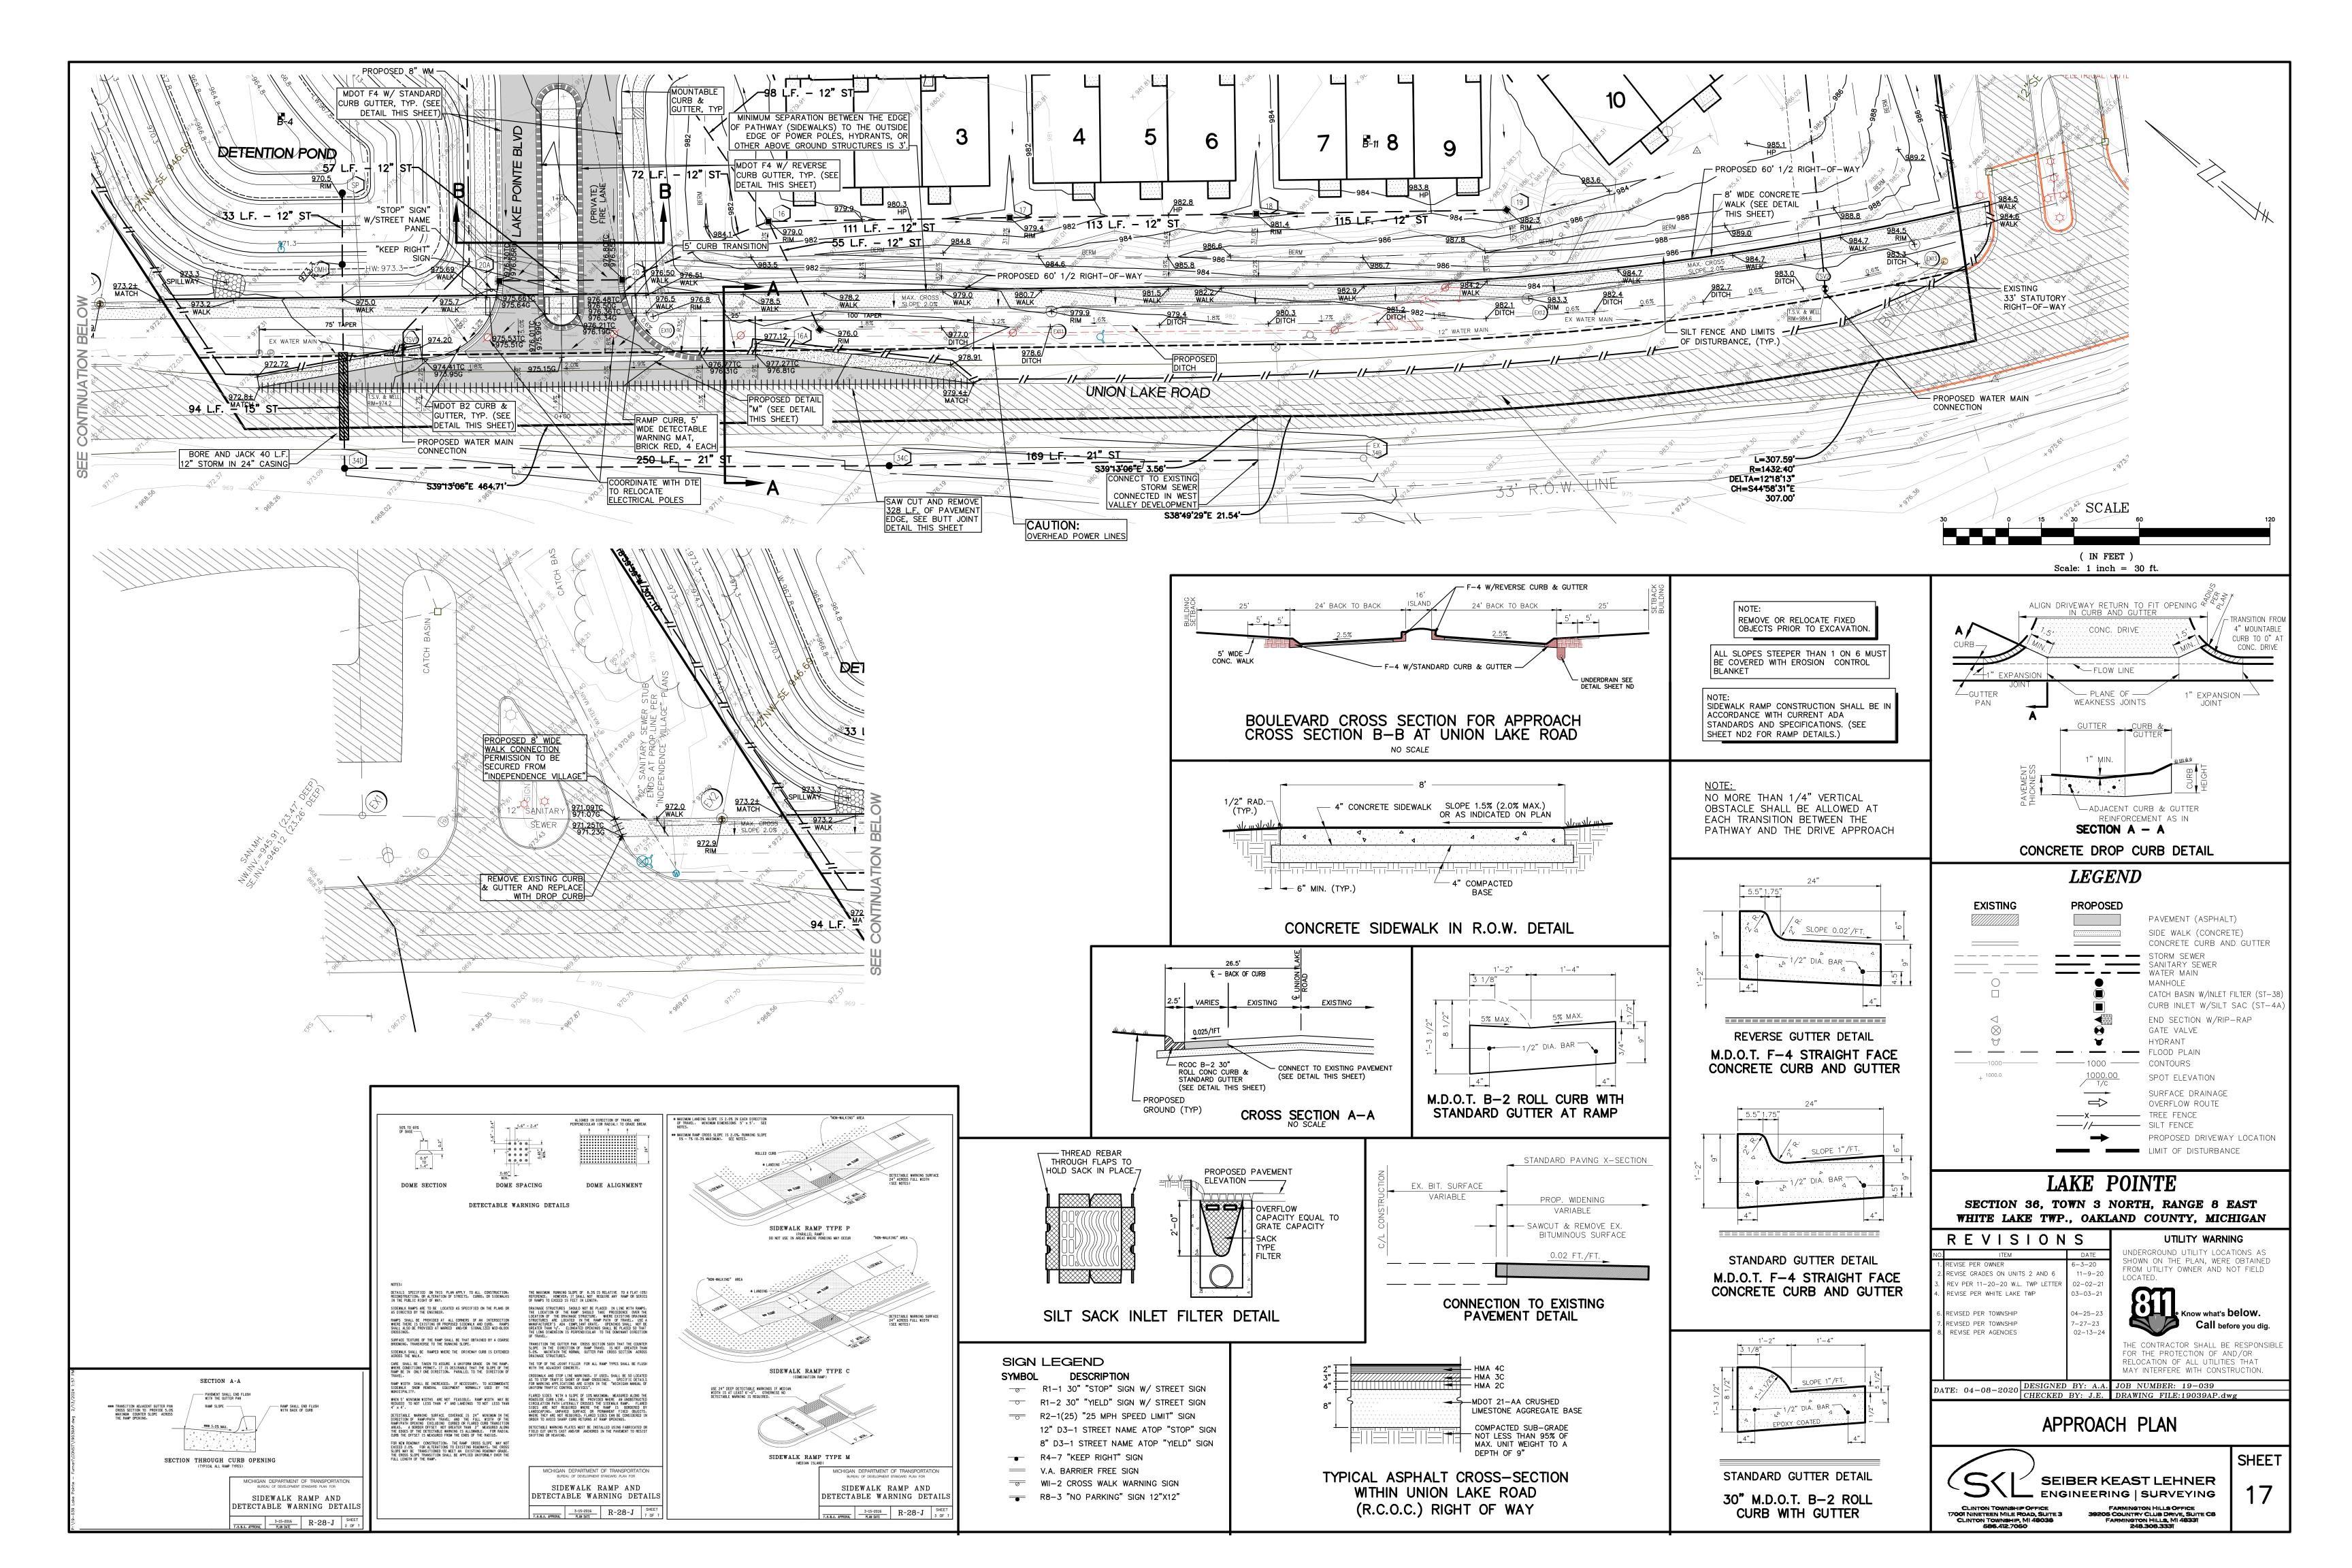
DATE: 04-08-2020 DESIGNED BY: A.A. JOB NUMBER: 19-039 CHECKED BY: J.E. DRAWING FILE:19039DD.dwg

DRAINAGE DISTRIBUTION PLAN & STORM SEWER CALCULATIONS



SEIBER KEAST LEHNER ENGINEERING | SURVEYING FARMINGTON HILLS OFFICE 39205 COUNTRY CLUB DRIVE, SUITE C8 FARMINGTON HILLS, MI 48331 248.308.3331



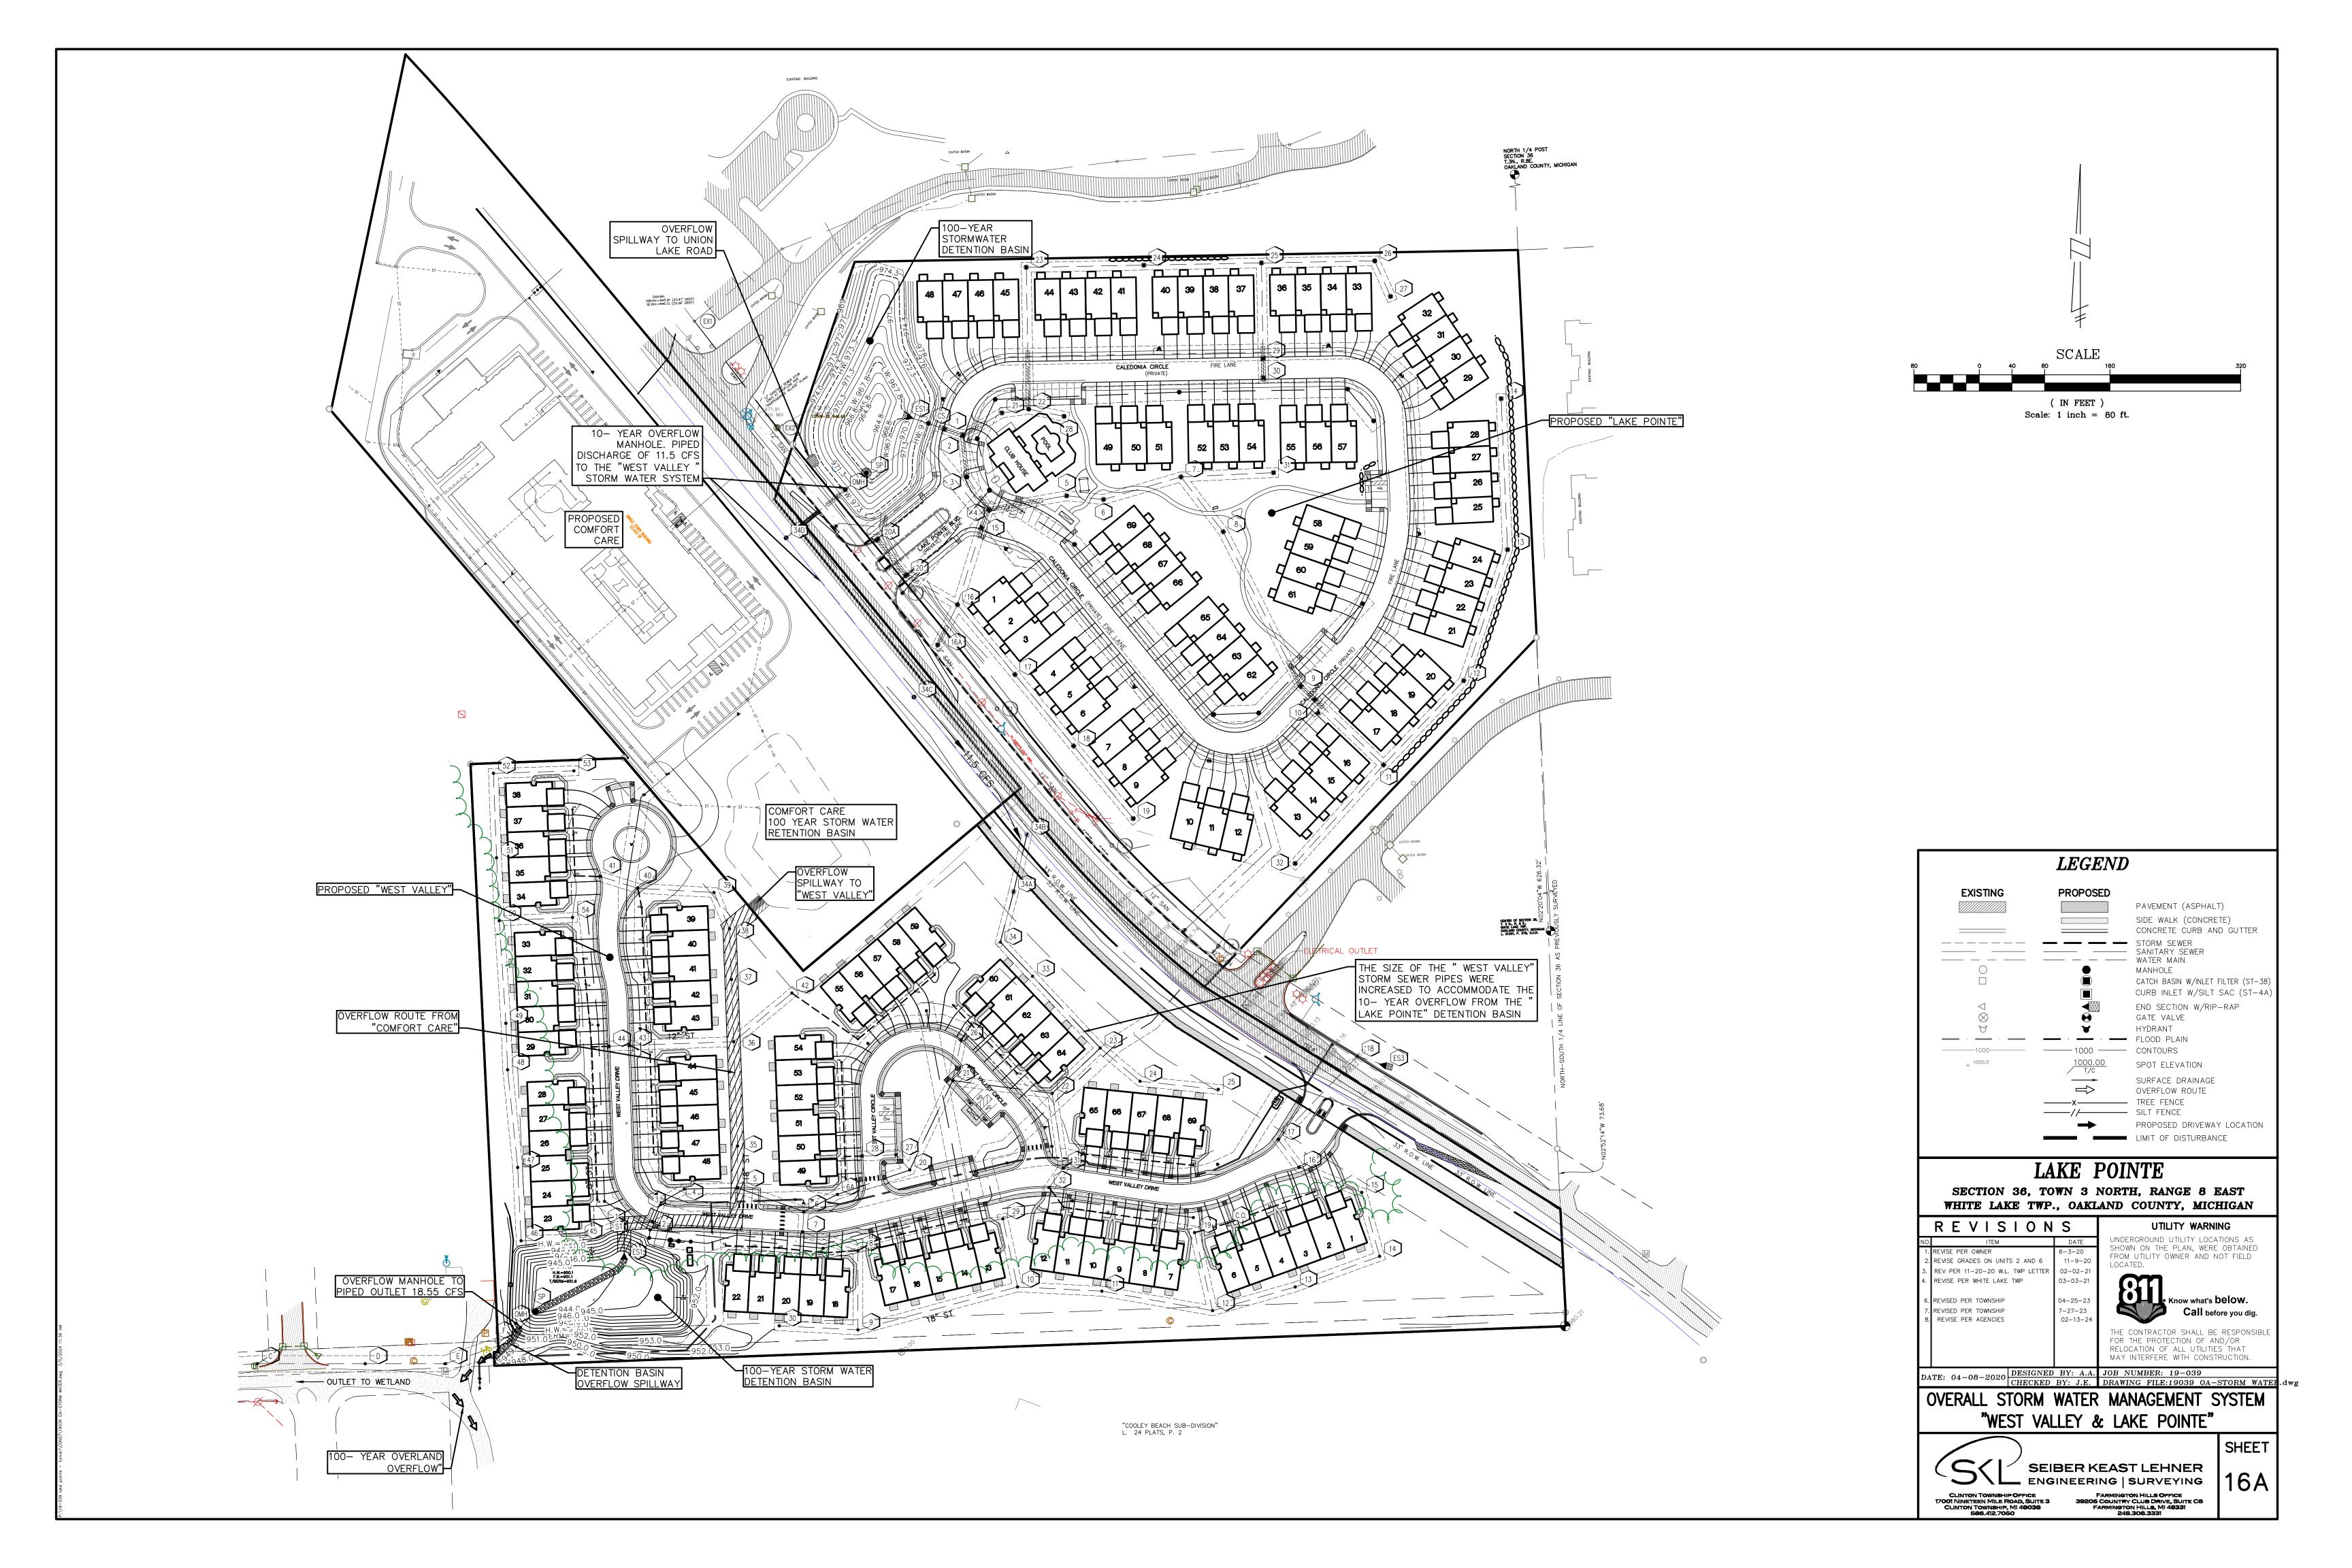

SOIL EROSION CONTROL NOTES

SACK TYPE FILTERS SHALL BE INSTALLED ON ALL CATCH BASINS AND INLETS.

- DEWATERING OF ANY KIND MUST BE FILTERED THROUGH VEGETATION, STONE OR "FILTER BAG".
- 3. IT IS THE DEVELOPER'S RESPONSIBILITY TO INSURE THE PROJECT STREETS AND ADJACENT ROADS ARE CLEAN & SWEPT THROUGHOUT THE ENTIRE CONSTRUCTION PERIOD.
- 4. IT IS THE DEVELOPER'S RESPONSIBILITY TO GRADE AND STABILIZE DISTURBANCES DUE TO INSTALLATION OF PUBLIC UTILITIES (I.E. PHONE, GAS, ELECTRIC, CABLE, ETC.)
- THE DEVELOPER IS RESPONSIBLE FOR DUST CONTROL THROUGHOUT ALL PERIODS OF CONSTRUCTION. WATERING TANKS WILL BE AVAILABLE AT ALL TIMES TO BE USED ON ANY AREA WHERE DUST BECOMES A PROBLEM.
- PARKING OF VEHICLES, EQUIPMENT, OR STOCKPILING OF MATERIALS IS STRICTLY PROHIBITED ALONG OR WITHIN THE UNION LAKE ROAD RIGHT OF WAY AREA.
- ALL CULVERT END SECTIONS MUST CONTAIN GROUTED RIP-RAP IN ACCORDANCE WITH ORDINANCE
- 8. THE SOIL EROSION CONTROLS WILL BE MAINTAINED WEEKLY AND AFTER EVERY STORM EVENT BY

S.E.S.C. SEQUENCE OF CONSTRUCTION

- . INSTALL ALL SOIL EROSION AND TREE PROTECTION FENCING AS PER APPROVED PLANS. CLEAR ONLY WHAT IS NECESSARY TO INSTALL FENCING.
- 2. STRIP AND STOCKPILE TOPSOIL IN A LOCATION APPROVED BY THE OWNER/ENGINEER. PLACEMENT OF ADDITIONAL CONTROL MEASURES MUST BE INSTALLED ON AND AROUND THE STOCKPILE.
- 3. CONSTRUCT DETENTION BASIN ALONG WITH APPLICABLE STORM SEWER (END-SECTIONS, SHORT STORM SEWER LENGTHS, STANDPIPE OUTLET FILTER). GRADE TO FINAL ELEVATIONS, DISTRIBUTE TOPSOIL, SEED AND STAKE STRAW MULCH BLANKETS ON THE SLOPES OF THE BASIN.
- 4. INSTALL UTILITIES (WATER MAIN, STORM SEWER, SANITARY SEWER) COMPLETE.
- 5. INSTALL, AS PER APPROVED PLANS, THE CATCH BASIN INLET FILTERS. INSPECT AND MAINTAIN FILTERS AS DIRECTED TO PREVENT CLOGGING AND UNNECESSARY FLOODING.
- 6. GRADE ROADWAY LIMITS AND INSTALL PAVEMENT COMPLETE.
- 7. BEGIN BUILDING CONSTRUCTION
- 8. INSTALL ALL PUBLIC UTILITIES (GAS, ELECTRIC, TELEPHONE, CABLE) COMPLETE.
- 9. STABILIZE TEMPORARILY OR PERMANENTLY ALL DISTURBED AREAS WITHIN FIVE (5) DAYS OF FINAL
- 10. INSPECT AND MAINTAIN ALL SOIL EROSION AND SEDIMENTATION CONTROL MEASURES WEEKLY AND AFTER EVERY STORM EVENT THROUGHOUT THE CONSTRUCTION OF THE PROJECT. REMOVAL OF CONTROL MEASURES MAY ONLY TAKE PLACE ONCE THE ENTIRE SITE IS FULLY STABILIZED. UPON FULL STABILIZATION IS COMPLETE, REMOVE THE STAND PIPE AND GRAVEL FILTER. THE DEVELOPER IS RESPONSIBLE FOR ALL SOIL EROSION CONTROL MEASURES.
- VEGETATION MUST BE ACCEPTABLY ESTABLISHED PRIOR TO FINAL RELEASE OF THE CONSTRUCTION DEPOSIT BY THE ROAD COMMISSION FOR UNION LAKE ROAD.

SOIL EROSION CONTROL VIOLATIONS/CITATIONS

- ROUTINE INSPECTIONS WILL BE PERFORMED BY THE OAKLAND COUNTY WATER RESOURCE COMMISSION (O.C.W.R.C.) OR ITS AGENT ONCE A WEEK.
- UPON COMPLETION OF INSPECTION, IF THE SITE IS FOUND NOT TO BE IN COMPLIANCE WITH O.C.W.R.C.'S SOIL EROSION AND SEDIMENTATION CONTROL ORDINANCE, THEN THE PERMIT HOLDER/SIGNER WILL BE ISSUED, BY HAND, MAIL OR EMAIL. A "NOTICE OF EROSION CONTROL DEFICIENCY" LETTER, THAT WILL INCLUDE ALL CURRENT AND PERTINENT NON-COMPLIANCE ITEMS. THE SITE AND/OR DEVELOPMENT WILL HAVE A PRE-DETERMINED AMOUNT OF TIME, FROM THE DATE OF THE "NOTICE" TO RECTIFY THESE ITEMS.
- 3. IF ALL OF THE ITEMS HAVE NOT BEEN ADDRESSED AFTER THE ELAPSED TIME SPECIFIED, THE PERMIT HOLDER/SIGNER WILL RECEIVE A "NON—COMPLIANCE" LETTER, WHICH WILL INCLUDE A "NOTICE TO SHOW CAUSE".
- UPON RECEIPT OF THE "NON-COMPLIANCE" LETTER AND THE "NOTICE TO SHOW CAUSE", THE PERMIT HOLDER/SIGNER WILL ATTEND A SHOW CAUSE HEARING AS WELL AS PAY A RE-INSPECTION FEE IN THE AMOUNT OF \$250.00 TO THE O.C.W.R.C. FOR ADDITIONAL INSPECTIONS, HEARINGS AND REPORT FOLLOW UP. THE BEFORE MENTIONED ACTIVITIES MUST TAKE PLACE WITHIN 24 HOURS UPON RECEIPT OF THE LETTER. AFTER THE HEARING, THE PROJECT, DEVELOPMENT MAY BE ISSUED A "STOP WORK" ORDER.
- IF A CITATION IS ISSUED TO THE PERMIT HOLDER/SIGNER AFTER THE SHOW CAUSE HEARING, AN ADDITIONAL \$400.00 WILL BE PAID TO THEN O.C.W.R.C., FOR FOLLOW-UP INSPECTIONS. MEETINGS AND OTHER EXPENSES INCURRED.

DETENTION BASIN MAINTENANCE SCHEDULE:

THE PROPERTY OWNER IS RESPONSIBLE FOR THE MAINTENANCE OF THE SEDIMENT STRUCTURES. MAINTENANCE SHOULD BE PERFORMED FOLLOWING ANY STORM AND SHOULD INCLUDE:

- CHECKING THE DEPTH OF SEDIMENT DEPOSIT TO ENSURE THE CAPACITY OF THE SEDIMENT STRUCTURES IS ADEQUATE FOR STORM WATER AND SEDIMENT DEPOSITION, AND FOR THE REMOVING OF SEDIMENT.
- 2. CHECKING THE BASIN FOR PIPING, SEEPAGE, OR OTHER MECHANICAL DAMAGE.
- 3. CHECKING FOR THE PRESENCE OF ANY SOIL CAKING, WHICH WOULD PREVENT PROPER DRAINAGE FROM THE BASIN.
- ANY PROBLEM DISCOVERED DURING THE MAINTENANCE CHECKS SHOULD BE ADDRESSED
- SEDIMENT REMOVED DURING CLEANING SHOULD BE PLACED AT AN UPLAND AREA AND STABILIZED SO THAT IT DOES NOT RE-ENTER THE DRAINAGE COURSE.

GROUND WATER NOTES

- IF THE STATIC GROUNDWATER LEVEL IS HIGHER THAN THE ELEVATION AT WHICH PROPOSED CONSTRUCTION WORK WILL TAKE PLACE, WHETHER DETERMINED BY INITIAL SOIL BORINGS OR DURING CONSTRUCTION, SO THAT IT WILL BE NECESSARY TO DEWATER AN AREA TO CONTINUE CONSTRUCTION, THEN THE WHITE LAKE TOWNSHIP WILL REQUIRE A WRITTEN DEWATERING PROCEDURE PROVIDED BY THE APPLICANT'S ENGINEER, PRIOR TO COMMENCEMENT OF THE DEWATERING OPERATION.
- IF GROUNDWATER IS ENCOUNTERED DURING CONSTRUCTION, THE CONTRACTOR MUST CONTACT WHITE LAKE DPS IN WRITING SHOWING NEED TO DEWATER PRIOR TO ANY FURTHER CONSTRUCTION.
- IF PROCEDURES ARE NOT SUBMITTED OR, ONCE APPROVED, ARE NOT ADHERED TO, THEN WHITE LAKE TOWNSHIP MAY TAKE ACTION TO SUSPEND DEWATERING ACTIVITIES AT THE PROJECT TO REQUIRE THE ADHERENCE TO PROCEDURES.

INSPECTION & MAINTENANCE SCHEDULE FOR SOIL EROSION CONTROL

GRADE STABILIZATION STRUCTURES SUCH AS: DROP CONTROL STRUCTURES; SIDE DRAINS (ENCLOSED); DROP INLET SPILLWAYS; DROP PIPES; STRAIGHT PIPES; TOEWALLS; DROP BOXES; CHUTES OR FLUMES (SOD, ROCK CONCRETE); EARTH EMBANKMENT STRUCTURES; DOWNDRAINS; SPILLWAYS SHALL BE MAINTAINED AS FOLLOWS:

BECAUSE GRADE STABILIZATION STRUCTURES ARE SUBJECT TO HIGH FLOW CONDITIONS, PERIODIC INSPECTIONS SHOULD BE PERFORMED TO ENSURE THAT EROSION IN NOT OCCURRING, AND THAT VEGETATION IS ADEQUATELY ESTABLISHED. THESE STRUCTURES SHOULD ALSO BE INSPECTED AFTER STORM EVENTS WHICH EXCEED THE DESIGN STORM.

THE DETENTION BASIN SHOULD BE INVESTIGATED TO ENSURE THAT THE CONCENTRATED FLOWS ARE NOT CAUSING EROSION INTO THE BOTTOM OF THE BASIN AND BLOCKING INFILTRATION. CHECK THE EMERGENCY BYPASS/OVERFLOW FOR EROSION. CHECK THE STRUCTURES ITSELF FOR CRACKED CONCRETE, UNEVEN OR EXCESSIVE SETTLING PIPING AND PROPER DRAIN FUNCTIONING REPAIR OR REPLACE FAILING STRUCTURES IMMEDIATELY. ADDRESS VEGETATION AND EROSION PROBLEMS AS SOON AS WEATHER PERMITS. OPEN STRUCTURES SHOULD BE SIGNED OR MARKED TO ALERT PEOPLE IN THE VICINITY ABOUT POTENTIAL DANGERS.

RIP-RAP

INSPECTIONS SHOULD BE MADE OF ALL RIP-RAPPED SITES IMMEDIATELY AFTER THE FIRST RAINFALL FOLLOWING INSTALLATION. THIS IS PARTICULARLY IMPORTANT IN AREAS WHERE RIP-RAP THAT IS DISPLACED DURING THE STORM WOULD IMPACT CULVERTS. THEREFORE, RIP-RAP SITES SHOULD BE CHECKED FOLLOWING STORMS. FSPFCIALLY THOSE WHICH ARE NEAR OR EXCEED STORM FREQUENCY USED IN THE DESIGN. DISPLACED RIP-RAP SHOULD BE REMOVED FROM ITS DOWNSTREAM LOCATION AND NEW RIP-RAP PLACE ACCORDING TO THE ENGINEERED

STORMWATER CONVEYANCE CHANNEL

AT MINIMUM, CHECK ALL CONSTRUCTED CHANNELS AFTER EACH STORM WHICH MEETS OR EXCEEDS THE DESIGN STORM, ON RIP-RAP LINED WATERWAYS, CHECK FOR SCOURING BELOW THE RIP-RAP LAYER. AND BE SURE THE STONES HAVE NOT BEEN DISPLACED BY THE FLOW. PARTICULAR ATTENTION SHOULD BE PAID TO THE OUTLET OF THE CHANNEL. IF EROSION IS OCCURRING, APPROPRIATE ENERGY DISSIPATION MEASURES SHOULD BE TAKEN. SEDIMENT SHOULD BE REMOVED FROM RIP-RAP LINED CHANNELS IF IT REDUCES THE CAPACITY OF THE CHANNEL.

SPOIL PILES

WHEN VEGETATION STABILIZATION IS PROMPTLY AND EFFECTIVELY APPLIED, VERY LITTLE MAINTENANCE IS REQUIRED. THE GUIDELINES BELOW SHOULD BE FOLLOWED ON ALL SITES: (1) PERIODIC INSPECTIONS SHOULD BE DONE TO ENSURE EXCESSIVE EROSION HASN'T OCCURRED. IF RUN OFF OR WIND EROSION HAS OCCURRED, REDUCE THE SIDE OF SLOPES OF THE SPOIL PILE, OR STABILIZE THE SPOIL PILE WITH PIECES OF SOD LAID PERPENDICULAR TO THE SLOPE, AND STAKED. (2) WHEN FILTER FENCING IS USED AROUND A SPOIL PILE, PERIODIC CHECKS SHOULD BE MADE TO ENSURE THAT PIPING HAS NOT OCCURRED UNDER FENCING, AND TO ENSURE THE FENCE HAS NOT COLLAPSED DUE TO SOIL SLIPPING OR ACCESS BY CONSTRUCTION EQUIPMENT. REPAIR ANY DAMAGED FENCING IMMEDIATELY. (3) BERMS AT THE BASE OF THE SPOIL PILE WHICH BECOME DAMAGED SHOULD BE REPLACED.

CATCH BASIN FILTERS

EFFECTIVE FILTERS WILL COLLECT SEDIMENT, PARTICULARLY WHEN THE SOIL IS SANDY. THESE FILTERS MUST BE CLEANED PERIODICALLY, SO THEY DON'T BECOME CLOGGED AND CAUSE FLOODING CONDITIONS, PIPING, OR OVERTOPPING OF THE CONTROL STRUCTURES. MAINTENANCE OF THESE ITEMS REQUIRES INSPECTION WEEKLY OR AFTER EACH RAIN EVENT. ALSO, THESE ITEMS ARE REUSABLE IF MAINTAINED CORRECTLY, THEY CAN BE REMOVED, EMPTIED, CLEANED AND REPLACED WITHOUT PURCHASING NEW ONES.

BUFFER/FILTER STRIPS (25' ENVIRONMENTAL SETBACKS)

PERIODIC INSPECTIONS SHOULD BE DONE TO ENSURE THAT CONCENTRATED FLOWS HAVE NOT DEVELOPED, AND TO MAKE SURE THE VEGETATIVE COVER IS MAINTAINING ITS EFFECTIVENESS. IF THE INTEGRITY OF THE BUFFER/FILTER STRIP IS JEOPARDIZED BY UPLAND EROSION, OR IF CONCENTRATED FLOWS ARE CREATING RILLS OR GULLIES UP-SLOPE OF THE STRIP, ADDITIONAL BMP'S MAY NEED TO BE INSTALLED. IF THE BUFFER STRIP IS BEING JEOPARDIZED BY STREAM BANK EROSION, THEN THE CAUSE OF THE BANK EROSION NEEDS TO BE INVESTIGATED AND ACTIONS TAKEN TO ADDRESS THE CAUSES. DAMAGED STRIPS SHOULD BE REPAIRED AS SOON AS POSSIBLE. STRIPS DAMAGED DUE TO CONSTRUCTION UP-SLOPE OF THE BUFFER/FILTER SHOULD BE REPLANTED, AS NECESSARY, AFTER THE CAUSE OF THE DAMAGE IS ASSESSED AND ANY OTHER BMP'S ARE NEEDED ARE IMPLEMENTED.

SILT FENCE


SILT FENCES SHOULD BE INSPECTED IMMEDIATELY AFTER EACH RAINFALL AND SEVERAL TIMES DURING PROLONGED RAINFALLS. IF THE FENCE IS SAGGING OR THE SOIL HAS REACHED ONE HALF THE HEIGHT OF THE FABRIC. THE SOIL BEHIND THE FABRIC MUST BE REMOVED AND DISPOSED OF IN A STABLE UPLAND SITE. THE SOIL CAN BE ADDED TO THE SPOIL PILE. IF THE FABRIC IS BEING UNDERCUT (i.e. IF THE WATER IS SEEPING UNDER THE FENCE), THE FENCE SHOULD BE REMOVED AND REINSTALLED FOLLOWING THE GIVEN PROCEDURES. FABRIC WHICH DECOMPOSES OR OTHERWISE BECOMES INEFFECTIVE SHOULD BE REMOVED AND REPLACED WITH NEW FILTER FABRIC IMMEDIATELY. FILTER FENCES SHOULD BE REMOVED ONCE VEGETATION WELL ESTABLISHED AND THE UP-SLOPE AREA IS FULLY STABILIZED OR UNLESS OTHERWISE DIRECTED BY THE ENGINEER.

SEEDING, SODDING & MULCHING

SEEDED, SODDED OR MULCHED AREAS SHOULD BE CHECKED FOLLOWING EACH RAIN TO ENSURE THE MATERIAL IS STAYING IN PLACE. ADDITIONAL TACKING MATERIALS OR NETTING MAY BE NEEDED TO BE APPLIED TO HOLD THE AFOREMENTIONED MATERIALS IN PLACE. MAINTENANCE PROCEDURES SHOULD ALSO BE FOLLOWED FOR THE BMP'S WHICH WERE IMPLEMENTED TO KEEP ERODED SOIL OR CONCENTRATED RUNOFF AWAY FROM THESE TARGET AREAS.

ACCESS ROAD (UNION LAKE ROAD)

PROPER MAINTENANCE INCLUDE ADDING ADDITIONAL LAYERS OF STONE WHEN THE ORIGINAL STONE BECOMES COVERED WITH MUD. AFTER EACH STORM EVENT, INSPECT THE ROAD FOR EROSION AND MAKE ANY NECESSARY REPAIRS. IT IS ALSO IMPORTANT TO CHECK AND MAINTAIN ANY BMP'S WHICH ARE USED IN CONJUNCTION WITH THIS BMP, ESPECIALLY THOSE FOR DRAINAGE. ALL SEDIMENT DROPPED OR ERODED ONTO PUBLIC RIGHT-OF-WAY SHOULD BE REMOVED IMMEDIATELY BY

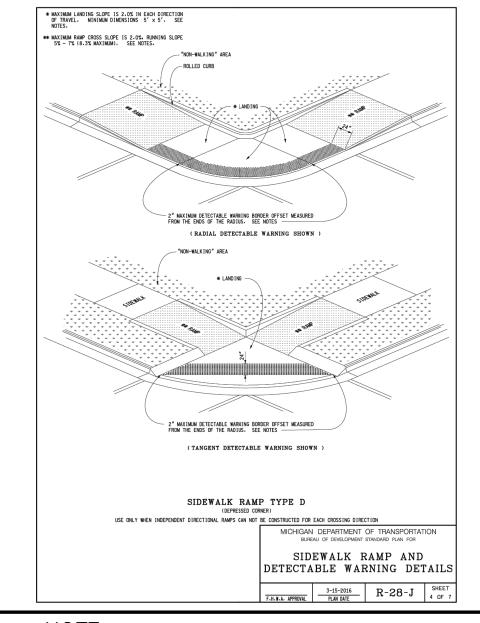

SLOPED SURFACE

DETECTABLE WARNIN

"NON-WALKING" ARE

CROSSWALK MARKING

PREFERRED LOCATION
 OF DRAINAGE INLET

ALTERNATE LOCATION
OF DRAINAGE INLET

2% (5.0% MAX.) SLOPE BEYO BOTTOM GRADE BREAK

SIDEWALK RAMP LOCATED IN RADIUS (TYPE R SHOWN)
(GRADE BREAK LESS THAN 5')

* GRADE BREAK RAMP SLOPE 5% - 7%
(8.3% MAXIMUM) SEE NOTES

APPROACH AREA SHALL END FLUSH WITH BACK

SIDEWALK RAMP ORIENTATION

0.65"

DOME SPACING

DETECTABLE WARNING DETAILS

DETAILS SPECIFIED ON THIS PLAN APPLY TO ALL CONSTRUCTION,
RECONSTRUCTION, OR ALTERATION OF STREETS, CURBS, OR SIDEWALKS
IN THE PUBLIC RIGHT OF WAY.

THE MAXIMUM RUNNING SLOPE OF 8.3% IS RELATIVE TO A FLAT (0%)
REFERENCE. HOWEVER, IT SHALL NOT RECOURS ANY RAMP OR SERIES
OF RAMPS TO EXCEPT 15 FEET IN LENGTH.

SIDEWALK RAMP TYPE P

(PARALLEL RAMP)
DO NOT USE IN AREAS WHERE PONDING MAY OCCUR

SIDEWALK RAMP TYPE C

SIDEWALK RAMP TYPE M

" EXPANSION JOINT RAMP AND LANDING SLAB THICKNESSES SHALL BE AS CALLED FOR ON THE PLANS

MICHIGAN DEPARTMENT OF TRANSPORTATION BUREAU OF DEVELOPMENT STANDARD TO THE ST

SIDEWALK RAMP AND

DETECTABLE WARNING DETAIL

ALIGNED IN DIRECTION OF TRAVEL AND PERPENDICULAR (OR RADIAL) TO GRADE BREAK

F.H.W.A. APPROVAL 3-15-2016 R-28-J S

TRANSITION THE GUTTER PAN CROSS SECTION SUCH THAT THE COUNTER SLOPE IN THE DIRECTION OF RAMP TRAVEL IS NOT GREATER THAN 5.0%. MAINTAIN THE NORMAL GUTTER PAN CROSS SECTION ACROSS DELIMINET OF THE PART OF THE PAR

THE TOP OF THE JOINT FILLER FOR ALL RAMP TYPES SHALL BE FLUSH WITH THE ADJACENT CONCRETE.

FLARED SIDES WITH A SLOPE OF 10% MAXIMUM. MEASURED ALONG THE ROMSDIRE CURB LINE. SHALL BE PROVIDED MHERE AN UNDESTRUCTED CIRCULATION PATH LATERALLY ROMSSES THE SIDESAKE RAMP. FLARED SIDES ARE NOT REGULIED MERGE THE RAMP IS BRORERED BY LAMOSCAPIRM. LAMPAUED SURFACE OF PERMANENT FIXED DRAJECTS. WHERE THEY ARE NOT REGULIED. FLARED SIDES CAN BE CONSIDERED IN OTICER TO AVOID SHAMP CURB FEXTURES AT RAMP CHINISS.

DETECTABLE WARNING PLATES MUST BE INSTALLED USING FABRICATED OR FIELD CUT UNITS CAST AND/OR ANCHORED IN THE PAVEMENT TO RESIST SHIFTING OR HEAVING.

SIDEWALK RAMP AND

TECTABLE WARNING DETAILS

DETECTABLE WARNING SURFACE 24" ACROSS FULL WIDTH (SEE NOTES)

MICHIGAN DEPARTMENT OF TRANSPORTA

SIDEWALK RAMP AND

ETECTABLE WARNING DETAILS

24" DEEP DETECTABLE WARNING, EXTENDING THE WIDTH OF THE

SIDEWALK RAMP PERPENDICULAR TO RADIAL CURB (TYPE F SHOWN) (USE WITH RADIAL CURB WHEN THE CROSSWALK AND SIDEWALK)

SIDEWALK RAMP LOCATED IN RADIUS (TYPE R SHOWN)
(GRADE BREAK GREATER THAN 5')

SIDEWALK RAMP PERPENDICULAR TO TANGENT CURB (TYPE F AND TYPE RF SHOWN)

SIDEWALK RAMPS ARE TO BE LOCATED AS SPECIFIED ON THE PLANS OR AS DIRECTED BY THE ENGINEER.

RAMPS SHALL BE PROVIDED AT ALL CORNERS OF AN INTERSECTION WHERE THERE IS EXISTING OR PROPOSED SIDEWALK AND CURB. RAMPS SHALL ALSO BE PROVIDED AT MARKED AND/OR SIGNALIZED MID-BLOCK ROCKETURE.

SURFACE TEXTURE OF THE RAMP SHALL BE THAT OBTAINED BY A COARSE BROOMING, TRANSVERSE TO THE RUNNING SLOPE.

SIDEWALK SHALL BE RAMPED WHERE THE DRIVEWAY CURB IS EXTENDED ACROSS THE WALK.

CARE SHALL BE TAKEN TO ASSURE A UNIFORM GRADE ON THE RAMP, WHERE CONDITIONS PERMIT, IT IS DESIRABLE THAT THE SLOPE OF THE RAMP BE IN ONLY ONE DIRECTION, PARALLEL TO THE DIRECTION OF

RAMP WIDTH SHALL BE INCREASED, IF NECESSARY, TO ACCOMMODATE SIDEWALK SNOW REMOVAL EQUIPMENT NORMALLY USED BY THE

WHEN 5' MINIMUM WIDTHS ARE NOT FEASIBLE, RAMP WIDTH MAY BE REDUCED TO NOT LESS THAN 4' AND LANDINGS TO NOT LESS THAN

FOR NEW ROADWAY CONSTRUCTION. THE RAWP CROSS SLOPE MAY NO EXCEED 2.07. FOR ALTERATIONS TO EXISTING ROADWAYS. THE CROS SLOPE MAY BE TRANSITIONED TO MEET AN EXISTING ROADWAY GRADE THE CROSS SLOPE TRANSITION SHALL BE APPLIED UNIFORMLY OVER TH


* MAXIMUM LANDING SLOPE IS 2.0% IN EACH DIRECTION OF TRAVEL. MINIMUM DIMENSIONS 5' x 5'. SEE

** MAXIMUM RAMP CROSS SLOPE IS 2.0% RUNNING SLOPE 5% - 7% (8.3% MAXIMUM). SEE NOTES.


"NON-WALKING" AREA

* GRADE BREAKS AT THE TOP AND BOTTOM OF CURB RAMPS SHALL BE PERPENDICULAR TO THE DIRECTION OF TRAVEL.

DETECTABLE WARNING PLATES MUST BE CONCRETE-EMBEDDED DETECTABLE WARNING PLATES. STAMPED CONCRETE WILL NOT BE ACCEPTABLE

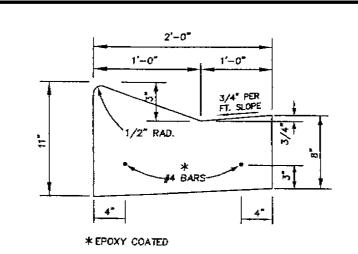


STANDARD GUTTER DETAIL MOUNTABLE CONCRETE CURB

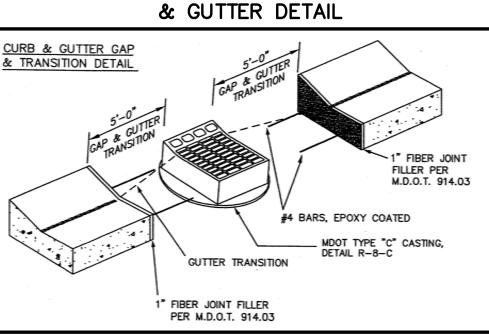


SECTION A-A PAVEMENT SHALL END FLUSH WITH THE GUTTER PAN RAMP SLOPE -RAMP SHALL END FLUSH WITH BACK OF CURB SECTION THROUGH CURB OPENING
(TYPICAL ALL RAMP TYPES) MICHIGAN DEPARTMENT OF TRANSPORTAT SIDEWALK RAMP AND DETECTABLE WARNING DETAILS 4. APPROVAL | 3-15-2016 | R-28-J | 2 RAMP DETAILS


DRAWN: 5-10-06 REVISED: 3-12-07

COMPACTED -SUBGRADE #4 BAR (CONTINUOUS) 1/2" RAD. SLOPE 1.5% (2.0% MAX.) — 4" CONCRETE (TYP.) OR INDICATED ON PLAN SIDEWALK 6" MIN (TYP.) — 4" COMPACTED BASE 21AA CRUSHED

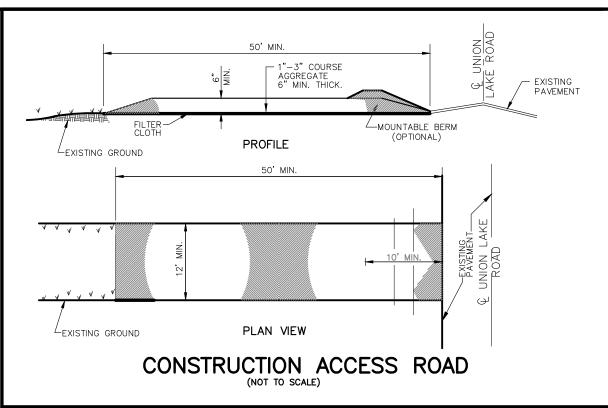


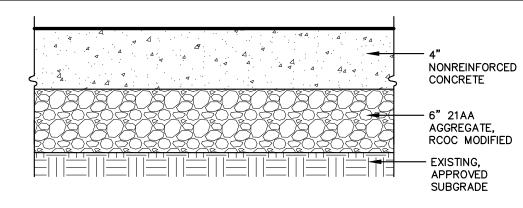

CONCRETE DRIVEWAY PAVEMENT CROSS SECTION

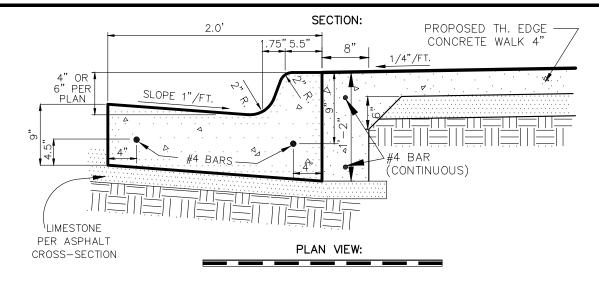


CONCRETE CURB WITH STANDARD GUTTER ABUTTING CONCRETE SIDEWALK DETAIL

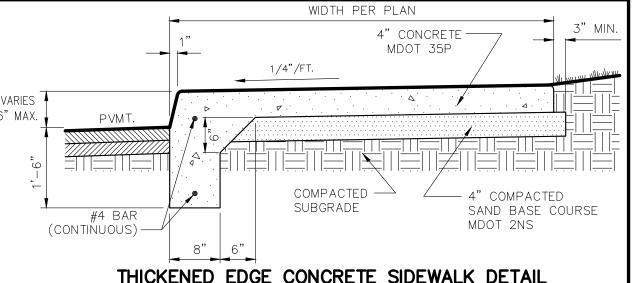


- USE 6" THICK MDOT LIMESTONE BASE COURSE AT DRIVEWAYS

INTERIOR 5' WIDE CONCRETE SIDEWALK DETAIL

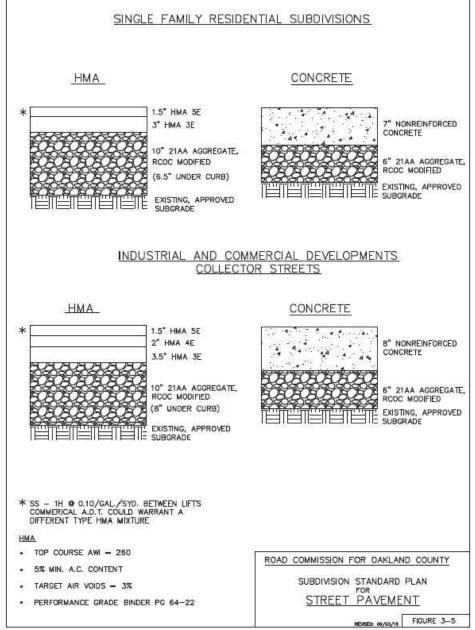

LAKE POINTE

SECTION 36, TOWN 3 NORTH, RANGE 8 EAST WHITE LAKE TWP., OAKLAND COUNTY, MICHIGAN

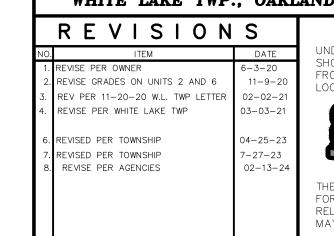

JNDERGROUND UTILITY LOCATIONS AS SHOWN ON THE PLAN, WERE OBTAINED FROM UTILITY OWNER AND NOT FIELD Know what's **below**. Call before you dig. THE CONTRACTOR SHALL BE RESPONSIE FOR THE PROTECTION OF AND/OR

UTILITY WARNING


SHEET

RELOCATION OF ALL UTILITIES THAT MAY INTERFERE WITH CONSTRUCTION DATE: 04-08-2020 DESIGNED BY: A.A. OB NUMBER: 19-039

NOTES AND DETAILS





05 COUNTRY CLUB DRIVE, SUITE C8 FARMINGTON HILLS, MI 48331 248.308.3331

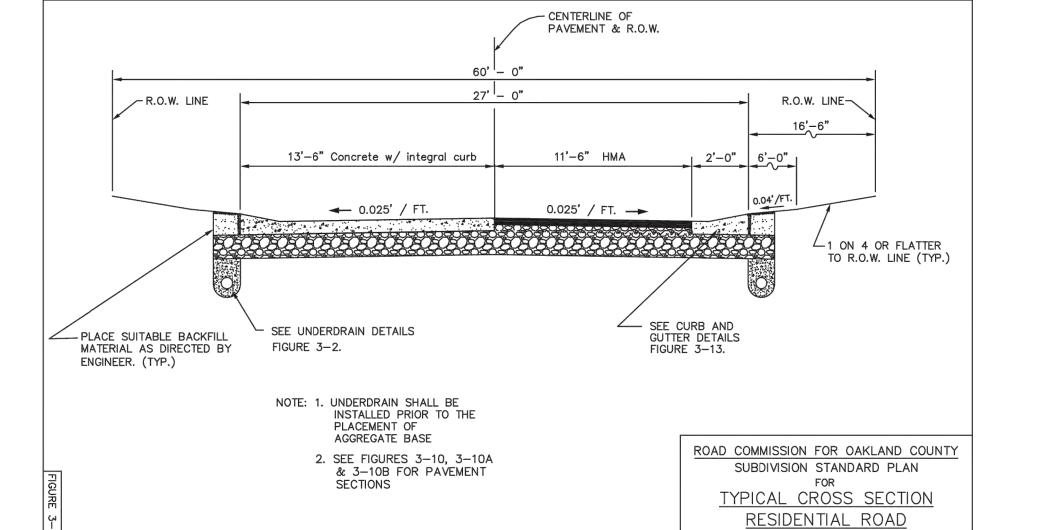

NOTE: 1. UNDERDRAIN MUST BE INSTALLED PRIOR TO CURB & CUTTER 2. SEE FIGURES 3-10, 3-10A & 3-10B FOR PAVEMENT BACK OF CURB-EXTEND AGGREGATE BASE TO THE OUTSIDE EDGE OF THE UNDERDRAIN TRENCH AS SHOWN.

APPROX. THICKNESS OF AGGREGATE BASE BENEATH CURB IS 6" TO 6 RCOC CLASS 1A MODIFIED (PEA UNDERDRAIN TRENCH TO BE WRAPPED 1/2" DEPENDING ON TYPE OF PAVING CROSS SECTION. PEBBLE) OR MIDOT CLASS 34R OPEN GRADED AGGREGATE. WITH NONWOVEN GEOTEXTILE FABRIC CONTINUOUS SUBGRADE UNDERDRAINS SHALL BE PROVIDED IN ALL DEVELOPMENT WHERE A COHESIVE SOILS PAVENENT DESIGN (FIG. 3-10) IS UTILIZED. UNDERDRAINS SHALE BE 6"
DIA CORRUGATED SLOTTED
POLYETHYLENE CONFORMING TO
AASHTO M252. ROAD COMMISSION FOR OAKLAND COUNTY SUBDIVISION STANDARD PLAN UNDERDRAIN

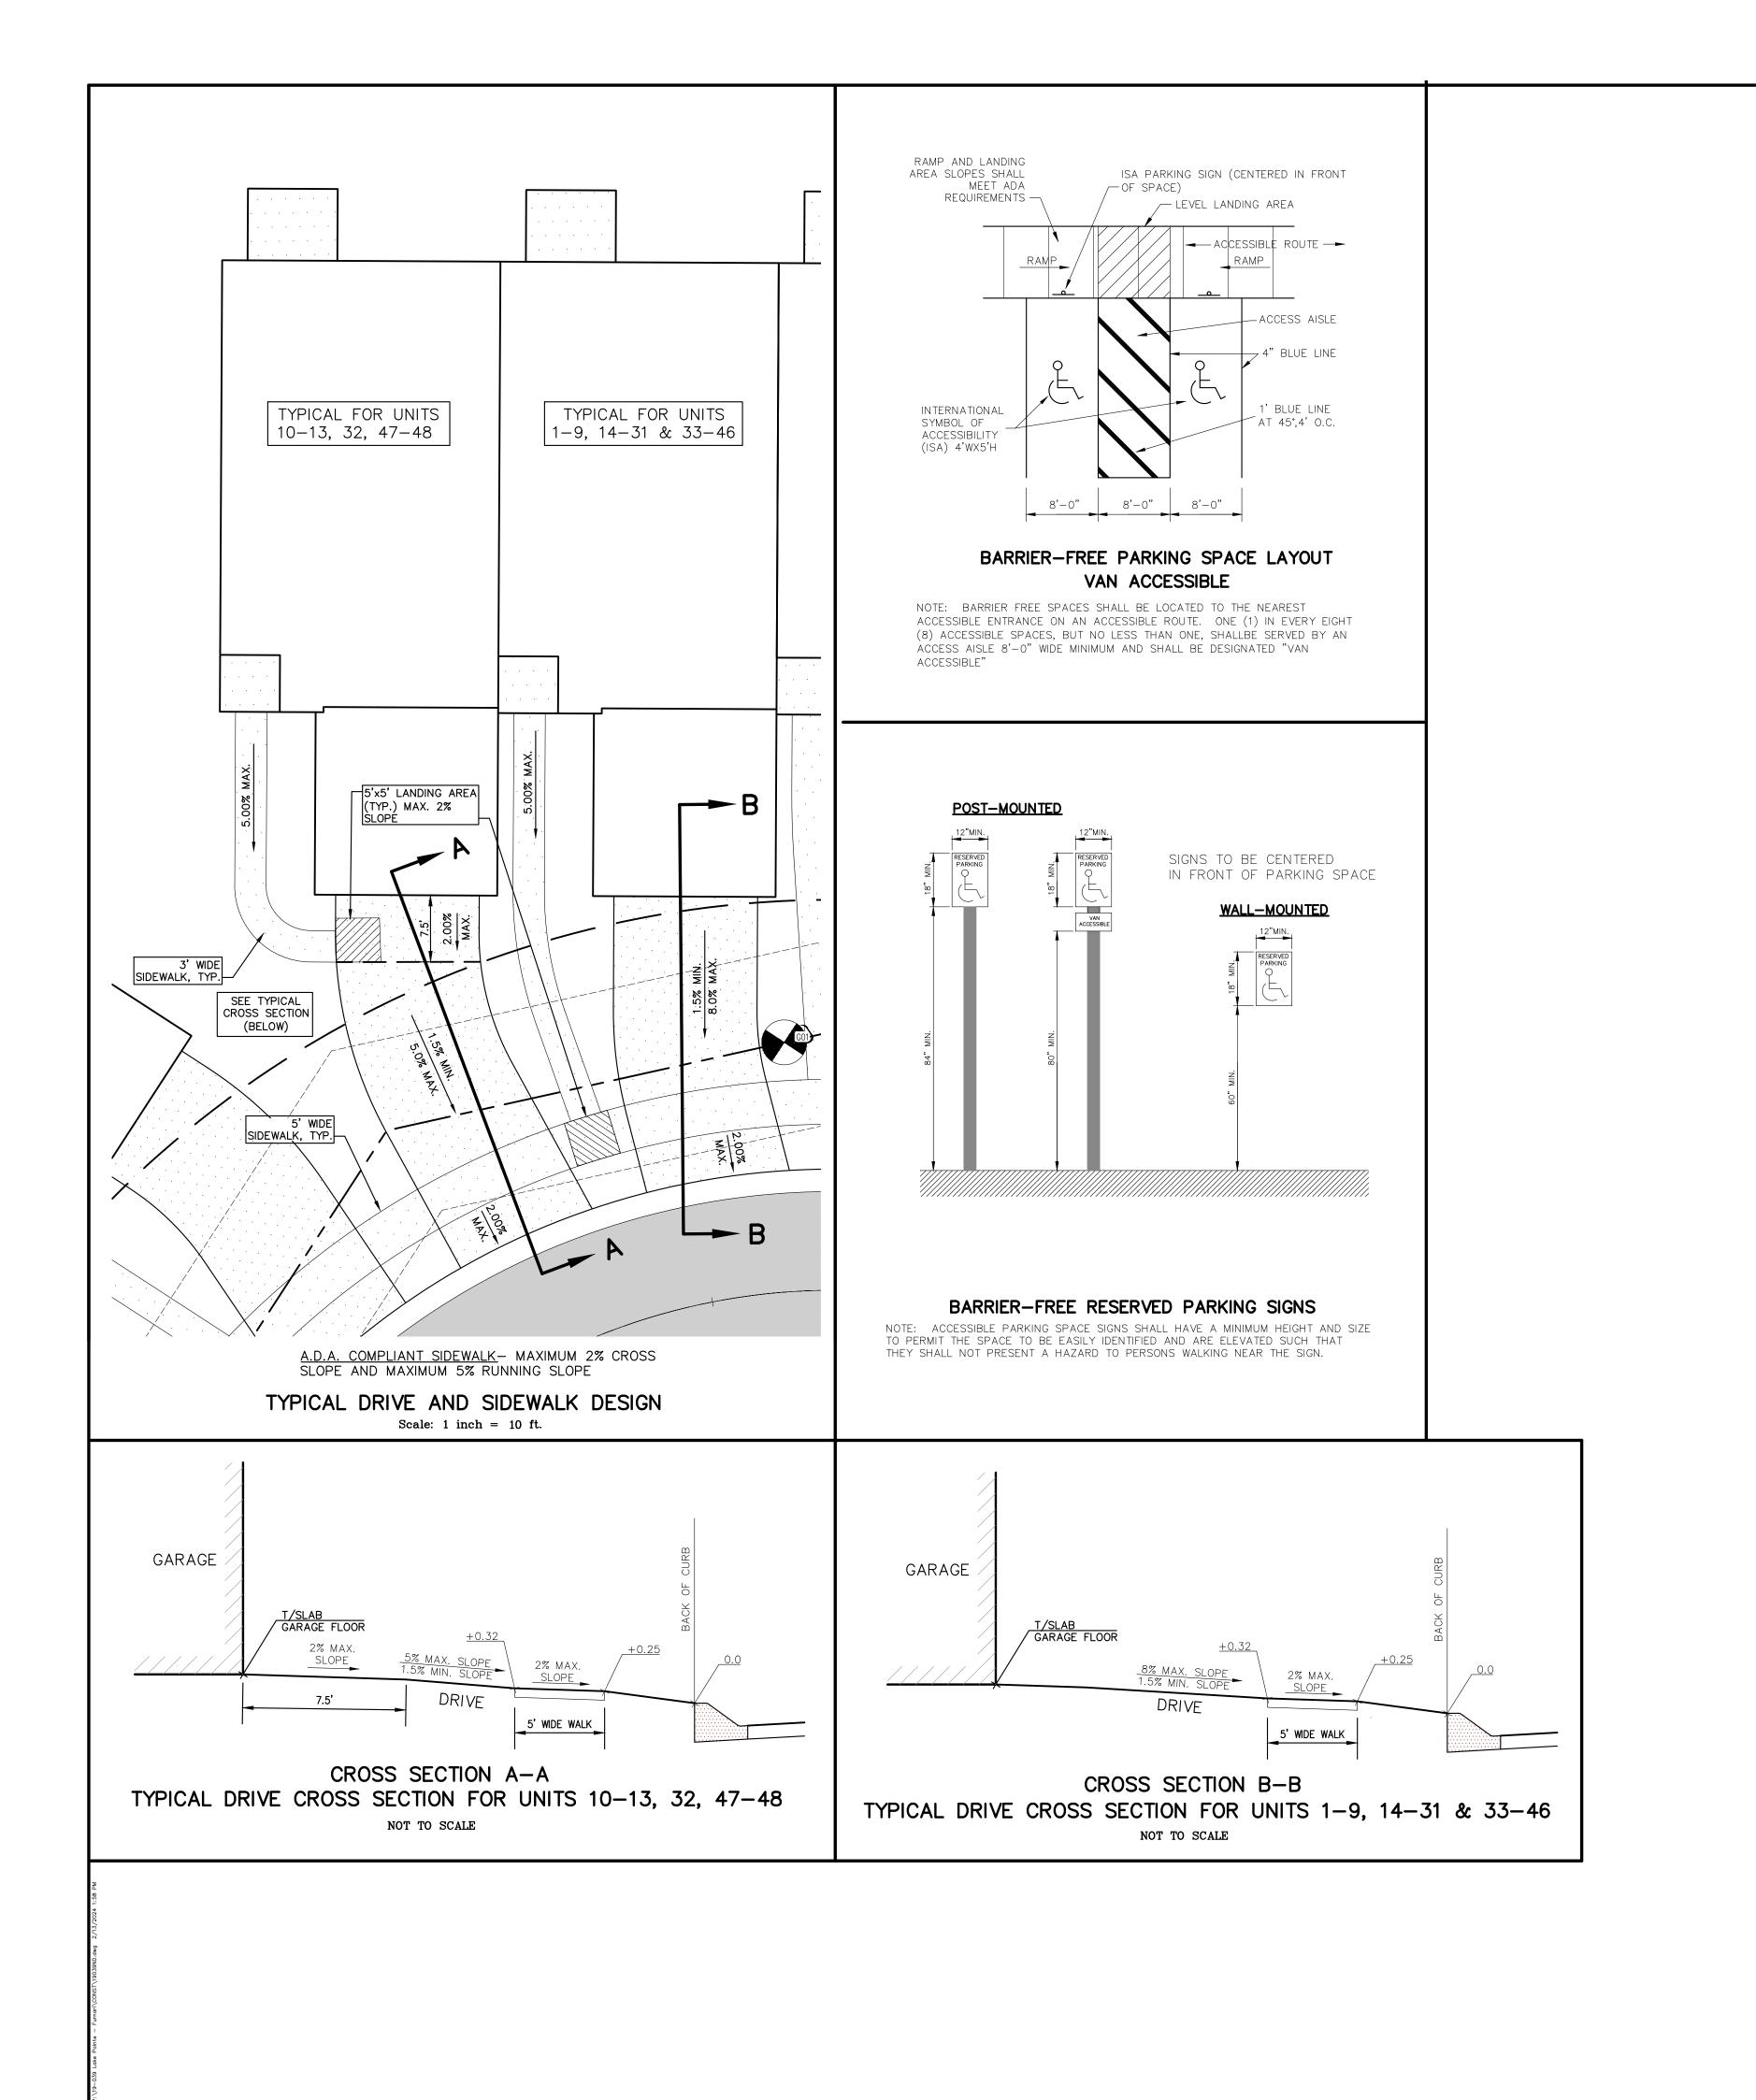

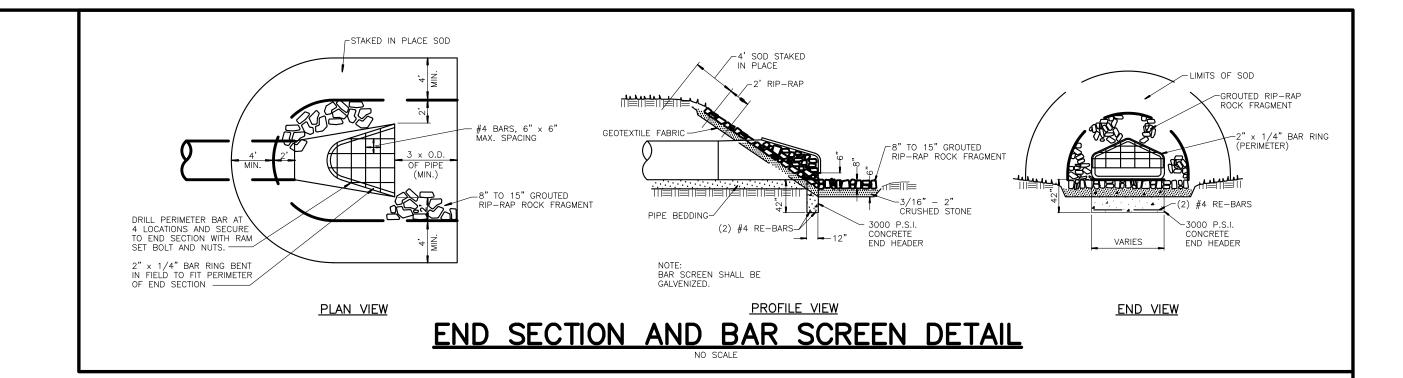

LAKE POINTE

SECTION 36, TOWN 3 NORTH, RANGE 8 EAST
WHITE LAKE TWP., OAKLAND COUNTY, MICHIGAN

 NO.
 ITEM
 DATE

 1.
 REVISE PER OWNER
 6-3-20

 2.
 REVISE GRADES ON UNITS 2 AND 6
 11-9-20

 3.
 REV PER 11-20-20 W.L. TWP LETTER
 02-02-21

 4.
 REVISE PER WHITE LAKE TWP
 03-03-21

 6.
 REVISED PER TOWNSHIP
 04-25-23

 7.
 REVISED PER TOWNSHIP
 7-27-23

 8.
 REVISE PER AGENCIES
 02-13-24

UNDERGROUND UTILITY LOCATIONS AS SHOWN ON THE PLAN, WERE OBTAINED FROM UTILITY OWNER AND NOT FIELD LOCATED.

Know what's below.

UTILITY WARNING

THE CONTRACTOR SHALL BE RESPONSIBLE FOR THE PROTECTION OF AND/OR RELOCATION OF ALL UTILITIES THAT MAY INTERFERE WITH CONSTRUCTION.


Call before you dig.

SHEET

DATE: 04-08-2020 DESIGNED BY: A.A. JOB NUMBER: 19-039
CHECKED BY: J.E. DRAWING FILE:19039ND.dwg

NOTES AND DETAILS



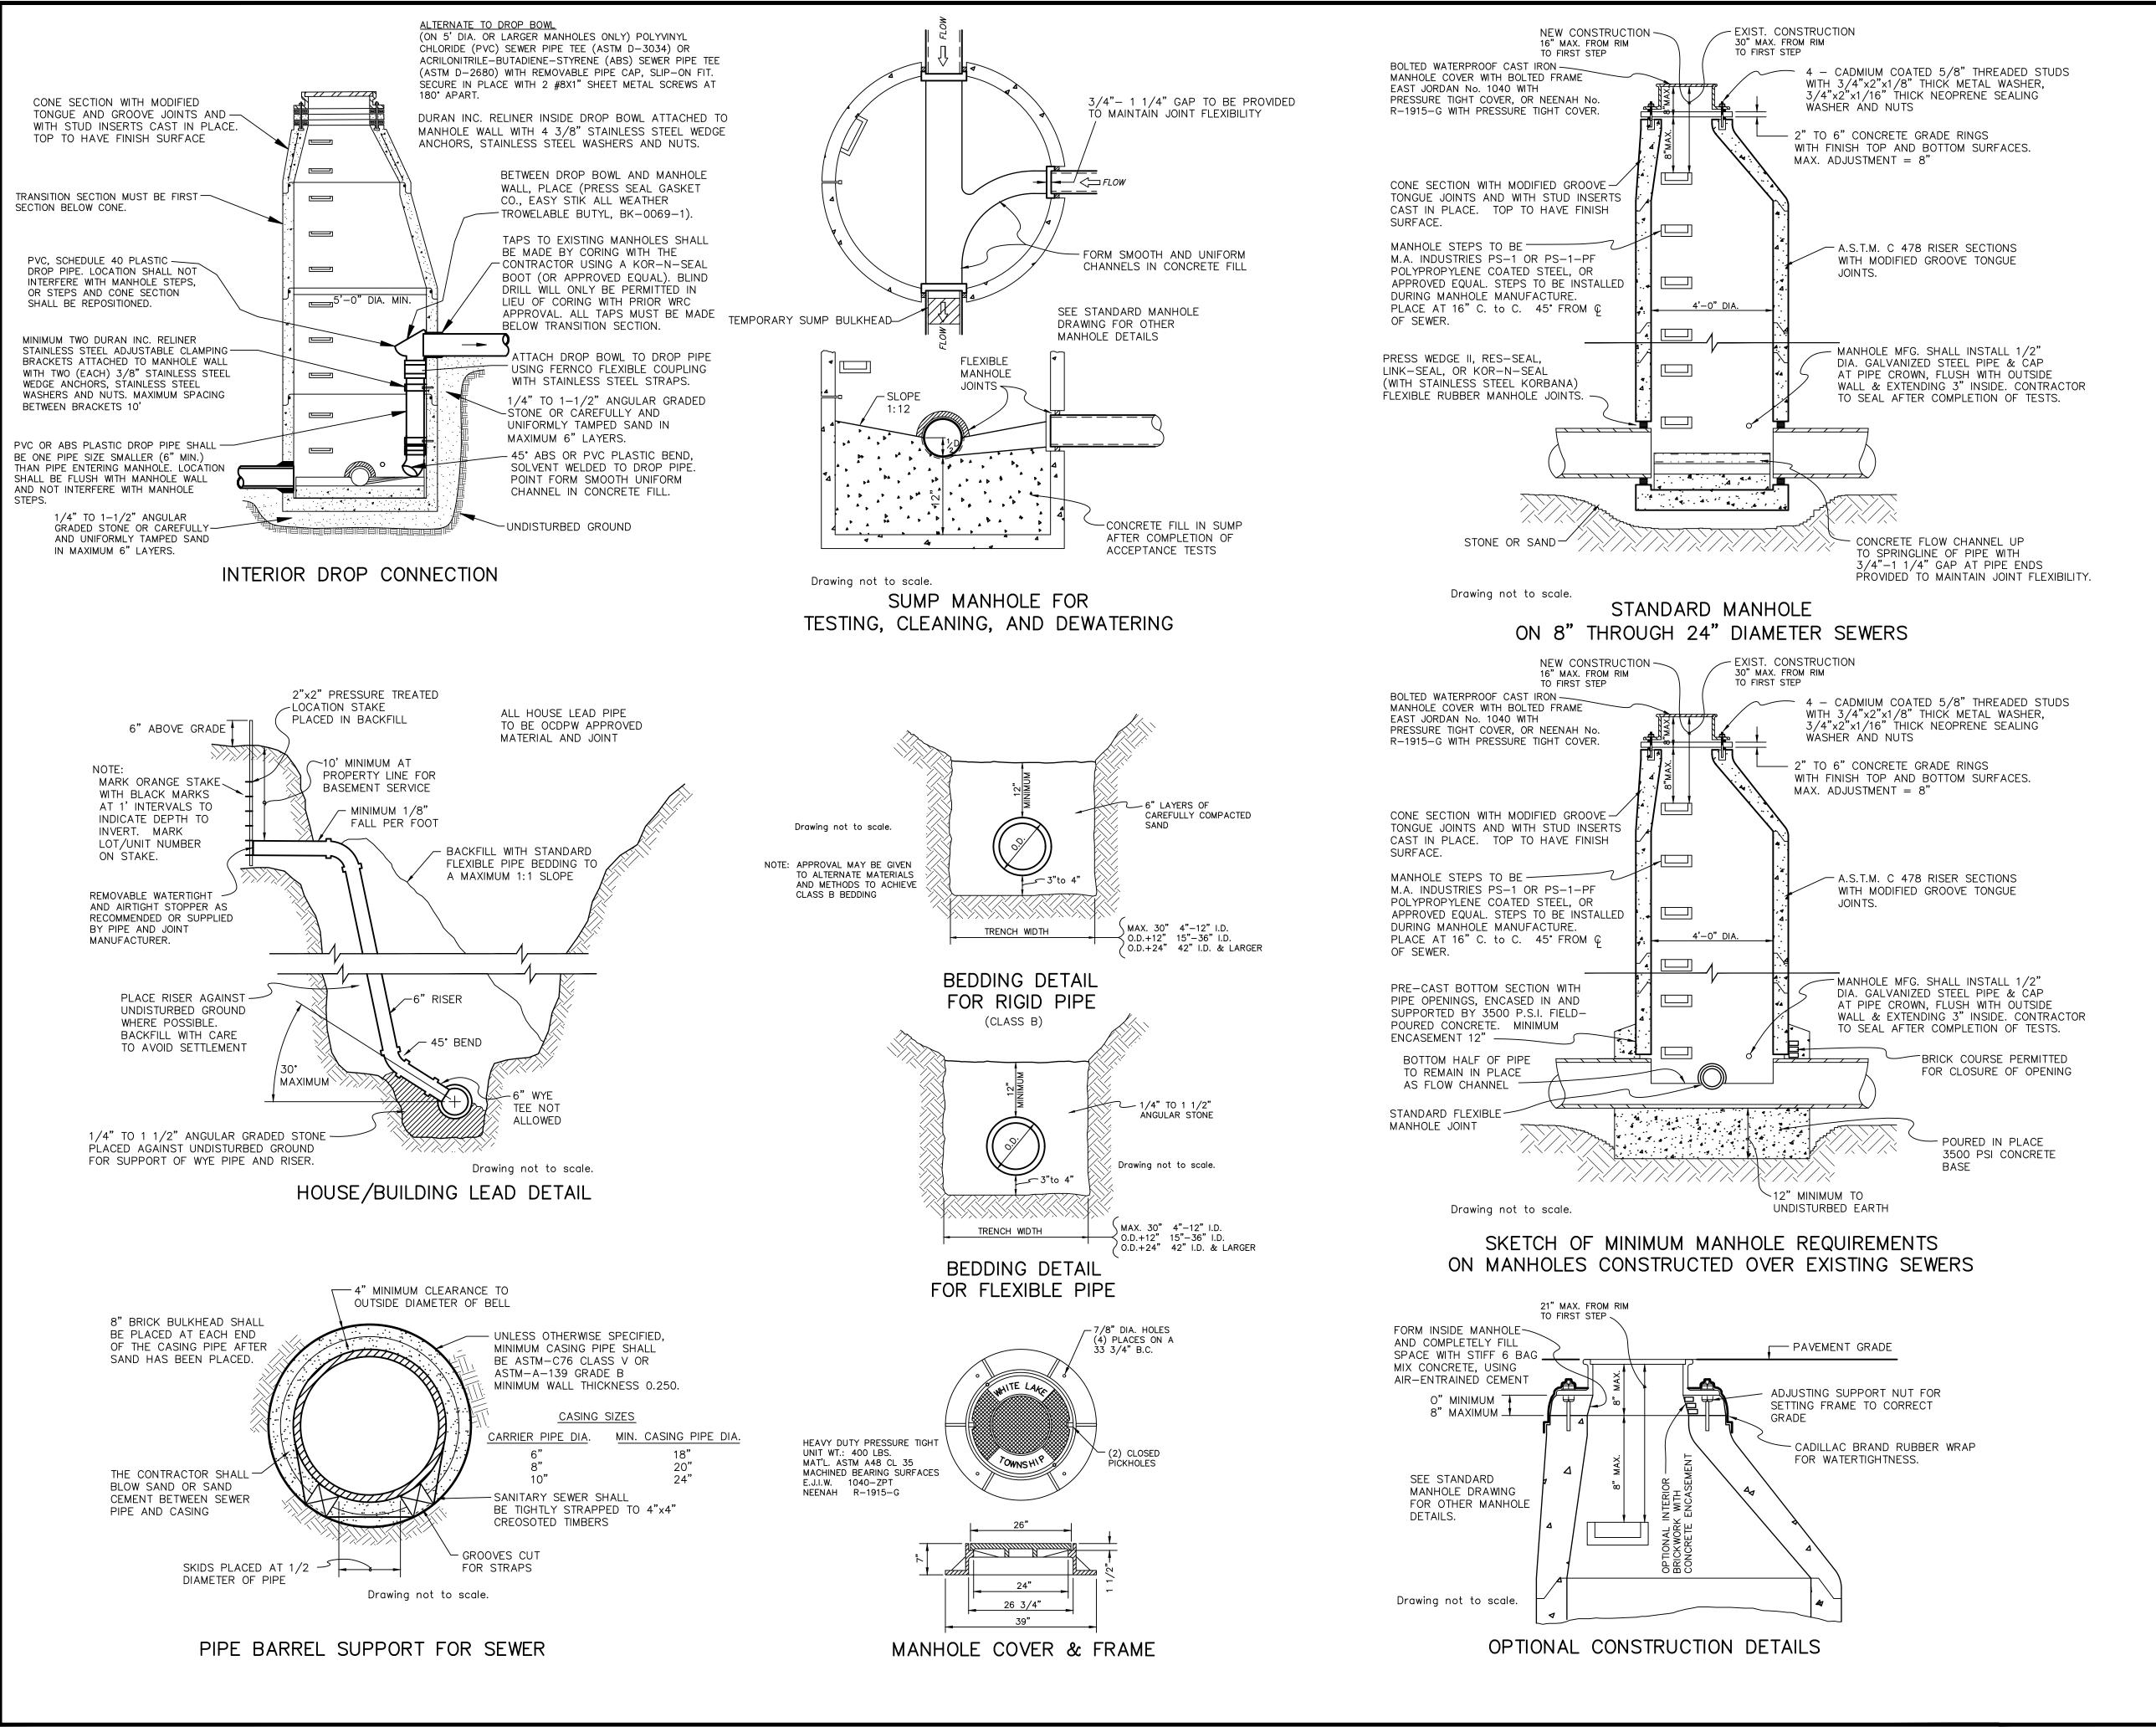

SANITARY SEWER CONSTRUCTION NOTES

- 1. All construction shall conform to the current standards and specifications of the local unit of government and the Oakland County Water Resources Commissioner (OCWRC). All sanitary sewer construction shall have full time inspection supervised by a professional engineer provided by or caused to be provided by the local unit of government.
- 2. At all connections to Oakland County Water Resources Commissioner's sewers or extensions, and before start of construction, the Contractor must obtain a Sewer Inspection Permit issued by the OCWRC. Gravity sewer permit charges are \$250.00 for each connection plus \$25.00 for each manhole constructed. Pressure sewer permit charges are \$250.00 per 2460 L.F. of force main with a minimum permit fee of \$250.00. Failure to pass any test segment will result in an additional charge to the Contractor for each retest, in accordance with the above price schedule. The Contractor shall also have posted with the OCWRC a \$5,000.00 surety bond and \$500.00 cash deposit. The Contractor shall notify the local unit of government and the OCWRC (248-858-1110) 24 hours prior to the beginning of any construction. Final acceptance tests must be witnessed by County personnel and must be scheduled by Municipality or It's consultant in advance with 24 hour notice at 248-858-1110.
- 3. No sewer installation shall have an infiltration or exfiltration exceeding 100 gallons per inch diameter per mile of pipe in a 24 hour period, and no single run of sewer between manholes shall exceed 100 gallons per inch diameter per mile. Air tests in lieu of infiltration tests shall be as specified in the OCWRC "Acceptance Tests", dated September, 1972. Only pipe and pipe joints approved by the Oakland County Water Resources Commissioner may be used for sanitary sewer construction.
- 4. Located in the first manhole upstream from the point of all connections to an existing OCWRC sewer, or extension thereto, a temporary 12—inch deep sump shall be provided in the first manhole above the connection which will be filled in after such successful completion of any acceptance test up to the standard fillet provided for the flow channel. A watertight bulkhead shall be provided on the downstream of the sump manhole.
- 5. All building leads and risers shall be 6-inch S.D.R. 23.5 ABS OR PVC pipe with chemically fused joints, or an approved equal pipe and joint. Sewer pipe wye shall contain factory installed premium joint material of an approved type compatible with that of the building lead pipe used. Building leads to be furnished with removable air tight and water—tight stoppers.
- 6. All rigid sewer pipe shall be installed in Class "B" bedding or better. All flexible, semi-flexible or composite sewer pipe shall be installed in conformance to the Oakland County Water Resources Commissioner specifications.
- 7. All new manholes shall have Oakland County Water Resources Commissioner approved flexible, water—tight seals where pipes pass through walls. Manholes shall be of precast sections with modified groove tongue and rubber gasket type joints. Precast manhole cone sections shall be Oakland County Water Resources Commissioner approved modified eccentric cone type. All manholes shall be provided with bolted, water—tight covers.
- 8. At all connections to manholes on Oakland County Water Resources Commissioner's sewers or extensions thereto drop connections will be required when the difference in invert elevations exceeds 18-inches. Outside drop connections only will be approved.
- 9. Taps to existing manholes shall be made by coring. The Contractor shall place a KOR-N-SEAL boot (or OCWRC approved equal) after coring is completed. Blind drilling will not be permitted in lieu of coring.
- 10. New manholes constructed directly on Oakland County Water Resources Commissioner's sewers shall be provided with covers reading "Oakland County — Sanitary" in raised letters. New manholes built over an existing sanitary sewer shall have monolithic poured bottoms.
- 11. No ground water, storm water, construction water, downspout drainage or weep tile drainage shall be allowed to enter any sanitary sewer installation.
- 12. Prior to excavation, the Contractor shall telephone MISS DIG (647-7344) for the location of underground pipeline and cable facilities, and shall also notify representatives of other utilities located in the vicinity of the work.
- 13. 18" minimum vertical separation and 10' minimum horizontal separation must be maintained between sanitary sewer and water main.
- 14. Manhole frame and cover shall be as follows: East Jordan heavy manhole cover, base flange type #1040 or Neenah Foundry heavy duty #R-1642 manhole frame. Solid lid cover shall be non-rocking and marked "WHITE LAKE TOWNSHIP SEWER DEPARTMENT.'

11/06/15

MARK ADDENDUM/CHANGE ORDER DATE MARK ADDENDUM/CHANGE ORDER DATE MARK ADDENDUM/CHANGE ORDER DATE

OCWRC COMMENTS

09/11/97

04/30/13

02/17/15

DESIGN: OA

CHECKED: -

FIRST ISSUE

UPDATED TITLE BLOCK

UPDATED NOTES

Johnson&Anderson

Waterford, Michigan 48328 tel (248) 681-7800 fax (248) 681-2660

Muskegon, Michigan 49441

2291 Water Street, Suite 6 Port Huron, Michigan 48060 tel (231) 780-3100 fax (231) 780-3115 tel (810) 987-7820 fax (810) 987-789

White Lake Township 7525 Highland Road (M-59) White Lake, Michigan 48383 248-698-3300




OB NO. DATE ISSUED 09/11/97

SHEET NO.

HORZ. AS NOTED

VERT. -

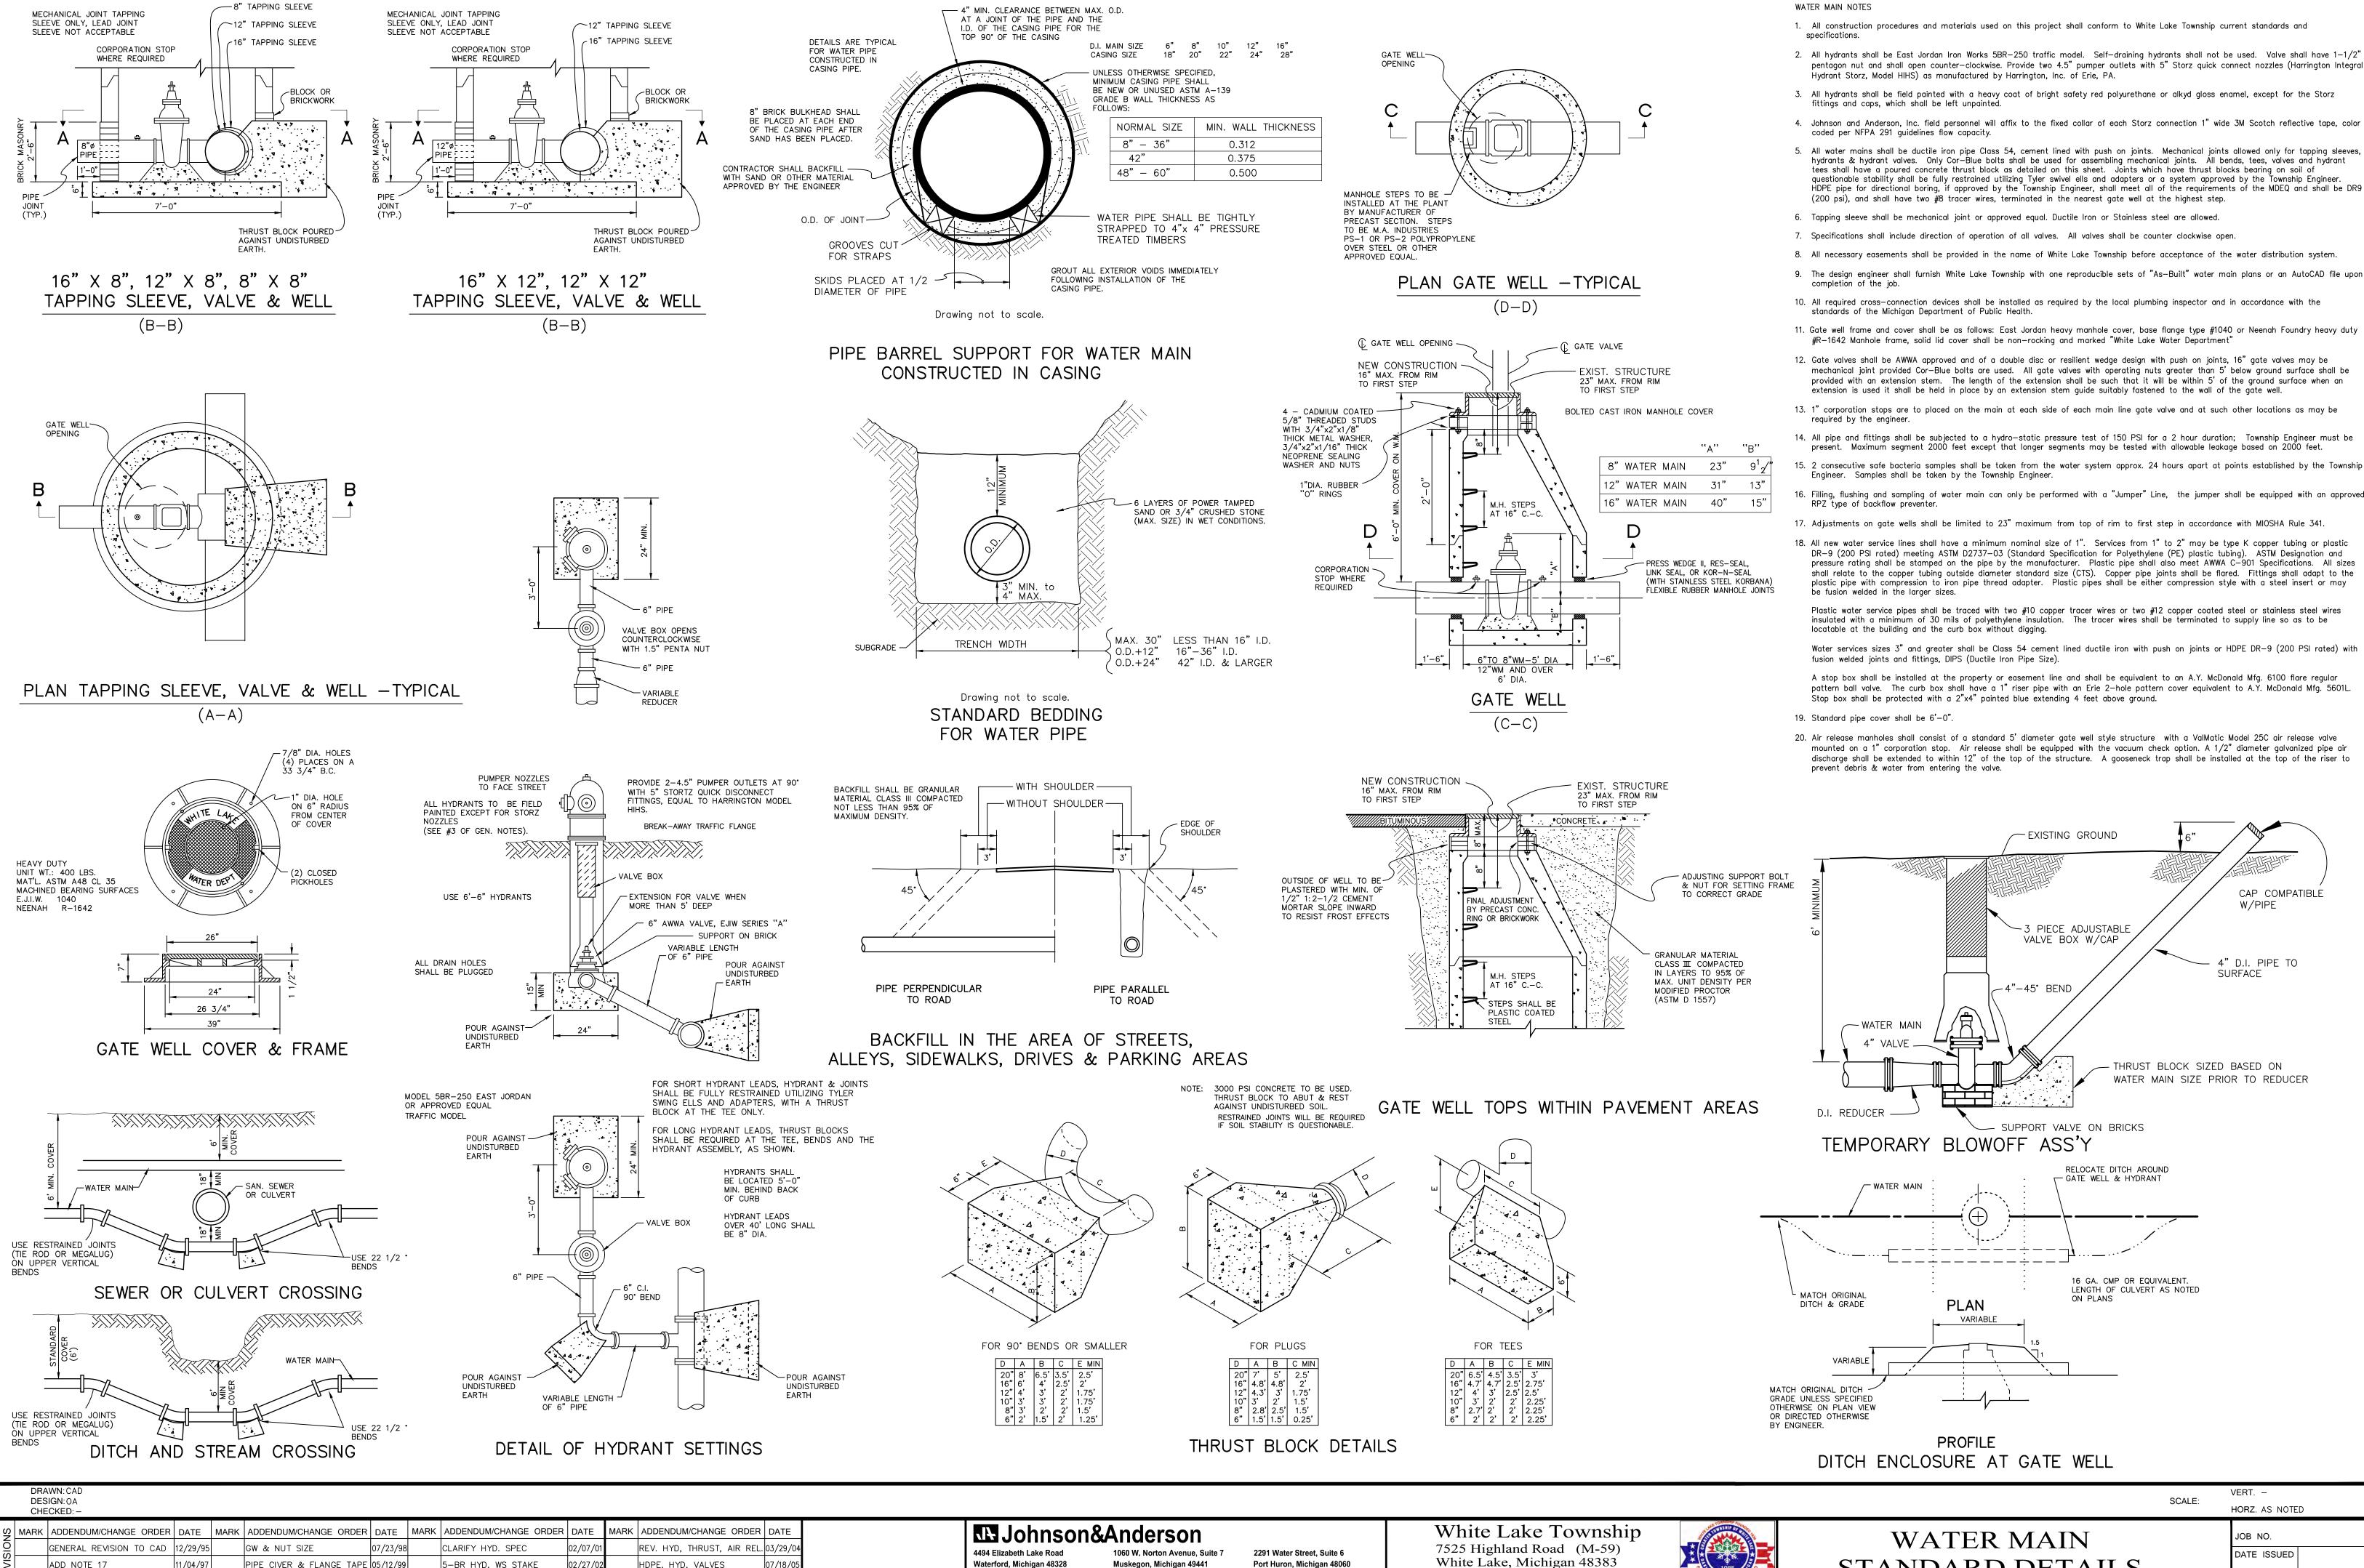

Waterford, Michigan 48328

Muskegon, Michigan 49441

tel (248) 681-7800 fax (248) 681-2660 tel (231) 780-3100 fax (231) 780-3115 tel (810) 987-7820 fax (810) 987-7895

Port Huron, Michigan 48060

248-698-3300

PIPE CIVER & FLANGE TAPE 05/12/99

07/06/99

ADD BLOWOFF

REVISE HYD. & THRUSTING 05/18/98

5-BR HYD, WS STAKE


ADD NOTE 19

HDPE, HYD, VALVES

UPDATED TITLE BLOCK

04/30/13

STANDARD DETAILS

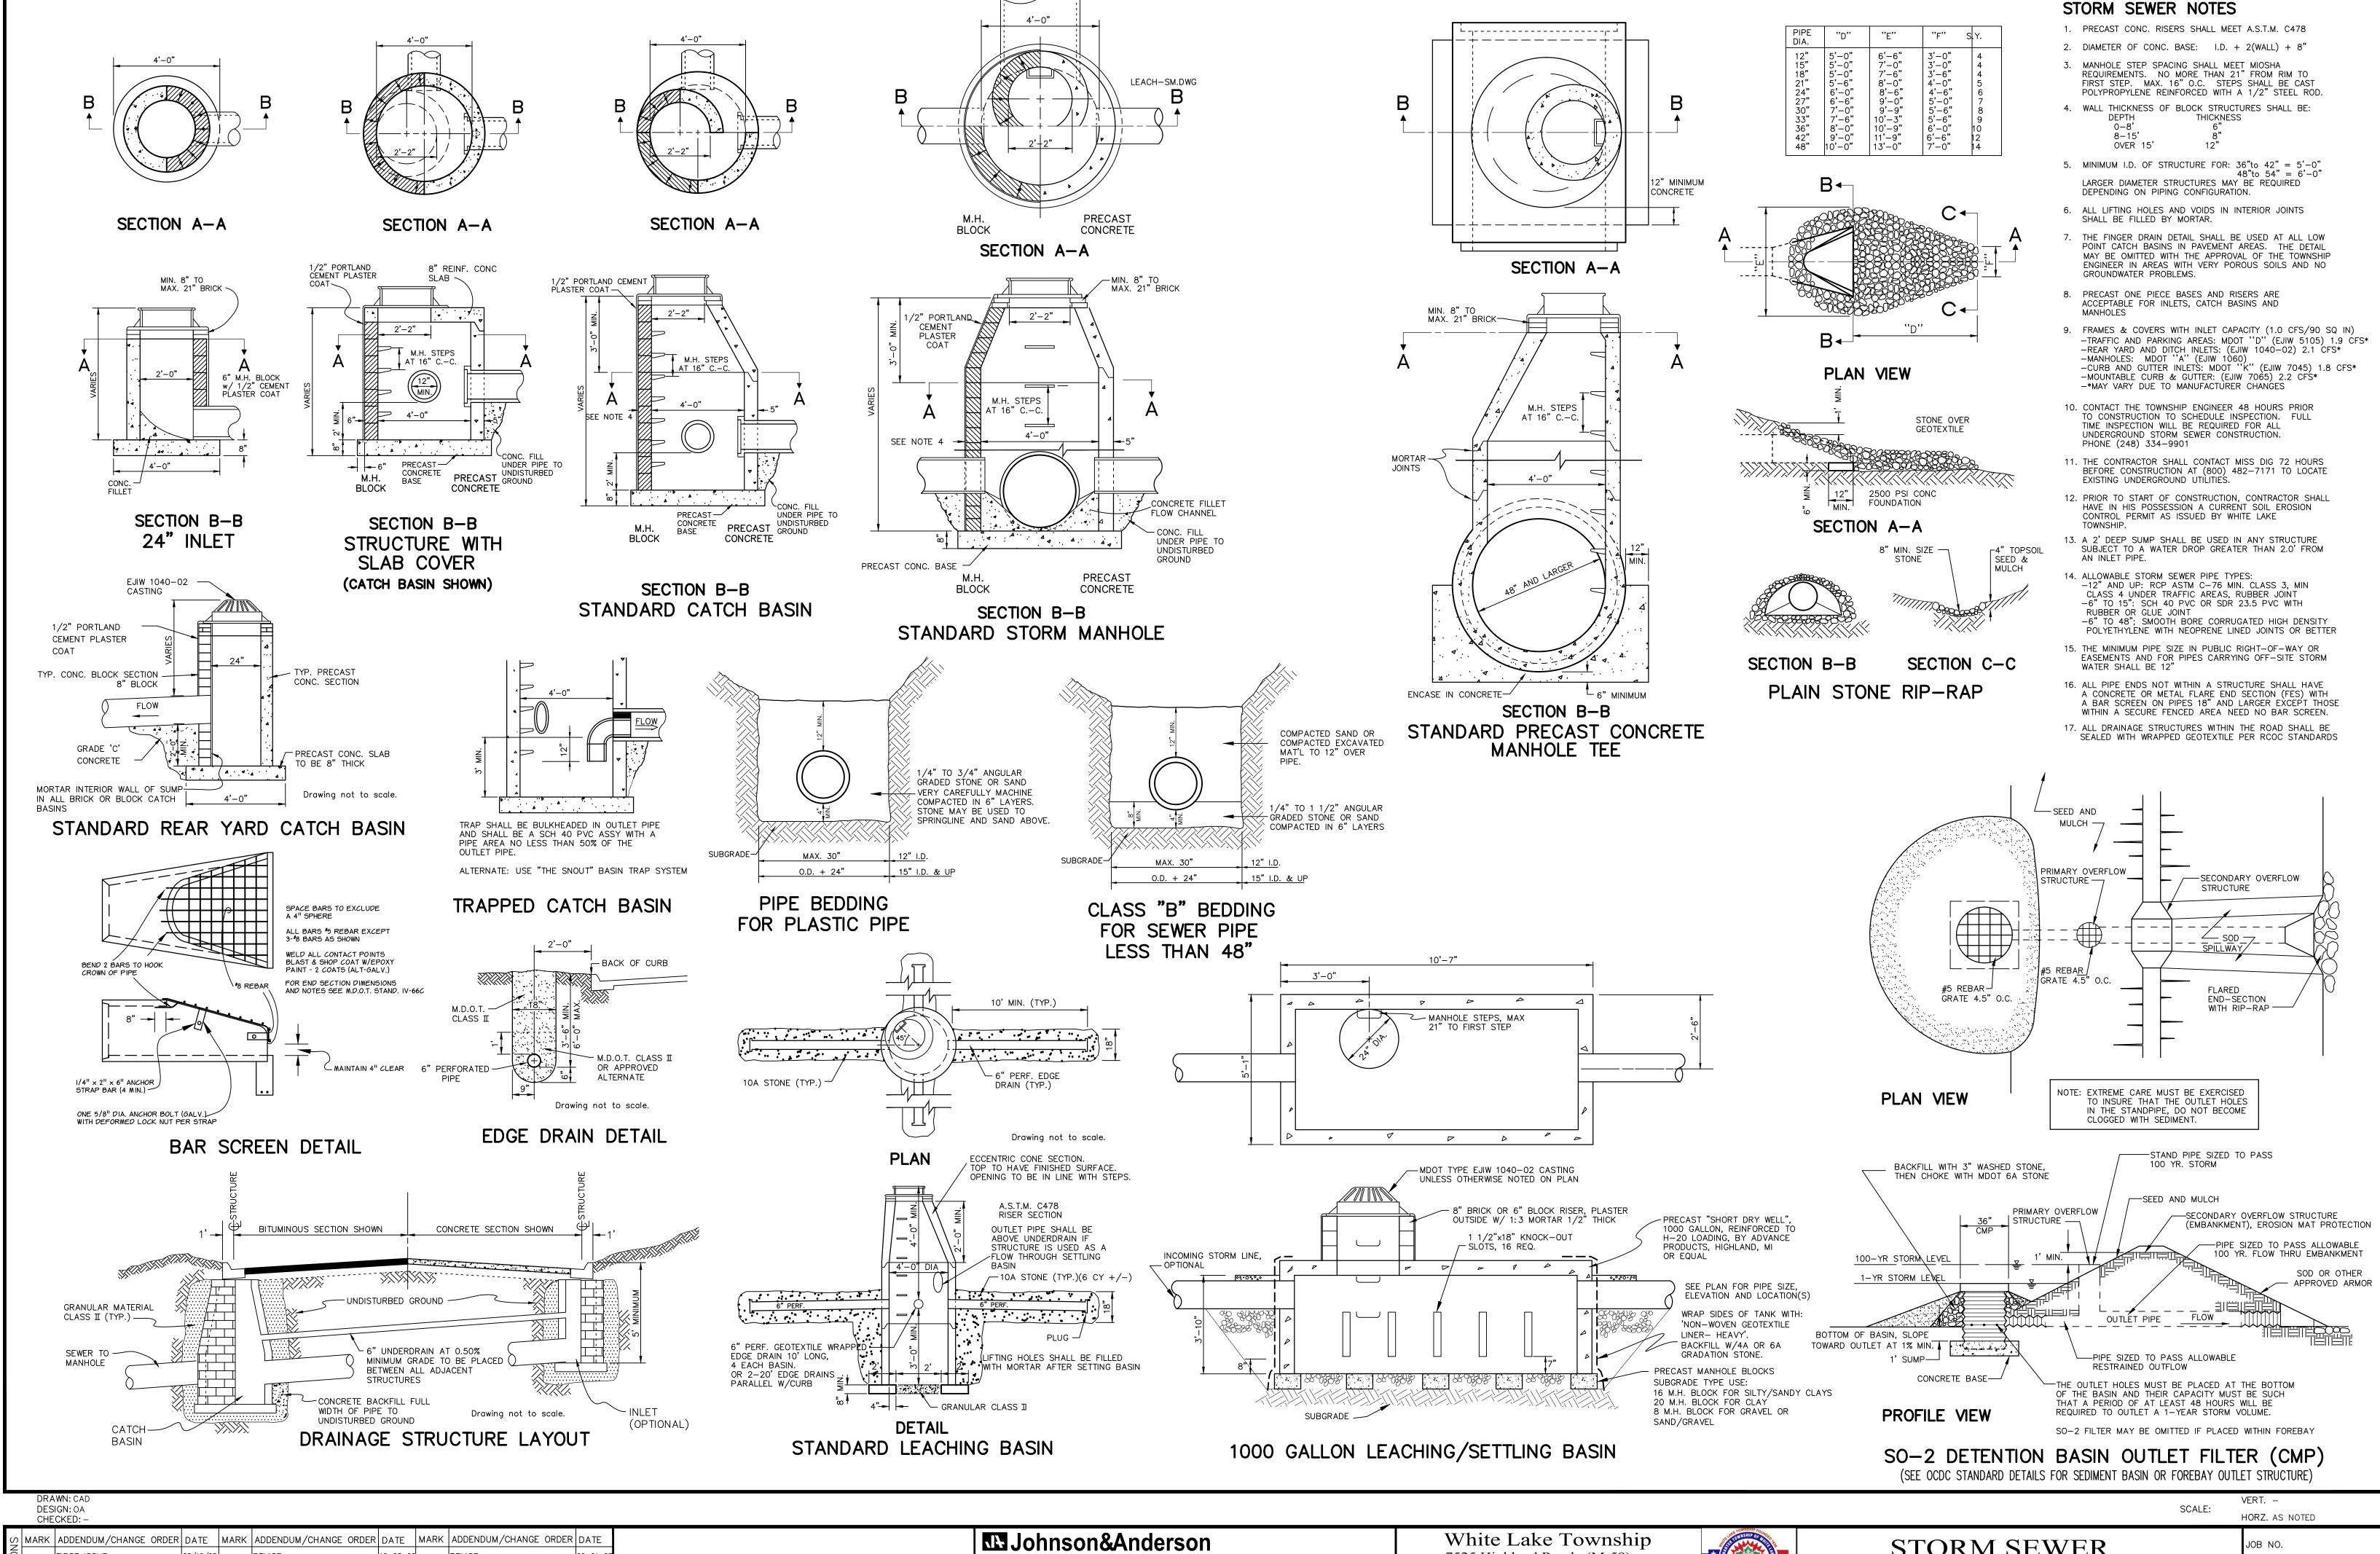

STORM SEWER

08/16/95

06-17-96

FIRST ISSUE

ADD SO-1

NEW BAR GRATE

REVISE


REVISE


10-03-02

12-17-03

UPDATED TITLE BLOCK

04/30/13

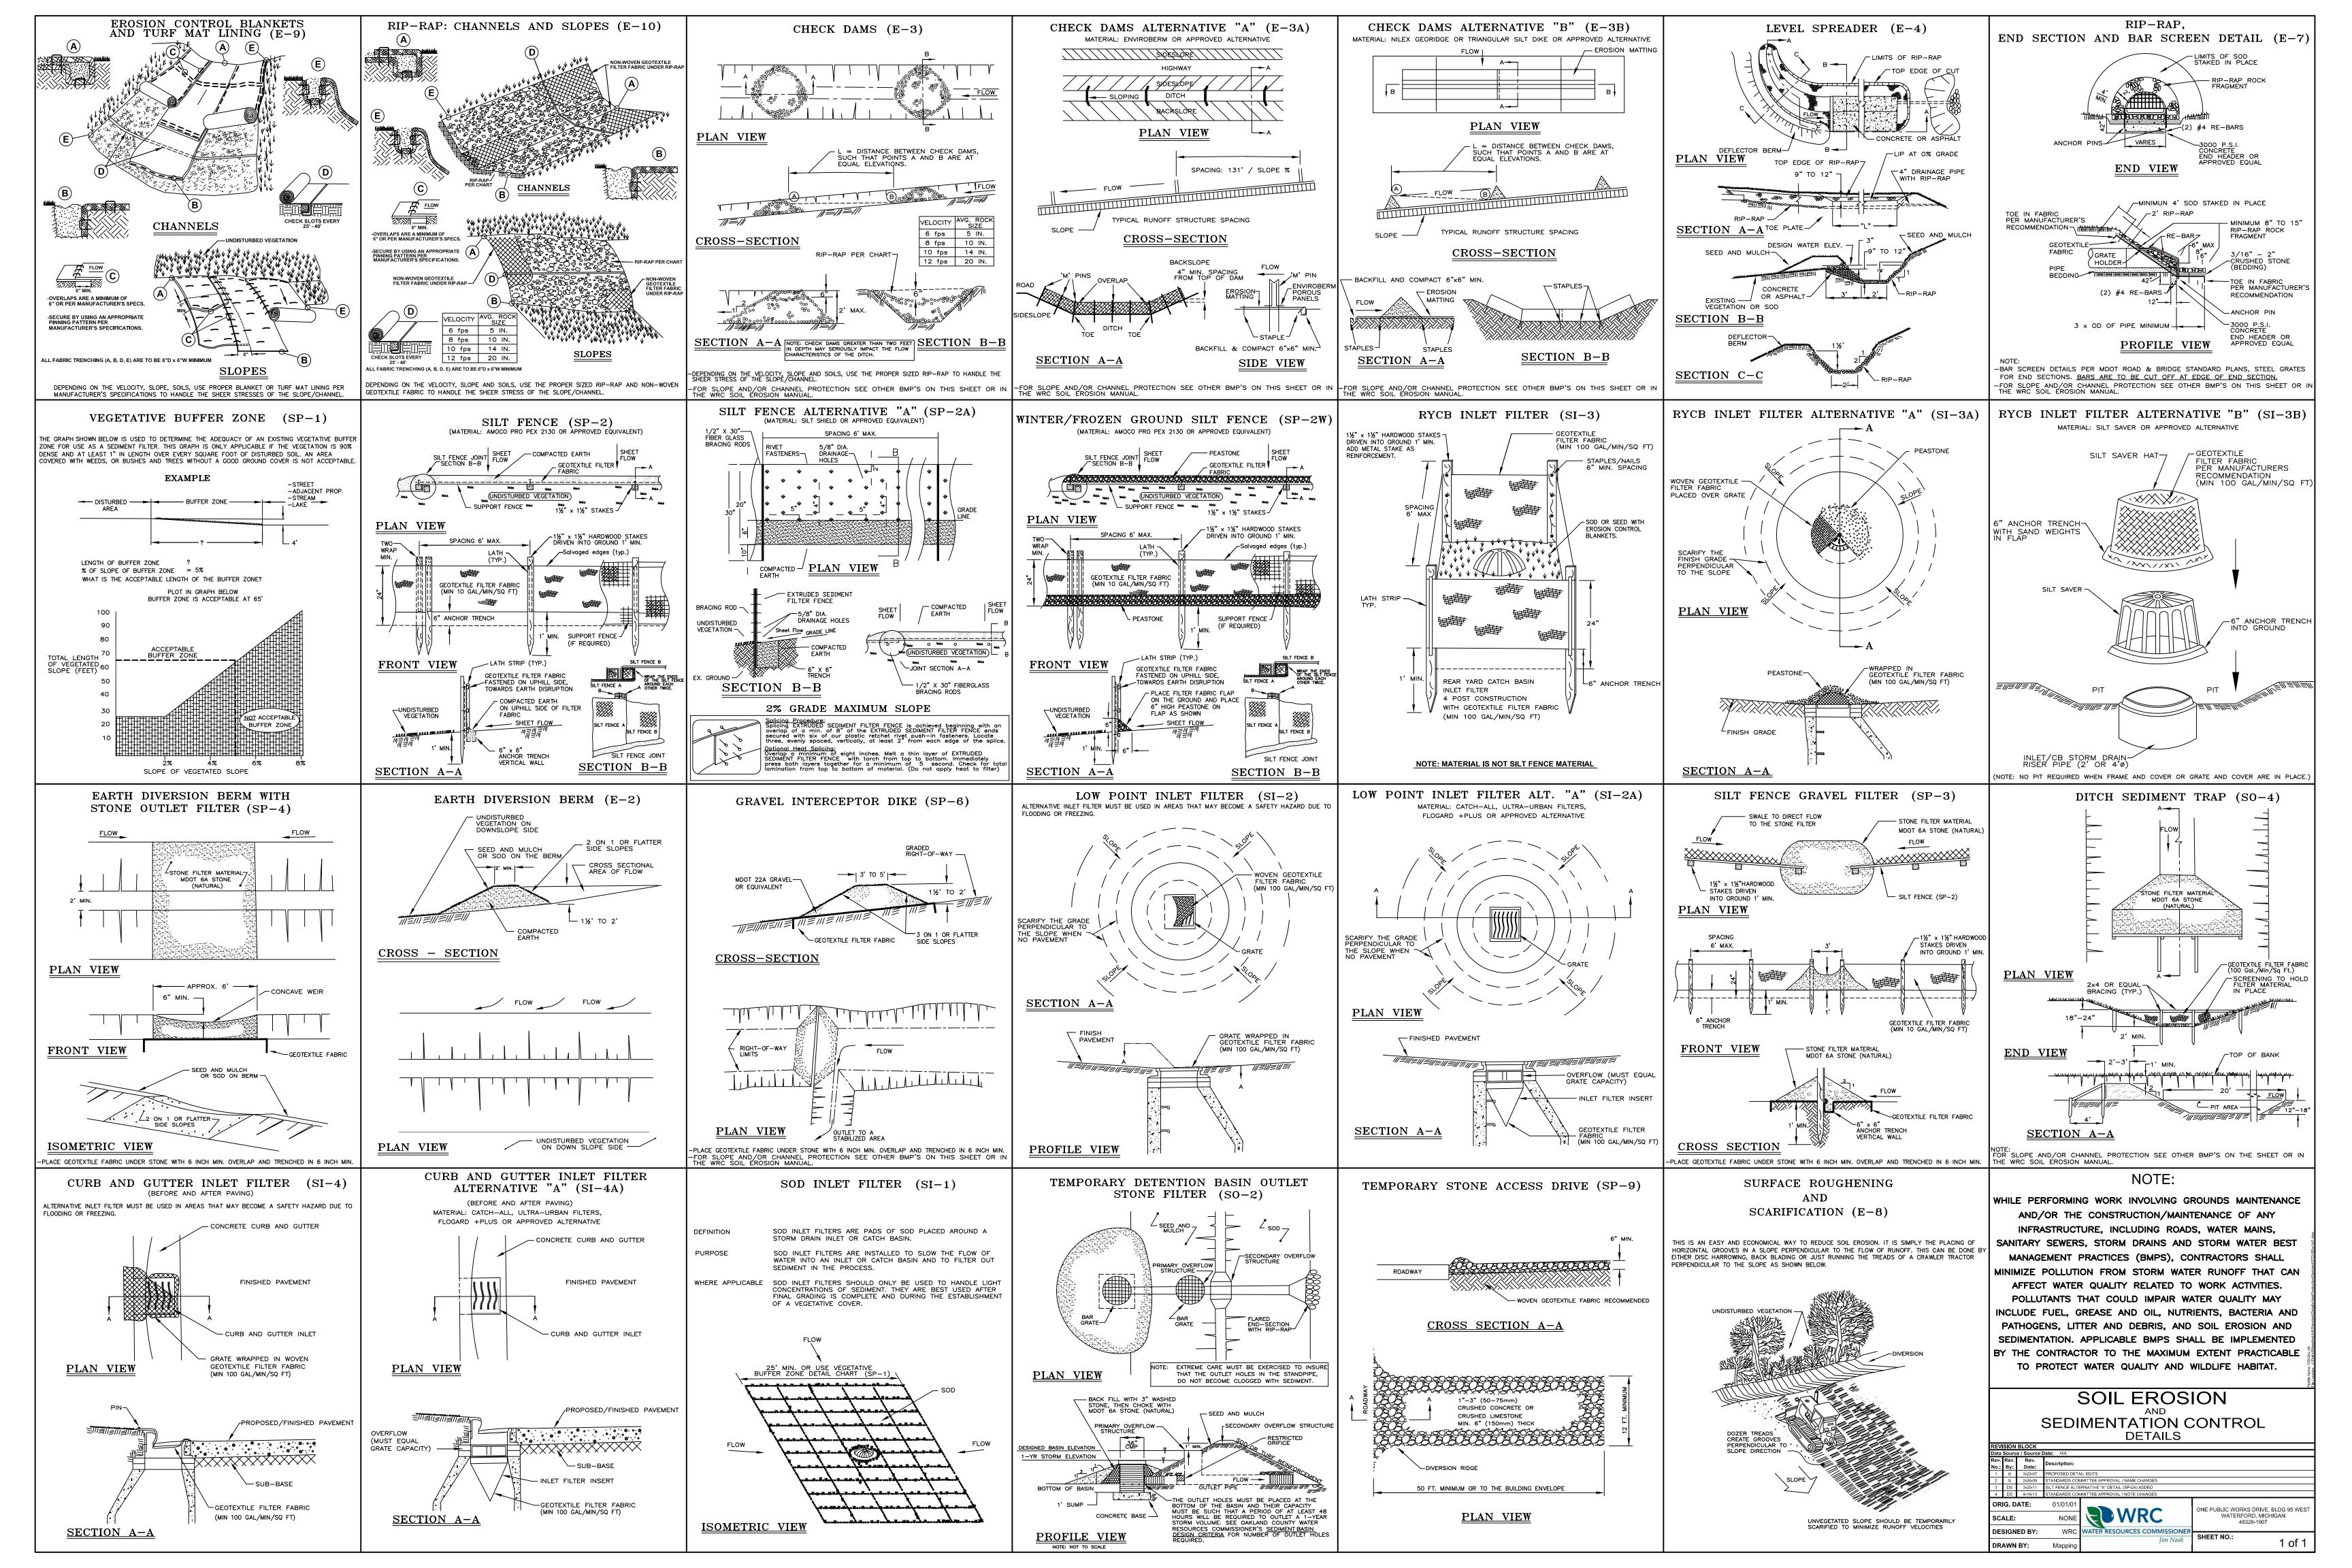

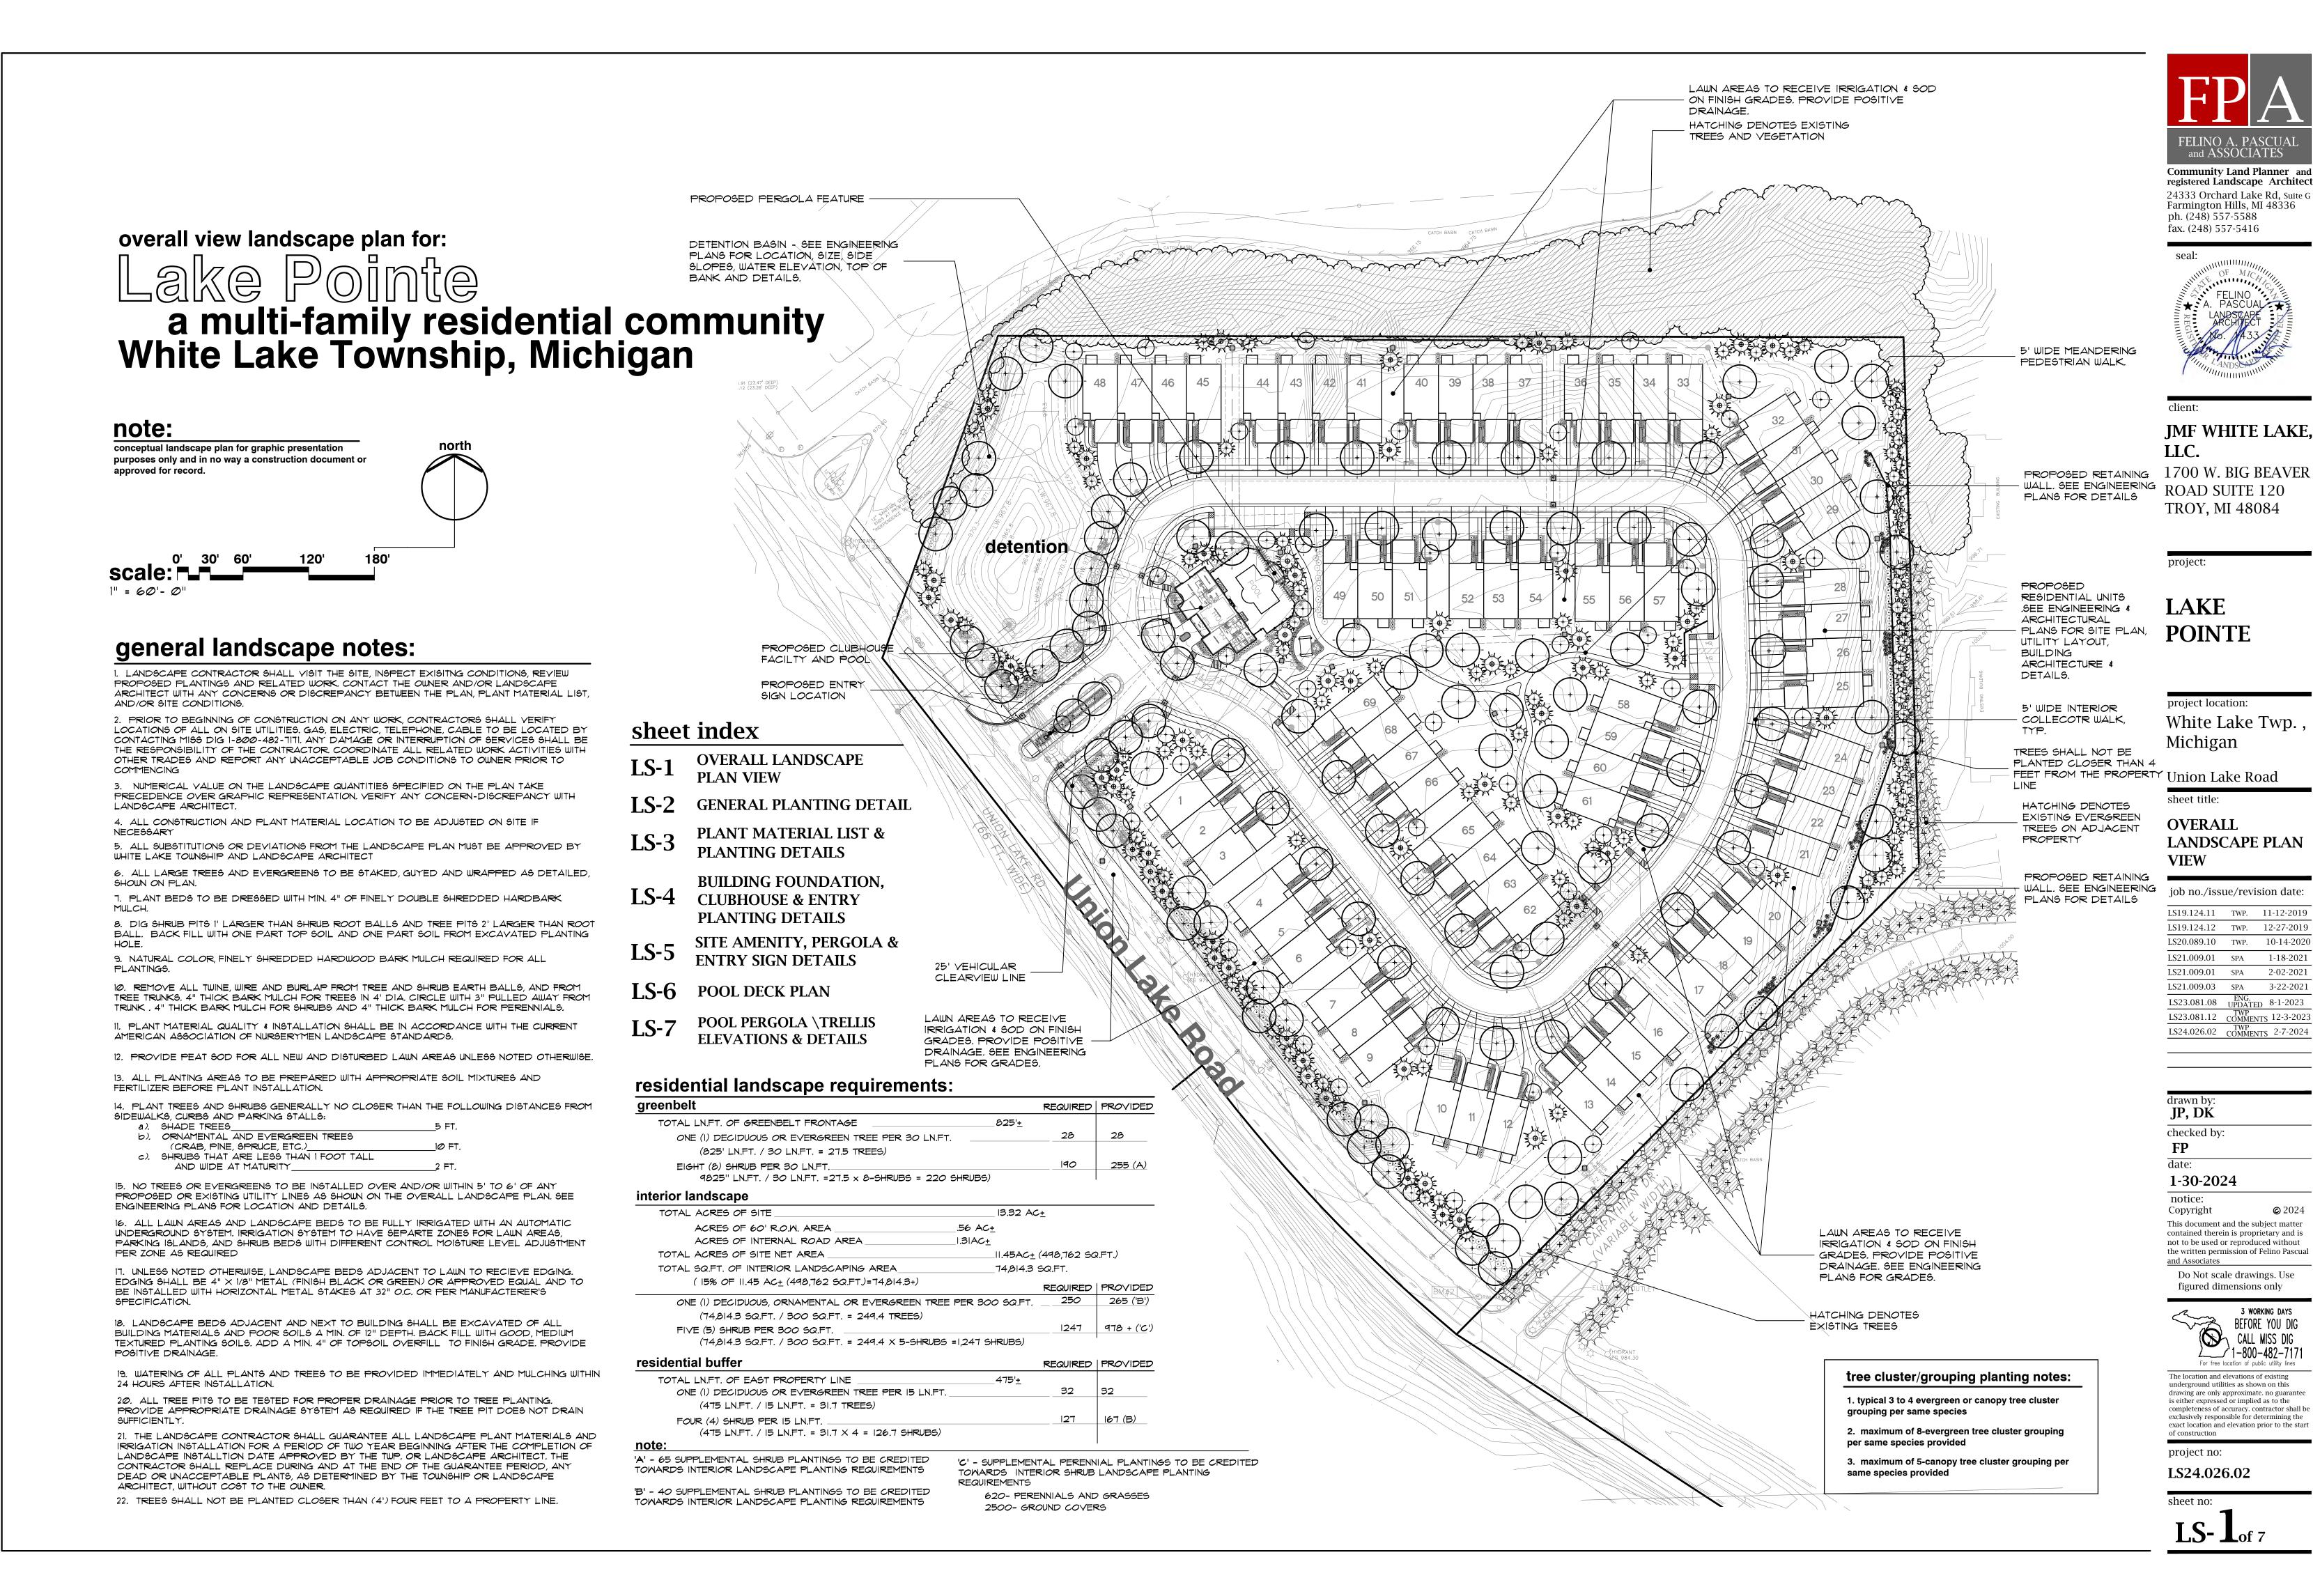





JMF WHITE LAKE, LLC.

1700 W. BIG BEAVER ROAD SUITE 120 TROY, MI 48084

project:

LAKE POINTE

project location: White Lake Twp., Michigan

Union Lake Road

GENERAL LANDSCAPE PLANTING DETAIL

ioh no /issue/revision date:

Job no./188	sue/rev	ision date:
LS19.124.11	TWP.	11-12-2019
LS19.124.12	TWP.	12-27-2019
LS20.089.10	TWP.	10-14-2020
LS21.009.01	SPA	1-18-2021
LS21.009.01	SPA	2-02-2021
LS21.009.03	SPA	3-22-2021
LS23.081.08	ENG. UPDATI	ED 8-1-2023
LS23.081.12	TWP COMME	NTS 12-3-2023
LS24.026.02	TWP COMME	NTS 2-7-2024

JP, DK

checked by:

date: 1-30-2024

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Do Not scale drawings. Use figured dimensions only



The location and elevations of existing underground utilities as shown on this drawing are only approximate. no guarantee is either expressed or implied as to the completeness of accuracy. contractor shall be exclusively responsible for determining the exact location and elevation prior to the start of construction

project no:

LS24.026.02 sheet no:

transformer pad planting detail

A MINIMUM OF 2' SEPARATION BETWEEN TRANSFORMER AND FULL GROWN SHRUBS AND TREES. GROUND COVERS ALLOWED UP TO TRANSFORMER PAD IF MAINTAINED BELOW 4" FULL GROWTH. IF TRANSFORMER FACES TOWARDS THE HOUSE, THEN THE SAME CONDITIONS EXIST. NO FULL GROWTH IN FRONT OF THE TRANSFORMER FOR AT LEAST A MINIMUM OF 8' THERE ARE NO WAIVERS GRANTED TO THE ABOVE CONDITION. DETAIL PER THE DETROIT EDISON COMPANY-SERVICE PLANNING DEPARTMENT

SEE ENGINEERING PLANS FOR PROPOSED LOCATIONS. TOTAL NUMBER OF TRANSFORMERS AND FINAL LOCATION PER DETROIT EDISON

Landscape maintenance notes:

LANDSCAPE MAINTENANCE PROCEDURES AND FREQUENCIES TO BE FOLLOWED SHALL BE SPECIFIED ON THE LANDSCAPE PLAN, ALONG WITH THE MANNER IN WHICH THE EFFECTIVENESS, HEALTH AND INTENDED FUNCTIONS OF THE VARIOUS LANDSCAPE AREAS ON THE SITE WILL BE ENSURED.

1. LANDSCAPING SHALL BE KEPT IN A NEAT, ORDERLY AND HEALTHY GROWING CONDITION, FREE FROM DEBRIS AND REFUSE.


2. PRUNING SHALL BE MINIMAL AT THE TIME OF INSTALLATION, ONLY TO REMOVE DEAD OR DISEASED BRANCHES. SUBSEQUENT PRUNING SHALL ASSURE PROPER MATURATION OF PLANTS TO ACHIEVE THEIR APPROVED PURPOSE

3. ALL DEAD OR DISEASED PLANT MATERIAL SHALL BE REMOVED AND REPLACED WITHIN SIX (6) MONTHS AFTER IT DIES OR IN THE NEXT PLANTING SEASON, WHICHEVER OCCURS FIRST. THE PLANTING SEASON FOR DECIDUOUS PLANTS SHALL BE BETWEEN MARCH 15 AND NOVEMBER 15 OR UNTIL THE PREPARED SOIL BECOMES FROZEN. THE PLANTING SEASON FOR EVERGREEN PLANTS SHALL BE BETWEEN MARCH I AND JUNE 1. PLANT MATERIAL INSTALLED TO REPLACE DEAD OR DISEASED MATERIAL SHALL BE AS CLOSE AS PRACTICAL TO THE SIZE OF THE MATERIAL IT IS INTENDED TO REPLACE.

plant material list

key	quant. LS-2	botanical name	common name	size	comments
		LARGE AND SMALL DECIDUOUS TREES			
GT	8	GLEDITSIA TRI. INERMIS 'SKYCOLE'	SKYLINE LOCUST	2 1/2" BB	
TC	8	TILIA CORDATA 'GREENSPIRE'	GREENSPIRE LINDEN	2 1/2" BB	
LS	7	LIQUIDAMBAR STYRACIFLUA	AMERICAN SWEETGUM	2 1/2" BB	
ZS	12	ZELKOYA SERRATE 'VILLAGE GREEN'	VILLAGE GREEN ZELKOVA	2 1/2" BB	
AR	11	ACER R. 'FRANKSRED'	RED SUNSET RED MAPLE	2 1/2" BB	
co	10	CELTIS OCCIDENTALIS	HACKBERRY	2 1/2" BB	
LŤ	10	LIRIODENDRON TULIPIFERA	TULIPTREE	2 1/2" BB	
QB	12	QUERCUS 'BICOLOR'	SWAMP WHITE OAK	2 1/2" BB	
AF	18	ACER X FREEMANII 'JEFF\$RED'	AUTUMN BLAZE RED MAPLE	2 1/2" BB	
APC	3	ACER P. 'CRIMGON KING'	CRIMSON KING NORWAY MAPLE	2 1/2" BB	
AS	2	ACER SACCHARUM	SUGAR MAPLE	2 1/2" BB	
OY	9	OSTRYA VIGINIANA	AMERICAN HOPHORNBEAM	2 1/2" BB	
CJ	2	CERCIDIPPHYLLUM JAPONICUM	KATSURATREE	2 1/2" BB	
СВ	6	CARPINUS BETULUS 'FASTIGIATA'	PYRAMIDAL EUROPENAN HORNBEAN	2 1/2" BB	
SR	2	SYRINGA RETICULATA 'IVORY SILK'	VORY SILK JAPANESE TREE LILAC	2 1/2" BB	
cc	7	CERCIS CANADENSIS	EASTERN REDBUD (MULTI-STEM)	8' BB	(MULTI-STEM)
AC	6	AMELANCHIER CANADENSIS	SHADBLOW SERVICEBERRY	8' BB	(MULTI-STEM)
cK	5	CORNUS KOUSA	KOUSA DOGWOOD	2" BB	
CP	1	CRATAEGUS PHAENOPYRUM	WASHINGTON HAWTHORN	2" BB	
MS	6	MALUS 'SNOWDRIFT'	SNOWDRIFT CRABAPPLE	2" BB	
MF	7	MALUS FLORIBUNDA	JAPANESE FLOWERING CRABAPPLE	2" BB	
MJ	7	MAGNOLIA LILIIFLORA 'JANE'	JANE MAGNOLIA	8' BB	(MULTI-STEM)
MR	4	MALUS 'RED BARRON'	RED BARRON CRABAPPLE	2" BB	
AP	2	ACER P. 'BLOODGOOD'	BLOODGOOD LACE LEAF JAPANESE MAPLE	#7 CONT 7' HIGH	
		LARGE AND SMALL EVERGREENS			
AW	36	ABIES CONCOLOR	CONCOLOR WHITE FIR	8' BB	
AWL	18	ABIES CONCOLOR	CONCOLOR WHITE FIR	10' BB 0	
PA	34	PICEA ABIES	NORWAY SPRUCE	8' BB	
PAL	20	PICEA ABIES	NORWAY SPRUCE	10' BB 0	
PD	32	PICEA GLAUCA 'DENSATA'	BLACK HILL SPRUCE	8' BB	
PDL	20	PICEA GLAUCA 'DENSATA'	BLACK HILL SPRUCE	10' BB 0	
		SHRUBS			
9	26	VIBRUNUM DENTATUM 'CHICAGO LUSTRE	CHICAGO LUSTRE ARROWOOD YIBRUNUM	3' BB	60" SPACING 0.0
FI	50	FORSYTHIS X INTERMEDIA	BORDER FORSYTHIA	3" BB	60" SPACING 0.0
	28	CORNUS STOLONIFERA	REDTWIG DOGWOOD	3' BB	60" SPACING 0.0
CS			MOHAWK VIBURNUM	3' BB	60" SPACING 0.
CS VMK	43	VIBURNUM X.B. 'MOHAWK'	 ICHAWR YIDARAGII		1 0 0, 7 10 11 10 0 11
	43	VIBURNUM X.B. 'MOHAWK' RHUS AROMATICA 'GRO-LOW'	GRO-LOW FRAGRANT SUMAC	24" CONT	48" SPACING O.C

BASE OF TO 4" DEPTH.

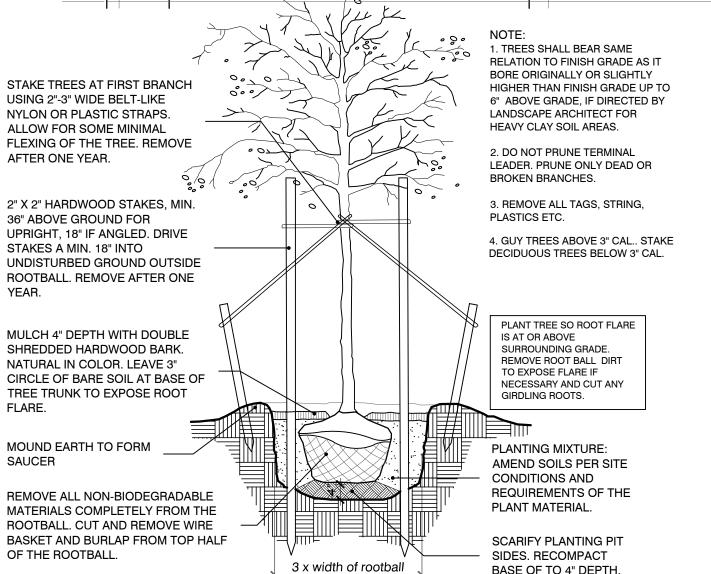

tree planting detail

Annual Rye Winter Wheat STAKE TREES AT FIRST BRANCH USING 2"-3" WIDE BELT- LIKE NYLON OR PLASTIC STRAPS. 1.EVERGREEN TREE SHALL BEAR ALLOW FOR SOME MINIMAL SAME RELATION TO FINISH GRADE FLEXING OF THE TREE. REMOVE AS IT BORE ORIGINALLY OR SLIGHTLY AFTER ONE YEAR. HIGHER THAN FINISH GRADE UP TO 6" ABOVE GRADE, IF DIRECTED BY LANDSCAPE ARCHITECT FOR HEAVY CLAY SOIL AREAS. 2" X 2" HARDWOOD STAKES, MIN. 36" ABOVE GROUND FOR 2. DO NOT PRUNE TERMINAL LEADER. UPRIGHT, 18" IF ANGLED. PRUNE ONLY DEAD OR BROKEN DRIVE STAKES A MIN. 18" BRANCHES. INTO UNDISTURBED GROUND OUTSIDE ROOTBALL. REMOVE AFTER ONE YEAR. MULCH 4" DEPTH WITH DOUBLE SHREDDED HARDWOOD BARK. NATURAL IN COLOR. LEAVE 3" PLANT TREE SO ROOT FLARE IS AT OR ABOVE SURROUNDING GRADE. CIRCLE OF BARE SOIL AT BASE REMOVE ROOT BALL DIRT TO OF TREE TRUNK TO EXPOSE EXPOSE FLARE IF NECESSARY AND ROOT FLARE. CUT ANY GIRDLING ROOTS. PLANTING MIXTURE: MOUND EARTH TO FORM AMEND SOILS PER SITE CONDITIONS AND REQUIREMENTS OF THE PLANT MATERIAL. REMOVE ALL NON-BIODEGRADABLE MATERIALS COMPLETELY FROM SCARIFY PLANTING PIT SIDES. THE ROOTBALL. CUT AND REMOVE RECOMPACT BASE OF TO 4" WIRE BASKET AND BURLAP FROM 3 x width of rootball TOP HALF OF THE ROOTBALL. evergreen planting detail

annual cover: (Edge, Upland & Dry Upland Zones) NATIVESCAPE L.L.C 50% Temporary Grasses: will contain two of the following species. P.O. BOX 122 Avena sativa MANCHESTER, MICHIGAN 48158 Lolium multiflorum ph: 517.456.9696 Triticum aestivum www.nativescape.net American Slough Grass Beckmannia syzigachne 3. REMOVE ALL TAGS, STRING,

4. GUY EVERGREEN TREES ABOVE 12'

HEIGHT. STAKE EVERGEEN TREE

BELOW 12' HEIGHT.

1 Aster puniceus (Swamp Aster)

Eupatorium perfoliatum (Boneset)

Liatris spicata (Dense Blazing Star)

Lobelia cardinalis (Cardinal Flower)

1 Lobelia siphilitica (Great Blue Lobelia)

Rudbeckia hirta (Black-Eyed Susan)

Silphium integrifolium (Rosinweed)

Silphium terebinthinaceum (Prairie Dock)

Solidago patula (Swamp Goldenrod)

Solidago riddellii (Riddell's Goldenrod)

Vernonia fasciculata (Smooth Ironweed)

Veronicastrum virginicum (Culver's Root)

Silphium perfoliatum (Cupplant)

Verbena hastata (Blue Vervain)

1 Zizia aurea (Golden Alexanders)

RECOMPACT BASE OF TO 4" DEPTH.

Eupatorium maculatum (spotted Joe-Pye Weed)

Helenium autumnale (Autumn Sneezeweed)

Penstemon digitalis (Foxglove Beardtongue)

Pycnanthemum virginianum (Mountain Mint)

3 Rudbeckia fulgida speciosa (Showy Black-Eyed Susan)

Rudbeckia subtomentosa (Sweet Black-Eyed Susan)

Planting landscape notes:

I) PLANT MATERIALS TO BE INSTALLED ACCORDING TO THE

REPLACE FALLING MATERIAL WITHIN I YEAR, OR THE NEXT

HARDWOOD BARK OF 4" THICK BARK MULCH FOR TREES IN

4' DIA. CIRCLE W/3" PULLED AWAY FROM TRUNK, 3" THICK

BARK MULCH FOR SHRUBS AND 2" THICK BARK MULCH FOR

1) TREE SHALL BE INSTALLED SAME RELATIONSHIP TO FINISH

FINISH GRADE UP TO 6" ABOVE GRADE, IF DIRECTED BY LANDSCAPE ARCHITECT FOR HEAVY CLAY SOIL AREAS. 2) DO NOT PRUNE TERMINAL LEADER PRUNE ONLY DEAD OR

4) REMOVE TREE STAKES, GUY WIRES AND TREE WRAP AFTER

1) SHRUB SHALL BE INSTALLED SAME RELATIONSHIP TO FINISH

FINISH GRADE UP TO 4" ABOVE GRADE, IF DIRECTED BY LANDSCAPE ARCHITECT FOR HEAVY CLAY SOIL AREAS.

2) DO NOT PRUNE TERMINAL LEADER PRUNE ONLY DEAD OR

THAT ARE UNSLIGHTLY AND COULD CAUSE GIRDLING.

GRASS IN A SOD NURSERY ON LOAM SOIL. SOD TO BE

A MINIMUM 4" TOP SOIL ON ALL SEEDED LAWN AREA

BEN INSTALLED AND APPROVED BY THE COMMUNITY

Sedge Meadow Mix: (Edge Zone)

Sedge Meadow Mix oz/acre

Carex comosa (Bristly Sedge)

Carex cristatella (Crested Sedge)

2 Carex stipata (Awl-Fruited Sedge)

6 Carex vulpinoidea (Fox Sedge)

2 Carex hystericina (Porcupine Sedge)

2 Carex tribuloides (Pointed Oval Sedge)

64 Elymus virginicus (Virginia Wild Rye)

6 Glyceria striata (Fowl Manna Grass)

8 Leersia oryzoides (Rice Cut Grass)

Scirpus atrovirens (Dark Green Bulrush)

Alisma subcordatum (Water plantain)

Aster novae-angliae (New England Aster)

Components per acre

8 lbs grasses and sedges, 3 lbs forbes

Angelica atropurpurea (Angelica)

8 Panicum virgatum (Switchgrass)

Forbs oz/acre

6 Carex frankii (Frank's Sedge)

4 Carex lurida (Lurid Sedge)

season. Use just above the normal waterline in the

capillary zone in our Lake Edge Enhancement System.

NO CONSTRUCTION SHALL OCCUR UNTIL TREE PROTECTION HAS

detention basin seed mix:

A mix of sedges, grasses and wildflowers recommended

1 Aster umbellatus (Flat-topped Aster)

WHITE LAKE TOWNSHIP. AND CURRENT AMERICAN

3) PLANT MATERIALS TO BE OF PREMIUM QUALITY, NO. I

4) MULCH IS TO BE NATURAL COLORED, DOUBLE SHREDDED

GRADE NORTHERN NURSURY GROWN, IN HEALTHY

CONDITION, FREE OF PESTS AND DISEASES.

5) CALL MISS DIG AT 1-800-482-7171 PRIOR TO ANY

3) REMOVE ALL TAGS, STRING, PLASTICS AND OTHER MATERIALS THAT ARE UNSLIGHTLY AND COULD CAUSE

2) PLANT MATERIALS TO BE GUARANTEED FOR 2 YEARS.

ASSOCIATION OF NURSERYMEN'S STANDARDS.

APPROPRIATE PLANTING PERIOD

GENERAL NOTES:

CONSTRUCTION.

DECIDUOUS & EVERGREEN TREE:

BROKEN BRANCHES.

ONE WINTER SEASON.

BROKEN BRANCHES

AND PROPORTIONS:

SITE PLAN.

10% RED FESCUE

DEVELOPMENT DIRECTOR.

25% CHEWING FESCUE

INSTALLED ON MINIMUM 2" TOPSOIL.

5% PERENNIAL RYE GRASS

60% KENTUCKY BLUE GRASS

1. SHRUB SHALL BEAR SAME RELATION TO FINISH GRADE AS IT BORE ORIGINALLY OR SLIGHTLY HIGHER THAN FINISH GRADE UP TO 4" ABOVE GRADE, IF DIRECTED BY LANDSCAPE ARCHITECT FOR HEAVY CLAY SOIL AREAS. MULCH 4" DEPTH WITH DOUBLE SHREDDED 2. PRUNE ONLY DEAD OR BROKEN BRANCHES. HARDWOOD BARK. NATURAL IN 3. REMOVE ALL TAGS, STRING, COLOR. LEAVE 3" CIRCLE OF BARE PLASTICS AND OTHER MATERIALS SOIL AT BASE OF TREE TRUNK TO EXPOSE ROOT FLARE. MOUND EARTH TO FORM SAUCER REMOVE COLLAR OF ALL FIBER 4 POTS. POTS SHALL BE CUT TO PROVIDE FOR ROOT GROWTH. REMOVE ALL NONORGANIC CONTAINERS COMPLETELY. SCARIFY PLANTING PITSIDES.

PLANTING MIXTURE: AMEND SOILS PER SITE CONDITIONS AND REQUIREMENTS OF THE PLANT MATERIAL. SHRUBS PLANTED IN BEDS SHALL HAVE ENTIRE BED MASS EXCAVATED AND BACKFILLED WITH APPROVED PLANT MIX. PLANTS SHALL NOT BE INSTALLED IN INDIVIDUAL HOLES. REMOVE ALL NON-BIODEGRADABLE MATERIALS COMPLETELY FROM THE ROOTBALL. CUT AND REMOVE WIRE BASKET AND BURLAP FROM TOP HALF OF THE ROOTBALL shrub planting detail

IRRGATION) sod & seeding area reference location map 2"-3' WIDE BELT-LIKE - NYLON OR PLASTIC STRAPS STAKE TREES - JUST BELOW

RECEIVE SEED MIX AND STRAW BLANKET ON 4" TOP AREA TO RECEIVE SOIL (WITH IRRIGATION) OPEN SPACE AREAS DETENTION POND TO RECEIVE SEED SEED MIX (NO MIX AND STRAW IRRIGATION) BLANKET ON 4" TOP SOIL (WITH IRRIGATION) AREAS TO RECEIVE IRRIGATION & SOD GRADE AS IT BORE ORIGINALLY OR SLIGHTLY HIGHER THAN GRADE AS IT BORE ORIGINALLY OR SLIGHTLY HIGHER THAN 3) REMOVE ALL TAGS, STRING, PLASTICS AND OTHER MATERIALS 1) SOD LAWN AREAS SHALL BE KENTUCKY BLUE GRASS BLEND AREAS TO RECEIVE 2) SEEDED LAWN AREAS SHALL CONSIST OF THE FOLLOWING TYPES IRRIGATION & SOD OPEN SPACE AREAS TO RECEIVE SEED MIX AND STRAW BLANKET ON 4" TOP SOIL. (WITH SEED MIX SHALL BE APPLIED AT A RATE OF 200 POUNDS PER ACRE AND WEED CONTENT SHALL NOT EXCEED 1%. SEED. PROVIDE TREES IDENTIFIED FOR PROTECTION DURING CONSTRUCTION AND THE MEANS OF PROTECTION SHALL BE IDENTIFIED PRIOR TO FINAL

OPEN SPACE AREAS TO



sod & seeding hatch pattern legend

AREAS TO RECEIVE IRRIGATION AND SOD, MAINTAINED AND MOWED WEEKLY

SCALE: 1"= 100'-0"

AREAS TO RECEIVE IRRIGATION AND HYDROSEED, MAINTAINED AND MOWED WEEKLY

AREAS TO RECEIVE DETENTION


AND LAWN AREAS.

POND SEED MIX ALL REQUIRED SITE IRRIGATION SYSTEMS SHALL INCLUDE A RAIN

SENSOR OR SIMILAR MEASURE TO ENSURE IRRIGATION DUES NOT OCCUR DURING OR SHORTLY AFTER PRECIPITATION EVENTS. ALL REQUIRED LANDSCAPE AREAS IN EXCESS OF 200

MAINTAINING A HEALTHY CONDITION FOR ALL PLANTINGS

SQUARE FEET SHALL BE IRRIGATED TO ASSIST IN

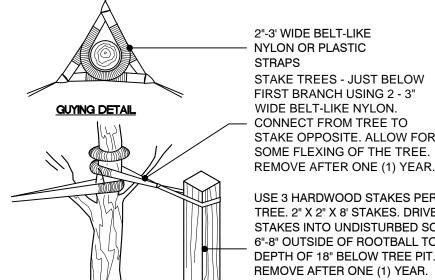

STAKING DETAIL


USE 3 HARDWOOD STAKES PER TREE. 2" X 2" X 8' STAKES. DRIVE STAKES INTO UNDISTURBED SOIL 6"-8" OUTSIDE OF ROOTBALL TO A DEPTH OF 18" BELOW TREE PIT. REMOVE AFTER ONE (1) YEAR. DO NOT USE WIRE OR ROPE THRU

Orient staking/guying to prevailing winds, except on slopes greater than 3:1 orient to

Use same staking/guying orientation for all plants within each grouping or area.

tree staking detail

STAKING/GUYING LOCATION

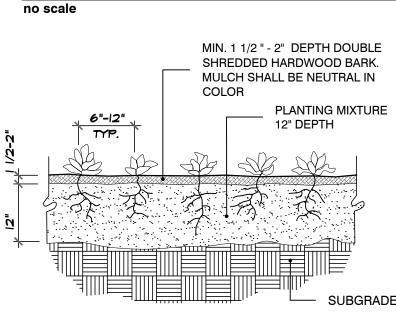

perennial planting detail



registered Landscape Architect Farmington Hills, MI 48336 ph. (248) 557-5588 fax. (248) 557-5416

seal:

JMF WHITE LAKE, LLC. 1700 W. BIG BEAVER ROAD SUITE 120

TROY, MI 48084

project:

LAKE POINTE

project location: White Lake Twp. Michigan

Union Lake Road

sheet title: PLANT MATERIAL LIST AND PLANT **DETAILS**

inh na liceus /ravicion data

JOD 110./188	ue/Tev.	ision date.
LS19.124.11	TWP.	11-12-2019
LS19.124.12	TWP.	12-27-2019
LS20.089.10	TWP.	10-14-2020
LS21.009.01	SPA	1-18-2021
LS21.009.01	SPA	2-02-2021
LS21.009.03	SPA	3-22-2021
LS23.081.08	ENG. UPDATI	ED 8-1-2023
LS23.081.12	TWP COMME	NTS 12-3-2023
LS24.026.02	TWP COMME	NTS 2-7-2024

JP, DK

checked by:

1-30-2024 notice:

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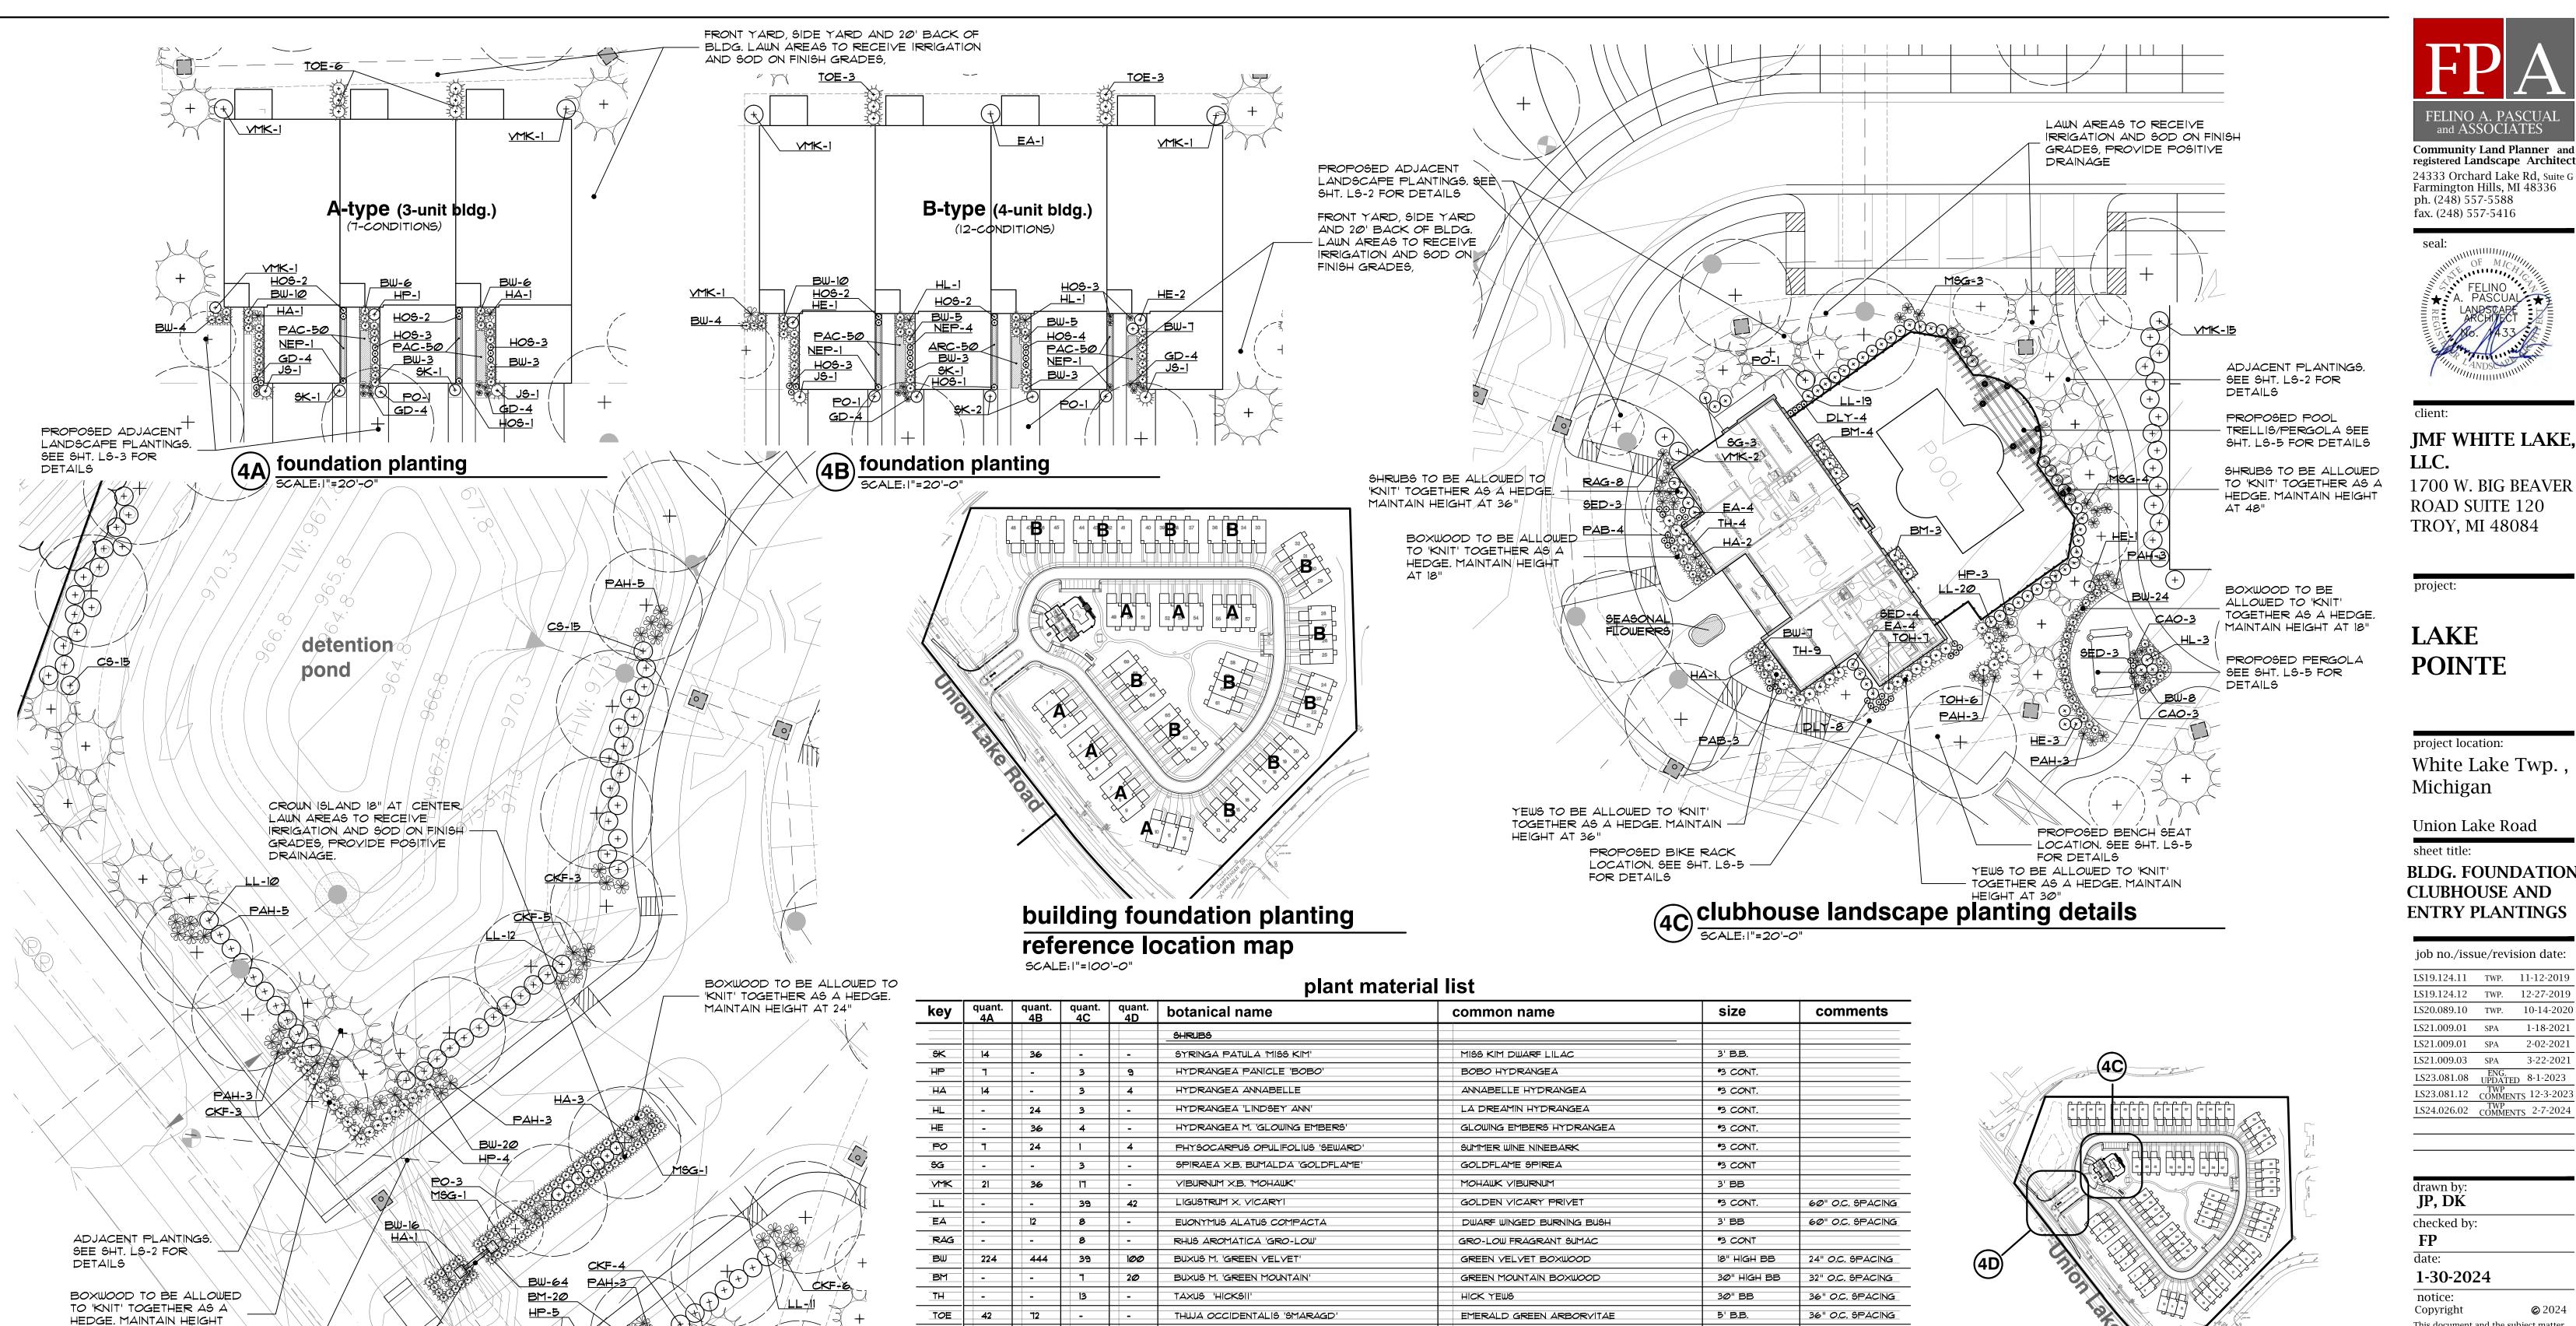


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project no: LS24.026.02

of construction

sheet no:



THUJA OCCIDENTALIS 'HELTZ'

CORNUS STOLONIFERA

JUNIPERUS SKYROCKET

GERANIUM X. 'ROZANNE'

SEDUM X. 'NEON'

HOSTA 'PATRIOT'

PERENNIALS AND GRASSES

PACHYSANDRA TERMINALIS

HEMEROCALLIS 'HAPPY RETURNS'

AJUGA REPTAN 'CATLIN'S GAINT'

PENNISETUM ALOPECUROIDES 'HAMELN'

CALAMAGROSTIS X.A. 'KARL FOERSTER'

MISCANTHUS SINENSIS 'MORNING LIGHT'

PENNISETUM ALOPECUROIDES 'LITTLE BUNNY

CALAMAGROSTIS X. ACUTIFLORA 'KARL FOERSTER

NEPETA X FAASSENII 'WALKER'S LOW'

JS

NEP

GD

PAC

DLY

SED

HOS

PAH

CKF

ARC

MSG

PAB

CAO

700

24

1200

180

600

#3 CONT

#3 CONT

5' BB

#1 CONT.

32 / FLAT

32 / FLAT

#1 CONT.

#1 CONT.

#1 CONT.

*3 CONT.

#3 CONT.

32 / FLAT

#3 CONT.

*3 CONT.

*3 CONT.

HELTZ ARBORVITAE

REDTWIG DOGWOOD

SKYROCKET JUNIPER

WALKER'S LOW NEPETA

JAPANESE PACHYSANDRA

HAPPY RETURNS DAYLILY

DWARF FOUNTAIN GRASS

LITTLE BUNNY FOUNTAIN GRASS

CATLINS GAINT AJUGA

KARL FOERSTER FEATHER REED GRASS

MORNING LIGHT JAPANESE SILVER GRASS

KARL FOERSTER'S FEATHER REED GRASS

ROZANNE GERANIUM

NEON SEDUM

PATRIOT HOSTA

36" O.C. SPACING

60" O.C. SPACING

60" O.C. SPACING

24" O.C. SPACING

12" O.C. SPACING

12" O.C. SPACING

24" O.C. SPACING

12" O.C. SPACING

24" O.C. SPACING

36" O.C. SPACING

36" O.C. SPACING

12" O.C. SPACING

36" O.C. SPACING

36" O.C. SPACING

reference location map

NO SCALE

AT 30"

PROPOSED SIGN MONUMENT

LAWN AREAS TO RECEIVE

PLANS FOR GRADES.

SCALE:1"=20'-0"

IRRIGATION & SOD ON FINISH

GRADES. PROVIDE POSITIVE

foundation planting

DRAINAGE. SEE ENGINEERING

PAH-3

LOCATION. SEE SHT. LS-5

FOR DETAILS



JMF WHITE LAKE,

1700 W. BIG BEAVER ROAD SUITE 120 TROY, MI 48084

project location: White Lake Twp.

Union Lake Road

BLDG. FOUNDATION, **CLUBHOUSE AND ENTRY PLANTINGS**

_		

job no./issue/revision date:		
LS19.124.11	TWP.	11-12-2019
LS19.124.12	TWP.	12-27-2019
LS20.089.10	TWP.	10-14-2020
LS21.009.01	SPA	1-18-2021
LS21.009.01	SPA	2-02-2021
LS21.009.03	SPA	3-22-2021
LS23.081.08	ENG. UPDATE	D 8-1-2023

LS24.026.02 TWP COMMENTS 2-7-2024

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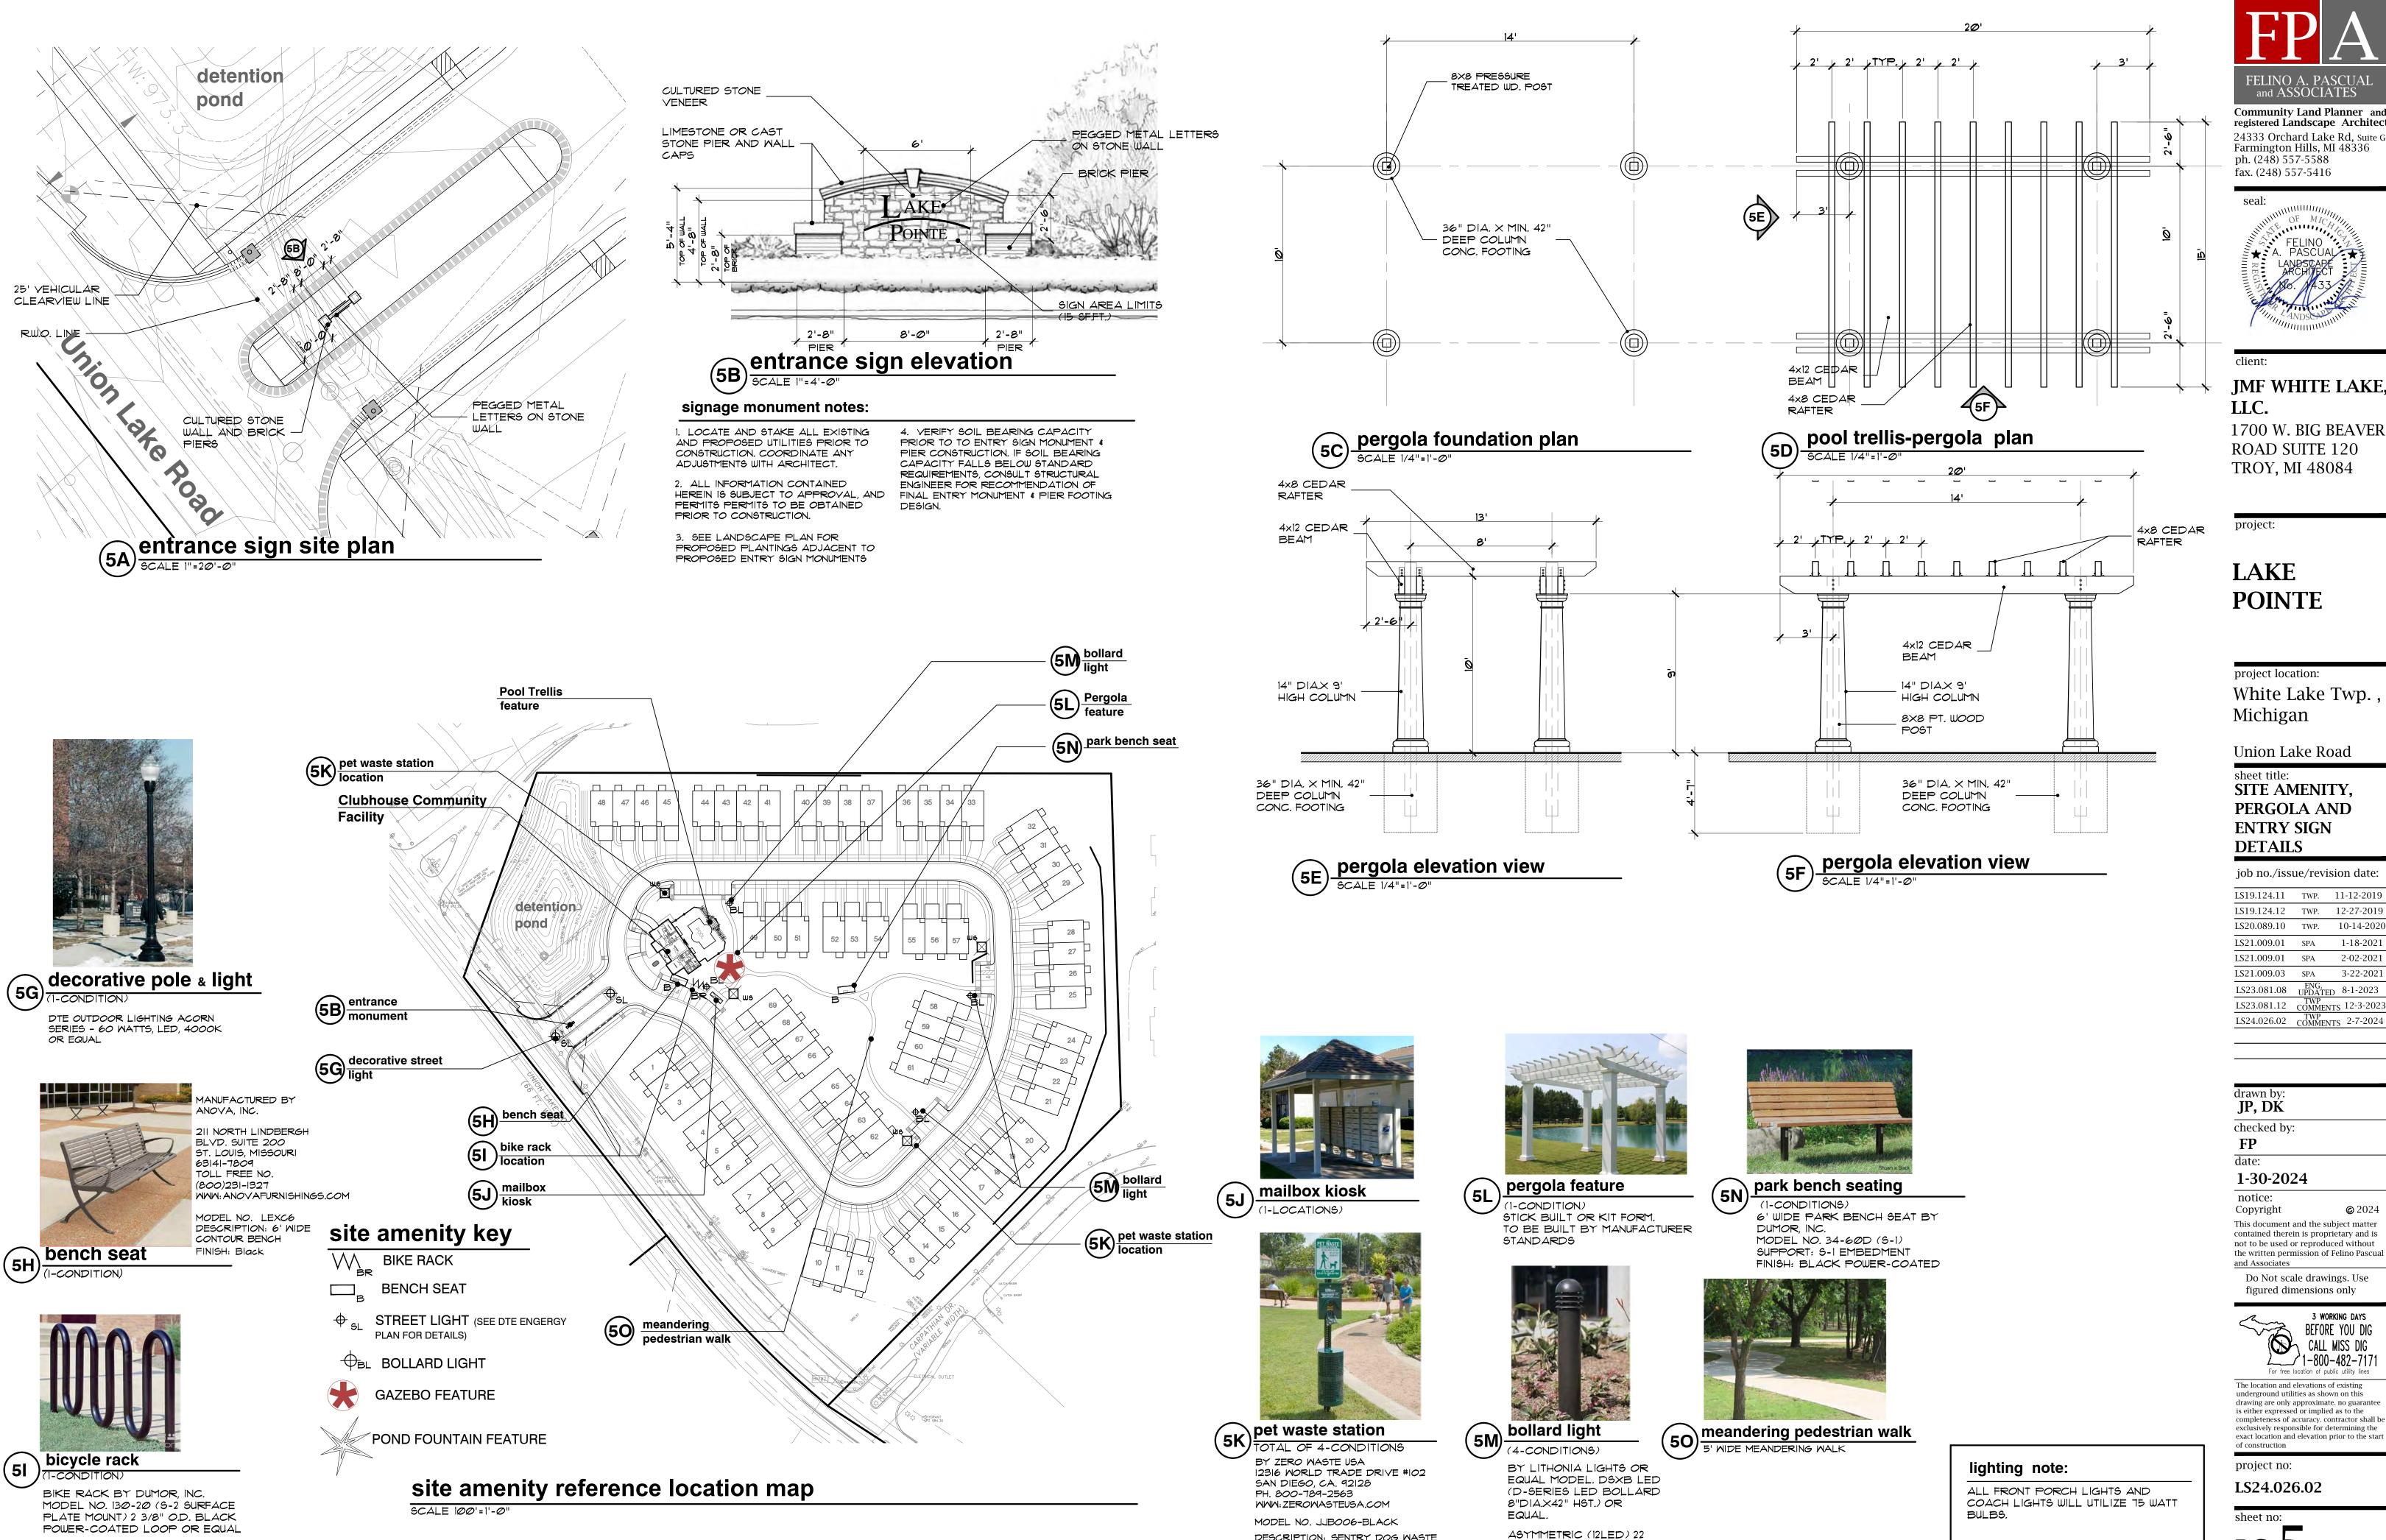


exclusively responsible for determining the exact location and elevation prior to the start

project no:

LS24.026.02

sheet no:



DESCRIPTION: SENTRY DOG WASTE

STATION (73"H X 13"W) FINISH: BLACK

WATTS, 4000K

FELINO A. PASCUAL and ASSOCIATES Community Land Planner and registered Landscape Architect 24333 Orchard Lake Rd, Suite G Farmington Hills, MI 48336 ph. (248) 557-5588

client:

JMF WHITE LAKE, LLC.

1700 W. BIG BEAVER ROAD SUITE 120 TROY, MI 48084

project:

LAKE POINTE

project location: White Lake Twp. Michigan

Union Lake Road

sheet title: SITE AMENITY, PERGOLA AND **ENTRY SIGN DETAILS**

job no./issue/revision date:

LS19.124.11 TWP. 11-12-2019 LS19.124.12 TWP. 12-27-2019 LS20.089.10 TWP. 10-14-2020 LS21.009.01 SPA 1-18-2021 LS21.009.01 SPA 2-02-2021 LS21.009.03 SPA 3-22-2021 LS23.081.08 UPDATED 8-1-2023 LS23.081.12 COMMENTS 12-3-2023

JP, DK checked by:

date:

1-30-2024

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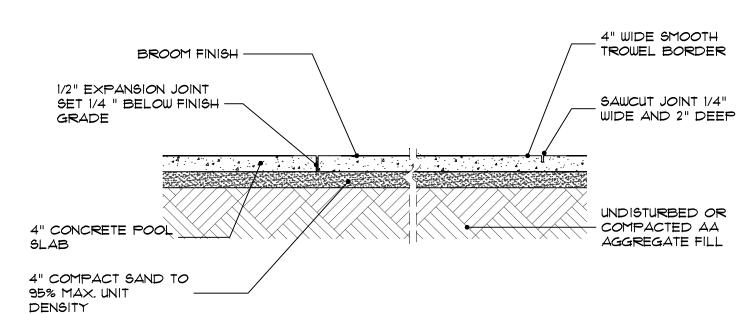
project no:

LS24.026.02


sheet no: **LS-5** of 7

swimming pool notes


- 1. THIS DRAWING ONLY PROVIDES THE LOCATION AND SHAPE OF THE PROPOSED SWIMMING POOL, DECK, AND / OR SPA. ALL STRUCTURAL AND ELECTRICAL REQUIREMENTS, CONSTRUCTION DETAILS, MATERIAL DETAILS, FINAL POOL FENCE LOCATION, AND OTHER RELATED INFORMATION ARE THE RESPONSIBILITY OF THE DESIGN BUILD FIRM OR CONTRACTOR.
- 2. THE DESIGN BUILD FIRM / CONTRACTOR SHALL PREPARE DETAILED PLANS, DRAWINGS AND SPECIFICATIONS TO BE SUBMITTED TO THE OWNER FOR REVIEW AND APPROVAL. THE DESIGN BUILD FIRM / POOL CONTRACTOR SHALL BE RESPONSIBLE TO MAKE APPLICATION TO AND OBTAIN POOL CONSTRUCTION PERMITS AND APPROVALS FROM LOCAL GOVERNING MUNICIPALITIES AND THE STATE.
- 3. CONSTRUCTION SUPERVISION AND SITE SAFETY SHALL BE THE FULL RESPONSIBILITY OF THE CONTRACTOR AND SHALL MEET ALL MUNICIPAL AND STATE REQUIREMENTS AND REGULATIONS.
- THIS DRAWING IS NOT FOR CONSTRUCTION PURPOSES, SEE ABOVE.
- 4. POOL DECK TO PITCH AWAY FROM POOL AND WALLS WITH NO PUDDLING TO OCCUR




6A concrete pool deck

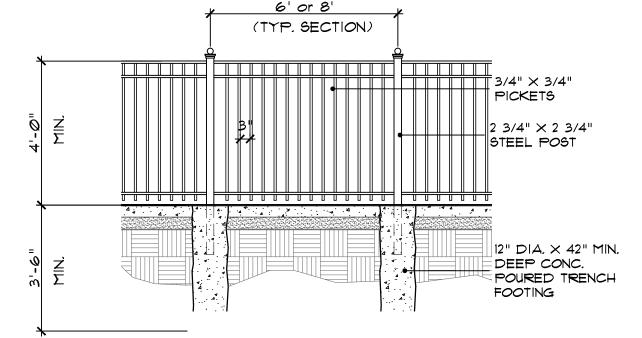

pool fence detail

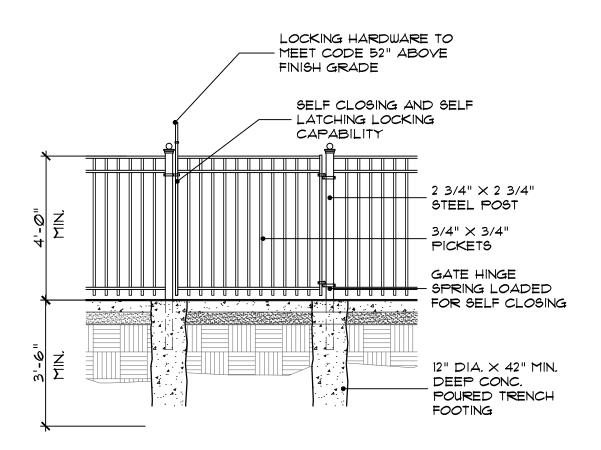

pool fence gate detail

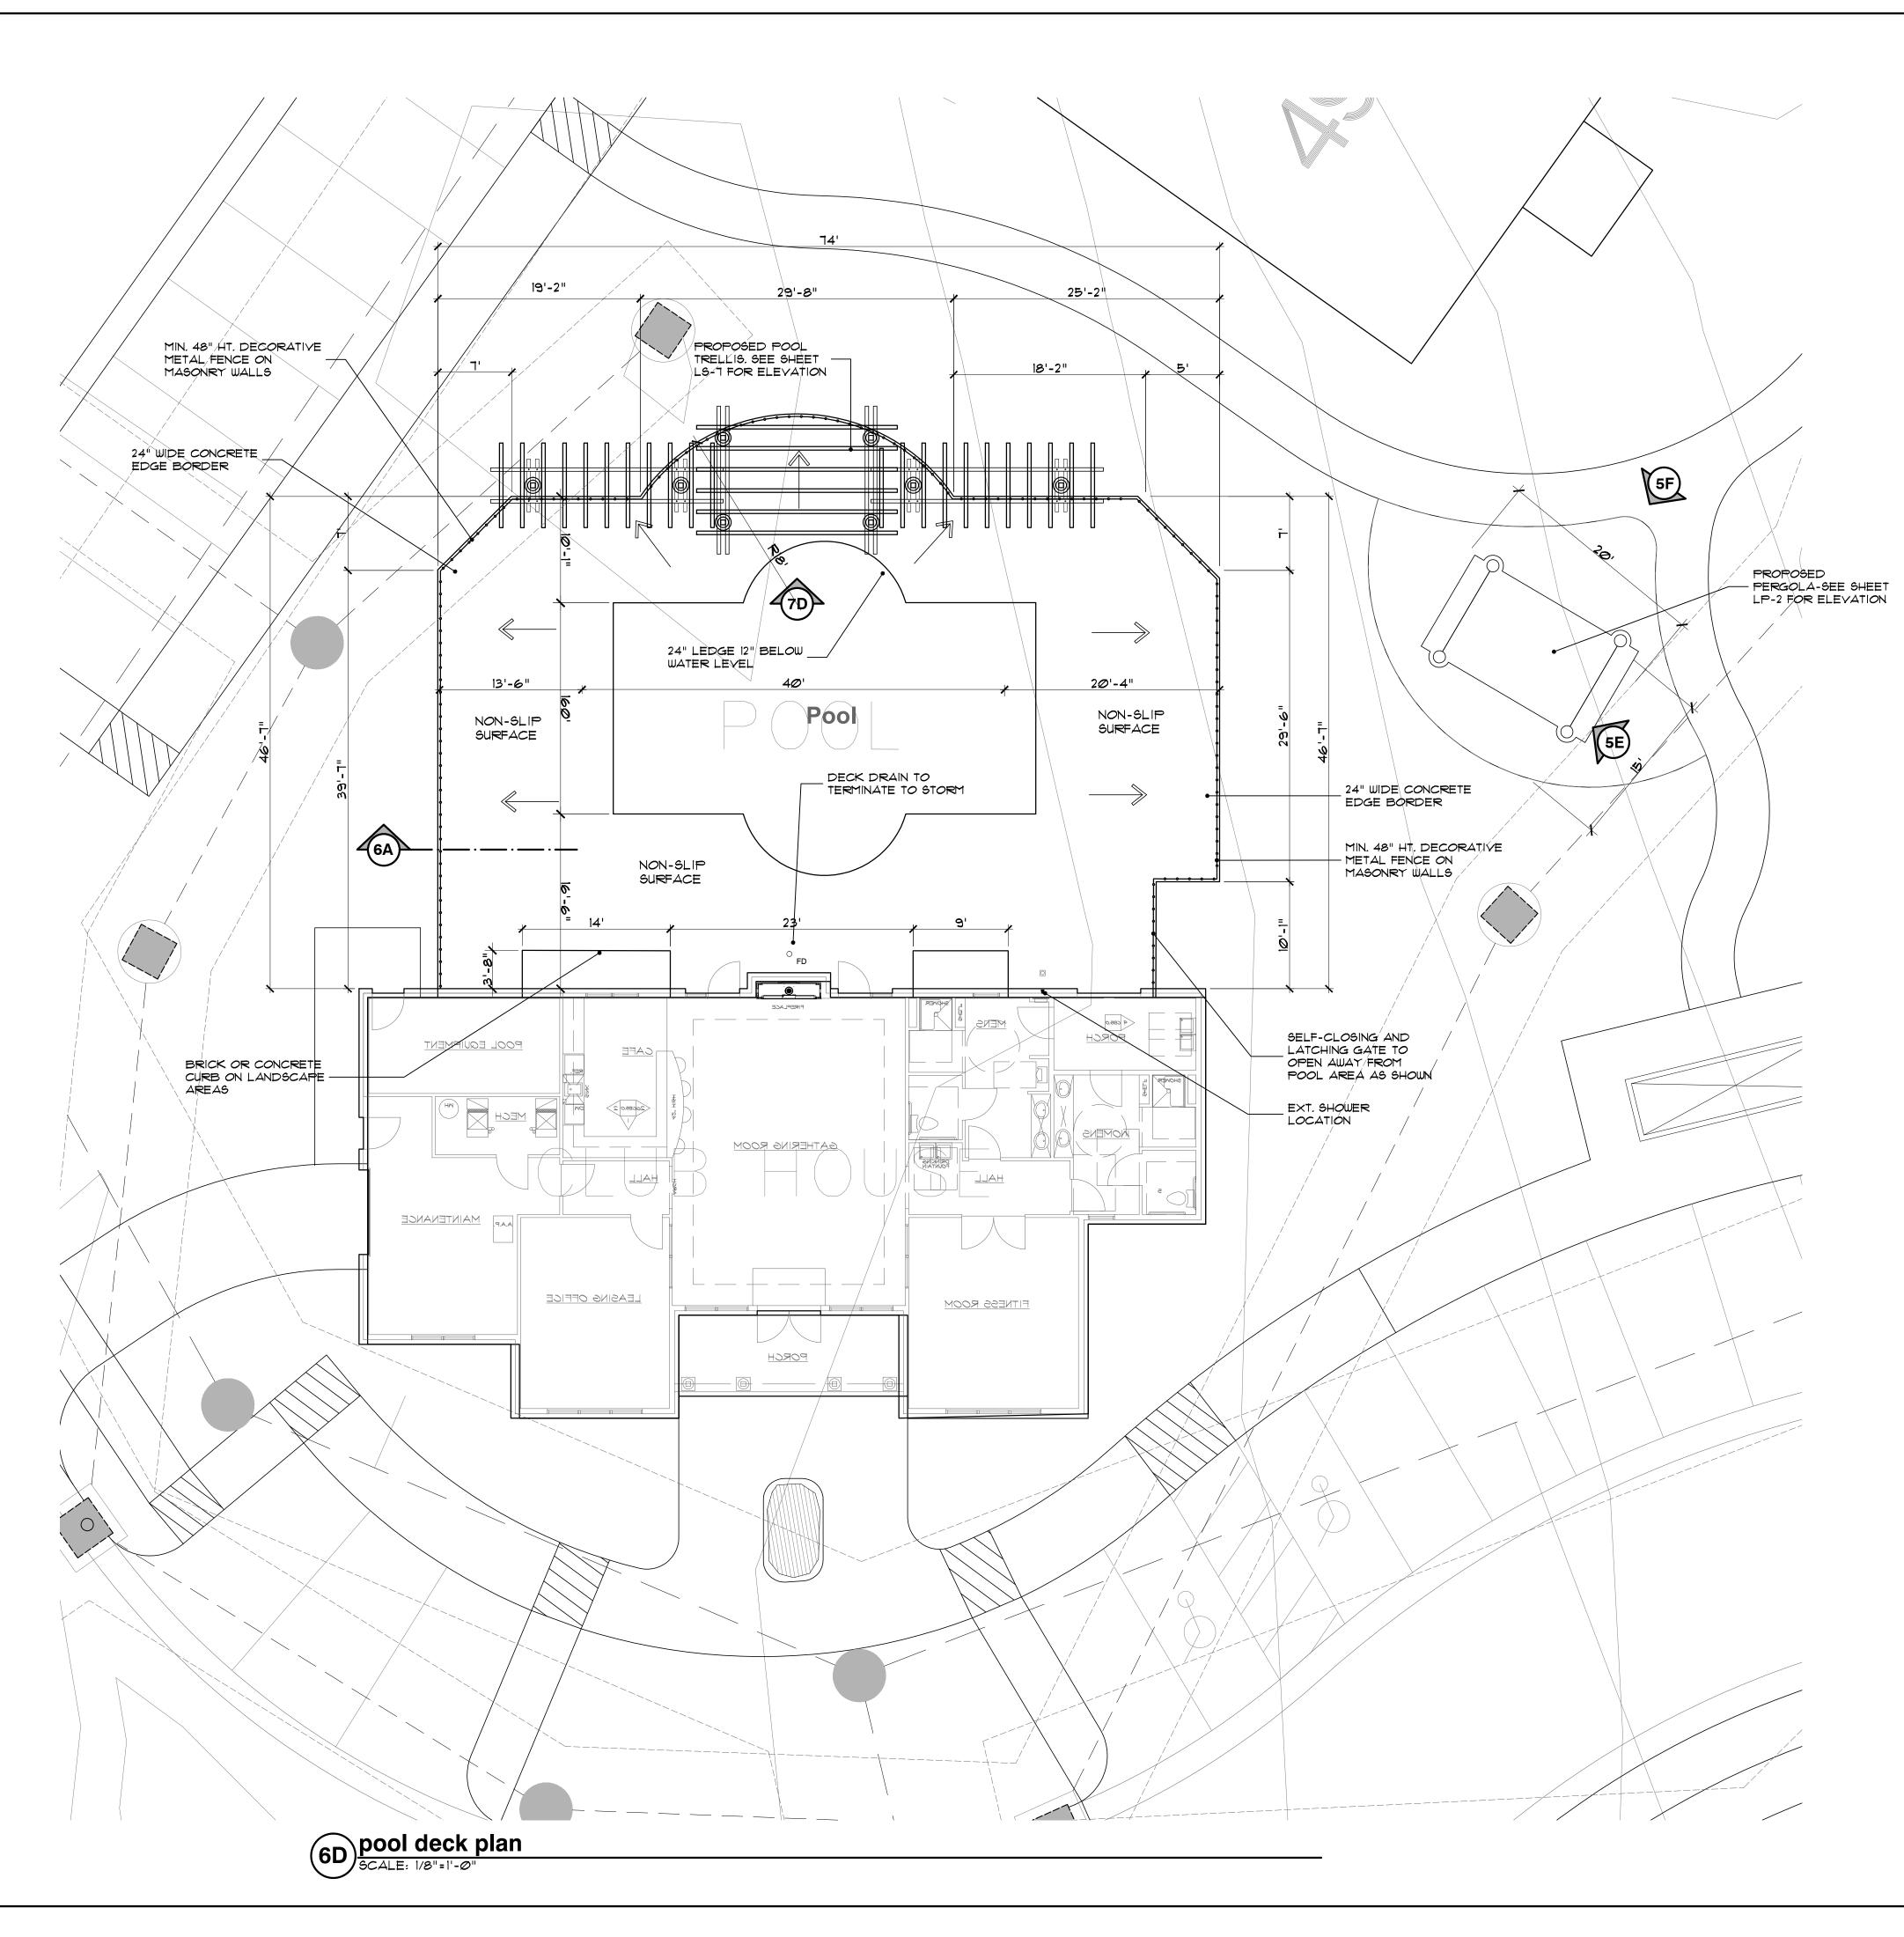



seal:

FELINO

A. PASCUAL

LANDSCAPE

ARCHITECT

ARCHIT

ph. (248) 557-5588

client:

JMF WHITE LAKE, LLC.

1700 W. BIG BEAVER ROAD SUITE 120 TROY, MI 48084

project:

LAKE POINTE

project location:
White Lake Twp.,
Michigan

Union Lake Road sheet title:

POOL DECK PLAN

job no./issue/revision date:

Job 2101, 200	010, 10.10	2011 0101101
LS19.124.11	TWP.	11-12-2019
LS19.124.12	TWP.	12-27-2019
LS20.089.10	TWP.	10-14-2020
LS21.009.01	SPA	1-18-2021
LS21.009.01	SPA	2-02-2021
LS21.009.03	SPA	3-22-2021
LS23.081.08	ENG. UPDATED	8-1-2023
LS23.081.12	TWP COMMEN	_{ΓS} 12-3-2023

LS24.026.02 TWP COMMENTS 2-7-2024

JP, DK checked by:

FP date:

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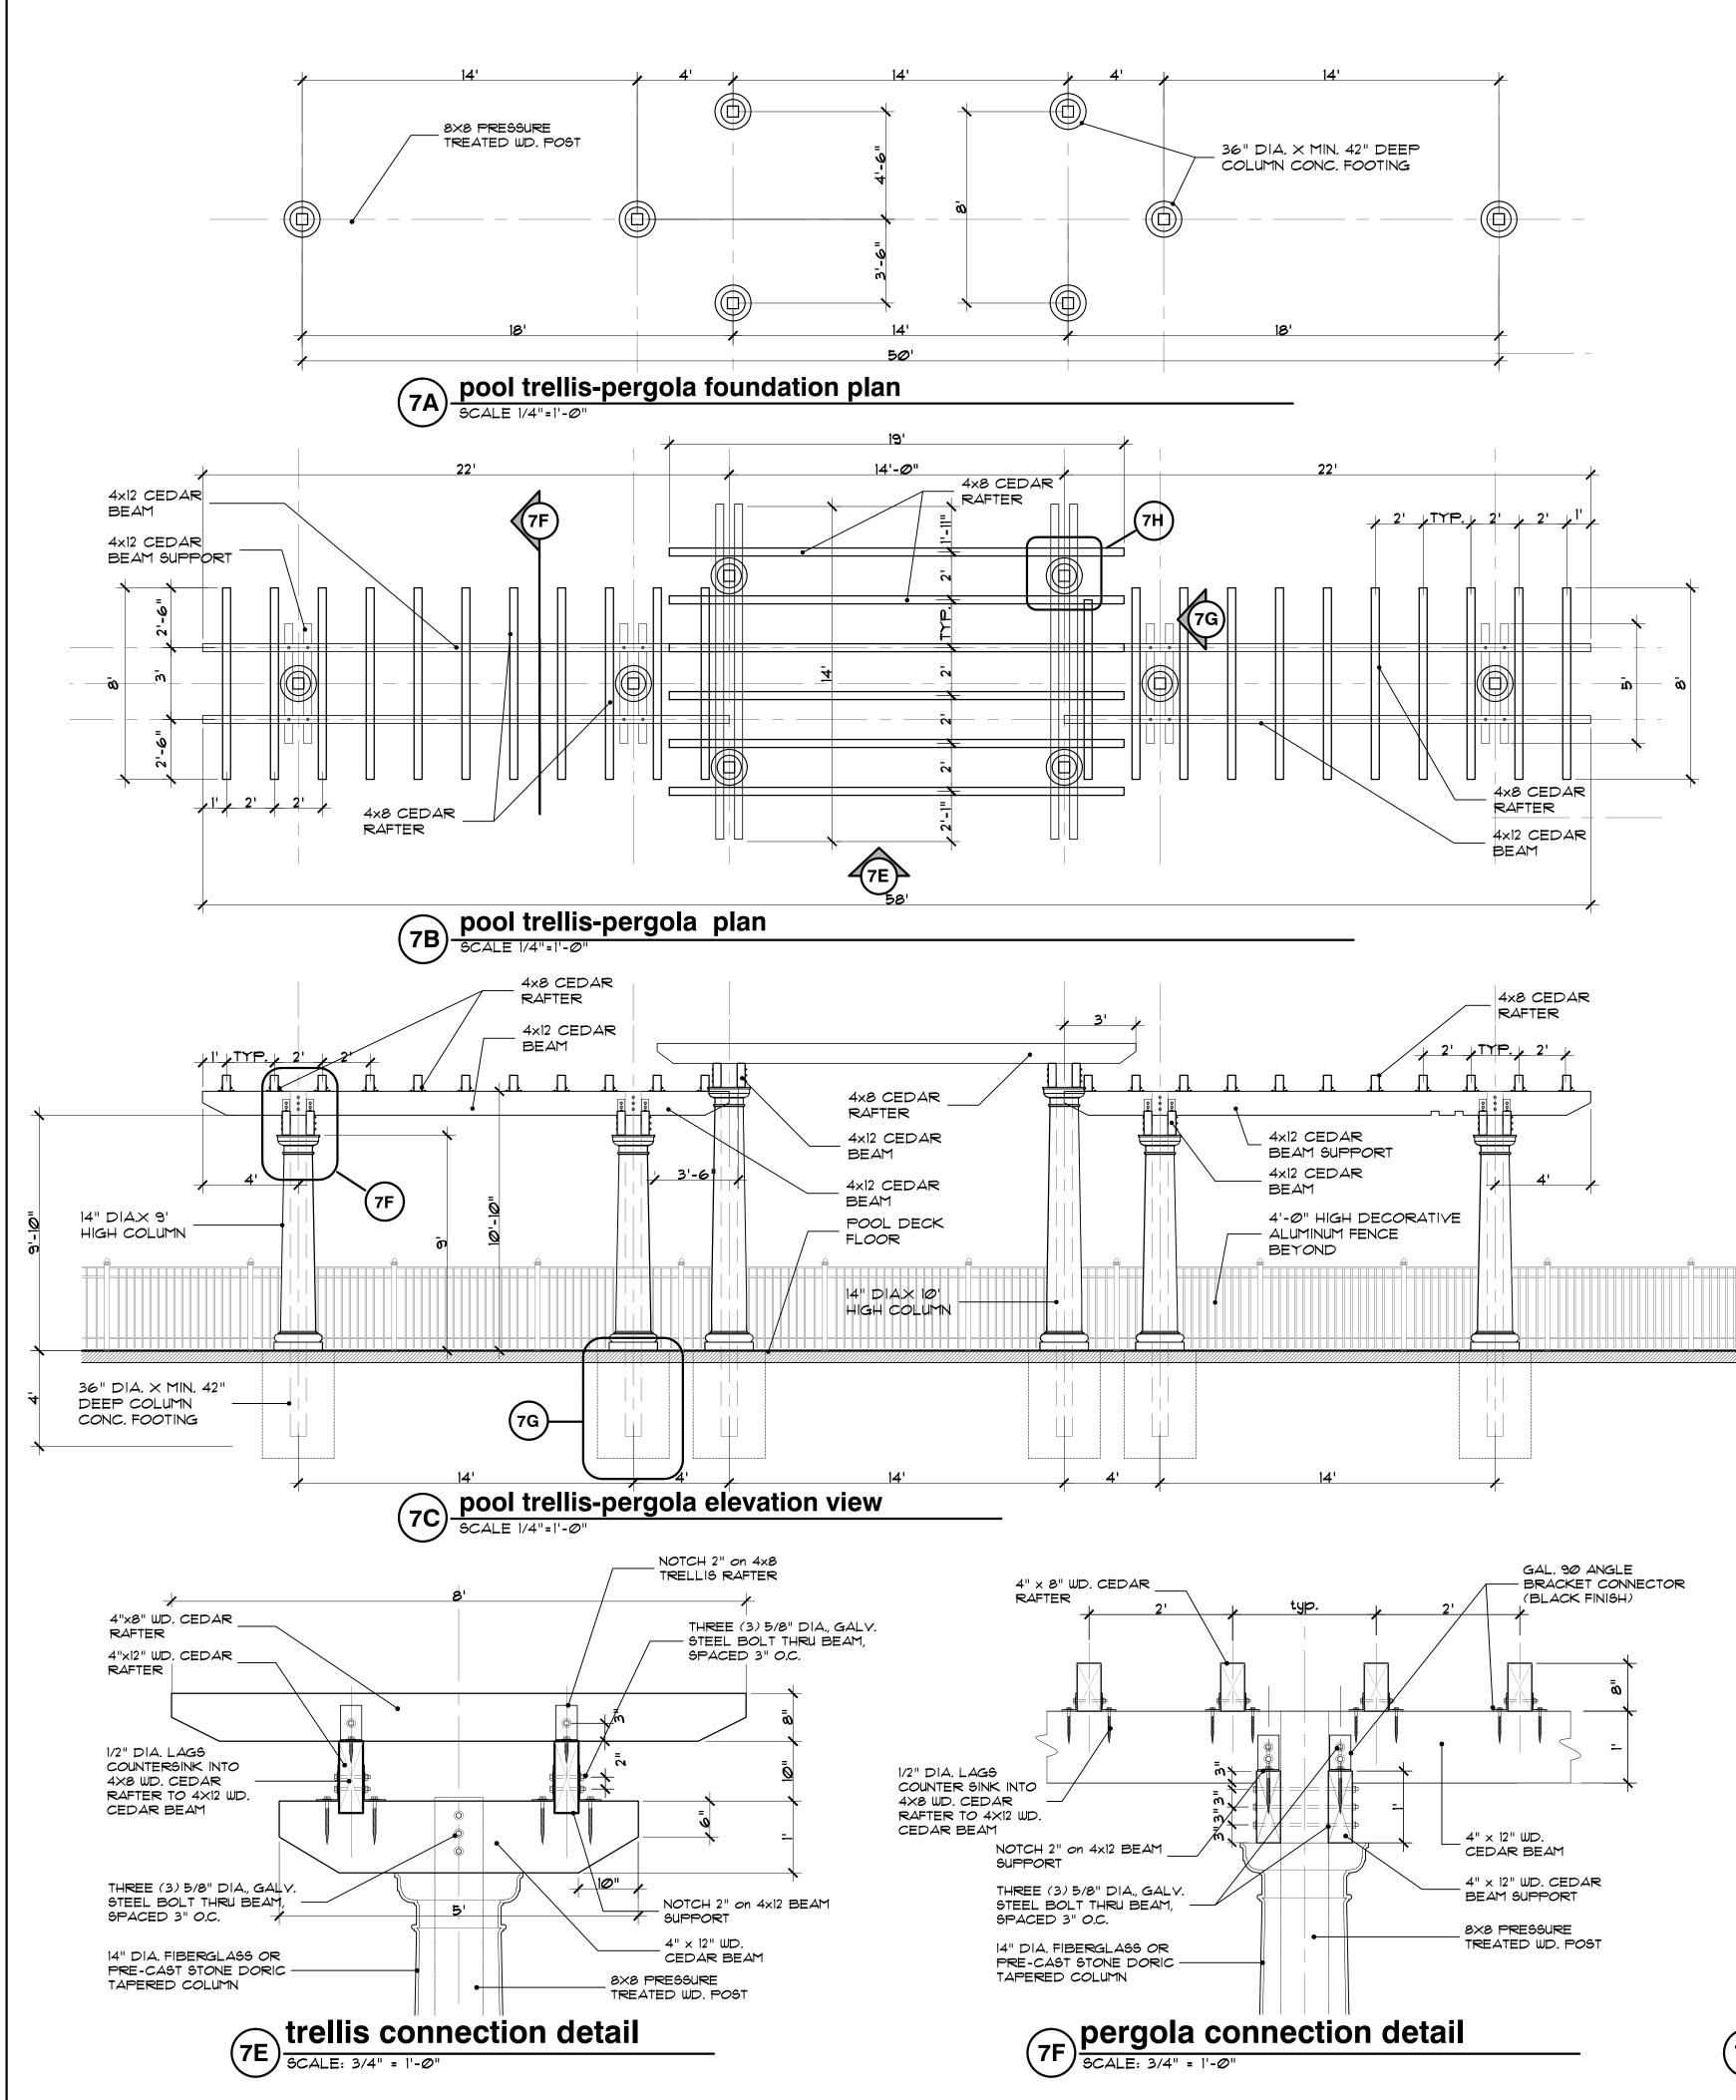


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project no:

LS24.026.02

sheet no:
LS-6 of 7



general notes:

ALL INFORMATION CONTAINED HEREIN IS SUBJECT TO APPROVAL, AND PERMITS TO BE OBTAINED PRIOR TO CONSTRUCTION FROM ALL NECESSARY AGENCIES.

2. CONTRACTOR SHALL VISIT THE SITE, INSPECT EXISTING CONDITIONS, REVIEW PROPOSED PLANS AND RELATED WORK. CONTACT THE OWNER WITH ANY CONCERNS OR DISCREPANCY BETWEEN THE PLANS AND/OR SITE CONDITIONS.

3. PRIOR TO BEGINNING OF CONSTRUCTION ON ANY WORK, CONTRACTORS SHALL YERIFY LOCATIONS OF ALL ON SITE UTILITIES. GAS, ELECTRIC, TELEPHONE, CABLE ANY DAMAGE OR INTERRUPTION OF SERVICES SHALL BE THE RESPONSIBILITY OF THE CONTRACTOR. COORDINATE ALL RELATED WORK ACTIVITIES WITH OTHER TRADES AND REPORT ANY UNACCEPTABLE JOB CONDITIONS TO OWNER PRIOR TO COMMENCING. CONTACT MISS DIG AT 811 OR 800 -482-7171 BEFORE YOU DIG

4. DO NOT SCALE DRAWING. USE FIGURED DIMENSIONS ONLY

5. VERIFY SOIL BEARING CAPACITY PRIOR TO ANY POST FOOTING CONSTRUCTION. IF SOIL BEARING CAPACITY FALLS BELOW STANDARD REQUIREMENTS, CONSULT STRUCTURAL ENGINEER FOR RECOMMENDATION OF FINAL POST FOOTING DESIGN.

6. ALL EXPOSED SAW CUT AREAS OF CEDAR WOOD LUMBER TO BE SEALED WITH WOOD PRESERVATIVE AS REQUIRED INCLUDING TRIMMED ENDS PER DRAWINGS.

1. ALL BRACKETS, FASTNERS, COMPOSITE SCREWS, NAILS, BOLTS, SHALL BE GALVANIZED OR ZINC COATED WITH ACQ AND CBA RATED FORMULATIONS.

8. GRADES BY OTHERS, FINAL GRADES TO PROVIDE POSITIVE DRAINAGE

9. CONSTRUCTION SUPERVISION AND SITE SAFETY SHALL BE THE FULL RESPONSIBILITY OF THE CONTRACTOR AND SHALL MEET ALL MUNICIPAL AND STATE REQUIREMENTS AND REGULATIONS.


10. FOOTINGS SHALL BEAR ON FIRM, UNDISTURBED SOIL WITH AN ASSUMED SAFE BEARING CAPACITY OF 2000 P.S.I. IF SOIL OF THIS CAPACITY IS NOT FOUND AT THE ELEVATIONS INDICATED, FOOTINGS SHALL BE ENLARGED OR LOWERED AT THE DIRECTION OF THE STRUCTURAL ENGINEER VERIFY FOUNDATION SOIL BEARING PRESSURE IN FIELD BY SOILS ENGINEER.

II. PROVIDE NECESSARY SHEETING SHORING BRACING, ETC. AS REQUIRED DURING EXCAVATIONS TO PROTECT SIDES OF EXCAVATIONS.


12. MINIMUM CONCRETE STRENGTH TO BE 3000 P.S.I. @ 28 DAYS, U.O.N.± SLABS SHALL BE 3500 P.S.I. MIN. U.O.N. EXPOSED CONCRETE SHALL BE 4000 P.S.I. WITH 6% ± 1% ENTRAINED AIR U.O.N.

13. ALL CONCRETE WORK AND PLACEMENT SHALL CONFORM TO THE LATEST RECOMMENDATIONS OF A.C.I.


14. PROVIDE MINIMUM 3" CONCRETE COVER FOR REINFORCEMENT BARS BELOW GRADE AND MINIMUM 2" CONCRETE COVER FOR REINFORCEMENT BARS ABOVE GRADE.

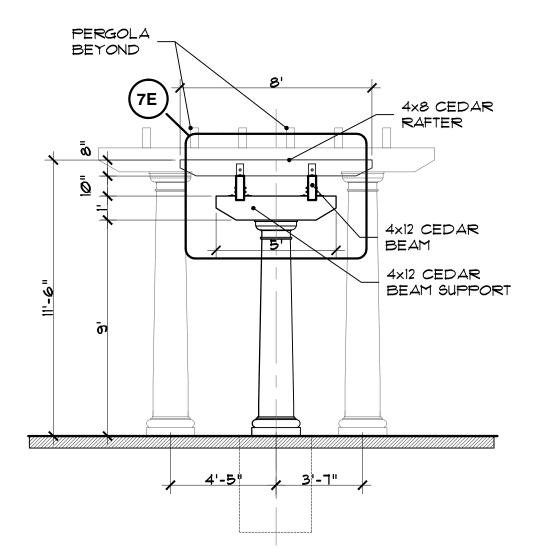

7D pool trellis-pergola elevation view

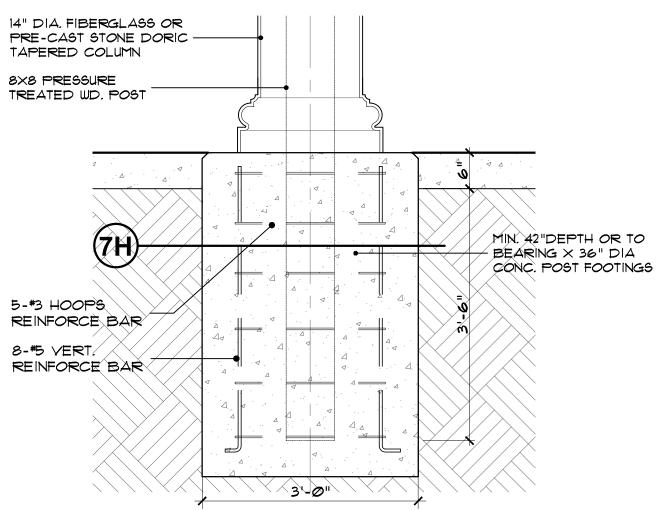


pergola footing detail

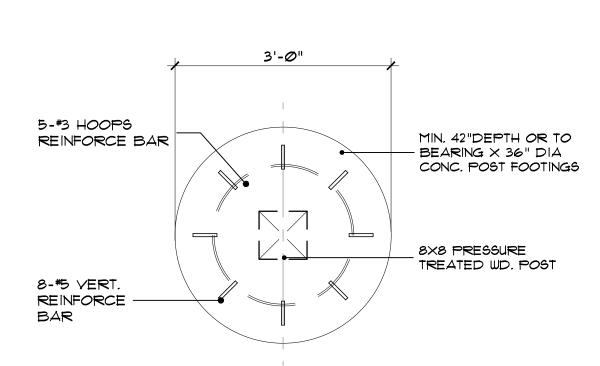

pergola footing detail

FELINO A. PASCUA and ASSOCIATES Community Land Planner and registered Landscape Architect 24333 Orchard Lake Rd, Suite G Farmington Hills, MI 48336 ph. (248) 557-5588

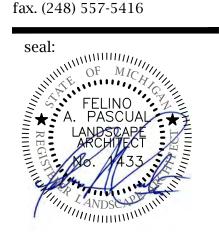

JMF WHITE LAKE, LLC. 1700 W. BIG BEAVER

ROAD SUITE 120 TROY, MI 48084

project:

LAKE POINTE

project location: White Lake Twp. Michigan

Union Lake Road

sheet title:

POOL PERGOLA \TRELLIS ELEVATIONS & DETAILS

job no./issue/revision date:

LS19.124.11	TWP.	11-12-2019
LS19.124.12	TWP.	12-27-2019
LS20.089.10	TWP.	10-14-2020
LS21.009.01	SPA	1-18-2021
LS21.009.01	SPA	2-02-2021
LS21.009.03	SPA	3-22-2021
LS23.081.08	ENG. UPDATED	8-1-2023

LS23.081.12 TWP COMMENTS 12-3-2023 LS24.026.02 TWP COMMENTS 2-7-2024

drawn by: JP, DK

checked by:

and Associates

date: 1-30-2024

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> Do Not scale drawings. Use figured dimensions only



The location and elevations of existing underground utilities as shown on this drawing are only approximate. no guarante is either expressed or implied as to the completeness of accuracy. contractor shall be exclusively responsible for determining the exact location and elevation prior to the start


project no:

of construction

LS24.026.02

sheet no:

LS-7 of 7

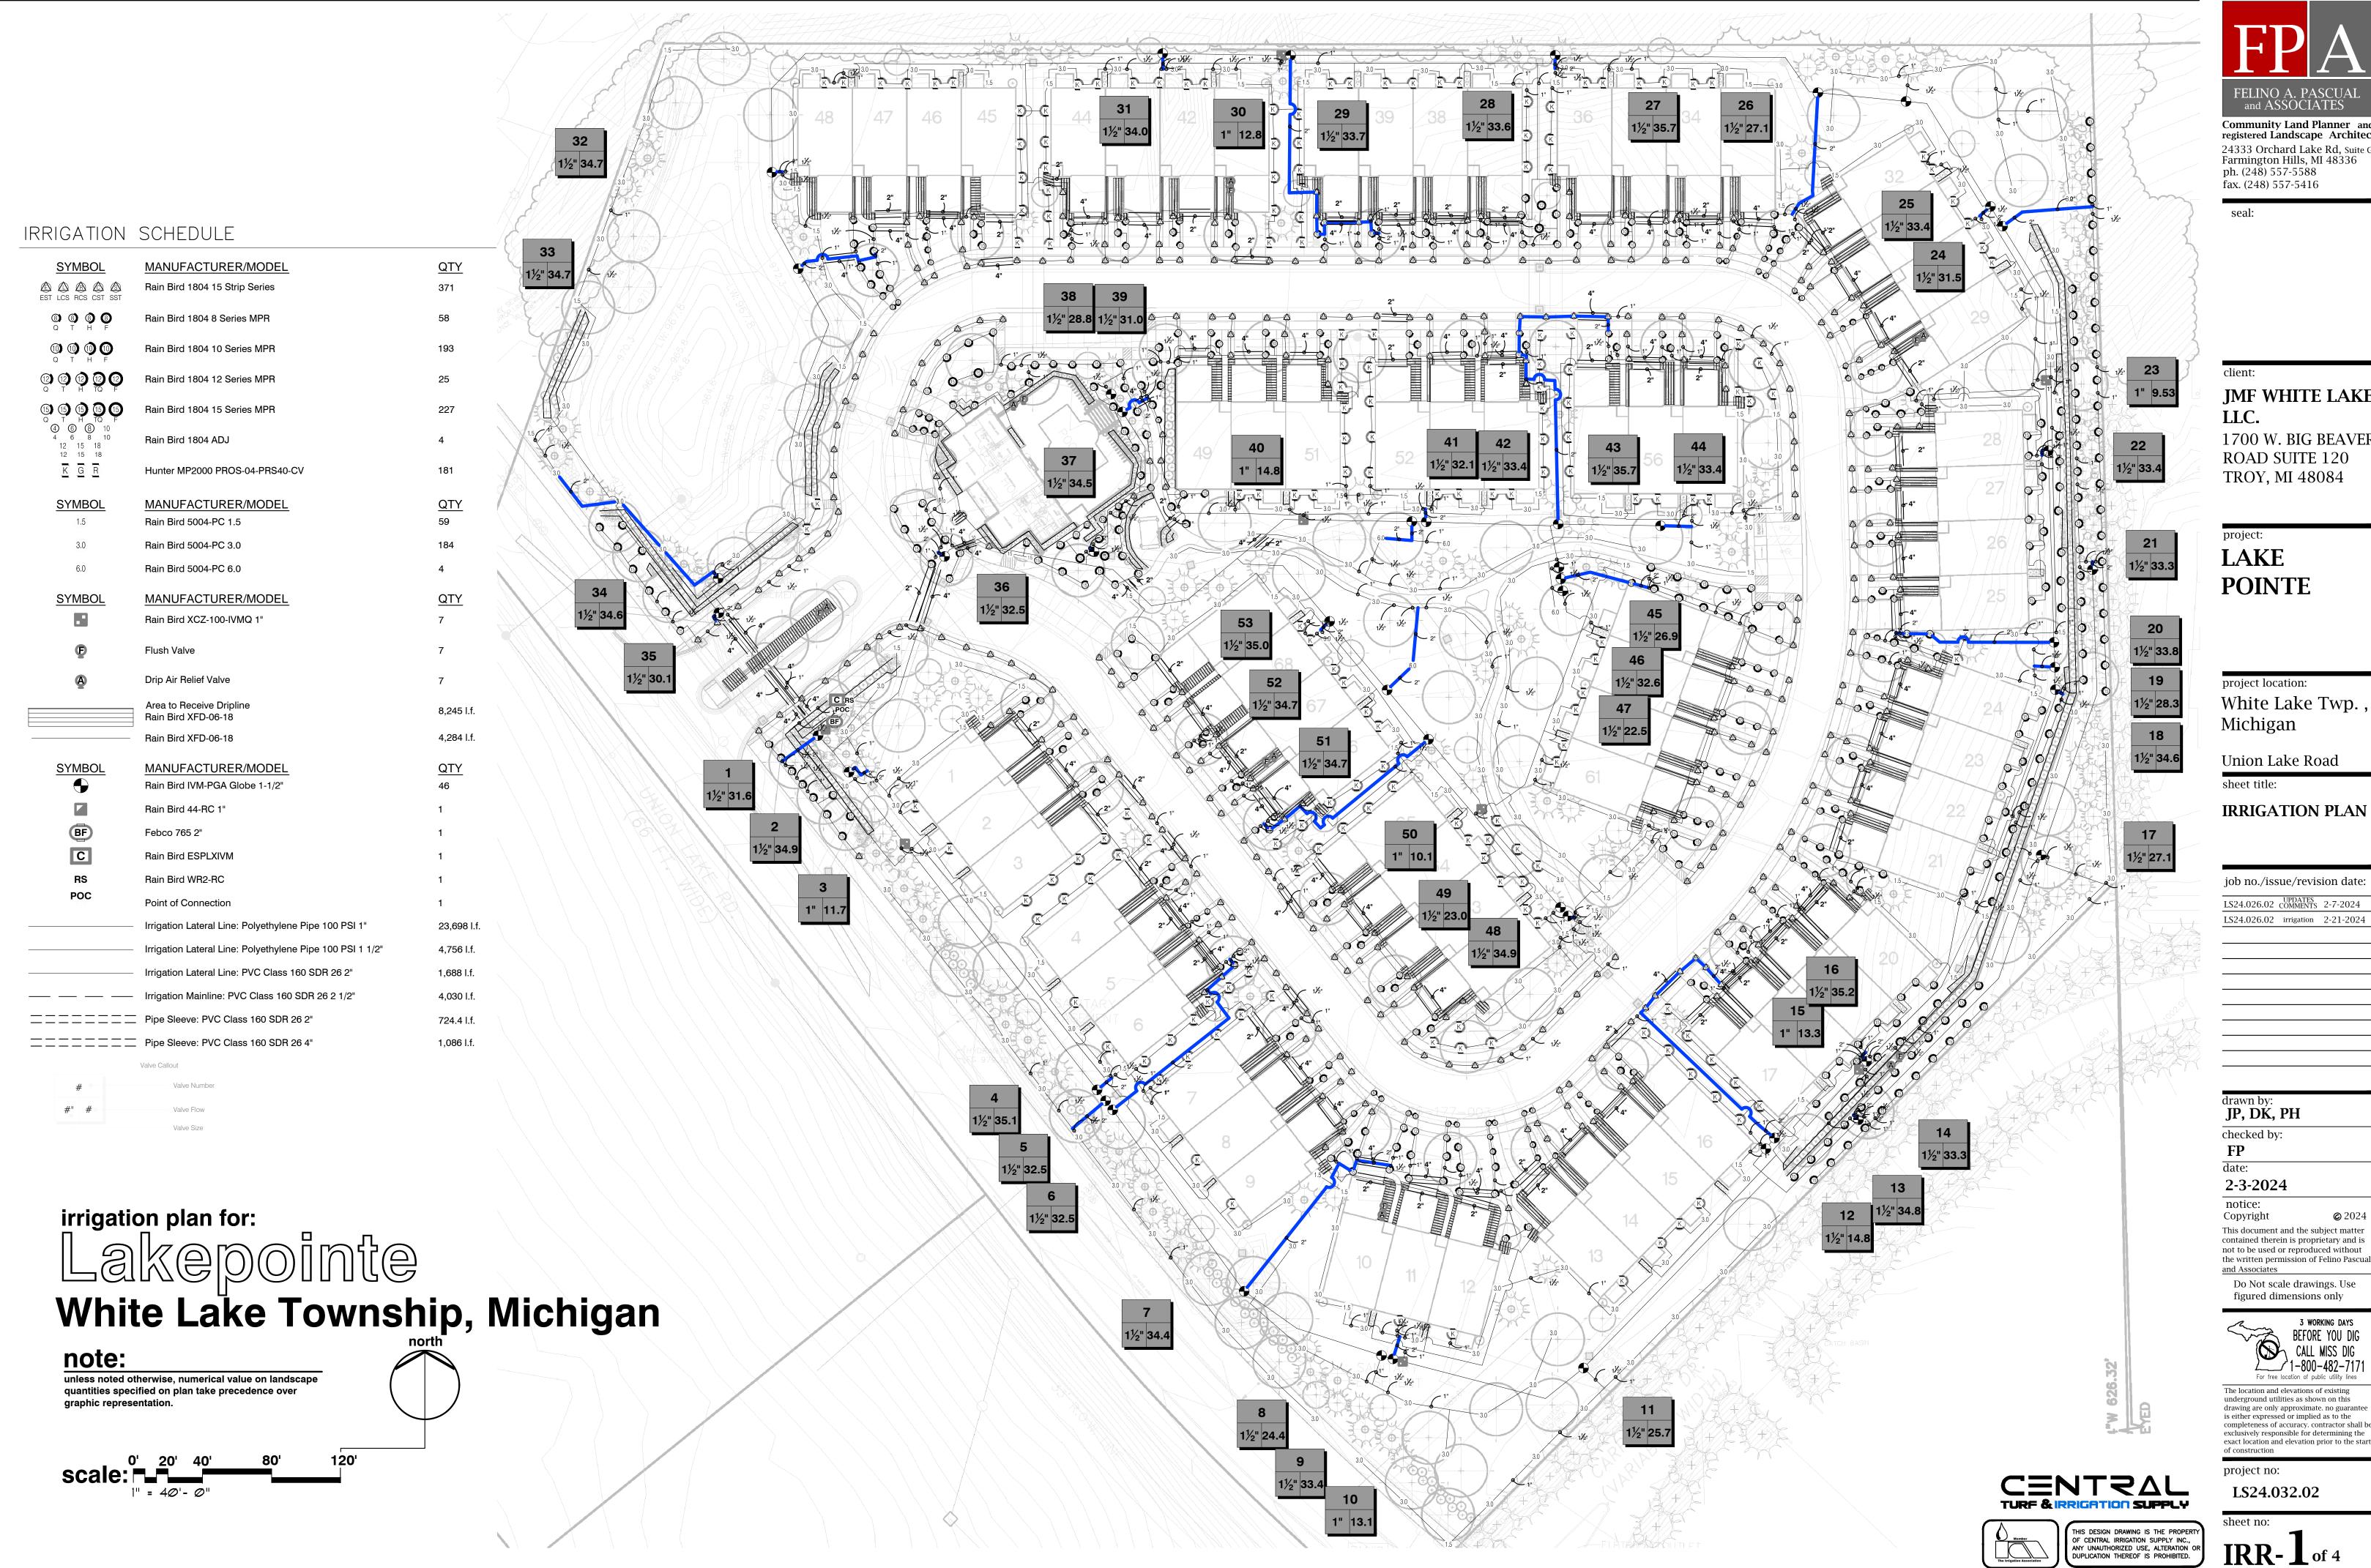



24333 Orchard Lake Rd, Suite G Farmington Hills, MI 48336 ph. (248) 557-5588 fax. (248) 557-5416

JMF WHITE LAKE,

1700 W. BIG BEAVER ROAD SUITE 120 TROY, MI 48084

LAKE

project location: White Lake Twp.,

Union Lake Road

IRRIGATION PLAN

job no./issue/revision date: LS24.026.02 UPDATES 2-7-2024 LS24.026.02 irrigation 2-21-2024

checked by:

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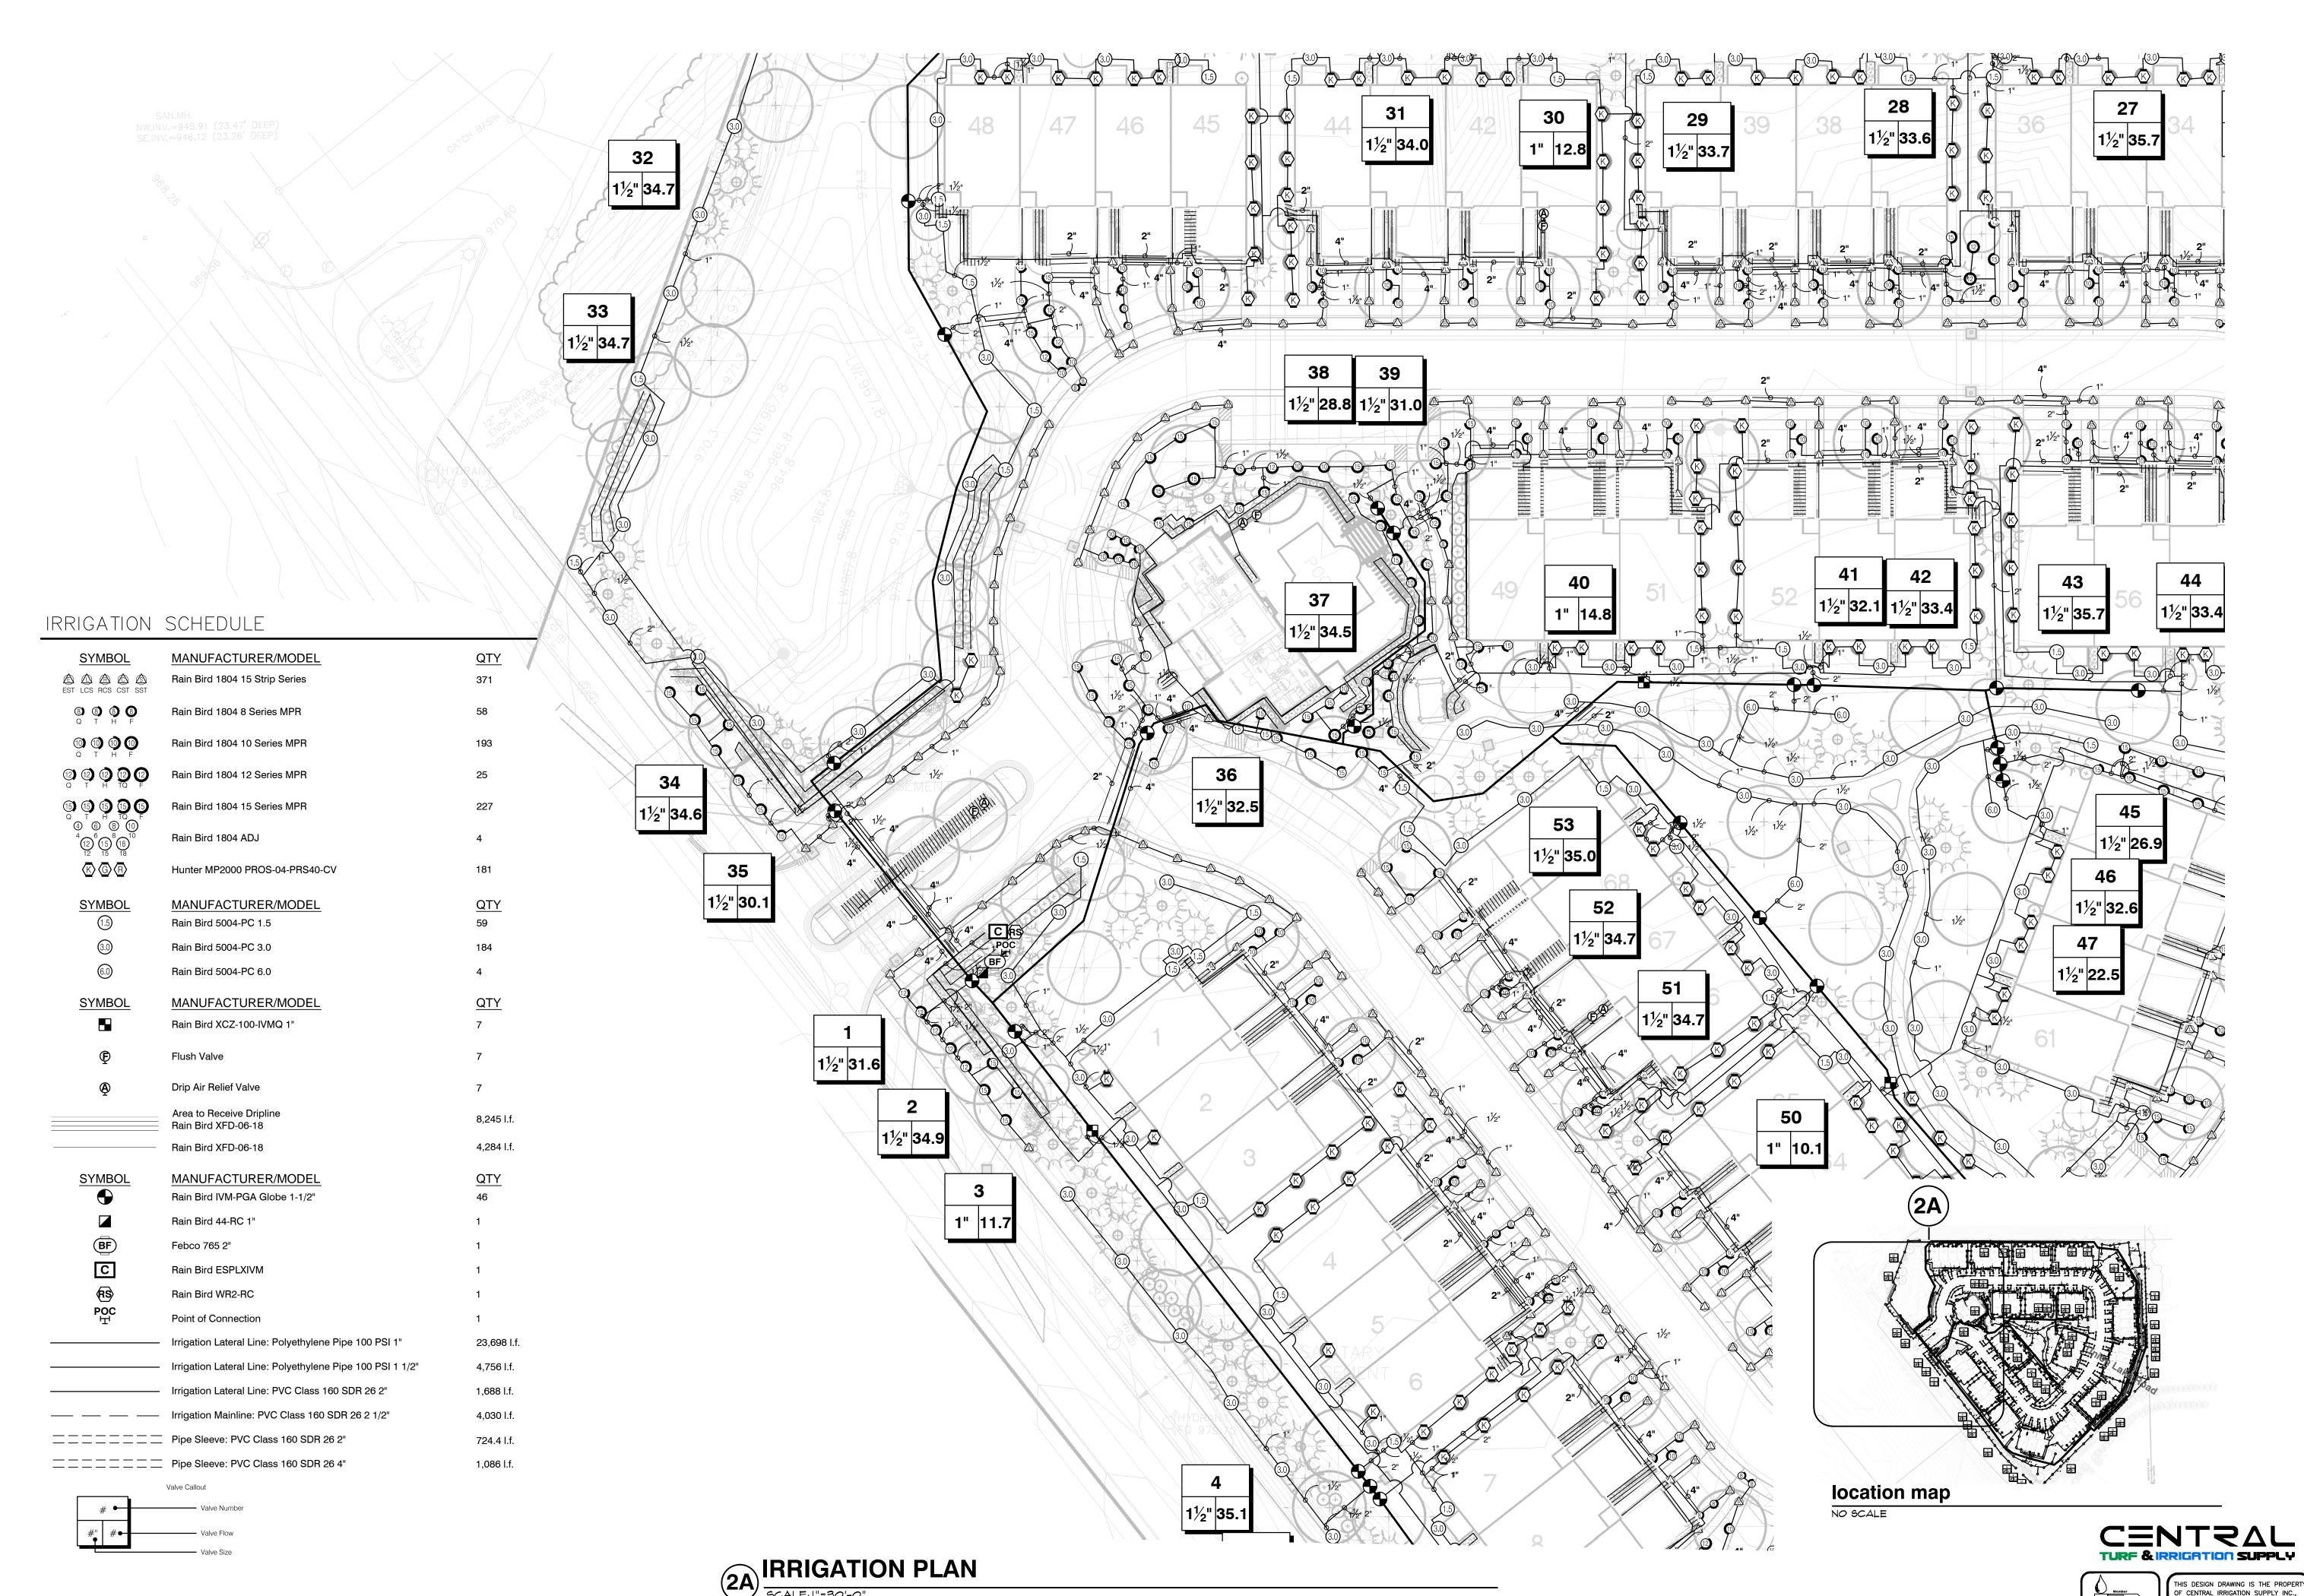
Do Not scale drawings. Use figured dimensions only

exclusively responsible for determining the exact location and elevation prior to the start

project no:

LS24.032.02

sheet no:



SCALE: |"=30'-0"



JMF WHITE LAKE, LLC.

1700 W. BIG BEAVER ROAD SUITE 120 TROY, MI 48084

project: **LAKE POINTE**

project location: White Lake Twp., Michigan

Union Lake Road sheet title:

IRRIGATION PLAN

job no./issue/revision date:

LS24.026.02 UPDATES 2-7-2024 LS24.026.02 irrigation 2-21-2024

JP, DK, PH checked by:

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project no:

LS24.032.02

sheet no:

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JMF WHITE LAKE, LLC.

1700 W. BIG BEAVER ROAD SUITE 120 TROY, MI 48084

project: **LAKE POINTE**

project location: White Lake Twp., Michigan

Union Lake Road sheet title:

IRRIGATION PLAN

job no./issue/revision date:

LS24.026.02 UPDATES 2-7-2024 LS24.026.02 irrigation 2-21-2024

drawn by: **JP, DK, PH**

checked by:

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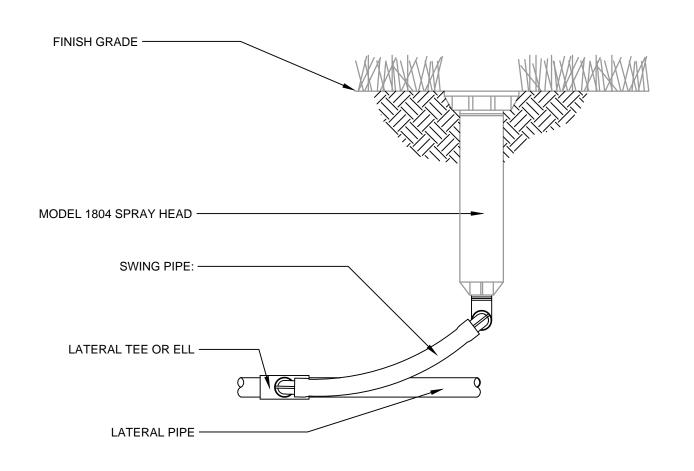
and Associates Do Not scale drawings. Use figured dimensions only


The location and elevations of existing underground utilities as shown on this drawing are only approximate. no guarantee is either expressed or implied as to the completeness of accuracy. contractor shall be exclusively responsible for determining the exact location and elevation prior to the start of construction


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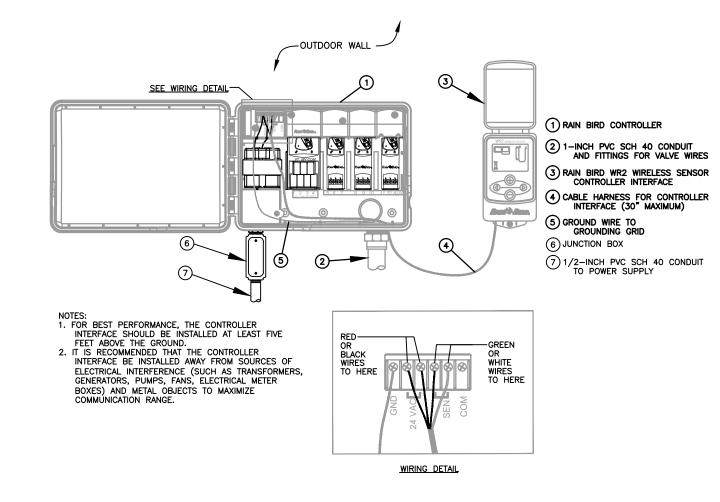
LS24.032.02

sheet no:





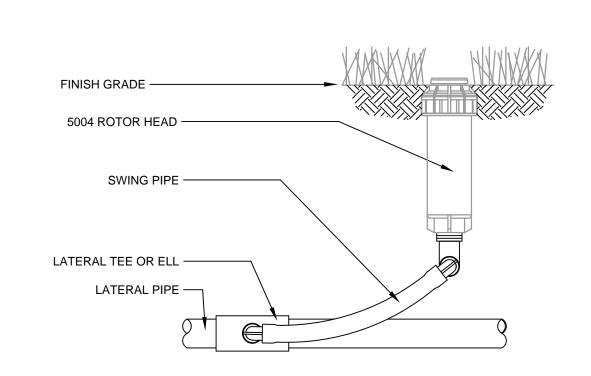

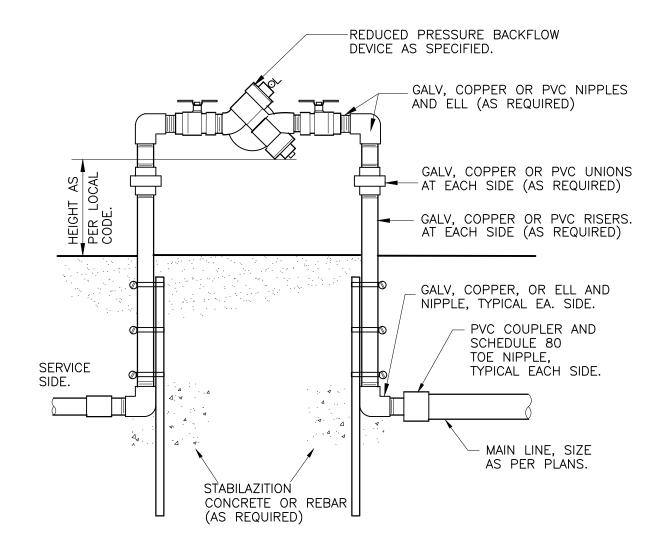

1804 SPRAY HEAD WITH SWING PIPE

TYPICAL DRIP TUBING LAYOUT

5004 ROTOR HEAD WITH SWING PIPE

S1-RO-RAI-01

REDUCED PRESSURE BACKFLOW DEVICE STANDARD


WR2 WIRELESS RAIN SENSOR

IRRIGATION SPECIFICATIONS

S1-QU-01

IRRIGATION SYSTEM DESIGN BASED ON 75 GPM AT 69 PSI.

- 2. IRRIGATION DESIGN IS FROM THE POINT OF CONNECTION(POC)ONLY. THE DESIGN IS BASED ON GALLONS PER MINUTE(GPM)AND POUNDS PER SQUARE INCH(PSI)FURNISHED BY OTHERS.
- 3. IRRIGATION CONTRACTOR IS TO VERIFY POINT OF CONNECTION IN THE FIELD. INSTALLER IS TO CONFIRM THE MINIMUM DISCHARGE REQUIREMENTS OF THE POINT OF CONNECTION AS INDICATED ON THE LEGEND PRIOR TO INSTALLATION.
- 4. THE PRESSURE REQUIREMENT AT THE POINT OF CONNECTION IS BASED ON NO MORE THAN 5 FEET OF ELEVATION CHANGE IN THE AREAS OF IRRIGATION.
- 5. ALL PRODUCTS SHALL BE INSTALLED IN ACCORDANCE WITH THE MANUFACTURER'S RECOMMENDATIONS AND ACCORDING TO LOCAL BUILDING, ELECTRICAL, AND PLUMBING CODES.
- 6. IRRIGATION CONTRACTOR WILL ARRANGE INSPECTIONS REQUIRED BY LOCAL AGENCIES AND ORDINANCES DURING THE COURSE OF CONSTRUCTION AS REQUIRED. ALL WIRING TO BE PER LOCAL CODE. BACKFLOW PREVENTION TO BE PER LOCAL CODE.
- 7. LOCATION OF IRRIGATION COMPONENTS SHOWN ON DRAWING IS APPROXIMATE. ACTUAL PLACEMENT MAY VARY SLIGHTLY AS
- REQUIRED TO ACHIEVE FULL, EVEN COVERAGE. ALL SPRINKLER HEADS SHALL BE INSTALLED PERPENDICULAR TO FINISH GRADES. EXCEPT AS OTHERWISE INDICATED.
- 9. INSTALL IRRIGATION MAINS WITH A MINIMUM 18" OF COVER BASED ON FINISH GRADES. INSTALL IRRIGATION LATERALS WITH MINIMUM 12" OF COVER BASED ON FINISH GRADES.
- 10. PIPE LOCATIONS ARE DIAGRAMMATIC. VALVES AND MAINLINE SHOWN IN PAVED AREAS ARE FOR GRAPHIC CLARITY ONLY.
- 11. THE IRRIGATION CONTRACTOR SHALL COMPLY WITH PIPE SIZES AS INDICATED.
- 12. ALL WIRE SPLICES OR CONNECTIONS SHALL BE MADE WITH APPROVED WATERPROOF WIRE CONNECTIONS AND BE IN A VALVE OR SPLICE BOX.
- 13. ALL CONTROL WIRING DOWNSTREAM OF THE CONTROLLER IS TO BE 2 WIRE, UL APPROVED DIRECT BURY.
- 14. THE DESIGN IS BASED ON THE SITE INFORMATION AND/OR DRAWING SUPPLIED WITH THE DESIGN CRITERIA BEING SET(AREA TO BE IRRIGATED, EQUIPMENT MANUFACTURER AND MODEL TO BE USED, WATER SOURCE INFORMATION, ELECTRICAL POWER AVAILABILITY, ETC...). SITEONE LANDSCAPE SUPPLY BEARS NO RESPONSIBILITY OR LIABILITY FOR ANY ERRORS IN DESIGN OR INSTALLATION THAT ARISE DUE TO INACCURACIES IN THE ABOVE REFERENCED INFORMATION SUPPLIED TO SITEONE LANDSCAPE SUPPLY LANDSCAPES IN RELATION TO THIS PROJECT, UNLESS OTHERWISE NOTED.

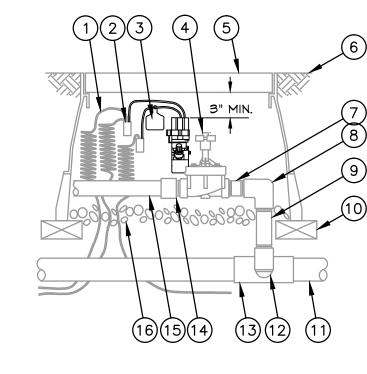

1) 30-INCH LINEAR LENGTH OF WIRE, COILED 2 WATERPROOF CONNECTION RAIN BIRD SPLICE-1 (1 OF 2)

3 ID TAG: RAIN BIRD VID SERIES 4 REMOTE CONTROL VALVE:
RAIN BIRD PESB-PRS-D
WITH NP-HAN

5 VALVE BOX WITH COVER:

(6) FINISH GRADE/TOP OF MULCH (7) PVC SCH 80 NIPPLE (CLOSE) (8) PVC SCH 40 ELL

9 PVC SCH 80 NIPPLE (LENGTH AS REQUIRED)

(10) BRICK (1 OF 4) (11) PVC MAINLINE PIPE (12) SCH 80 NIPPLE (2-INCH LENGTH, HIDDEN) AND SCH 40 ELL (13) PVC SCH 40 TEE OR ELL (14) PVC SCH 40 MALE ADAPTER (15) PVC LATERAL PIPE (16) 3.0-INCH MINIMUM DEPTH OF 3/4-INCH WASHED GRAVEL PEB SERIES ELECTRIC VALVE

- 10X15 RECTANGULAR BOXES WITH 6' EXTENSIONS AS INDICATGED. FINISHED GRADE. MASTER CONTROL — SCHEDULE 80 NIPPLES, VALVE INLET SIZE. VALVE AS SPECIFIED. FLOW SENSOR AS SPECIFIED. WATERPROOF WIRE WATERPROOF WIRE CONNECTORS ON CONNECTORS, ON 18" LOOPED WIRES. ADD SENSOR DECODER 30" LOOPED WIRES. IF REQUIRED. SCH 80 NIPPLES, CABLE TO CONTROLLER SENSOR VALVE INLET SIZE. TERMINAL BOARD, AS MFG. RECOMMEND. FLOW REDUCER AS REQUIRED .-PVC MAIN LINE -TO BACKFLOW FIVE PIPE DIAMETERS TEN PIPE DIAMETERS DEVICE. NO VALVES, REDUCERS, OR ELBOWS IN THIS AREA.

6

FINISHED GRADE. - QUICK COUPLING VALVE AS SPECIFIED. TWO STAINLESS STEEL CLAMPS. -SWING JOINT PVC SCH80 REBAR OR STEEL PIPE-

QUICK COUPLING VALVE IN BOX

CENTRAL **TURF & IRRIGATION SUPPLY** THIS DESIGN DRAWING IS THE PROPER OF CENTRAL IRRIGATION SUPPLY INC.,

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JP, DK, PH checked by:

2-3-2024

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and ASSOCIATES

Community Land Planner and registered Landscape Architect

24333 Orchard Lake Rd, Suite G Farmington Hills, MI 48336

JMF WHITE LAKE,

1700 W. BIG BEAVER

ROAD SUITE 120

TROY, MI 48084

LLC.

project:

LAKE

POINTE

project location:

Michigan

sheet title:

White Lake Twp.,

Union Lake Road

IRRIGATION

NOTES & DETAILS

job no./issue/revision date:

LS24.026.02 COMMENTS 2-7-2024

 $LS24.026.02 \quad irrigation \quad 2\text{-}21\text{-}2024$

ph. (248) 557-5588

fax. (248) 557-5416

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nderground utilities as shown on this is either expressed or implied as to the completeness of accuracy. contractor shall b exclusively responsible for determining the exact location and elevation prior to the start of construction


project no: LS24.032.02

sheet no:

MASTER VALVE/FLOW SENSOR ASSEMBLY


S1-VA-RAI-03

S1-MI-03

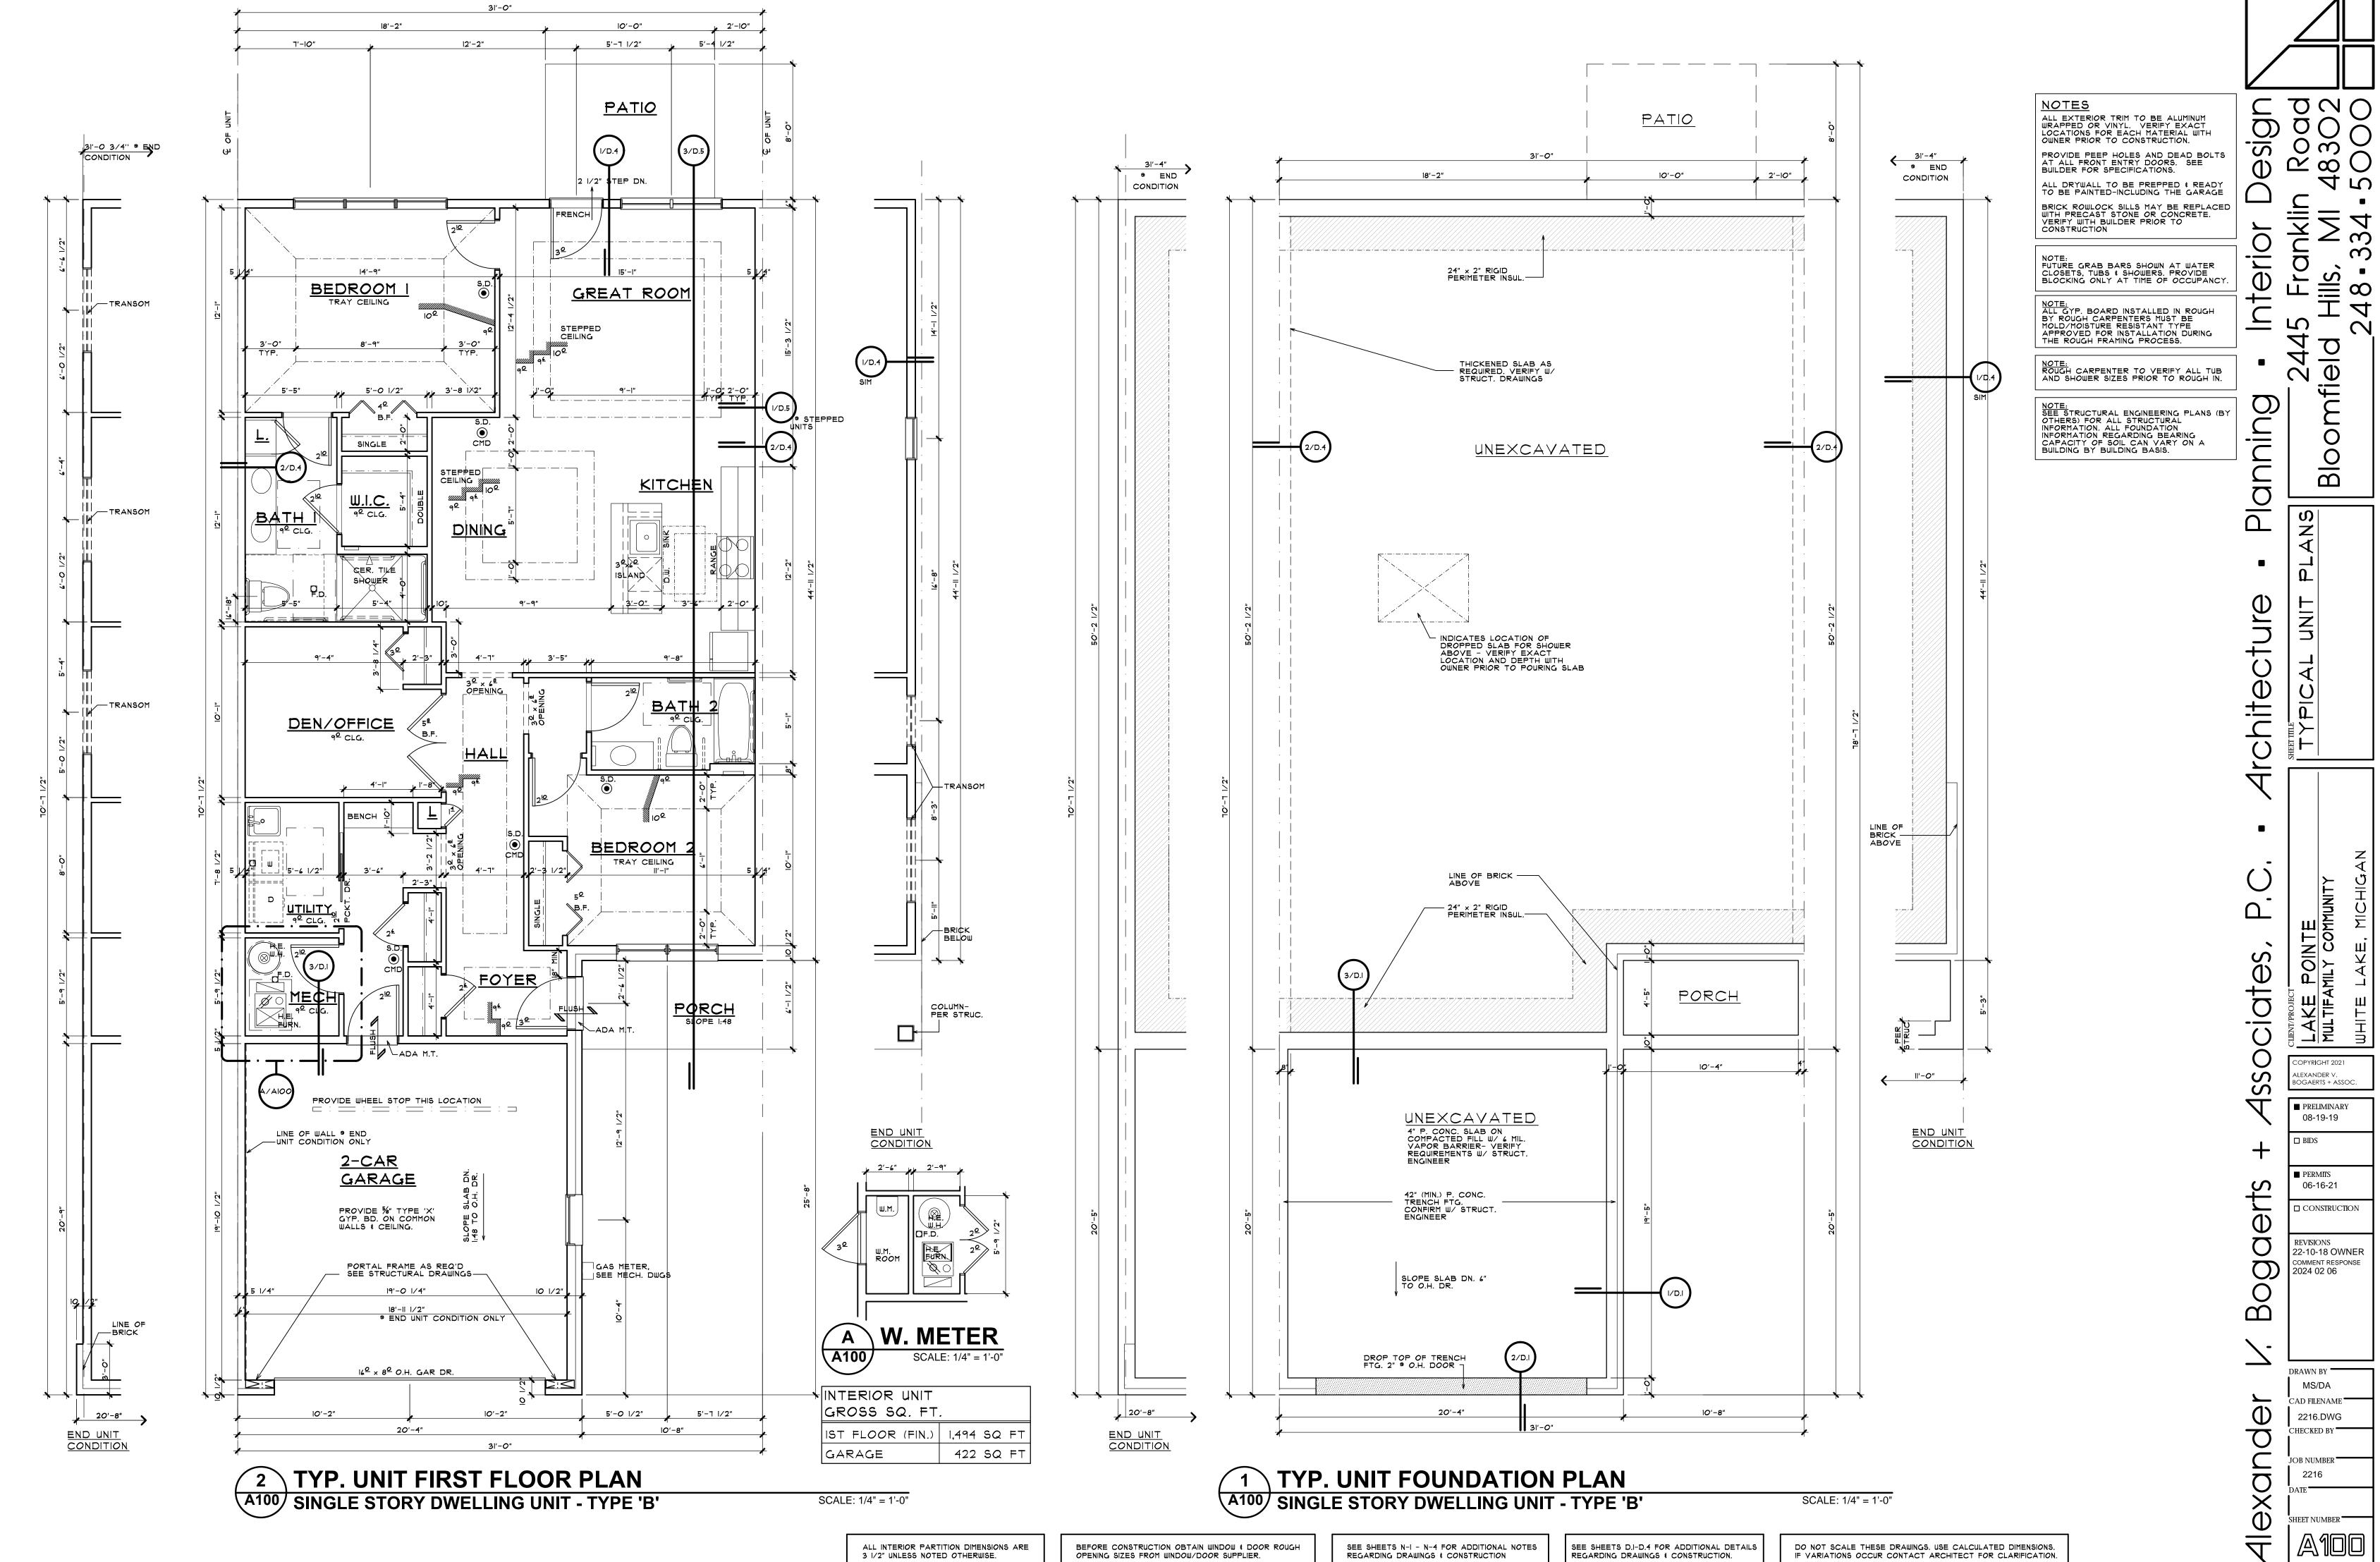



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Bo

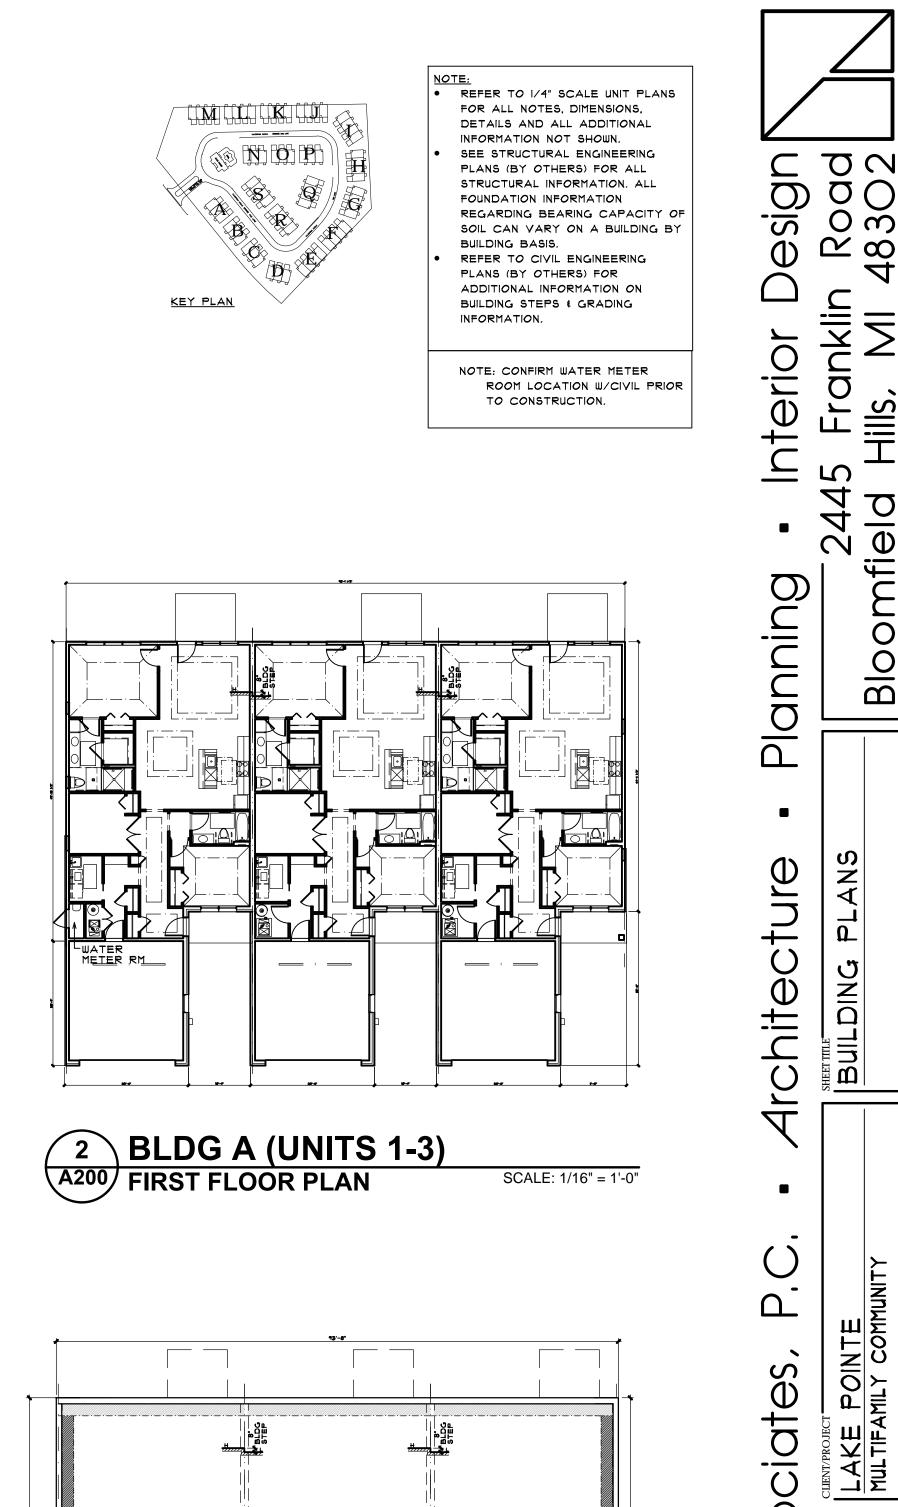BULDING

OPYR**I**GHT 2021

LEXANDER V. OGAERTS + ASSOC.

■ PRELIMINARY 08-19-19

□ BIDS

PERMITS 06-16-21

☐ CONSTRUCTION

REVISIONS 22-10-18 OWNER


COMMENT RESPONSE 2024 02 06

DRAWN BY MS/DA CAD FILENAME 2216.DWG CHECKED BY


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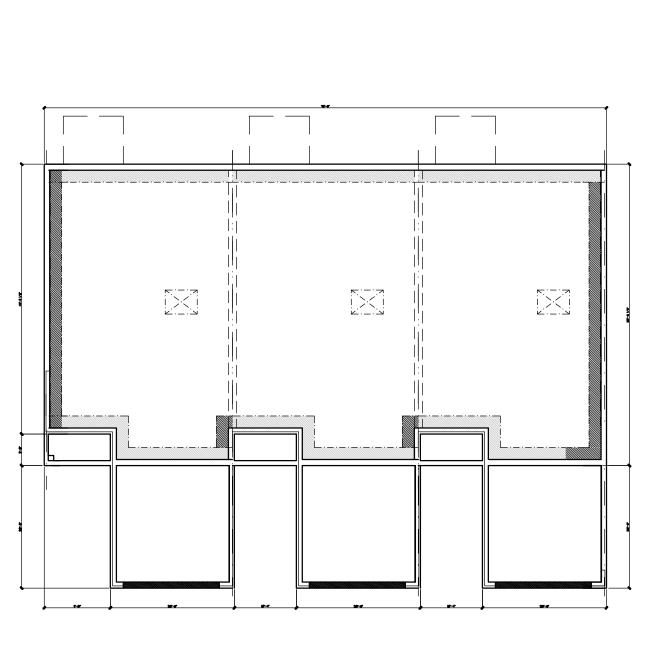
SHEET NUMBER

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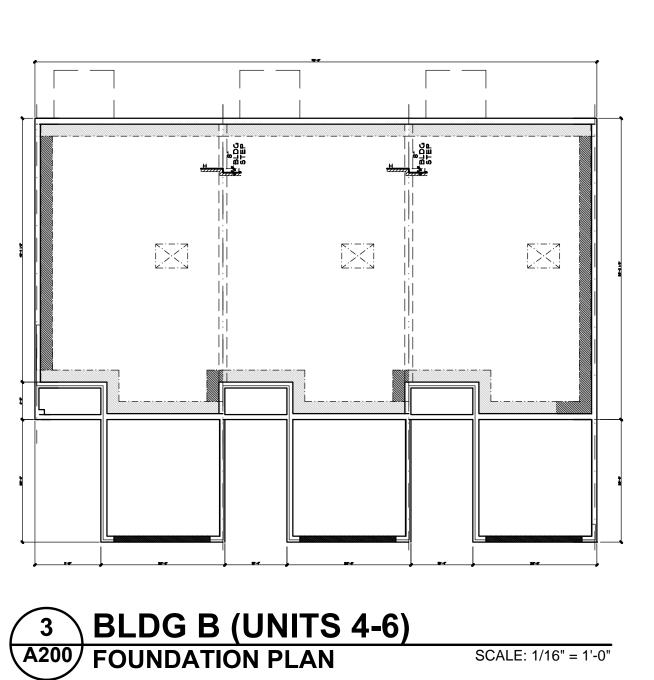
A200 FIRST FLOOR PLAN




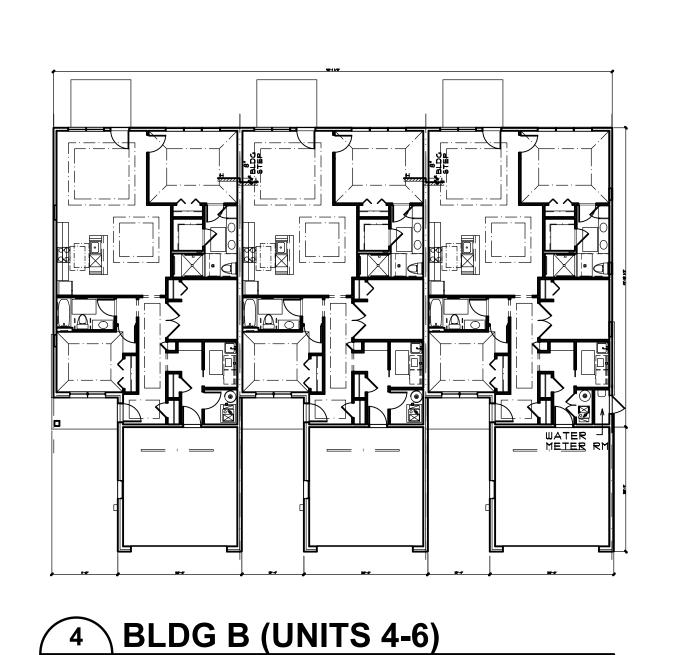



6 BLDG C,D,N,O - FIRST FLOOR PLAN

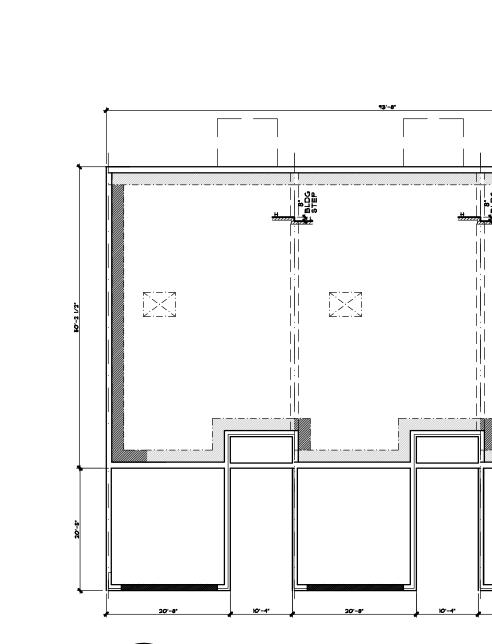A200 (UNITS 7-9, 10-12, 49-51, 52-54)



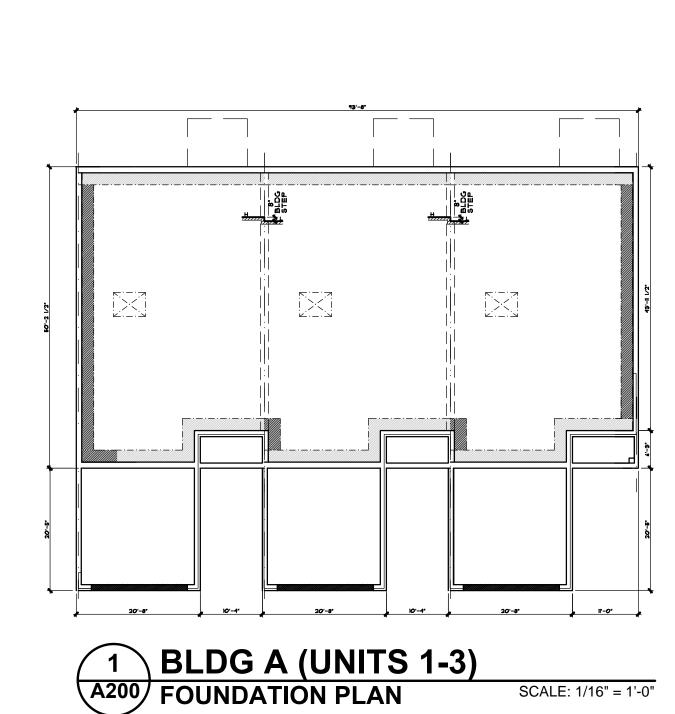

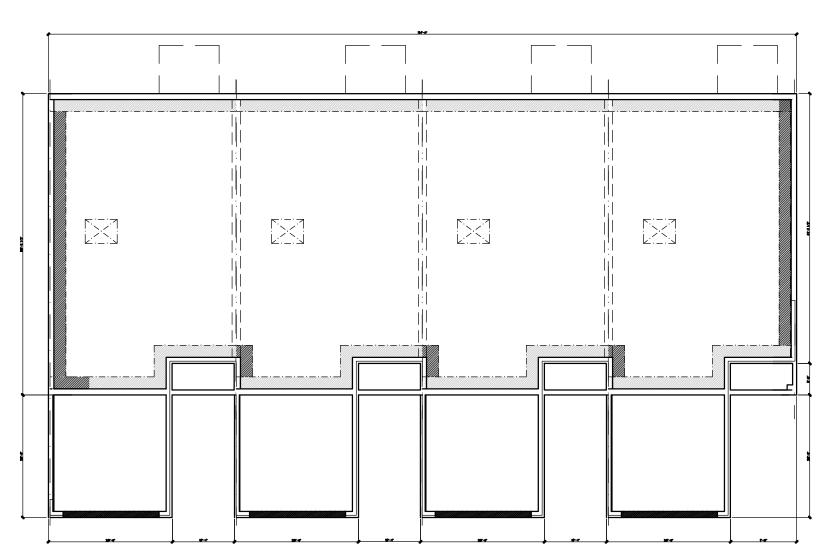

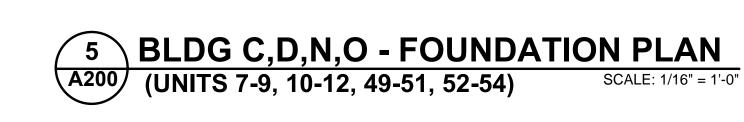



7 BLDG E (UNITS 13-16)
A200 FOUNDATION PLAN SCALE: 1/16" = 1'-0"

8 BLDG E (UNITS 13-16)

A200 FIRST FLOOR PLAN

ALL INTERIOR PARTITION DIMENSIONS ARE 3 1/2" UNLESS NOTED OTHERWISE.

WATER J ME<u>TER</u> RM

SEE SHEETS N-I - N-4 FOR ADDITIONAL NOTES REGARDING DRAWINGS & CONSTRUCTION

BEFORE CONSTRUCTION OBTAIN WINDOW & DOOR ROUGH OPENING SIZES FROM WINDOW/DOOR SUPPLIER.

SEE SHEETS D.I-D.4 FOR ADDITIONAL DETAILS REGARDING DRAWINGS & CONSTRUCTION.

DO NOT SCALE THESE DRAWINGS, USE CALCULATED DIMENSIONS. IF VARIATIONS OCCUR CONTACT ARCHITECT FOR CLARIFICATION.



S:\CURRENT\1client\Furnari\WHITE LAKE\LAKE POINTE\04 DRAWINGS\2216 ELEV.dwg, 2/6/2024

KEY PLAN


• REFER TO 1/4" SCALE UNIT PLANS FOR ALL NOTES, DIMENSIONS,

DETAILS AND ALL ADDITIONAL INFORMATION NOT SHOWN. SEE STRUCTURAL ENGINEERING PLANS (BY OTHERS) FOR ALL STRUCTURAL INFORMATION. ALL


FOUNDATION INFORMATION REGARDING BEARING CAPACITY OF SOIL CAN VARY ON A BUILDING BY BUILDING BASIS. REFER TO CIVIL ENGINEERING PLANS (BY OTHERS) FOR

ADDITIONAL INFORMATION ON BUILDING STEPS & GRADING INFORMATION.

NOTE: CONFIRM WATER METER ROOM LOCATION W/CIVIL PRIOR TO CONSTRUCTION.

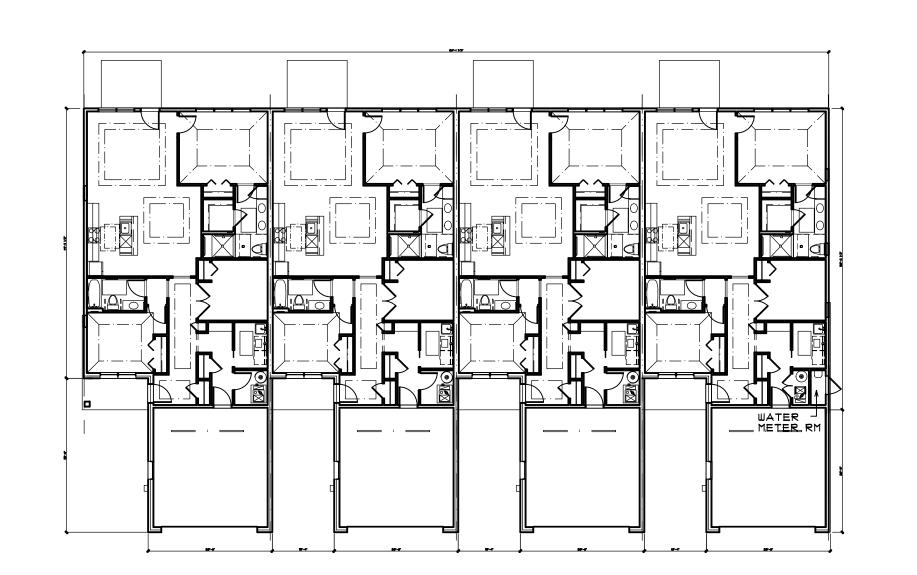


6 BLDG I - FIRST FLOOR PLAN
A202 UNITS (29-32) SCALE: 1/16" = 1'-0"

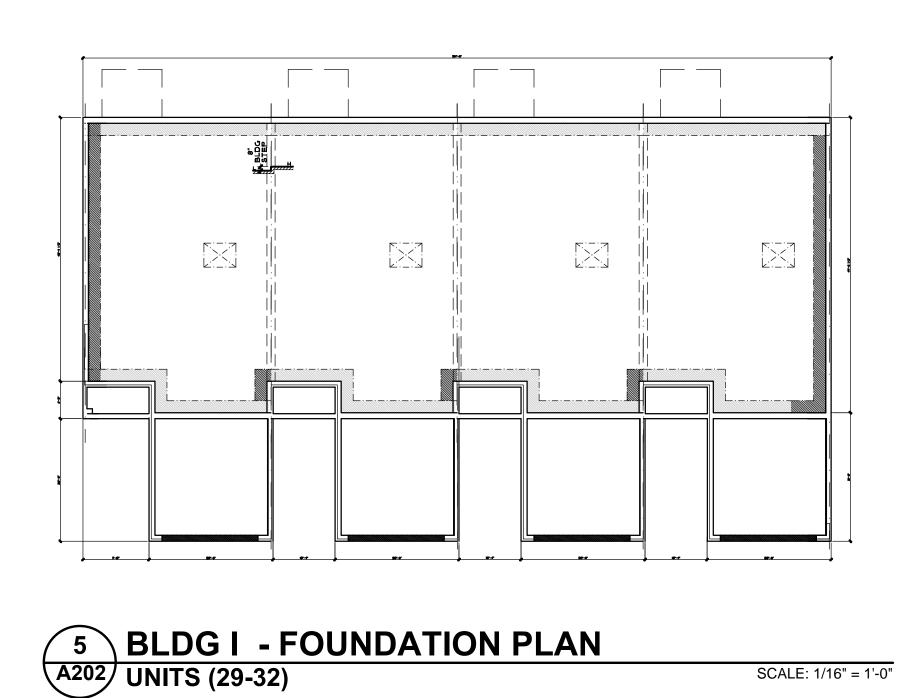


SCALE: 1/16" = 1'-0"

WATER J METER RM

4 BLDG H - FIRST FLOOR PLAN A202 UNITS (25-28) SCALE: 1/16" = 1'-0"

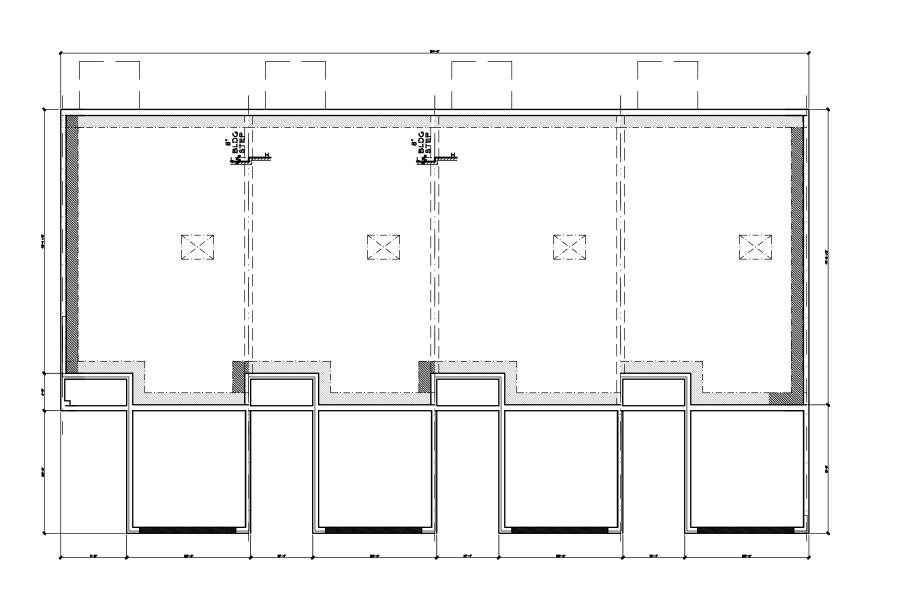


3 BLDG H - FOUNDATION PLAN A202 UNITS (25-28) SCALE: 1/16" = 1'-0"

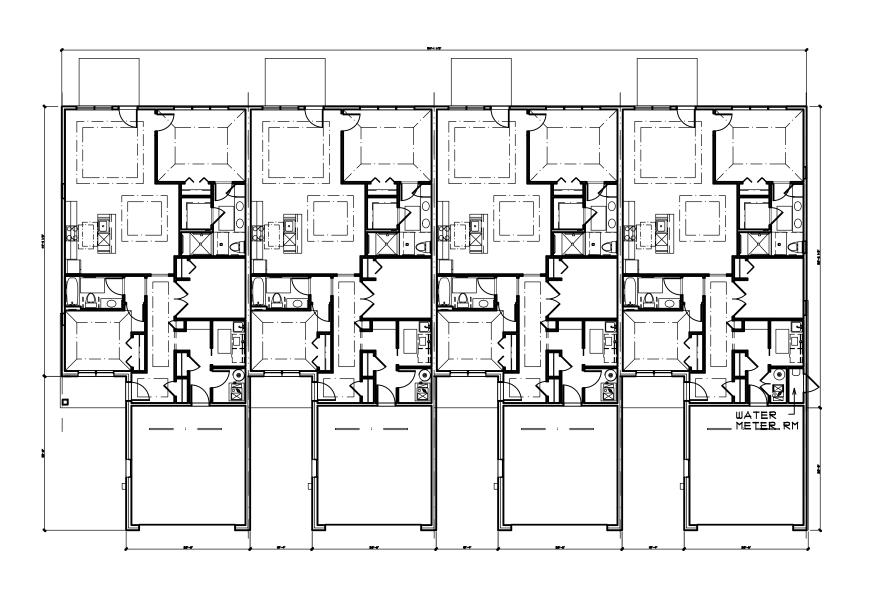

2 BLDGS F,G,K,L,M,Q - FIRST FLOOR PLAN

A202 UNITS (17-20, 21-24, 37-40, 41-44, 45-48, 58-61)

SCALE: 1/16" = 1'-0"

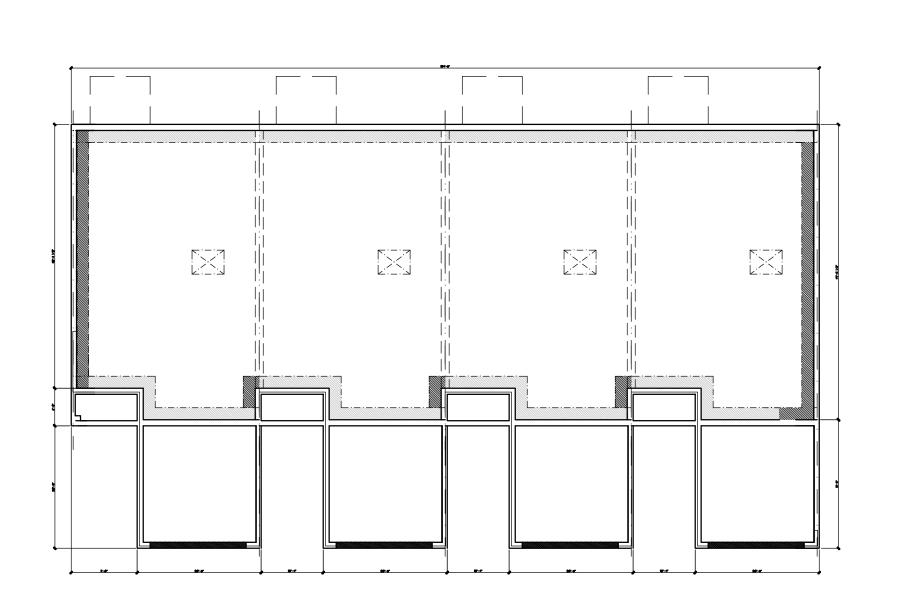

1 BLDGS F,G,K,L,M,Q - FOUNDATION PLAN
A202 UNITS (17-20, 21-24, 37-40, 41-44, 45-48, 58-61)
SCALE: SCALE: 1/16" = 1'-0"

ALL INTERIOR PARTITION DIMENSIONS ARE 3 1/2" UNLESS NOTED OTHERWISE.

BEFORE CONSTRUCTION OBTAIN WINDOW & DOOR ROUGH OPENING SIZES FROM WINDOW/DOOR SUPPLIER.

SEE SHEETS N-I - N-4 FOR ADDITIONAL NOTES REGARDING DRAWINGS & CONSTRUCTION

SEE SHEETS D.I-D.4 FOR ADDITIONAL DETAILS REGARDING DRAWINGS & CONSTRUCTION.

DO NOT SCALE THESE DRAWINGS. USE CALCULATED DIMENSIONS.

Z **4rchitec** BULDING LAKE POINTE
MULTIFAMILY COMMUNITY Bo

LEXANDER V. OGAERTS + ASSOC. ■ PRELIMINARY 08-19-19

Bo

☐ BIDS ■ PERMITS 06-16-21

☐ CONSTRUCTION

REVISIONS 22-10-18 OWNER COMMENT RESPONSE 2024 02 06

DRAWN BY MS/DA CAD FILENAME 2216.DWG CHECKED BY OB NUMBER

SHEET NUMBER

A202



BEFORE CONSTRUCTION OBTAIN WINDOW & DOOR ROUGH

OPENING SIZES FROM WINDOW/DOOR SUPPLIER.

NOTE:


SEE SHEETS D.I-D.4 FOR ADDITIONAL NOTES

REGARDING DRAWINGS & CONSTRUCTION.

DO NOT SCALE THESE DRAWINGS. USE CALCULATED DIMENSIONS. IF VARIATIONS OCCUR CONTACT ARCHITECT FOR CLARIFICATION.

REFER TO 1/4" SCALE ELEVATIONS ON SHEET

22-10-18 OWNER

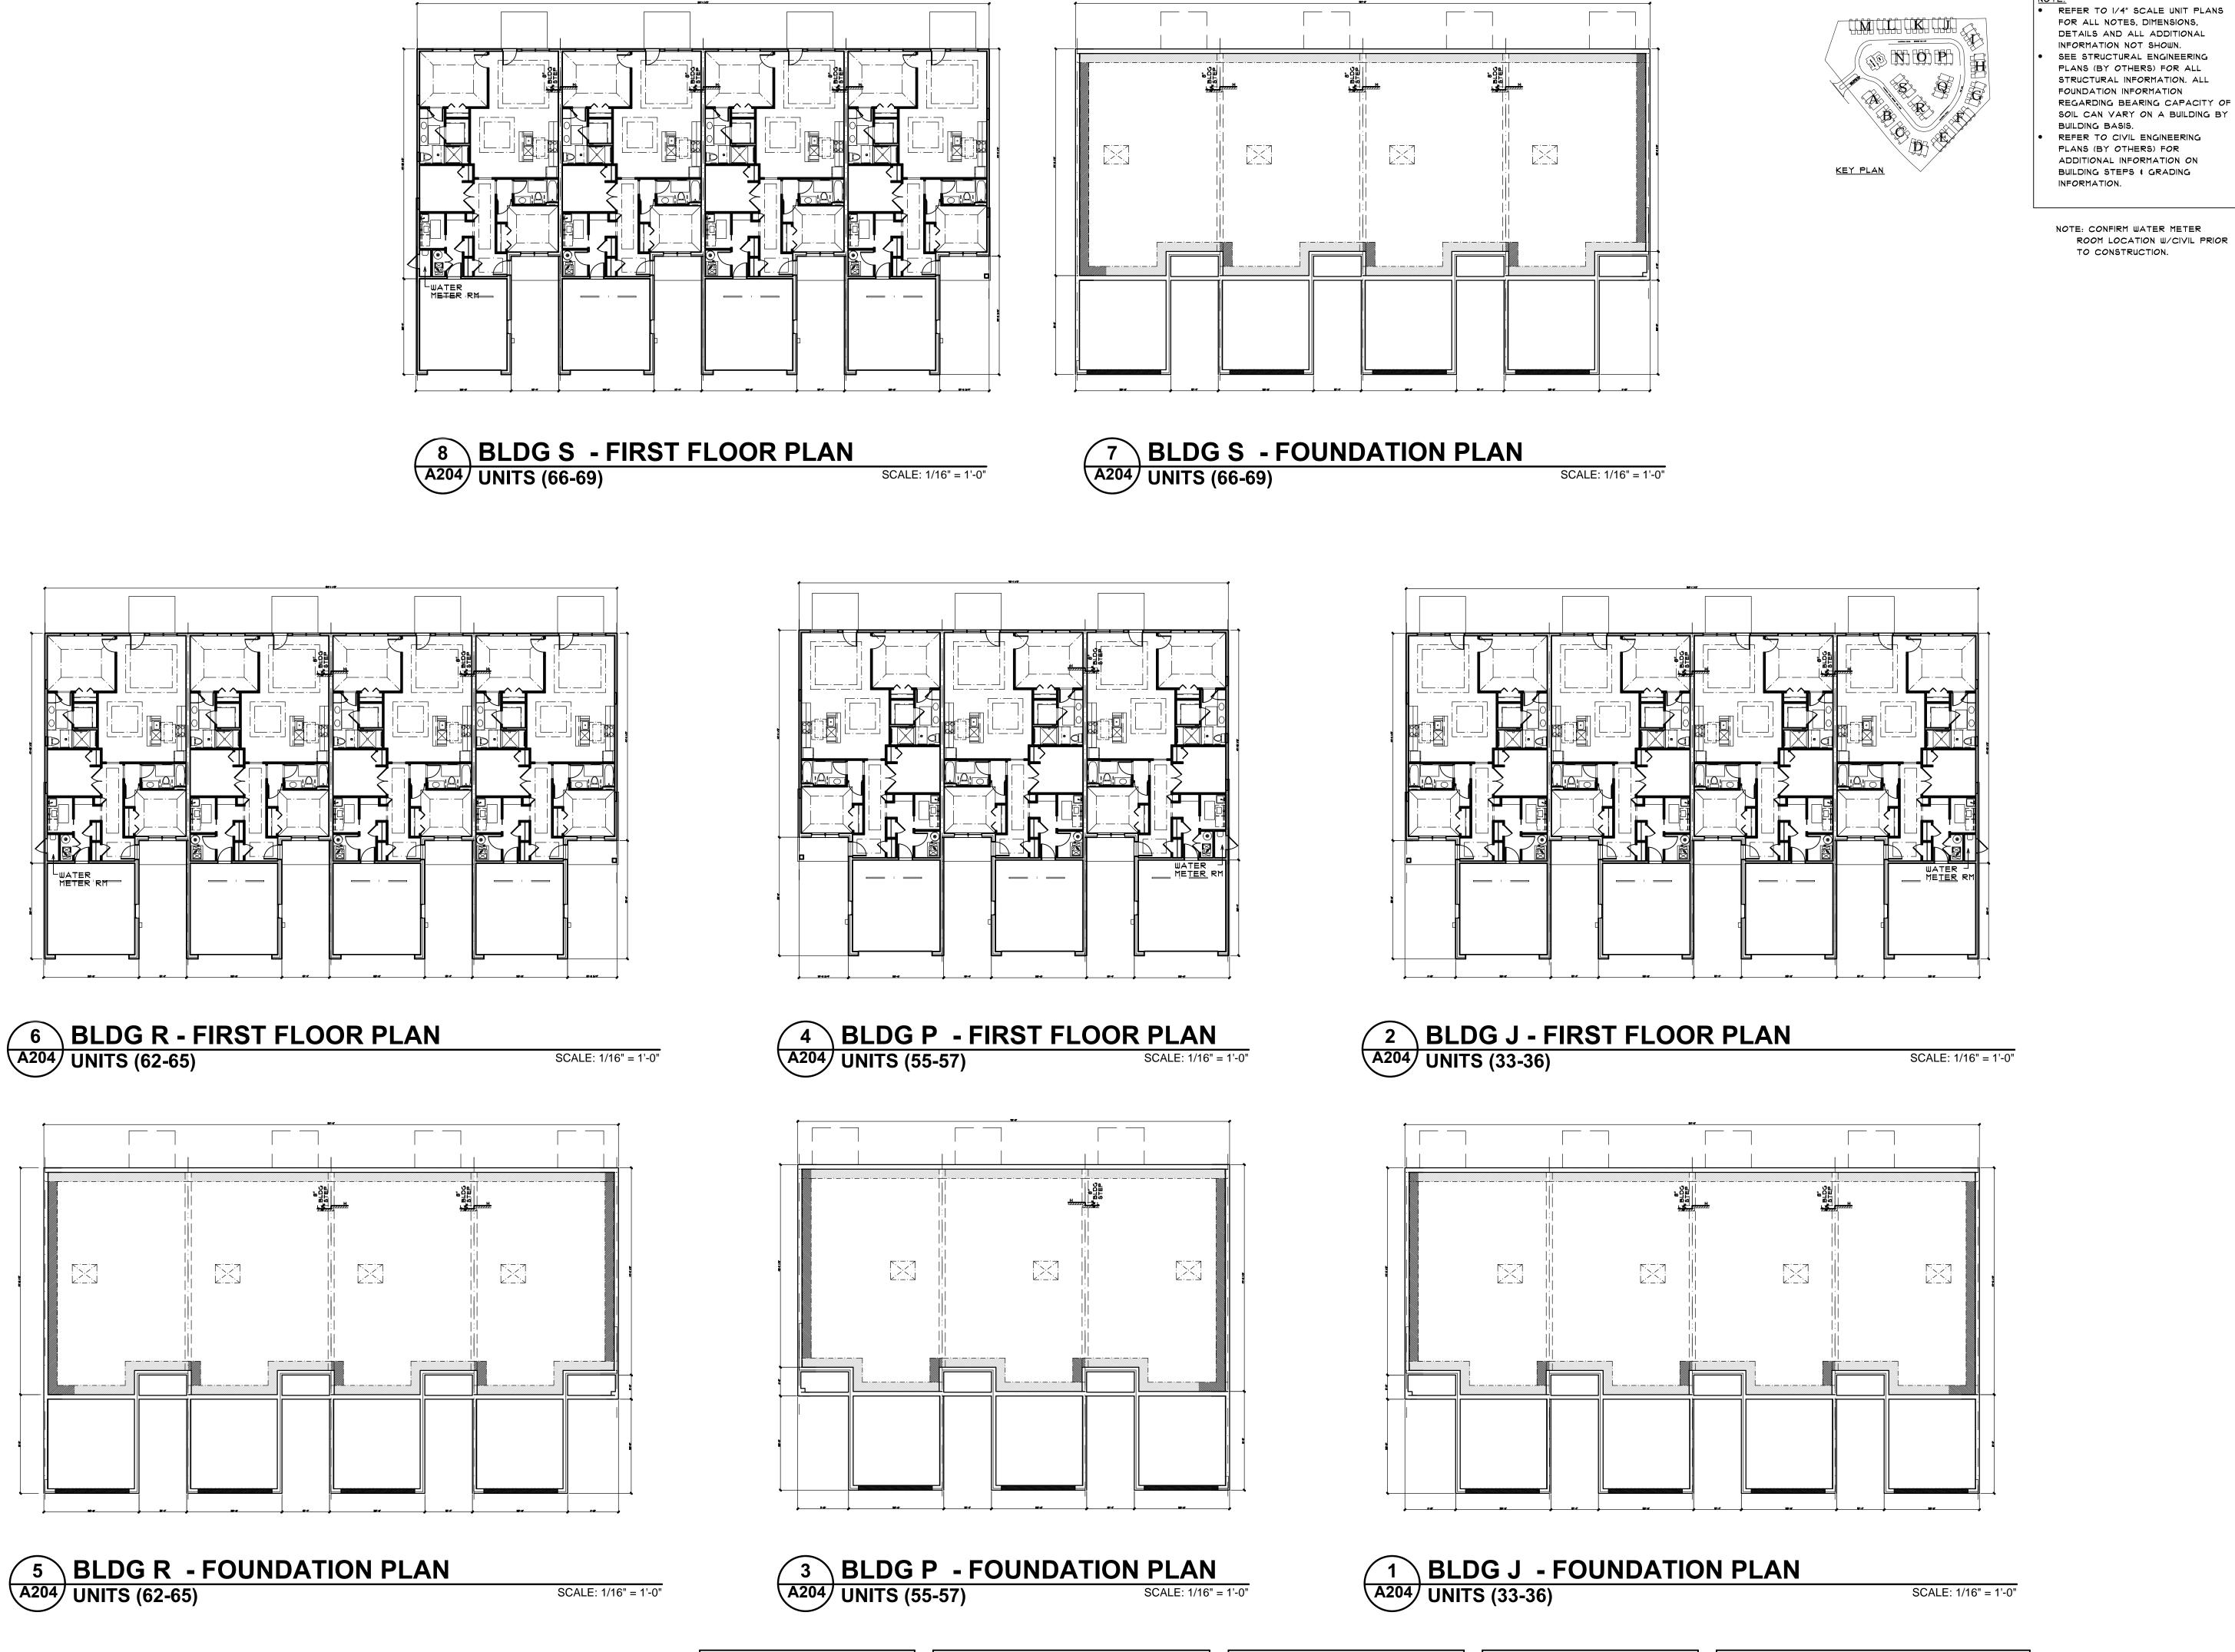

Blo BUILDING LAKE POINTE
MULTIFAMILY COMMUNITY LEXANDER V. OGAERTS + ASSOC. ■ PRELIMINARY 08-19-19 ■ PERMITS 06-16-21 ☐ CONSTRUCTION REVISIONS 22-10-18 OWNER COMMENT RESPONSE 2024 02 06 Bo DRAWN BY MS/DA CAD FILENAME 2216.DWG CHECKED BY OB NUMBER SHEET NUMBER

ALL INTERIOR PARTITION DIMENSIONS ARE 3 1/2" UNLESS NOTED OTHERWISE.

BEFOR OPENIN

BEFORE CONSTRUCTION OBTAIN WINDOW & DOOR ROUGH OPENING SIZES FROM WINDOW/DOOR SUPPLIER. SEE SHEETS N-I - N-4 FOR ADDITIONAL NOTES REGARDING DRAWINGS & CONSTRUCTION


SEE SHEETS D.I-D.4 FOR ADDITIONAL DETAILS REGARDING DRAWINGS & CONSTRUCTION.

DO NOT SCALE THESE DRAWINGS. USE CALCULATED DIMENSIONS.
IF VARIATIONS OCCUR CONTACT ARCHITECT FOR CLARIFICATION.



2 COLOR SCHEMES

Scale: NONE

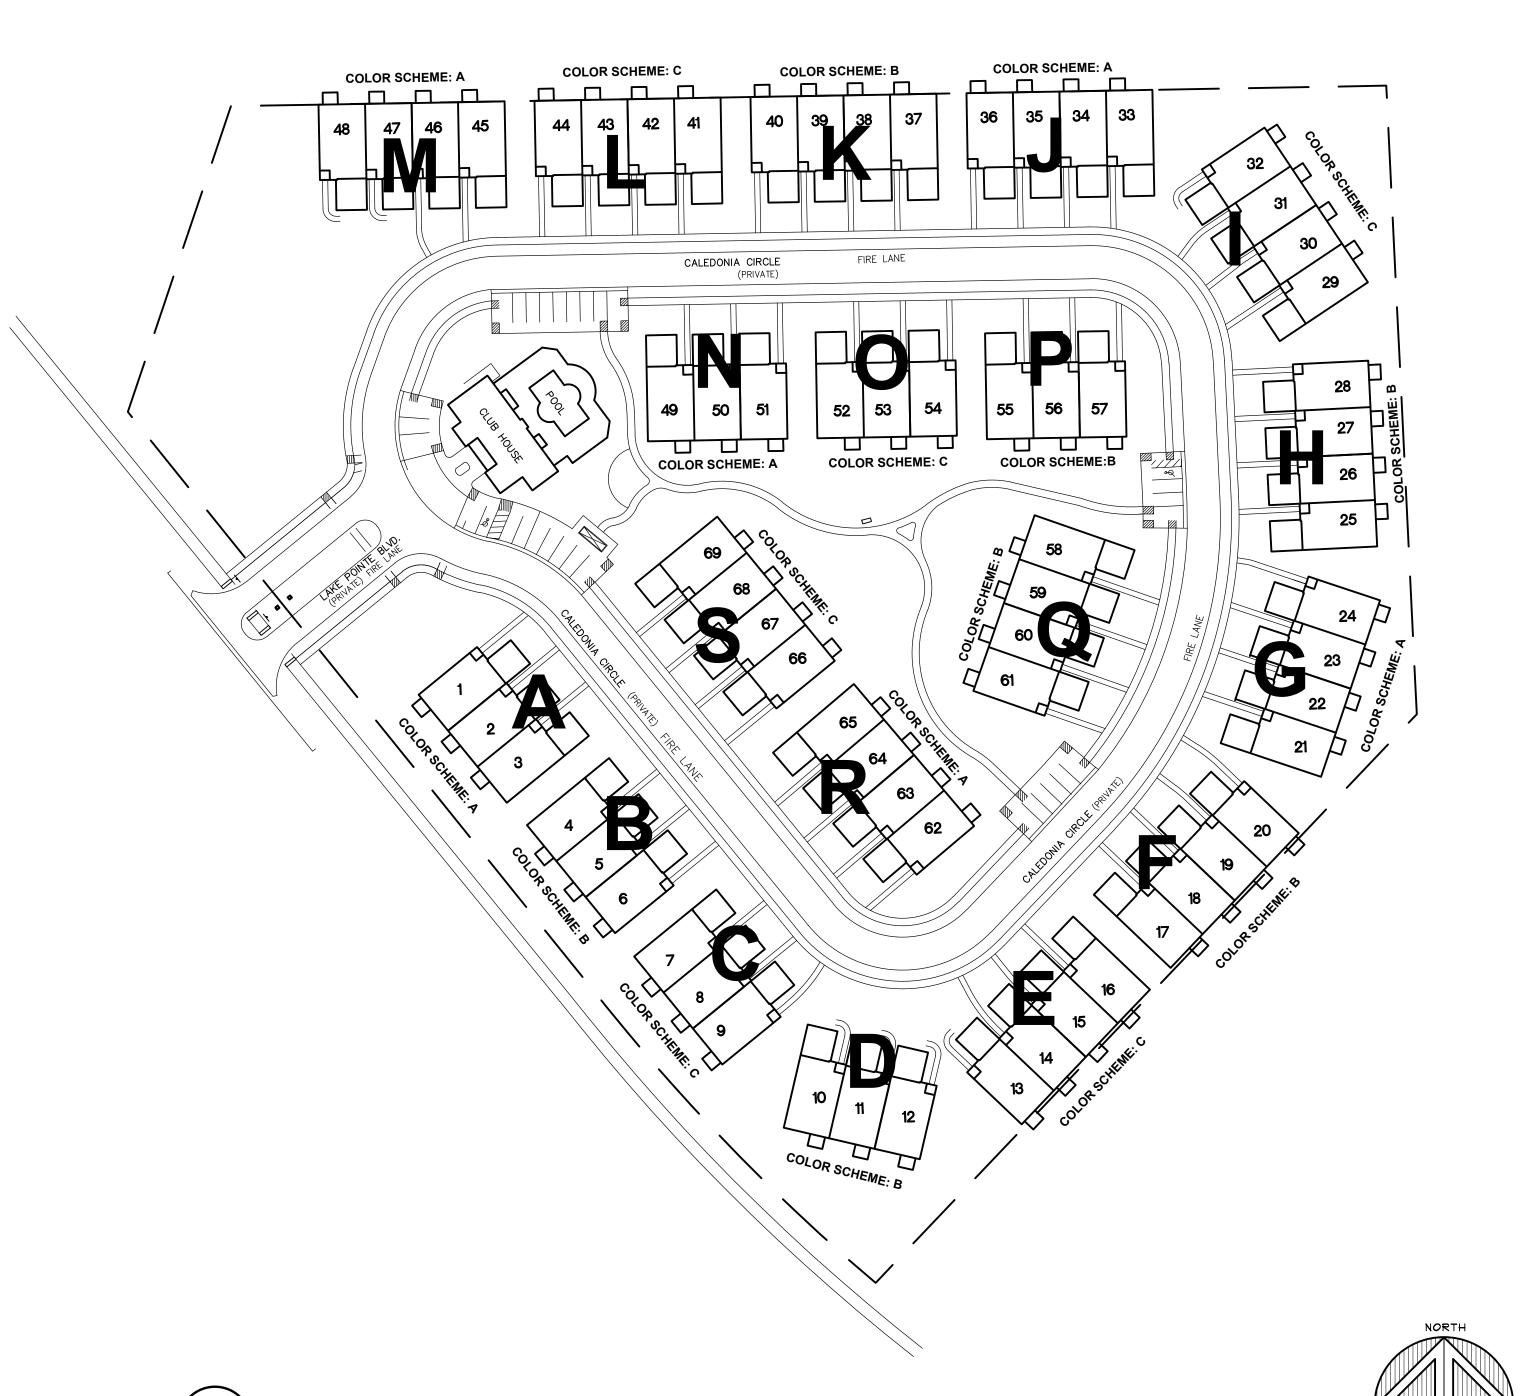

Planning **4rchitecture SS** $\overset{\circ}{\Omega}$

Blo

■ PRELIMINARY 08-19-19

REVISIONS 22-10-18 OWNER COMMENT RESPONSE 2024 02 06

MS/DA

2216.DWG CHECKED BY

Scale: NONE

NOTE: SITE PLAN SHOWN FOR REFERENCE ONLY. REFER TO CIVIL ENGINEERING DRAWINGS FOR ALL ADDITIONAL INFORMATION.

SITE PLAN





REVISED 12.4.17

Issued For:
REVIEW
11.11.16
REVISED
7.10.17
REVISED PER COMMENTS
10.12.17
REVISED

NOTE TO ALL CONTRACTORS :

ALL CONTRACTORS SHALL VERIFY & COORDINATE
ALL DIMENSIONS ON DRAWINGS, AS WELL AS REVIEW
& COORDINATE PLANS W/ EXTERIOR BLDG. ELEVATIONS,
SECTIONS, & DETAILS BEFORE COMMENCING WITH THE
WORK. IF DIMENSIONAL ERRORS OR CONFLICTS OCCUR
BETWEEN PLANS, BLDG. ELEVATIONS, SECTIONS & DETAILS
IT SHALL BE BROUGHT TO THE ATTENTION OF THE ARCHITECT
BEFORE PROCEEDING WITH THE WORK. CONTRACTORS WHO
FAIL TO VERIFY, REVIEW, & COORDINATE THE WORK,
& CONTRACTORS WHO SCALE DRAWINGS TO DETERMINE
PLACEMENT OF PART(S) OF THE WORK, SHALL TAKE FULL
RESPONSIBILITY SHOULD THAT PORTION OF THE WORK BE
IMPROPERLY LOCATED OR CONSTRUCTED.

MATERIAL LEGEND

A ASPHALT SHINGLES

B MET. DRIP EDGE & GUTTER ON 2x8 WD. TRIM FASCIA (ALUM. CLAD)

MET. DRIP EDGE ON

2x8 WD. TRIM RAKE BD. (ALUM. CLAD)
1x4 WD. TRIM SUB-RAKE BD. (ALUM. CLAD)

E IX6 VINYL TRIM

VINYL CORNER TRIM

G HORIZ. VINYL SIDING

BRICK W/ BRICK SILL


VINYL SHAKE SIDING

K 12" RD COLUMN

L MTL FLASHING

M ROOF JACK

 $\left\langle \begin{array}{c} N \end{array} \right\rangle$ DOWNSPOUT

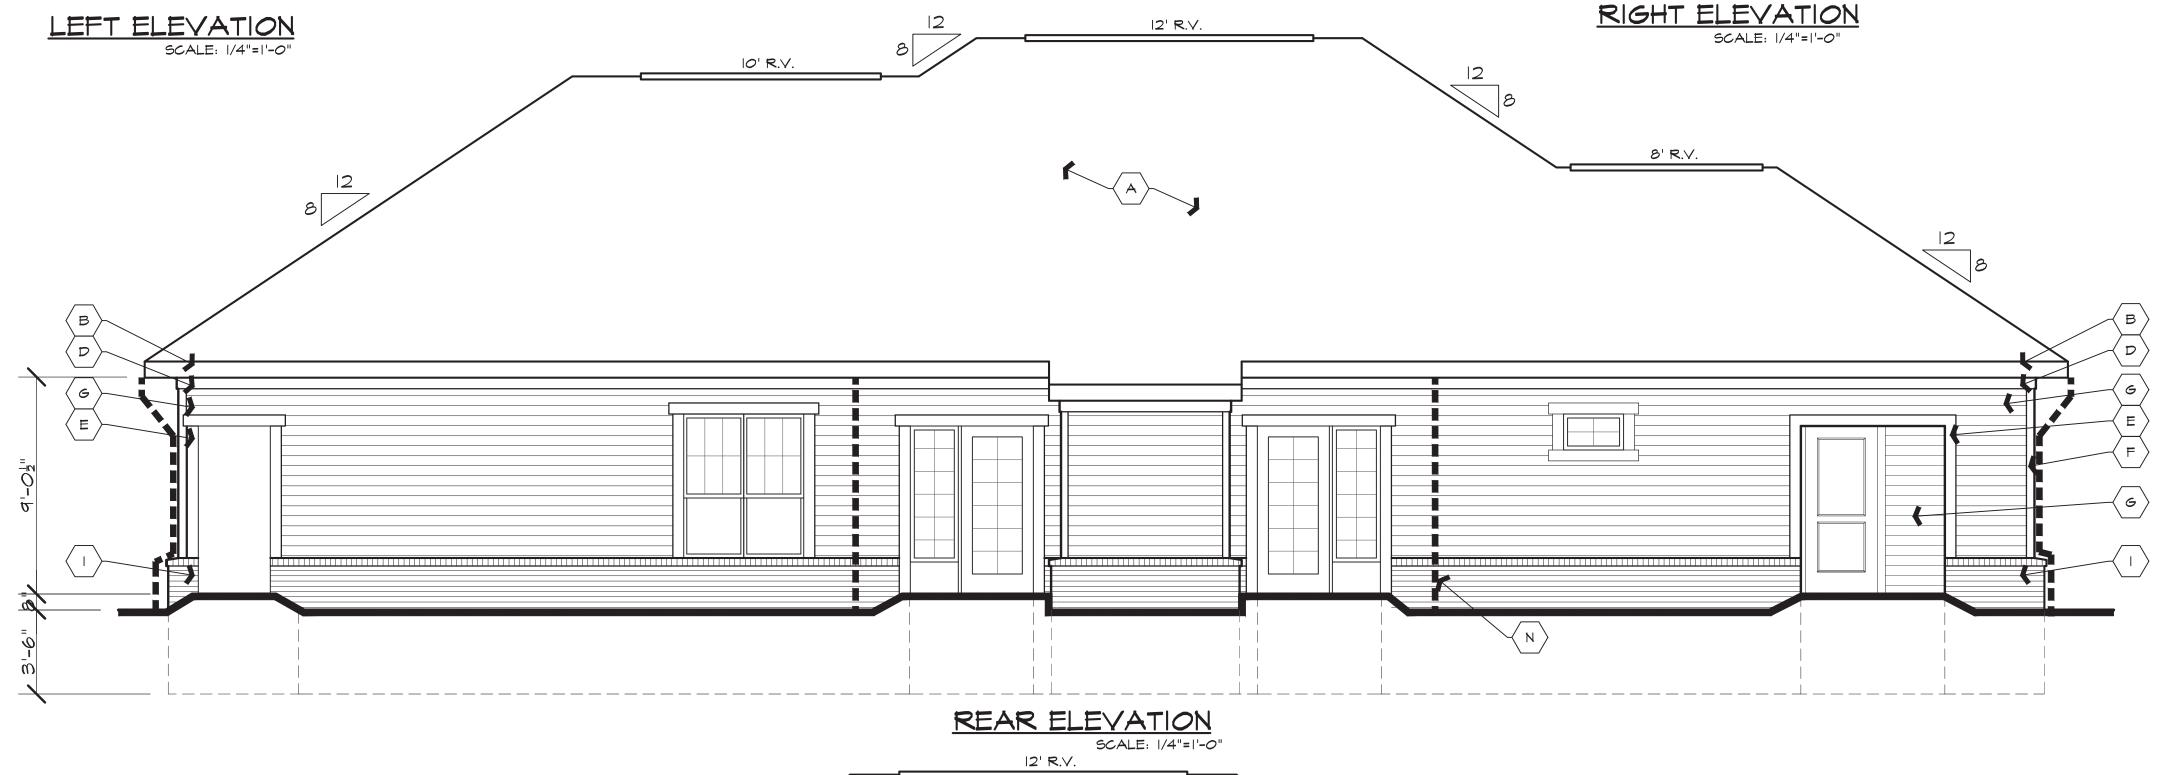

FAIRVIEW

Developer:

COMPANIES 1700 W. Big Beaver, Suite 120 Troy, Michigan 48084

Project:

ENCORE at DEERHILL

Independence Township, Michigan

Sheet Title:


COMMUNITY
BUILDING
ELEVATIONS

Project Number: 16-122

Drawn: RCC

Checked: DT
Date: 9.23.16

Sheet Number: CB4.0

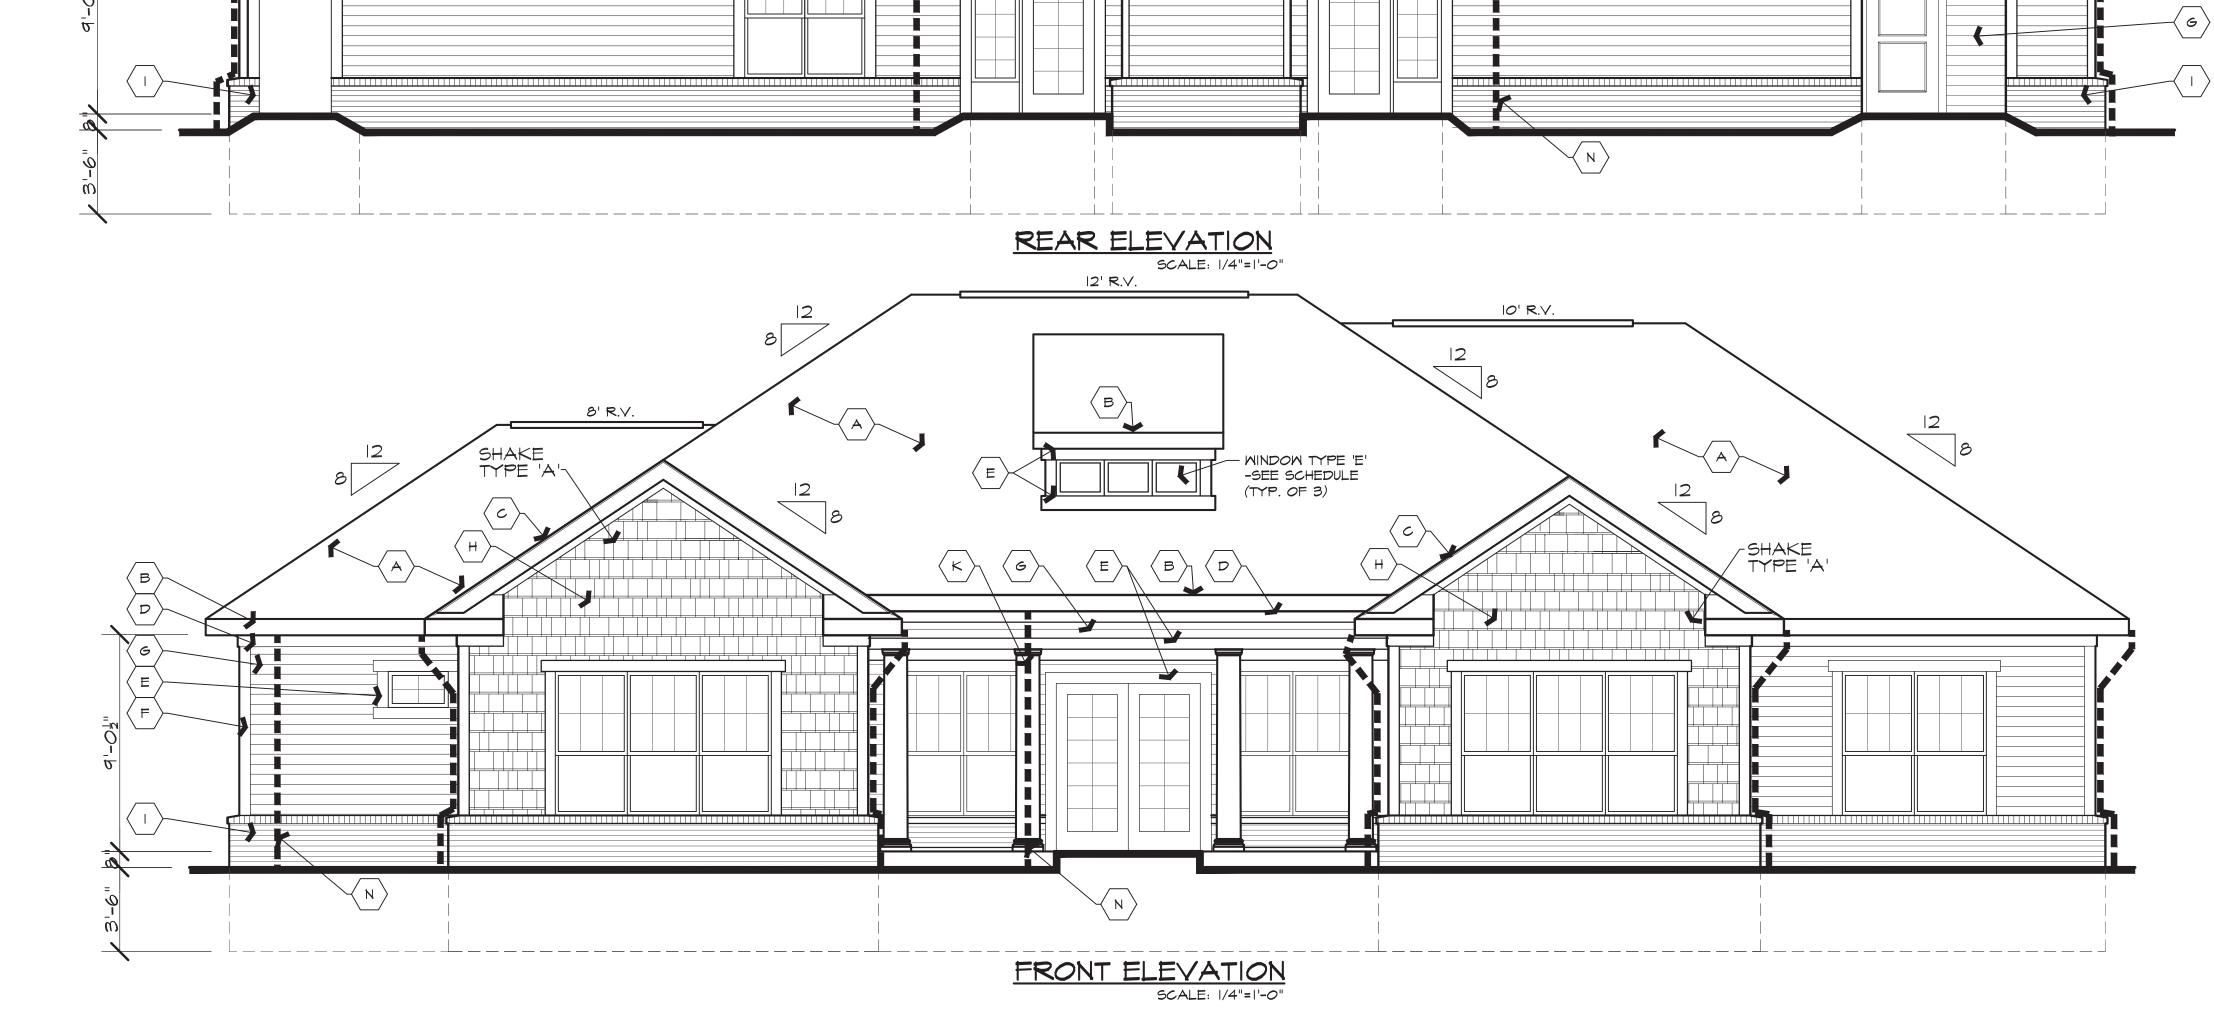



August 7, 2024

Sean O' Neil, Director Community Development Department Charter Township of White Lake 7525 Highland Road White Lake, Michigan 48383

RE: Lake Pointe Apartment Development – Planned Development Agreement – 6th Review

DLZ Job No. 1745-0385-00

Dear Mr. O' Neil,

The applicant is proposing a 69 unit attached single family apartment development on a 13.32 acre parcel located off Union Lake Road. This is a review of the proposed PDA documents that were prepared for JMF White Lake, LLC. and were submitted to this office on July 29, 2024 via Dropbox.

The following items were submitted as part of this review:

Draft PDA Agreement

Please note that comments from our June 27, 2024 review are in italics. Responses to those items are in **bold**. New comments are in standard font.

We offer the following comments for your consideration:

General

- 1. We generally defer comment regarding document format and agreement language to the Township Attorney. Comment remains.
- 2. We defer to the Township regarding item 2.4 and whether the Township does indeed waive the Traffic Impact Assessment, and Community Impact Statements. Comment partially addressed. A Traffic Impact Assessment was submitted and reviewed by Township staff and consultants. It is unknown whether a Community Impact Statement has been submitted and reviewed by the appropriate parties. Comment addressed. Design engineer has stated that a Community Impact Statement is not required by the Township. The requirement for a Community Impact Statement

WLT- Lake Pointe PDA – Review .06
August 7, 2024
Page 2 of 3



was waived at the White Lake Township Board meeting on May 18, 2021. Comment remains as a notation.

- 3. We defer to the Township with respect to whether there will be restrictions and by laws since this development is to be single family apartments. Our concern is the protection of surface drainage easements from encroachments so as surface drainage in these areas does not become impeded. Comment rescinded, design engineer has stated that this development consists only of rental properties and will thus be under the control of a single owner. Comment remains as a notation.
- 4. A Storm Maintenance Agreement and Lien are required as noted in our February 22, 2021 Final Engineering Review letter. The Storm Sewer and Detention Basin Easement documents were provided with this PDA review. The Maintenance Agreement will need to contain language referencing shared maintenance responsibility between Lake Pointe and West Valley as detention basin discharge from Lake Pointe will flow through West Valley's storm sewer system. Comment remains as a notation; we recommend approval subject to preparation and approval of a joint maintenance agreement regarding the storm sewer. Article IV Section 4.6 references the parties will enter into stormwater maintenance and easement agreements; we recommend this language be revised to match the Township standard form which is titled "storm water management facilities easement, maintenance agreement, and lien". We also recommend the reference to item (c) be removed as the Comfort Care Senior Living facility has no connection to the Lake Pointe development.
- 5. Item 4.11 of the agreement references the requirement to obtain an off-site easement from Independence Village in order to extend the proposed sidewalk fronting Union Lake Road. Per a Zoom meeting held with our office and the developer, as well as the developer's engineer on May 30, 2024, the portion of sidewalk fronting Independence Village will not be done. The developer noted in this meeting that Independence Village is not willing to provide an easement document for the sidewalk extension. We recommend this language (Article IV, Item 4.11 of Agreement) be removed from the agreement; however, we will defer to the Township Attorney regarding this item.

WLT- Lake Pointe PDA - Review .06 August 7, 2024 Page 3 of 3

Recommendation-

We recommend approval of the PDA subject to incorporation of the above referenced items. If you have any questions, please feel free to contact us.

Sincerely,

DLZ Michigan

Michael Leuffgen, P.E. Department Manager

Victoria Loemker, P. E. Senior Engineer

Cc: Andrew Littman, Community Development, via email Aaron Potter, DPS Director, via email

Hannah Kennedy-Galley, Community Development, via email

Lisa Hamameh, RSJA Law, via email

 $X:\Projects\2017\1745\038500\ WLT\ Lake\ Pointe\PDA\ Review\Submittal\ \#6\Review.06.docx$

LISA J. HAMAMEH Ihamameh@rsjalaw.com

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July 30, 2024

via email only: soneil@whitelaketwp.com
Sean O'Neil
Community Development Director
White Lake Township
7525 Highland Road
White Lake, Michigan 48383

RE: 6th Review of Planned Development Agreement Lake Pointe

Dear Sean:

You asked that we review the proposed revised Planned Development Agreement for Lake Pointe ("Agreement") submitted by JMF White Lake, LLC ("Developer"). There were no Exhibits attached to this draft and, therefore, we defer to the Township Engineer regarding the Exhibits. Our comments regarding the Planned Development Agreement follow:

General Comments

- 1. As stated in previous correspondence, prior to the execution of the Agreement, the Developer must provide documentation evidencing ownership of the Property. Developer has provided an unrecorded Warranty Deed, dated March 26, 2021. The Township may want to verify it has been recorded at the Register of Deeds and there have been no ownership changes since that time by reviewing property documents or assessing records, or by requesting a title search. In addition, a company resolution authorizing the signer to execute the Agreement on behalf of the LLC is required.
- As stated in previous correspondence, the Township should consider whether the
 development schedule provided in Paragraph 4.2 is acceptable. The Zoning Ordinance
 requires a development schedule, including any individual stages or phases, and the
 anticipated beginning and completion dates.
- 3. Paragraph 1.2 should be revised to move the last sentence after the first sentence so the events occur chronologically. Additionally, this Paragraph provides that the Final Site Plan expired on July 7, 2024. Has that been extended again?
- 4. Paragraph 1.5 should be revised to coincide with the Township's Zoning Ordinance, Section 6.7(E). For example, the second sentence defines "minor changes" to be limited to those provided in the ordinance, but also expands the definition to include Section

6.7(E)(ii and iii) which are <u>not</u> "minor changes" and may not be approved administratively. Additionally, Community Development Director should replace the term Planning Director.

5. While a provision was added to Paragraph 4.6 to address storm water maintenance easement in light of the shared facilities with West Valley and Comfort Care, additional discussion is needed. A meeting to discuss this issue is recommended

6. While I recognize these are new requests, the Agreement should be revised to include the

following provisions:

a. A breach provision to provide:

- 1. Any breach of this Agreement shall constitute a nuisance *per se* which shall be abated. The parties therefore agree that, in the event of a breach of this Agreement by Developer, which is not cured in accordance with this Agreement, the Township, in addition to any other relief which it may be entitled to at law or in equity, shall be entitled under this Agreement for an order of a court of competent jurisdiction providing for relief in the form of injunctive relief or specific performance requiring abatement of the nuisance *per se*.
- 2. In the event of a breach of this Agreement, the Township may notify Developer of the occurrence of the breach and issue a written notice requiring the breach be cured within thirty (30) days; provided, however, that if the breach, by its nature cannot be cured within thirty (30) days, Developer shall not be in breach hereunder if Developer commences the cure within the thirty (30) day period and diligently pursues the cure to completion.

b. a provision acknowledging that at the time of execution of the Agreement, the Owner will not have yet obtained engineering approvals for the Development and that additional conditions may be imposed, provided that no such conditions be inconsistent with the PD Plan or this Agreement and shall not change or eliminate any development right authorized thereby. Those conditions shall be incorporated into and made part of this Agreement automatically upon issuance of said conditions.

If you have any additional questions or would like to discuss this matter further, please call.

Very truly yours,

ROSATI SCHULTZ JOPPICH

& AMTSBUECHLER PC

Lisa J. Hamameh

cc: M. Leuffgen

V. Loekmker

PLANNED DEVELOPMENT AGREEMENT LAKE POINTE

Entered into between:

JMF Union Lake, LLC

A Michigan limited liability company

and

Charter Township of White Lake, a Michigan Charter Township

Dated: ______, 2024

PLANNED DEVELOPMENT AGREEMENT

(Lakepoint – White Lake Township)

This Planned Development Agreement (the "Agreement") is entered into as of ______, 2024, by and among JMF Union Lake, LLC, a Michigan limited liability company, whose address is 1700 W. Big Beaver Road, Suite 120, Troy, Michigan 48084 (hereafter referred to as "Developer" or "Owner"), and Charter Township of White Lake, a Michigan Charter Township, whose address is 7525 Highland Road, White Lake, Michigan 48383 ("Township").

RECITALS

- A. Developer owns certain real property consisting of approximately 13.32 acres located in the Township on the northeast side of Union Lake Road and northwest of Carpathian Drive, which is more particularly described on **Exhibit A** attached hereto (the "Property"). The Property is zoned PD, or Planned Development by the Township.
- B. Developer desires to develop the Property as multi-family, residential housing project consisting of 69 units as depicted in the Final Site Plan prepared by Seiber, Keast Engineering, L.L.C. (Job No. 19-039, revised February 13, 2024), attached hereto as **Exhibit B** (the "Final PD Plan"), for the proposed Lake Pointe residential development (the "Project").
- C. At a meeting held by the Township Planning Commission on January 16, 2020, the Township Planning Commission recommended approval of Developer's revised Preliminary Site Plan, subject to conditions.
- D. At a meeting held by the Township Board on January 21, 2020, the Township Board approved the revised Preliminary Site Plan, subject to conditions.
- E. At a meeting held by the Township Board on February 16, 2021, the Township Board approved a one-year extension of the revised Preliminary Site Plan for the Project.
- F. At a meeting held by the Township Planning Commission on May 6, 2021, the Planning Commission approved the Final Site Plan, subject to conditions, and

- recommended approval of the Planned Development Agreement to the Township Board.
- G. At a meeting held by the Township Board on May 18, 2021, the Township Board approved the Planned Development Agreement and waived the requirement for a community impact statement.
- H. At a meeting held by the Township Planning Commission on February 1, 2024, the Planning Commission approved an extension of the Final Site Plan until July 7, 2024.
- I. By entering into this Agreement, Owner and the Township desire to set forth the parties' obligations with respect to the Planned Development for the Property and the Project and the terms and requirements under which the Property and the Project shall be developed.

NOW, THEREFORE, in consideration of the premises and the mutual covenants of the parties described in this Agreement, the parties agree as follows:

ARTICLE I

DESCRIPTION OF THE PROJECT; PD AND PD PLANS

- 1.1. <u>Description of Project.</u> The project ("Project") covers an area comprising approximately of 13.32 acres located on the northeast side of Union Lake Road and west of Williams Lake Road. The Project will consist of 69 attached residential rental housing units. Each residence will be ranch-style dwelling with a 2-car attached garage.
- 1.2. PD Plan Approval; Exhibits. The revised Preliminary Site Plan prepared by Sieber, Keast Engineering, L.L.C. was approved by the Township Board on January 21, 2020, and thereafter extended for one year by the Township Board at its meeting held on February 16, 2021. On May 18, 2021, the Township Board approved the original Planned Development Agreement, which thereafter expired, and then on August _____, 2024, approved this Agreement, which approval grants Developer the right to construct facilities as set forth in the Final PD Plan, subject to this Agreement and all applicable permits in the ordinary course, as the same may be modified and amended in accordance with the Township Zoning Ordinance from time to time. All exhibits attached hereto are incorporated herein and made a part hereof by reference. Thereafter, the Final Site Plan was extended by the Planning Commission to July 7, 2024.
- 1.3. <u>Performance Criteria.</u> Developer affirmatively submits that the proposed uses on the Property shall not exceed the performance criteria found in the Township Zoning Ordinance and the standards listed therein.
- 1.4. <u>Waivers and/or Modifications to Standard Zoning Requirements.</u> Except as otherwise provided in this Agreement and the Final PD Plan, Developer shall adhere to all applicable

Township ordinances, codes, rules, regulations and standards. Waivers from the Township Zoning Ordinance which the Township shall be deemed to have granted, and hereby grants, as well as modifications to standard zoning requirements which will be requested, if any, are as set forth on the Final PD Plan and this Agreement.

- 1.5. <u>Minor Modifications.</u> If, following the approval of the Final PD Plan, Developer proposes minor changes to the Final PD Plan, including changes required during final engineering review and required by other State and County regulatory agencies, such minor changes may be made subject only to "Administrative Approval". The term "Minor Changes" shall be those changes set forth in the Township Zoning Ordinance, Article 6, Section 6.7(E)(i-iii). For purposes of this Agreement, "Administrative Approval" shall mean the approval by the Planning Director of the Township, or his/her designee, or such other individual as may be designated by the Township Board, without the necessity of review by the Township Board or the Township Planning Commission or any amendment to this Agreement.
- 1.6. Statement of Planning Objectives and Community Benefits to be Achieved by the **Project.** The primary planning objectives of this development are to create alternative, high quality rental housing options that appeal to both active retirees and empty nesters who want to stay in place or be attracted to the White Lake community and to meet the needs and growing demand of younger working and professional millennials for high quality rental housing, consistent with the Master Plan objective to provide for a diversity of housing opportunities in the Township. The Project will provide more open space and less housing density than permitted under the applicable zoning ordinance and Master Plan. A substantially larger open space area is achievable because of the unique situation where the Developer also owns the West Valley development on the southwest side of Union Lake Road and can provide an integrated storm drainage system serving multiple properties. For the reasons described in paragraph 2.3 below, Developer also agreed to contribute \$15,000 for the installation of speed bumps in the neighboring Bocovina development. Developer will also contribute: (a) to the Township the sum of \$2,050 for the future installation of approximately 630 square feet of offsite concrete sidewalk along Union Lake Road to Independence Circle; and (b) the sum of \$7,500 to the Park Fund. While the density of the Project is consistent with the existing zoning, the contribution to the Park Fund will assist the Township in continuing to furnish public amenities that will serve the new residents of the Project. The Project also includes substantial on-site recreational amenities, including walking paths, seating areas and a swimming pool and clubhouse.

ARTICLE II

REQUIREMENTS FOR DEVELOPMENT

2.1. **<u>Development Standards.</u>** The Property shall be developed and improved in compliance with the following:

- (a) The Charter Township of White Lake Zoning Ordinance, as amended, and engineering design standards, except where modified by this Agreement and the Exhibits attached hereto;
- (b) This Agreement;
- (c) The Final PD Plan;
- (d) The conditions set forth in Paragraph 2.3 below; and
- (e) All applicable federal, state and county laws, rules and regulations.
- 2.2. Effect of PD Approval. To the extent that developing the Property in accordance with this Agreement and the PD Plan will deviate from the Zoning Ordinance or any other Township Ordinance or regulation, this Agreement and the Final PD Plan shall control. To the extent this Agreement and PD Plan attached hereto are silent on development issues, the Project shall comply with the Zoning Ordinance and other Township ordinances and regulations. All improvements constructed in accordance with this Agreement and the Final PD Plan shall be deemed to be conforming under the Zoning Ordinance and in compliance with all ordinances of the Township. The Project shall not be subject to any additional requirements contained in any amendments or additions to Zoning Ordinances adopted subsequent to the date of this Agreement which conflict with the provisions of this Agreement including the PD Plan and/or any plans which are approved pursuant to this Agreement.
- 2.3. Conditions to Approval. Prior to commencement of construction of the Project, Developer will: contribute the sum of up to \$15,000 to pay for speed bumps to be installed in the neighboring Bocovina residential development per a separate written agreement with the Bocovina's homeowners association; and deliver the sum of \$2,050 to the Township for future installation of an off-site concrete sidewalk as described in paragraph 1.6 above. The purpose of the speedbumps is to both discourage cut-through traffic and reduce traffic speeds for safety of the residents. The off-site sidewalk contribution is intended to further the Township's objective of achieving connectivity and non-motorized access throughout the Township. In addition, no bars shall be installed on the back of patios to interfere with access to the open space from the patios.
- 2.4. <u>Traffic Impact Assessment.</u> Revised traffic impact assessments dated December 2, 2019, and June 7, 2024, prepared by Fleis & Vandenbrink were received and reviewed by Township staff and consultants.

ARTICLE III

USES WITHIN THE PROJECT

3.1. **Approved Uses for the Project.** The Project will consist of 69 ranch-style residential units (or a density at 5.41 units per acre) in 19 buildings. Each residence shall have two bedrooms and an attached 2-car garage and each building shall contain no more than 4-attached residential dwelling units.

3.2. **Project Amenities.** In order to provide on-site recreational amenities to serve the residents of the Project, Developer will install a clubhouse and pool as depicted in the Final PD Plan. An open space area consisting of approximately 8.42 acres will be maintained, with walking paths, seating, a pergola structure and dog waste stations as depicted in the Final PD Plan.

ARTICLE IV

DEVELOPER'S RIGHTS AND OBLIGATIONS

- 4.1. **Right to Develop.** Developer shall have the right to develop the Property in accordance with the PD Plan and this Agreement.
- 4.2. <u>Development Schedule.</u> Developer shall commence development of the Project within 12 months from the Township's approval of this Agreement. The intent is complete the development as a single phase once commenced. The foregoing development schedule may be modified by Developer as necessary or appropriate based on the timing of State and County agency approvals, market and other conditions, with the Township's consent, which shall not be unreasonably withheld or delayed.
- 4.3. <u>Internal Roads in the Project.</u> The internal roads within the Project will be private and constructed in accordance with Final PD Plan, Township Engineering Design Standards, approved Final Engineering Plan, and RCOC Approval.
- 4.4. <u>Landscape Plan.</u> The Landscape Plans, Sheets LS-1 through LS-7, which are part of the Final PD Plan attached hereto as Exhibit B, identify the landscaping to be installed within the Project.

4.5. <u>Utilities.</u>

- (a) <u>Sanitary Sewer System.</u> Sanitary sewers shall be extended by the Developer to serve the Project which must connect to the Township's sanitary sewer system. Connection to the sanitary sewer system shall require payment of all applicable fees, charges, and assessments, in accordance with the Township's Ordinance. The Final PD Plan identifies the sewer lines and related sanitary sewer easements to be dedicated to the Township as depicted in the Easement for Sanitary Sewer Exhibits.
- (b) <u>Water System.</u> Water service shall be extended by the Developer to serve the Project which must connect to the Township's water system. Connection to the water system shall require payment of all applicable fees, charges, and assessments, in accordance with the Township Ordinance. The Final PD Plan identifies the water lines and related water easements to be dedicated to the Township as depicted in the Easement for Watermain Exhibits.
- 4.6. <u>Storm Water Detention.</u> Storm water shall be conveyed by a storm sewer system to a storm water detention basin located within the Project as shown in the Final PD Plan. All such storm water drainage facilities, including the detention basin and all related improvements shall be designed in accordance with all applicable ordinances and

engineering regulations and standards as depicted in the Easement for Storm Sewer Exhibits. Prior to commencement of construction, the parties (and, to the extent applicable, third parties) will enter into the following a separate sStormwater mMaintenance and easement aAgreements utilizing standard Township agreement forms: (a) stormwater agreement for the Project; (b) stormwater agreement serving both the Project and the proposed adjacent West Valley development; and (c) a stormwater overflow easement for the Comfort Care Senior Living facility on nearby land. in a form to be mutually agreed upon by the parties in the exercise of reasonable discretion.

- 4.7. <u>Signs.</u> The entrance signage and other directional signage for the Project shall be as depicted in the Final PD Plan. Any additional signage or modification of signage proposed to be installed will have to be approved by the Township and Developer will comply with all the sign regulations in the Township's sign ordinance.
- 4.8. <u>Architectural and Site Design Guidelines.</u> The Project shall be developed in conformance with the following architectural and site minimum standards:
 - (a) <u>Minimum Setbacks.</u> Setback requirements shall be in accordance with the approved final PD Plan.
 - (b) <u>Exterior Materials.</u> The building elevations and exterior materials shall be consistent with the elevations and materials set forth in the Final PD Plan and any modifications to same will be of equal or better quality and durability and shall be approved in accordance with the Township Zoning Ordinance.
 - (c) <u>Driveways and Sidewalks.</u> Curbs, gutters and sidewalks shall be constructed of concrete and shall be in accordance with the approved Final PD Plan and approved Final Engineering Plan. Driveways shall be constructed of concrete.
- 4.9 <u>Permits and Authorizations.</u> All state, county and federal permits required for completion of the project shall be approved prior to the scheduling of a pre-construction meeting with Developer and the Township staff and consultants.
- 4.10 <u>Improvements and Alternations.</u> Developer shall not engage in any improvements or alterations on the Property, including, without limitation, site grading work or installation of utilities, until completion of the pre-construction meeting.
- 4.11 Offsite Pathway/Sidewalk Easement. Developer agrees that it shall obtain a fully executed offsite pathway/sidewalk easement from the adjoining owner(s) of Independence Village in such form as is approved by the Township, prior to scheduling the preconstruction meeting.

ARTICLE V

MAINTENANCE OF OPEN SPACE

5.1. <u>Common Elements and Common Facilities.</u> The Developer shall have the responsibility for maintaining the open space and installed landscaping located within the Project.

ARTICLE VI

TOWNSHIP'S RIGHTS AND OBLIGATIONS

- 6.1. **Permits and Authorizations.** The Township shall grant to Developer and its contractors and subcontractors all Township permits and authorizations necessary to bring and/or construct all utilities necessary to service the Property and to otherwise develop and improve the Property in accordance with the Final PD Plan, provided the Developer has first made all requisite filings and submissions for permits, complied with the requirements for said permits or authorizations submittals, and paid all required fees in accordance with the Township's Ordinances. Any applications for permits or authorizations from the Township will be processed in the customary manner. The Township shall cooperate with Developer in connection with Developer's applications for any necessary county, state, federal or utility company approvals, permits or authorizations to the extent that such applications and or discussions are consistent with the Final PD Plan and this Agreement and provided that the Township shall not be required to initiate legal proceedings or assume any financial obligations of Developer, including without limitation the payment of any compensation, cost or fee. Once appropriate approvals are granted, Developer shall be entitled to obtain a grading permit from the Township and thereafter commence grading and clearing activities.
- 6.2. Township Action For Failure to Maintain Property. In the event the Developer defaults in its obligation to maintain the property in a reasonable condition, using reasonable standards, and consistent with and as required under the Final PD Plan and this Agreement, the Township may serve written notice upon Developer setting forth the manner in which Developer has failed to maintain the Property, and such notice shall include a demand that deficiencies be cured within a stated reasonable time period no less than thirty (30) days, and shall set forth the date, time and place of a hearing before the Township Board for the purpose of allowing Developer to be heard as to why the Township should not proceed to perform the maintenance which has not been undertaken. In that hearing, the time for curing such deficiencies, and the hearing itself, may be extended. If, following the hearing, the Township Board shall determine that the Developer has not cured such deficiency within the time specified at the hearing, then upon five (5) days written notice to Developer, the Township shall thereupon have the power and authority, but not the obligation, to enter upon the Property or cause its agents or contractors to enter upon the Property to cure such deficiency as reasonably found by the Township to be appropriate and/or necessary, in a manner so as to reasonably minimize any interference with the residential occupancy and use the Property and the cost and expense of such curative actions, including the cost of notices by the Township and reasonable legal, planning, and engineering fees and costs incurred by the Township shall be paid by the Developer. Such amount shall constitute a lien on the Property and the Township may require such costs and expenses to be paid prior to the commencement of work. If such costs and expenses have not been paid within sixty (60) days of a billing to the Developer, all unpaid amounts may be (a) placed on a delinquent tax roll of the Township as to the Property and shall accrue interest and penalties and shall be collected as and shall be deemed delinquent real property taxes in

the discretion of the Township; or (b) assessed against the Developer and collected as special assessment on the next annual Township tax roll; or (c) collected by use of the applicable provisions of Michigan law providing for foreclosure by advertisement, the Owner having specifically granted the Township the required power of sale to do so; or (d) collected by suit against Developer. If suit is initiated, the Developer shall pay all of the Township's reasonable legal fees and costs. The selection of remedy shall be at the sole option of the Township, and election of one remedy shall not waive the use of any other remedy.

ARTICLE VII

MISCELLANEOUS PROVISIONS

- 7.1. <u>Governing Law.</u> This Agreement shall be governed by and construed in accordance with the laws of the State of Michigan.
- 7.2. <u>Counterparts.</u> This Agreement may be executed in multiple counterparts, each of which shall be deemed an original and all of which shall constitute an agreement. The signature of any party to any counterpart shall be deemed to be a signature to, and may be appended to, any other counterpart.
- 7.3. Successors and Assigns. The terms, provisions and conditions of this Agreement are and shall be deemed to be of benefit to the Property and shall run with and bind the Property, and shall bind and inure to the benefit of the successors and assigns of the parties to this Agreement.
- 7.4. <u>Amendment.</u> This Agreement may only be modified by written agreement of the Township and Developer or any successor in title who assumes Developer's rights and obligations hereunder.
- 7.5. Authority. This Agreement has been duly authorized by all necessary action of Developer and the Township, through the approval of the members of the Developer and the Township Board at a meeting in accordance with the laws of the State of Michigan, and the ordinances of the Township. By the execution of this Agreement, the parties each warrant that they have the authority to execute this Agreement and bind the Property in its respective entities to its terms and conditions.
- 7.6. **Partial Invalidity.** Invalidation of any of the provisions contained in this Agreement or the application thereof to any persons by judgment or court order shall in no way affect any of the other provisions hereof or the application thereof to any other person and the same shall remain in full force and effect.
- 7.7. **No Partnership.** None of the terms or provisions contained in this Agreement shall be deemed to create a partnership or joint venture between Developer and the Township.
- 7.8. <u>Incorporation of Documents.</u> The recitals contained in this Agreement, the introductory paragraph, and all exhibits attached to this Agreement and referred to herein shall for all

- purposes be deemed to be incorporated in this Agreement by this reference and made a part of this Agreement.
- 7.9. <u>Integration Clause.</u> This Agreement is intended as the complete integration of all understandings between the parties related to the subject matter herein. No prior contemporaneous addition, deletion, or other amendment shall have any force or effect whatsoever, unless referenced in this Agreement.
- 7.10. **Recording.** This Agreement shall be executed by the parties and recorded by the Township in the office of the Oakland County Register of Deeds. All recording fees shall be paid by the Developer.
- 7.11. Waiver. Failure of either party to insist upon strict performance of any of the terms, conditions or covenants hereof shall not be deemed to be a waiver of any rights or remedies that such party may have hereunder, at law or in equity, and shall not be deemed a waiver of any subsequent breach or default under this Agreement. No waiver by either party of any default under this Agreement shall be affecting or binding unless made in writing and no such waiver shall be implied from any omission by the party to take an action with respect to the default. No express written waiver of any default shall affect any other default or cover any other period of time, and one or more written waivers of any default shall not be deemed to be a waiver of any subsequent default in performance of the same or any other term or provision contained in this Agreement.
- 7.12. <u>Violations.</u> Violations of the provisions of this Agreement shall be deemed to be violations of the Township Zoning Ordinance and shall entitle the Township to all rights and remedies provided by the Zoning Ordinance or any other applicable law for such violation.
- 7.13. **Acknowledgments.** The parties negotiated the terms of the Agreement and the parties agree that its terms, conditions and requirements are lawful and consistent with the intent and provisions of local ordinances, state and federal law. Developer has offered and agreed to proceed with the undertakings and obligations as set forth in this Agreement in order to protect the public health, safety, and welfare and provide material advantages and development options for Developer, all of which undertakings and obligations the parties agree are necessary in order to ensure public health, safety, and welfare, to ensure compatibility with adjacent uses of land, to promote use of the Property in a socially, environmentally, and economically desirable manner, and to achieve other reasonable and legitimate objectives of the parties, as authorized under applicable Township ordinances and the Michigan Zoning Enabling Act, MCL 125.3101, et seq., as amended. It is also agreed and acknowledged that the terms, conditions, obligations, and requirements of this Agreement are dearly and substantially related to the burdens to be created by the development and use of the Property under the approved PD, and are, without exception, clearly and substantially related to the Township's legitimate interests in protecting the public health, safety and general welfare. Furthermore, the parties fully accept and agree to the final terms, conditions, requirements and obligations of the Agreement and shall not be permitted in the future to claim that the effect of the Agreement results in an unreasonable limitation upon uses of all or any portion of the Property, or claim that enforcement of the

Agreement causes an inverse condemnation, other condemnation or taking of all or any portion of the Property.

(Signatures and notarization are contained on the following pages)

By:		JMF UNION LAKE, LLC, a Michigan limited liability company
Its: Sole Member and Manager Dated: STATE OF MICHIGAN) SS COUNTY OF OAKLAND) The foregoing Planned Development Agreement was acknowledged before me this day of, 2024 by Michael S. Furnari, the Sole Member and Manager of JMF Union Lake, LLC, a Michigan limited liability company, on behalf of said company. Notary Public Notary Public, State of Michigan, County of _		By:
STATE OF MICHIGAN) SS COUNTY OF OAKLAND) The foregoing Planned Development Agreement was acknowledged before me this day of, 2024 by Michael S. Furnari, the Sole Member and Manager of JMF Union Lake, LLC, a Michigan limited liability company, on behalf of said company. Notary Public Notary Public, State of Michigan, County of		Printed: Michael S. Furnari
STATE OF MICHIGAN) SS COUNTY OF OAKLAND) The foregoing Planned Development Agreement was acknowledged before me this day of, 2024 by Michael S. Furnari, the Sole Member and Manager of JMF Union Lake, LLC, a Michigan limited liability company, on behalf of said company. Notary Public Notary Public, State of Michigan, County of .		Its: Sole Member and Manager
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Notary Public Notary Public, State of Michigan, County of	day of, 2024 b	y Michael S. Furnari, the Sole Member and Manager of JMF
Notary Public, State of Michigan, County of	Union Lake, LLC, a Michigan limi	ted liability company, on behalf of said company.
Notary Public, State of Michigan, County of		
· · · · · · · · · · · · · · · · · · ·		Notary Public
Acting in the County of		Notary Public, State of Michigan, County of
My Commission Expires:		Acting in the County of _ My Commission Expires:

CHARTER TOWNSHIP OF WHITE LAKE, a Michigan Charter Township

	By:
	Printed:
	Its:
	Dated:
STATE OF MICHIGAN COUNTY OF OAKLAND	SS
COUNTION OAKLAND	
The foregoing Planned Deve	opment Agreement was acknowledged before me this
day of, 2024 by _	, the of
Charter Township of White Lake, Township.	a Michigan Charter Township, on behalf of said Charter
	Notary Public Notary Public, State of Michigan, County of Acting in the County of My Commission Expires:
Prepared by:	When recorded, return to:
Alan M. Greene, Esq. Dykema Gossett PLLC 39577 Woodward Avenue, Suite 300 Bloomfield Hills, MI 48304	White Lake Township c/o Township Clerk 7525 Highland Road White Lake, MI 48383

121352.000001 4865-5536-0723.1

EXHIBIT A

(Legal Description)

EXHIBIT B

(Final Site Plan)