50TH & RAINBOW DEVELOPMENT

W 50TH STREET & RAINBOW BLVD WESTWOOD, KANSAS 66205

Comprehensive Use Plan.

Attract and keep residents.

Retain and grow property values.

Support local / small business development

Protect and minimize impacts to adjacent residential property.

serve to provide additional amenities to the residents in the area.

school, while still in use, is scheduled to be vacated in August 2024.

developer as part of this project apart from a sales tax waiver on construction materials.

Offer indoor and/or outdoor community activity/gathering spaces.



MAIN BUILDING PERSPECTIVE RENDERING | L19

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PAVILION PERSPECTIVE RENDERING | A19

The following Deviations from the equivalent C-1 Zoning are requested as part of the proposed PD Planned Development District:

the west and north of the main building with 171 covered parking spaces. 125 surface parking spaces are also provided on the east and west sides of the main building.

The specific stated desired outcomes of the 5050 Rainbow Site, and the Westwood View Elementary site per the Westwood Comprehensive Use Plan are to:

Specifically related to Section 1.6.17 of the Zoning Ordinance Criteria for Considering Applications for a Rezoning Request:

facades of varying colors to also complement and blend into the surrounding residential neighborhood.

with current C-1 Zoning. Minor deviations are anticipated and included in the deviations list on the cover sheet.

5.3.7 A Unless otherwise indicated in a specific Overlay District, the facade of building in the C-1 District shall be constructed directly on the build-to line along at least seventy percent of the length of the building.

The proposed project would provide a vital fully integrated, mixed-use, pedestrian oriented commercial neighborhood that would meet all of the desired outcomes as listed in the Comprehensive Use Plan.

F. The extent to which approval of the application would detrimentally affect nearby properties. Approval of the application would have no detrimental effect on nearby properties. G. The extent to which the proposed use would substantially harm the value of nearby properties. The proposed use will not harm and may enhance the value of nearby properties.

retail shops throughout the day. Parking for the proposed development would be handled internally on the site so there would be minimal overflow to the surrounding area.

due to denial of the application, however if the application is denied, a substantial portion of the site would remain vacant and the future of city park would be in jeopardy.

The proposed development is surrounded by residential housing of 2 story scale set back typically 35-60 feet from Rainbow Boulevard. Placing the buildings at property line is inconsistent with surrounding scale and development. Placing the buildings back from Rainbow allows a softening of the perimeter to create a better scale with the neighboring houses as well as opportunity to create more habitable spaces for pedestrians, restaurants and retail. In effect it allows a place to be created versus a space directly adjacent

The 50th and Rainbow Development is a proposed Planned Development District (PD) located on the west side of Rainbow Boulevard between 50th Street in the City of Westwood, Kansas. The proposed project will feature approximately 22,509 square feet of retail space on the 1ST floor of the building and approximately 90,007 square feet of office space on 3 floors above the retail. Adjacent to the main building is a smaller 11,933 square foot single story office / retail building broken into two masses.

Because of the mixed-use nature of the proposed project, it is anticipated that portions of the first and second floors of the buildings may be a mix of retail and office uses in lieu of being strictly retail. An underground parking structure is located to

With regard to the 2017 Westwood Comprehensive Use Plan, the land use map in Section 3.3 identifies the proposed development location as Public / Semi-Public and Open Space. This usage type per Figure 3.2 accounts for only 4.4% and 0.8% of the overall city land use. Given the small percentage of space allocated to these uses, it seems vital to the community to maintain these land use types. The proposed development would offer a mixture of Public and Semi-Public spaces with office and retail buildings, and maintain the Open Space components with the proposed City Park. Alternatively, if the plan reverted to the R-1 Single Family Residence Zoning of the surrounding neighborhood, the location would become private space which would seem in conflict with the

A. The conformance of the proposed use to the City's Comprehensive Plan and other adopted planning policies. Per Section 6.2.2, a PD Planned Development district is equivalent to C-1 Zoning. The proposed development would be in substantial compliance

buildings have intentionally been pushed back from Rainbow Boulevard and the tallest of the buildings are at the center of the site to best fit in with the scale and character of the surrounding neighborhood. Additionally, the majority of existing trees will be preserved at the perimeter of the site to create a large multistory landscape buffer from surrounding neighbors and preserve the existing quality of the streetscape. Building massing has been broken down in plan and elevation to create smaller scaled

B. The character of the neighborhood including, but not limited to: Land use, zoning, density (residential), architectural style, building materials, height, structural mass, siting, open space, and floor-to-area ration (commercial and industrial). The proposed

C. The zonings and uses of nearby properties, and the extent to which the proposed use would be in harmony with such zonings and uses. All nearby properties are Zoned R-1 Single Family Residential. The proposed Development would bring a mix of office

D. The suitability of the property for the uses to which it has been restricted under the applicable zoning district regulations. While the current property could be utilized for single family residential, adding a mixture of office, retail and park functions would

E. The length of time the property has remained vacant as zoned. The former church site property along Rainbow Boulevard was acquired by the City of Westwood and the church was demolished to accommodate the city's plan for future development The

H. The extent to which the proposed use would adversely affect the capacity or safety of the portion of the road network influenced by the use, or present parking problems in the vicinity of the property. The existing site functions as both a school and a park, creating peak traffic times as well as various visitor traffic throughout the day. Traffic flow for the proposed development would be of a similar nature with peak traffic times at the beginning and end of the office work day, and various visitor traffic to the

J. The economic impact of the proposed use on the community. The Economic Impact of the proposed project would result in a net increase to the sales and property taxes received by the City of Westwood. No tax incentives are being requested by the

K. The gain, if any, to the public health, safety, and welfare due to denial of the application as compared to the hardship imposed upon the landowner, if any, as a result of denial of the application. No gain to the public health, safety and welfare would occur

and retail uses to the project compatible with the surrounding neighborhood providing residents walkable places to work and shop fullfilling the purpose of a fully integrated, mixed-use, pedestrian oriented neighborhood.

I. The extent to which the proposed use would create excessive air pollution, water pollution, noise pollution, or other environmental harm. No excess air, water or noise pollution or other environmental harm would occur.

Additionally, 5.5.1 B states that in C-1 Districts, off-street parking of no less than 75% of the parking places shall be to the rear or side of the building. As proposed 85% of the parking spaces will be .

Underground rock is currently located at elevation 936 only a few feet below grade. Due to the natural slope of the site from a high on the southeast, placing all parking to the rear of buildings would create a primary retail entrance via an

5.3.7 C Parking areas and parking garages shall be recessed or placed to the rear of buildings.

5.5.1 B states that in C-1 Districts, off-street parking of no less than 75% of the parking places shall be to the rear or side of the building. The proposed development has 85% of parking areas and parking garages at the rear or side of the building, hidden from view. The natural topography of the site sets itself up to place a recessed garage at the rear of the buildings with a small surface parking lot in front of the buildings to allow visible access to the retail and office entries.

5.3.8 A B C One-, two-, and three-story buildings are permitted in the C-1 Mixed-use Districts.

The proposed four-story portions remain in compliance with the zoning requirements and maximum allowable height restrictions of a "mid-rise building". Portions of the building at the center of the project are 4 stories along Rainbow Boulevard. The additional story creates a stronger mass at the center of the site, allowing for rooftop terraces and a stronger sense of hierarchy and visual interest toward the center of the site. Because the project is set into a hillside, the four-story portions of the building allow for a more varied appearance in keeping with the massing and variety of the neighboring residential area. Moreover, on the west and north sides of the site the buildings will only have 3 stories visible above grade.

5.4.2.1 Minimum Parking Spaces Per Use

Based on the developer's experience with the local market and retail and office uses of a similar type to those of the proposed development, the amount of parking proposed is less than the minimum requirement and in keeping with market expectations and



PROPERTY LOCATION MAP | A11

af@karbank.com **ARCHITECT** KENNY MILLER PERSPECTIVE ARCHITECTURE & DESIGN 2000 SHAWNEE MISSION PKWY SUITE 100 MISSION WOODS, KS 66205 kenny@pad.studio

MISSION WOODS, KANSAS 66205

PROPERTY DEVELOPER

ADAM FELDMAN

SUITE 400

816.221.4488

CIVIL ENGINEER AUSTIN LAGE KARBANK REAL ESTATE COMPANY 2000 SHAWNEE MISSION PARKWAY 7101 COLLEGE BLVD. SUITE 400 OVERLAND PARK, KANSAS 66210 913.663.1900 austin.lage@ibhc.com

DEVIATION REQUESTS | F01 PROJECT LOCATION PLAN OVERALL SITE PLAN SITE PLAN - GROUND LEVEL SITE PLAN - SECOND LEVEL

PROJECT NARRATIVE | M01

SIGHT DISTANCE PLAN FIRE TRUCK MANEUVERABILITY GRADING PLAN TREE PRESERVATION PLAN LANDSCAPE PLAN - GROUND LEVEL LANDSCAPE PLAN - SECOND LEVEL PHOTOMETRICS PLAN

ARCHITECTURAL SITE PLAN ARCHITECTURAL SITE PLAN ARCHITECTURAL SITE PLAN **BUILDING ELEVATIONS BUILDING ELEVATIONS BUILDING ELEVATIONS**

2000 SHAWNEE MISSION PKWY SUITE 100 MISSION WOODS, KS 66205

816 502 1500

WWW.PAD.STUDIO

MATTHEW MASILIONIS - ARCHITECT KANSAS # 4053

I have prepared the drawings and assume responsibility for the sheets numbered with an "A" prefix for the project named Other drawings and specifications attached for the above-mentioned project have been by and are the esponsibility of the licensed engineer whose stamp and firm appear on that sheet. The Architect is not responsible for the design of the


mechanical, electrical, plumbing, civil, landscaping, structural gnage (not specified), fire sprinkler or fire supression systems; and does not take responsibility for the compliance of these areas with the laws of the above governm entities. The architect is not responsible for materials, mponents or equipment, as well as the method in which they are installed on the project by others. The architect is not nired or responsible for certification, during construction or upon completion of construction. The architect is not sponsible for improper operation due to faulty installation or product failure during construction or after completion of struction when operation has begun by the landlord or

The licensed professional whose stamp appears or sheets other than those specifically noted above shall be



50TH AND RAINBOW DEVELOPMENT

W50TH ST. & RAINBOW BLVD.

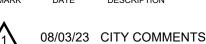

COVER SHEET


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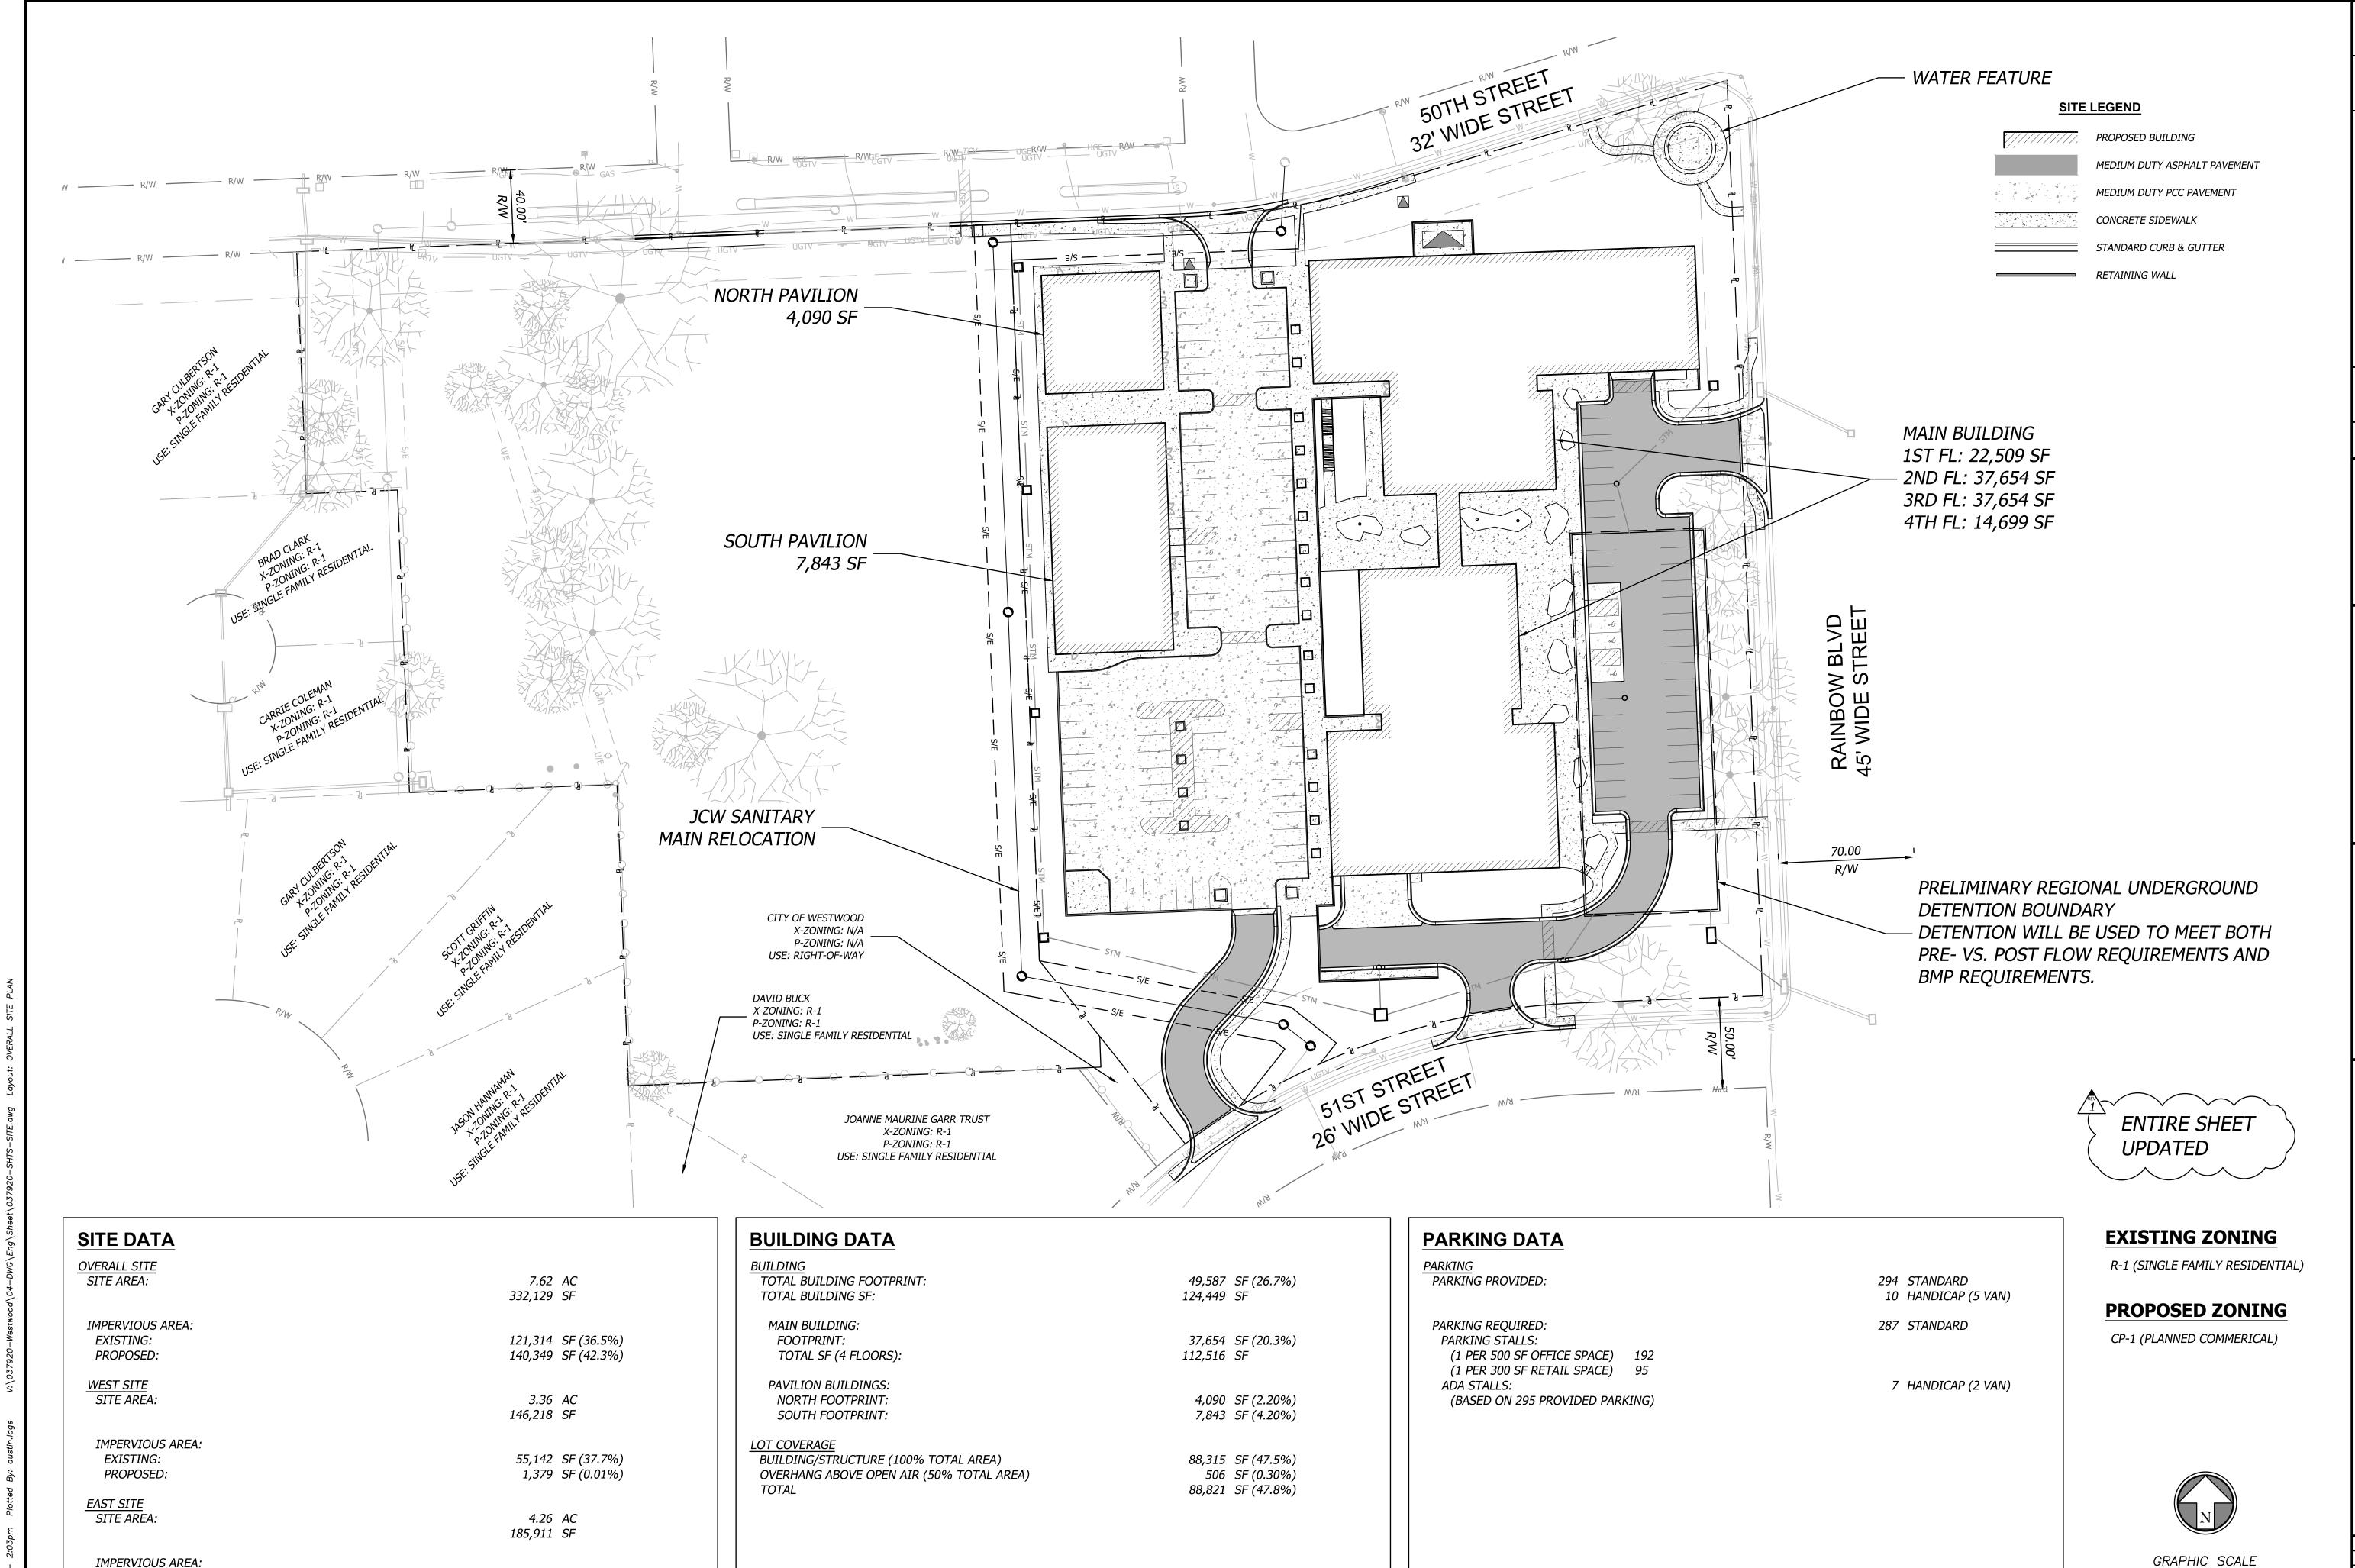
2021073.000 SHEET AUTHOR K. MILLER CHECKED BY M. PAXTON

PDP SUBMITTAL

CONTACT INFORMATION | A06

SHEET INDEX | A01



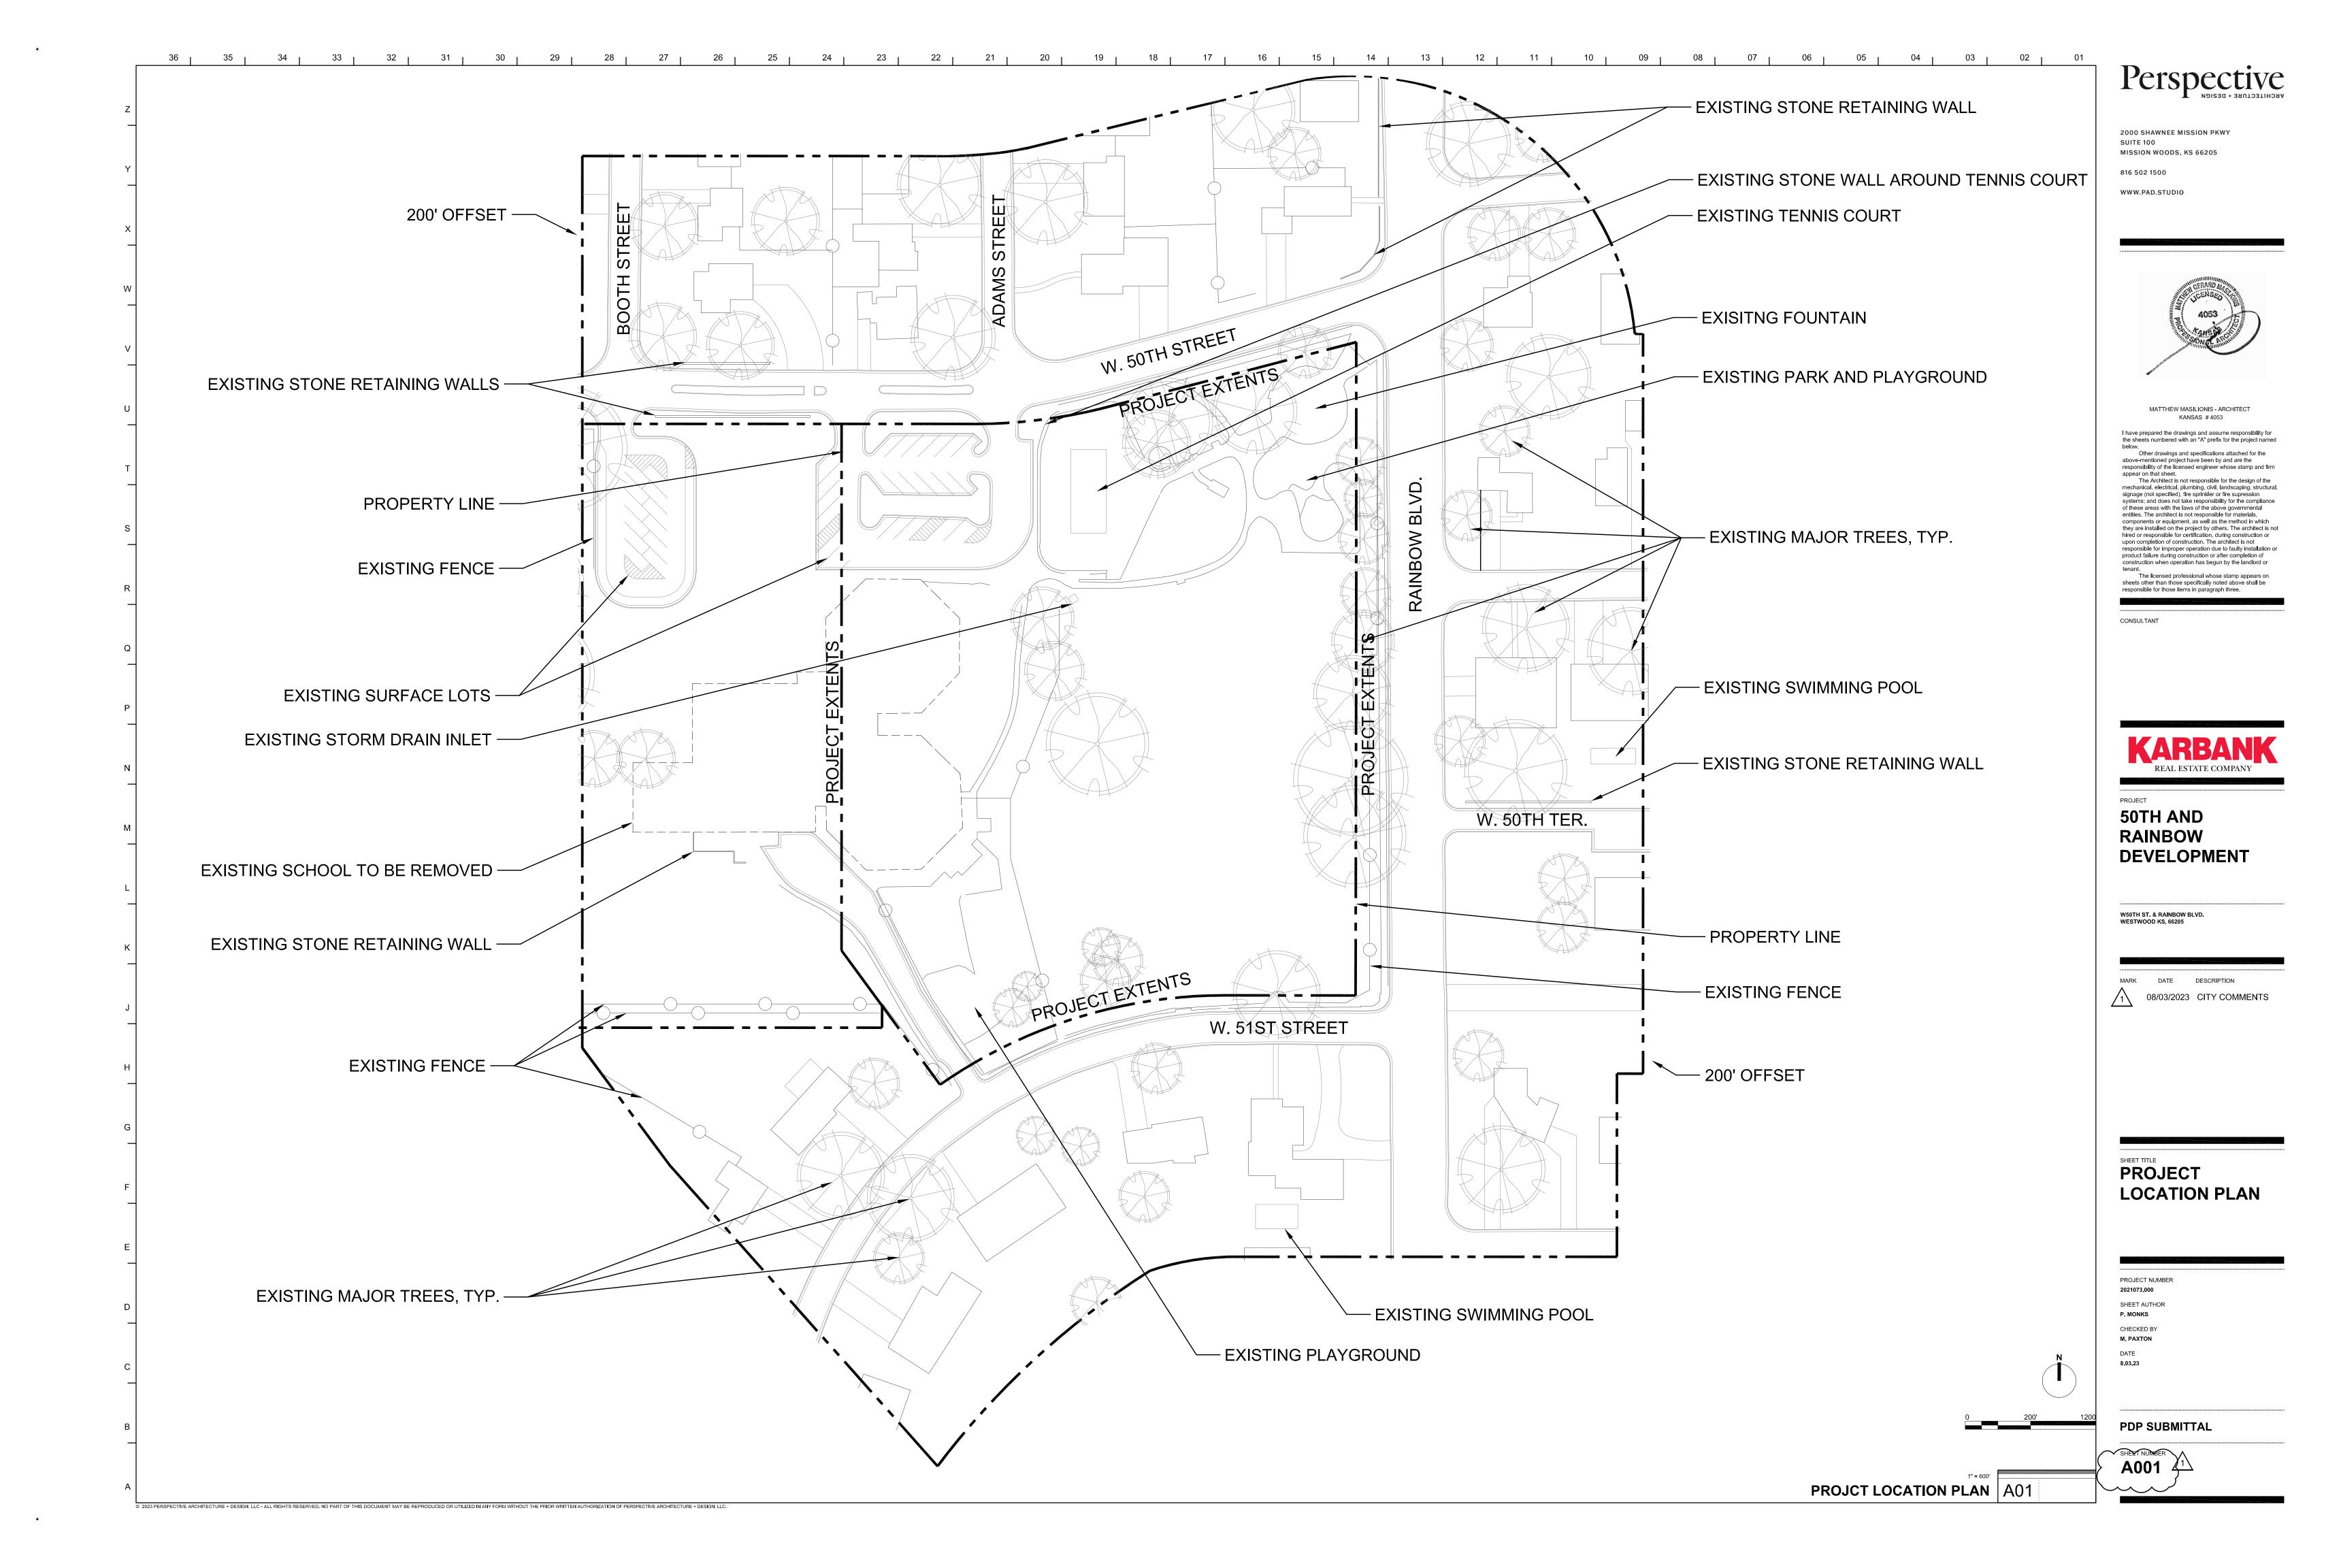

IMPERVIOUS AREA:

EXISTING:

PROPOSED:

66,158 SF (35.6%)


138,970 SF (74.8%)





PDP SUBMITTAL & RAINBOW DEVELOPMENT WESTWOOD, KS 66205 SITE OVERALL

Design: DSN Drawn: DRN Checked: Issue Date: 07/20/202. roject Number: 03792

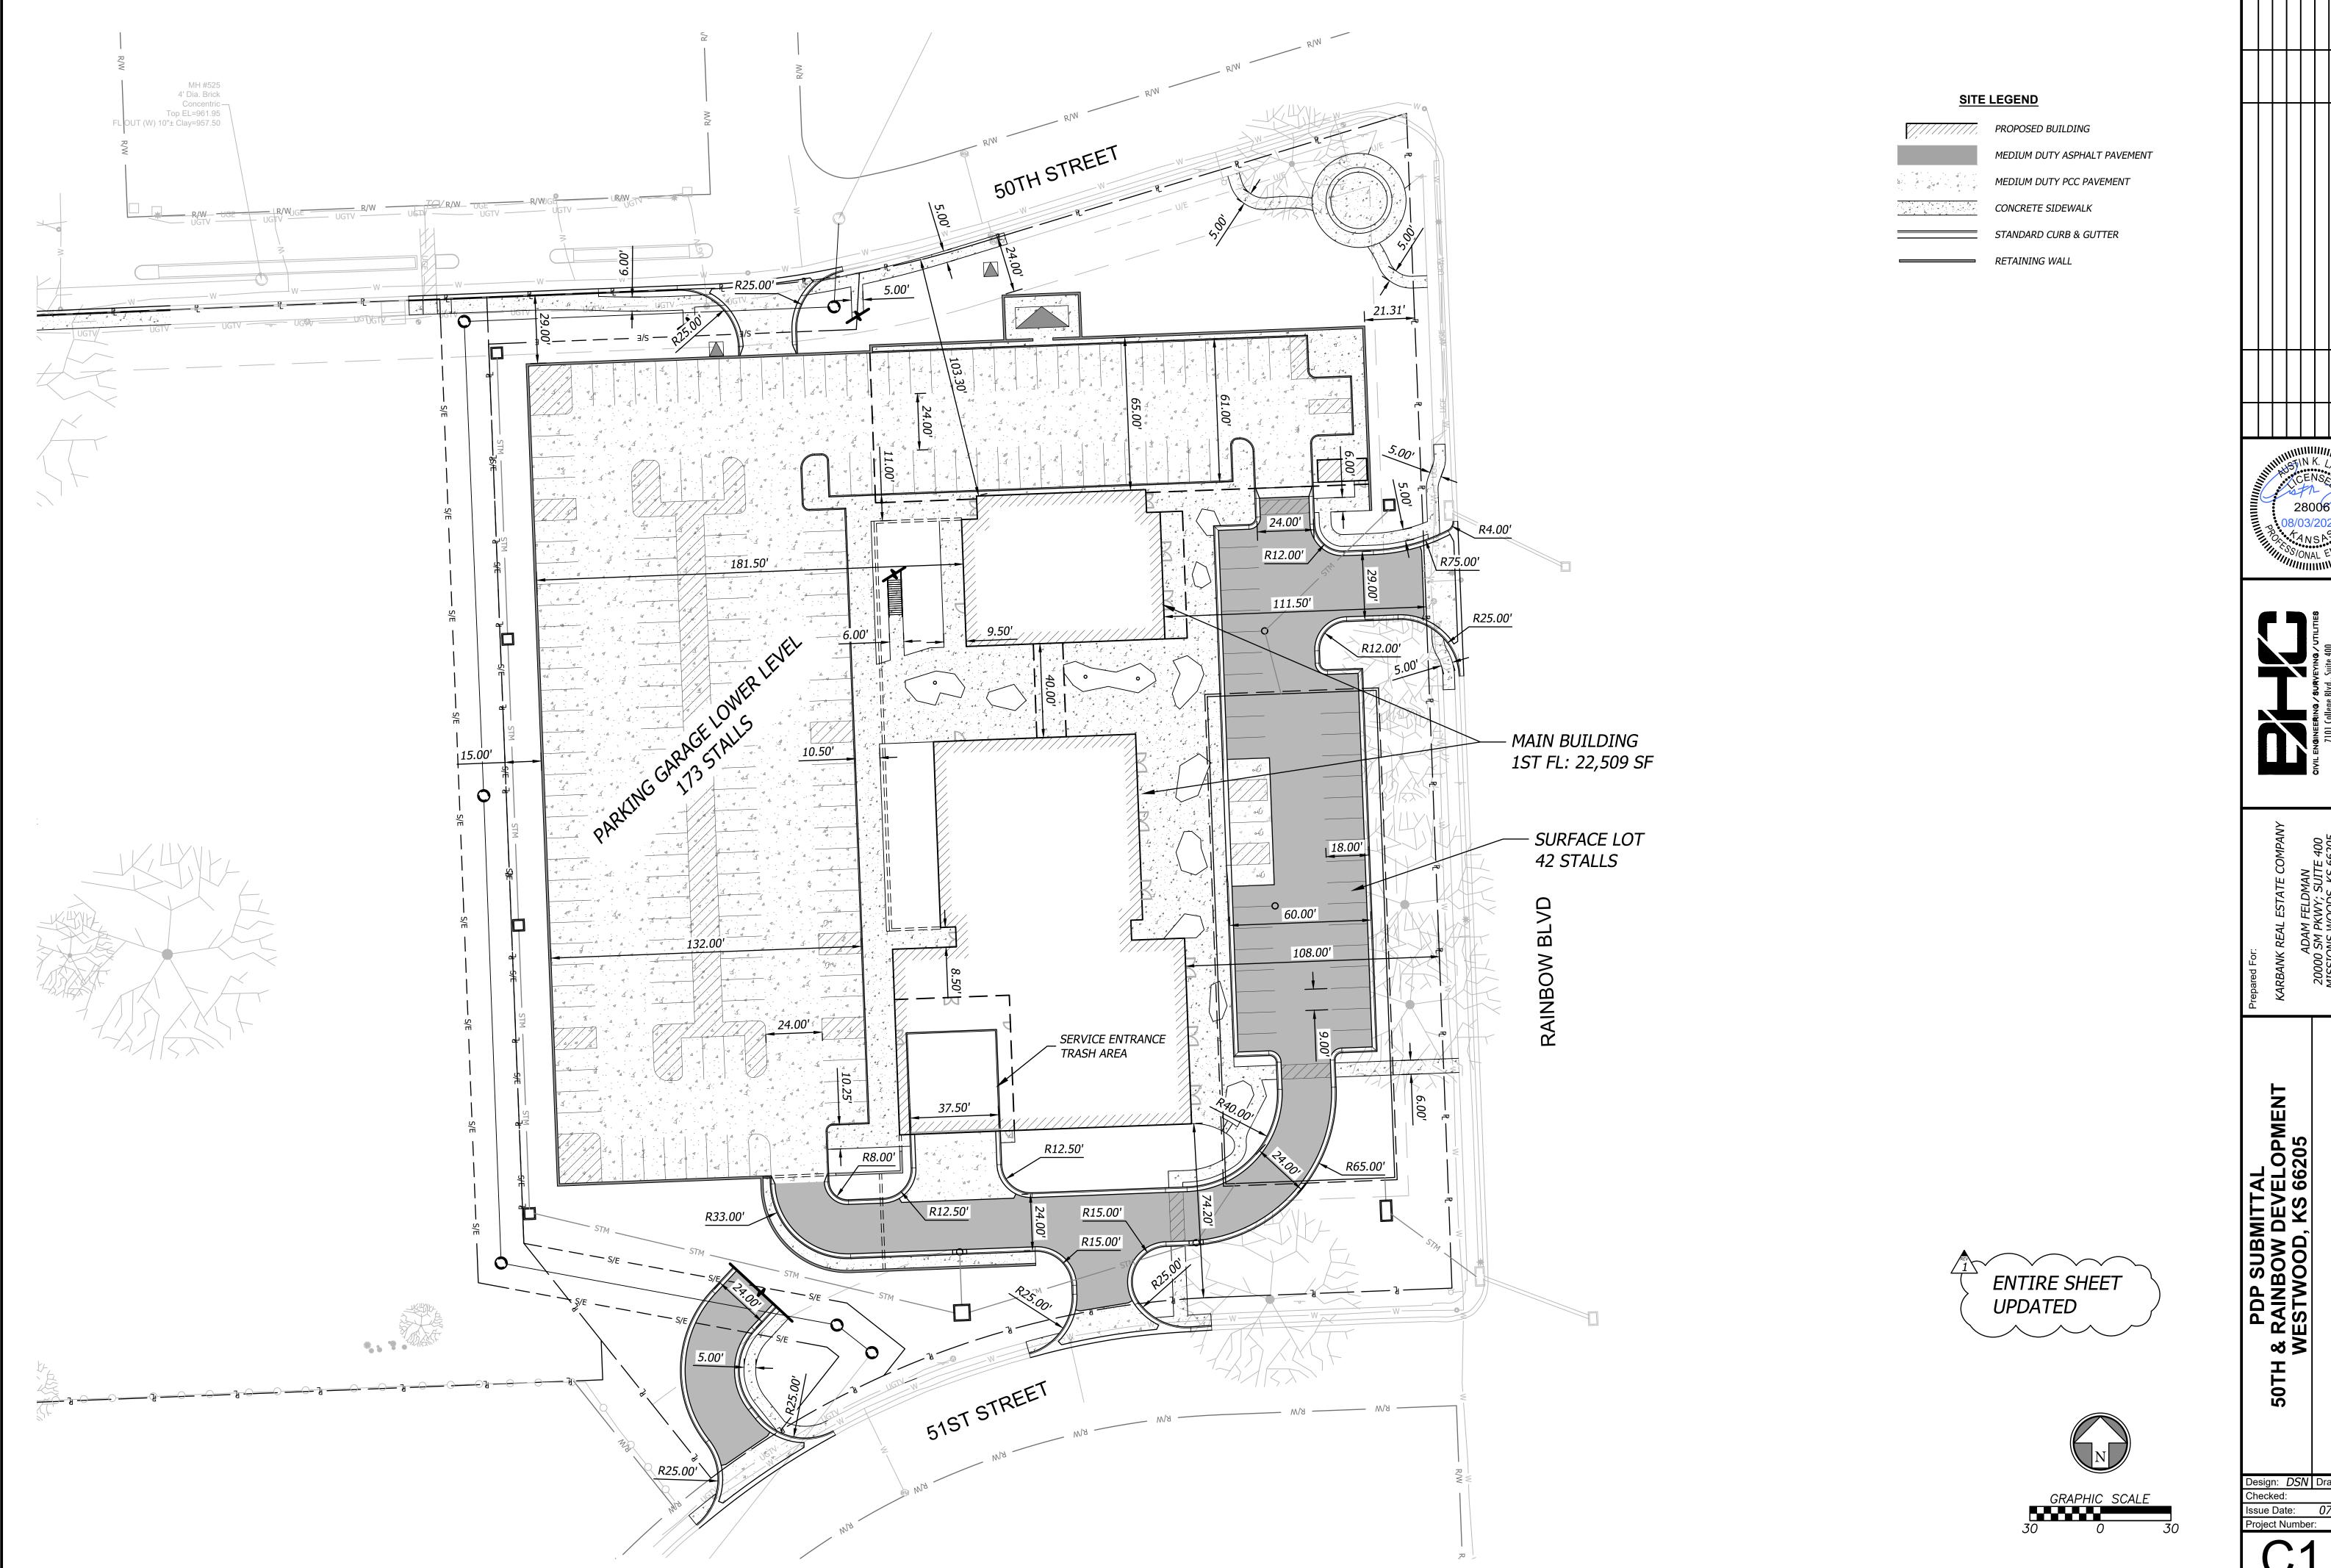








SITE PLAN-GROUND LEVEL

Design: DSN Drawn: DRN
Checked: CHK
Issue Date: 07/20/2023
Project Number: 037920

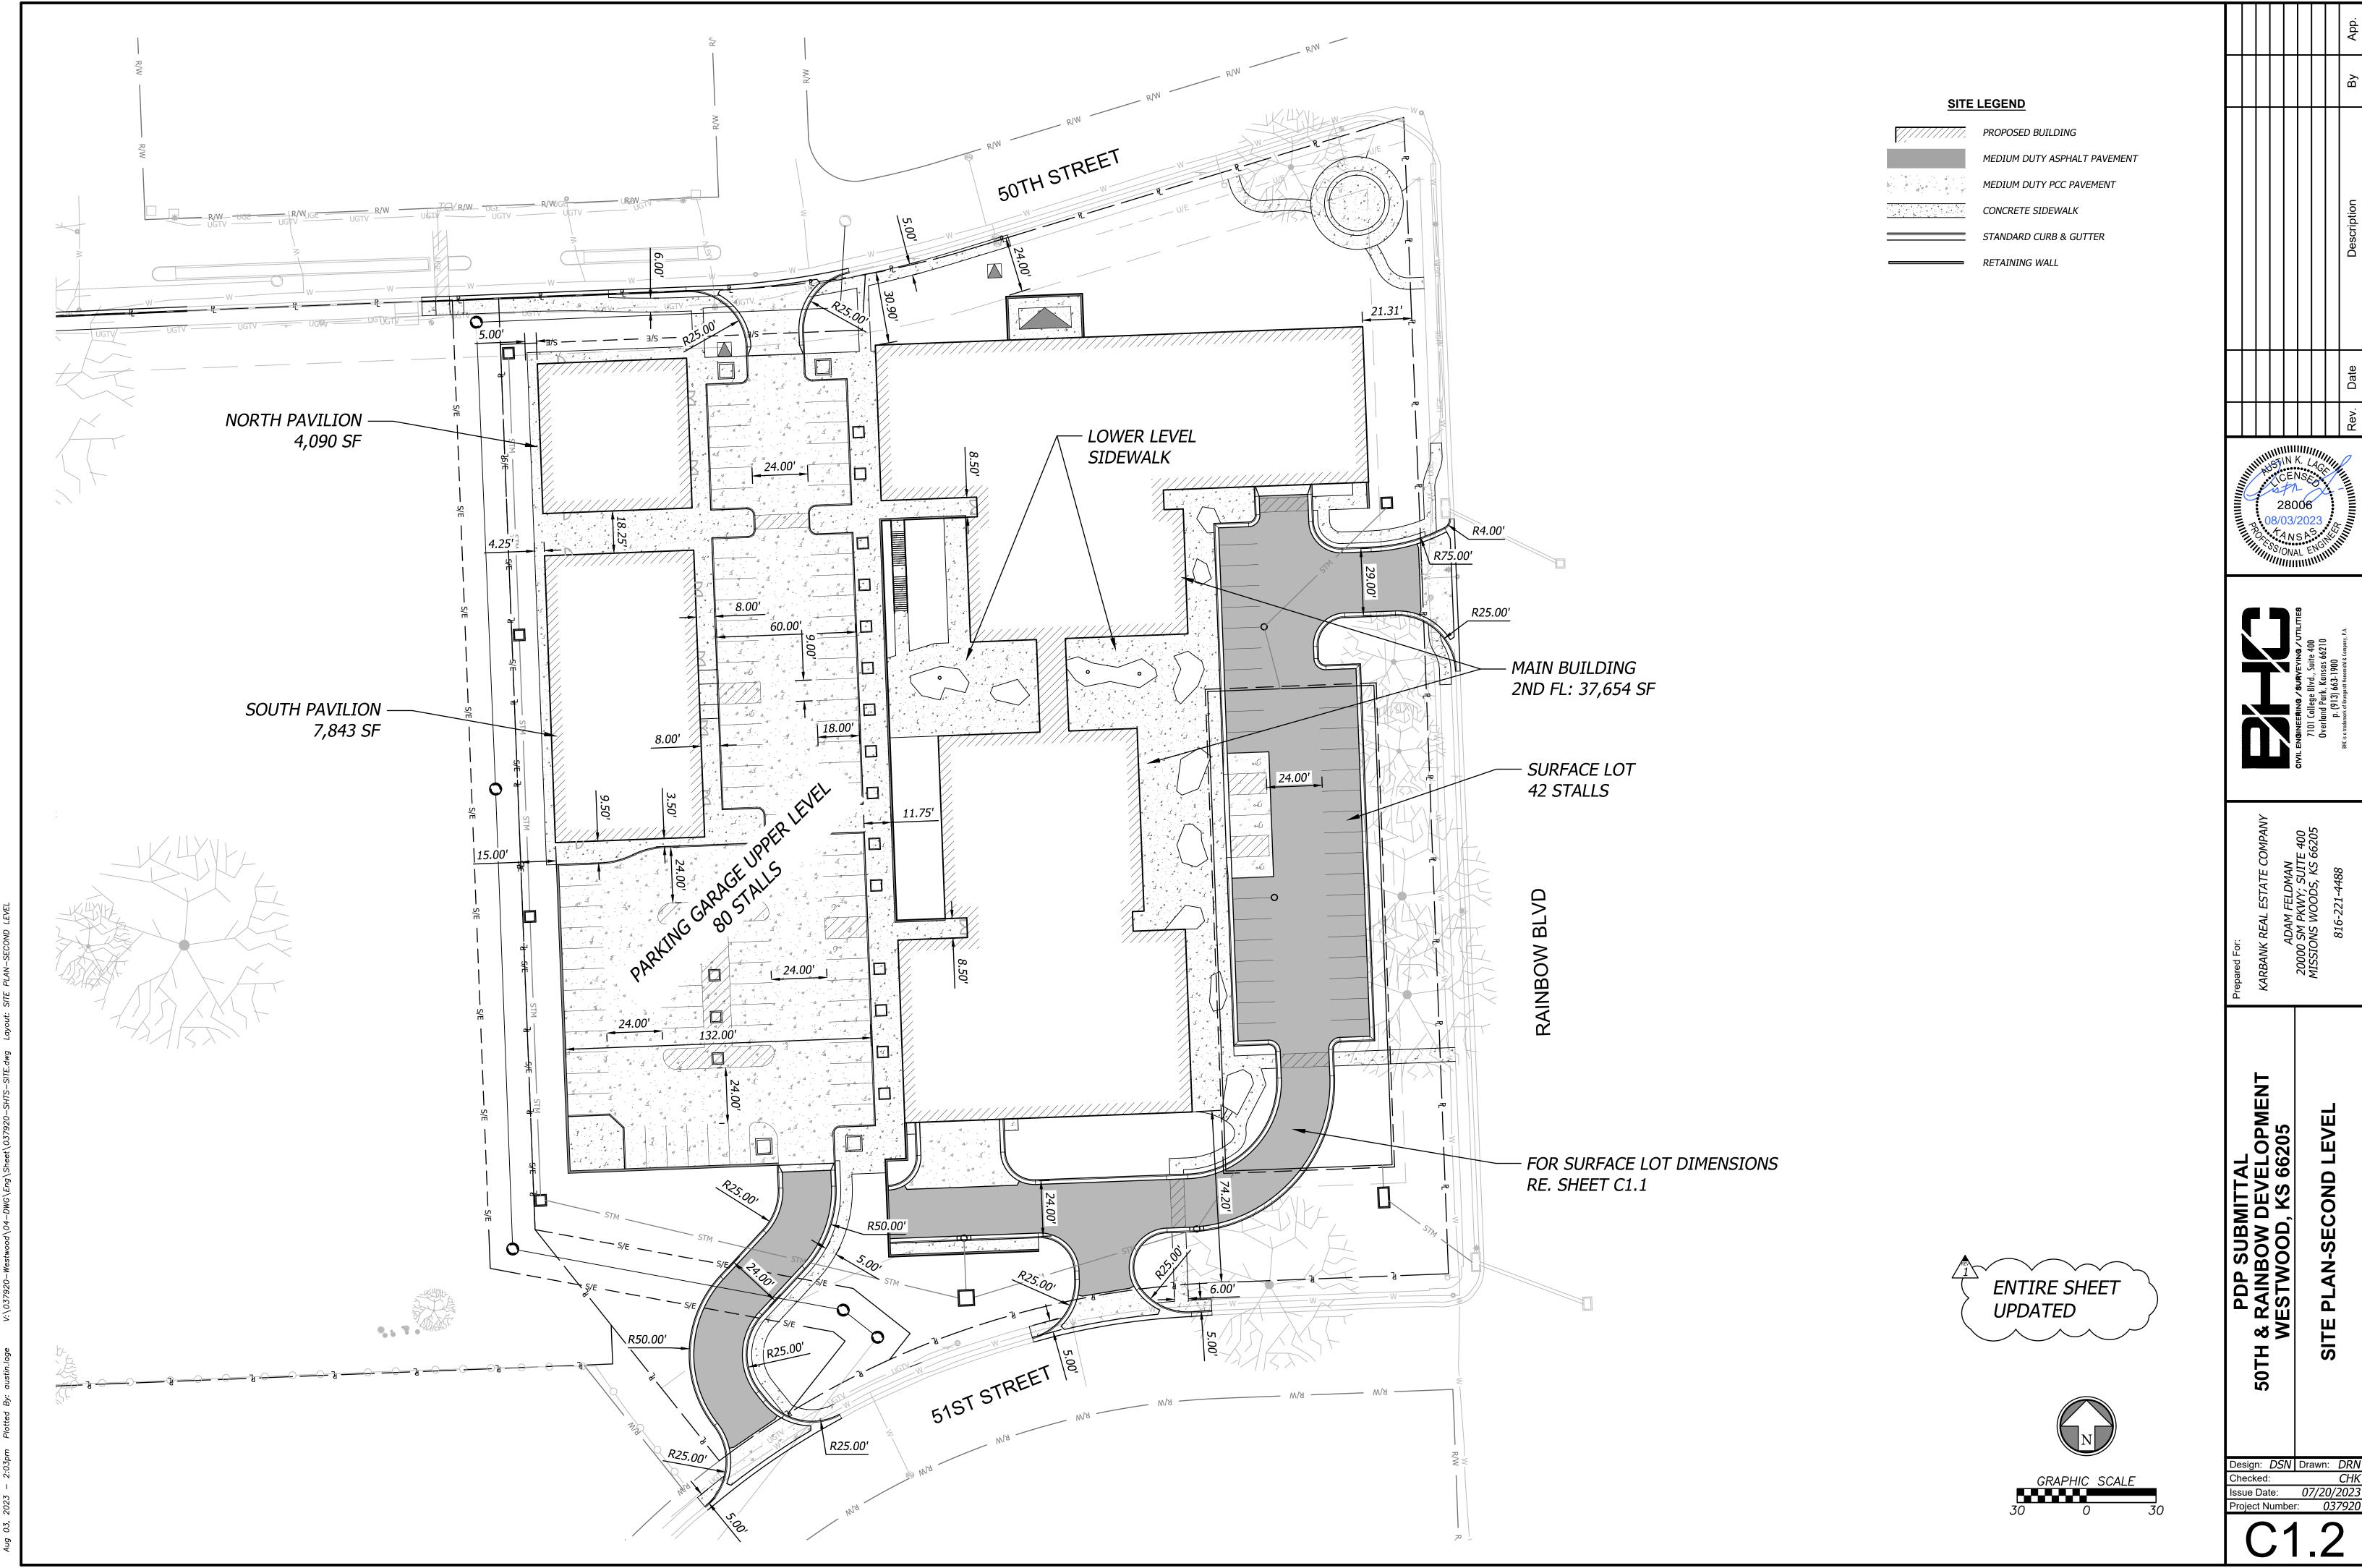



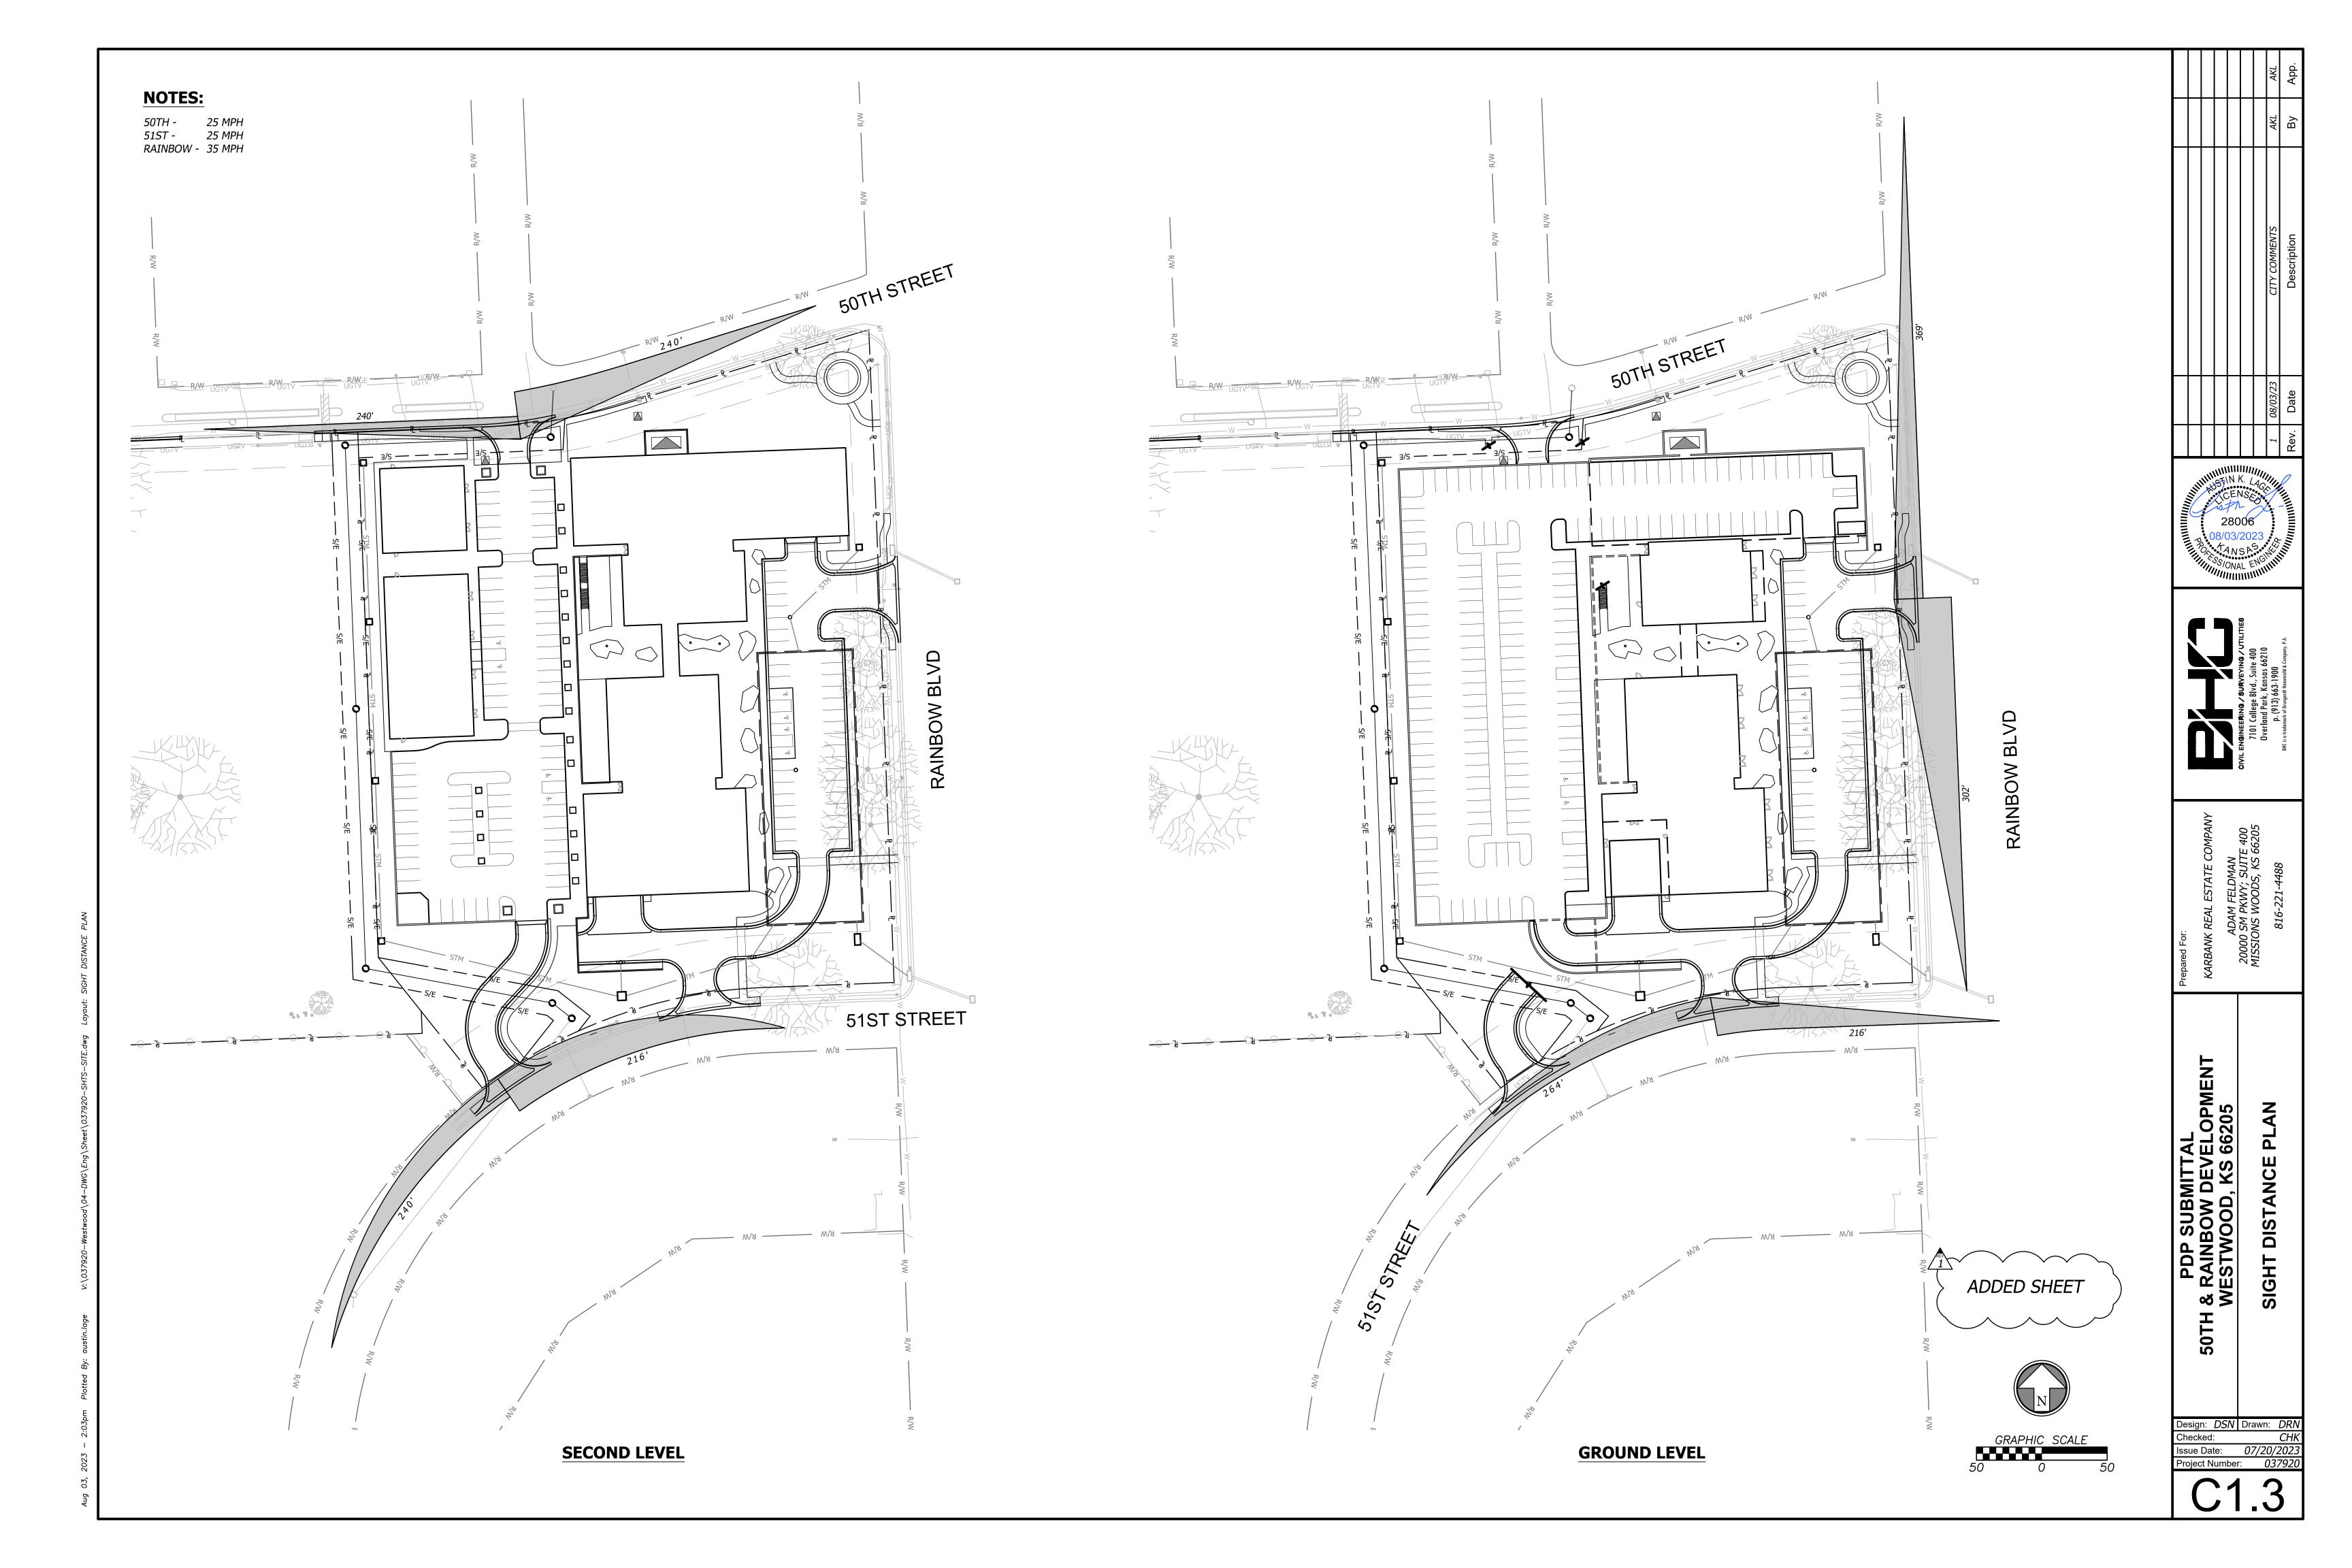

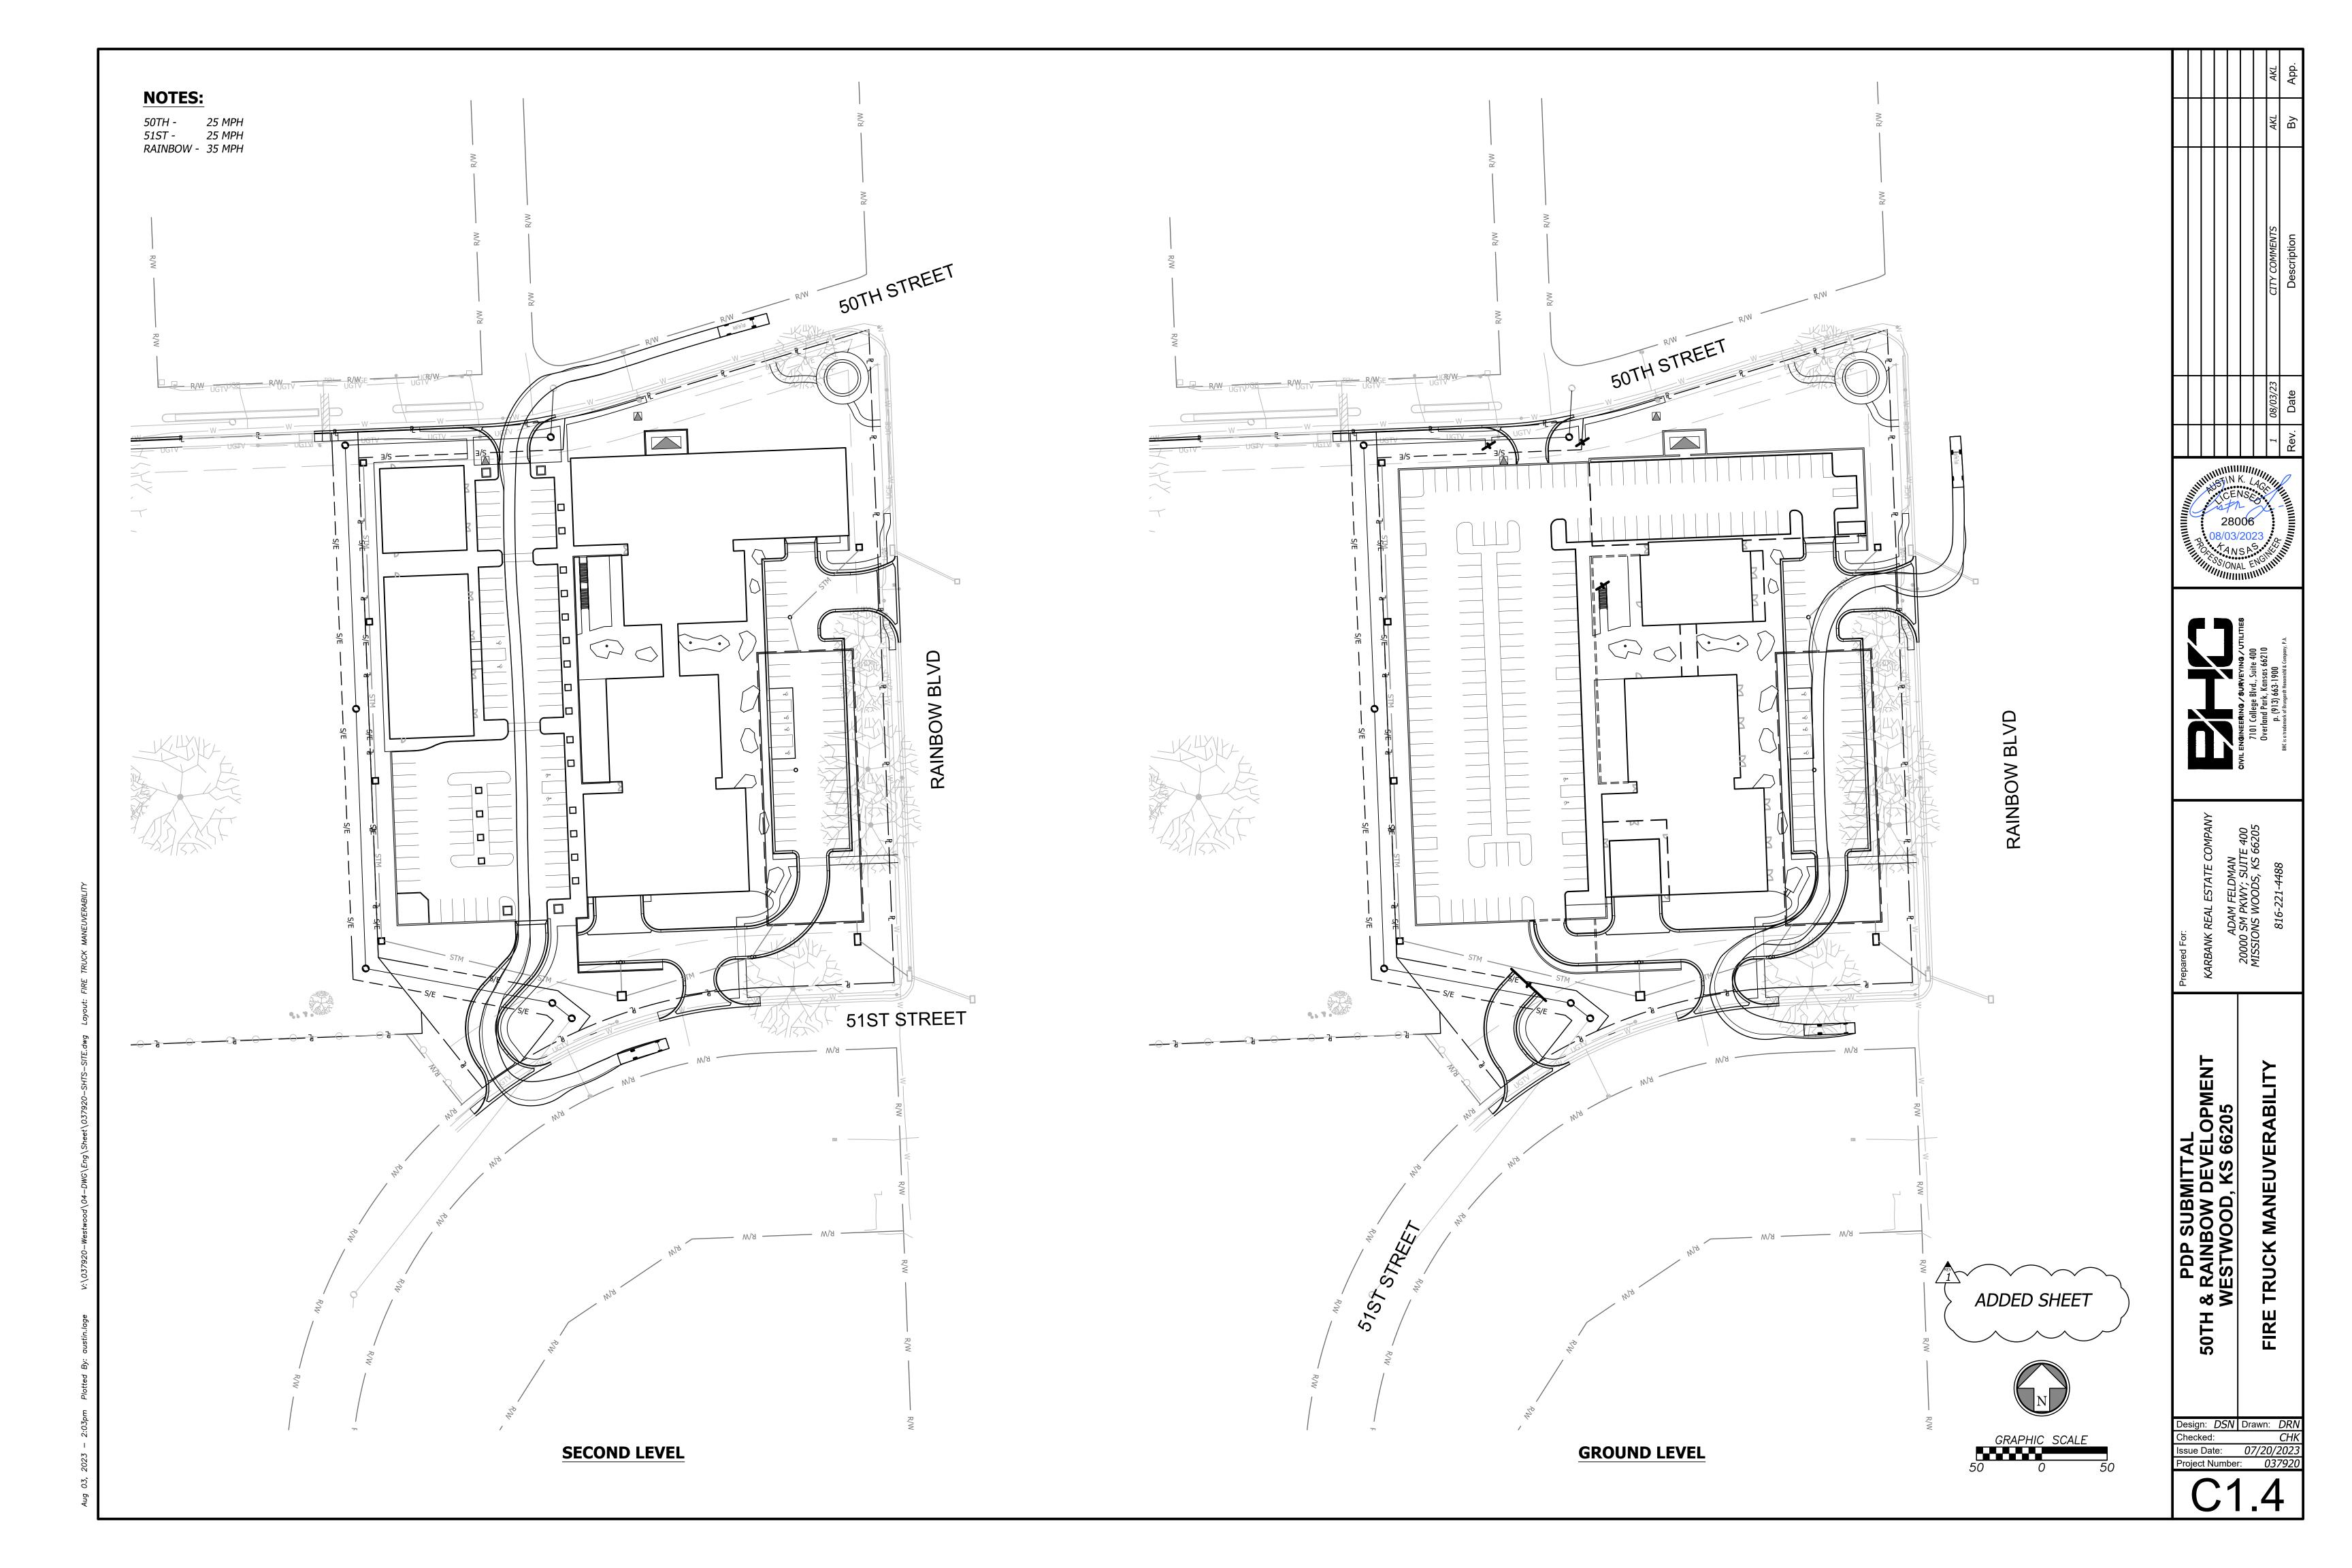

GRADING NOTES

- Contractor shall obtain a copy of the <u>Geotechnical Services Report</u> for the project and be 7. familiar with the existing conditions and recommendations contained in the report if such a report has been prepared.
- Contractor is responsible for any over excavation of existing unsuitable soils will be required under building and pavement areas. Contractor shall perform over excavation of unsuitable soils as a part of this work.
- Contractor shall obtain soils suitable as structural fill from off-site sources. All borrow materials must be tested and approved by the Geotechnical Engineer prior to importing the soils to the project site.
- Contractor shall operate under the terms and permits included in the Stormwater Pollution Prevention Plan (SWPPP) prepared for this project and permitted through the State of Kansas. Contractor shall employ a qualified person to conduct regular inspections of the site erosion control measures and document such inspections in the SWPPP document maintained by the Contractor.
- All topsoil, vegetation, root structures, and deleterious materials shall be stripped from the ground surface prior to the placement of embankments. Contractor shall obtain the on-site geotechnical representative's acceptance of the existing ground surface materials and the 12. A 2.0% maximum cross slope shall be maintained on all pedestrian sidewalks and paths. proposed fill material prior to the placement of fill.
- All proposed contour lines and spot elevations shown are finish ground elevations. Contractor shall account for pavement depths, building pads, topsoil, etc when grading the site.

- All disturbed areas that are not to be paved (green spaces) shall be finish graded with a minimum of six inches of topsoil.
- All excavation and embankments shall comply with the recommendations provided by the geotechnical engineer.
- 9. Prior to placing any concrete or asphalt pavement the contractor shall perform a proof roll of the pavement sub-grade with a fully loaded tandem axle dump truck. The proof roll shall be conducted in the presence of the on-site geotechnical representative. Areas that display rutting or pumping that are unsatisfactory to the geotechnical representative shall be re-worked and a follow-up proof roll shall be conducted prior to acceptance of the sub-grade for paving. The contractor may, at its own expense, stabilize the sub-grade using Class C fly ash or quicklime, as approved by the geotechnical engineer.
- 10. Finished grades shall not be steeper than 3:1.
- 11. All grading work shall be considered unclassified. No additional payments shall be made for rock excavation. Contractor shall satisfy himself as to any rock excavation required to accomplish the improvements shown hereon.

FLOOD STATEMENT

The subject property lies within Flood Zone " X " (unshaded) (Areas determined to be outside the 0.2% annual chance floodplain.), as shown on the Johnson County, Kansas and Incorporated Areas Flood Insurance Rate Map (F.I.R.M.). Map Number: 20091C0010G

Panel No: 10 of 161

Map Revised Date: August 3, 2009


<u>NOTE:</u> This statement is provided for informational purposes only and shall in no way constitute a basis for a flood certificate. No field work was performed to establish the boundaries of this zone. The information was derived by scaling the subject property on the above referenced map.

BENCHMARKS

(DATUM: NAVD88)

JOHNSON COUNTY VERTICAL CONTROL POINT BENCHMARK BENCHMARK NUMBER: 901 ELEVATION= 883.46

BERNTSEN ALUMINUM DISK STAMPED BM 901. TOP 24 INCH CONCRETE CURB IN LINE WITH WEST FACE OF RCB, 20 FEET SOUTH OF RCB ON THE NORTH SIDE 50TH TERR.

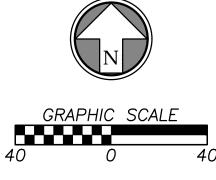






PDP SUBMITTAL RAINBOW DEVELOPMENT ESTWOOD, KS 66205

Design: *DSN* Drawn: *DRN* ssue Date: 07/20/202. roject Number: 03792

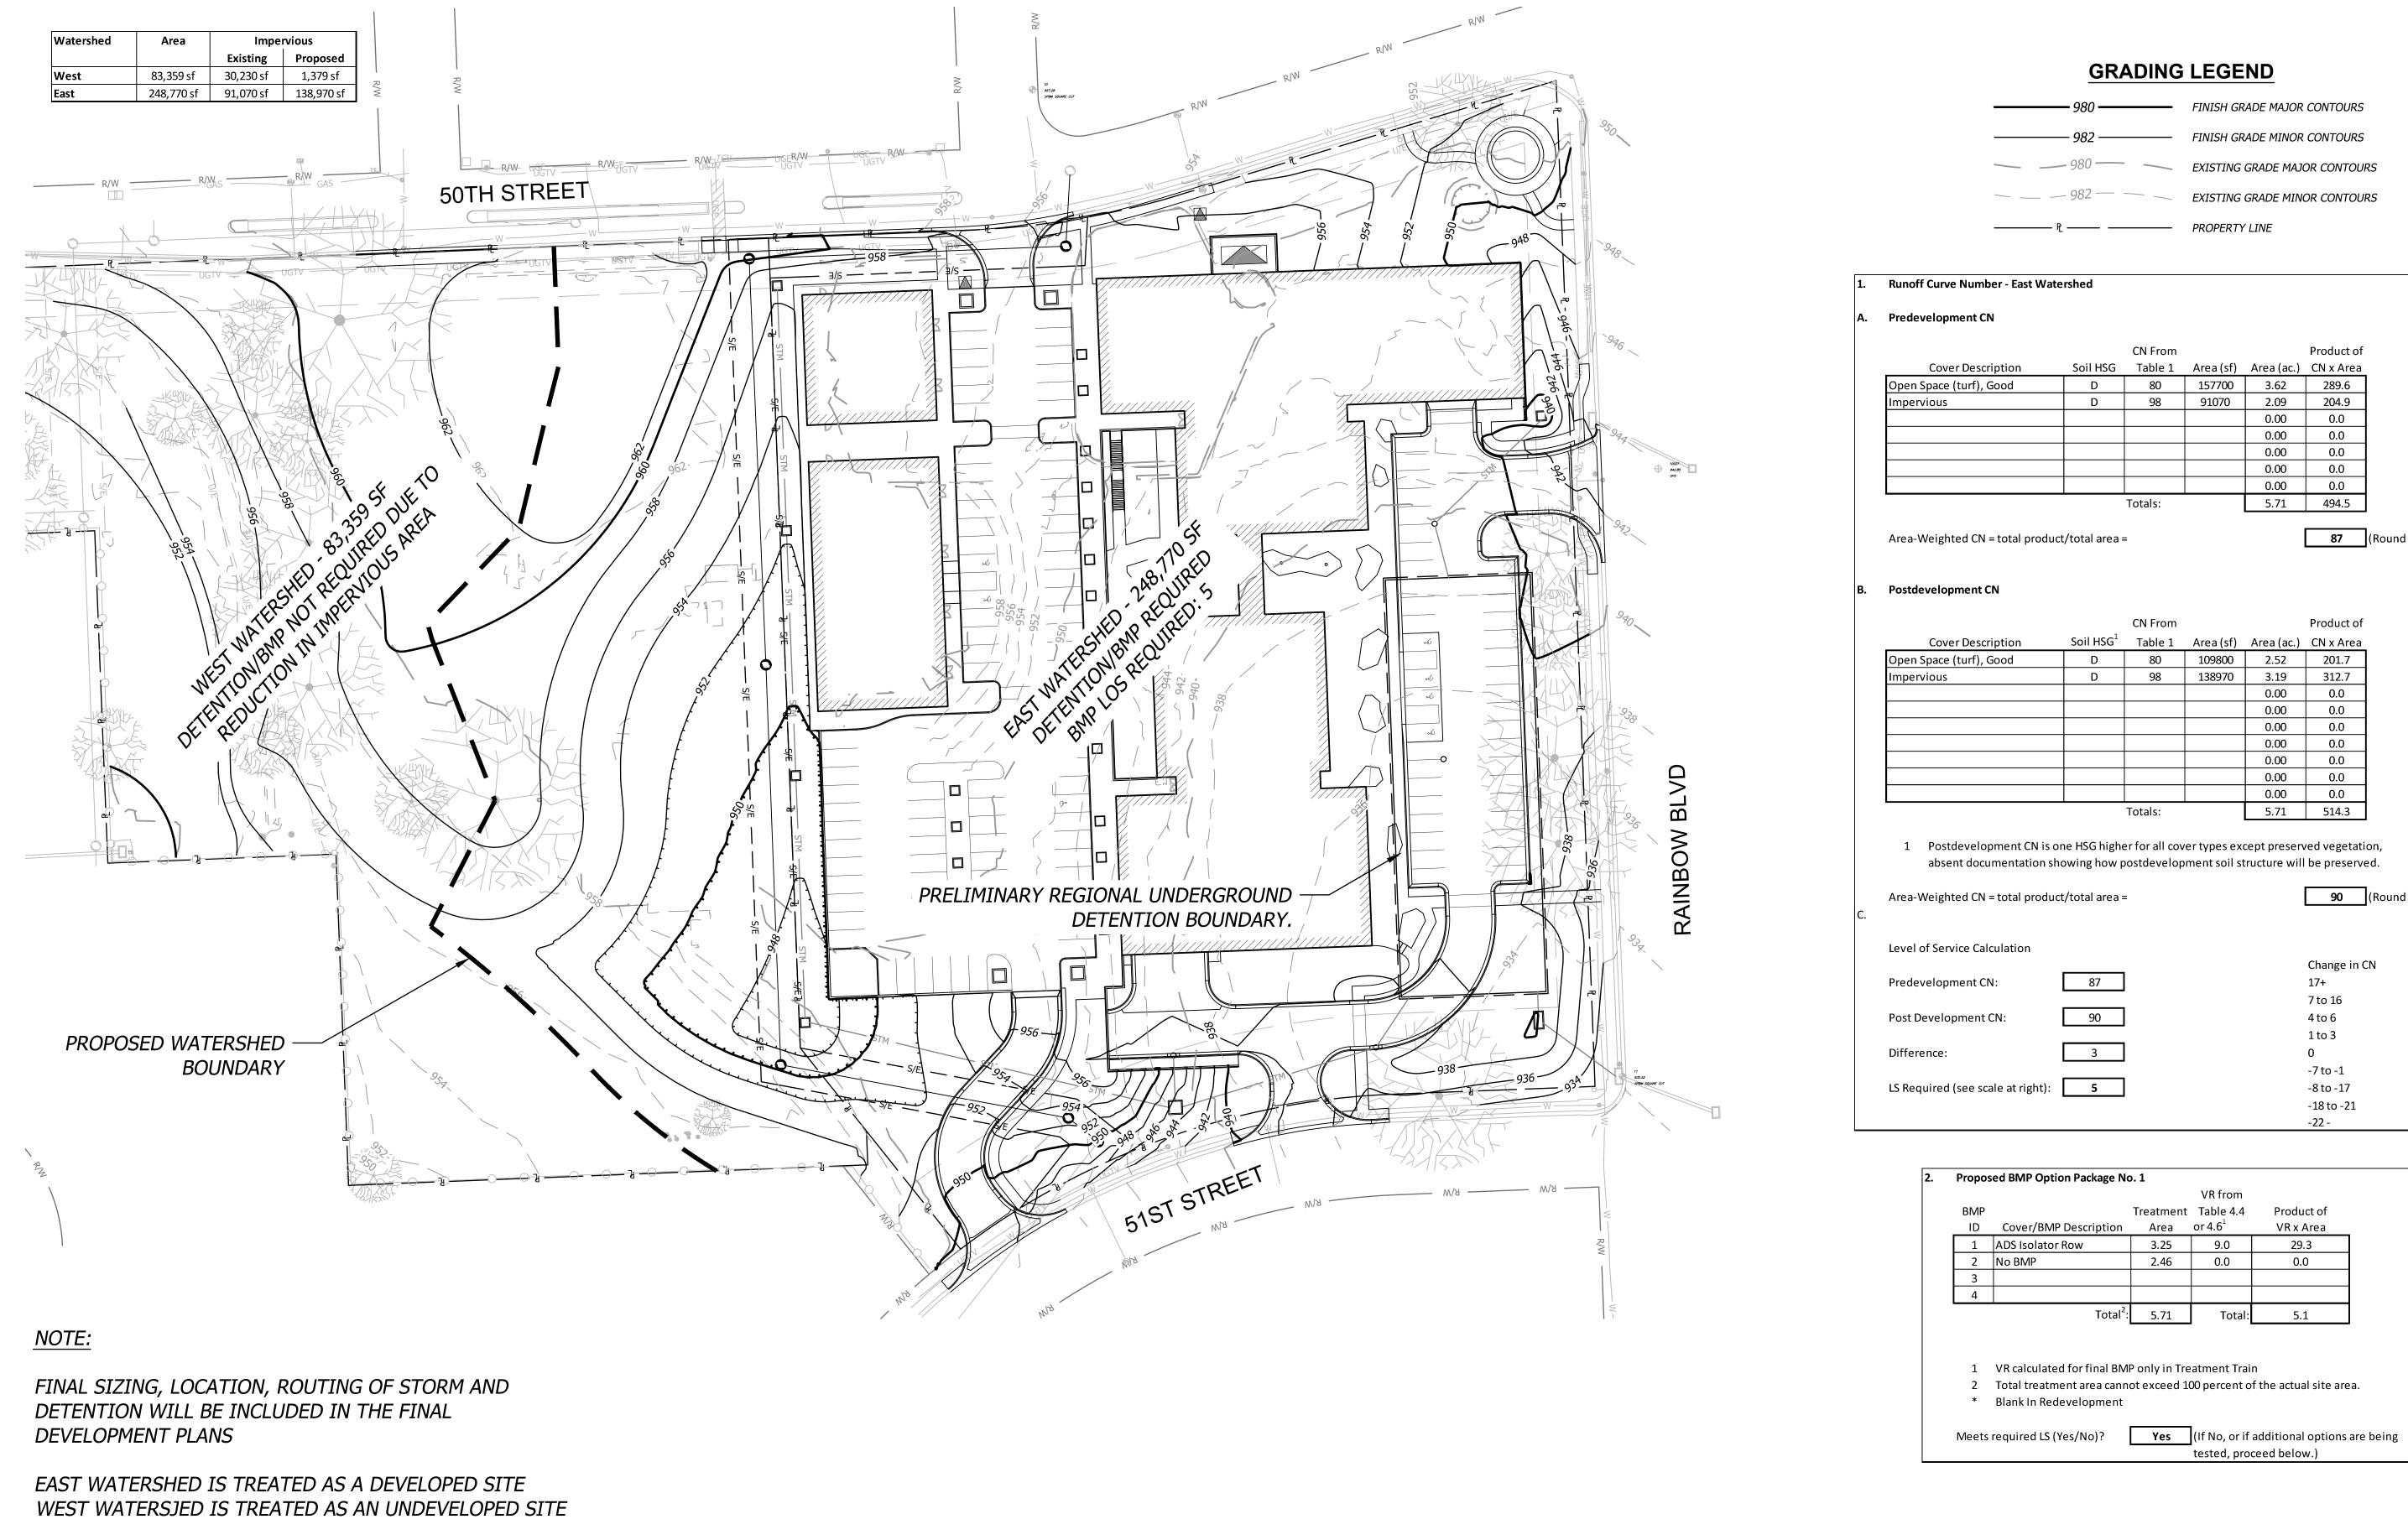

— FINISH GRADE MINOR CONTOURS —— 980 —— EXISTING GRADE MAJOR CONTOURS — — 982 — — EXISTING GRADE MINOR CONTOURS

		CN From			Product of
Cover Description	Soil HSG	Table 1	Area (sf)	Area (ac.)	CN x Area
Open Space (turf), Good	D	80	157700	3.62	289.6
Impervious	D	98	91070	2.09	204.9
				0.00	0.0
				0.00	0.0
				0.00	0.0
				0.00	0.0
				0.00	0.0
	Totals:		5.71	494.5	

87 (Round to integer)

		CN FIOIII			Product of
Cover Description	Soil HSG ¹	Table 1	Area (sf)	Area (ac.)	CN x Area
Open Space (turf), Good	D	80	109800	2.52	201.7
Impervious	D	98	138970	3.19	312.7
				0.00	0.0
				0.00	0.0
				0.00	0.0
				0.00	0.0
				0.00	0.0
				0.00	0.0
				0.00	0.0
	·	Totals		5 71	51/13


1 Postdevelopment CN is one HSG higher for all cover types except preserved vegetation, absent documentation showing how postdevelopment soil structure will be preserved.

90 (Round to integer) Change in CN 17+ 7 to 16 4 to 6 1 to 3 -7 to -1 -8 to -17

			VICTIOIII	
BMP		Treatment	Table 4.4	Product of
ID	Cover/BMP Description	Area	or 4.6 ¹	VR x Area
1	ADS Isolator Row	3.25	9.0	29.3
2	No BMP	2.46	0.0	0.0
3				
4				
	Total ² :	5.71	Total:	5.1

2 Total treatment area cannot exceed 100 percent of the actual site area.


ADDED SHEET

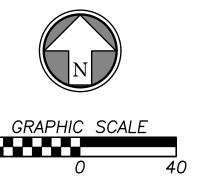




PDP SUBMITTAL 50TH & RAINBOW DEVELOPMENT WESTWOOD, KS 66205

Design: DSN Drawn: DRN Issue Date: 07/20/202. roject Number: 03792

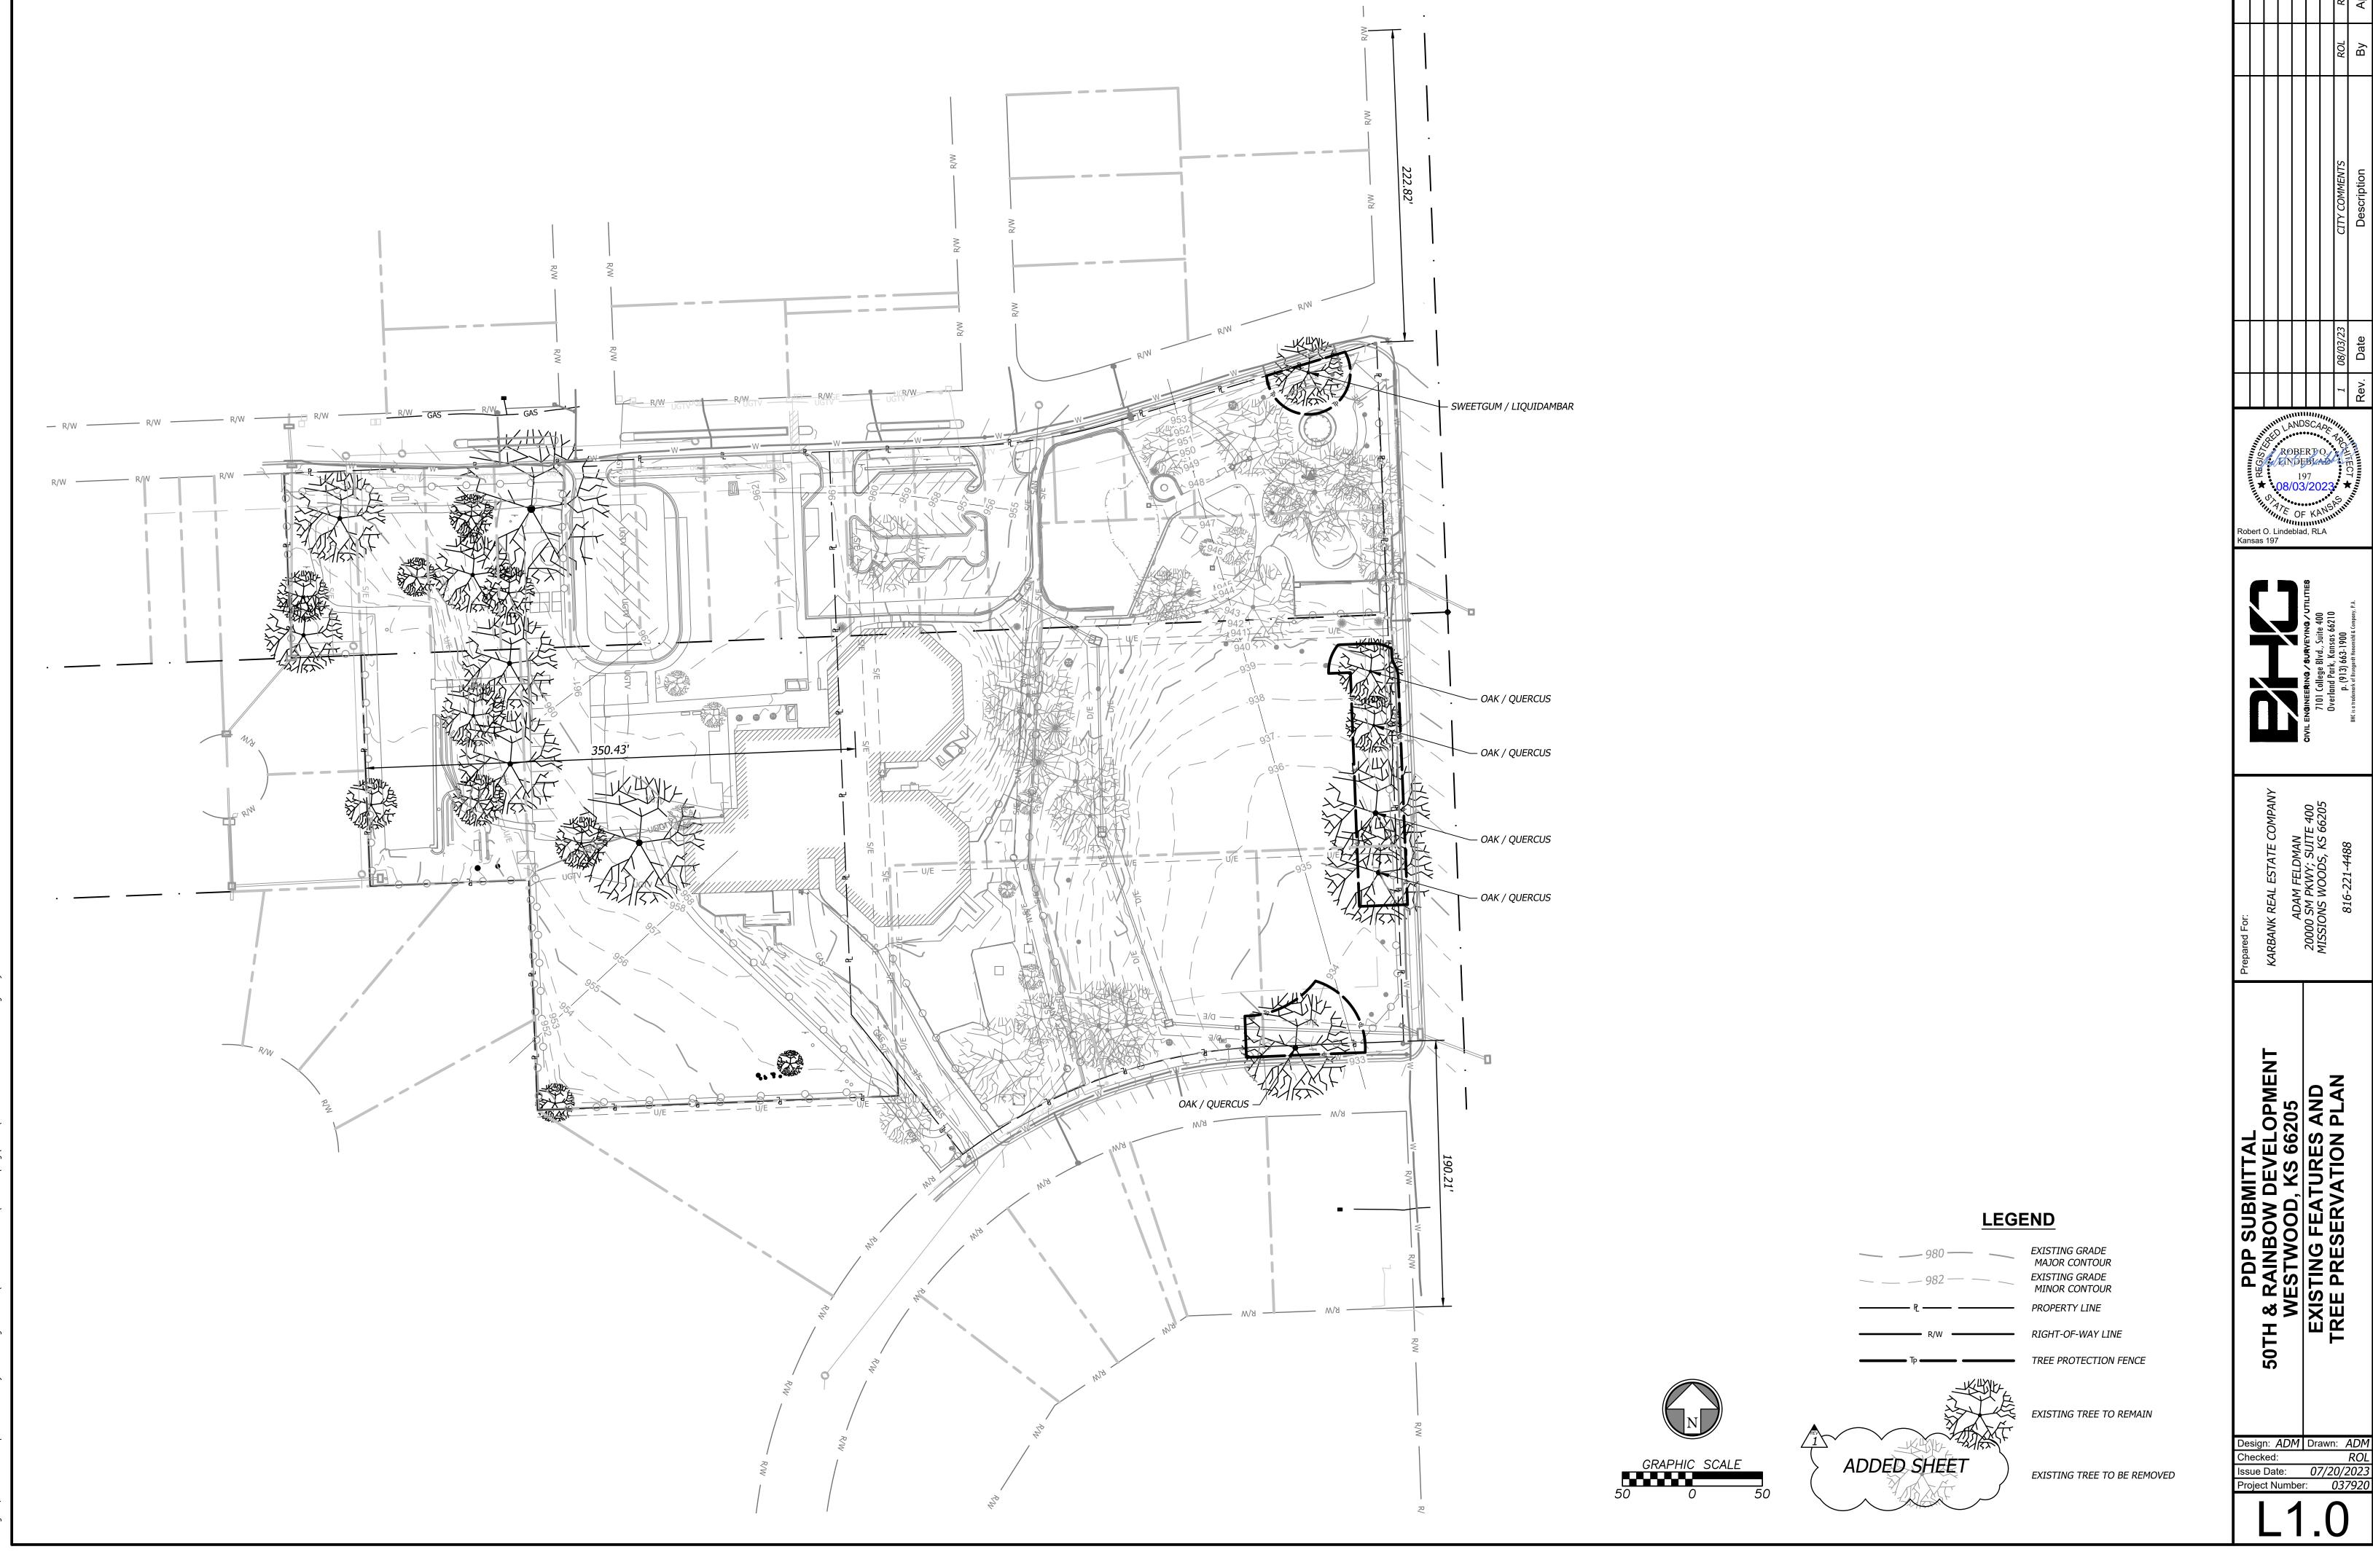





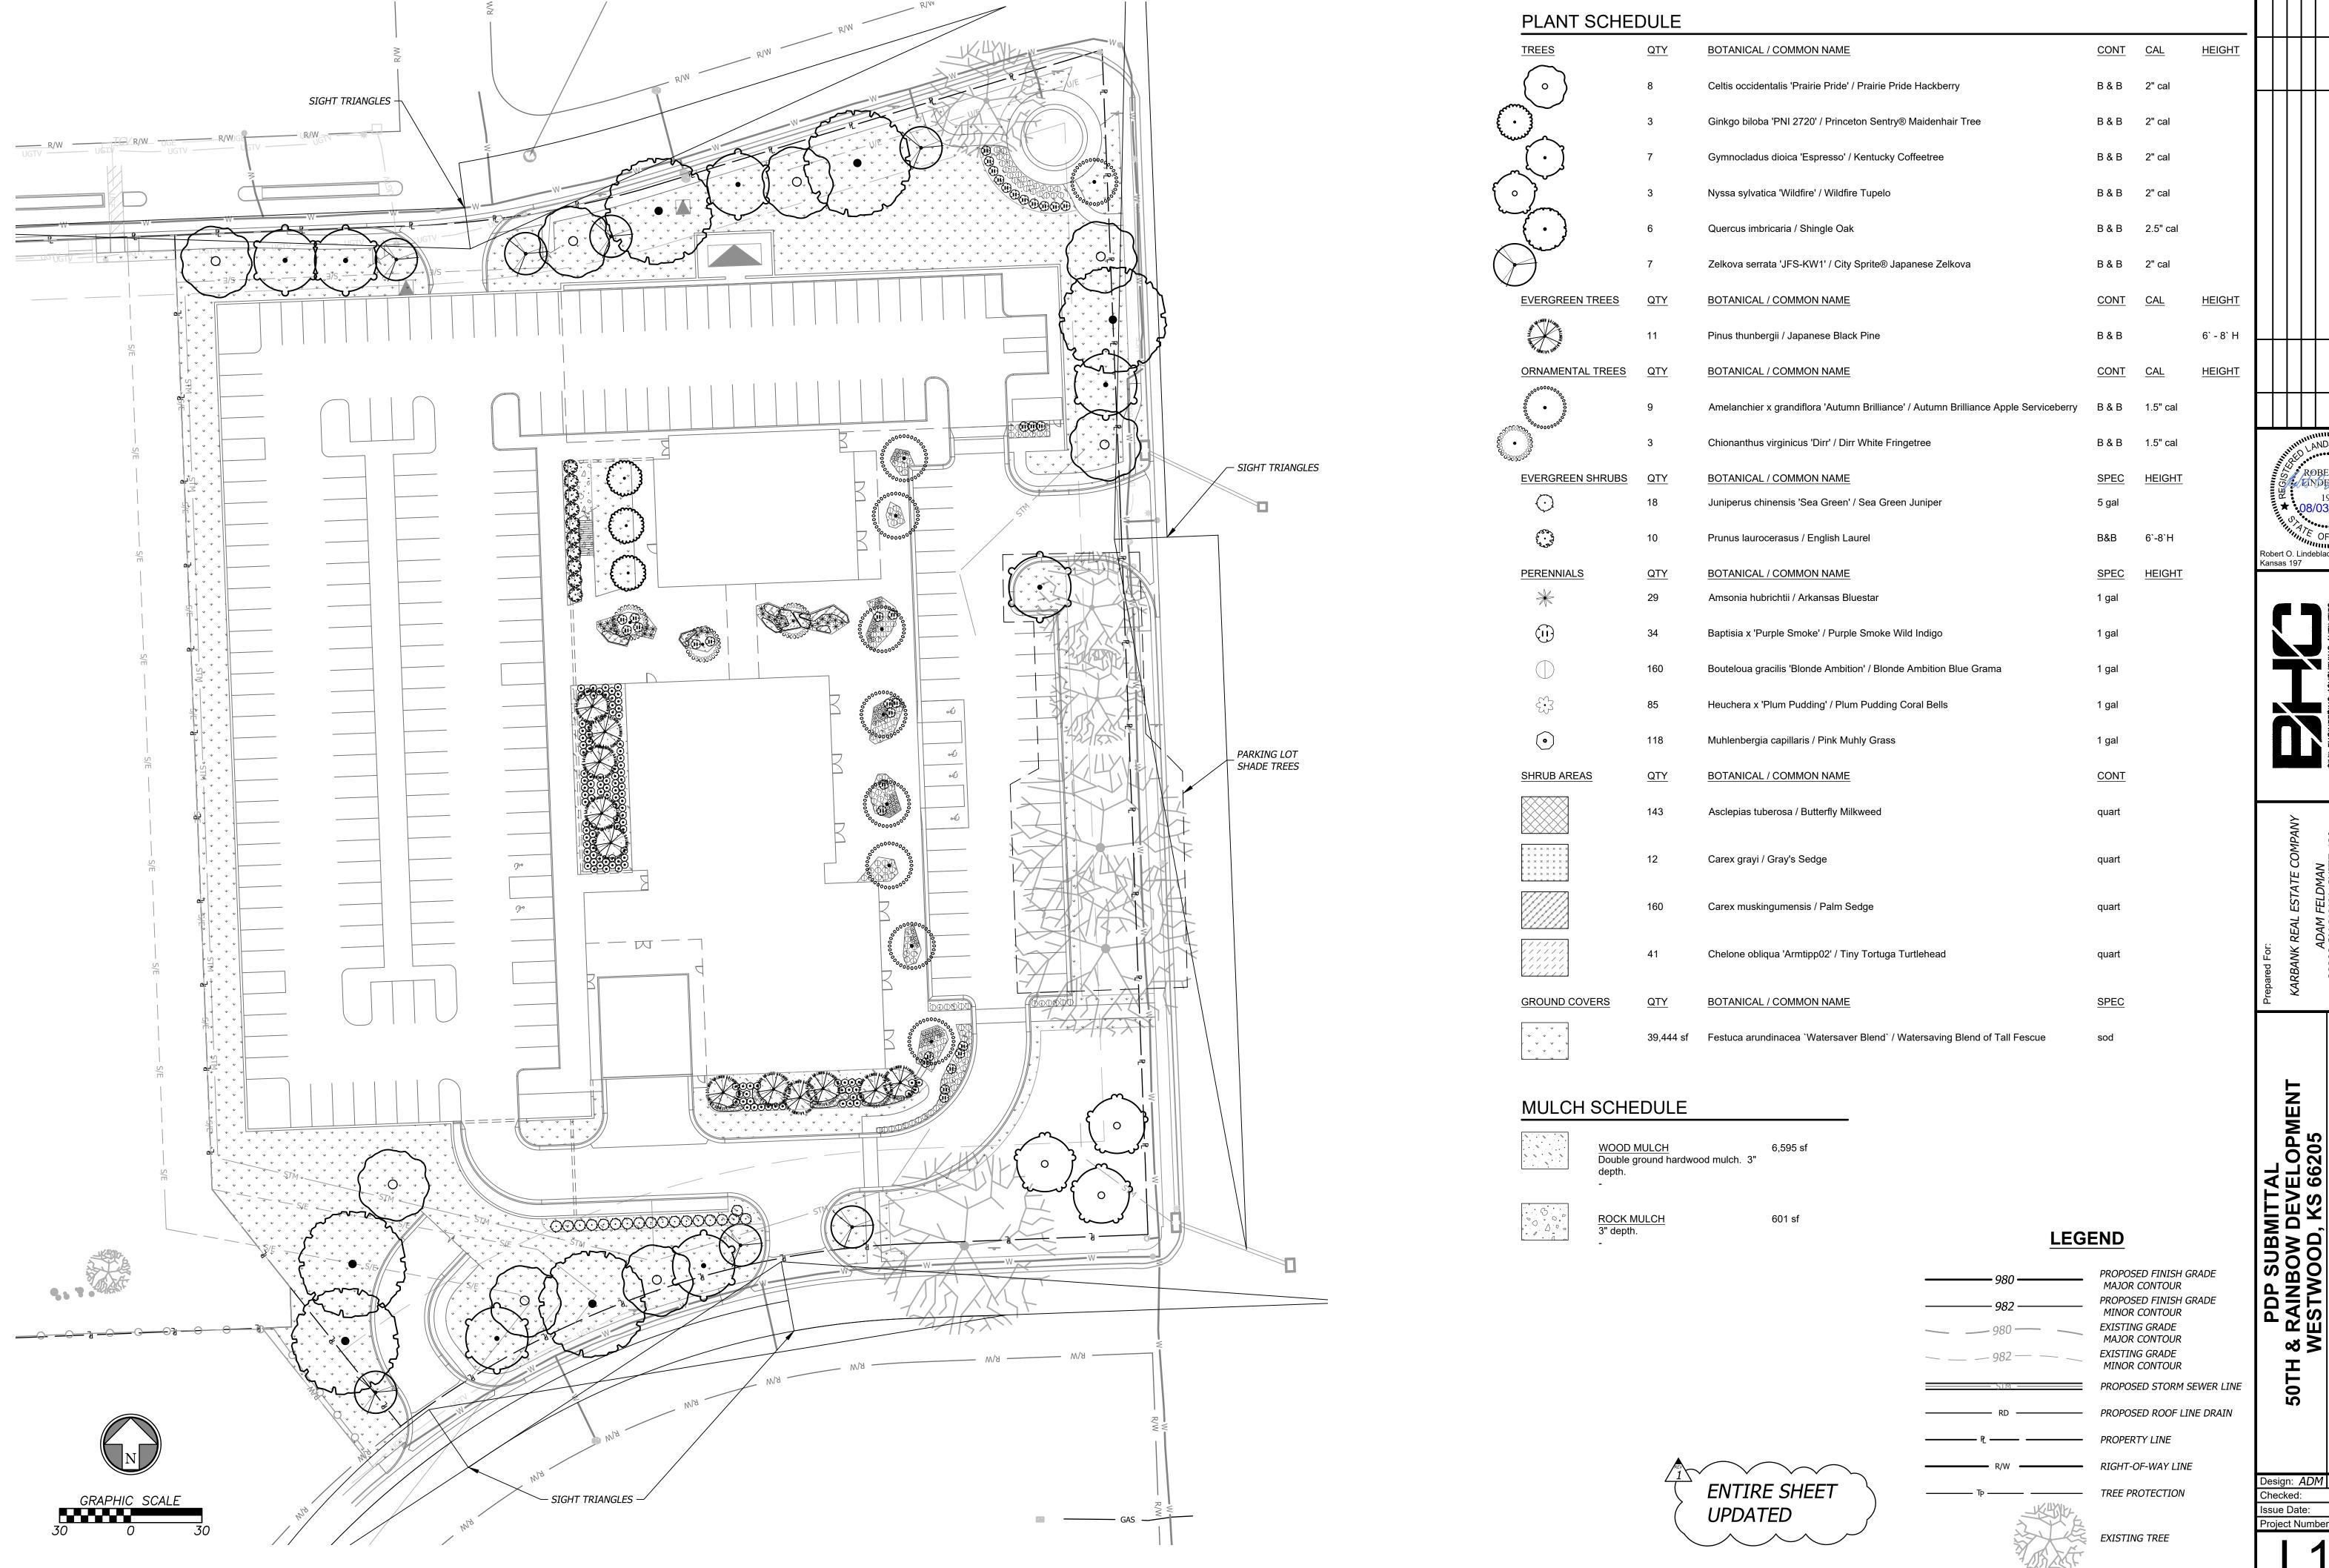

Robert O. Lindeblad, RLA Kansas 197

PLAN-GROUND

Design: ADM Drawn: ADM


Issue Date: 07/20/202 Project Number: 03792

PLANT SCHEDULE

ORNAMENTAL TREES QTY BOTANICAL / COMMON NAME

Malus x 'Royal Raindrops' / Royal Raindrops Crabapple B & B 1.5" cal

MULCH SCHEDULE

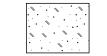

WOOD MULCH Double ground hardwood mulch. 3"

LEGEND


980	PROPOSED FINISH GRADE MAJOR CONTOUR
982	PROPOSED FINISH GRADE MINOR CONTOUR
	EXISTING GRADE MAJOR CONTOUR
982	EXISTING GRADE MINOR CONTOUR
SIM	PROPOSED STORM SEWER LINE
RD	PROPOSED ROOF LINE DRAIN
	PROPERTY LINE
R/W	RIGHT-OF-WAY LINE
Tp	TREE PROTECTION



GENERAL LANDSCAPE NOTES

- 1. The Contractor shall verify and coordinate all final grades with the Landscape Architect and or design team prior to completion.
- 2. Location and placement of all plant material shall be coordinated with the Landscape Architect prior to installation.
- 3. Location of all utilities are approximate, the Contractor shall field verify locations prior to commencement of construction operations.
- 4. Refer to Civil Drawings for all grading and berming, erosion control, storm drainage, utilities and site layout.
- 5. The Contractor shall arrange and conduct a pre-construction meeting onsite with Landscape Architect prior to work.
- 6. Plant quantities are for information only, drawing shall prevail if conflict occurs. Contractor is responsible for calculating own quantities and bid accordingly. Minimum quantities for each category of planting required by City Code must be maintained.
- 7. The Contractor is to notify Landscape Architect after staking is complete and before plant pits are excavated.
- 8. Tree locations in areas adjacent to drives, walks, walls and light fixtures may be field adjusted as approved by Landscape Architect.

- 9. The Contractor shall report subsurface soil or drainage problems to the Landscape Architect.
- The plan is subject to changes based on plant size and material availability. All changes or substitutions must be approved by the City of Westwood, Kansas and the Landscape Architect.
- 11. Aluminum landscape edging to be used on all landscape beds adjoining turf areas as noted on landscape plans. Edging shall not be used between pavement and landscape beds.
- 12. Landscape Contractor shall be responsible for watering all plant material until the time that a permanent water source is ready.
- 13. The Contractor shall provide a submittal to show proof of procurement, sources, quantities, and varieties for all shrubs, perennials, ornamental grasses, and annuals within 21 days following the award of the contract.
- 14. Contractor shall provide full maintenance for newly landscaped areas for a period of 30 days after the date of final acceptance. At the end of the maintenance period, a healthy, well-rooted, even-colored, viable turf and landscaped area must be established. The landscaped areas shall be free of weeds, open joints, bare areas, and surface irregularities.
- 15. Landscape Contractor shall provide rock mulch sample to owner for approval.

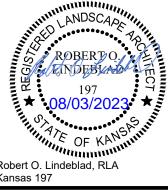




LEVEL PDP SUBMITTAL RAINBOW DEVELOPMENT ESTWOOD, KS 66205 PLAN-SECOND જ ≶


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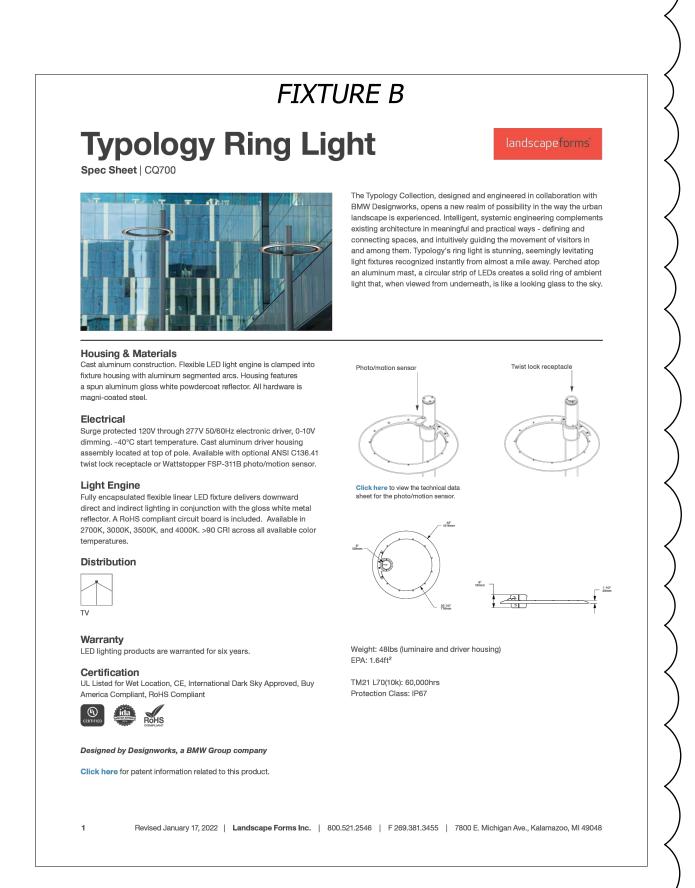
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$\begin{array}{c ccccccccccccccccccccccccccccccccccc$	0.5 0.8 1.1 1.1 0.9 0.8 0.9 1.2 1.7 2.3 1.5 0.3 0.1 0.4 0.8 1.2 1.3 1.0 0.9 0.9 1.1 1.3 1.3 0.9 0.3 0.1
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A2-HSS 0.1 0.1 0.1 0.1 0.2 0.2 0.3 0.6 3.2 0.5 3.9 1.4 0.9 2.2 3.4 2.6 2.1 1.9 2.0 2.4 3.1 3.4 1.9 1.5 1.9 0.1 0.2 0.6 3.4 6.2 2.6 0.9 0.7 1.4 1.9 1.6 1.4 1.3 1.3 1.3 1.5 1.8 2.0 1.5 1.8 2.9	2.4 3 0 3.3 2.6 2 4 32 2.1 1.4 0.3 0.1 0.0 0.0
S/F	A1-HSS
S/E	W W W W
0.0 0.0 0.1 0.7 2.7 7.3 4.3 0.6 0.2 0.1 0.0 0.1 0.1 0.1 0.1 0.1 0.1 0.1 0.1	
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9.1 1.5 1.2 1.5 W 515 W	
	GRAPHIC SCALE
	30 0 30


LUMINAIRE SCHEDULE						
CALLOUT	SYMB0L	DESCRIPTION	MODEL	QUANTITY	DEFAULT ELEVATION	
A1	← □	DALVIK 650S	HessAmerica, DAL650S—2LVC—WW—T4	7	15'	
A1-HSS	← □	DALVIK 650S	HessAmerica, DAL650S—2LVC—WW—T4—HSS	16	15'	
A2-HSS	← □	DALVIK 650S	HessAmerica, DAL650S—2LVC—WW—T3—HSS	2	15'	
B1	ю	Formed cast aluminum housing, LED strips with no enclosure	Landscape Forms Inc, CQ701—HE—LO	12	20'	
C1	0	Pathway Luminaire	Forms And Surfaces, 104971299CRT-002, Radia Pathway LBRAD CHECK CCT	11	1'	





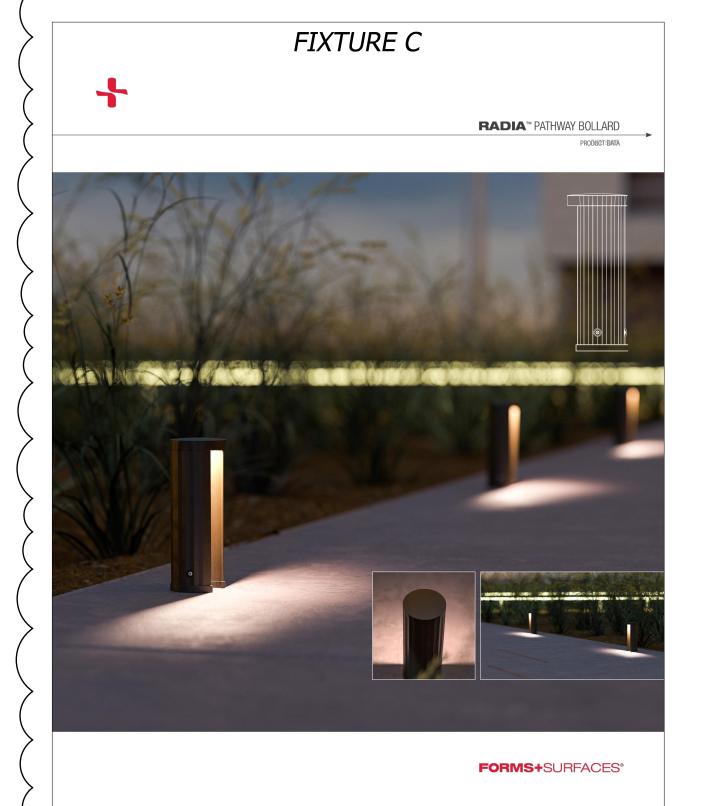

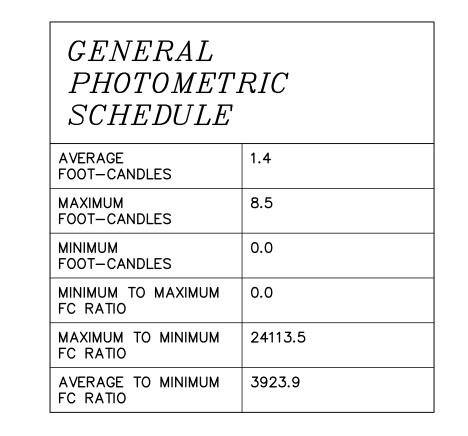

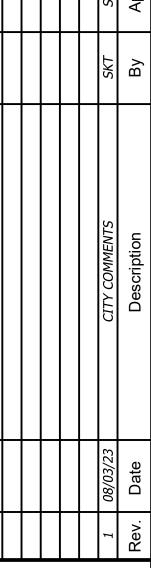






PDP SUBMITTAL RAINBOW DEVELOPMENT ESTWOOD, KS 66205 **PHOTOMETRICS**


Design: *DSN* Drawn: *DRN* Checked: Issue Date: 07/20/202. Project Number: 03792

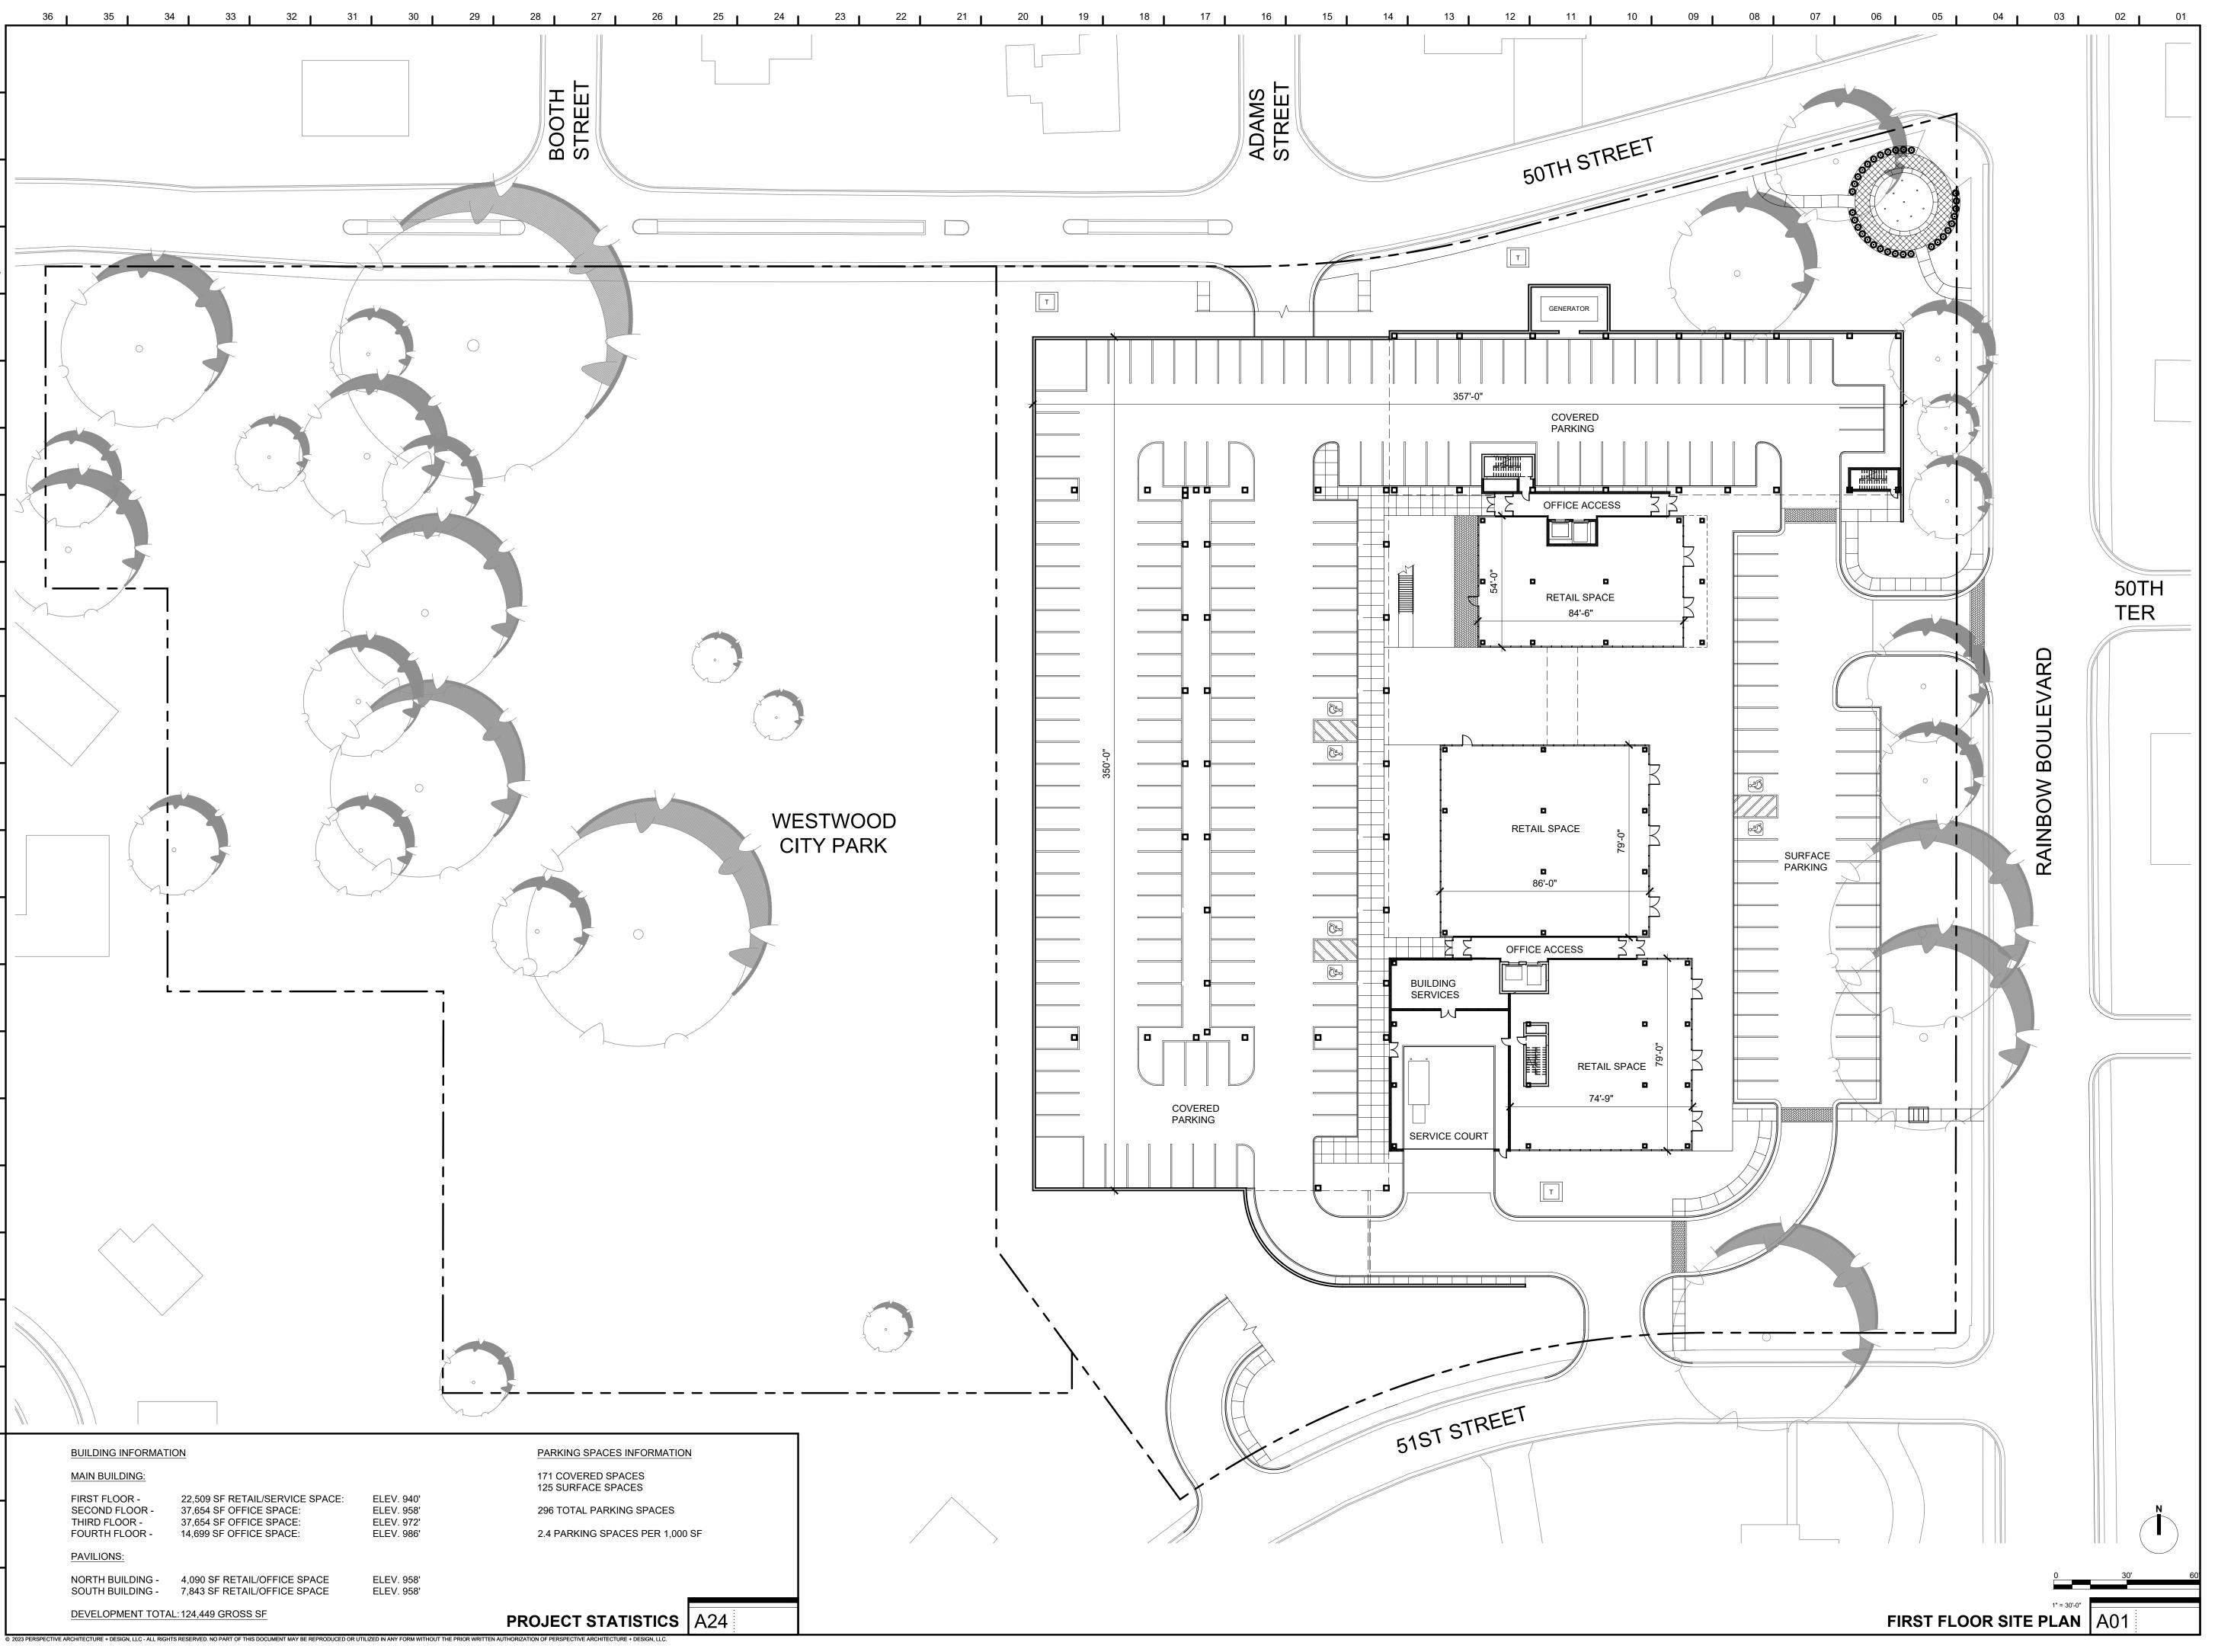

Perspective Perspective

2000 SHAWNEE MISSION PKWY SUITE 100 MISSION WOODS, KS 66205

816 502 1500 WWW.PAD.STUDIO

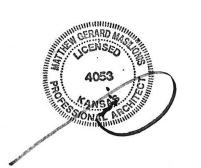

MATTHEW MASILIONIS - ARCHITECT KANSAS #4053

I have prepared the drawings and assume responsibility for the sheets numbered with an "A" prefix for the project named below.

below.

Other drawings and specifications attached for the above-mentioned project have been by and are the responsibility of the licensed engineer whose stamp and firm appear on that sheet.

The Architect is not responsible for the design of the mechanical, electrical, plumbing, civil, landscaping, structural, signage (not specified), fire sprinkler or fire supression systems; and does not take responsibility for the compliance of these areas with the laws of the above governmental entities. The architect is not responsible for materials, components or equipment, as well as the method in which they are installed on the project by others. The architect is not hired or responsible for certification, during construction or upon completion of construction. The architect is not responsible for improper operation due to faulty installation or

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responsible for improper operation due to faulty installation or product failure during construction or after completion of construction when operation has begun by the landlord or

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OJECT

50TH AND RAINBOW DEVELOPMENT

W50TH ST. & RAINBOW BLVD. WESTWOOD KS, 66205

MARK DATE DESCRIPTION


HEET TITLE

ARCHITECTURAL SITE PLAN

PROJECT NUMBER
2021073.000
SHEET AUTHOR
K. MILLER
CHECKED BY
M. PAXTON

PDP SUBMITTAL


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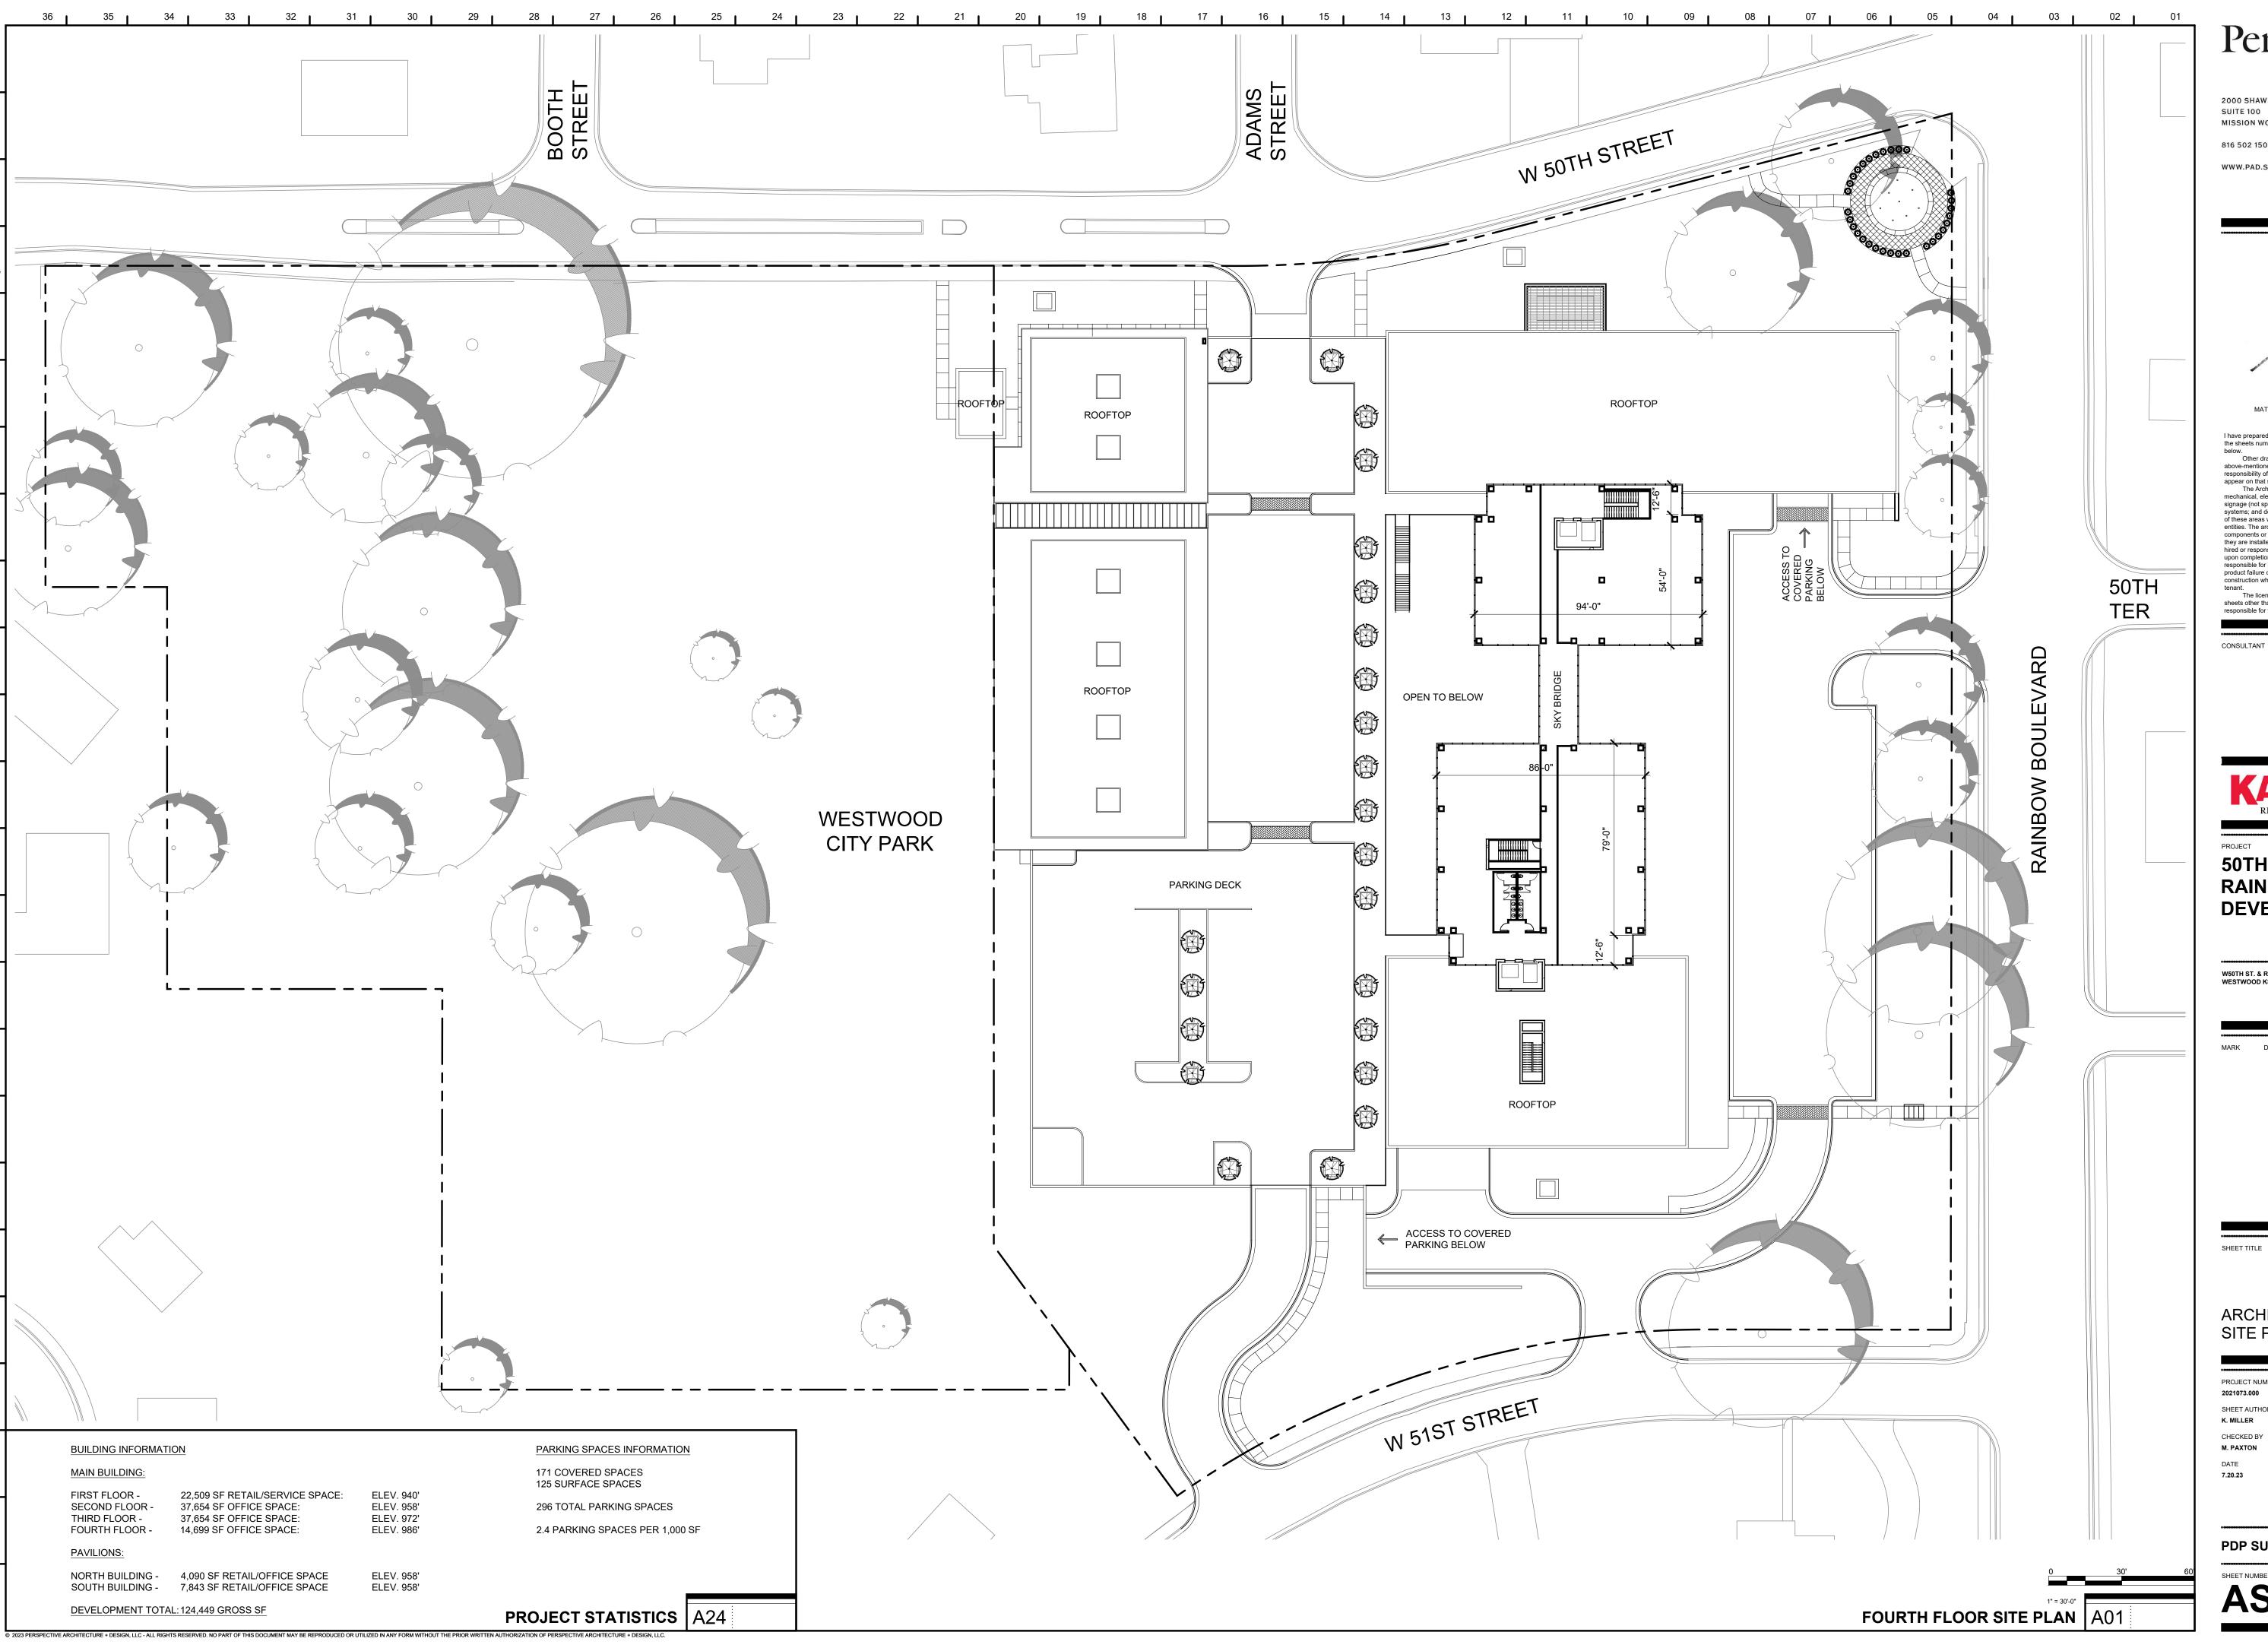
MARK DATE DESCRIPTION
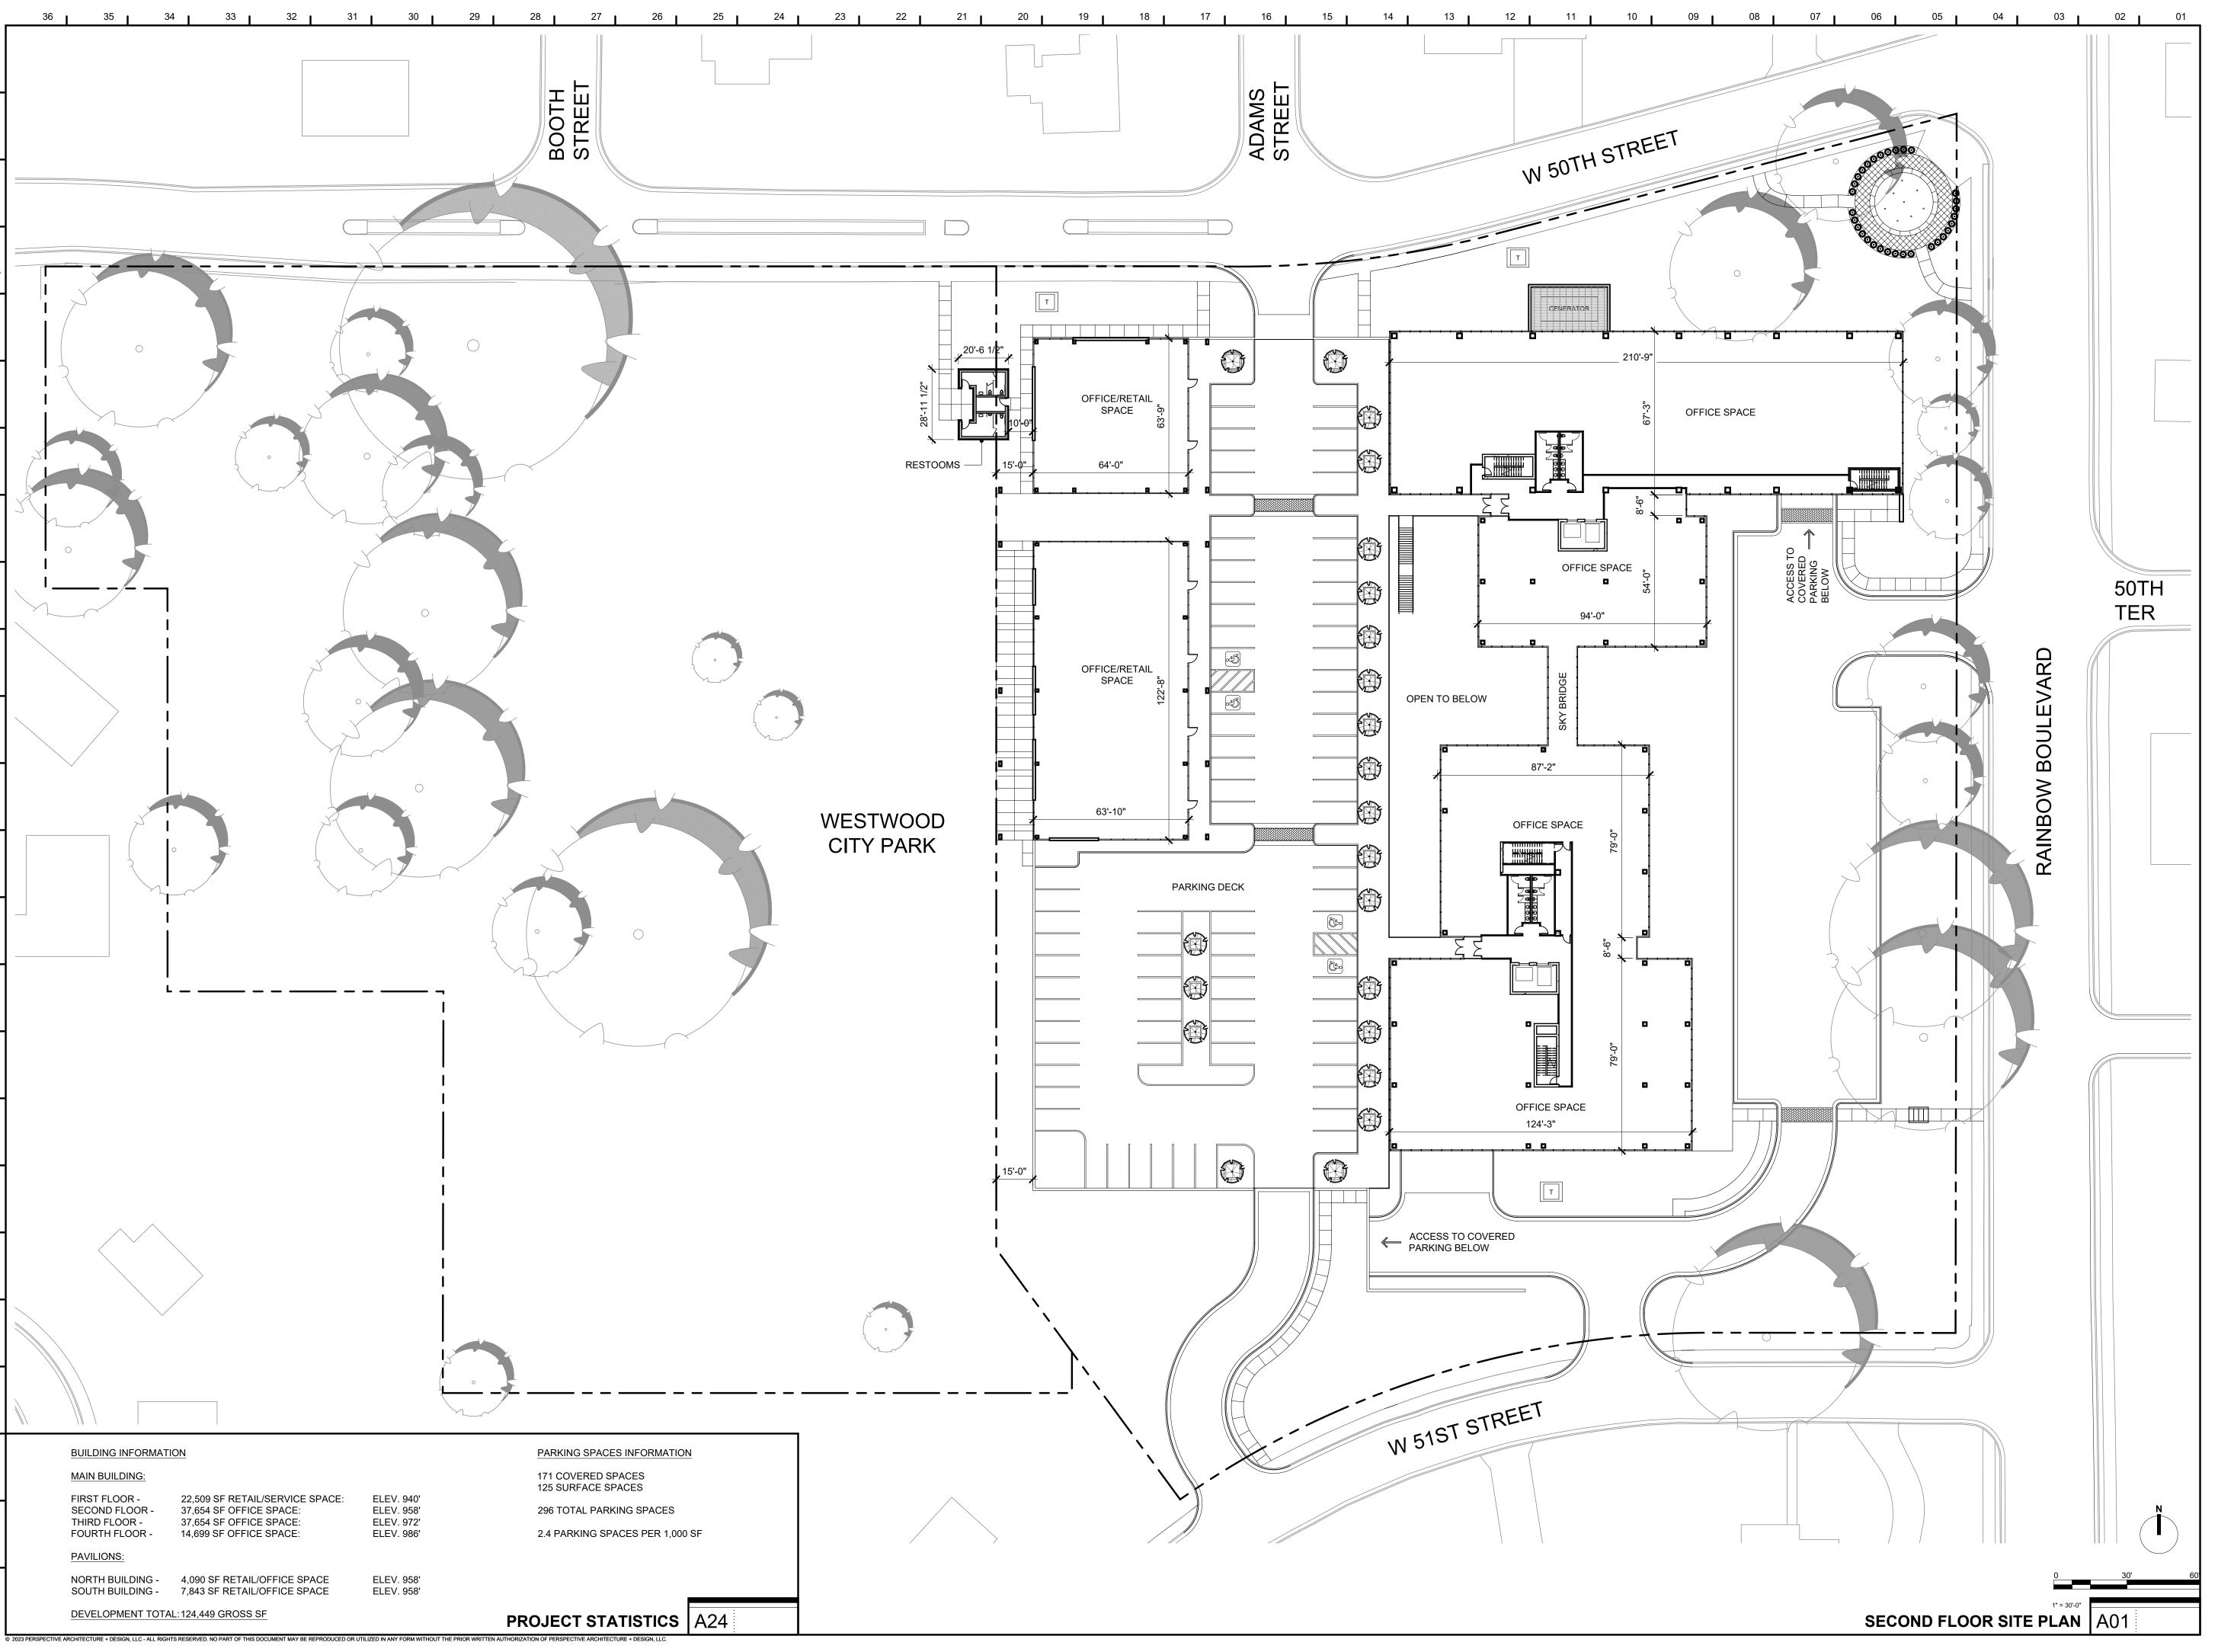
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PROJECT NUMBER 2021073.000 SHEET AUTHOR K. MILLER CHECKED BY M. PAXTON

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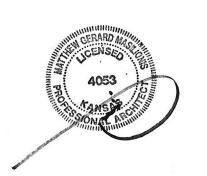
AS102



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ARCHITECTURAL SITE PLAN

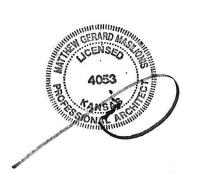PROJECT NUMBER 2021073.000 SHEET AUTHOR K. MILLER CHECKED BY M. PAXTON

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AS103

— GLAZED TERRACOTTA METAL PANEL SCREEN WALL — — GLAZED TERRACOTTA METAL PANEL SCREEN WALL — — GLAZED TERRACOTTA GLAZED TERRACOTTA — RAINSCREEN RAINSCREEN RAINSCREEN RAINSCREEN BUTT-GLAZED
CURTAINWALL
SYSTEM CLEAR ANODIZED — METAL CANOPY W/ — WOOD SOFFIT CURTAINWALL SYSTEM - BRICK VENEER T.O. MECHANICAL SCREEN_ METAL CANOPY W/ -WOOD SOFFIT ROOF DECK_ 1006'-0" CLEAR ANODIZED -CURTAINWALL SYSTEM FOURTH FLOOR
990'-0" THIRD FLOOR 974'-0" SECOND FLOOR
958'-0" ______ FIRST FLOOR
940'-0"

· CERARD MARINE

2000 SHAWNEE MISSION PKWY

MISSION WOODS, KS 66205

SUITE 100

816 502 1500

WWW.PAD.STUDIO

GENSES A053

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tenant.

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1/16" = 1'-0"

MAIN BUILDING - WEST ELEVATION NO1

KARBANK REAL ESTATE COMPANY

PROJECT

50TH AND RAINBOW DEVELOPMENT

W50TH ST. & RAINBOW BLVD. WESTWOOD KS, 66205

MARK DATE DESCRIPTION

JEET TITI E


ELEVATIONS


PROJECT NUMBER

SHEET AUTHOR
K. MILLER
CHECKED BY
M. PAXTON
DATE
7.20.23

PDP SUBMITTAL


SHEET NUMBER
A201

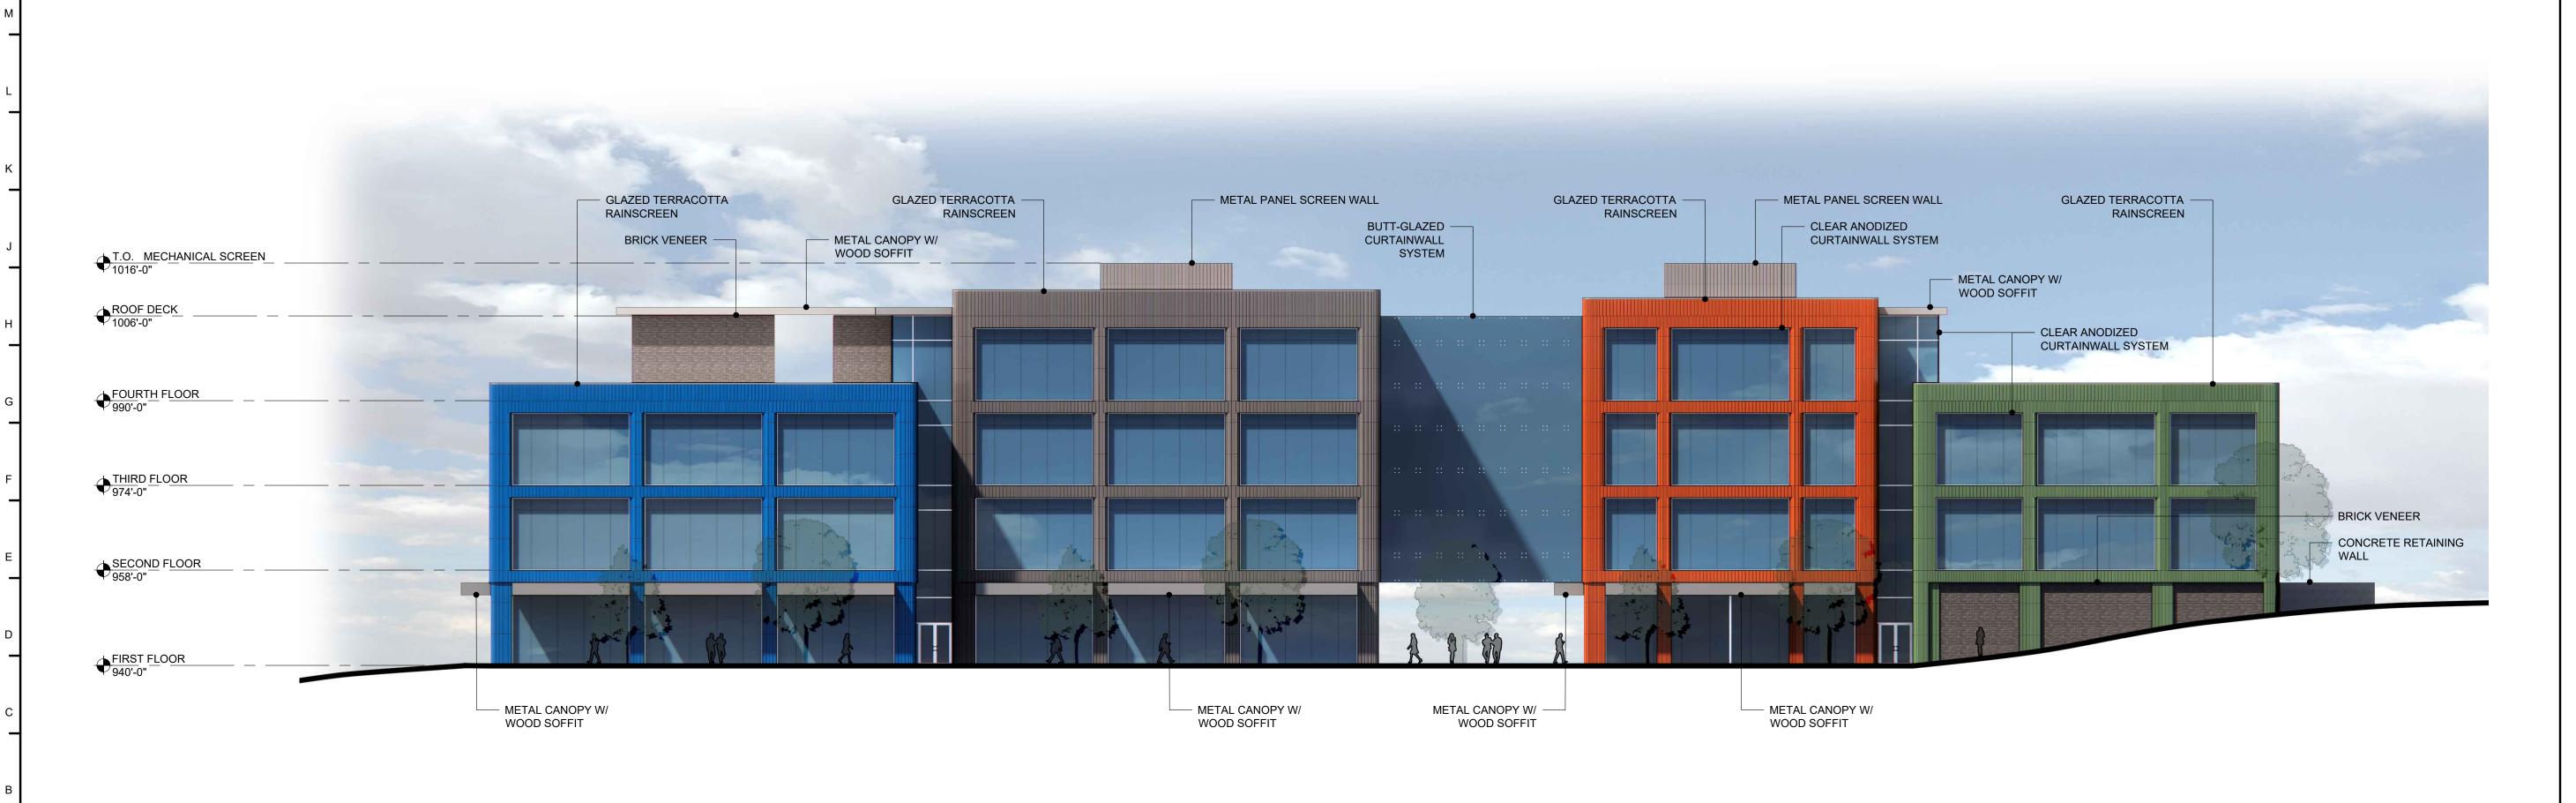

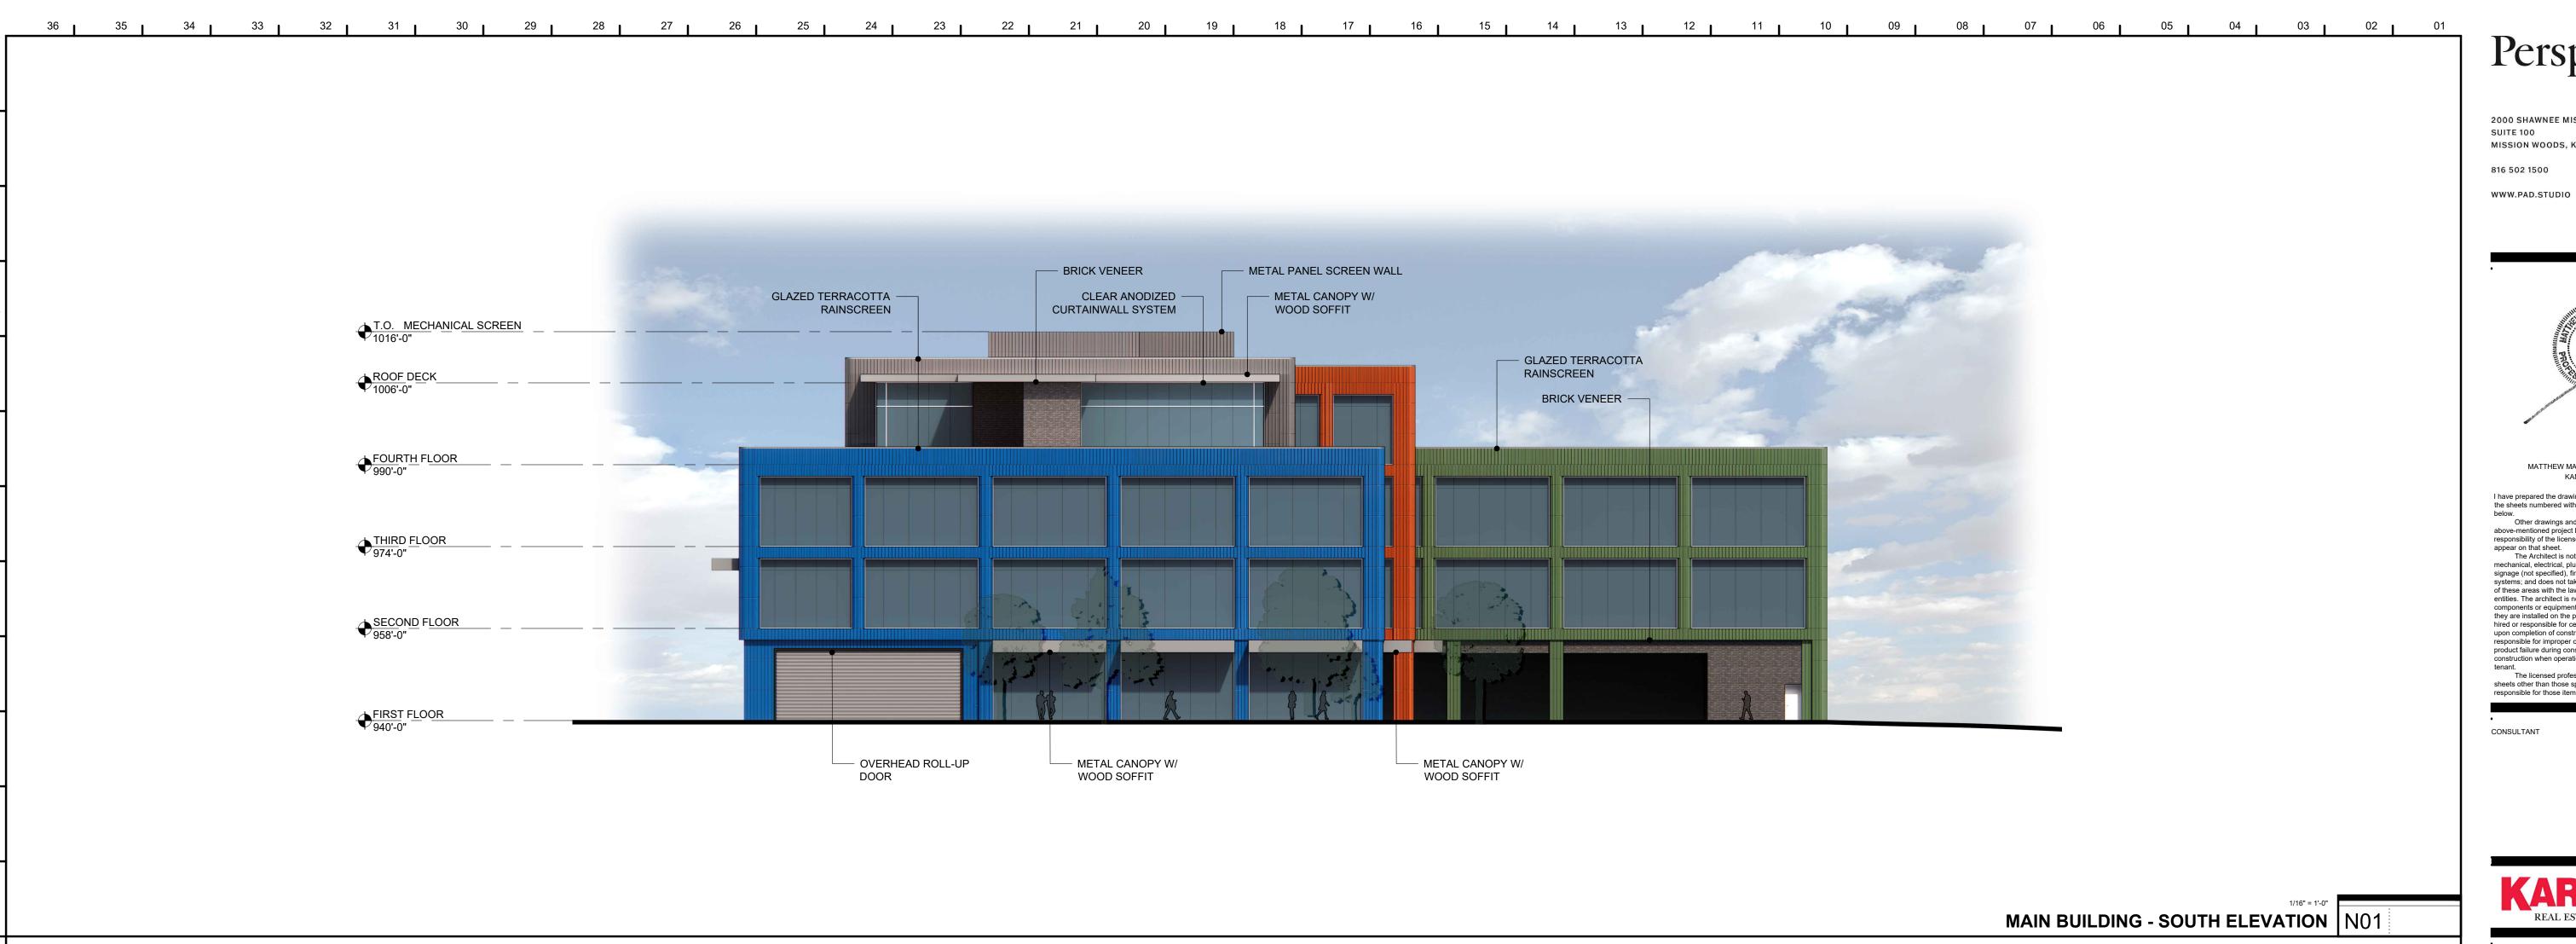

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816 502 1500

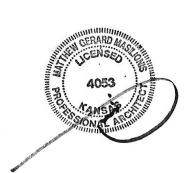

MATTHEW MASILIONIS - ARCHITECT KANSAS # 4053

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50TH AND RAINBOW **DEVELOPMENT**

W50TH ST. & RAINBOW BLVD. WESTWOOD KS, 66205

ELEVATIONS

PROJECT NUMBER 2021073.000 SHEET AUTHOR K. MILLER CHECKED BY M. PAXTON

DATE **7.20.23**

PDP SUBMITTAL

SHEET NUMBER

