CONSTRUCTION PLANS FOR:



WESTLAKE

NWC SEMINOLE PRATT WHITNEY & PERSIMMON WESTLAKE, FL 33470

PROJECT TEAM

PROPERTY OWNER/DEVELOPER: FIFTH THIRD BANK 38 FOUNTAIN SQUARE PLAZA, MD 10903K CINCINNATI, OH 45202 PH: (513) 534-0706 CONTACT: TAMMALA BROOKS

SURVEYORS:
EBI SURVEYING
8415 SUNSTATE STREET
TAMPA, FLORIDA 33634
CONTACT: THOMAS SERBU
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EMAIL: THOMAS@EBISURVEY.COM


CIVIL ENGINEER:


SUITE 230 TAMPA, FLORIDA 33602 PH: (813) 434-4770 CONTACT: NISIT SAPPARKHAO

ARCHITECT:
BDG ARCHITECTS

550 SOUTH CALDWELL STREET SUITE 1800 CHARLOTTE, NORTH CAROLINA 28202 PH: (704) 981-8951 CONTACT: JUAN C. QUINONES

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PARCEL CONTROL NUMBER: 77-40-43-01-24-001-0000
PALM BEACH COUNTY, FLORIDA

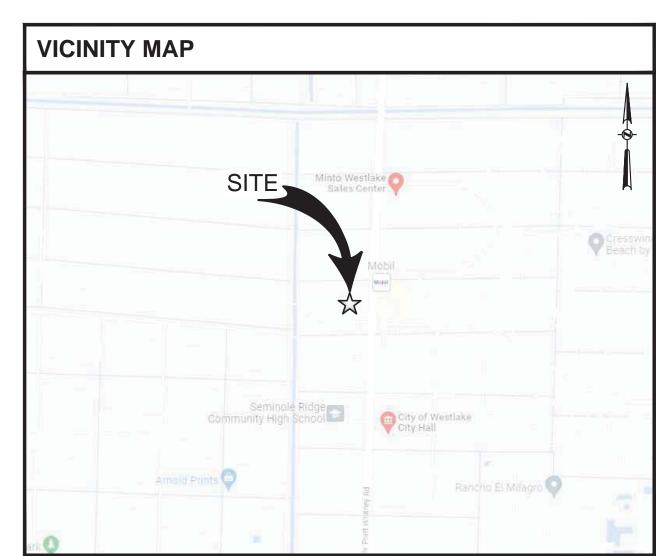SHEET NO.	SHEET TITLE	
C00.00	COVER SHEET	
C00.01	CIVIL SPECIFICATIONS	
C01.01	DEMOLITION PLAN	
C02.01	SITE PLAN	
C03.01	GRADING PLAN	
C03.02	STORM PIPING PLAN	
C04.01	UTILITY PLAN	
C05.01	DETAILS	
C05.02	DETAILS	
C05.03	DETAILS	
C06.01	SWPPP GENERAL REQUIREMENTS	
C06.02	EROSION CONTROL PLAN PHASE I	
C06.03	EROSION CONTROL PLAN PHASE II	
C06.04	EROSION AND SEDIMENTATION CONTROL DETAILS	
C07.01	LANDSCAPE PLAN	
L01.01	LANDSCAPE DETAILS	
L01.02	IRRIGATION PLAN	
L02.01	IRRIGATION DETAILS	
1 OF 1	COPY FROM SURVEY PLANS	

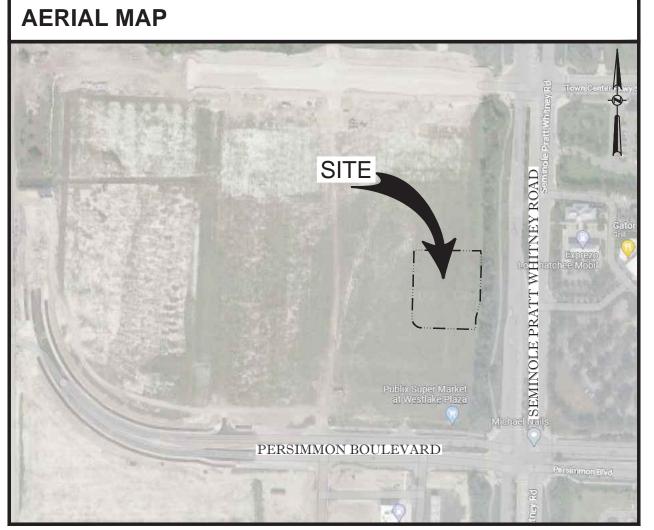

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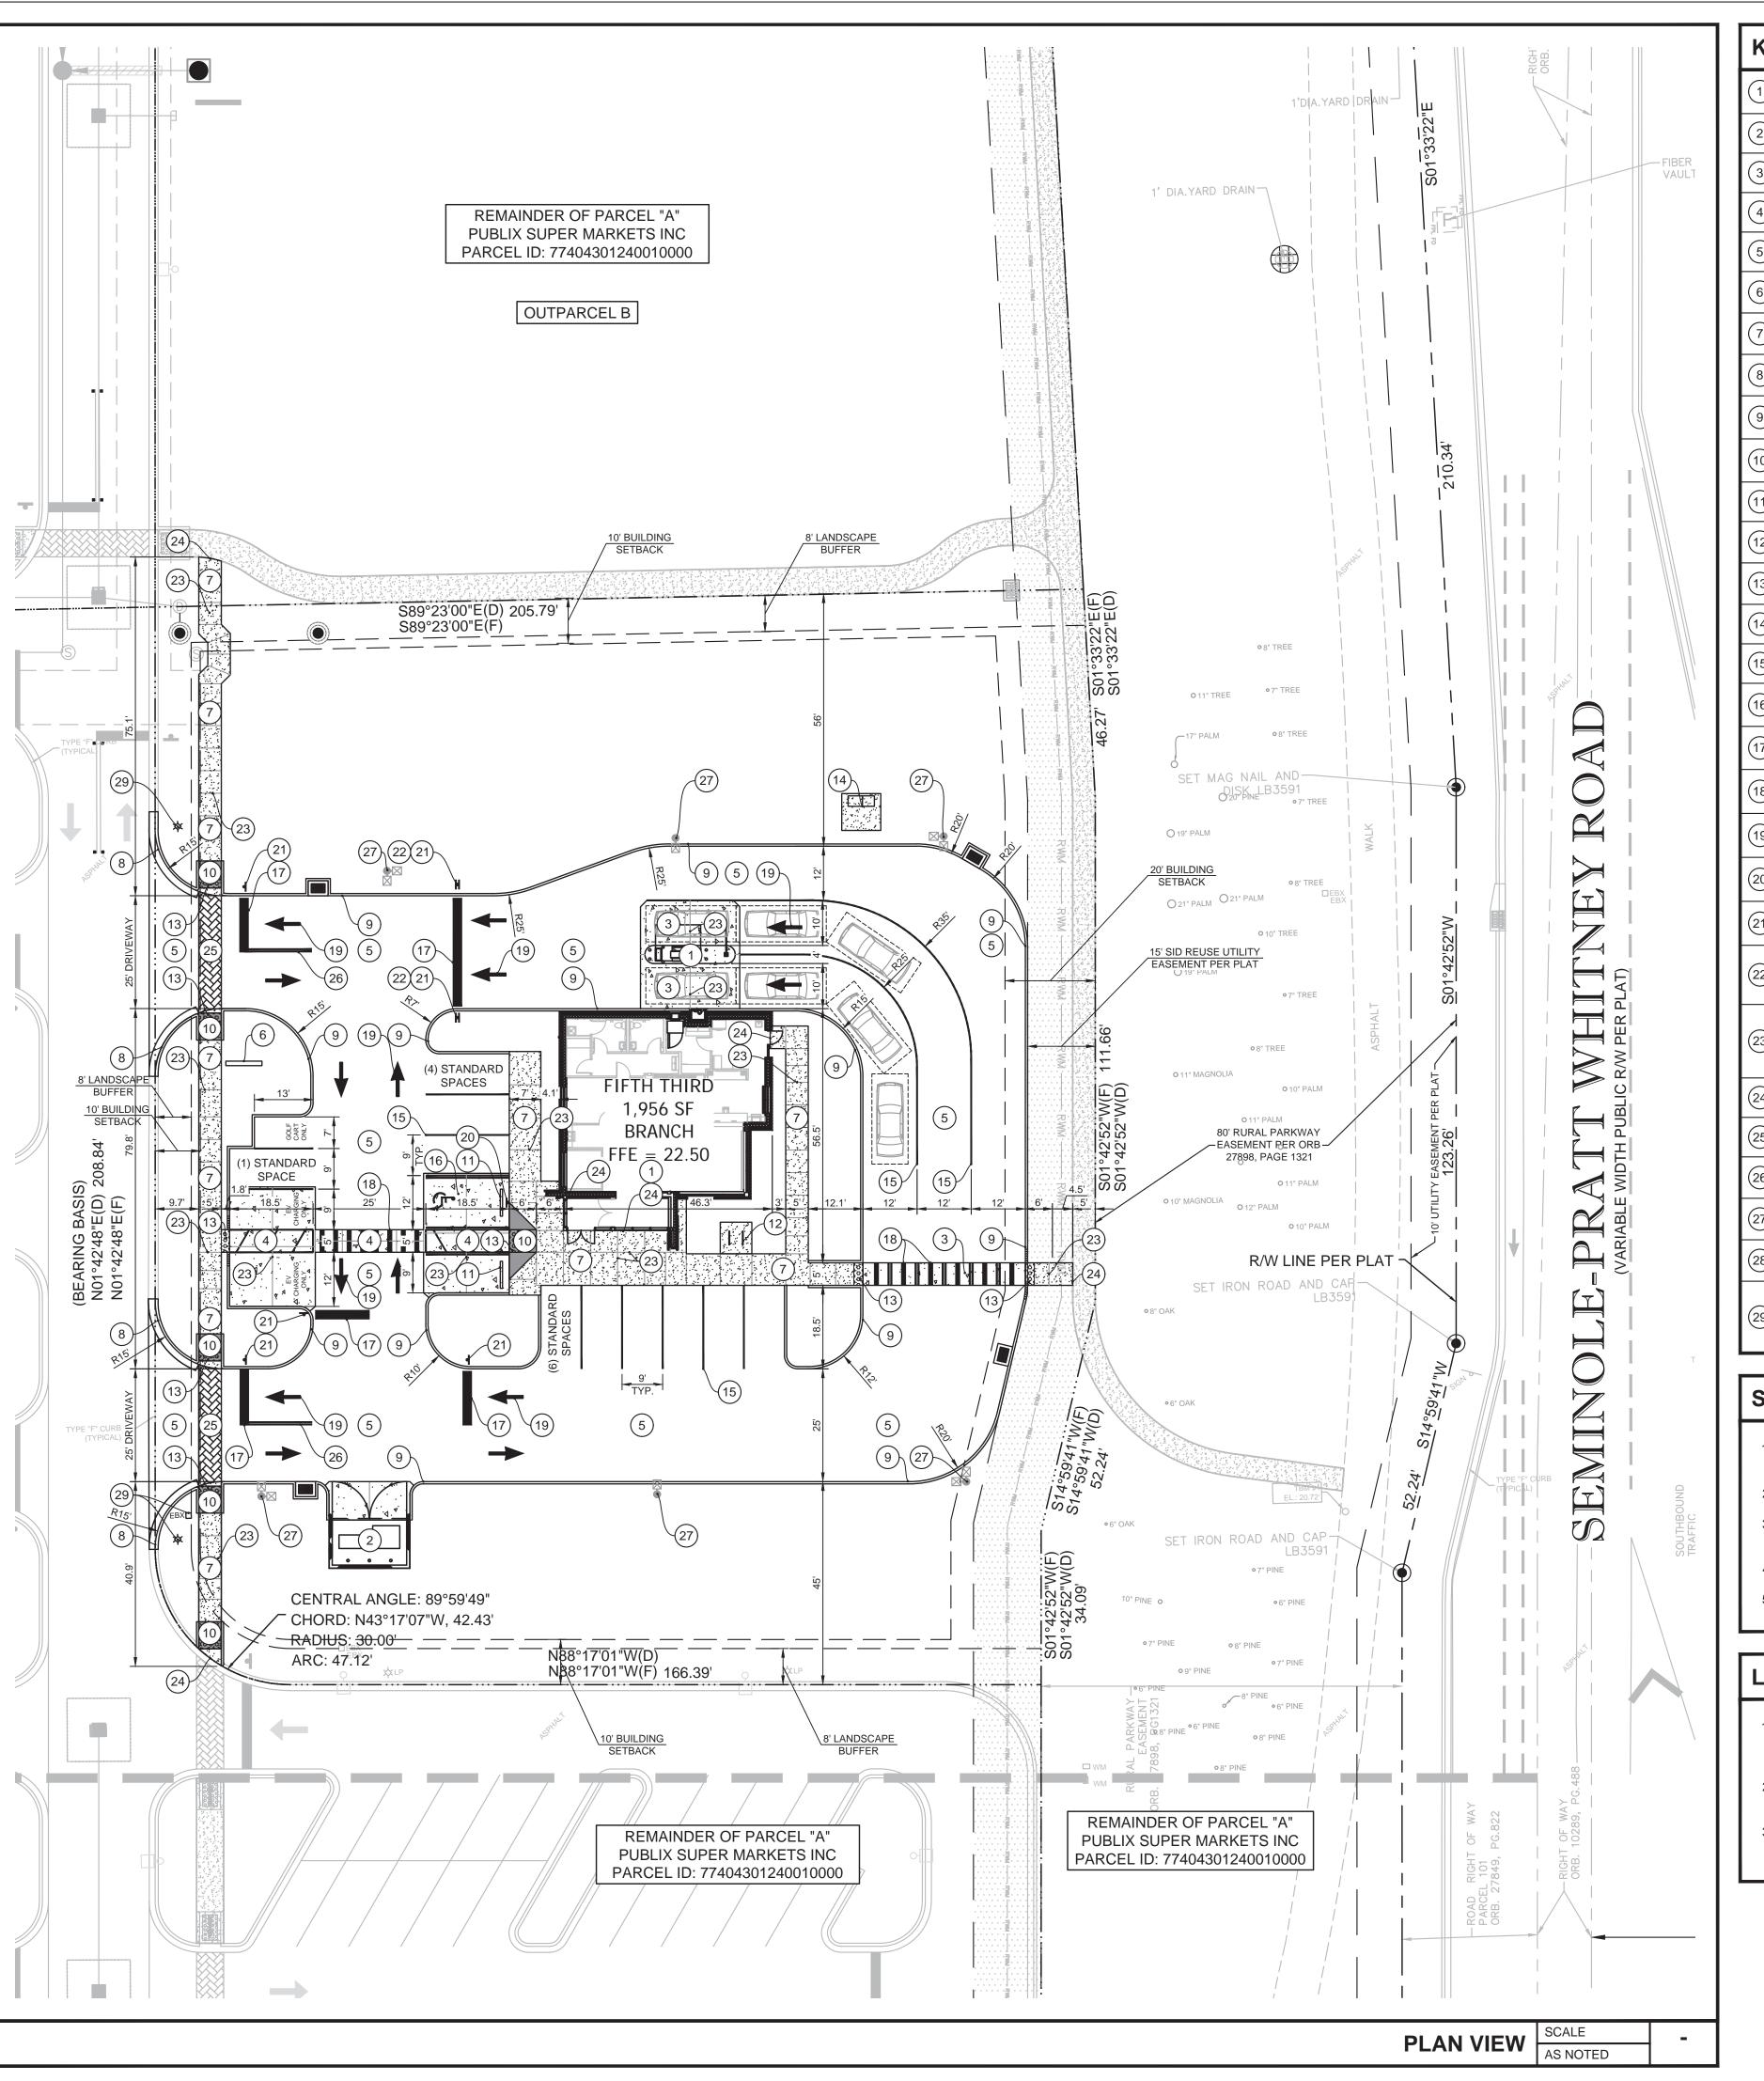


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KEYED NOTES

- NEW FIFTH THIRD BANK BUILDING AND DRIVE-THRU CANOPY (SEE ARCHITECTURAL PLANS).
- NEW TRASH ENCLOSURE (SEE ARCHITECTURAL PLANS).
- NEW 6" CONCRETE PAVEMENT. SEE DETAILS, SHEET C05.01.
- NEW 6" BLACK TINTED CONCRETE. SEE DETAILS, SHEET C05.01.
 - NEW ASPHALT PAVEMENT. SEE DETAILS, SHEET C05.01.
- NEW ID SIGN (DESIGNED AND PERMITTED BY OTHERS).
- NEW 4" CONCRETE SIDEWALK, SEE PLAN FOR WIDTH. SEE DETAILS,
- NEW 18" CURB AND GUTTER. SEE DETAILS, SHEET C05.01.
- NEW 6" X 18" VERTICAL CURB, 3-FOOT CURB TRANSITION AT PATHWAYS. SEE DETAILS, SHEET C05.01
-) | NEW ADA RAMP. SEE DETAILS, SHEET C05.01.
- NEW WHEEL STOPS (TYPICAL OF 2). SEE DETAILS, SHEET C05.01.
- NEW FIFTH THIRD STANDARD BICYCLE RACKS. SEE DETAILS, SHEET
- 3) NEW DETECTABLE WARNING. SEE DETAILS, SHEET C05.01.
- (14) NEW TRANSFORMER PAD. SEE UTILITY PLAN, SHEET C04.01.
- (15) NEW 6-INCH "WHITE" PARKING/AISLE STRIPE (CONTINUOUS PAINT)
- NEW ACCESSIBLE PARKING SPACE AND ACCESS AISLE SEE DETAILS, SHEET C05.01.
- (17) NEW 24-INCH "WHITE" STOP BAR (CONTINUOUS PAINT).
- NEW 5-FOOT WIDE CROSSWALK, 12-INCH "WHITE" STRIPE @ 36" O.C. (CONTINUOUS PAINT).
- (19) NEW "WHITE" DIRECTIONAL ARROW (CONTINUOUS PAINT).
- NEW ACCESSIBLE PARKING SIGN. SEE DETAILS, SHEET C05.02.
- NEW 30" R1-1 "STOP" SIGN (TYPICAL OF 6). SEE DETAILS, SHEET C05.02. (PROVIDED AND INSTALLED BY FIFTH THIRD SIGN VENDOR).
- NEW 30" R5-1 "DO NOT ENTER" SIGN (TYPICAL OF 2). (22) | SEE DETAILS, SHEET C05.02. (PROVIDED AND INSTALLED BY FIFTH THIRD SIGN VENDOR).
- SAWCUT A 1/4" CONTROL JOINT IN NEW SIDEWALK AS SHOWN. NEW CONTROL JOINT DEPTH MUST BE A MINIMUM OF 25% OF THE OVERALI SLAB DEPTH AND BE PERFORMED WITHIN 12 HR OF POUR. (TYPICAL). SEE DETAILS, SHEET C05.01.
- **EXPANSION JOINTS (TYPICAL)**

DEVELOPER.

- (25) NEW CROSSWALK PAVERS TO MATCH EXISTING DEVELOPMENT.
- (26) NEW 6-INCH "DOUBLE YELLOW" LANE STRIPE (CONTINUOUS PAINT).
- (27) NEW AREA LIGHT POLE. SEE ELECTRICAL SITE PLANS.
- ELECTRICAL STUB-UP FOR FUTURE ELECTRIC VEHICLE (EV) CHARGING STATION. SEE ELECTRICAL SHEET FOR MORE DETAILS.
- EXISTING DEVELOPMENT LIGHT POLE AND ELECTRICAL JUNCTION BOX TO BE RELOCATED BY GENERAL CONTRACTOR / ELECTRICAL CONTRACTOR. GENERAL CONTRACTOR TO COORDINATE WITH

SITE PLAN GENERAL NOTES

- ALL DIMENSIONS SHOWN ARE TO FACE OF CURB. BUILDING DIMENSIONS ARE TO FACE OF BUILDING.
- 2. EXISTING IMPROVEMENTS SHOWN ARE TAKEN FROM THE SURVEY.
- 3. BUILDING AND SIDEWALK DIMENSIONS ARE TO OUTSIDE EDGE OF
- 4. ALL TIES TO THE PROPERTY LINE ARE BASED ON THE SURVEY.
- 5. ALL CURB RADIUS ARE 3' UNLESS OTHERWISE NOTED

LANDSCAPE NOTE

- CONTRACTOR TO RE-GRADE SURROUNDING GRADE ELEVATION AND RE-SOD AS NEED TO MEET PROPOSED TOP OF SIDEWALK ELEVATIONS.
- CONTRACTOR SHALL REPLACE ALL DISTURBED LANDSCAPING TO MATCH EXISTING.
- CONTRACTOR SHALL TIE INTO EXISTING IRRIGATION SYSTEM AND EXTEND NEW DRIP IRRIGATION AS REQUIRED TO ACCOMMODATE NEW CONSTRUCTION.

LEGEND

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PROPERTY LINE

EXISTING TO REMAIN

EXISTING CONCRETE TO REMAIN

PROPOSED CONCRETE LESS THAN 6'

PROPOSED CONCRETE 6" OR GREATER

NEW ASPHALT PAVEMENT

SETBACK/BUFFER

PROPOSED CURB

PROPOSED CURB AND GUTTER

BANK W/ DRIVE-THRU

SITE DATA

FUTURE LAND USE DESIGNATION: DOWNTOWN MIXED USE **EXISTING ZONING DISTRICT:** MIXED USE

SECTION/TOWNSHIP/RANGE: 01 43 40

PROPERTY CONTROL NUMBER: 77-40-43-01-24-001-0000

EXISTING USE: VACANT/COMMERCIAL APPROVED USE: MIXED USE PROPOSED USE: COMMERCIAL /

PARCEL DATA

PART OF PUBLIX RETAIL CENTER: 379,626 SF (8.72 AC) OUTPARCEL C: 49,220 SF (1.13 AC) PROPOSED PLAT AREA: 49,220 SF (1.13 AC)

FIFTH THIRD BANK W/ DRIVE-THRU: 1,956 SF NUMBER OF FLOORS: PROPOSED BUILDING HEIGHT: 23 FT MAX. BUILDING HEIGHT FOR MU: 120 FT 43,560 SF MINIMUM PARCEL SIZE: MAXIMUM LOT COVERAGE: 45% MINIMUM PERVIOUS AREA: 25% MINIMUM BUILDING SEPARATION: 20 FT

PARKING DATA

BANK W. DRIVE-THRU: 1 SPACE PER 300 SF OF G.F.A. 1,956 SF x (1/300) = 7 SPACES

TOTAL PARKING PROVIDED: STANDARD PARKING: 11 SPACES **EVCPS PARKING:** 2 SPACES LSEV PARKING: 1 SPACE

ACCESSIBLE PARKING: 1 SPACE TOTAL PARKING:

PARKING SPACE SIZE: **BICYCLE PARKING REQUIRED:**

9' X 18.5' MINIMUM / 25' DRIVE AISLE 5% OF REQUIRED PARKING 7 SPACES * 5% = 1 SPACE REQUIRED 4 BICYCLE PARKING PROVIDED

LOADING ZONE:

*NOTE: FINANCIAL INSTITUTIONS DO NOT USE LOADING ZONES FOR SECURITY PURPOSES. DELIVERY TRUCK WILL PARK DIRECTLY IN FRONT OF MAIN ENTRANCE.

LANDSCAPE REQUIREMENTS

LANDSCAPE BUFFER - SEMINOLE PRATT WHITNEY ROAD = 0' LANDSCAPE BUFFER - SIDE (NORTH) = 8' LANDSCAPE BUFFER - SIDE (SOUTH) = 8' LANDSCAPE BUFFER - REAR (WEST) = 8'

BUILDING REQUIREMENTS

BUILDING SETBACK - SEMINOLE PRATT WHITNEY ROAD = 20' BUILDING SETBACK - SIDE (NORTH) **BUILDING SETBACK - SIDE (SOUTH)** = 10' **BUILDING SETBACK - REAR (WEST)** = 10'

FLOOD ZONE

FLOOD ZONE AE ELEVATION 18.5' PER FEMA MAP 12099C0531F DATED

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Engineering Group LLC Ecn=Nisit Sapparkhaø, email=nisit@iegroup.net Date: 2023.03.02 11 34:18 Adobe Acrobat DC

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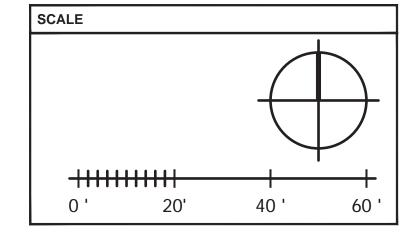
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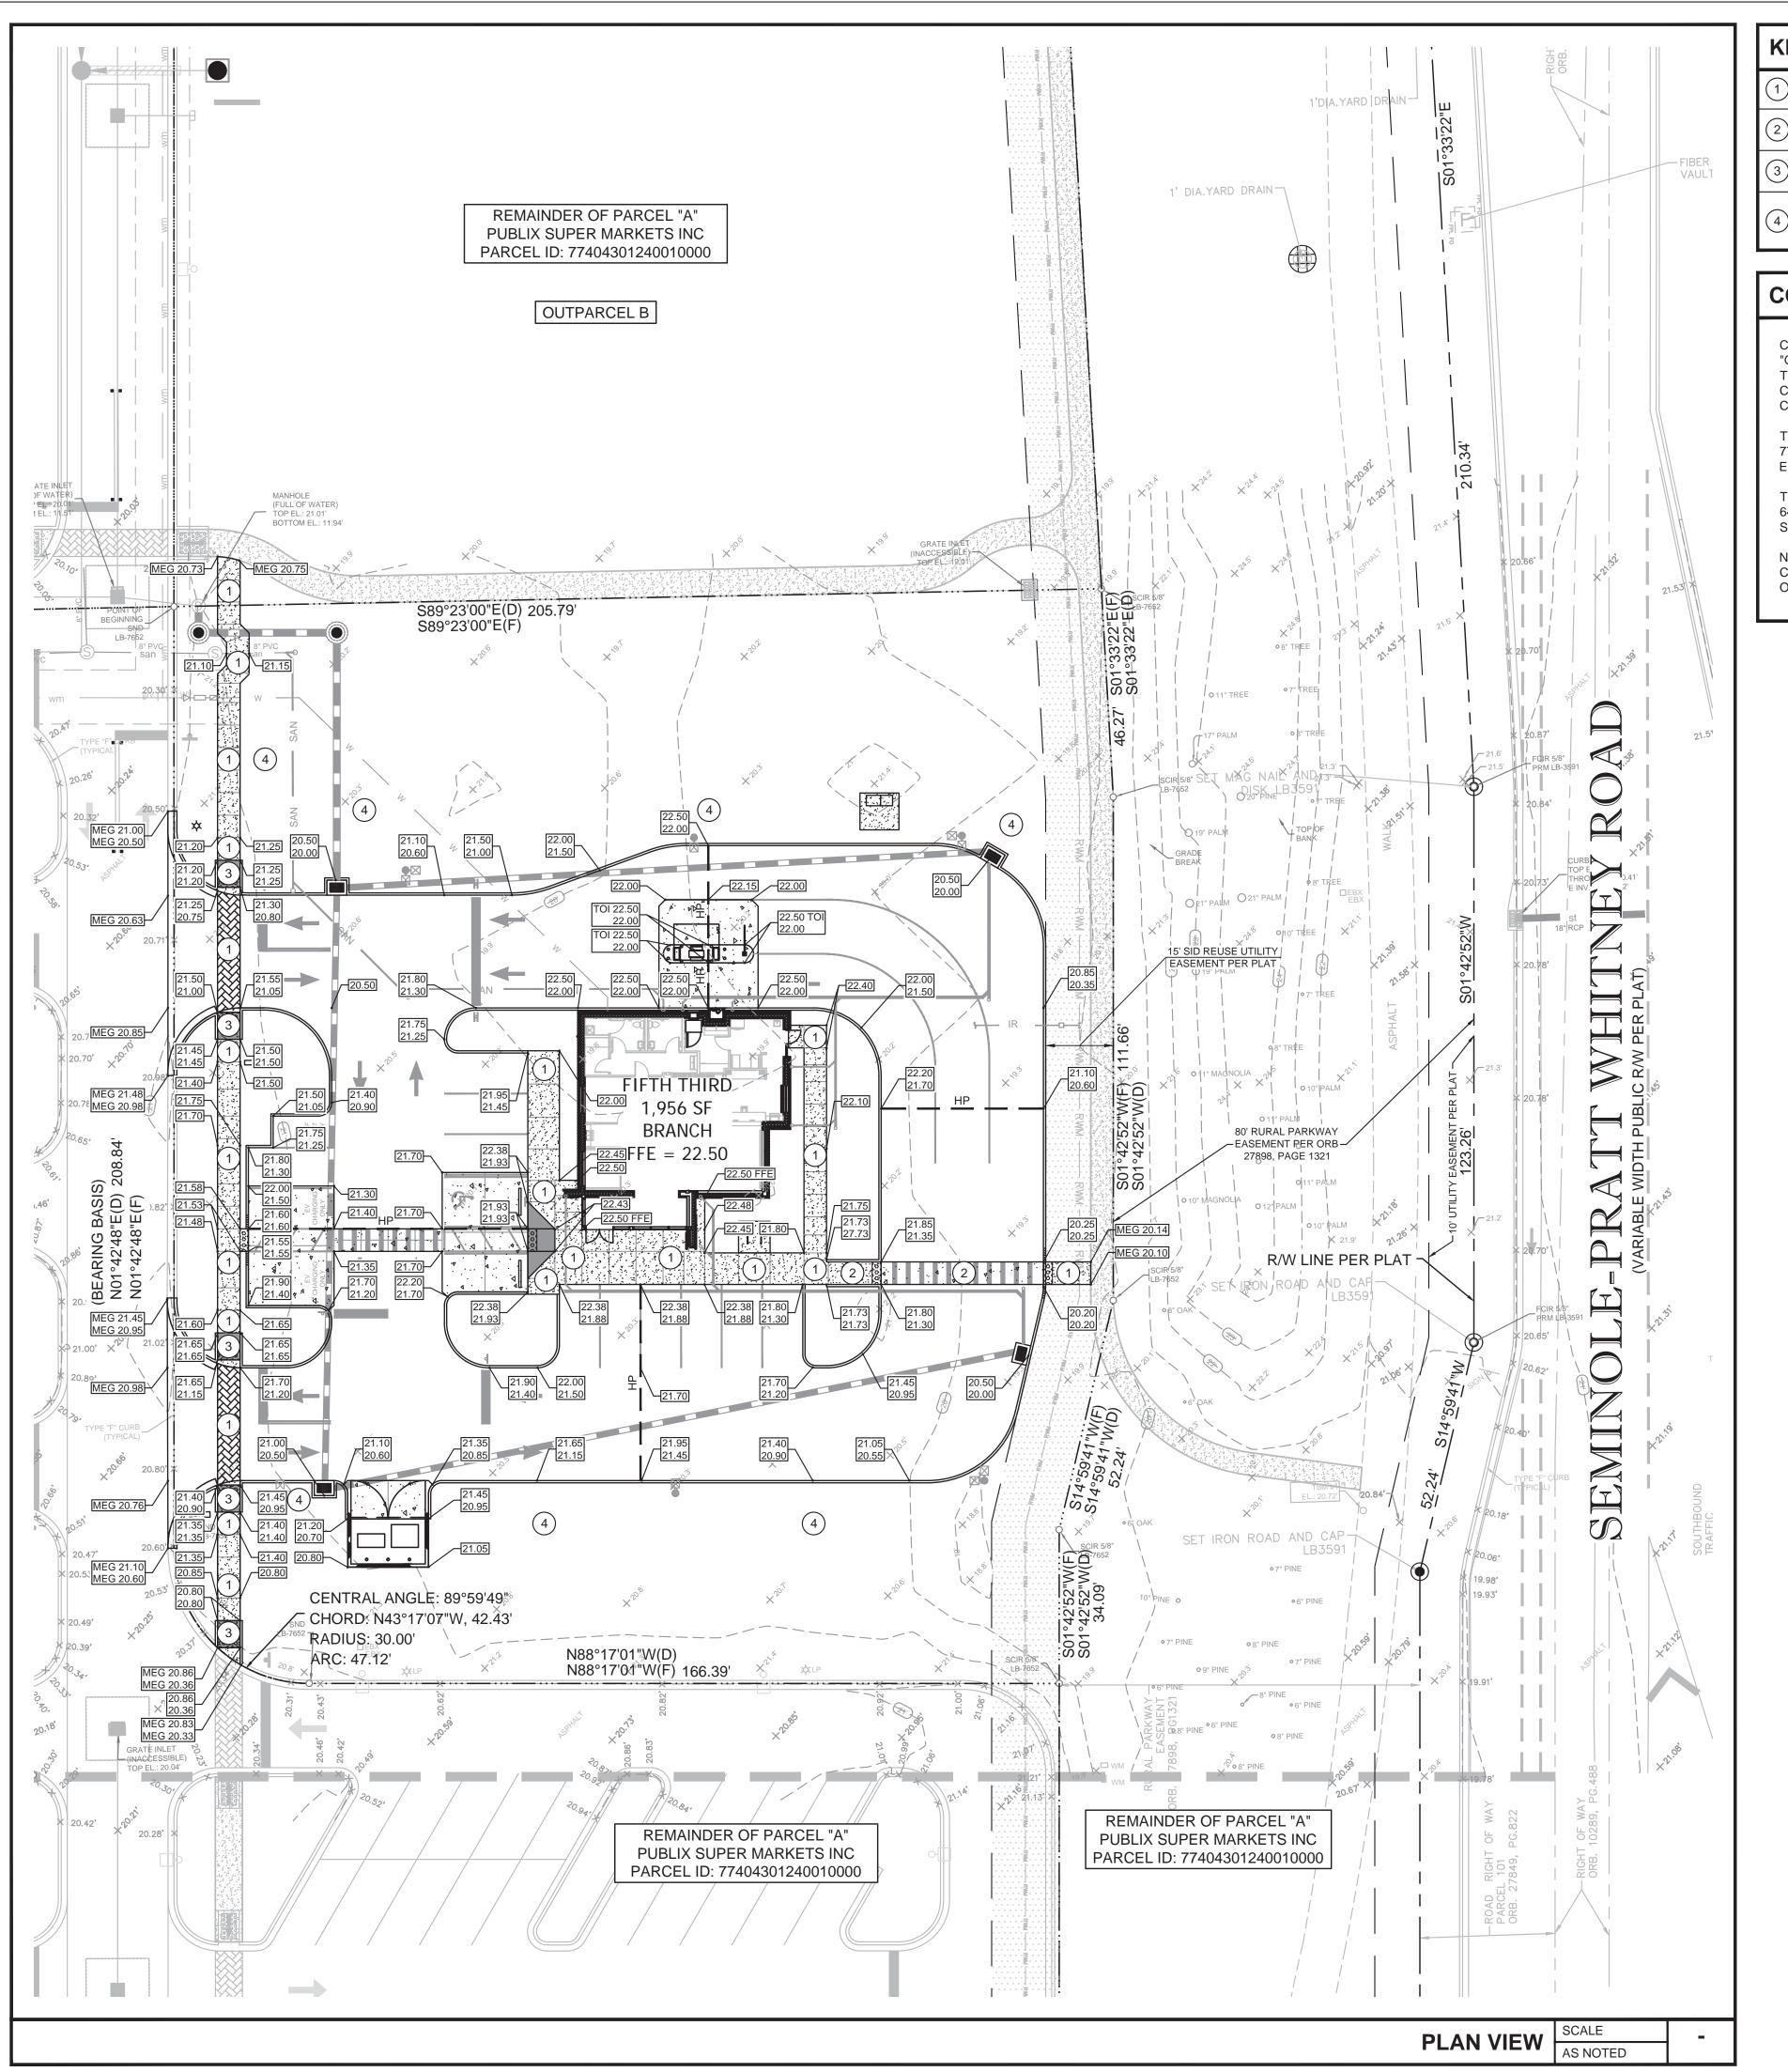
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SHEET TITLE

SITE PLAN

SHEET NUMBER





KEYED NOTES:

- SURFACE SLOPES NOT TO EXCEED 1:48 IN ALL DIRECTIONS.
- SURFACE SLOPES NOT TO EXCEED 1:48 CROSS SLOPES AND 1:20
- SURFACE SLOPES NOT TO EXCEED 1:48 CROSS SLOPES AND 1:12
- RE-GRADE SURROUNDING LANDSCAPING GRADE ELEVATION AND RE-SOD/RE-MULCH AS REQUIRED TO MATCH EXISTING GRADE ELEVATIONS, SLOPES NOT TO EXCEED 4:1.

CONTROL BENCHMARKS

CONTROL BENCHMARK: STATION IS A P.B.C BRASS DISK STAMPED "GRIFFIN". LOCATED IN THE TOP OF THE SOUTH CONCRETE CURB OF THE ENTRANCE OF GROVE MARKET SHOPPING CENTER 3' NORTH OF A CONCRETE LIGHT POLE AND 25' EAST OF THE EAST EDGE OF A 5' WIDE

TBM #1: STATION IS A NAIL AND DISK STAMPED "EBI LB-7652" LOCATED 77.6' NORTHEAST OF THE SOUTHEAST CORNER OF SUBJECT PARCEL. EL.: 20.72' (NAVD88)

TBM #2: STATION IS A NAIL AND DISK STAMPED "EBI LB-7652" LOCATED

CONTRACTOR TO ESTABLISH CONTROL BENCHMARKS BEYOND LIMITS

CONCRETE SIDEWALK. EL.: 20.03' (NAVD88)

64.6' SOUTHWEST OF THE POINT OF CURVE ON THE SOUTH LINE OF SUBJECT PARCEL. EL.: 20.36' (NAVD88)

OF DEMOLITION PRIOR TO CONSTRUCTION.

LEGEND

ELEVATION

TYP	TYPICAL	HP	CONCRETE PIPE HIGH POINT
CO	CLEANOUT	MEG	MATCH EXISTING GRADE
ΙE	INVERT ELEVATION	TOI	TOP OF ISLAND
SE	SUMP ELEVATION	DS	BUILDING DOWN SPOUT
×49.58 0.00	EXISTING ELEVATION PROPOSED PAVEMENT		12" OR GREATER STORMWATER PIPE
0.00	TOP OF SIDEWALK/CURB EDGE OF PAVEMENT		LESS THAN 12" STORMWATER PIPE
	DITCH BOTTOM INLET	→ ~	PROPOSED SURFACE STORMWATER FLOW
	CURB INLET		PROPOSED SWALE STORMWATER FLOW
FFE	FINISH FLOOR ELEVATION	- - 29	EXISTING CONTOUR
	-	29	PROPOSED CONTOUR

RCP

REINFORCED

EROSION CONTROL MEASURE NOTE

REQUIRED EROSION CONTROL MEASURES SHALL BE INSTALLED AS NEEDED AND MUST REMAIN INTACT THROUGHOUT CONSTRUCTION. FAILURE TO INSTALL OR PROPERLY MAINTAIN THESE BARRICADES WILL RESULT IN ENFORCEMENT ACTION WHICH MAY INCLUDE CITATIONS, AND INITIATION OF CIVIL PENALTY PROCEDURES.

PAVING AND GRADING GENERAL NOTES

- 1. SEE GENERAL NOTES SHEET FOR EROSION AND SILTATION CONTROL ALONG WITH GENERAL NOTES.
- 2. SEE SITE PLAN SHEET FOR SITE DATA.
- 3. SEE SURVEY FOR TEMPORARY BENCH MARK (TBM) LOCATIONS.
- 4. THE CONTRACTOR SHALL MEET ALL REQUIREMENTS FOR LOCAL MUNICIPALITY AND THE FLORIDA DEPARTMENT OF TRANSPORTATION WITH REGARD TO IMPROVEMENTS WITHIN THEIR RESPECTIVE RIGHTS-OF-WAY.
- 5. ALL DISTURBED AREAS WITHIN RIGHT-OF-WAY TO BE RETURNED TO MATCH EXISTING CONDITION.
- 6. ALL CLEANOUT TOP ELEVATION SHALL MATCH FINISH GRADE ELEVATIONS.
- CONTRACTOR SHALL INSTALL EROSION CONTROL SILT FENCE AROUND THE PERIMETER OF THE SITE AND MUST MAINTAIN THE SILT FENCE IN GOOD REPAIR UNTIL ALL CONSTRUCTION IS COMPLETE AND THE AREA IS STABILIZED.
- 8. THE CONTRACTOR SHALL CONTACT THE ENGINEER PRIOR TO ANY CONSTRUCTION IF ANY PROBLEMS OR DISCREPANCIES EXIST.

ACCESSIBILITY NOTES

- 1. ALL ACCESSIBLE PARKING SPACES AND ACCESS AISLES ADJACENT TO THE HANDICAP PARKING SPACES SHALL HAVE A MAXIMUM OF 2% SLOPE IN ALL DIRECTIONS (THIS INCLUDES RUNNING SLOPE AND CROSS SLOPE).
- 2. AN ACCESSIBLE ROUTE FROM THE PUBLIC STREET OR SIDEWALK TO ALL BUILDING ENTRANCES MUST BE PROVIDED. THIS ACCESS ROUTE SHALL BE A MINIMUM OF 48" WIDE. THE RUNNING SLOPE OF AN ACCESSIBLE ROUTE SHALL NOT EXCEED 5% AND THE CROSS SLOPE SHALL NOT EXCEED 2%.
- SLOPES EXCEEDING 5% BUT LESS THAN 8% WILL REQUIRE A RAMP AND MUST CONFORM TO THE REQUIREMENTS FOR RAMP DESIGN (HANDRAILS, CURBS, LANDINGS). NO RAMP SHALL EXCEED AN 8% RUNNING SLOPE OR 2% CROSS SLOPE.
- IT WILL BE THE RESPONSIBILITY OF THE GENERAL CONTRACTOR TO ENSURE THAT THE ACCESSIBLE PARKING SPACES, ACCESSIBLE ROUTES, AND SIDEWALK/CROSSWALKS ARE CONSTRUCTED TO MEET ADA REQUIREMENTS.
- ANY REQUIREMENTS LISTED ABOVE THAT CAN NOT BE MET SHALL BE BROUGHT TO THE ENGINEER'S ATTENTION IMMEDIATELY. ANYTHING NOT BUILT TO THE ABOVE STANDARDS WILL REQUIRE REMOVAL AND REPLACEMENT OF THE NON COMPLIANT AREAS AT THE GENERAL CONTRACTORS COST.

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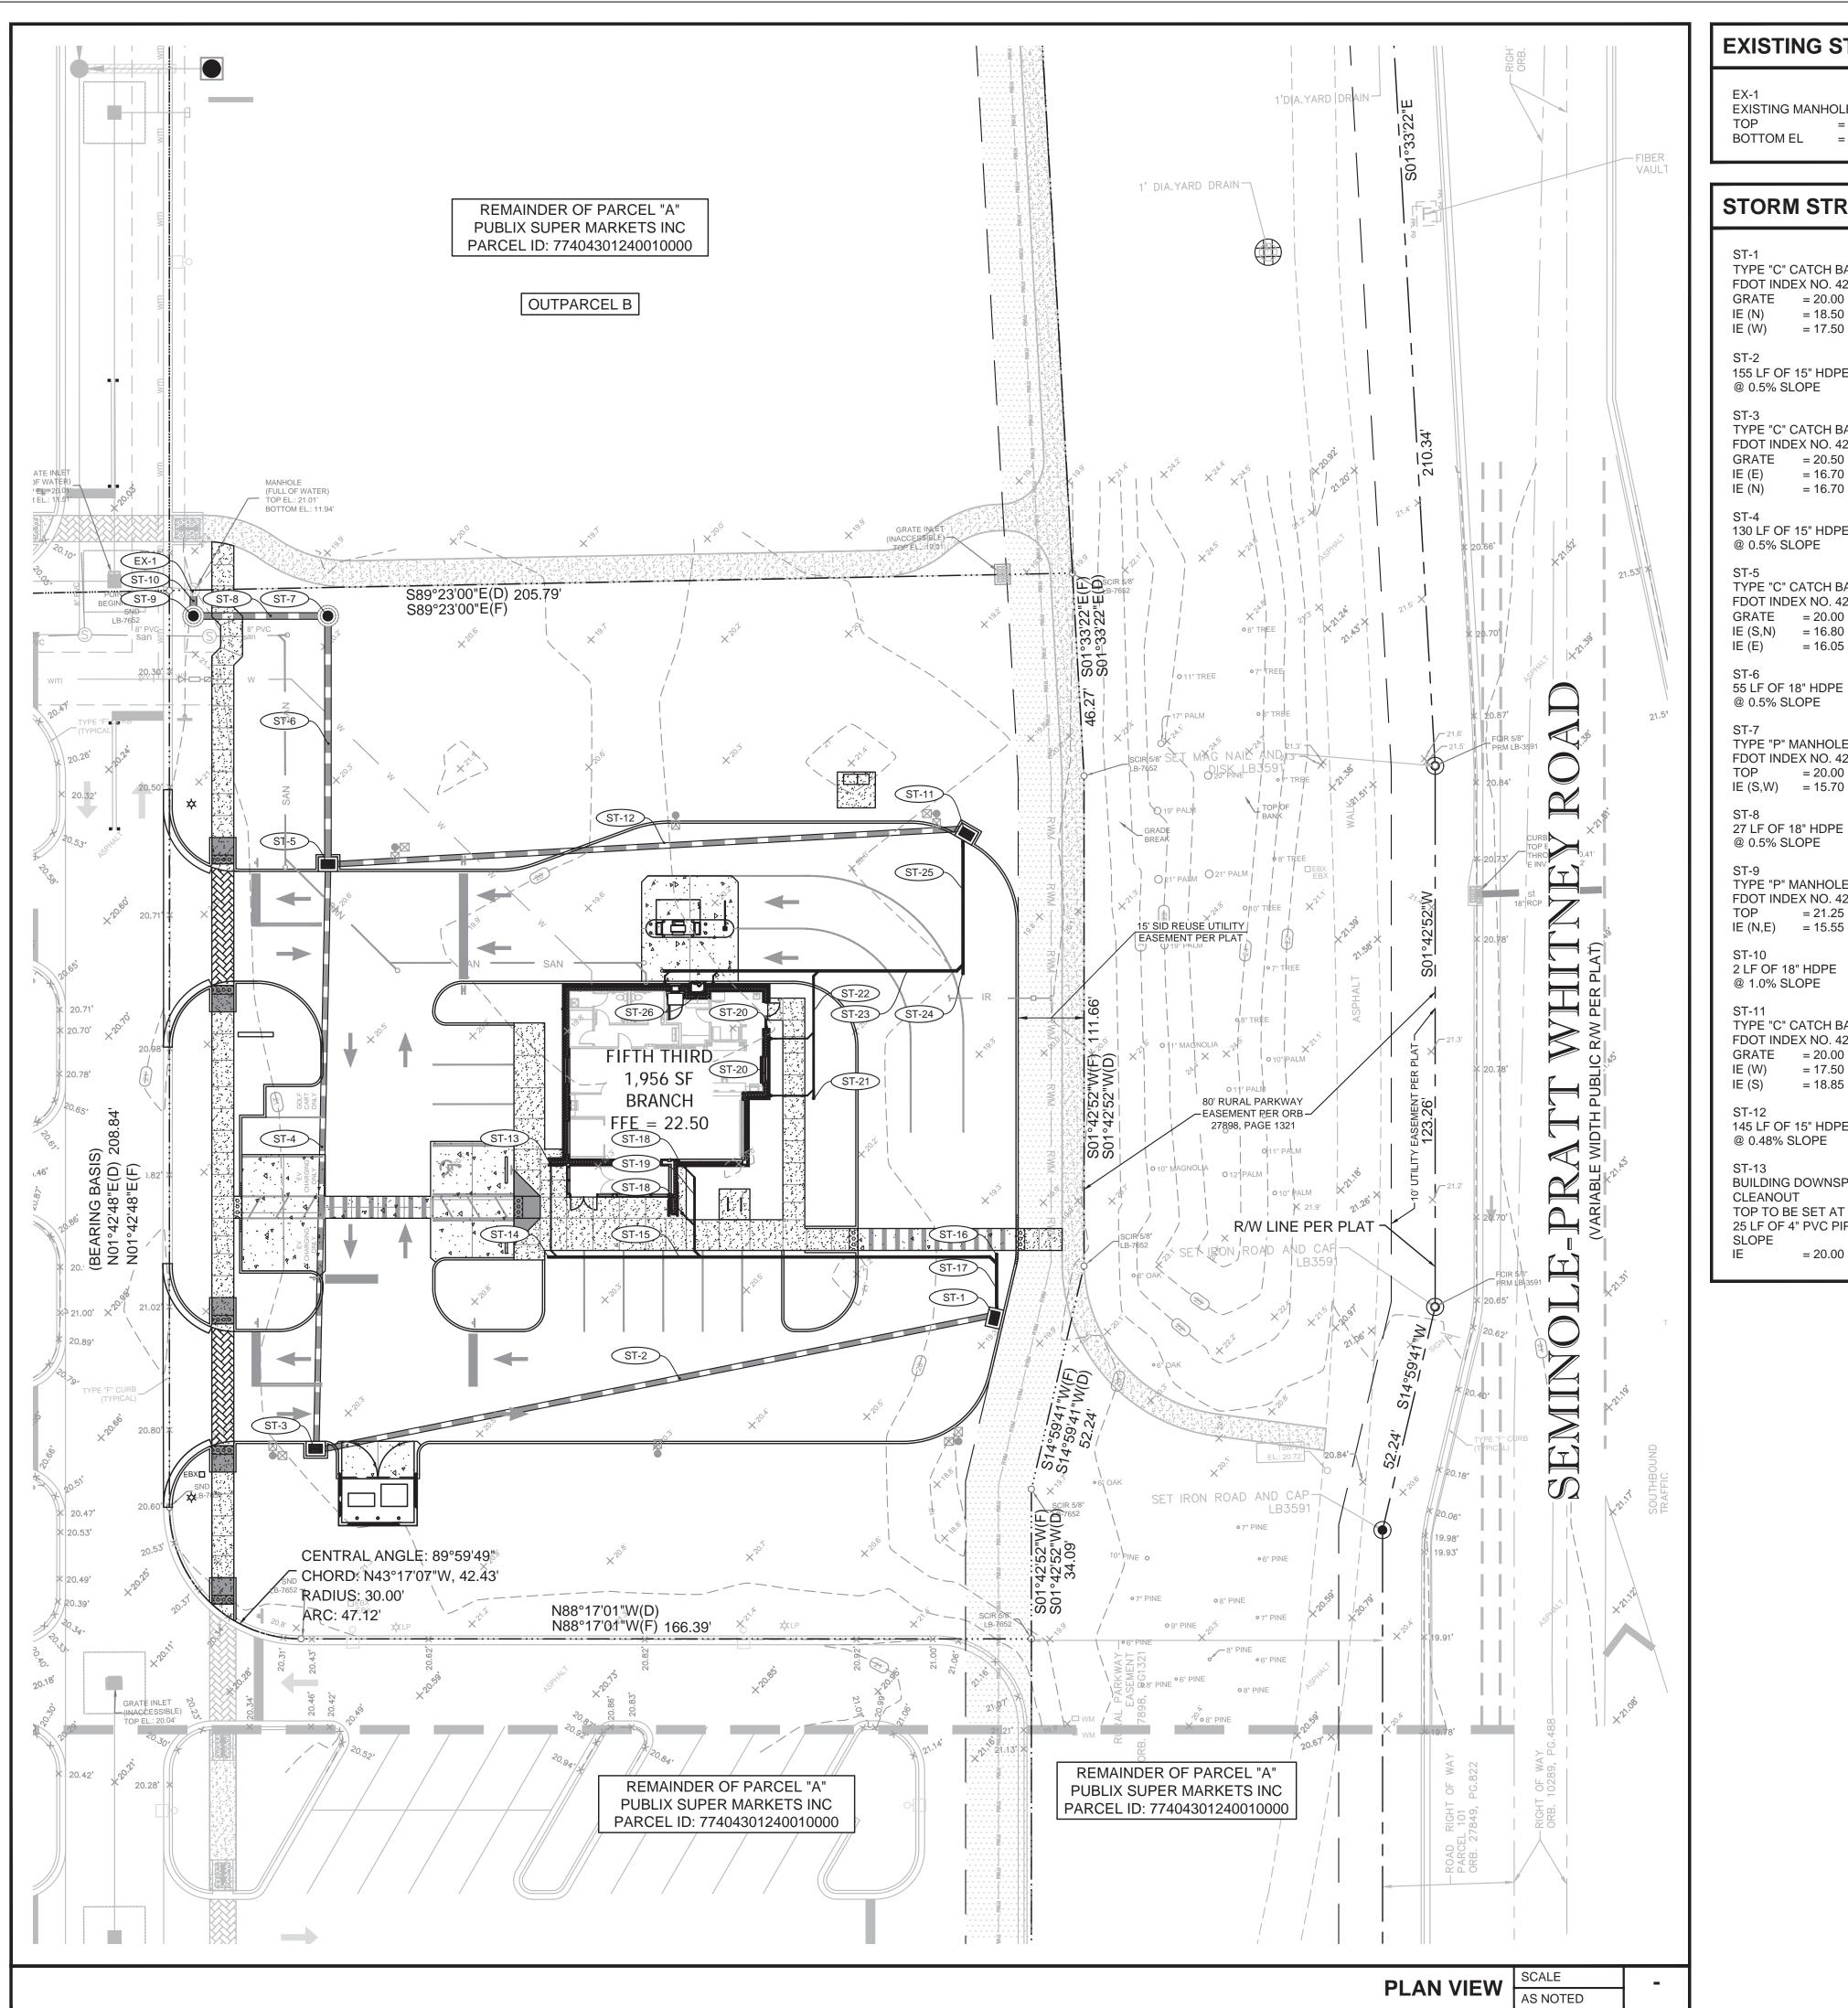
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GRADING PLAN

SHEET NUMBER

C03.01

SCALE 40 ' 60 20'



EXISTING STORM STRUCTURE/PIPING DATA

EXISTING MANHOLE BOTTOM EL = 11.94'

STORM STRUCTURE/PIPING DATA

CONSTRUCT CLEANOUT TYPE "C" CATCH BASIN TOP TO BE SET AT GRADE FDOT INDEX NO. 425-052 = 19.75GRATE = 20.00= 18.50

= 17.50105 LF OF 8" PVC @ 1.0% MIN. SLOPE 155 LF OF 15" HDPE

ST-16 @ 0.5% SLOPE CONSTRUCT CLEANOUT TOP TO BE SET AT GRADE = 18.70TYPE "C" CATCH BASIN

FDOT INDEX NO. 425-052 ST-17 GRATE = 20.5013 LF OF 8" PVC = 16.70@ 1.0% MIN. SLOPE = 16.70

BUILDING DOWNSPOUT AND 130 LF OF 15" HDPE CLEANOUT @ 0.5% SLOPE TOP TO BE SET AT GRADE WITH 4 LF OF 4" PVC PIPE @ 1.0% MIN. SLOPE TYPE "C" CATCH BASIN = 22.00

ST-20

= 21.85

= 19.20

BUILDING DOWNSPOUT AND

= 20.00

TOP TO BE SET AT GRADE WITH

30 LF OF 8" PVC

CLEANOUT

@ 1.0% MIN. SLOPE

FDOT INDEX NO. 425-052 GRATE = 20.00ST-19 IE (S,N) = 16.8020 LF OF 6" PVC = 16.05 @ 1.0% MIN. SLOPE

55 LF OF 18" HDPE **BUILDING DOWNSPOUT AND** @ 0.5% SLOPE CLEANOUT TOP TO BE SET AT GRADE WITH 10 LF OF 4" PVC PIPE @ 1.0% MIN TYPE "P" MANHOLE FDOT INDEX NO. 425-010

= 20.00= 20.00IE (S,W) = 15.70ST-21 CONSTRUCT CLEANOUT TOP TO BE SET AT GRADE

ST-22 30 LF OF 6" PVC TYPE "P" MANHOLE @ 1.0% MIN. SLOPE FDOT INDEX NO. 425-010

= 21.25ST-23 IE (N,E) = 15.5570 LF OF 8" PVC @ 1.0% MIN. SLOPE

@ 1.0% SLOPE CONSTRUCT CLEANOUT TOP TO BE SET AT GRADE TYPE "C" CATCH BASIN ST-25

FDOT INDEX NO. 425-052 GRATE = 20.00= 17.50IE (W) IE (S) = 18.85

145 LF OF 15" HDPE @ 0.48% SLOPE **BUILDING DOWNSPOUT AND** CLEANOUT TOP TO BE SET AT GRADE WITH

3 LF OF 4" PVC PIPE @ 1.0% MIN. SLOPE 25 LF OF 4" PVC PIPE @ 1.0% MIN. = 20.00

LEGEND

ELEVATION TYPICAL CLEANOUT INVERT ELEVATION SUMP ELEVATION EXISTING ELEVATION DITCH BOTTOM INLET CURB INLET FINISH FLOOR ELEVATION REINFORCED CONCRETE PIPE

STORM SEWER STRUCTURE NUMBER **BUILDING DOWN SPOUT**

12" OR GREATER STORMWATER PIPE LESS THAN 12" STORMWATER PIPE DIRECTION OF PIPE FLOW

- -29- EXISTING CONTOUR ——29— PROPOSED CONTOUR

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- 2. SEE SITE PLAN SHEET FOR SITE DATA.
- 3. SEE SURVEY FOR TEMPORARY BENCH MARK (TBM) LOCATIONS.
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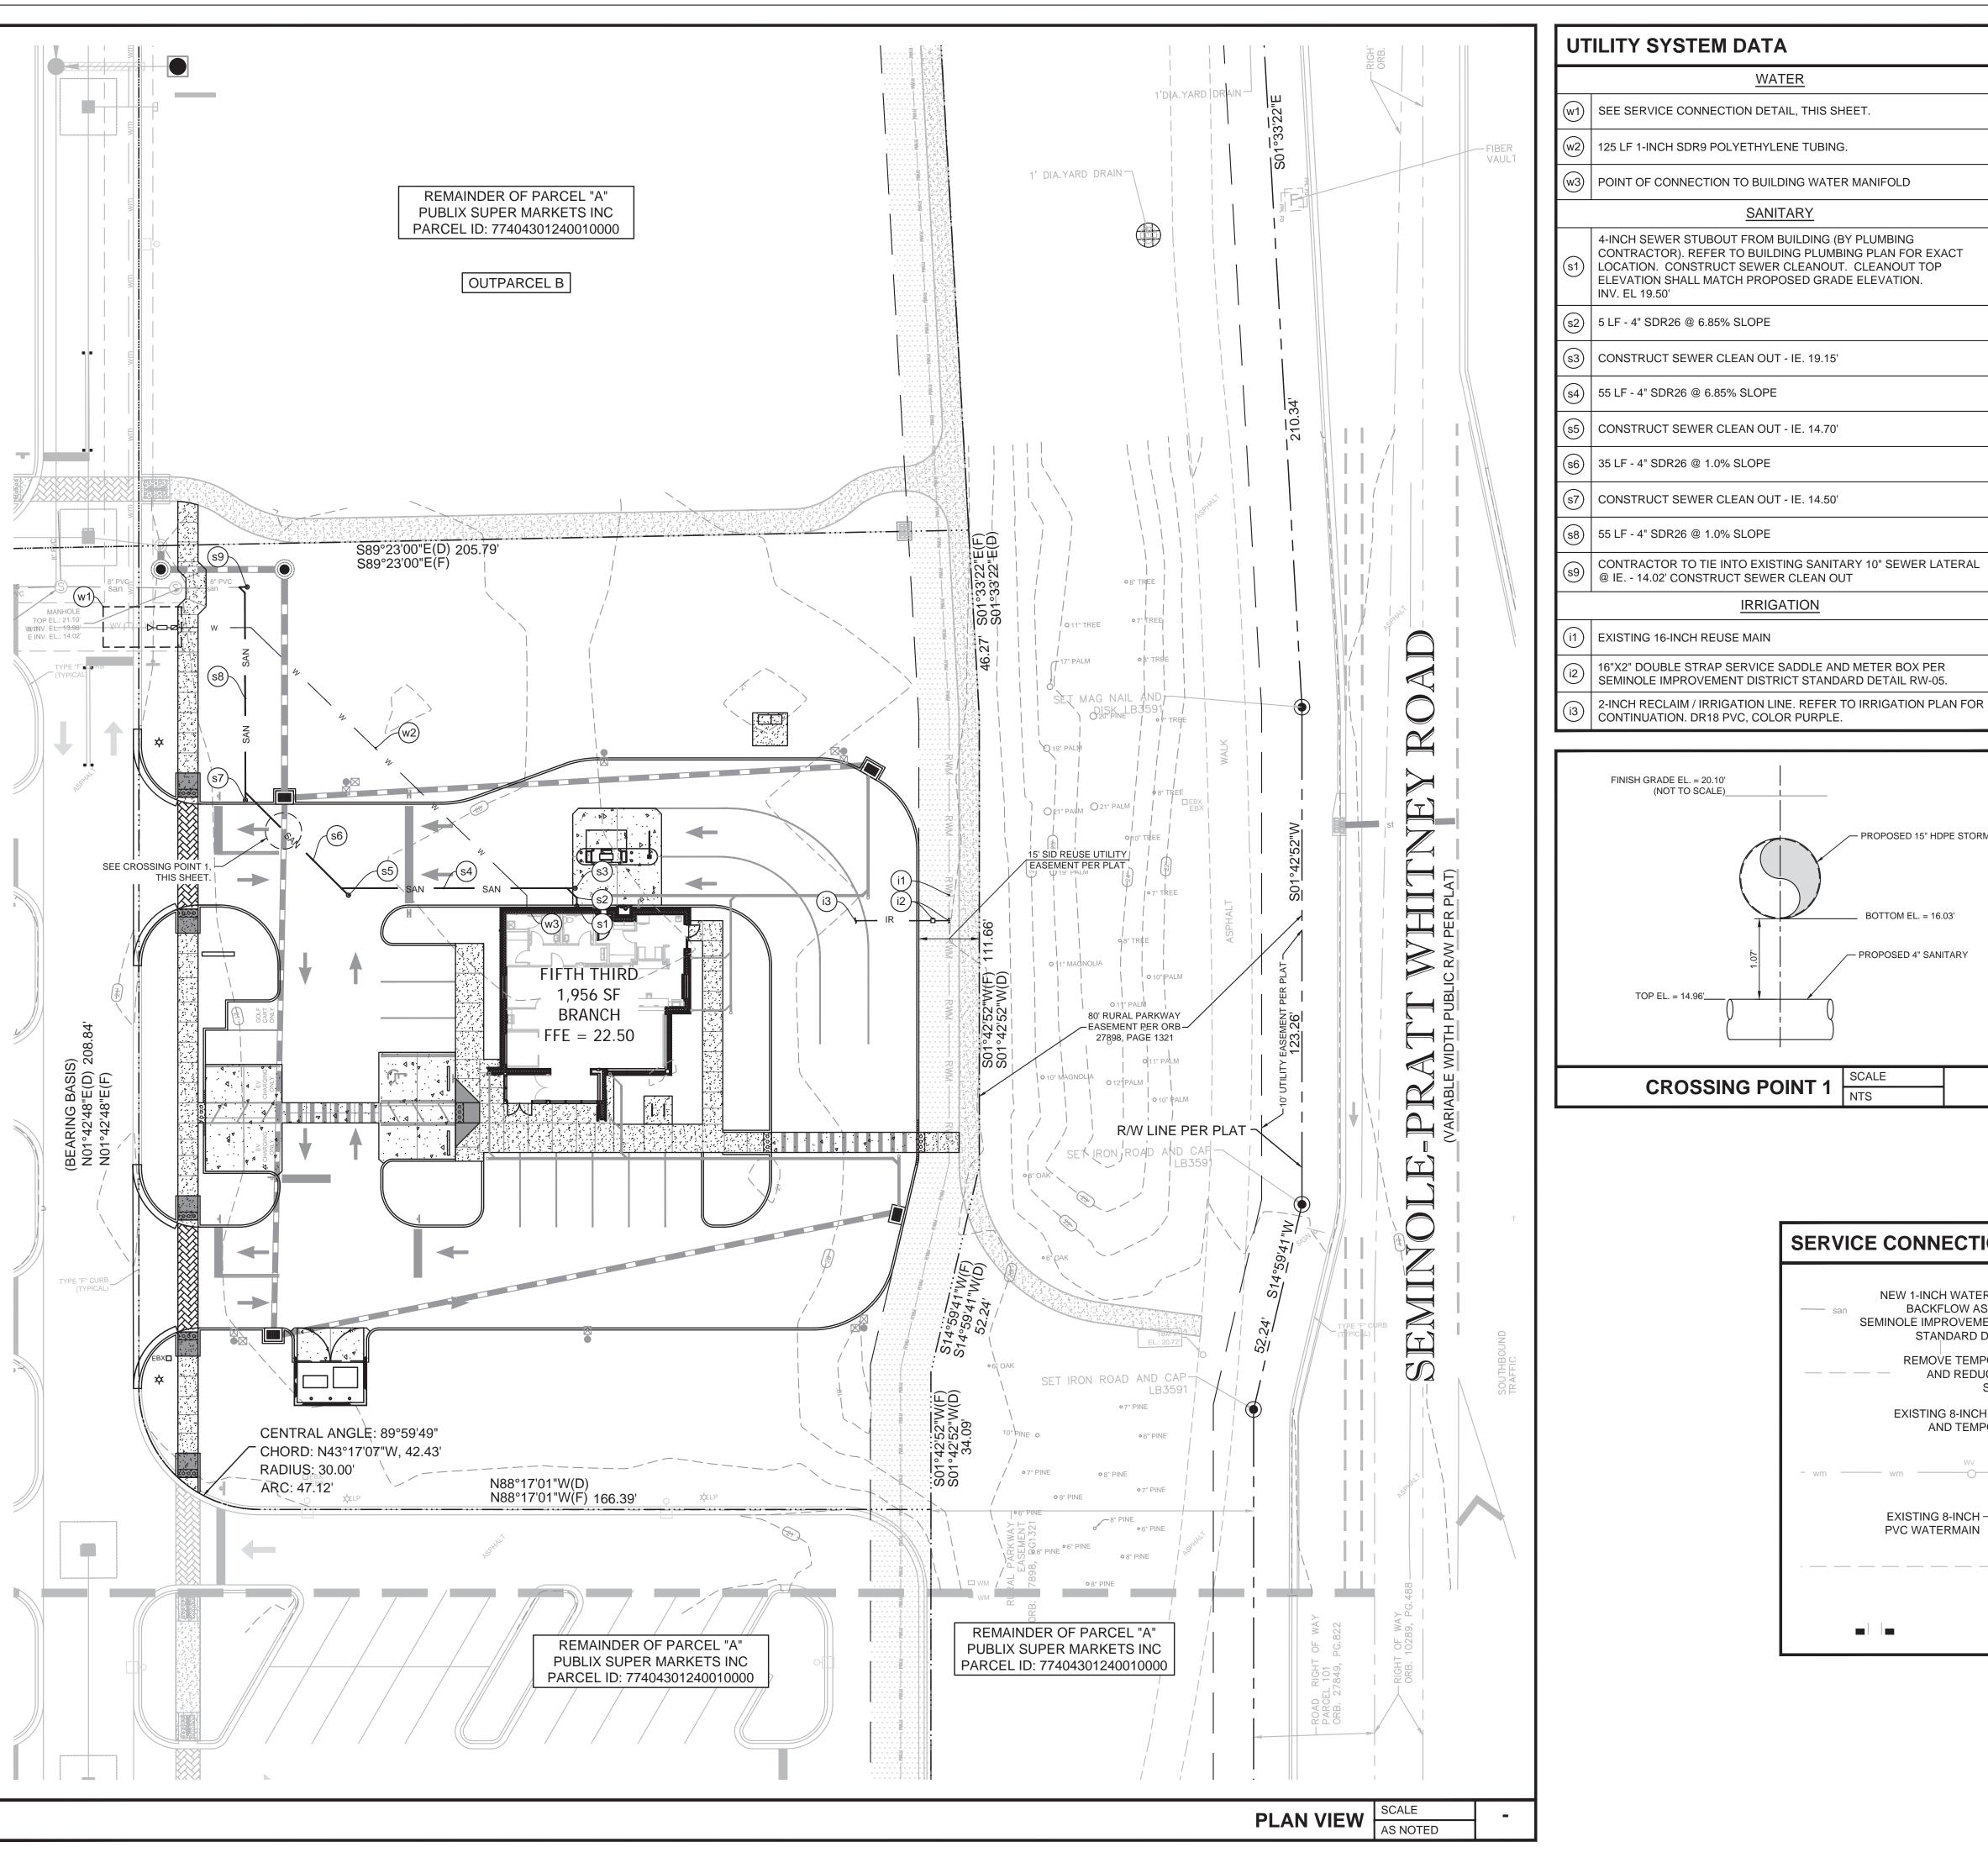
STORM PIPING PLAN


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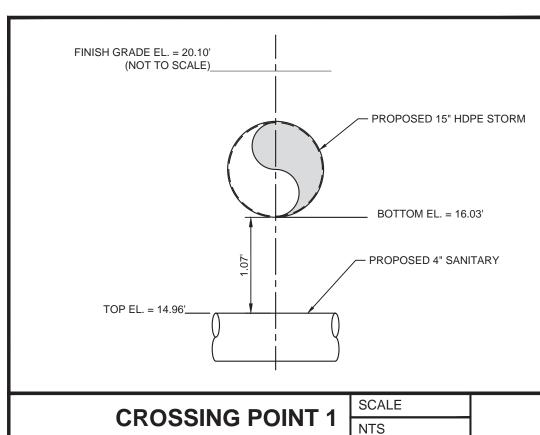
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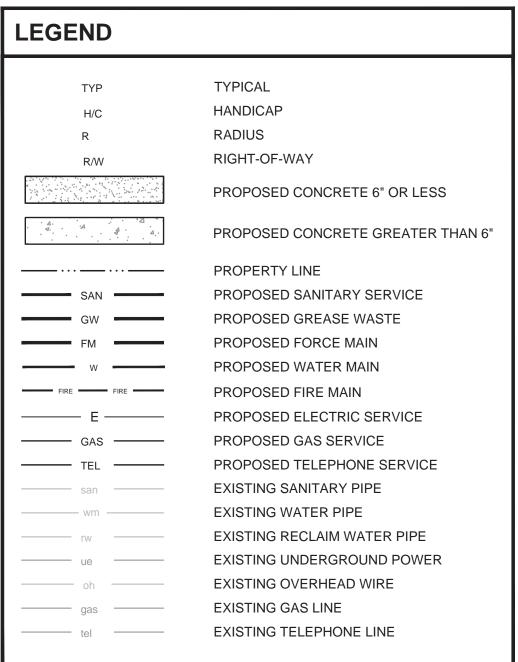
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SCALE 40' 60 20'









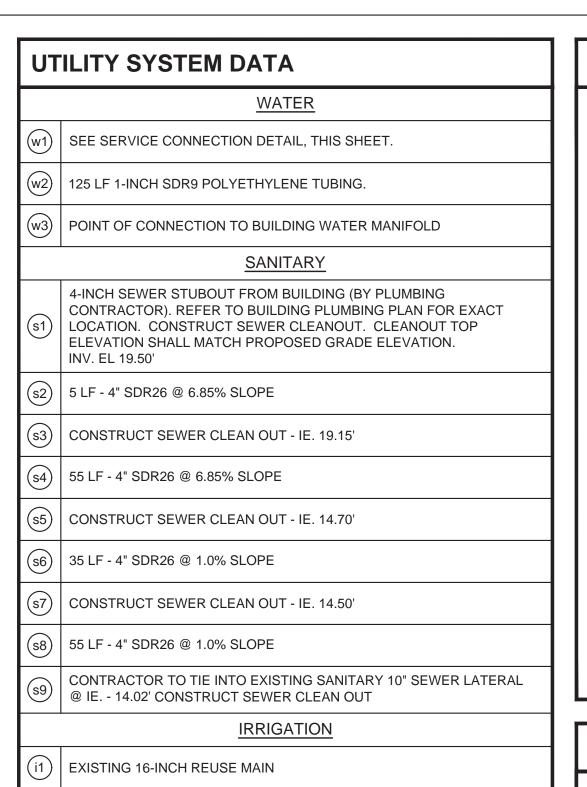

UTILITY NOTES

- CONTRACTOR TO VERIFY THE LOCATION OF ALL EXISTING UNDERGROUND UTILITIES WITHIN THE LIMITS OF CONSTRUCTION AND ADVISE THE ENGINEER OF RECORD OF ANY CONFLICTS IMMEDIATELY.
- CONTRACTOR SHALL NOTIFY AND COORDINATE WATER SERVICE WITH LOCAL MUNICIPALITIES UTILITIES DEPARTMENT.
- CONTRACTOR SHALL NOTIFY AND COORDINATE SEWER SERVICE WITH LOCAL MUNICIPALITIES UTILITIES DEPARTMENT.
- CONTRACTOR TO COORDINATE INSTALLATION OF ELECTRICAL POWER SERVICE WITH LOCAL ELECTRIC COMPANY.
- CONTRACTOR TO INSTALL PVC CONDUIT FOR TELEPHONE SERVICE (TO PROPERTY LINE) AND COORDINATE INSTALLATION OF SERVICE WITH TELEPHONE OPERATIONS.
- SEE SURVEY FOR LOCATION OF OTHER EXISTING UTILITIES.
- SEE CIVIL SPECIFICATIONS AND REFERENCE DRAWING SHEETS FOR ADDITIONAL UTILITY NOTES.
- ALL ON-SITE PVC WATER SERVICE AFTER METER SHALL BE SDR9 POLYETHYLENE TUBING.
- ALL CROSSINGS OF WATER AND SEWER LINES MUST MAINTAIN PROPER CLEARANCE (SEE CIVIL SPECIFICATIONS AND REFERENCE DRAWING SHEETS).
- 10. CONTRACTOR IS RESPONSIBLE FOR COMPLYING TO THE SPECIFICATIONS OF THE CITY/TOWNS STANDARD
- CONSTRUCTION AND UTILITY REQUIREMENTS. 11. TREES SHALL NOT BE PLANTED WITHIN 10 FEET FROM THE
- WATER MAIN. 12. ALL CLEANOUT TOP ELEVATION SHALL MATCH FINISH GRADE ELEVATIONS.

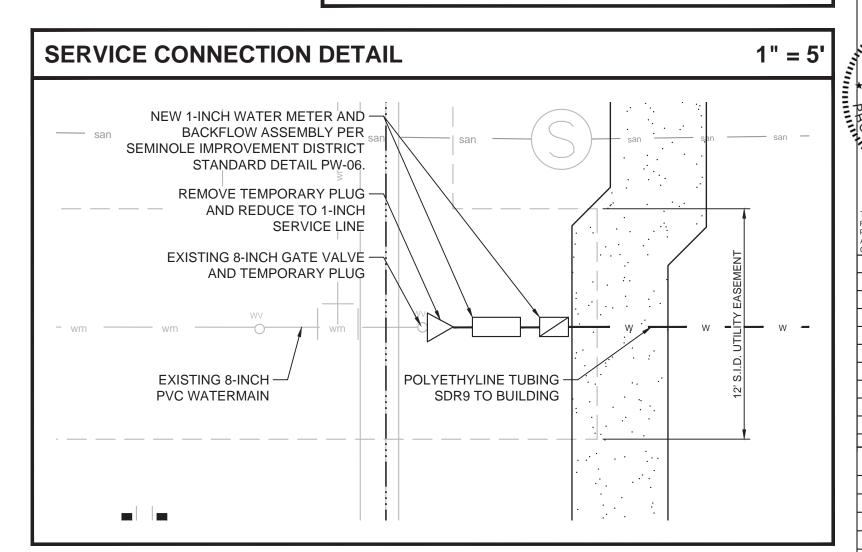

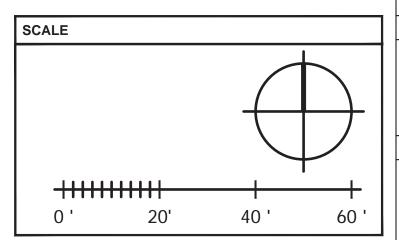



400 N Ashley Drive, P: 813 - 323 - 9233 Lic. #: AA - 0003590 Tampa, FL 33602 W: www.bdgllp.com



BANK

THIRD



INFINITY ENGINEERING GROUP, LLC 1208 East Kennedy Boulevard

Suite 230 Tampa, Florida 33602 [p]: 813.434.4770 [f]: 813.445.4211 www.iegroup.net

FL Cert. of Auth. No 27889 IEG JOB NO. 15-276.00

No 64085

SEAL NISIT SAPPARKHAO, P.E. FL REG. NO. 64085 Digitally signed by Nisit Sapparkhao DN: c=US, st=Florida, I=Tampa, o=Infinity Engineering Group LLC **≣c**n=Nisit Sapparkhao, email=nisit@iegroup.het

> Date: 2023.03.02 11:34:55 Adobe Acrobat DC

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SSUE	BY	DATE	DESCRIPTION
		03/01/23	REVIEW SET

PROJECT INFORMATION BLOCK

DATE: DRAWN BY: CHECKED BY:


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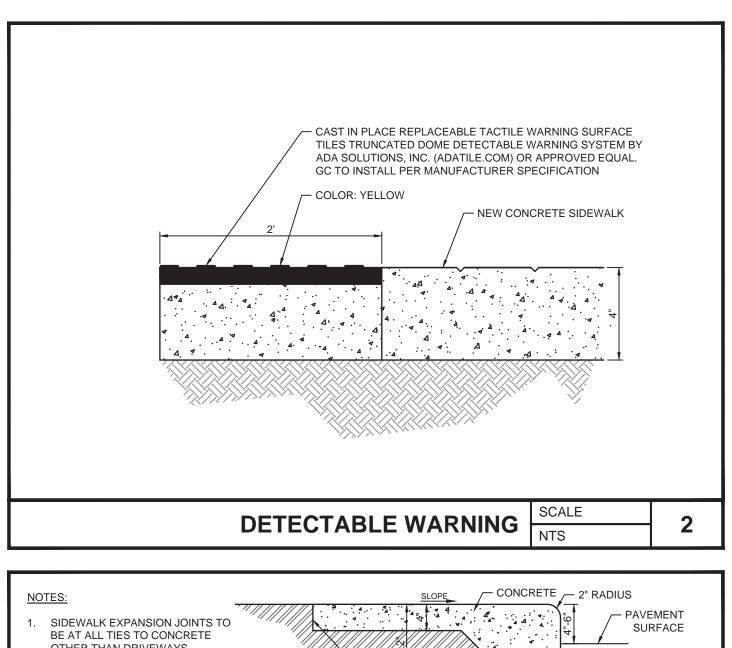
JOB#

UTILITY PLAN

SHEET NUMBER

C04.01



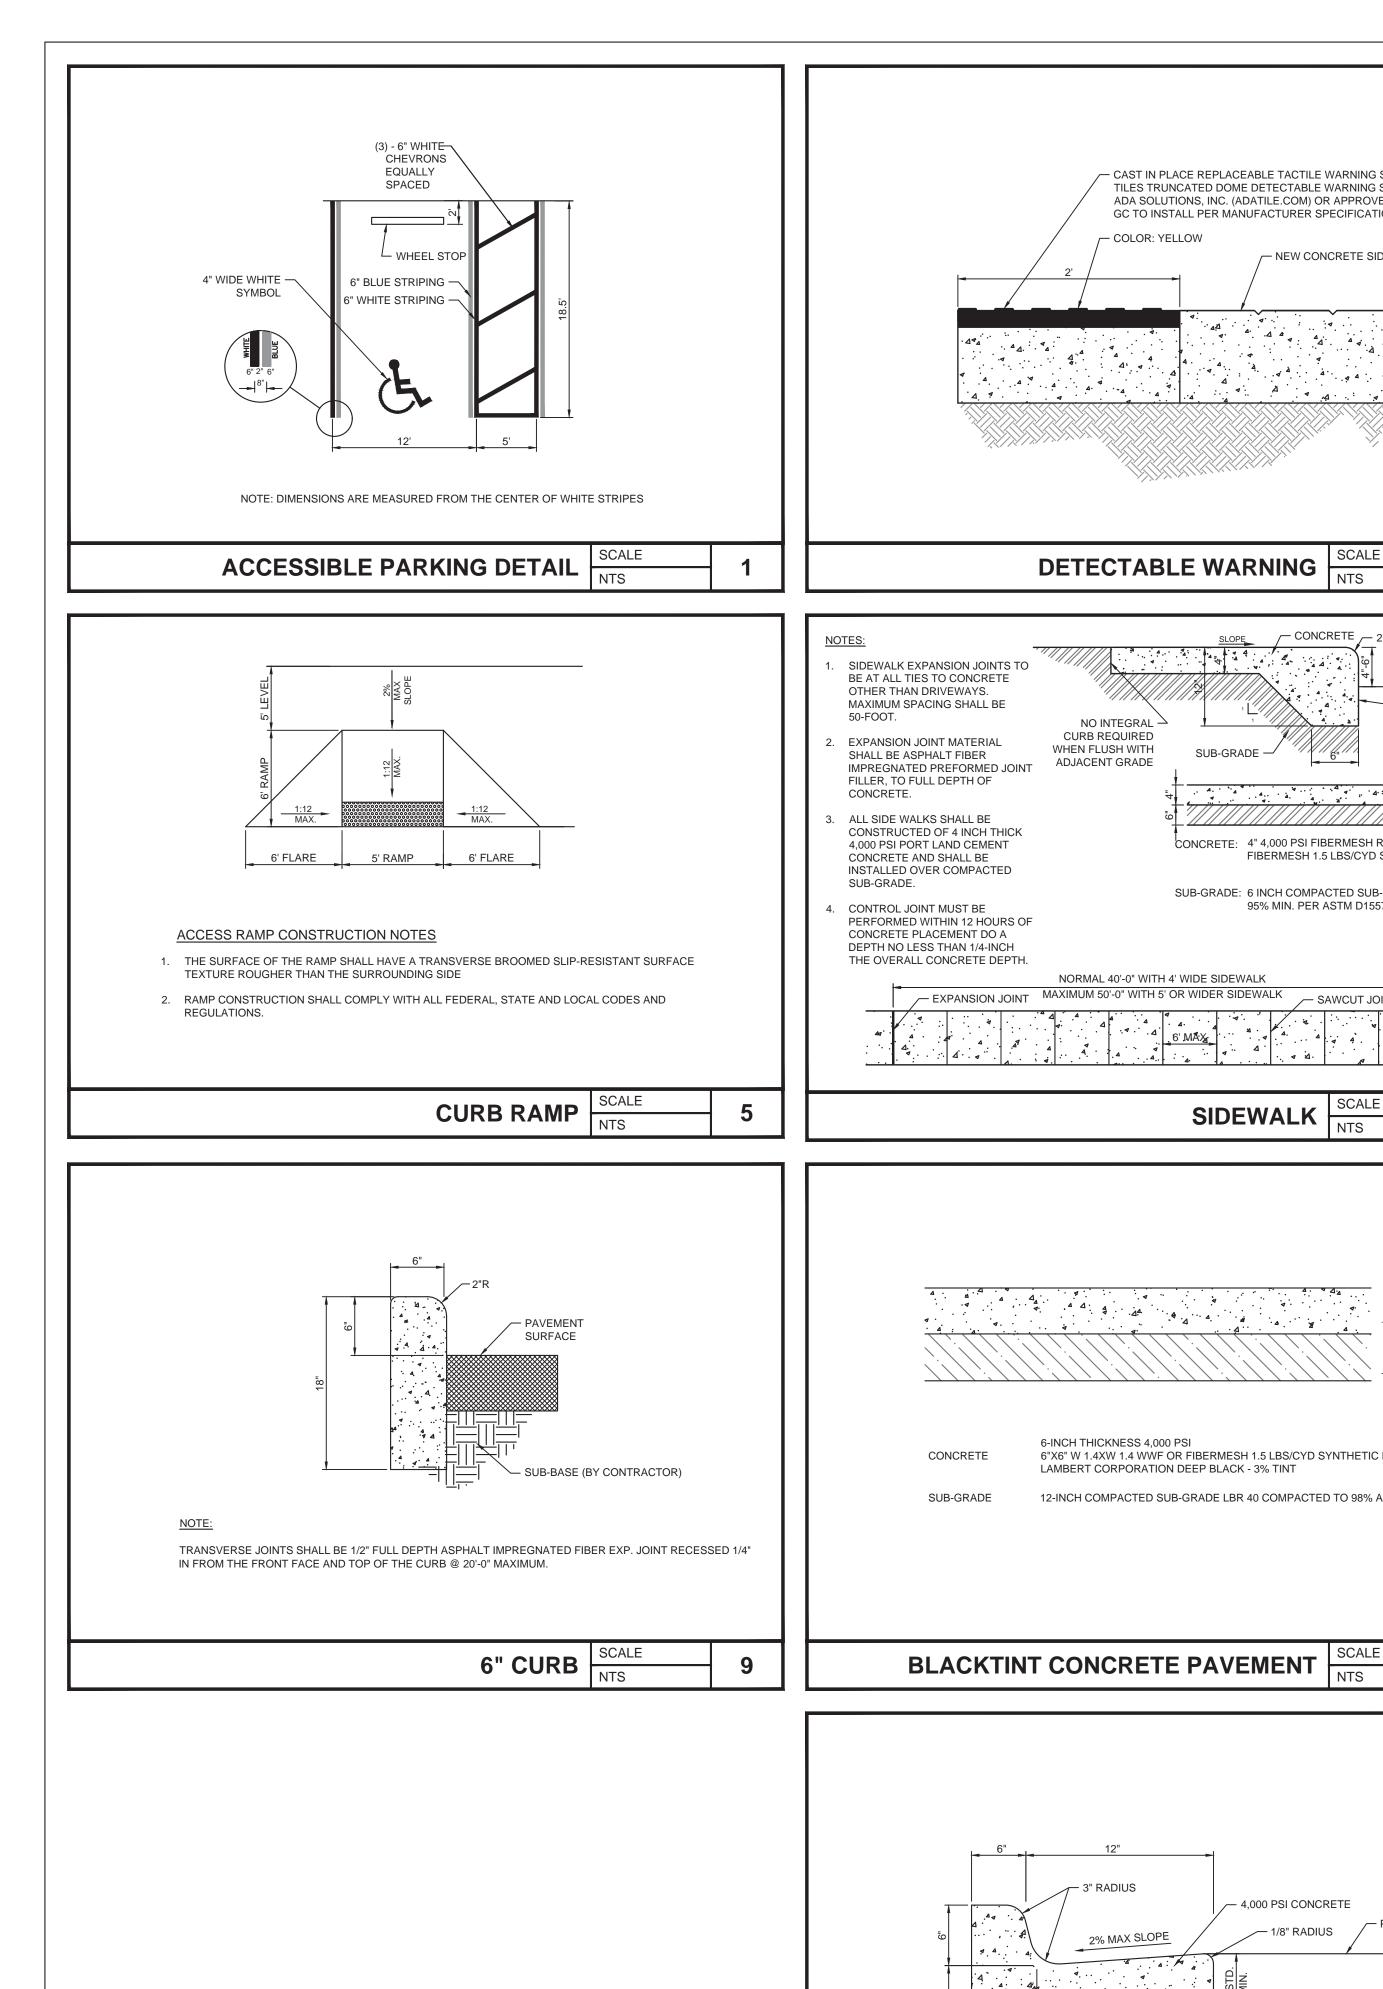

NO INTEGRAL ·

NORMAL 40'-0" WITH 4' WIDE SIDEWALK

6-INCH THICKNESS 4,000 PSI

- 3" RADIUS

2% MAX SLOPE

18" CURB AND GUTTER SCALE NTS

LAMBERT CORPORATION DEEP BLACK - 3% TINT

6"X6" W 1.4XW 1.4 WWF OR FIBERMESH 1.5 LBS/CYD SYNTHETIC FIBER

12-INCH COMPACTED SUB-GRADE LBR 40 COMPACTED TO 98% AASHTO T-180


— 4,000 PSI CONCRETE

SUB-GRADE -

CURB REQUIRED

WHEN FLUSH WITH

ADJACENT GRADE

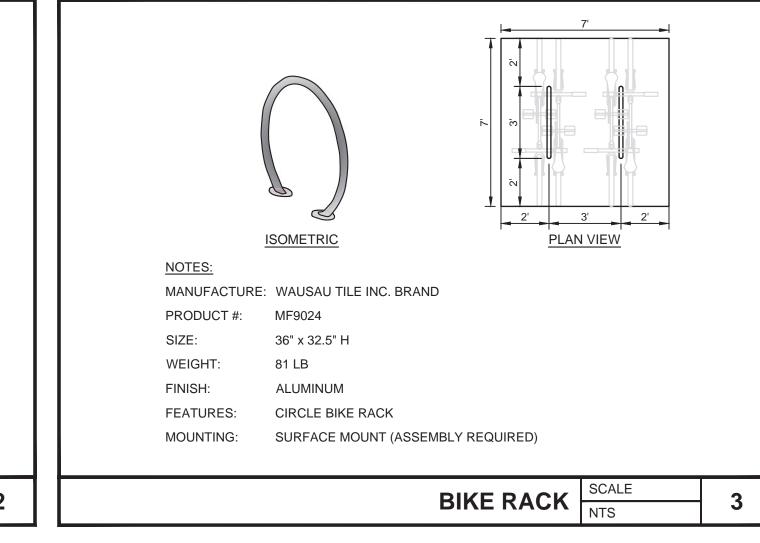

429 PRIMER

EXPANSION JOINT SCALE NTS

/ SIKA FLEX 2-C SEALANT

- BACKER ROD: ETHAFOAM "SM"

- EXPANSION JOINT FILLER

OR APPROVED EQUAL

SEAL TITE FIBRE

SIDEWALK EXPANSION JOINTS TO

BE AT ALL TIES TO CONCRETE

MAXIMUM SPACING SHALL BE

OTHER THAN DRIVEWAYS.

EXPANSION JOINT MATERIAL

SHALL BE ASPHALT FIBER

FILLER, TO FULL DEPTH OF

CONCRETE.

CONCRETE

SUB-GRADE

IMPREGNATED PREFORMED JOINT

UTILIZE INTEGRAL

CURB SIDEWALK

WHEN ADJACENT

TO PAVEMENT

CONCRETE

— PAVEMENT SURFACE


CONCRETE


FIBERMESH 1.5 LBS/CYD SYNTHETIC FIBER

CONCRETE: 4" 4,000 PSI FIBERMESH REINFORCED CONCRETE

SUB-GRADE: 6 INCH COMPACTED SUB-GRADE TO 95% MIN. PER ASTM D1557

SIDEWALK SCALE NTS

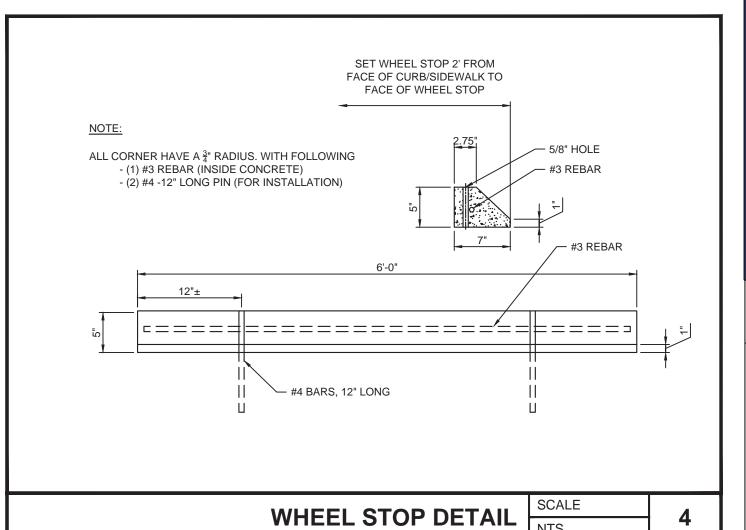


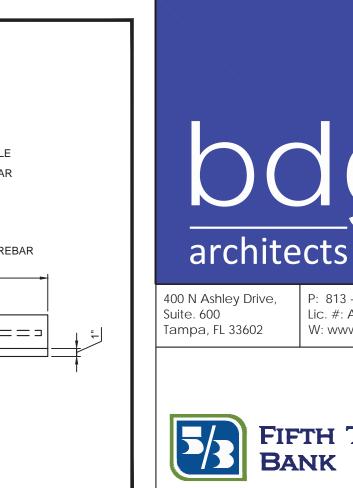






P: 813 - 323 - 9233


Lic. #: AA - 0003590 W: www.bdgllp.com

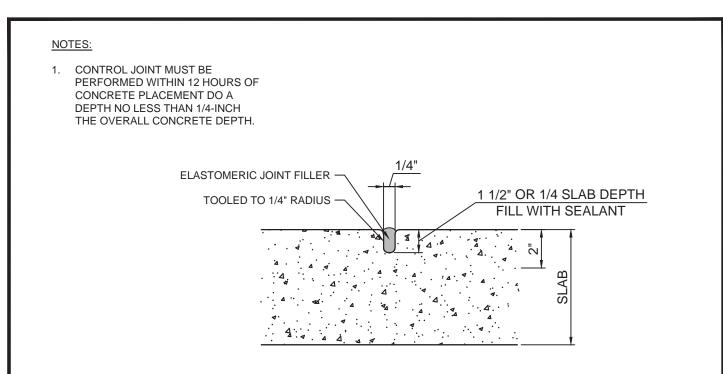


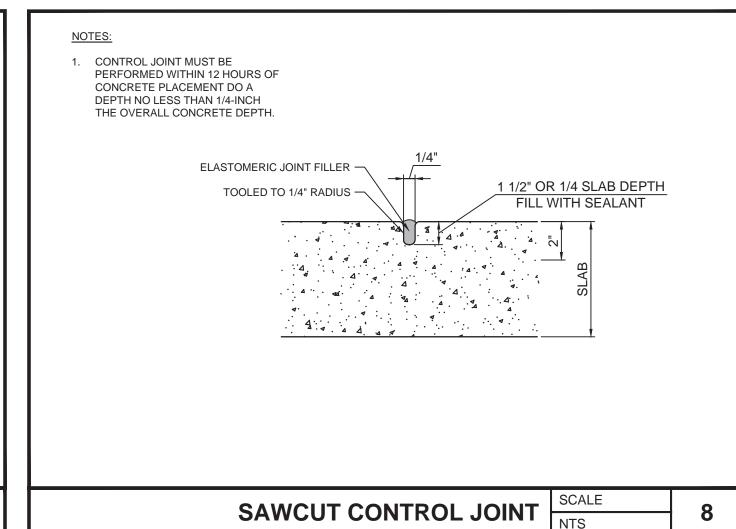

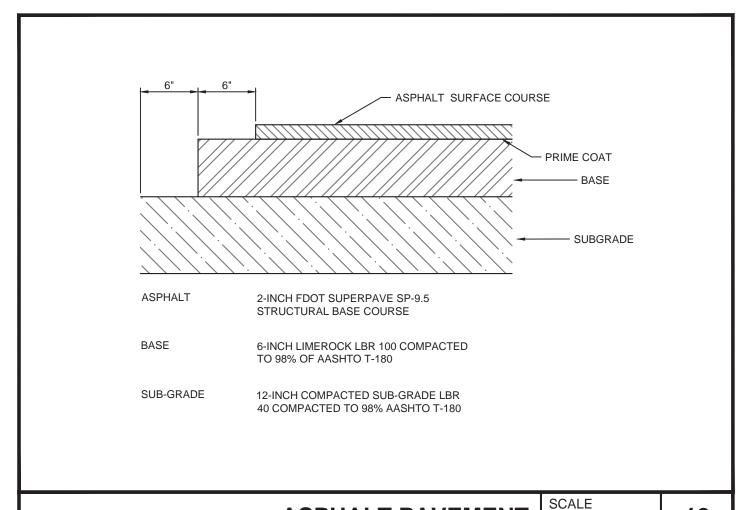

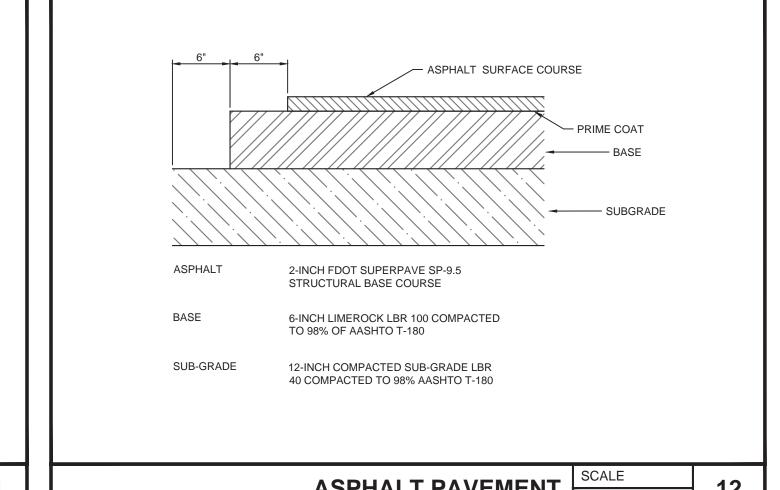

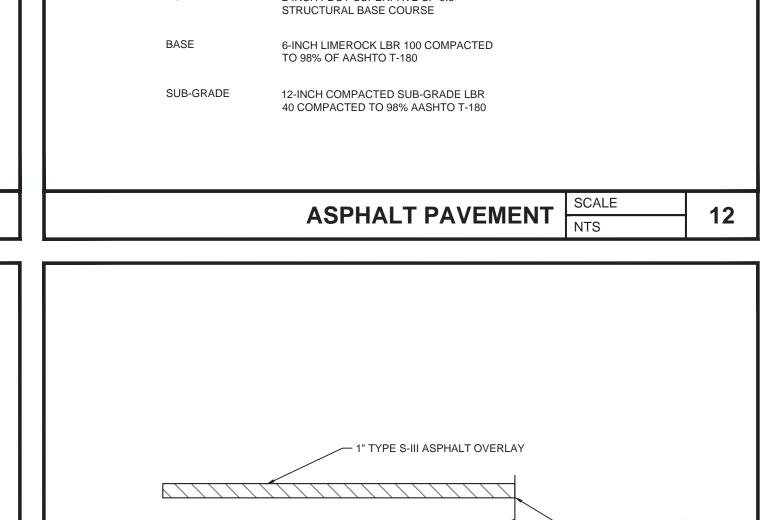


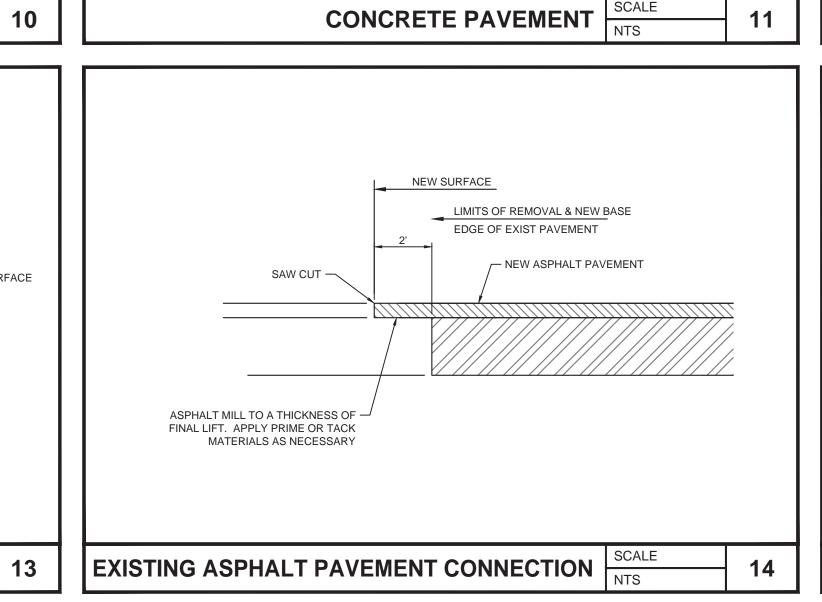


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C05.01

INFINITY


INFINITY ENGINEERING GROUP, LLC

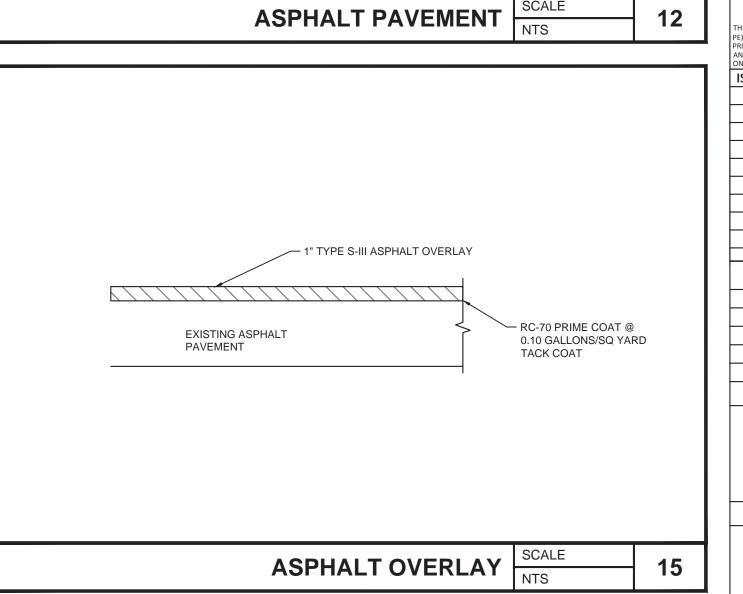
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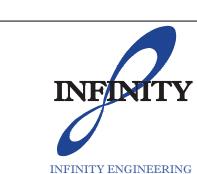


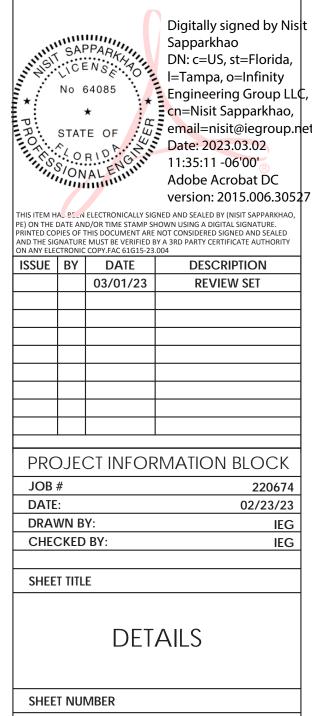



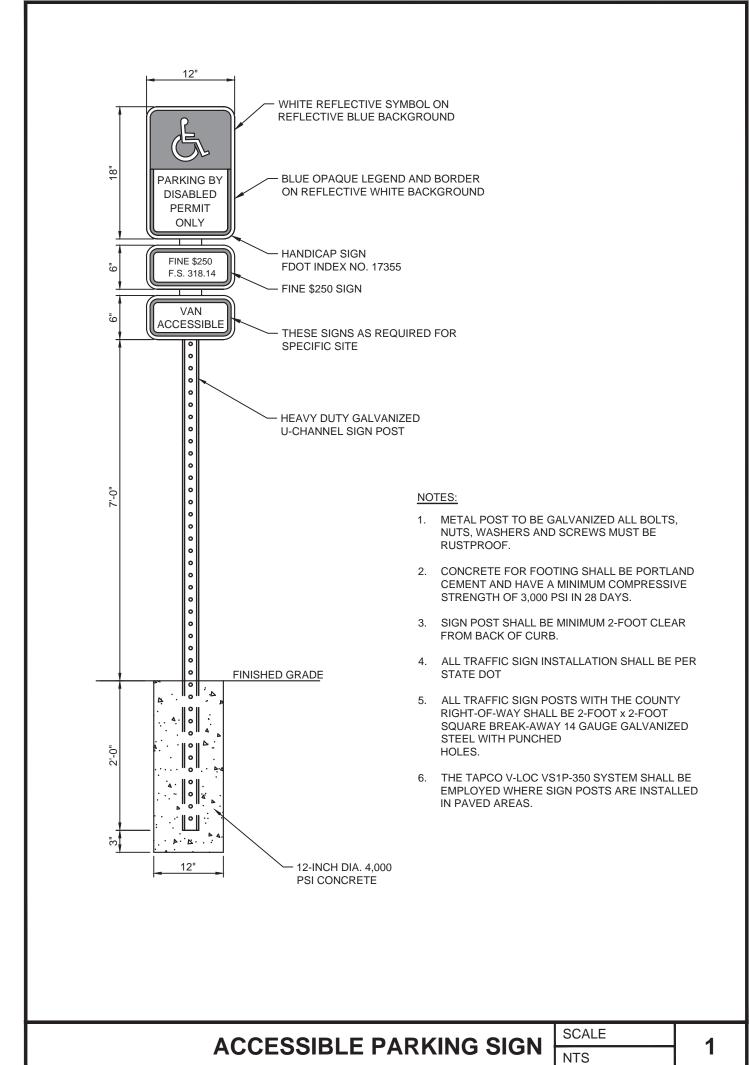

OUT PARCEL C - WESTLAKE PLAZA NWC SEMINOLE PRATT WHITNEY RD & PERSIMMON BLVD. THIRD FIFTH

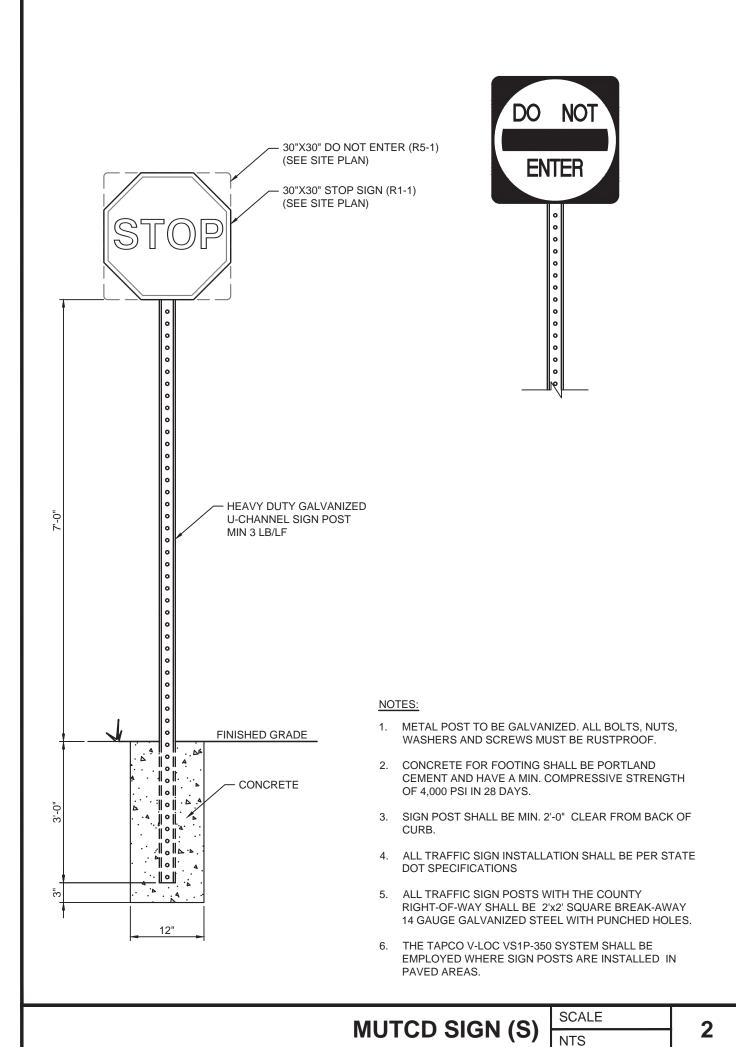

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IEG JOB NO. 15-276.00 SEAL NISIT SAPPARKHAO, P.E. FL REG. NO. 64085

Digitally signed by Nisit No 64085 STATE OF

DN: c=US, st=Florida, Engineering Group LLC, cn=Nisit Sapparkhao, email=nisit@iegroup.net
Date: 2023.03.02 11:35:37 -06'00' Adobe Acrobat DC version: 2015.006.30527

Sapparkhao

ISSUE	BY	BY DATE DESCRIP		
		03/01/23	REVIEW SET	

JOB# 220674 DATE: 02/23/23 DRAWN BY: CHECKED BY:

SHEET TITLE

DETAILS

SHEET NUMBER

C05.02