PROPOSED MULTI-FAMILY DEVELOPMENT **LUMIN TERRACE**

EXCEL 100 Camelot Drive Fond du Lac, WI 54935 920-926-9800 excelengineer.com

PROPOSED MULTI-FAMILY



240136200


WATERTOWN, WISCONSIN

PROJECT INFORMA

SITE INFORMATION:
PROPERTY AREA: 406,529 S.F. (9.33 ACRES).
EXISTING ZONING: MR-10
PROPOSED ZONING: MR-10
PROPOSED USE: MULTI-FAMILY APARTMENTS
AREA OF SITE DISTURBANCE: 387,800 S.F. (8.90 ACRES)
SSTBACCE BIRDDING: FRONT (WEST) = 25' SIDE RIOSHIN-SOUTH = 10% LOT WIDTH, OR MIN OF 8', MAX OF 14' STREE (FLAST) = 10% LOT WIDTH, OR MIN OF 8', MAX OF 14' PAVEMENT: FRONT (WEST) = 10' SIDE RIOSHINGOUTH = 3' STREE (FLAST) = 3'
PROPOSED BUILDING HEIGHT; 34" (MAX, HEIGHT ALLOWED; 35")
PARKING REQUIRED; 2.5 SPACES PER 3-BED, 2 SPACES PER 2-BED, 1-BED, OR EFFICIENCY (196)
PARKING PROVIDED: 196 SPACES (8 H.C. ACCESSIBLE)
HANDICAR STALLS REQUIRED: 5 HANDICAR STALLS REQUIRED: 9

	١		
EXISTING SITE DATA	<u>1</u>		
	AREA (AC)	AREA (SF)	RATIO
BUILDING FLOOR AREA	0.00	0	0.09
PAVEMENT (ASP. & CONC.)	0.86	37,255	9.2%
TOTAL IMPERVIOUS	0.86	37,255	9.2%
LANDSCAPE/ OPEN SPACE	8.48	369,272	90.89
PROJECT SITE	9.33	406,527	100.0%
Proposed Site Da	AREA (AC)	AREA (SF)	RATIC
			12.29
BUILDING FLOOR AREA	1.14	49,548	
BUILDING FLOOR AREA PAVEMENT (ASP. & CONC.)		49,548 132,373	
	1.14		32.6%
PAVEMENT (ASP. & CONC.)	1.14 3.04	132,373	32.6%




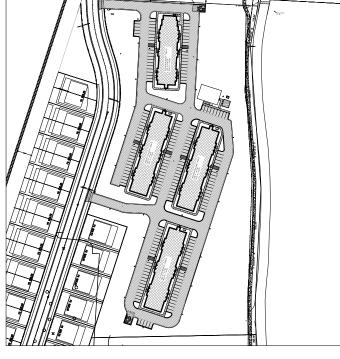

PROJECT CONTACTS

OWNER	RINFORMATION:
HORIZO	ON DEVELOPMENT GROUP, INC.
SCOTT	KWIECINSKI
5201 E/	AST TERRACE DRIVE, SUITE 300
MADIS	DN, WI 53718
Phone:	(608) 354-0820
Email: S	Kwiecinski@horizondbm.com

LOCATION MAP

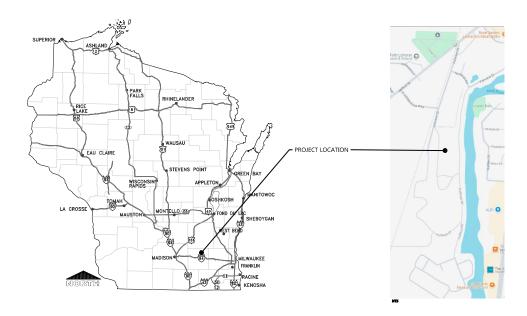

PROJECT NOTES

GENERAL PROJECT NOTES

CONSTRUCTION STAKING SERVICES

SHEET INDEX

NUMBER	SHEET NAME / DESCRIPTION	
C0.1	CIVIL COVER SHEET	
C0.2	CIVIL SPECIFICATIONS	
C1.0	EXISTING SITE AND DEMOLITION PLAN	
C1.1	SITE PLAN	
C1.2A	GRADING AND EROSION CONTROL PLAN - OVERALL	
C1.2B	GRADING AND EROSION CONTROL PLAN - NORTH	
C1.2C	GRADING AND EROSION CONTROL PLAN - SOUTH	
C1.3A	UTILITY PLAN - OVERALL	
C1.3B	UTILITY PLAN - NORTH	
C1.3C	UTILITY PLAN - SOUTH	
C1.4	LANDSCAPE AND RESTORATION PLAN	
C2.0	DETAILS	
C2.1	DETAILS	
C3.1	SITE PHOTOMETRIC PLAN & DETAILS	

LEGEND

3TWL	IDENTIFICATION	SYM.	<u>IDENTIFICATION</u>
SPOT ELEVATI	PROPOSED SPOT ELEVATIONS (FLOW LINE OF CURB		
000.00 000.00 EG	UNLESS OTHERWISE SPECIFIED) EXISTING GRADE SPOT ELEVATIONS	000,00 TC 000,00 FL	PROPOSED SPOT ELEVATIONS (TOP OF CURB, FL OF CURB)
000.00 BG	PROPOSED SPOT ELEVATIONS PROPOSED SPOT ELEVATIONS (REFERENCE R-WALL DETAIL) BG-FINISHED SURFACE GRADE AT BACK OF WALL FG-FINISHED SURFACE GRADE AT FRONT OF WALL	000.00 TW 000.00 BW	PROPOSED SPOT ELEVATIONS (TOP OF WALK, BY OF WALK @ FLOWLINE)
EXISTING SITE			
-	EXISTING SIGN	ø	EXISTING UTILITY POLE
ě.	EXISTING HANDICAP PARKING STALL	ø→	EXISTING UTILITY POLE WITH GUY WIRE
•	EXISTING WATER VALVE IN BOX	0-0	EXISTING STREET LIGHT
0	EXISTING WATER VALVE IN MANHOLE		EXISTING TELEPHONE PEDESTAL
×	EXISTING WATER SERVICE VALVE	0	EXISTING ELECTRIC PEDESTAL
•	EXISTING WELL	\boxtimes	EXISTING ELECTRIC BOX
-	EXISTING STORM CATCH BASIN	4	EXISTING FLOOD LIGHT
-	EXISTING STORM CURB INLET	0	EXISTING TELEPHONE MANHOLE
	EXISTING SQUARE CATCH BASIN	0	EXISTING CABLE TV PEDESTAL
- ×	EXISTING LIGHT POLE	М	EXISTING GAS VALVE
	1-1/4° REBAR SET WEIGHING 4.30 LB/FT.	(IIIII)	EXISTING HEDGE
•	3/4" REBAR SET WEIGHING 1.50 LB/FT.	~~~~	EXISTING WOODED AREA
	1-1/4" REBAR FOUND		EXISTING MARSH AREA
	3/4" REBAR FOUND	0	EXISTING DECIDUOUS TREE WITH TRUNK DIAMET
	2" IRON PIPE FOUND	*	EXISTING CONIFEROUS TREE
	1" IRON PIPE FOUND	78	EXISTING SHRUB
-	SECTION CORNER	- -	EXISTING STUMP
PROPOSED SIT		- / (EXISTING STOWN
	PROPOSED SIGN		PROPOSED STORM FIELD INLET - ST EL
- E	PROPOSED SIGN PROPOSED HANDICAP PARKING STALL	00	PROPOSED STORM FIELD INCET - ST FI
	PROPOSED HANDICAP PARKING STALL PROPOSED WATER VALVE IN BOX	\rightarrow	PROPOSED EIGHT POLE PROPOSED DRAINAGE FLOW
	PROPOSED WATER VALVE IN MANHOLE		PROPOSED APRON END SECTION
	PROPOSED WATER SERVICE VALVE		
-			SOIL BORING
	PROPOSED WELL	Ę.	PROPOSED CLEANOUT
	PROPOSED STORM CATCH BASIN - ST CB PROPOSED STORM CURB INLET - ST CI	DSG	PROPOSED CLEANOUT PROPOSED DOWNSPOUT TO GRADE
	PROPOSED STORM CORD INCET - ST CI	DSR	PROPOSED DOWNSPOUT TO RISER
EXISTING LINE	TYDES		
0	— EXISTING CHAINUNK FENCE	ra6	EXISTING POLISH SEWER AND MANHOLE
	EXISTING WOOD FENCE		— EXISTING PROCESS SEWER AND MANHOLE
*	EXISTING BARBED WIRE FENCE	CLW-	EXISTING CLEAR WATER LINE
	EXISTING CURB AND GUTTER	го —	EXISTING UNDERGROUND FIBER OPTIC LINE
	EXISTING GUARD RAIL		EXISTING UNDERGROUND ELECTRIC CABLE
80)	EXISTING GROUND CONTOUR		— EXISTING UNDERGROUND TELEPHONE CABLE
	EXISTING STORM SEWER AND MANHOLE		EXISTING UNDERGROUND GAS LINE
sa	S EXISTING SANITARY SEWER AND MANHOLE	- ou -	— EXISTING OVERHEAD UTILITY LINE
	EXISTING WATER LINE AND HYDRANT		
#_	INTERIOR PROPERTY LINE		—RIGHT-OF-WAY LINE
onenecto i mu			- NIGHT-OF-WAT LINE
PROPOSED LINE		POL 6	PROPOSED POLISH SEWER AND MANHOLE
	PROPOSED CHAINLINK FENCE		
-0-0-	PROPOSED WOOD FENCE	P CIW —	PROPOSED PROCESS SEWER AND MANHOLE PROPOSED CLEAR WATER LINE
* *			
	PROPOSED CURB AND GUTTER	FO	PROPOSED UNDERGROUND FIBER OPTIC LINE
• • •	PROPOSED GUARD RAIL	— Е —	PROPOSED UNDERGROUND ELECTRIC CABLE
800	PROPOSED GROUND CONTOUR	T	PROPOSED UNDERGROUND TELEPHONE CABLE
	PROPOSED STORM SEWER AND MANHOLE - ST MH	— с —	PROPOSED UNDERGROUND GAS LINE
SA(9-PROPOSED SANITARY SEWER AND MANHOLE - SAN MH	ou	PROPOSED OVERHEAD UTILITY LINE
*	PROPOSED WATER LINE AND HYDRANT		
_	PROPOSED PROPERTY LINE		— GRADING/SEEDING LIMITS

SOPOSED MULTI-FAMILY DEVELOPMENT LUMIN TERRACE
JOHNSON STREET • WATERTOWN, WI PROPOSED

OCT, 23, 2024 OCT. 30, 2024

240136200

C0.2

CIVIL SPECIFICATIONS

DIVISION 31 FARTH WORK

31 10 00 SITE CLEARING (DEMOLITION)

- A CONTRACTOR SMALL CALL DISCISSES FOR TIME MAD COLORED, A PRINCE IT THE LOCATION AS DISCISSES TO SMALL BE REPORTED FOR AN OCCURRENCES SERVICED FOR AN OCCUPRENCES SERVICED FOR AN OCCUPRENCES SERVICED FOR AN OCCUPRENCES SERVICED FOR AN OCCUPRENCES SERVICED FOR AN OCCUPRENCE SERVICED FOR AN OC

31 20 00 EARTH MOVING

DIVISION 32 EXTERIOR IMPROVEMENTS

32 10 00 AGGREGATE BASE & ASPHALT PAVEMENT

32 20 00 CONCRETE AND AGGREGATE BASE

- 32 20 DO CONCRETE AND AGGREGATE BASE

 A COMMAND TO OWNER OF COME DO AGGREGATE BASE OF CONCRETA WHEN INDICATED ON THE PLANS

 B LANGINGARY WHO AND AGGREGATION A

- 1) TIE BARS AT ALL CONTRACTION JOINTS OF THE CONCRETE. TIE BARS SHALL BE #4 REBAR 30" LONG PLACED AT 30" O.C.

- PRINCED AT 80 CONTINUEND AND ATT THE CORREST. TO MASS SHALL BY A SERVE BY CORREST AND ADMINISTRATION OF THE CORREST TO MASS SHALL BY A SERVE BY CORREST CORRES

- A TOPICE. CONTRACTOR TO PROJECT A VINNAMA OF P OF POPICE FOR ALL STURIES ONLY AFFAC. OTHER HIM ANGIOGNE ROLLING SAME, IS PROGRESS WITH A STURIES OF P OF POPICE. IS SEEN TO P OF THE POPICE OF P OF POPICE. IS SEEN TO P OF THE POPICE OF P OPICE OF P OPICE OF P OPICE OF P OPIC OF

- TREES AS REQUERED.

 FIRE AND PRIME MAINTENANCE VIVE READY. CONTRACTOR TO PROVIDE MAINTENANCE OF ALL IMPREVAMENT OF A PRIMEO OF 90 DWS FROM THE DATE OF RESTALLATION. MAINTENANCE TO RICKLUDE REQUERE WAS TREED, OR SEQUERED THE CONTRACTOR TO PROVIDE 1 THAN WARRANTY OF ALL TREES, SHAUSE, AND PERSONNEL SHAUSHMANNEL, COMPANION TO PROVIDE 1 THAN WARRANTY OF ALL TREES, SHAUSE, AND PERSONNEL.

 FORMALE MULES, PROVIDE 1 THAN HOW THOSE ALMART OF SHREDER HANDWOOD MAILCH AT ALL.

PRANTER AREAS DOZIOTATIO ON THE LANGSCARE FIAM. DISTRAL OVER MOTHANOVAN WILD BARRIER HABES, COLOR BY CONTEX.

LAMBAR MILLOS PROVINCES.

LAMBAR MILLOS PROVINCES.

LAMBAR MILLOS PROVINCES Y MORMAN THEICE BLANKET ON 15' MERRIAM TO 25' MANOVAN CHUSHOD ESCONTRES. SOME 1' ALL PLANKET, MANOS SERVICES ON THE LANGSCARE PRAN. PONZIAL OVER THE LANGSCARE PRAN. PONZIAL DESCRIPTION AND MANOS PRAN. PONZIAL SOME PRANCES PROVINCES PRANCES PRANCES PRANCES PROVINCES PRANCES PRANCES PROVINCES PRANCES PRANCES

DIVISION 33 UTILITIES

- 33 10 00 SITE UTILITIES

SHOP DRAWING SUBMITTALS

- SOURCE MATERIAI
- 32.10.00 (A) AGGREGATE BASE & ASPHALT PAVEMENT

 HOT MIX ASPHALT SPECIFICATIONS
- AGGREGATE BASE
 PAVEMENT MARKINGS 32.20.00-CONCRETE AND AGGREGATE BASE
- DESIGN MIX
 AGGREGATE BASE
 COMPRESSION TEST RESULTS
 PAVEMENT MARKINGS
- DETECTABLE WARNING PLATES
- 32.30.00 LANDSCAPING
 AMENDED SOIL MIX
- SEEDING PRODUCT DATA
- MULCH PRODUCT DATA FROSION MATTING

TABLE A: ALLOWABLE PIPE MATERIAL SCHEDULE Joint: ASTM D3139 Integral Be oigot tomeric Seal: ASTM F477 gittiess astomeric Gasket: ASTM F477 ASTM F2648, ASTM F2306, AASHTO M252, TYPE S (4 IN - 10 IN), AASHTO M294, TYPE S (12 IN - 60 M294

ASTM C14, ASTM C76, AASHTO M170




EXCEL Always a Better Plan 100 Camelot Drive Fond du Lac, WI 54935 920-926-9800 excelengineer.com

PROPOSED MULTI-FAMILY DEVELOPMENT LUMIN TERRACE
JOHNSON STREET • WATERTOWN, WI

PRELIMINARY DATES
OCT. 23, 2024
OCT. 25, 2024
OCT. 30, 2024
NOV. 8, 2024

240136200

C1.0

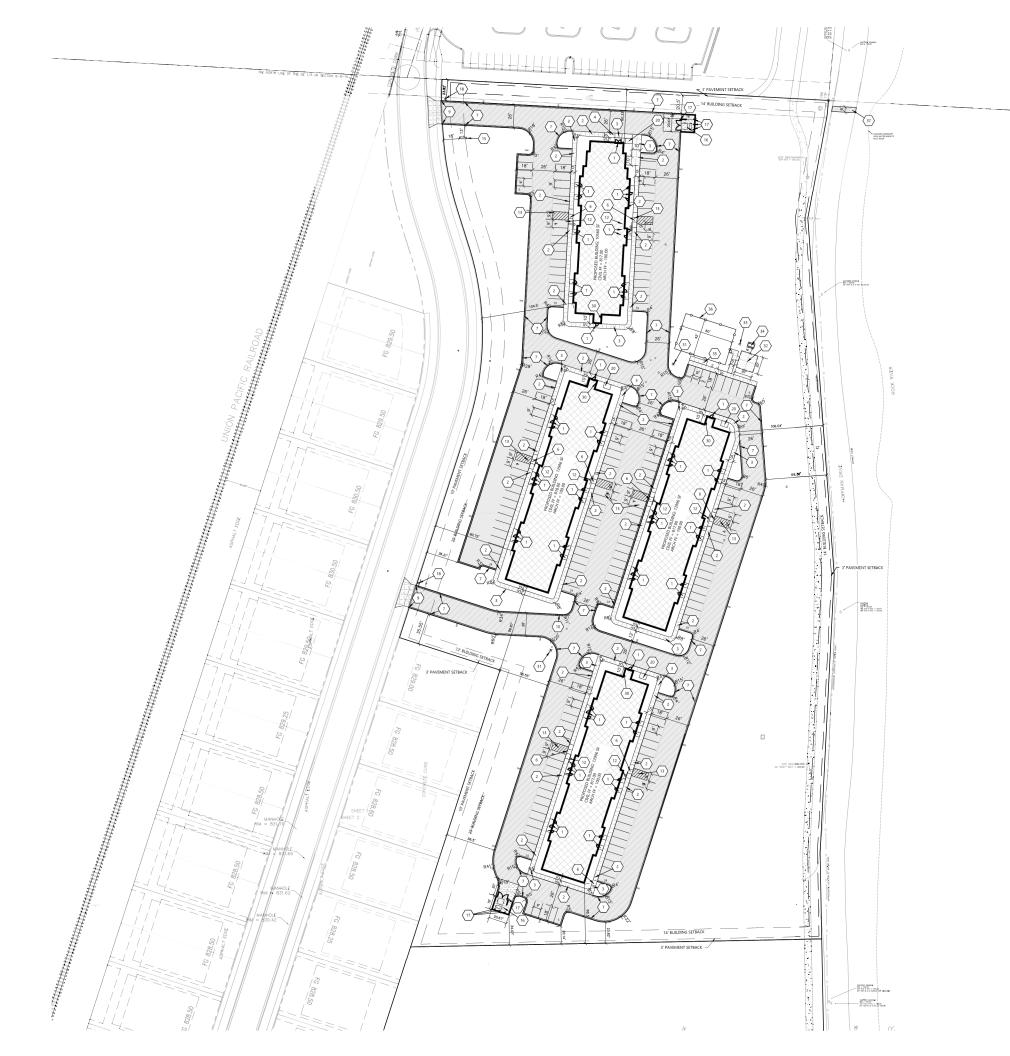



PROPOSED MULTI-FAMILY DEVELOPMENT LUMIN TERRACE
JOHNSON STREET • WATERTOWN, WI

OCT. 3, 2024
OCT. 11, 2024
OCT. 14, 2024
OCT. 18, 2024
OCT. 23, 2024
OCT. 25, 2024
OCT. 30, 2024
NOV. 8, 2024

240136200 **C**1.1

CIVIL SITE PLAN


KEYNOTES

(10)

LEGEND:

 CONCRETE STOOP (SEE STRUCTURAL PLANS FOR DETAILS) RAISED WALK (SEE DETAIL) FLUSH WALK (SEE DETAIL)

ASPHALT/BASE SECTION TO MATCH EXISTING ROAD SECTION PER WATERTOWN SPECIFICATIONS.

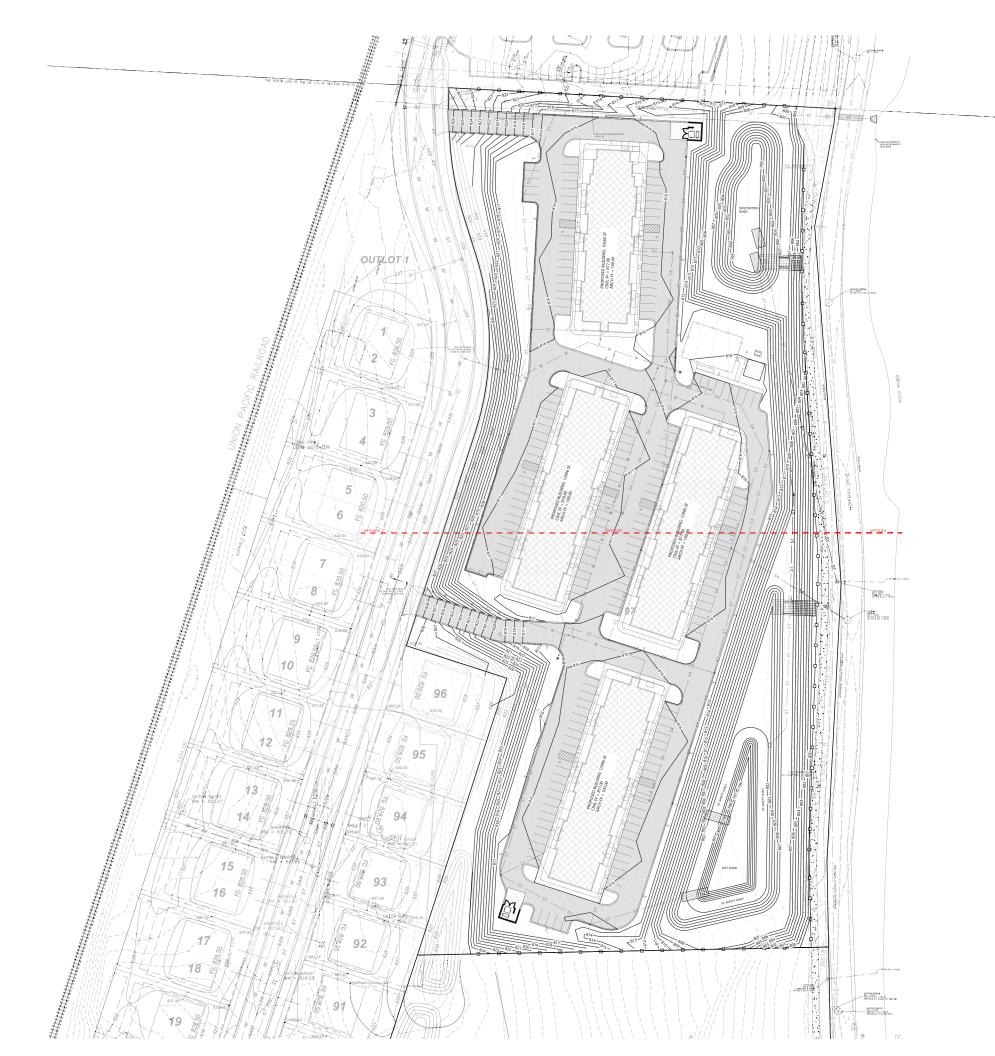

GENERAL NOTES:

- HANDICAP STALL AND ACCESS AISLES SHALL NOT EXCEED A SU 1.50% IN ANY DIRECTION. HANDICAP STALL & ACCESS AISLES S CONFORM TO ADA REQUIREMENTS (CURRENT EDITION)
- ALL SIDEWALKS SHALL NOT EXCEED A MAXIMUM CROSS SU 1.50% AND RUNNING SLOPE OF 4.50% UNLESS OTHERWISE:
- ENTRANCE AT CONSTRUCTION ENTRANCE FOR PROPOSED IMPROVEMENTS AS REQUIRED PER CODE.
- CONTRACTOR SHALL PROVIDE CONCRETE WASHOUT AS REQ
- CONTRACTOR SHALL PROVIDE TEMPORARY INLET PROTI ALL CURB INLETS & CATCH BASINS ONSITE & OFFSITE IN DOWNSTREAM OF THE PROJECT SITE PER LOCAL CODE.

KEYNOTE	<u>S</u>
EC 1	SILT FENCE
EC 3	STABILIZED CONSTRUCTION ENTRANCE
(EC 4)	INLET PROTECTION



PROJECT INFORMATION

NOSECT INFORMATION

PROPOSED MULTI-FAMILY DEVELOPMENT **LUMIN TERRACE**JOHNSON STREET • WATERTOWN, WI

ESSIONAL SEAL


PRELIMINARY DATES	
OCT. 11, 2024 OCT. 18, 2024 OCT. 23, 2024 OCT. 25, 2024 OCT. 30, 2024 OCT. 30, 2024 NOV. 8, 2024	OT FOR CONSTRUCTION


240136200

C1.2A

CIVIL GRADING AND EROSION CONTROL PLAN - OVERALL



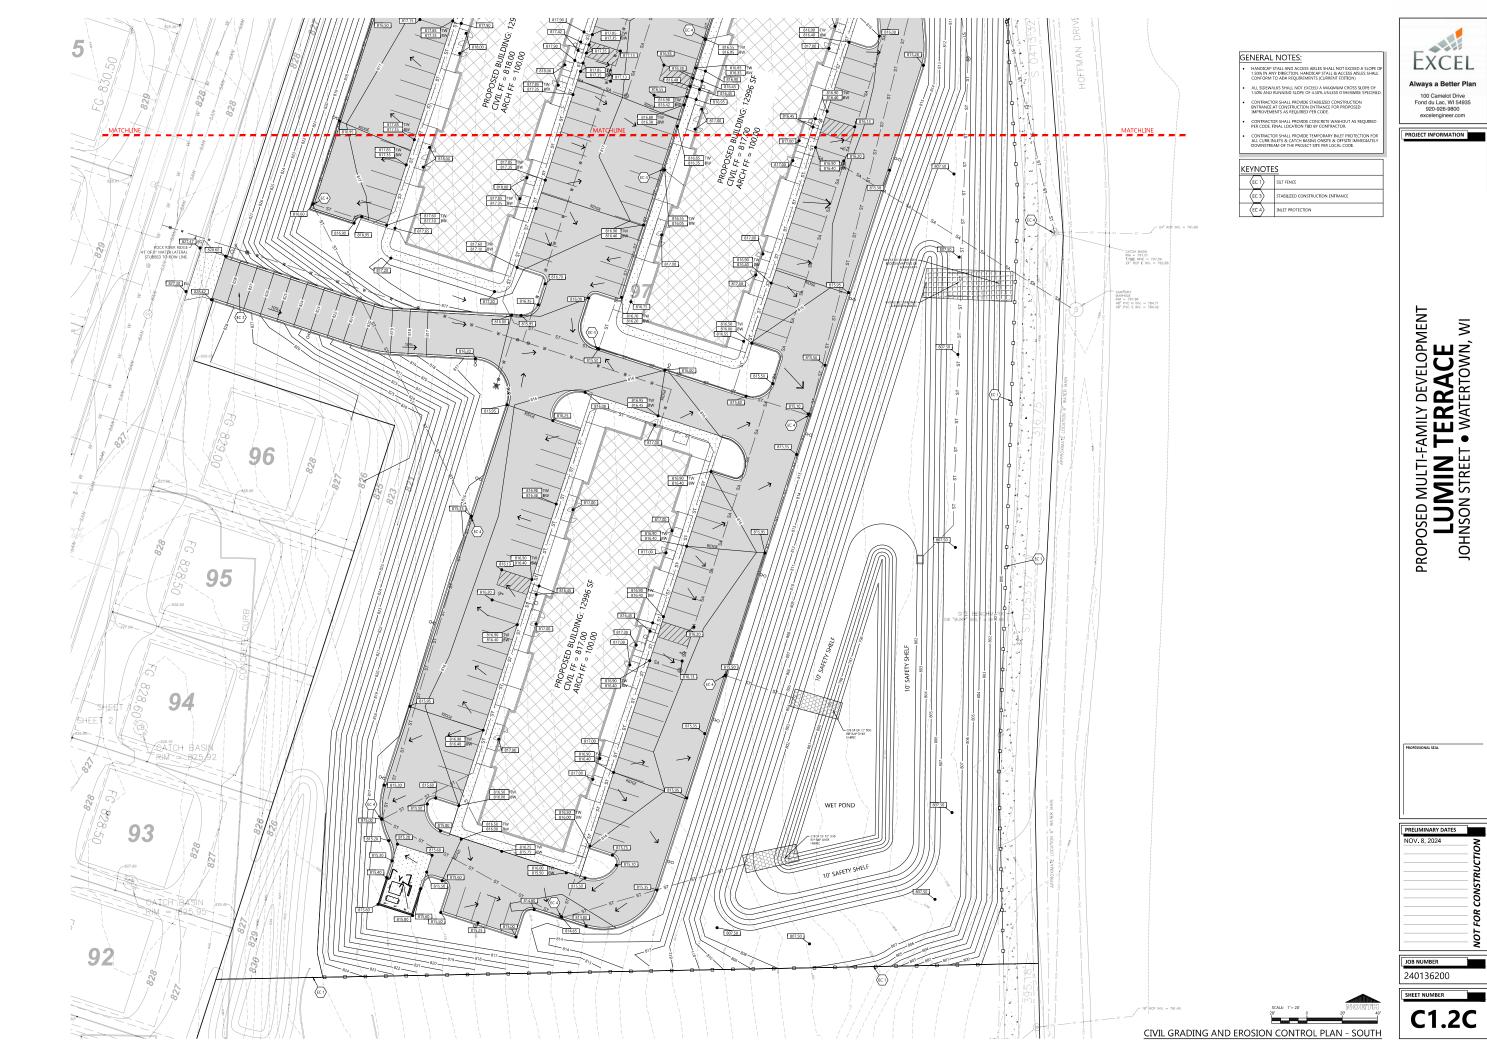

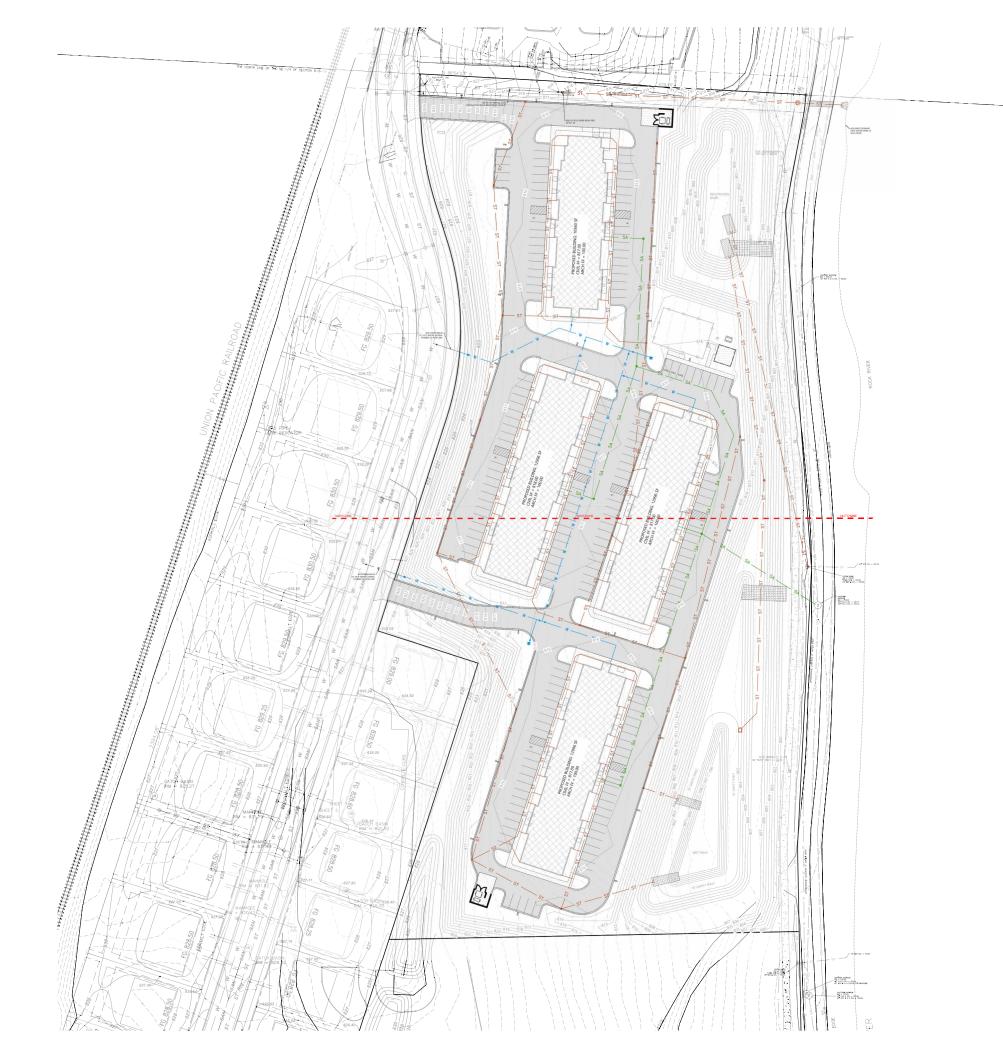

GENERAL NOTES:

 ALL DOWNSPOUT LEADERS WITH DS TAG SHALL BE 6" HDPE PL WITH LENGTH OF LEADER NOTED AFTER DS PREFIX.
 CONTRACTOR TO VERIFY WATER AND SANITARY PIPE SIZING W INTERIOR PLUMBER PRIOR TO CONSTRUCTION AND NOTITY. EXCEL

Always a Better Plan

100 Camelot Drive
Fond du Lac, WI 54995
920-926-9800
excelengineer.com

PROJECT INFORMATION

PROJECT INFORMATION

PROPOSED MULTI-FAMILY DEVELOPMENT **LUMIN TERRACE**JOHNSON STREET • WATERTOWN, WI

ESSIONAL SEAL

PRELIMINARY DATES
OCT. 17, 2024
OCT. 18, 2024
OCT. 23, 2024
OCT. 25, 2024
OCT. 30, 2024
NOV. 7, 2024


OCT. 30, 2024
NOV. 7, 2024


JOB NUMBER
240136200


SHEET NIMBER


SHEET NUMBER C1.3A

CIVIL UTILITY PLAN - OVERALL

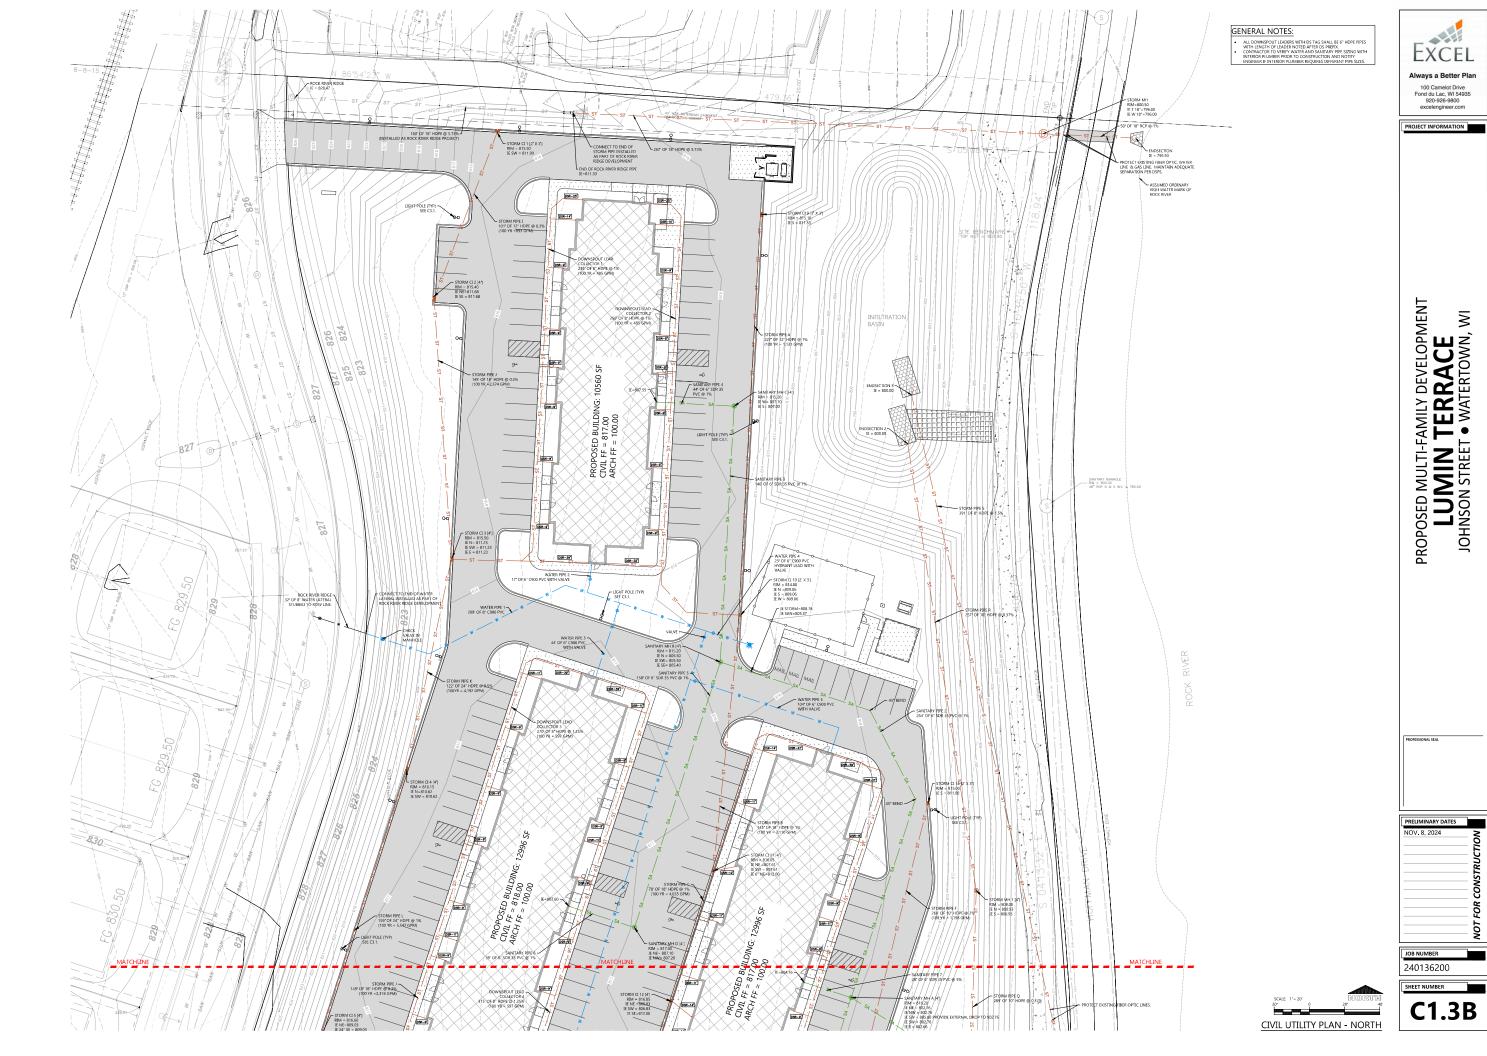

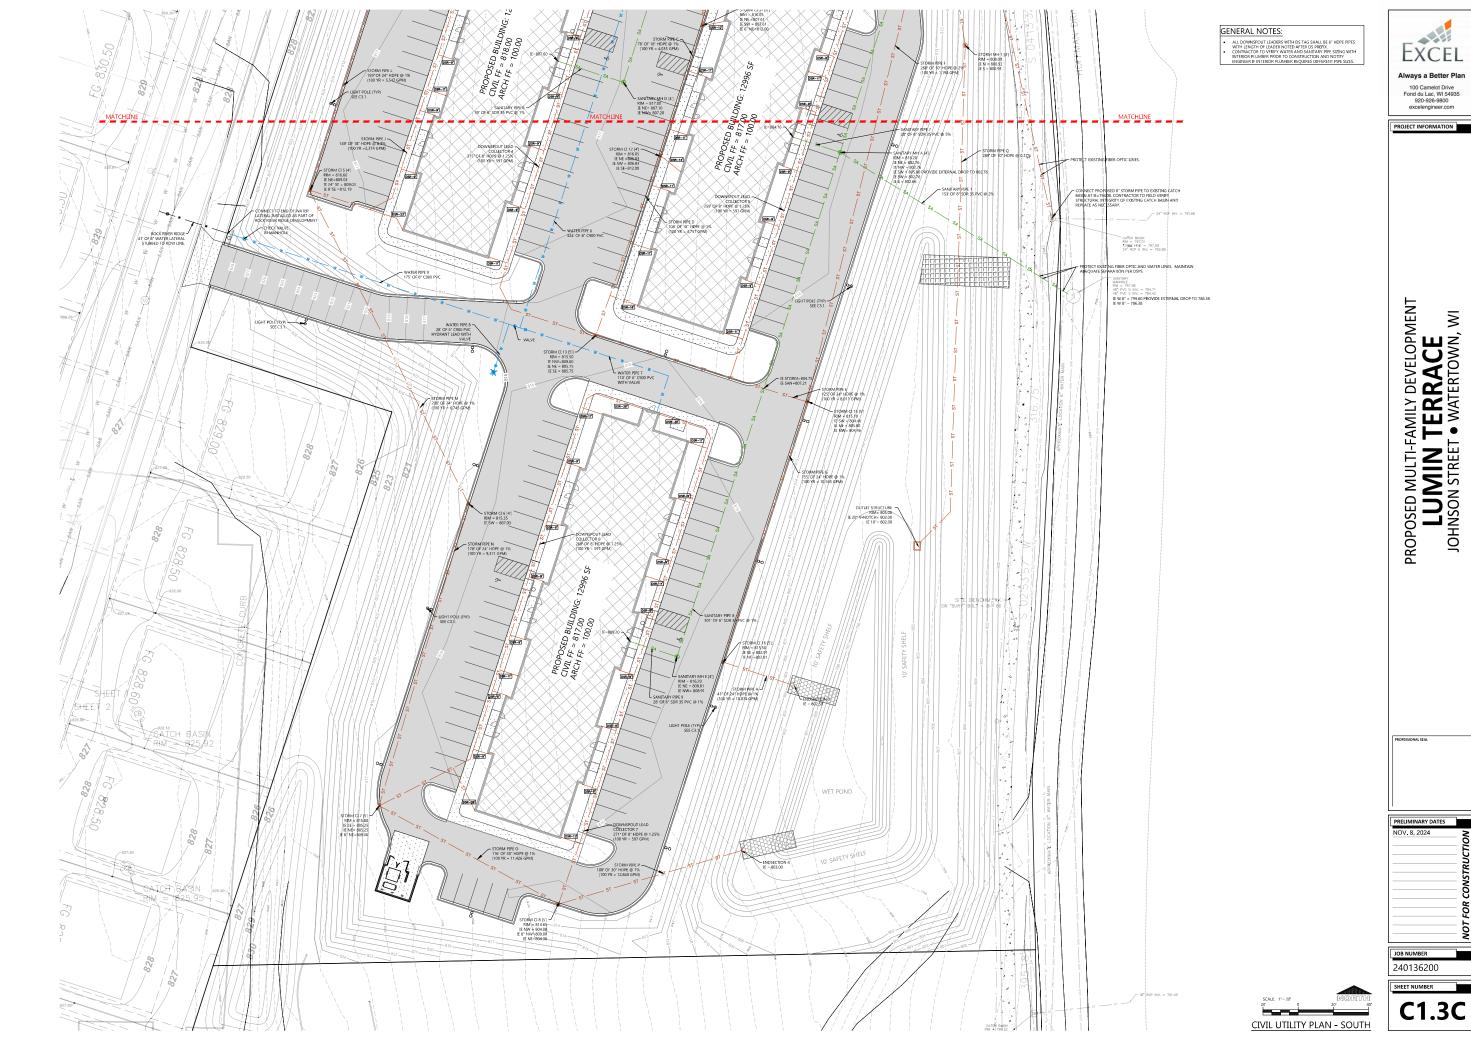


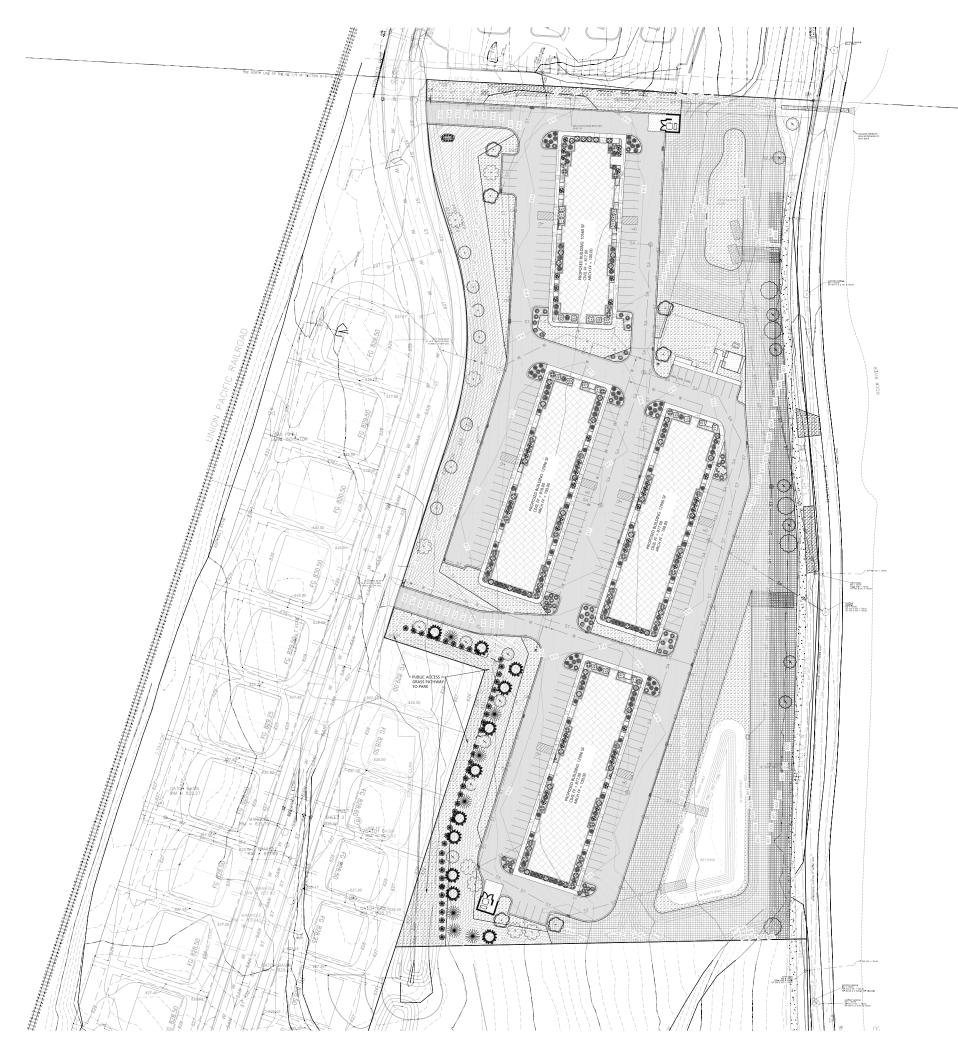

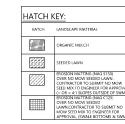


	LANDSCAPING CAL	CULATIONS
ZONE	REQ. PLANTS	PLANTS PROVIDED
PAVED AREAS	GREATER OF: 100 POINTS PER 20 PARKING STALLS OR 10,000 SQUARE FEET OF PARKING AREA A MINIMUM OF 30% OF POINTS DEVOTED TO CLIMAXYTALL TREES AND 40% TO 51HRUBS 1100-1980 POINTS TOTAL REQUIRED 1324*3-398 POINTS MINIMUM TALL TREES	66 (S-POINT) DECIDIOUS SHRUBS 40 (S-POINT) EVERGEREN SHRUBS 530 TOTAL SHUB POINTS PROVIDED 11 (75 POINT) CLIMAX TREE 825 TOTAL TREE POINTS 1355 POINTS TOTAL PROVIDED
DEVELOPED LOTS	1324*.4=530 POINTS MINIMUM SHRUBS 20 POINTS PER 1,000 SQUARE FEET OF BUILDING FOOTPRINT ******20=991 POINTS REQD	48 (3 POINT) DECIDUOUS SHRUBS=144 7 (20 POINT) MEDIUM TREES =140 18(40 POINT) TALL EVERGREEN TREES=760
STREET	DO POINTS PRE TO LINEAR FEET OF STREET FRONTAGE SHRUSS NOT ALLOWED, A NIRMMUM OF 50% OF POINTS PRIVATED TO CLEMAN/THAL TRESS AND 30%. TO MEDIUM TREE, \$155,547 at 100 MEDIUM TREE TREE, \$155,547 at 100 MEDIUM TREE TREEDIUM TREEDI	HOFFMAN ROAD 5 (75 POINT) CLIMAX=375 8 (20 POINT) CLIMAX=375 8 (20 POINT) MEDIUM:160 535 TOTAL JOHNSON STREET 3 (35 POINT) CLIMAM=225 7 (15 POINT) MEDIUM=105 330 TOTAL
BUILDING FOUNDATION	SO POINTS PER 100 FEET OF BUILDING FOUNDATION CLIMAX TREES AND TALL TREES SHALL NOT BE USED TO MET THIS REQUIREMENT. (637+637+637+556)/100*50=1,234 POINTS REQD	131 (5-POINT) DECIDUOUS SHRUBS 9 (3-POINT) DECIDUOUS SHRUBS 81 (5-POINT) EVERGREEN SHRUBS 55 (3-POINT) EVERGREEN SHRUBS TOTAL 1,234 POINTS PROVIDED


			PLANTED		
SYMBOL	COMMON NAME	BOTANICAL NAME	SIZE	QUANTITY	POIN
		DECIDUOUS TREES			
0	Sugar Maple	Acer saccharum	2*	6	7
0	Red Oak	Quercus rubra	2*	8	7
0	Ginkgo	Ginkgo bilboa	2"	5	7
0	River Birch	Betuļa nigra	2"	7	1
0	American Arborvitae	EVERGREEN TREES Thuja occidentalis	2.	15	4'-
*	Austrian Pine	Pinus nigra	4'	7	4
Ö	Black Hills Spruce	Picea glauca	4'	11	40
*	Common Lilac	DECIDUOUS SHRUBS Syringa vulgaris	24"	81	
*	Common Lilac Weigela Carnaval		24° 24°	81	
•		Syringa vulgaris			
® ● B	Weigela Carnaval	Syringa vulgaris Weigela Florida 'courtalor'	24"	3	
•	Weigela Carnaval Smooth Sumac	Syringa vulgaris Weigela Horida 'courtalor' Rhus glabra	24' 24'	3 21	
(B) (C) (C) (C) (C) (C) (C) (C) (C) (C) (C	Weigela Carnaval Smooth Sumac Tamarisk	Syringa vulgaris Weigela Horida 'courtalor' Rhus glabra Tamarix ramosissima	24° 24° 24°	3 21 23	
® ● B	Weigela Carnaval Smooth Sumac Tamarisk Gray Dogwood	Syringa vulgaris Weigela Horida 'courtalor' Rhus glabra Tamarix ramosissima Corrus racemosa	24* 24* 24* 24*	3 21 23 24	
(B) (C) (C) (C) (C) (C) (C) (C) (C) (C) (C	Weigela Carnaval Smooth Sumac Tamarisk Gray Dogwood Eastern Ninebark	Syringa vulgaris Weigela Horida 'courtalor' Rhus glabria Tamarix ramosissima Corrus racemosa Physocarpus opulifolius	24* 24* 24* 24* 24*	3 21 23 24 51	
\$ \$ \$ \$ \$	Weigela Carnaval Smooth Sumac Tamarisk Gray Dogwood Eastern Ninebark	Syringa vulgaris Weigda Horida 'countalor' Rhus glabra Tamaric ramosissima Cornus sedemosa Physocarpus opulfiolius Costoneaster fucida	24* 24* 24* 24* 24*	3 21 23 24 51	
₩ ₩ ₩	Weigels Carnaval Smooth Sumac Tannarisk Gray Dogwood Eastern Ninebark Hedge Cotoneaster	Syringa vulgaris Weigela Horida 'couralor' Pitra glabra Tamaris ramosissima Corrus racemosa Physicoprus copuliolius Cotoneaster fucida EVERGREEN SHRUBS	24* 24* 24* 24* 24* 24* 24*	3 21 23 24 51 48	
\$ \$ \$ \$ \$	Wolgels Carnaval Smooth Suma: Tamatrisk Gray Dogwood Eastern Ninebark Hedge Cotonesster Pfitzer Juniper	Syringa vulgaris Weigela Horida 'courtalor' Nhus glabria Tamair ramosisima Corrus racemosa Physocripus opulifolius Cotionesiter fucida EVERGREEN SHRUSS Juniperus chimenis 'Pfitzeriana'	24* 24* 24* 24* 24* 24* 24* 24* 24* 12*-15"	3 21 23 24 51 48	
© © © © © © © © © © © © © © © © © © ©	Wingels Camaval Smooth Sures: Tamarisk Gray Dogwood Eastern Nimebark Hedge Coloneaster Phitzer Juniper Arradia Juniper	Syringa vulgaris Weigde Horids 'courslor' Place blabra Sanatic ramodisma Corrus sciencessa Physicarpia copulfolius Cotinesster fucids EVERGREN SHRUES Juniperus chimenis 'Pfitzeriana' Juniperus sabina 'arcada'	24* 24* 24* 24* 24* 24* 24* 24* 24* 24*	3 21 23 24 51 48	
₩ ₩ ₩	Weigels Carnaval Smooth Sume: Tamanisk Gray Dogwood Eastern Ninebasisk Hedge Coloneaster Pitzer Juniper Arcadia Juniper Ware American Arbonistae	Syringa vulgaris Weigda Honda 'courtalor' Rhus glabra Tamaric ramoissima Corrus racemosa Physosophilos Cotioneaster lucida EVERCREEN SHRUSS Junipenus chimensis "Pitrariana" Junipenus sabina 'arcadia' Titaja cociondial "Robusta"	24* 24* 24* 24* 24* 24* 24* 24* 24* 36*	3 21 23 24 51 48 48 55 19	
© © © © © © © © © © © © © © © © © © ©	Wrigels Carnaval Smooth Sumac Famanisk Gray Dopacod Eastern Ninebark Hedge Cotonesster PRizer Juniper Arcada Juniper Water American Arboniste Hannewall Yow	Syringa valgaris Weigela Florida 'courtalor' Place Jobbos Flamaric ramossisma Corrus scenence Physocarpus opulficilius Cotonesster lucicis Cotonesster lucicis EVERCREEN SHBUSS Auriperus chimenis "Pitzeriana" Juniperus chimenis "Pitzeriana" Thiga occidentalis "Robusta" Tawas coupidatis "Expossa" Tawas coupidatis "Expossa"	24" 24" 24" 24" 24" 24" 24" 24" 24" 24"	3 21 23 24 51 48 48 55 19	

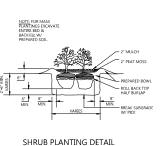

SHRUB PLANTING DETAIL

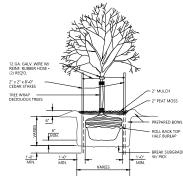

TREE PLANTING DETAIL

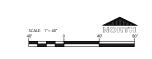

CIVIL LANDSCAPE AND RESTORATION PLAN




PROPOSED MULTI-FAMILY DEVELOPMENT LUMIN TERRACE
JOHNSON STREET • WATERTOWN, WI

OCT. 23, 2024 OCT. 25, 2024 OCT. 30, 2024 NOV. 8, 2024

240136200

C1.4

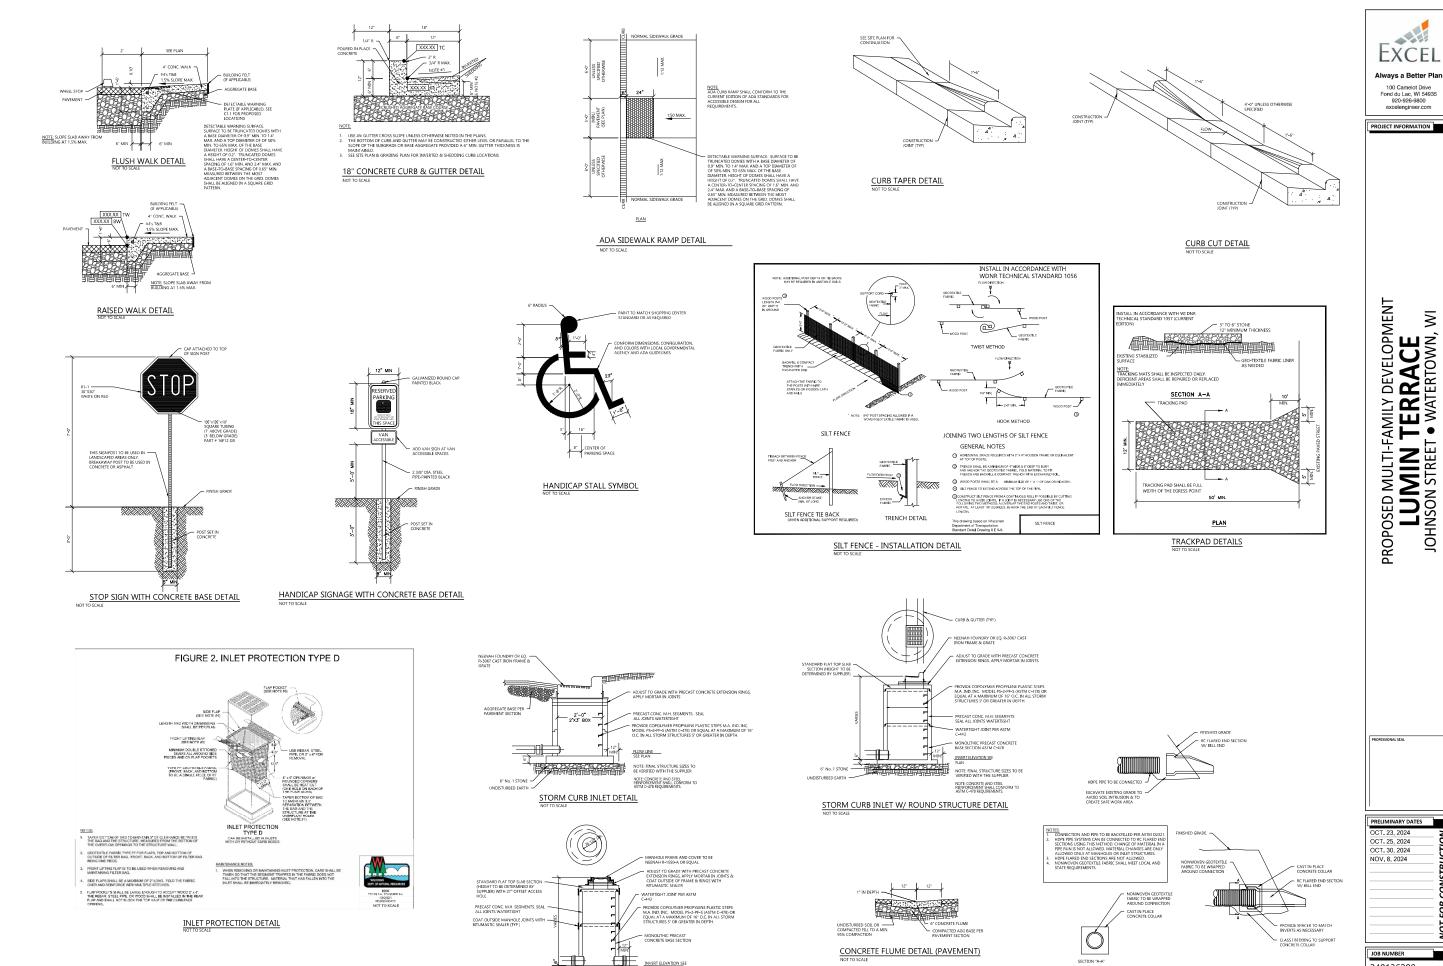

SANITARY MANHOLE DETAIL

240136200

SHEET NUMBER


C2.0

CONNECTION DETAIL FOR HDPE PIPE TO RC FLARED END SECTION BELL END

PRELIMINARY DATES
OCT. 23, 2024
OCT. 25, 2024
OCT. 30, 2024
NOV. 8, 2024
NOV. 8, 2024

240136200

C2.1

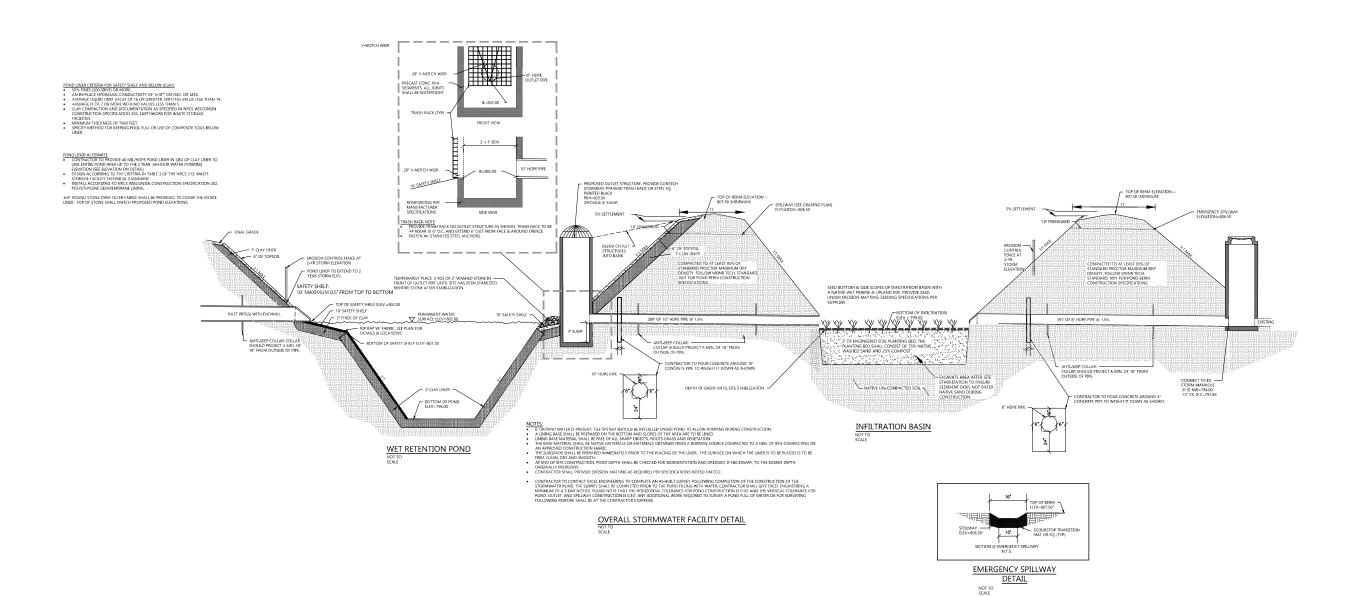





PROJECT INFORMATION

PROPOSED MULTI-FAMILY DEVELOPMENT LUMIN TERRACE
JOHNSON STREET • WATERTOWN, WI

NOV. 8, 2024

JOB NUMBER 240136200 SHEET NUMBER C3.1

COOPER LIGHTING SOLUTIONS LUMARK (FORMERLY EATON)

PSS0000SEN page 1

Lumark

Area / Site Luminaire

Product Features

Product Certifications

Quick Facts

MOTES:

1. Well type, "years designishis org-resets" to confict.

2. IDA Certified for 3000K CCT and warrier only.

O COOPER

L13

Quick Facts

Direct-mounted discrete light engine for improved optical uniformity and visual comfort

Lumen packages range from 4,300 - 68,000 nominal lumens (30W - 550W)

Replaces 70W up to 1,000W HID equivalents

Efficacies up to 157 lumens per watt

Standard universal quick mount arm with universal drill pattern

Prevail Discrete LED

P66 P6A

A2.0



FRONT ELEVATION

SCALE: 1/8" = 1"-0"



REAR ELEVATION


SCALE: 1/8" = 1'-0"



SIDE ELEVATION

SCALE: 1/8" = 1'-0"



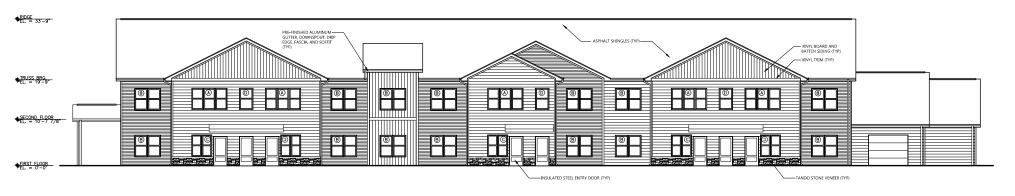

FRONT ELEVATION
SCALE: 1/8" = 1'-0"



REAR ELEVATION

SCALE: 1/8" = 1'-0"



SIDE ELEVATION
SCALE: 1/8" = 1'-0"



SIDE ELEVATION
SCALE: 1/8" = 1'-0"

EXCEL Always a Better Plan 100 Camelot Drive Fond du Lac, WI 54935 920-926-9800 excelengineer.com

PROPOSED MULTI-FAMILY DEVELOPMENT LUMIN TERRACE
JOHNSON STREET • WATERTOWN, WI

PRELIMINARY DATES

JOB NUMBER 240136200 **A2.1**