BASIC TWO-STORY/ FINISHED CAPE SET FIRST FLOOR MODULES

SET 2ND FLOOR MODULES

INSTALL 2X ACROSS MARRIAGE LINE DIVIDED EQUALLY

RAISE ROOF AND PULL THE KNEEWALL INTO POSITION

HIP OPTION

PART OF THE ROOF IS HINGED WITH THE REMAINDER SHIPPED PANELIZED INCLUDING THE HIP RAFTER. PART OF THE ROOF SHEATHING IS STEPPED BACK FOR SITE SETUP. THIS ROOF SHEATHING SHOULD BE INSTALLED AFTER THE FRAMING CONNECTIONS HAVE BEEN MADE.

NOTE:

PORCHES, DECKS AND/OR GARAGE TO BE THE DECISION OF THE BUILDER OR OWNER PER LOCAL CODES & REQUIREMENTS.

HOMES ®

PROJECT NO.

**FP. NUMBER** 223217


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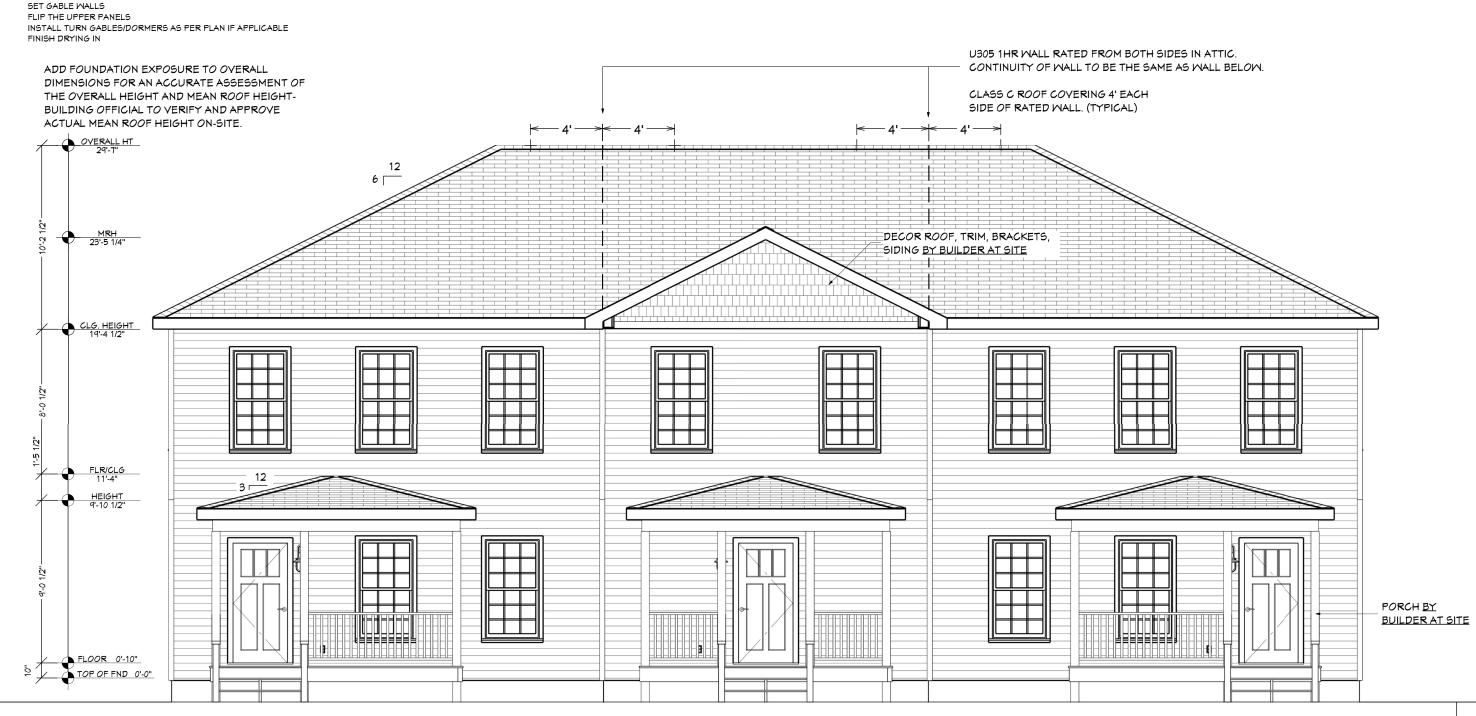


EVATION

SHEET:

1.0 OF 6

THIS IS A BASIC SET OF INSTRUCTIONS TO HELP GUIDE THE SET CREW ON DAY OF SET. SET CREW SHOULD READ THE PLANS THOROUGHLY PRIOR TO SET DAY. THESE SET INSTRUCTIONS COVER THE SET ORDER AND ANY MAJOR POINTS THAT MAY NEED TO BE ADDRESSED, PROPER MODULE CONNECTIONS AND FASTENING IS NOT PART OF THESE INSTRUCTIONS. SET CREW TO FOLLOW INDUSTRY STANDARD SAFETY PRACTICES AND OSHA REQUIREMENTS.

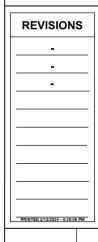


## FRONT ELEVATION

THESE RENDERINGS ARE AN ARTIST'S DEPICTION ONLY, MAY NOT REFLECT THE ACTUAL FINAL PRODUCT. PLAN UPDATES MAY NOT BE REFLECTED IN RENDERINGS. REFER TO THE CONSTRUCTION DOCUMENTS FOR ADDITIONAL INFORMATION. RENDERINGS SHALL NOT BE USED FOR CONSTRUCTION. TOWNHOUSE - LOT #130, #132, #134 4,836 TOTAL SQ. FT. FAUQUIER HABITAT FOR HUMANITY

NOTE:

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REAR ELEVATION

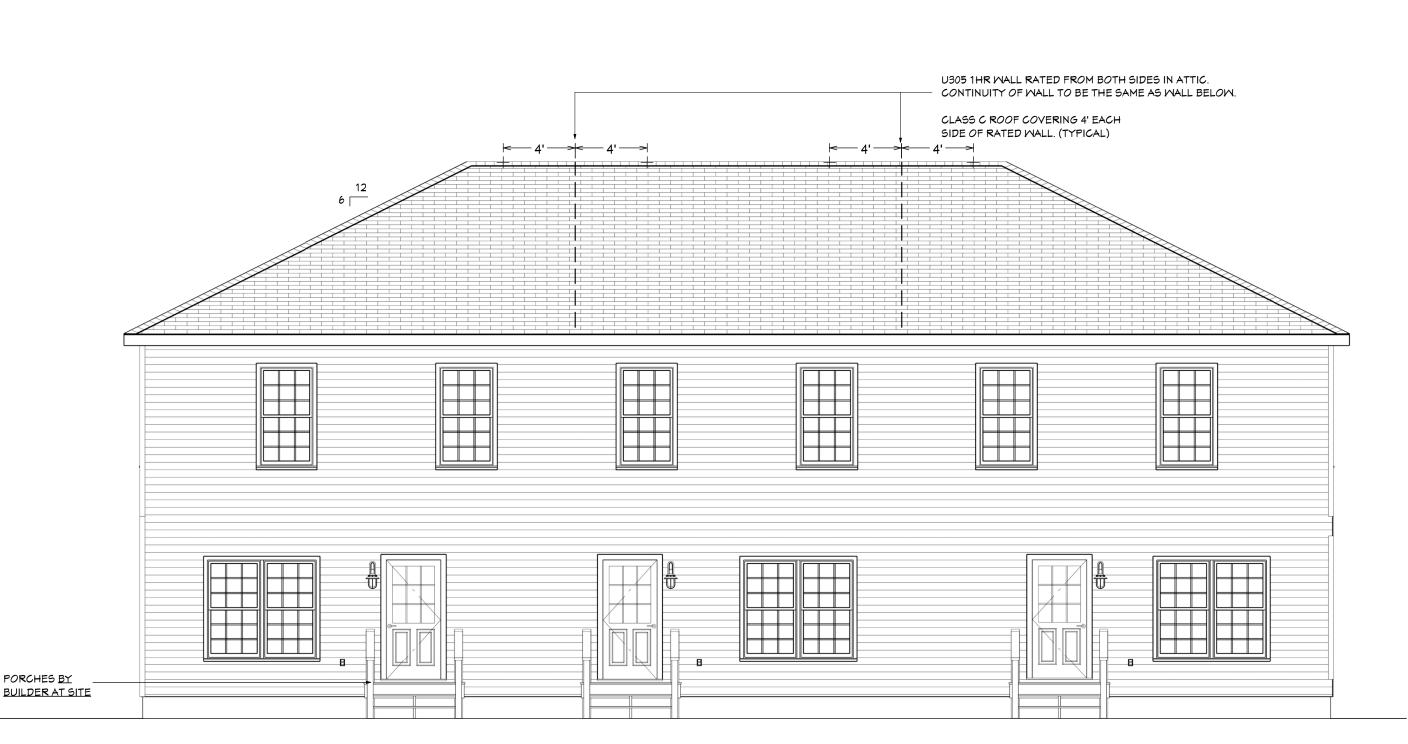PORCHES BY

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REVISIONS

ELEVATION

SHEET:

NOTE:
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LEFT ELEVATION

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SCALE:

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REVISIONS

SHEET:

1.2 OF 6

NOTE:
PORCHES, DECKS ANDIOR GARAGE TO BE
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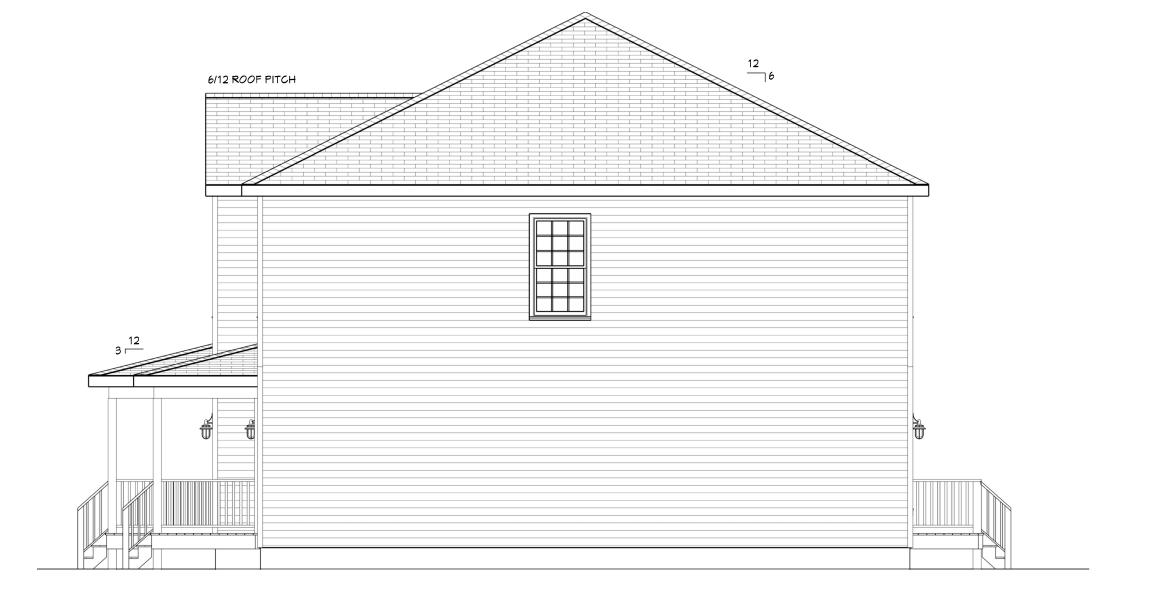
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REVISIONS


SHEET:

1.3 OF 6



**RIGHT ELEVATION** 

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CARDINAL HOMES ®

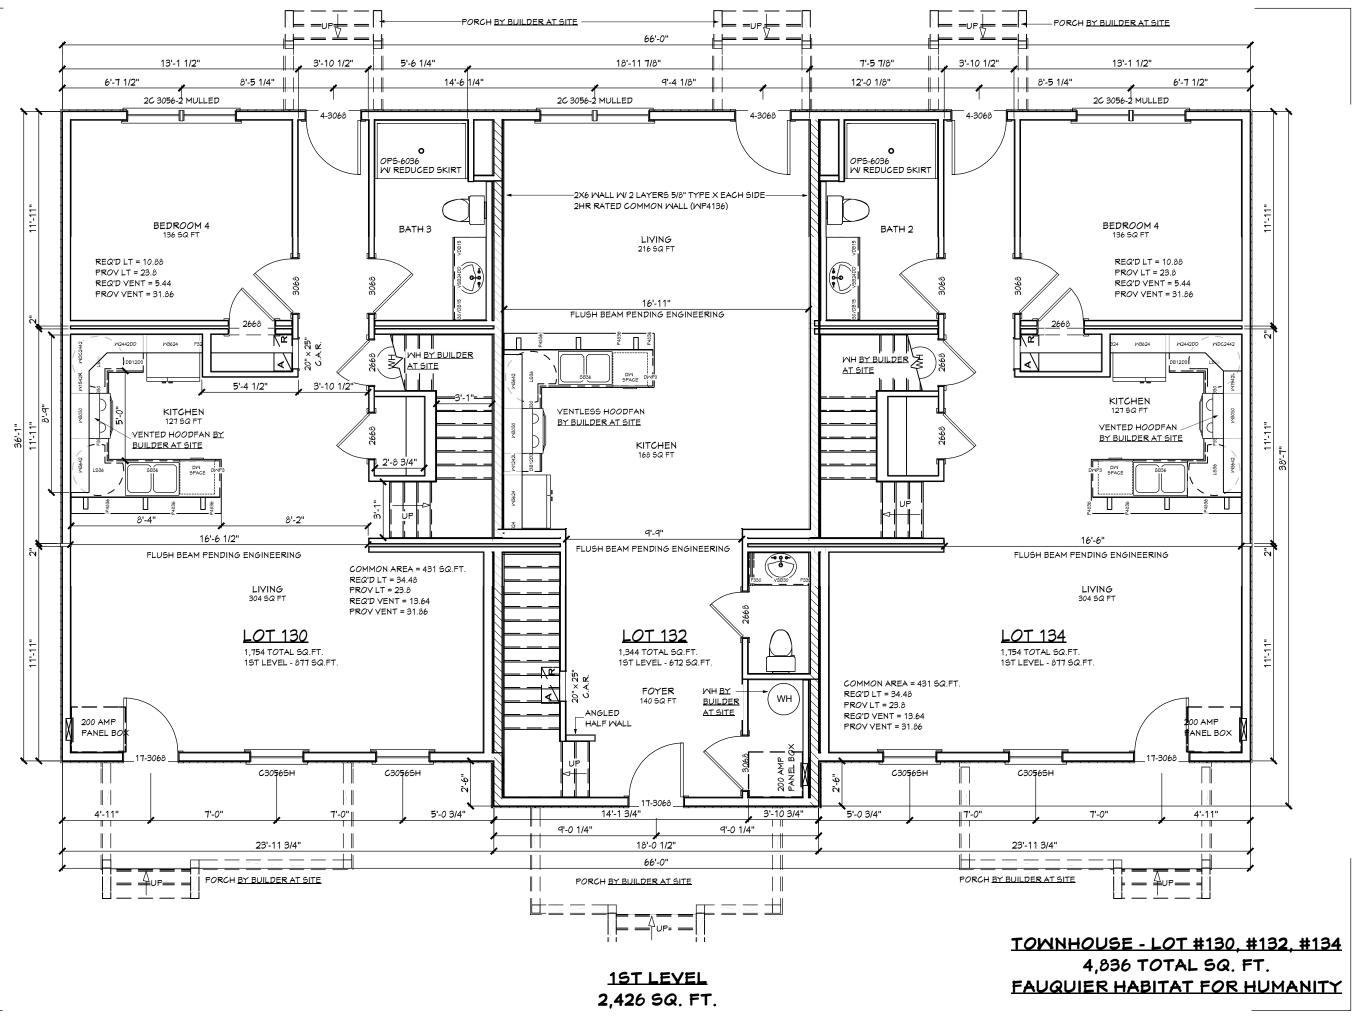PROJECT NO.

FP. NUMBER 223217

PRINT NO.

DATE

9/15/23

DRAWN BY: EW

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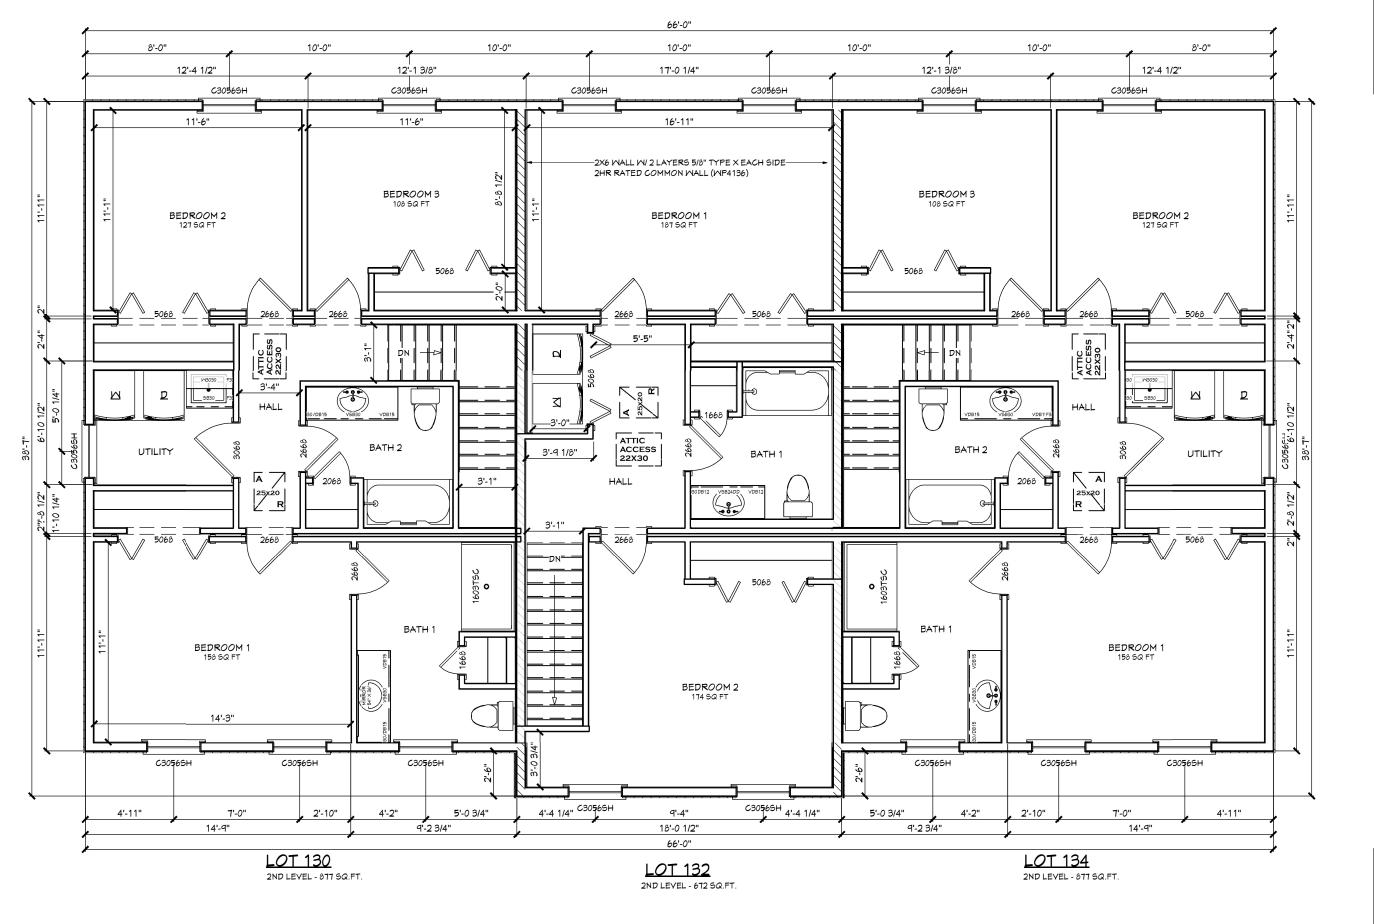
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REVISIONS

FLOOR PLAN

SHEET:

2.0 OF 6



2ND LEVEL 2,426 SQ. FT. TOWNHOUSE - LOT #130, #132, #134 4,836 TOTAL SQ. FT. FAUQUIER HABITAT FOR HUMANITY CARDINAL HOMES ®

PROJECT NO.

FP. NUMBER 223217

PRINT NO.

DATE 9/15/23

DRAWN BY:

EW

SCALE:

3/16" = 1'-0"

REVISIONS

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FLOOR PLAN
2024 KITUWAH MANUFACTURING, LLC

SHEET:

WINDOW SCHEDULE 1ST FLOOR									
LABEL	QTY	FLOOR	MIDTH	HEIGHT	R/0	DESCRIPTION	NOTES	LIGHT	VENT
2C 3056-2 MULLED	3	[1	73"	65 1/2"	77"X66 1/2"	MULLED UNIT		23.8	12.26
C3056SH	4	1	36"	66"	36 1/2"X66 1/2"	SINGLE HUNG		11.9	6.13

					DOOR S	CHEDULE 1ST FLO	00R	
LABEL	QTY	FLOOR	SIZE	MIDTH	HEIGHT	R/0	DESCRIPTION	COMMENTS
3068	3	1	3068 L IN	36"	80"	38"X82 1/2"	HINGED-PER ORDER	
3068	2	1	3068 R IN	36"	80"	38"X82 1/2"	HINGED-PER ORDER	
2668	4	1	2668 L IN	30"	80"	32"X82 1/2"	HINGED-PER ORDER	
2668	3	1	2668 R IN	30"	80"	32"X82 1/2"	HINGED-PER ORDER	
17-3068	1	1	3068 L EX	36"	80"	38 1/2"X82 1/2"	EXT. HINGED-CRAFTSMAN THREE LITE II	LOW THRESHOLD
17-3068	2	1	3068 R EX	36"	80"	38 1/2"X82 1/2"	EXT. HINGED-CRAFTSMAN THREE LITE II	LOW THRESHOLD
4-3068	2	1	3068 L EX	36"	80"	38 1/2"X82 1/2"	EXT. HINGED-9 LITE, 2 PANEL	
4-3068	1	1	3068 R EX	36"	80"	38 1/2"X82 1/2"	EXT. HINGED-9 LITE, 2 PANEL	

MINDOM SCHEDULE 2ND FLOOR									
LABEL	QTY	FLOOR	MIDTH	HEIGHT	R/0	DESCRIPTION	NOTES	LIGHT	VENT
C30565H	16	2	36"	66"	36 1/2"X66 1/2"	SINGLE HUNG		11.9	6.13

	DOOR SCHEDULE 2ND FLOOR							
LABEL	QTY	FLOOR	SIZE	MIDTH	HEIGHT	R/0	DESCRIPTION	NOTES
5068	9	2	5068 L/R	60"	80"	62"X82 1/2"	4 DR. BIFOLD-PER ORDER	
3068	1	2	3068 L IN	36"	80"	38"X82 1/2"	HINGED-PER ORDER	
3068	1	2	3068 R IN	36"	80"	38"X82 1/2"	HINGED-PER ORDER	
2668	7	2	2668 L IN	30"	80"	32"X82 1/2"	HINGED-PER ORDER	
2668	6	2	2668 R IN	30"	80"	32"X82 1/2"	HINGED-PER ORDER	
2068	1	2	2068 R IN	24"	80"	26"X82 1/2"	HINGED-PER ORDER	
2068	1	2	2068 L IN	24"	80"	26"X82 1/2"	HINGED-PER ORDER	
1668	1	2	1668 L IN	18"	80"	20"X82 1/2"	HINGED-PER ORDER	
1668	2	2	1668 R IN	18"	80"	20"X82 1/2"	HINGED-PER ORDER	

#### OTE:

- 1. INTERIOR DOORS NOT ON A MARRIAGE LINE HAVE A 2X4 FLAT HEADER. OTHER HEADER / STRUCTURAL SUPPORT OPTIONS MAYBE LISTED ON FLOOR PLAN
- 2. ALL EXTERIOR WINDOW & DOOR HEADERS TO BE (3) 2X4 SPF#2 HEADER UNLESS OTHERWISE NOTED
- PG 32, BEAM SPANS
- 3. ALL MATELINE DOOR HEADERS TO BE (2) 2X4 SPF#2 HEADER
- PER MODULE/ NO SPLICE UNLESS OTHERWISE NOTED
- PG 2. BEAM SPANS

CARDINAL HOMES ®

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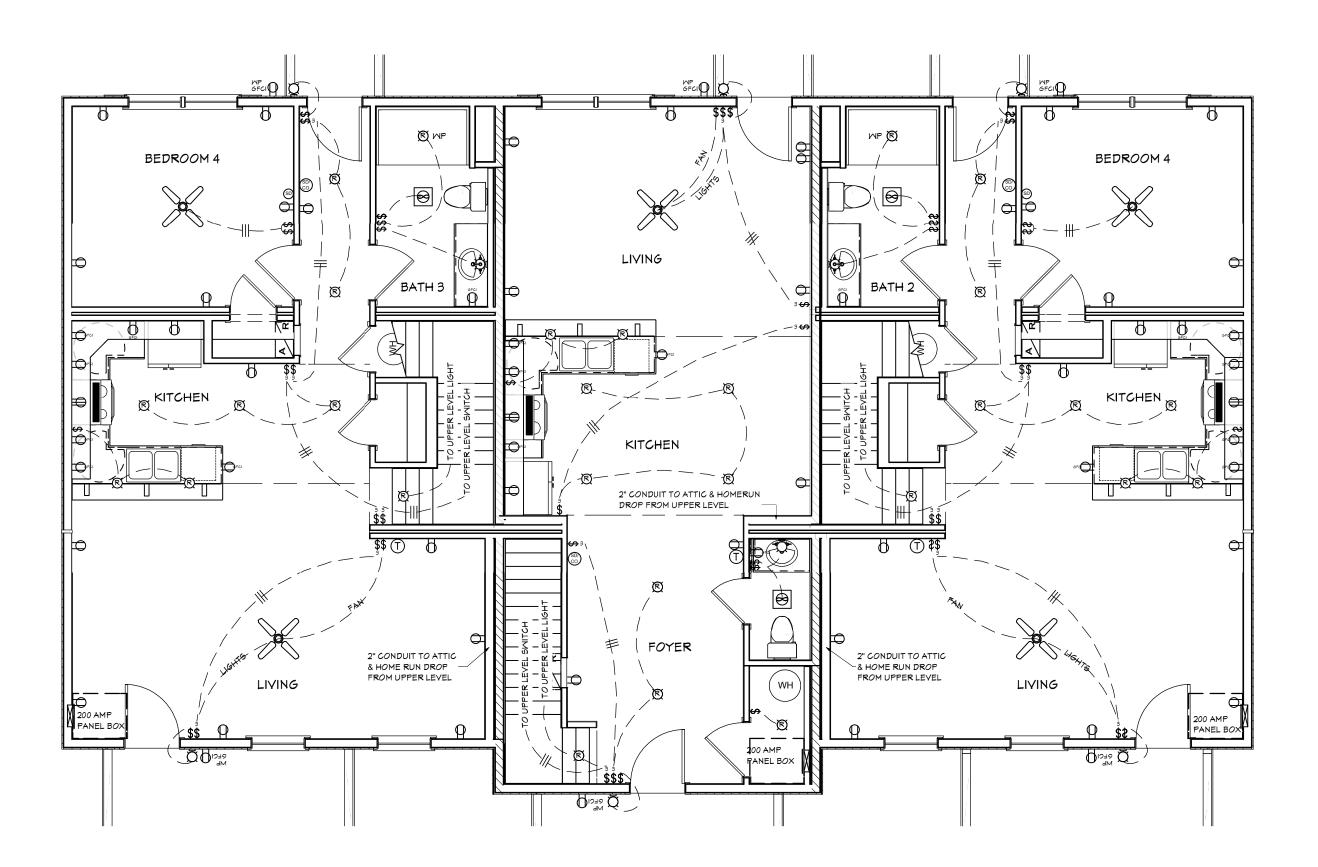
REVISIONS

WINDOW / DOOR SCHEDULE

SHEET:

2.2 OF 6

TOWNHOUSE - LOT #130, #132, #134 4,836 TOTAL SQ. FT. FAUQUIER HABITAT FOR HUMANITY



**1ST LEVEL** 

TOWNHOUSE - LOT #130, #132, #134 4,836 TOTAL SQ. FT. FAUQUIER HABITAT FOR HUMANITY



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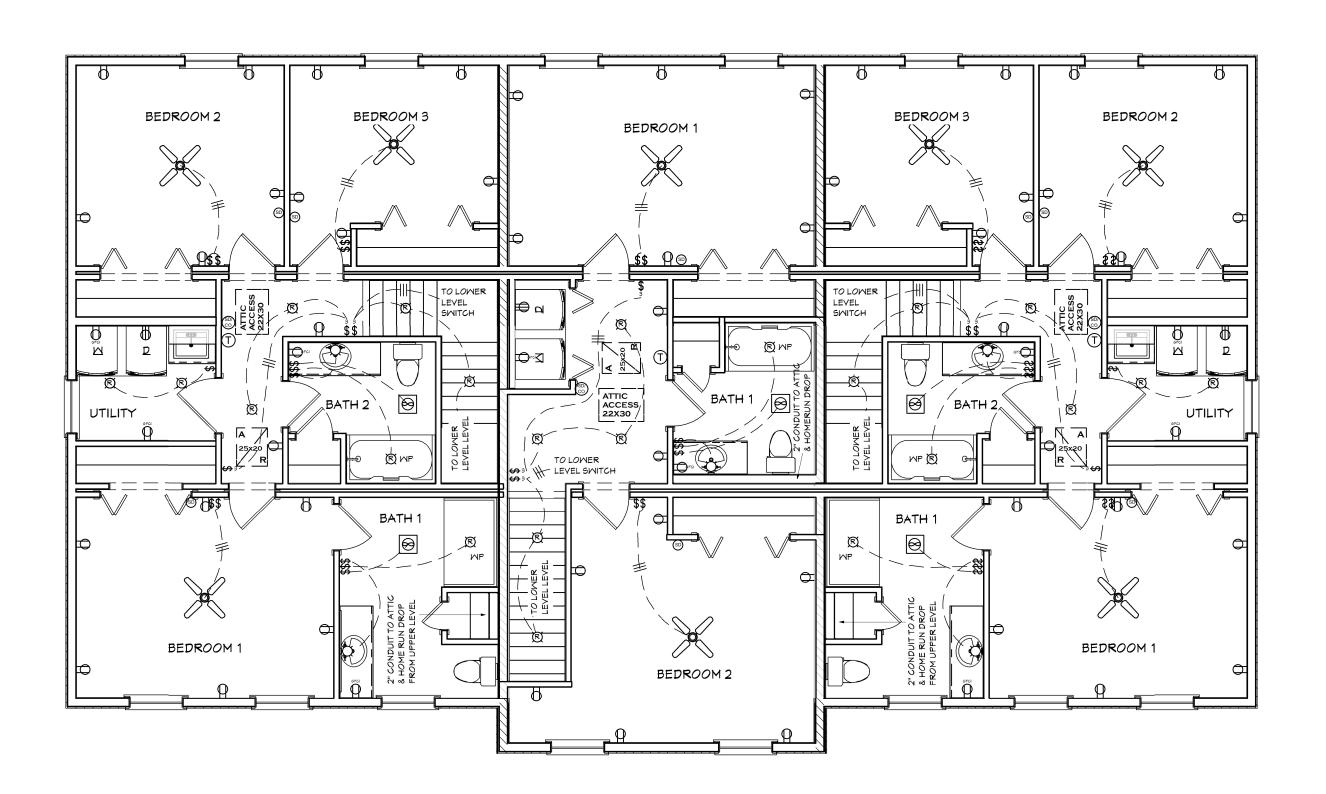
SCALE:

3/16" = 1'-0"

ELECTRICAL

SHEET:

3.0 OF 6



2ND LEVEL

TOWNHOUSE - LOT #130, #132, #134 4,836 TOTAL SQ. FT. FAUQUIER HABITAT FOR HUMANITY



PROJECT NO.

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EW

SCALE:

3/16" = 1'-0"

ELECTRICAL

SHEET:

## ELECTRICAL NOTES

- 1. THE AMPACITY OF ALL GENERAL BRANCH CIRCUITS SHALL BE 20 AMPS. ALL OTHER CIRCUITS LISTED AS DEDICATED ON THE ELECTRICAL PANEL CIRCUIT DIRECTORY SHALL BE SIZED AS REQUIRED BY LISTING FOR INDIVIDUAL ITEMS. ALL GENERAL BRANCH RECEPTACLES ARE TO BE TAMPER RESISTANT EXCEPT FOR RECEPTACLES LOCATED WITHIN A DEDICATED SPACE FOR AN APPLIANCE THAT IN NORMAL USE ISN'T EASY MOVED FROM ON PLACE TO ANOTHER.
- 2. GENERAL CIRCUITING INFORMATION:
- A. ONE CENTRAL HEATING CIRCUIT (SPACE SHALL BE ALLOWED FOR ON MAIN PANEL UNLESS OTHERWISE NOTED)
- B. KITCHEN SMALL APPLIANCE AND DINING AREA RECEPTACLES 20 AMP CIRCUITS, MINIMUM NUMBER IS 2. ALL EATING SPACES, INCLUDING DINING ROOM, DINING NOOKS, BREAKFAST AREAS, ETC., SHALL BE PROVIDED WITH THIS 20 AMP PROTECTION.
- C. LAUNDRY CIRCUIT ONE 20 AMP CIRCUIT, GFCI PROTECTED, FOR WASHER AND ASSOCIATED RECEPTACLE IN AREA AND ONE DEDICATED 30 AMP CIRCUIT FOR DRYER.
- D. GENERAL LIGHTING AND CONVENIENCE RECEPTACLE BRANCH CIRCUITS AS DESIGNED PER RESIDENCE.
- 3. CARDINAL HOMES SHALL INSTALL A CIRCUIT DIRECTORY ON THE INSIDE COVER OF EVERY PANEL BOARD ENCLOSURE FOR CIRCUIT IDENTIFICATION. THE NUMBERS 1 THROUGH 14 SHALL BE RESERVED FOR THE FOLLOWING DEDICATED CIRCUITS: RANGE, WATER HEATER, DRYTER, WELL, WASHER, BATH GFGI, SMOKE DETECTORS, AND KITCHEN SMALL APPLIANCE BRANCH CIRCUITS. THEY ARE TO BE CONSIDERED DEDICATED CIRCUITS AND MAY NOT SERVE ANY OTHER ITEM IN COMBINATION WITH THE DEDICATED LISTING. ALL OTHER NUMBERS MAY BE USED FOR GENERAL BRANCH CIRCUITS OR AS REQUIRED FOR ADDITIONAL DEDICATED CIRCUITS, ANY CIRCUIT LISTED AS DEDICATED ON THE DIRECTORY MAY ONLY SERVE THE ITEM(S) LISTED AS DEDICATED TO THAT CIRCUIT.
- 4. NONMETALLIC CABLE (NM) IS USED THROUGHOUT AND IS INSTALLED AND SUPPORTED AS PER IT'S LISTING.
- 5. POWER AND LIGHTING DISTRIBUTION:
- A. GENERAL USE RECEPTACLES SHALL BE DISTRIBUTED WITHIN THE RESIDENCE.
- B. SMALL KITCHEN APPLIANCE SHALL NOT BE COMBINED WITH ANY OTHER RECEPTACLE TO COMPLETE ANY OTHER CIRCUIT. ALL SMALL KITCHEN APPLIANCE CIRCUITS SHALL NOT SERVE ANY OTHER OUTLETS OR DEVICES. SMALL KITCHEN APPLIANCE COUNTER TOP RECEPTACLES SHALL BE PROVIDED WITH GROUND FAULT PROTECTION. SMALL KITCHEN APPLIANCE CIRCUITS SHALL BE ON 20 AMP BREAKERS.
- C. BATHROOM RECEPTACLES EACH BATHROOM SHALL HAVE A MINIMUM OF ONE WALL RECEPTACLE INSTALLED ADJACENT TO EACH LAVATORY. THIS RECEPTACLE SHALL BE PROVIDED WITH GROUND FAULT CIRCUIT INTERRUPTION.
- D. OUTDOOR RECEPTACLES EACH HOME SHALL BE PROVIDED WITH A MINIMUM OF TWO OUTDOOR RECEPTACLES, ONE IN FRONT AND ONE IN BACK. PURCHASER TO SUPPLY AND INSTALL EXTERIOR GFCI RECEPTACLES ON SITE IF GRADE LEVEL DOES NOT ALLOW RECEPTACLE INSTALLATION AT THE REQUIRED HEIGHT. THESE RECEPTACLES SHALL BE PROVIDED WITH GFCI PROTECTION.

## 6. SMOKE DETECTORS:

ALL SMOKE DETECTORS SUPPLIED AND INSTALLED BY CARDINAL HOMES AND ALSO THOSE THAT ARE SITE INSTALLED SHALL BE APPROVED AND LISTED AS REQUIRED. THEY SHALL BE INSTALLED AND LOCATED IN EACH RESIDENCE. ALL DETECTORS SHALL BE WIRED AS TO BE INTERCONNECTED, RECEIVING PRIMARY POWER FROM A PERMANENT LIGHTING SOURCE, WITH PROVISIONS FOR BATTERY BACK-UP POWER. THE POWER SOURCE SHALL BE FROM A CIRCUIT THAT WOULD BE IN NORMAL DAILY USE BY THE HOUSEHOLD. THE SMOKE DETECTOR POWER SOURCE SHALL BE SO NOTED ON THE PLANS AND CIRCUIT DIRECTORY. ALL SMOKE DETECTORS MUST BE WIRED TO BE CONTAINED IN THE SAME CIRCUIT.

1. ARC FAULT BREAKERS:

ALL 120-VOLT, SINGLE PHASE, 15-AND 20 AMP-BRANCH CIRCUITS SUPPLYING OUTLETS INSTALLED IN BEDROOMS, SHALL BE PROTECTED BY A LISTED ARC-FAULT CIRCUIT INTERRUPTER IN ACCORDANCE WITH VIRGINIA UNIFORM STATEWIDE BUILDING CODE

# ALL ELECTRICAL BOXES IN THE FIRE-RATED ASSEMBLY WALL SHALL BE RATED FOR ONE HOUR

## FIRE RATINGS / EMERGENCY LIGHTING

- 1. ELECTRICAL & DATA BOXES INSTALLED IN FIRE RATED ASSEMBLIES SHALL BE RATED 1HR MIN.
- 2. THRU PENETRATIONS OF RATED WALL ASSEMBLIES SHALL BE PROTECTED

   BOXES INSTALLED SO THAT THE ANNULAR SPACE BETWEEN THE WALL MEMBRANE AND THE BOX DOES NOT EXCEED 1/8"
- BOXES INSTALLED IN RATED ASSEMBLIES ON OPPOSITE SIDES OF WALL SHALL BE PROTECTED BY SOLID FIREBLOCKING, OR PUTTY PADS APPLIED TO BOTH BOXES
- 3. THRU PENETRATIONS OF HORIZONTAL RATED ASSEMBLIES SHALL BE PROTECTED BY AN APPROVED THROUGH PENETRATION FIRESTOP SYSTEM
- 4. MEMBRANE PENETRATIONS BY ELECTRICAL & DATA BOXES INSTALLED IN FIRE RATED ASSEMBLIES SHALL BE PROTECTED
- 5. THE BRANCH CIRCUIT FEEDING EMERGENCY LIGHTING SHALL BE THE SAME BRANCH CIRCUIT AS THAT SERVING THE NORMAL LIGHTING IN THAT AREA AND BE CONNECTED AHEAD OF ANY LOCAL SWITCHES.

	ELEGTRICAL - LEGEND							
SYMBOL	DESCRIPTION							
WIRE	CEILING FAN (WIRE ONLY)							
€ €	VENTILATION FANS: CEILING MOUNTED, WALL MOUNTED							
	LIGHT FIXTURES: SURFACE, PENDANT, CEILING RECESSED, WP LIGHT							
a Q	LIGHT FIXTURES: FLUSH MOUNTED, WALL SCONCE WALL							
	FLUORESCENT LIGHT FIXTURE							
Φ	240V RECEPTACLE							
MP GFCI	110V RECEPTACLE: DUPLEX, WEATHER PROOF, GFCI							
\$ \$ \$	SWITCHES: SINGLE POLE, 3-WAY, 4-WAY							
DM T \$ \$	SWITCHES: DIMMER, TIMER							
Z P	WALL JACKS: PHONE, TV (CONDUIT ONLY)							
Ţ	THERMOSTAT							
T PC P	DOOR BELL: TRANSFORMER, CHIME, PUSH BUTTON							
(SD) (SD)	SMOKE DETECTOR, CARBON MONOXIDE / SD COMBO							
o	UNDER CABINET LIGHTS							
$\boxtimes$	ELECTRICAL DISTRIBUTION PANEL							

## ADDITIONAL ELECTRICAL NOTES:

ELECTRICAL DEVICE INSTALLATION HEIGHTS

## RECEPTACLE

TYPICAL WALL HEIGHT: 20" TO TOP OF BOX KITCHEN (36"H  $\times$  24"D) CABINET: 46 1/2" VANITY / DESK (30"H  $\times$  21"D): 45 1/2"

## MALL SMITC

TYPICAL WALL HEIGHT: 45  $\frac{1}{2}$ " TO TOP OF BOX LOWER ANY ADDITIONAL GANG BOX IN CONJUNCTION WITH TYPICAL GANG BOX

## EXTERIOR CARRIAGE STYLE LIGHTS

12" OFF OF DOOR JAMB 74" TO CENTER OF SIDING PLATE

## YANITY LIGHTS

WITH MEDICINE CABINET =  $\delta$ 1" TO CENTER OF BOX WITH 36IN MIRROR =  $\delta$ 5" TO CENTER OF BOX

## TRANSFORMER BOX LOCATION (FOR DOOR BELL)

INSTALL THE TRANSFORMER IN A SMALL  $2\mathrm{ft}$  CLOSET OVER THE DOOR

## DOOR BEL

INSTALL ON LATCH SIDE IN BRICK MOLD AT 42IN FROM FLOOR TO CENTER

## THERMOSTAT WIRE LOCATION

TYPICAL WALL HEIGHT: 60" TO WIRE PENETRATION

## MISC

PHONE/TY/DATA ROUGH IN CONDUIT JACKS TYPICAL WALL HEIGHT: 20" TO TOP OF BOX

FUTURE HYAC CONDUIT LOCATION PREP FOR CAPE / TWO STORY

(2) 2" CONDUIT INSTALLED FROM FLOOR TO CEILING FOR HYAC PREP

FANEL		" & PANEL SCH	IEDULE B
	20 لر	00 AMP	
RANGE	40A 8/3 1		2 WATER HEATER
RANGE	40A 8/3 3	4 25A 10/2	2 MATER HEATER
DRYER	30A 10/3 5	6 20A 12/3	3 WELL
DRYER	30A 10/3 7	8 20A 12/3	MELL
SM. APPL - (KIT.)	20A 12/2 9	10 20A 12/2	SM. APPL - (KIT.)
LAUNDRY	20A 12/211	12 20A 12/2	LAT. NEOD. OT OT
BATH 1 & GFCI RECS.	20A 12/2 13	14 20A 12/2	2 ▲ 1ST LVL HALL SM. DET
BATH 2 & GFCI RECS	20A 12/2 15	16 20A 12/	2 A 2ND LVL HALL/ UTILITY
BATH 3 & GFCI RECS	20A 12/2 17	18 20A 12/2	BEDROOM 1-AFCI
KITCHEN LGTS	20A 12/2 _ 19	20 20A 12/2	BEDROOM 2-AFCI
LIVING ROOM	20A 12/2 21	22 20A 12/2	BEDROOM 3-AFCI
SHMASHER W/ LOCKOUT & GFC	20A 12/2 23	24 20A 12/2	BEDROOM 4-AFCI
HOODFAN	20A 12-2 \( 25	26 20A 12/2	2 UTILITY
		28	
	29	30	
	31	32	_
2ND LEYEL HVAC	20A 12-3 33	34 60A	*H. P. (SITE INSTALLED)
2ND LEVEL HVAC	20A 12-3 35	36 60A	*H. P. (SITE INSTALLED)
A/C (SITE INSTALLED) *	30A 37	38 60A	*H. P. (SITE INSTALLED)
A/C (SITE INSTALLED) *	30A 39	40 60A	*H. P. (SITE INSTALLED)
GFCI - GFCI BREAKER OR CIRCUI	T WITH A GECI	COM	BINATION ARC FAULT
RECEPT- (ONE OR THE OTHER NOT		A	UIT INTERRUPTER
* BREAKER NOT INSTAL	EDATCH	+**SFPAR	ATE PANEL BOXES FOR "A" & "B"

	PANEL SC	CHEDULE "C"
		00 <sub>1</sub> AMP
RANGE RANGE DRYER	40A 8/3 1 40A 8/3 3 30A 10/3 5	2 25A 10/2 WATER HEATER 4 25A 10/2 WATER HEATER 6 20A 12/3 WELL
DRYER SM. APPL - (KIT.) LAUNDRY	30A 10/3 7 20A 12/2 9 20A 12/2 11	8 20A 12/3 MELL 10 20A 12/2 SM. APPL - (KIT.) 12 20A 12/2 EXT. RECS. GFCI
BATH 1 & GFCI RECS.  BATH 2 & GFCI RECS  KITCHEN LGTS	20A 12/2 13 20A 12/2 15 20A 12/2 17	14 20A 12/2 ▲ 2ND LVL HALL/ STAIR 16 20A 12/2 ▲ FOYER/ SMOKE DET. 18 20A 12/2 ▲ BEDROOM 1-AFCI
LIVING ROOM  DISHWASHER WI LOCKOUT & GFC  HOODFAN	20A 12/2 19	20 20A 12/2 BEDROOM 2-AFCI
	25 27	26 \ 28 \ 30 \ \ \ \ \ \ \ \ \ \ \ \ \ \ \ \ \
2ND LEVEL HVAC 2ND LEVEL HVAC	20A 12-3 33 20A 12-3 35	32
A/C (SITE INSTALLED) * A/C (SITE INSTALLED) *	30A 37	38 60A *H. P. (SITE INSTALLED) 40 60A *H. P. (SITE INSTALLED)
GFCI - GFCI BREAKER OR CIRCUI' RECEPT- (ONE OR THE OTHER NOT  ** BREAKER NOT INSTALI	вотн)	COMBINATION ARC FAULT CIRCUIT INTERRUPTER

TOWNHOUSE - LOT #130, #132, #134 4,836 TOTAL SQ. FT. FAUQUIER HABITAT FOR HUMANITY CARDINAL HOMES ®

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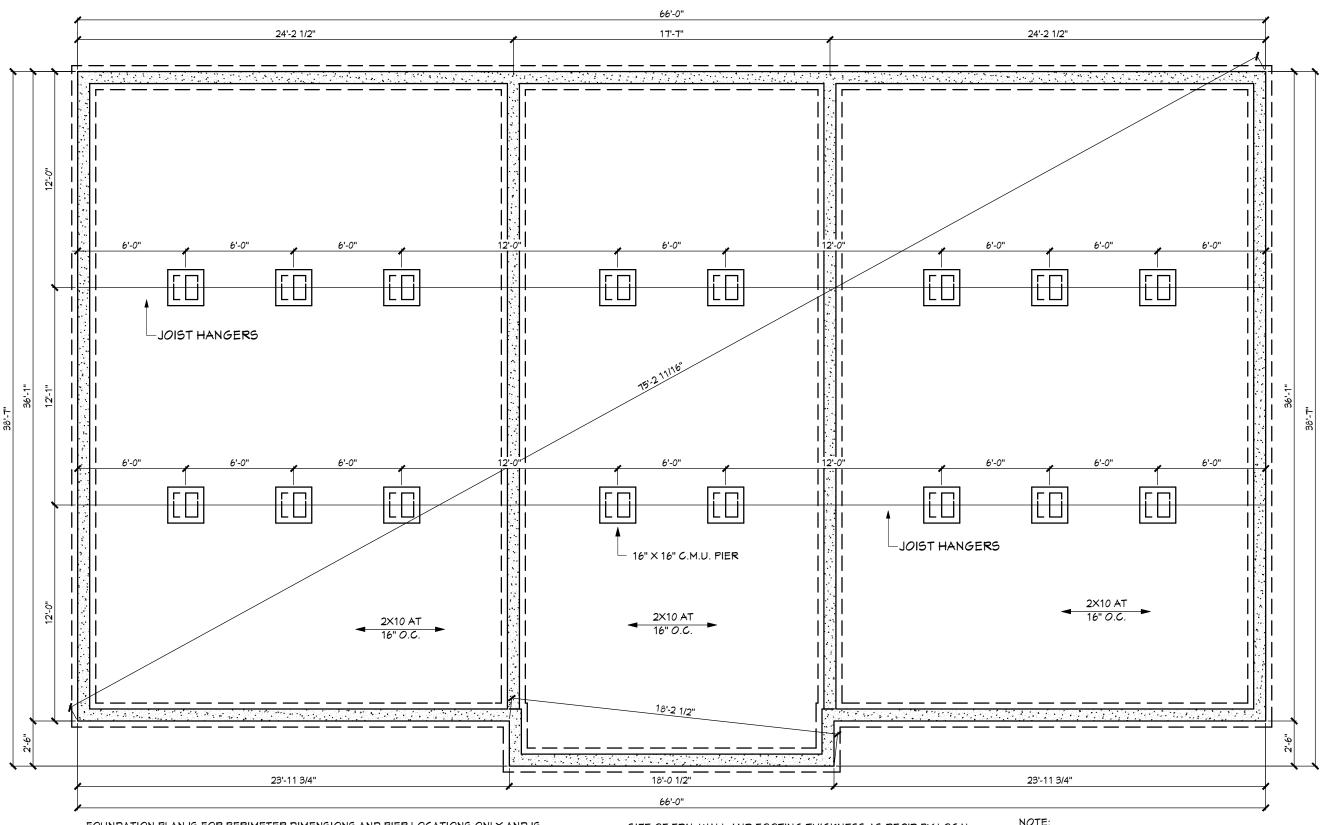
SCALE: 3/16" = 1'-0"

REVISIONS

ELECTRICAL

SHEET:

3.2 OF 6



FOUNDATION PLAN IS FOR PERIMETER DIMENSIONS AND PIER LOCATIONS ONLY AND IS DESIGNED ON INFORMATION SUBMITTED. ANY ALTERATIONS TO THE EXTERIOR DIMENSIONS OR CHANGES TO MATING WALL OPENINGS AFTER THE DESIGN SET OF PLANS MAY IMPACT THIS DESIGN AND WILL REQUIRE A NEW DRAWING. ACTUAL FOUNDATION DESIGN AND INSTALLATION TO BE BY BUILDER ON-SITE SUBJECT TO INSPECTION AND APPROVAL BY BUILDING OFFICIAL BASED ON LOCAL SOIL CONDITIONS.

BUILDER AT SITE TO DETERMINE METHOD OF VENTILATING CRAWLSPACE OR ALTERNATE METHODS IN ACCORDANCE WITH SECTION 1203.4.2 AND BE APPROVED BY LOCAL BUILDING OFFICIAL

SIZE OF FDN. WALL AND FOOTING THICKNESS AS REQ'D BY LOCAL REQUIREMENTS/CONDITIONS-

FTG. SHALL BE BELOW FROST LINE-

ENTIRE FOUNDATION SUBJECT TO INSPECTION AND APPROVAL BY AUTHORITY HAVING JURISDICTION- BY BUILDER ON-SITE-

C.M.U. & FTG. DEPENDS ON BACKFILL REFER TO LOCAL CODES.

TOWNHOUSE - LOT #130, #132, #134 4,836 TOTAL SQ. FT. FAUQUIER HABITAT FOR HUMANITY

**HOMES** ®

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REVISIONS

**FOUNDATION** 

SHEET:

4.0 OF 6

#### **FOUNDATION NOTES:**

1.) THIS FOUNDATION IS BASED UPON THE FOLLOWING LOADING CONDITIONS:

ROOF LIVE LOAD: SEE COVERPAGE

FLOOR LIVE LOAD: 40 P.S.F.
WIND LOADING: SEE COVERPAGE

MINIMUM ALLOWABLE SOIL BEARING: 2,000 P.S.F. (2,500 P.S.F GA)

IF THESE CONDITIONS CANNOT BE VERIFIED (FIELD), THEN THE FOUNDATION MUST BE ADJUSTED BY A REGISTERED ENGINEER OR ARCHITECT IN ACCORDANCE WITH GOOD ENGINEERING PRACTICE.


- 2.) BUILDER MUST CHECK AND CONFIRM ALL DIMENSIONS PRIOR TO COMMENCING CONSTRUCTION.
- 3.) FOUNDATION PLAN IS FOR DIMENSIONS ONLY- FOUNDATION DESIGN AND COMPLETION TO BE BY BUILDER INCLUDING FOOTING DRAINS, VAPOR BARRIER, SILL PLATES, WATER-PROOFING, INSULATION, BACKFILL AND ALL FINISH WORK. ALL WORK MUST COMPLY WITH STATE AND LOCAL CODES AS WELL AS PROFESSIONAL STANDARDS.
- 4.) ALL CONCRETE TO HAVE A MINIMUM COMPRESSIVE STRENGTH (fc) OF 2,500 P.S.I. ALL STEEL TO BE GRADE 40 OR BETTER. STEEL MUST COMPLY WITH ASTM A615.
- 5.) ALL MASONRY UNITS ARE TO BE LAID IN TYPE "M" OR "S" MORTAR. HOLLOW MASONRY PIERS TO BE CAPPED WITH 4" SOLID MASONRY FOR 1 STORY & 8" SOLID MASONRY FOR 2 & 2\ STORIES. SEE APPLICABLE CODES FOR ALTERNATE METHODS.
- 6.) THE CRAWLSPACE MUST BE PROVIDED WITH AN ACCESS PANEL MEASURING  $18^{\circ}$  X 24". IF MECHANICAL EQUIPMENT IS LOCATED IN CAWLSPACE AREA, THE ACCESS TO BE 22" WIDE X 30" HIGH MINIMUM.
- 7.) CRAMLSPACE AREA SHALL BE PROVIDED WITH VENTILATION OPENINGS THROUGH THE FOUNDATION WALL. THE MINIMUM NET AREA OF VENTILATION SHALL BE 1 SQ. FT. FOR EACH 150 SQ. FT. OF UNDER FLOOR SPACE.

THIS NUMBER MAY BE REDUCED DEPENDING ON LOCAL CODE JURISDICTIONS. THE VENTILATION OPENINGS SHALL BE PLACED WITHIN 3 FEET OF EACH CORNER OF THE BUILDING AND MAY BE CORROSION-RESISTANT WIRE MESH WITH THE LEAST DIMENSION BEING 1/8". EXCEPTIONS EXIST THAT MAY REDUCE THE NUMBER OF FOUNDATION VENTS, TYPE OF VENT OR REQUIRE AN APPROVED VAPOR BARRIER IS THE RESPONSIBILITY OF THE BUILDER OR OWNER TO COMPLY WITH LOCAL CODES & REQUIREMENTS.

8.) ALL FOOTINGS SHALL BE SUPPORTED ON UNDISTURBED SOIL OR ENGINEERED FILL. EXTERIOR FOOTINGS SHALL EXTEND BELOW APPLICABLE FROST LINE AND AT LEAST 12" BELOW THE UNDISTURBED SOIL. SEE

APPLICABLE CODE FOR EXCEPTIONS. MINIMUM COMPRESSIVE STRENGTH OF CONCRETE FOR FOOTINGS SHALL BE 2500 PSI AFTER 28 DAYS.

- 9.) FOUNDATION ANCHORAGE PER SECTION R403.1.6
- 10.)FINISH GRADE SHALL FALL AWAY A MINIMUM OF 6 INCHES WITHIN THE FIRST 10 FEET.
- 11.) PROVIDE TERMITE SHIELDS AS REQUIRED BY LOCAL CODE AND SUSCEPTIBLY.
- 12.) INFILTRATION, ALL OPENINGS IN THE EXT. BLDG. ENVELOPE SHALL BE SEALED AGAINST AIR INFILTRATION.

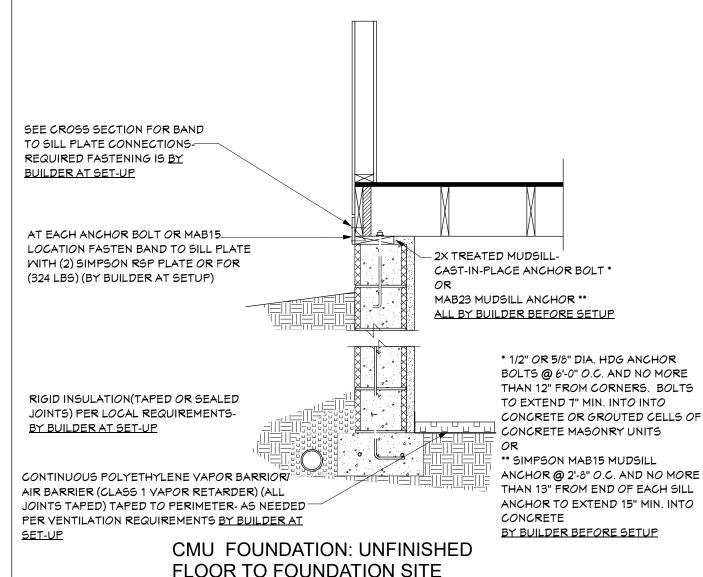

CONNECTIONS USING 1/2 OR 5/8" ANCHOR BOLTS

FOUNDATION DESIGN HAS BEEN EXTRAPOLATED

OR SIMPSON MAB15 MUDSILL ANCHORS-

FROM CHAPTER 4 OF THE IRC-

TOWNHOUSE - LOT #130, #132, #134 4,836 TOTAL SQ. FT. FAUQUIER HABITAT FOR HUMANITY CARDINAL HOMES ®

**PROJECT NO** 

FP. NUMBER

223217

PRINT NO.

DATE

9/15/23

DRAWN BY:

EW

SCALE:


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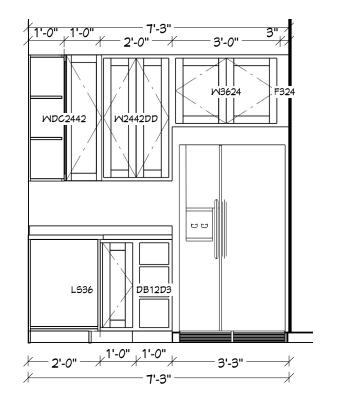
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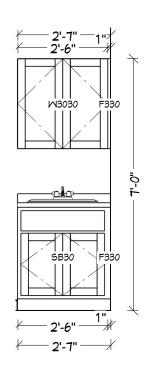
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FOUNDATION

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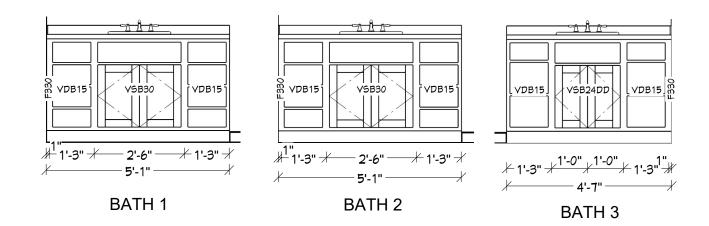






**LAUNDRY** 
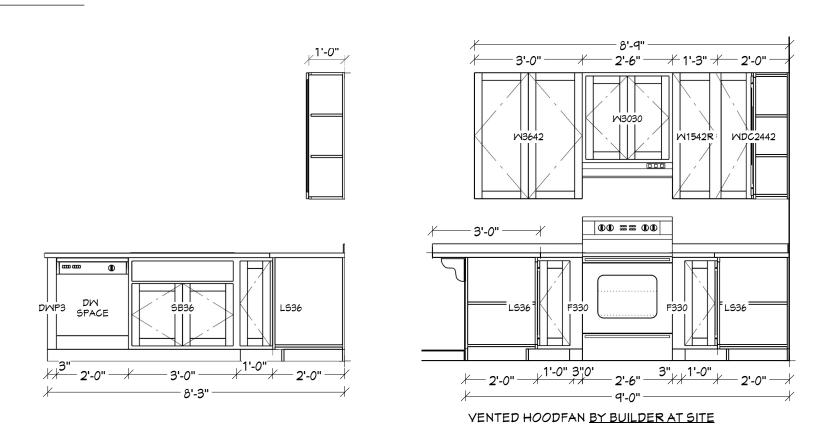
# KITCHEN CABINETS



**MOLF CABINETS MARKED WITH \*\* ARE** SPECIAL ORDER AND REQUIRE A LONGER LEAD TIME

TOEKICKS TO BE USED ON ALL BASE CABINETS

LOT 130

CROWN MOULDING (CCROWN134) ON ALL WALL CABINETS

THESE RENDERINGS ARE AN ARTIST'S DEPICTION ONLY, MAY NOT REFLECT THE ACTUAL FINAL PRODUCT. PLAN UPDATES MAY NOT BE REFLECTED IN RENDERINGS. REFER TO THE CONSTRUCTION DOCUMENTS FOR ADDITIONAL INFORMATION. RENDERINGS SHALL NOT BE USED FOR CONSTRUCTION.

CABINET SCHEDULE LOT	130,132	,134
LABEL	QTY	FLOOR
LS36	5	1
DB12D3	3	1
WSM 1/2"	2	1
F330	9	1
W3030	3	1
SB30	2	2
WDC2442	2	1
W1542L	1	1
W2442DD	2	1
SB36	3	1
DWP3	3	1
P4836	9	1
BAR BRACKET	9	1
W1542R	1	1
VSB24DD	2	1
VDB15	4	1
VSB30	1	1
W1242L	1	1
W3624	3	1
F324	3	1
W3642	3	1
W3030	2	2
F330	9	2
VDB12	2	2
VDB15	8	2
VSB24DD	1	2
VSB30	4	2

TOWNHOUSE - LOT #130, #132, #134 4,836 TOTAL SQ. FT. FAUQUIER HABITAT FOR HUMANITY

**CARDINAL HOMES** ®

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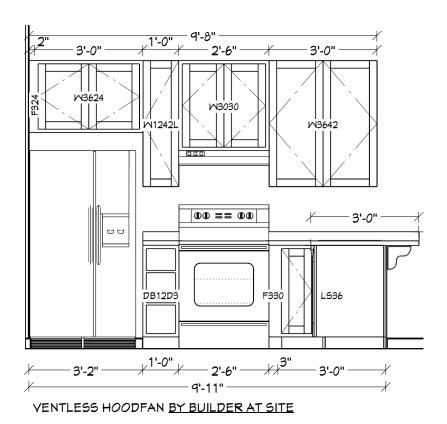
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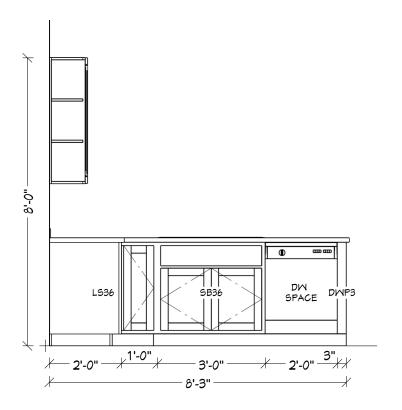
**REVISIONS** 

CABINETS


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**CABINETS** 





KITCHEN CABINETS

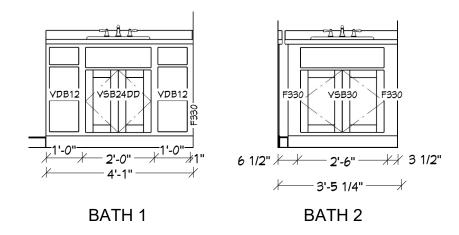

LOT 132

THESE RENDERINGS ARE AN ARTIST'S DEPICTION ONLY, MAY NOT REFLECT THE ACTUAL FINAL PRODUCT. PLAN UPDATES MAY NOT BE REFLECTED IN RENDERINGS. REFER TO THE CONSTRUCTION DOCUMENTS FOR ADDITIONAL INFORMATION. RENDERINGS SHALL NOT BE USED FOR CONSTRUCTION.

**MOLF CABINETS MARKED WITH \*\* ARE** SPECIAL ORDER AND REQUIRE A LONGER LEAD TIME

TOEKICKS TO BE USED ON ALL BASE CABINETS

CROWN MOULDING (CCROWN134) ON ALL WALL CABINETS

TOWNHOUSE - LOT #130, #132, #134 4,836 TOTAL SQ. FT. FAUQUIER HABITAT FOR HUMANITY

HOMES ®

PROJECT NO.

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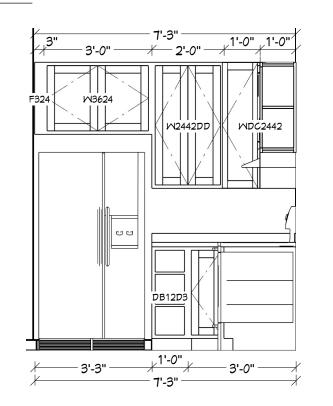
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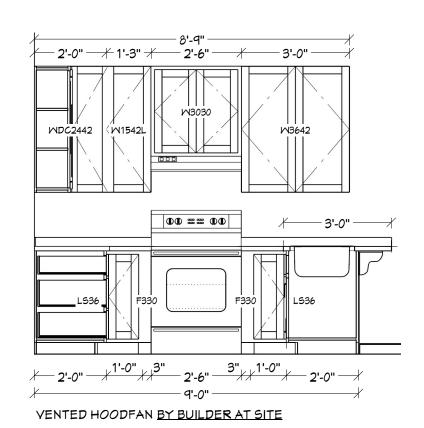
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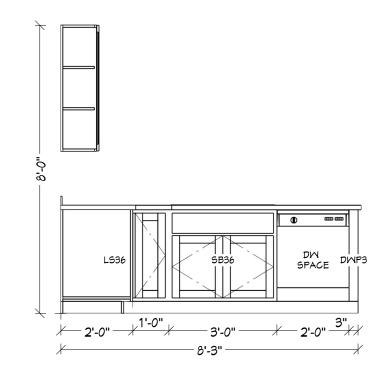
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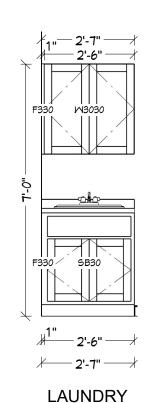
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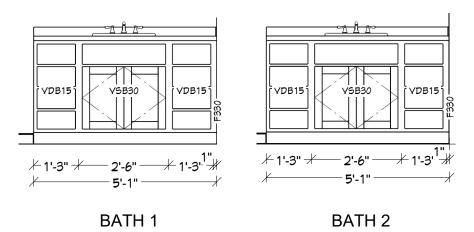









KITCHEN CABINETS



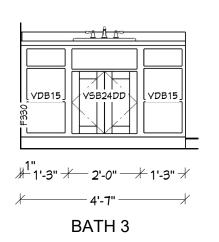

LOT 134

WOLF CABINETS MARKED WITH \*\* ARE
SPECIAL ORDER AND REQUIRE A LONGER LEAD TIME

TOEKICKS TO BE USED ON ALL BASE CABINETS

CROWN MOULDING (CCROWN134) ON ALL WALL CABINETS

TOWNHOUSE - LOT #130, #132, #134 4,836 TOTAL SQ. FT. FAUQUIER HABITAT FOR HUMANITY CARDINAL HOMES ®

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SCALE: 3/8" = 1'-0"

REVISIONS

2024 KITUWAH MANUFACTURING, LLC

CABINETS

SHEET:

CABINETS