## Walton County The Grove

## Change Proposal #28 Bldg C and F Rigid Insulation Add

#### **General Contractor:**

Reeves Young 45 Peachtree Industrial Boulevard N.W. Sugar Hill, GA 30518 770-271-1159

February 19, 2025



Walton County, GA The Grove, a Walton County Parks & Recreation Facility

Attn: John Ward, County Manager Jeff Prine, Capital Project Manager – Ascension Program Management

#### Change Proposal #28 – Building C & F Rigid Insulation Add

The proposal below is for revisions made per the updated VE conformed set due to permitting comments resulting in the addition of rigid insulation at both the Softball Concessions (Building C) and the Amphitheater (Building F).

Per the base bid documents, rigid insulation was to be carried at only conditioned spaces. For building C, the only room that was considered conditioned was the kitchen. For building F, all rooms except the storage room were considered conditioned. The cost below is for the entirety of building C and F to receive rigid insulation at the exterior walls.

Description	Qty	Unit	Unit Price	Total
Building C Rigid Insulation Add	1	LS	\$6,462.50	\$6,462.50
Building F Rigid Insulation Add	1	LS	\$1,936.00	\$1,936.00
Total Subcontractor Cost	1	LS		\$8,398.50
Payment & Performance Bond	0.597	%	\$50.14	\$50.14
General Liability Insurance	0.811%	% \$112.96		\$112.96
Builders Risk Insurance	0.174%	%	\$24.24	\$24.24
RY Overhead and Profit	10	%	\$1,392.82	\$1,392.82
TOTAL				\$9,371.21

#### See Bulletin 6 and RFI 176 response for additional information

If you have any questions or require any additional information, please do not hesitate to contact us at (470) 725-0022 or via email at iarnold@reevesyoung.com

Sincerely, Reeves Young, LLC Isaiah Arnold

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Project Manager

45 Peachtree Industrial Blvd, Suite 200 770.271.1159 Sugar Hill, GA 30518 reevesyoung.com

<u>Approval</u>			
Lose Design (Architect of Record)	Signature: RAR	Date: _	2/25/25
Ascension PM (Capital Project Manager)	Signature: Thomas J. Prine	Date: _	02.25.2025
Walton County	Signature:	Date: _	
Reeves Young	Signature: dsull cm	Date: _	02/19/25

Performance Construction Services, LLC 499 Tuggle Greer Drive Buford, GA 30518 O. 770-217-7545 F. 770-217-7357

#### CHANGE ORDER REQUEST #12

Date:February 6, 2025Job Name:The Grove ParkJob Location:1089 Highway 81, GA 30052

#### We propose the following changes in scope of work:

#### • Building - C

- Additional materials:
  - + \$120 (5) tubes glue @\$24
  - + \$3,805 (50) Sheets 1-1/2" Rigid Insulation @\$76.10
- o <u>Additional Labor</u>:
  - + \$1,350 (1) Day for (3) Men
  - + \$600 (1) Day on-site supervisor

\$ 3,925.00 Additional Materials
 <u>\$ 1,950.00 Additional Labor</u>
 \$5,875.00 Subtotal
 <u>\$ 587.50 (10% ) Mark-up</u>
 \$6,462.50 TOTAL ADDED COST - Building C

#### • Building - F

- o Additional materials:
  - + \$24 (1) tubes glue @\$24
  - + \$761 (10) Sheets 1-1/2" Rigid Insulation @\$76.10
- o Additional Labor:
  - + \$675 (1/2) Day for (3) Men
  - + \$300 (1/2) Day on-site supervisor
- \$ 785.00 Additional Materials
- \$ 975.00 Additional Labor
- \$1,760.00 Subtotal
- \$ 176.00 (10% ) Mark-up

\$1,936.00 TOTAL ADDED COST - Building F

We propose the above changes in the scope of work of the added sum of: Eight Thousand Three Hundred Ninety-Eight Dollars and Fifty Cents (\$8,398.50).

# BUILDING C

## PLAN GENERAL NOTES

1. SEE ENLARGED PLAN AND DETAILS FOR ADDITIONAL INFORMATION.

2. ALL FLOORS TO SLOPE AT 1/8" PER FOOT, UNO, COORDINATE W/PLUMBING & STRUCTURAL.

3. SEE NOTED PLAN FOR SIGNAGE.

4. COORDINATE ALL CABINET WORK AND OFCI. ITEMS W/ OWNER.

5. ALL ELECTRIC AND PLUMBING DEVICES ON EXT. WALLS TO BE "CENTERED" ON CMU VERTICALLY AND HORIZONTALLY (W.P. OUTLETS, HOSE BIBBS, ETC). INSTALL SMOOTH FACE BLOCK AT LOCATIONS OF EXT. DEVICES AS REQUIRED FOR A LEVELED INSTALLATION OF DEVICE.

6. SEAL ALL PENETRATIONS OF CONDUIT, MECHANICAL DUCT WORK, PIPING, IN ALL SUBSTRATES, INTERIOR AND EXTERIOR WALLS, CEILINGS FLOORS

7. ARCHITECTURAL BUILDING FFE. LISTED AS 0'-0", COORDINATE ACTUAL W/CIVIL.

8. PROVIDE MASONRY CONTROL JOINTS AS REQUIRED. COORDINATE ANY EXPANSION/CONTROL/CONSTRUCTION JOINTS. VERIFY W/ ARCH. AND STRUC. FOR ANY DISCREPANCIES THAT OCCUR DURING THE CONSTRUCTION PHASE.

9. SEALANT AT EXPANSION JOINT TO MATCH ADJACENT WALL COLOR. 10. ALL NEW MASONRY JOINTS TO BE CONCAVED TOOLED.

11. ALL DOWN SPOUTS TO CONNECT TO UNDERGROUND PIPING UNLESS OTHERWISE NOTED, COORDINATE W/ CIVIL AS REQUIRED.

12. ALL EXPOSED STEEL TO BE SHOP PRIMED AND FIELD PAINTED.

13. INSTALL NECESSARY BLOCKING BEHIND DESIGNATED LOCATION OF SIGNAGE.

14. PROVIDE HOSE-BIBBS WITH LOCKABLE BOX, PROVIDE FREEZE-PROOF TYPE FOR EXTERIOR LOCATION, SEE PLUMBING.

15. CAULK ALL DOOR & WINDOW FRAMES AT THE JOINT BETWEEN THE FRAME & THE ADJACENT SUBSTRATE.

16. CAULK ALL JOINTS BETWEEN FIXED CABINET WORK, PLUMBING FIXTURES, & BACKSPLASH TO WALL TRANSITION JOINT.

17. COORDINATE BUILDING SITE ORIENTATION/LAYOUT WITH CIVIL

## ROOM FINISH SCHEDULE

- 18. FOR CONCRETE PAVING SEE SITE/CIVIL
- 19. SEE SITE DRAWINGS FOR ALL EXT. SLAB JOINT DETAILS.
- 20. SEE STRUCTURE FOR ALL FOOTING & SLAB REQUIREMENTS.

21. PROVIDE AND INSTALL KNOXBOX AT BUILDING ENTRANCE AS REQUIRED PER LOCAL CODE OFFICIAL DIRECTIONS AND REQUIREMENTS. MODEL OF KNOXBOX. TO BE APPROVED BY LOCAL CODE OFFICIALS. KNOXBOX TO BE MODEL 3200 - 10 KEY CAPACITY - COLOR BLACK. VERIFY INSTALLATION LOCATION W/ ARCH. RECESSED MOUNTED ON BUILDING. - PROVIDE SMOOTH FACE BLOCK. BEHIND KNOXBOX AS REQUIRED TO MATCH ADJACENT BUILDING BLOCK.

22. PROVIDE ROUNDED CORNER ON ALL EXPOSED CMU CORNERS, INCLUDING BUT NOT LIMITED TO DOOR JAMBS AND OTHER OPENINGS.

23. SEE SHEET A0.02C FOR RESTROOM ACCESSORIES, GRAB BAR SIZES AND MOUNTING HEIGHTS & PLUMBING FIXTURES LEGEND. SEE PLUMBING FOR FIXTURE SPEC.

24. GENERAL CONTRACTOR TO PROVIDE COMBINED RE-BAR / CONDUIT/ PLUMBING PIPE LAYOUT SUBMITTAL FOR COORDINATION PRIOR TO INSTALLATION OF ANY OF THESE ITEMS.

25. SEE SHEET A4 SERIES FOR WALL SECTIONS & DETAILS.


26. SEE SHEET A6 SERIES FOR RCP.


27. SEE SHEET A7 SERIES FOR ROOF PLANS.


28. SEE SHEET A8 SERIES FOR DOOR AND WINDOW SCHEDULE & DETAILS.

30. SEE SHEET A9 SERIES FOR ARCHITECTURAL WOODWORK AND FINISH LEGEND

C01 MEN'S R C02 WOMEN'S C03 CONCES										1				20
C02 WOMEN'S C03 CONCES	DOM NAME FLOOR	NORTH EAST	WALLS SOUTH	WEST	WALL BASE	CEILING FINISH	NOTES					> - +		
C03 CONCES	RESTROOM EP-1 S RESTROOM EP-1	PNT-3 PNT-5 PNT-3 PNT-3	PNT-3 PNT-3	PNT-3 PNT-2		PLW-PNT 7 PLW-PNT 7				4' - 0"			A4	
	SION EP-1	PNT-3 PNT-3	PNT-3	PNT-3	EP	PLW-PNT 7								
C04 PANTRY C05 UMPIRE	EP-1 SC-1	PNT-3         PNT-3           PNT-3         PNT-3	PNT-3 PNT-3	PNT-3 PNT-3	RB-1	PLW-PNT 7 PLW-PNT 7								
C06 ELECTRI C07 MECHAN		PNT-3         PNT-3           PNT-3         PNT-3	PNT-3 PNT-3	PNT-3 PNT-3		PLW-PNT 7 PLW-PNT 7			A3.30C					09
C08 MECHAN C09 STORAG	IICAL YARD SC-2 E SC-1	 PNT-3 PNT-3	- PNT-3	- PNT-3	- RB-1	PLW-PNT 7			•	4' - 0"		A3 (		21
C10 CHASE	SC-1	PNT-3 PNT-3	PNT-3	PNT-3	RB-1	PLW-PNT 7		A3.10C 1						
	ATERIAL	PNT-3 PNT-3	-	PNT-3	L MATER									
_	ESCRIPTION			FINISH	DESCR						1	(C10)	NOT	
S SC-1 SE/	OXY FLOORING ALED CONCRETE SLAB - SM			B S S S S S S S S S S S S S S S S S S S		COVED EPOXY	BASE							
	ALED CONCRETE SLAB - BF	ROOM FINISH, COORDINA										Ż		FD 6
CMU CO	NCRETE MASONRY UNIT -	PAINT COLOR NOTED		DI PLW- CEIFING DI PLW- DNT 7	PLYWOOI	D, PNT -7 COLO	3		·			(24)		
				B PNT 7									(WH) 9	NO1
SIGNAC	E SCHEDU	JLE												
•	r Number Room Number	Room Name	CHARACTER LIN		ACTER LINE 2		NOTES						<u>. / . / . / . / . / . / . / .</u>	
		IEN'S RESTROOM	MEN'S WOMEN'S		ESTROOM ESTROOM	1,2,3,4,5				.0	NFWH+			18' - 0"
		ONCESSION ANTRY	CONCESSION PANTRY			1,2,3,5 1,2,3,5				4	(C09)	$\geq$		
C05	C05 C05 L	IMPIRE	UMPIRE			1,2,3,5						4		
C07	C07 C07 N	IECTRICAL	ELECTRICAL MECHANICAL			1,2,3,5 1,2,3,5					(C09)			
		TORAGE	MECHANICAL STORAGE		YARD	1,2,3,5 1,2,3,5			:	+ + +				
	C10 C10 C	CHASE	CHASE			1,2,3,5			į					
NOTES:	DLID BLOCKING BEHIND DE													-
2. INSTALL SIG	INAGE AT WALL BESIDE DC	OR AT LATCH SIDE FOR	SINGLE DOOR,											
3. SIGNAGE MU	UST COMPLY WITH ALL ADA ABOVE FINISH FLOOR (SEE	A REGULATIONS INCLUD	ING BUT NOT LIM	ITED TO:										
3.2. CHARAC 3.3. PICTOGE	TERS		_ ,											
3.4. BRAILLE 3.5. FINISH													$\times \times \times \times \times \times$	× × × × × × ×
4.1. MAN FIG	NIVERSAL PICTOGRAM FIGU GURE AT MEN'S RESTROOM	IS								<b>\</b>				
	FIGURE AT WOMEN'S RES D WOMAN FIGURE AT FAMI	LY / UNISEX RESTROOM	S									5		12
	CHAIR / HANDICAP FIGURE . R SYMBOL AT ALL RESTRO												L	
4.4. WHEELC 4.5. SHOWEF	L MANUFACTURER DRAWI													
4.4. WHEELC 4.5. SHOWER 5. PROVIDE AL	L MANUFACTURER DRAWI		ION TO INSTALL.								 			
4.4. WHEELC 4.5. SHOWER 5. PROVIDE AL COO SIGNAGE	L MANUFACTURER DRAWI		ION TO INSTALL.								 		·	
4.4. WHEELC 4.5. SHOWER 5. PROVIDE AL COO SIGNAGE SYMBOL			ION TO INSTALL.											
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4.4. WHEELC 4.5. SHOWER 5. PROVIDE AL SIGNAGE SYMBOL				WALL CONTR	OL JOINT - SEE	E STRUCTURE								
4.4. WHEELC 4.5. SHOWEF 5. PROVIDE AL SIGNAGE SYMBOL PLAN K	EYNOTES	1	0 MASONRY			E STRUCTURE								
4.4. WHEELC 4.5. SHOWER 5. PROVIDE AL SIGNAGE SYMBOL PLAN K	EYNOTES TLINE ABOVE, TYP.	IISH - SEE CIVIL	0 MASONRY 1 KNOX BOX					PARTITIC	N TYPES					
4.4. WHEELC 4.5. SHOWER 5. PROVIDE AL SIGNAGE SYMBOL PLAN K 1 ROOF OUT 2 SEALED CC 3 SEALED CC 5X5 PRE-FI	EYNOTES "LINE ABOVE, TYP. ONCRETE SLAB BROOM FIN ONCRETE SLAB IN. ALUM GUTTER & 4X4 DC	IISH - SEE CIVIL 1	0 MASONRY 1 KNOX BOX 2 LETTER BU	I, VERIFY LOC	ATION W/ BUILI			PARTITIC Type symbol			WALL THK.		FIRE RATING	REMARKS
4.4. WHEELC 4.5. SHOWER 5. PROVIDE AL SIGNAGE SYMBOL PLAN K 1 ROOF OUT 2 SEALED CC 3 SEALED CC 4 SX5 PRE-FI SYSTEM, T WATER SY	EYNOTES TLINE ABOVE, TYP. ONCRETE SLAB BROOM FIN ONCRETE SLAB IN. ALUM GUTTER & 4X4 DC TYP. SEE CIVIL FOR UNDER STEM CONNECTION	IISH - SEE CIVIL 1 WNSPOUT GROUND STORM 1	0 MASONRY 1 KNOX BOX 2 LETTER BU 3 22" X 36" AT	I, VERIFY LOC/ IILDING SIGN	ATION W/ BUILI			TYPE SYMBOL	ASSEMBLY	· · · · · · · · · · · · · · · · · · ·				REMARKS
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4.4. WHEELC 4.5. SHOWER 5. PROVIDE AL COO SIGNAGE SYMBOL PLAN K 1 ROOF OUT 2 SEALED CO 3 SEALED CO 3 SEALED CO 4 SYSTEM, T WATER SY 5 PRE-FINISH 6 FLOOR DR.	EYNOTES TLINE ABOVE, TYP. ONCRETE SLAB BROOM FIN ONCRETE SLAB IN. ALUM GUTTER & 4X4 DC YP. SEE CIVIL FOR UNDER STEM CONNECTION HED DOWNSPOUT METAL C AIN, TYP. SEE PLUMBING	IISH - SEE CIVIL 1 WNSPOUT GROUND STORM 1 COVER 1	0 MASONRY 1 KNOX BOX 2 LETTER BU 3 22" X 36" AT 4 PROVIDE 4 5 MASONRY	, VERIFY LOC/ IILDING SIGN TTIC ACCESS I " CMU AS REC CONTROL JOI	ATION W/ BUILI	DING OFFICIALS ESSED HAND D		TYPE SYMBOL	ASSEMBLY 8" CMU 8" CMU W/ 1 1/2" Z ME FURRING, 1 1/2" RIGID	TAL INSUL.	7-5/8" 9-3/4"			PROVIDE WOO FRAMED WALL
4.4. WHEELC 4.5. SHOWEF 5. PROVIDE AL COO SIGNAGE SYMBOL <b>PLAN K</b> 1 ROOF OUT 2 SEALED CO 3 SEALED CO 3 SEALED CO 4 SYSTEM, T WATER SY 5 PRE-FINISH 6 FLOOR DR 7 ROLL UP S	EYNOTES TLINE ABOVE, TYP. ONCRETE SLAB BROOM FIN ONCRETE SLAB IN. ALUM GUTTER & 4X4 DC YP. SEE CIVIL FOR UNDER STEM CONNECTION HED DOWNSPOUT METAL C AIN, TYP. SEE PLUMBING ECURITY DOOR - SEE DOO	IISH - SEE CIVIL 1 WNSPOUT GROUND STORM 1 COVER 1 R SCHEDULE 1	<ol> <li>MASONRY</li> <li>KNOX BOX</li> <li>LETTER BU</li> <li>22" X 36" AT</li> <li>PROVIDE 4</li> <li>MASONRY</li> <li>MECHANIC ABOVE CEI</li> </ol>	, VERIFY LOC/ IILDING SIGN ITIC ACCESS I " CMU AS REC CONTROL JOI AL EQUIPMEN LING, SEE STF	ATION W/ BUILI A3 PANEL ABOVE RUIRED AT REC NT, TYP. SEE S T PLATFORM A RUCTURAL	DING OFFICIALS ESSED HAND D		TYPE     SYMBOL       N01     Image: Constraint of the second se	<b>ASSEMBLY</b> 8" CMU 8" CMU W/ 1 1/2" Z ME	TAL INSUL.	7-5/8"	9'-4" AFF.	NONE	PROVIDE WOO FRAMED WALL PLYWOOD SHE ON UNCONDITION
<ul> <li>4.4. WHEELC</li> <li>4.5. SHOWER</li> <li>5. PROVIDE AL</li> <li>COO</li> <li>SIGNAGE</li> <li>SYMBOL</li> </ul> PLAN K 1 ROOF OUT 2 SEALED CC 3 SEALED CC 3 SEALED CC 3 SEALED CC 4 SYSTEM, T 5 PRE-FINISH 6 FLOOR DR. 7 ROLL UP S 8 MECHANIC/	EYNOTES TLINE ABOVE, TYP. ONCRETE SLAB BROOM FIN ONCRETE SLAB IN. ALUM GUTTER & 4X4 DC YP. SEE CIVIL FOR UNDER STEM CONNECTION HED DOWNSPOUT METAL C AIN, TYP. SEE PLUMBING	ISH - SEE CIVIL 1 WNSPOUT GROUND STORM 1 COVER 1 R SCHEDULE 1	<ol> <li>MASONRY</li> <li>KNOX BOX</li> <li>LETTER BU</li> <li>22" X 36" AT</li> <li>PROVIDE 4</li> <li>MASONRY</li> <li>MECHANIC ABOVE CEI</li> </ol>	, VERIFY LOC/ IILDING SIGN ITIC ACCESS I " CMU AS REC CONTROL JOI AL EQUIPMEN	ATION W/ BUILI A3 PANEL ABOVE RUIRED AT REC NT, TYP. SEE S T PLATFORM A RUCTURAL	DING OFFICIALS EESSED HAND D STR		TYPE         SYMBOL           N01	ASSEMBLY 8" CMU 8" CMU W/ 1 1/2" Z ME FURRING, 1 1/2" RIGID	TAL INSUL.	7-5/8" 9-3/4"	9'-4" AFF.	NONE	PROVIDE WOO FRAMED WALL PLYWOOD SHE

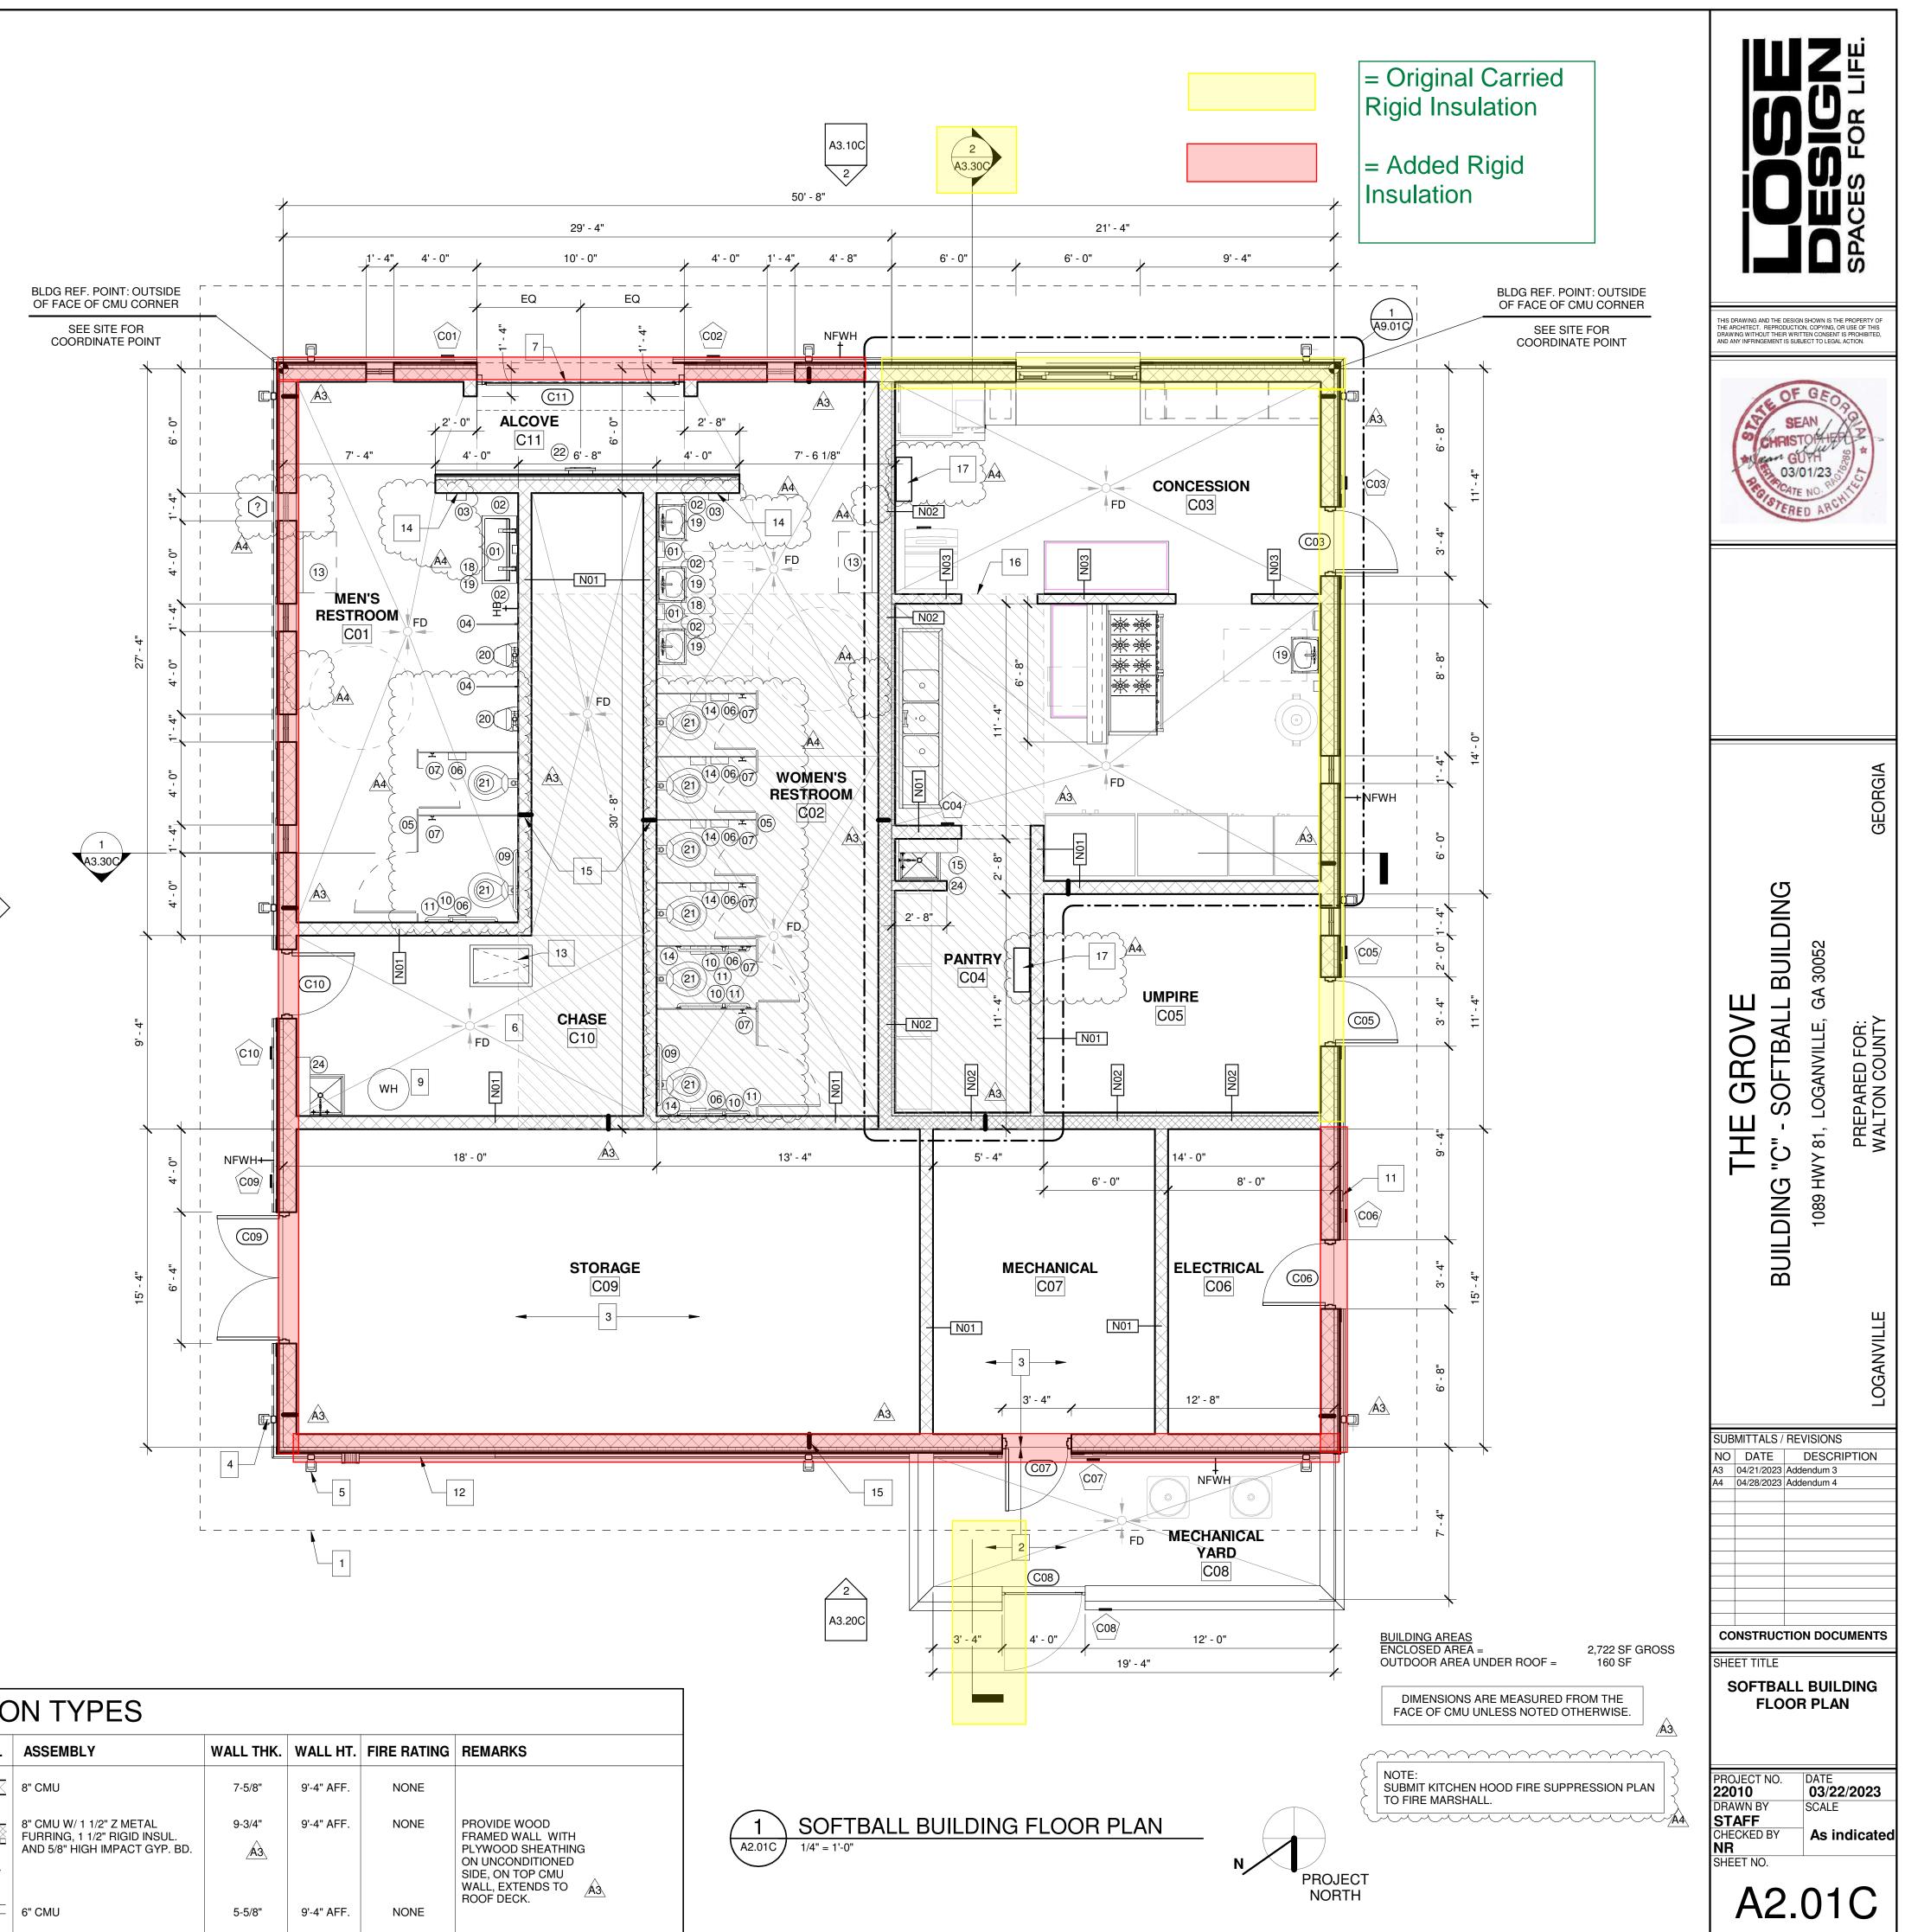

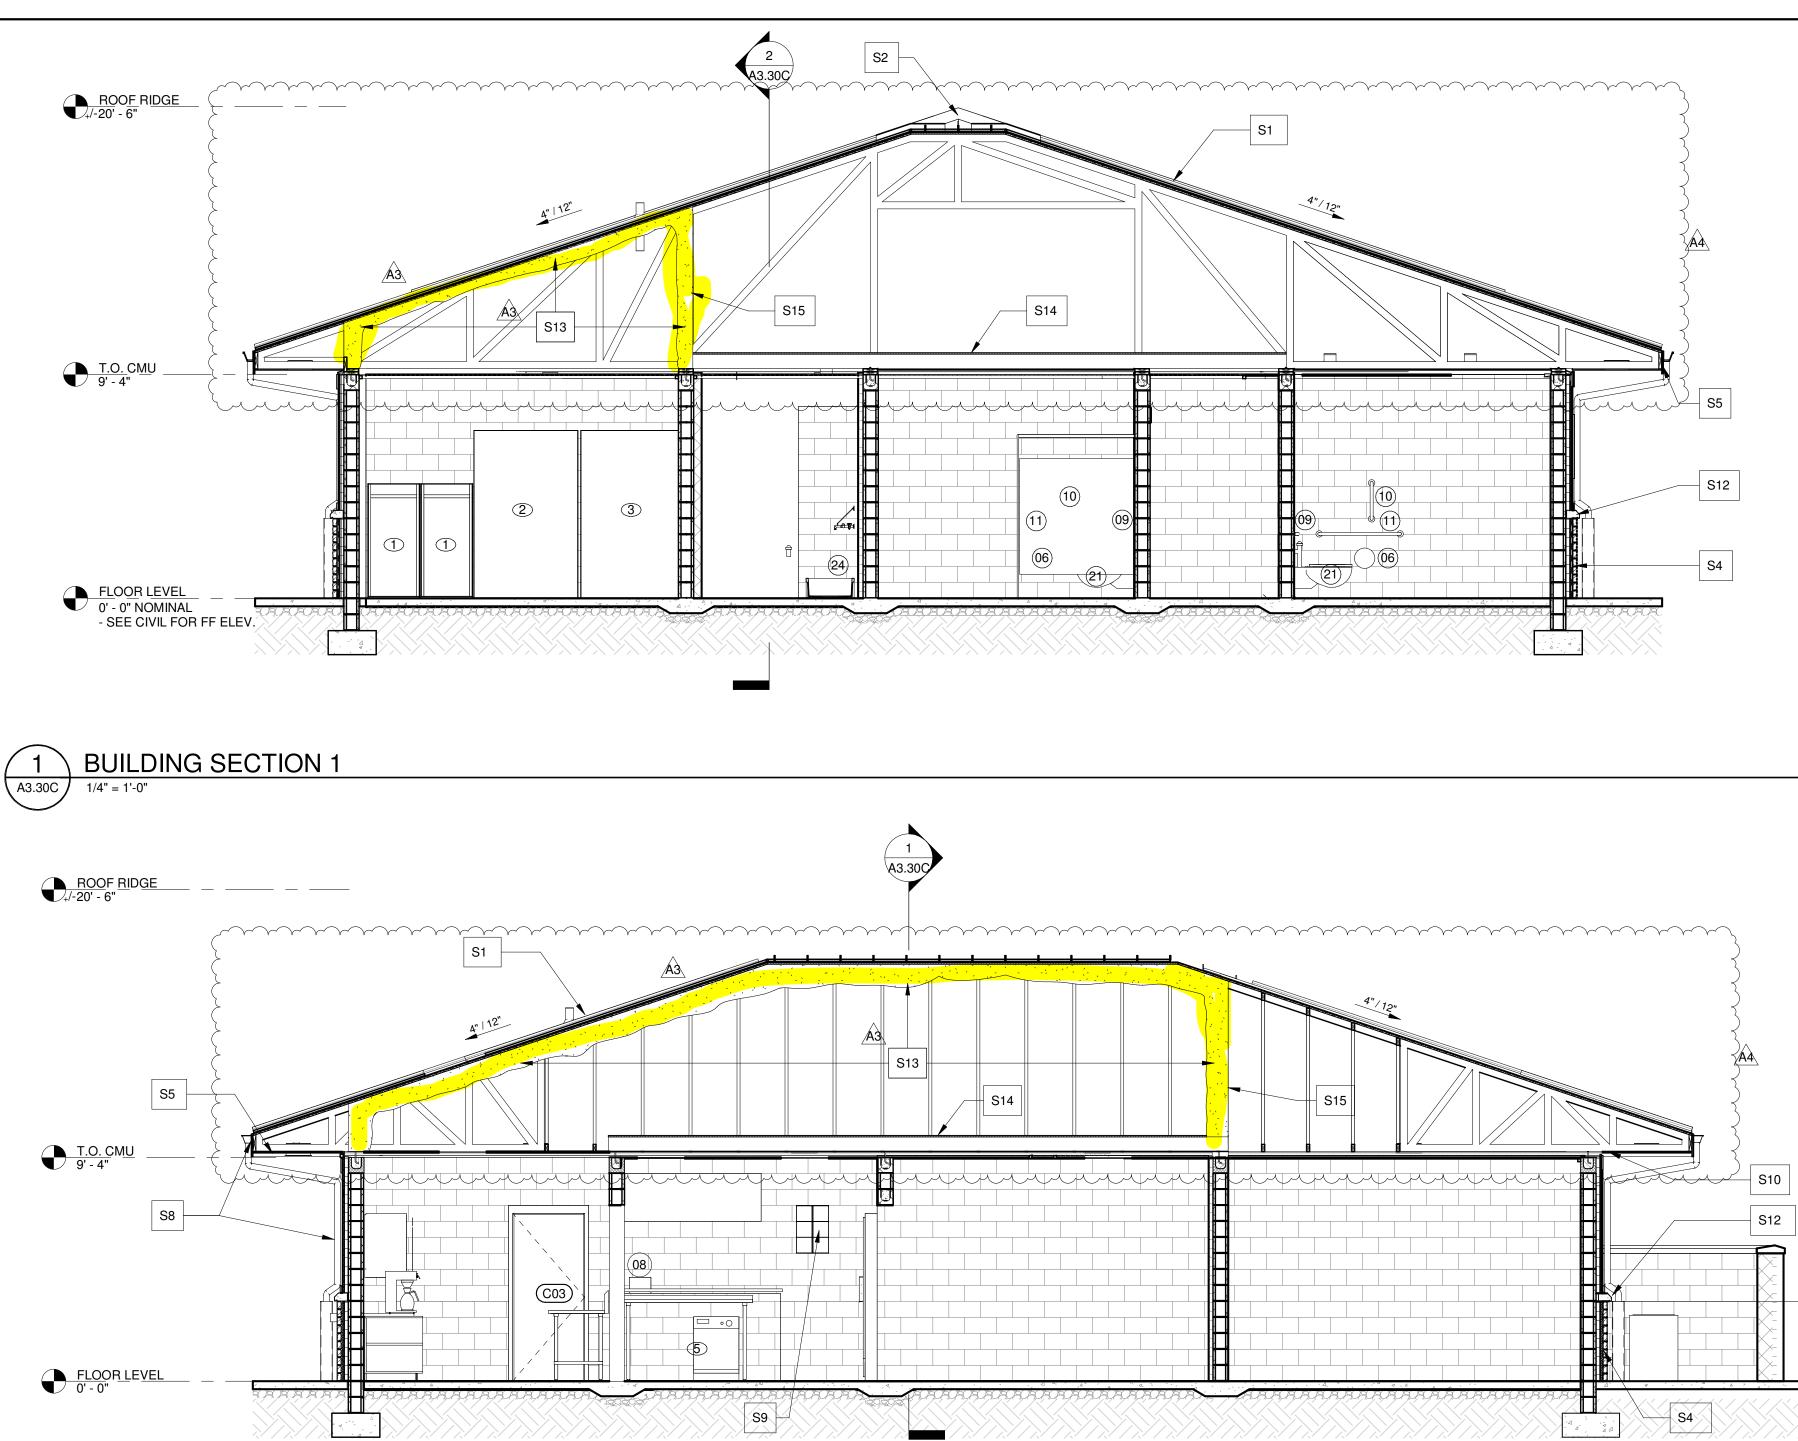

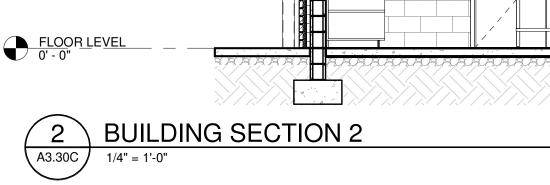

GE	ENERAL NOTES	SEC	TION KEYNOTES	
1.	ARCHITECTURAL BUILDING FFE. LISTED AS 0'-0", COORDINATE ACTUAL W/ CIVIL	S1	PRE-FINISHED METAL ROOF	S10
2.	ELEVATION MARKS TO BE VERIFIED IN FIELD WITH MATERIAL AND ASSEMBLY DIMENSIONS.	S2	RIDGE VENT SYSTEM W/ PRE-FINISHED METAL RIDGE CAP - SEE MECH.	S11
3. 4.	DIMENSIONS ARE FROM FINISH FLOOR. (U.N.O.) SEE STRUCTURE FOR ALL FOOTING & SLAB REQUIREMENTS.	S3	DECORATIVE WOOD TRUSS AT GABLE	S12
5. 6.	SEE SHEET A4 SERIES FOR WALL SECTIONS & DETAILS. SEE SHEET A6 SERIES FOR RCP.	S4	MANUFACTURED ADHERED STONE VENEER SYSTEM, TYP.	
7. 8.	SEE SHEET A7 SERIES FOR ROOF PLANS. SEE SHEET A8 SERIES FOR DOOR SCHEDULE & DETAILS.			S13
9. 10.	SEE SHEET A8 SERIES FOR WINDOW SCHEDULE & DETAILS. SEE SHEET A9 SERIES FOR ARCHITECTURAL WOODWORK AND	S5	1X FIBER CEMENT FASCIA BD. TYP., PAINTED	S14
	FINISH LEGEND	S6	STEEL COLUMN, TYP., SEE STRUCTURAL	S15
		S7	OUTDOOR SPOTLIGHT, TYP., SEE ELEC.	
		S8	5X5 PRE-FIN. ALUM GUTTER & 4X4 DOWNSPOUT SYSTEM, TYP. SEE CIVIL FOR UNDERGROUND STORM WATER SYSTEM CONNECTION	
		S9	(6) 8X8X4 (FROSTED) GLASS BLOCK, TYP.	

EXTERIOR SOFFIT SYSTEM

BOARD AND BATTEN CEILING SYSTEM

CAST STONE WAINSCOT CAP W/ CONT. DRIP EDGE


PROVIDE SPRAY INSULATION AT UNDERSIDE OF ROOF DECK AT CONDITION AREAS.

MECHANICAL EQUIPMENT PLATFORM, VERIFY CLEARANCES WITH MECHANICAL. SEE STRUCTURAL


 $\underbrace{\mathsf{A}}$ PROVIDE SHEATHING TO OUTSIDE OF ADDITIONAL WOOD TRUSS OR WOOD FRAME, LOCATE ON CENTER OF CMU WALL


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NOTE: NO ATTIC VENTILATION WHERE RAFTERS ARE INSULATED WITH SPRAY INSULATION.	GEORGIA
	THE GROVE         BUILDING "C" - SOFTBALL BUILDING         1089 HWY 81, LOGANVILLE, GA 30052         LOGANVILLE         REPARED FOR:         WALTON COUNTY
	SUBMITTALS / REVISIONS         NO       DATE         DESCRIPTION         A3       04/21/2023         Addendum 3         A4       04/28/2023
	CONSTRUCTION DOCUMENTS SHEET TITLE SOFTBALL BUILDING - BUILDING SECTIONS
	PROJECT NO. 22010 DRAWN BY STAFF CHECKED BY NR SHEET NO. DATE 03/22/2023 SCALE As indicated NR SHEET NO.

A 4 4 4

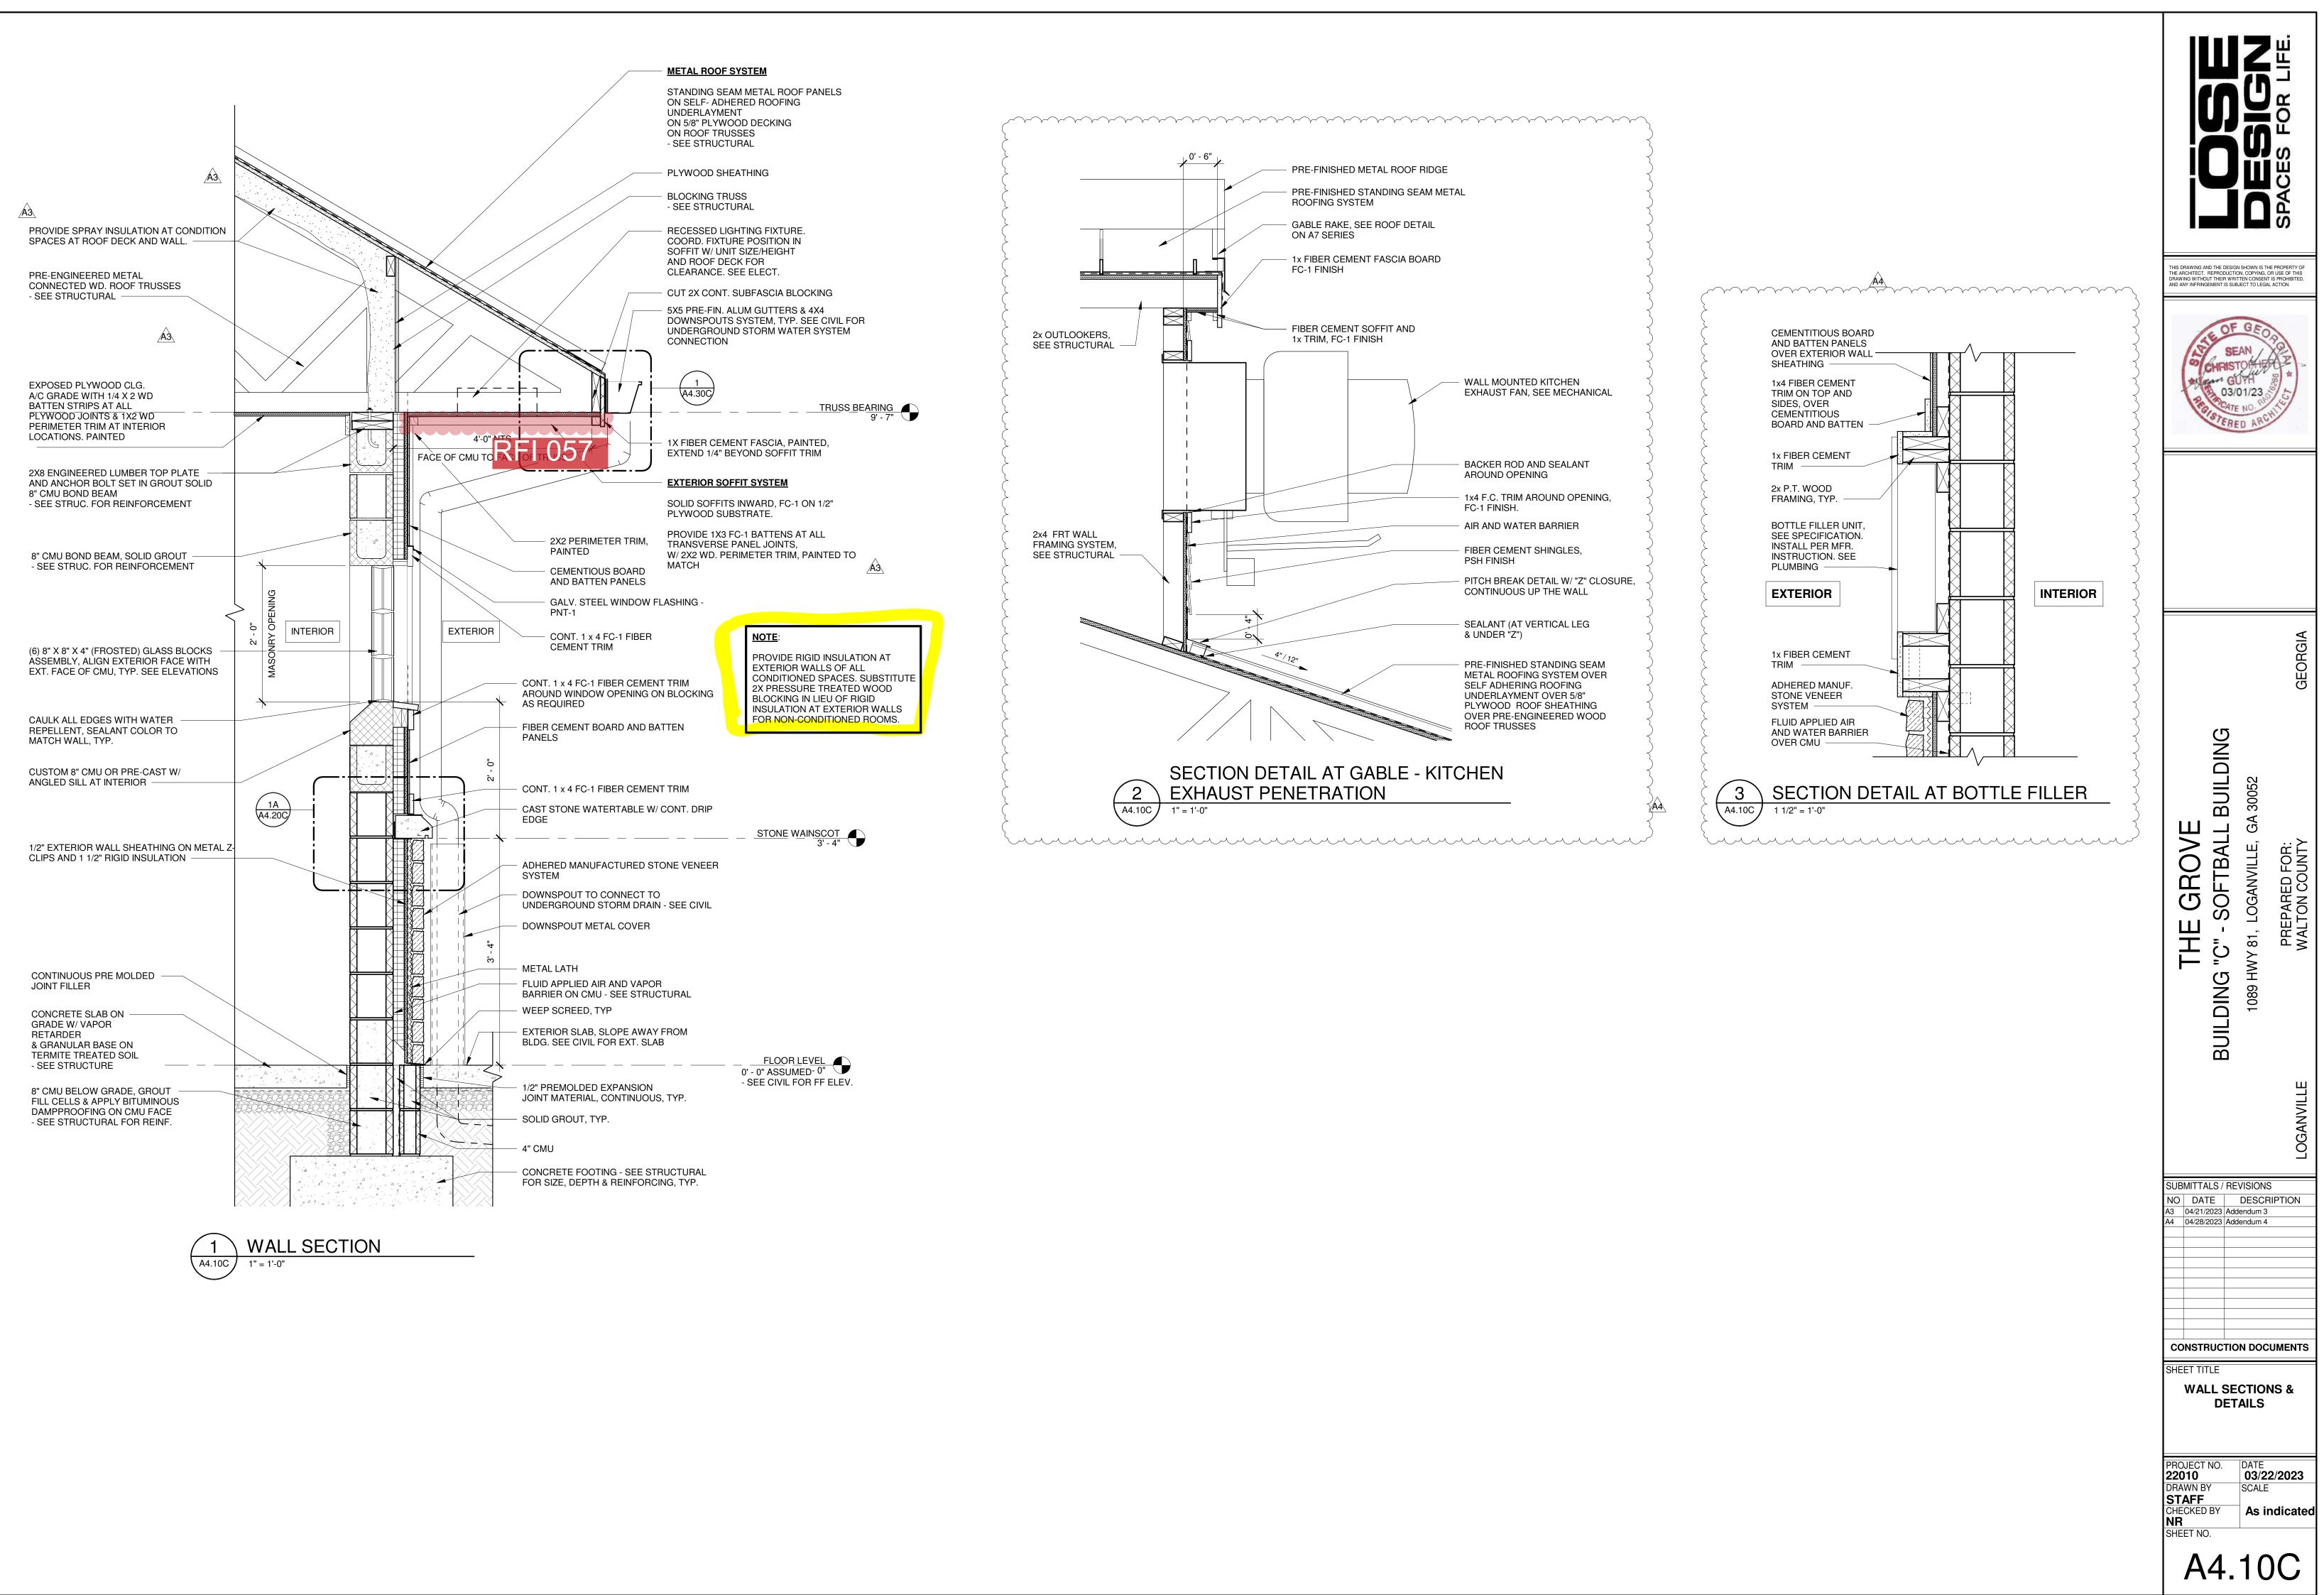




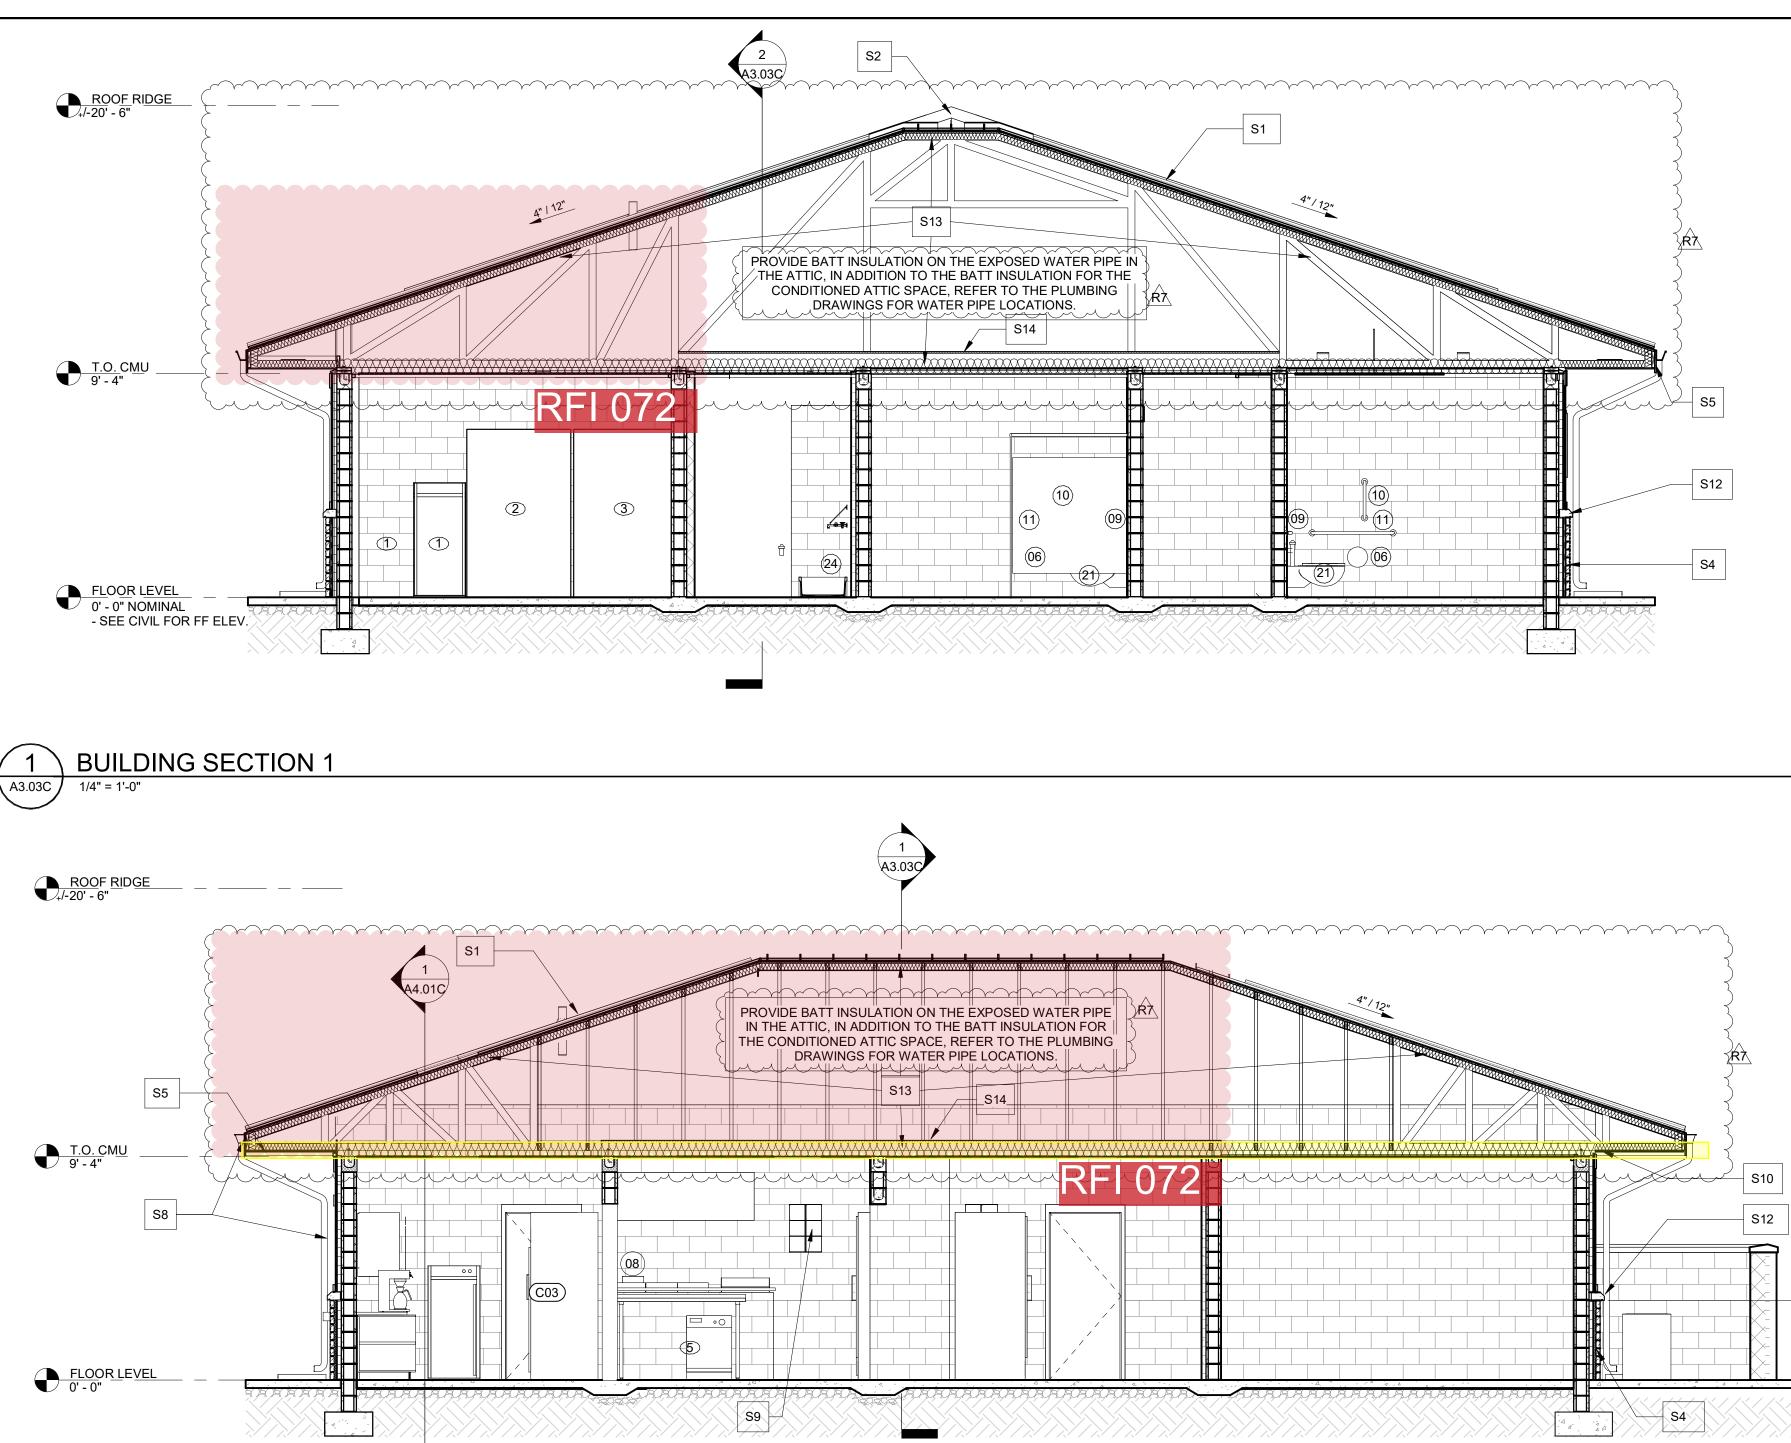

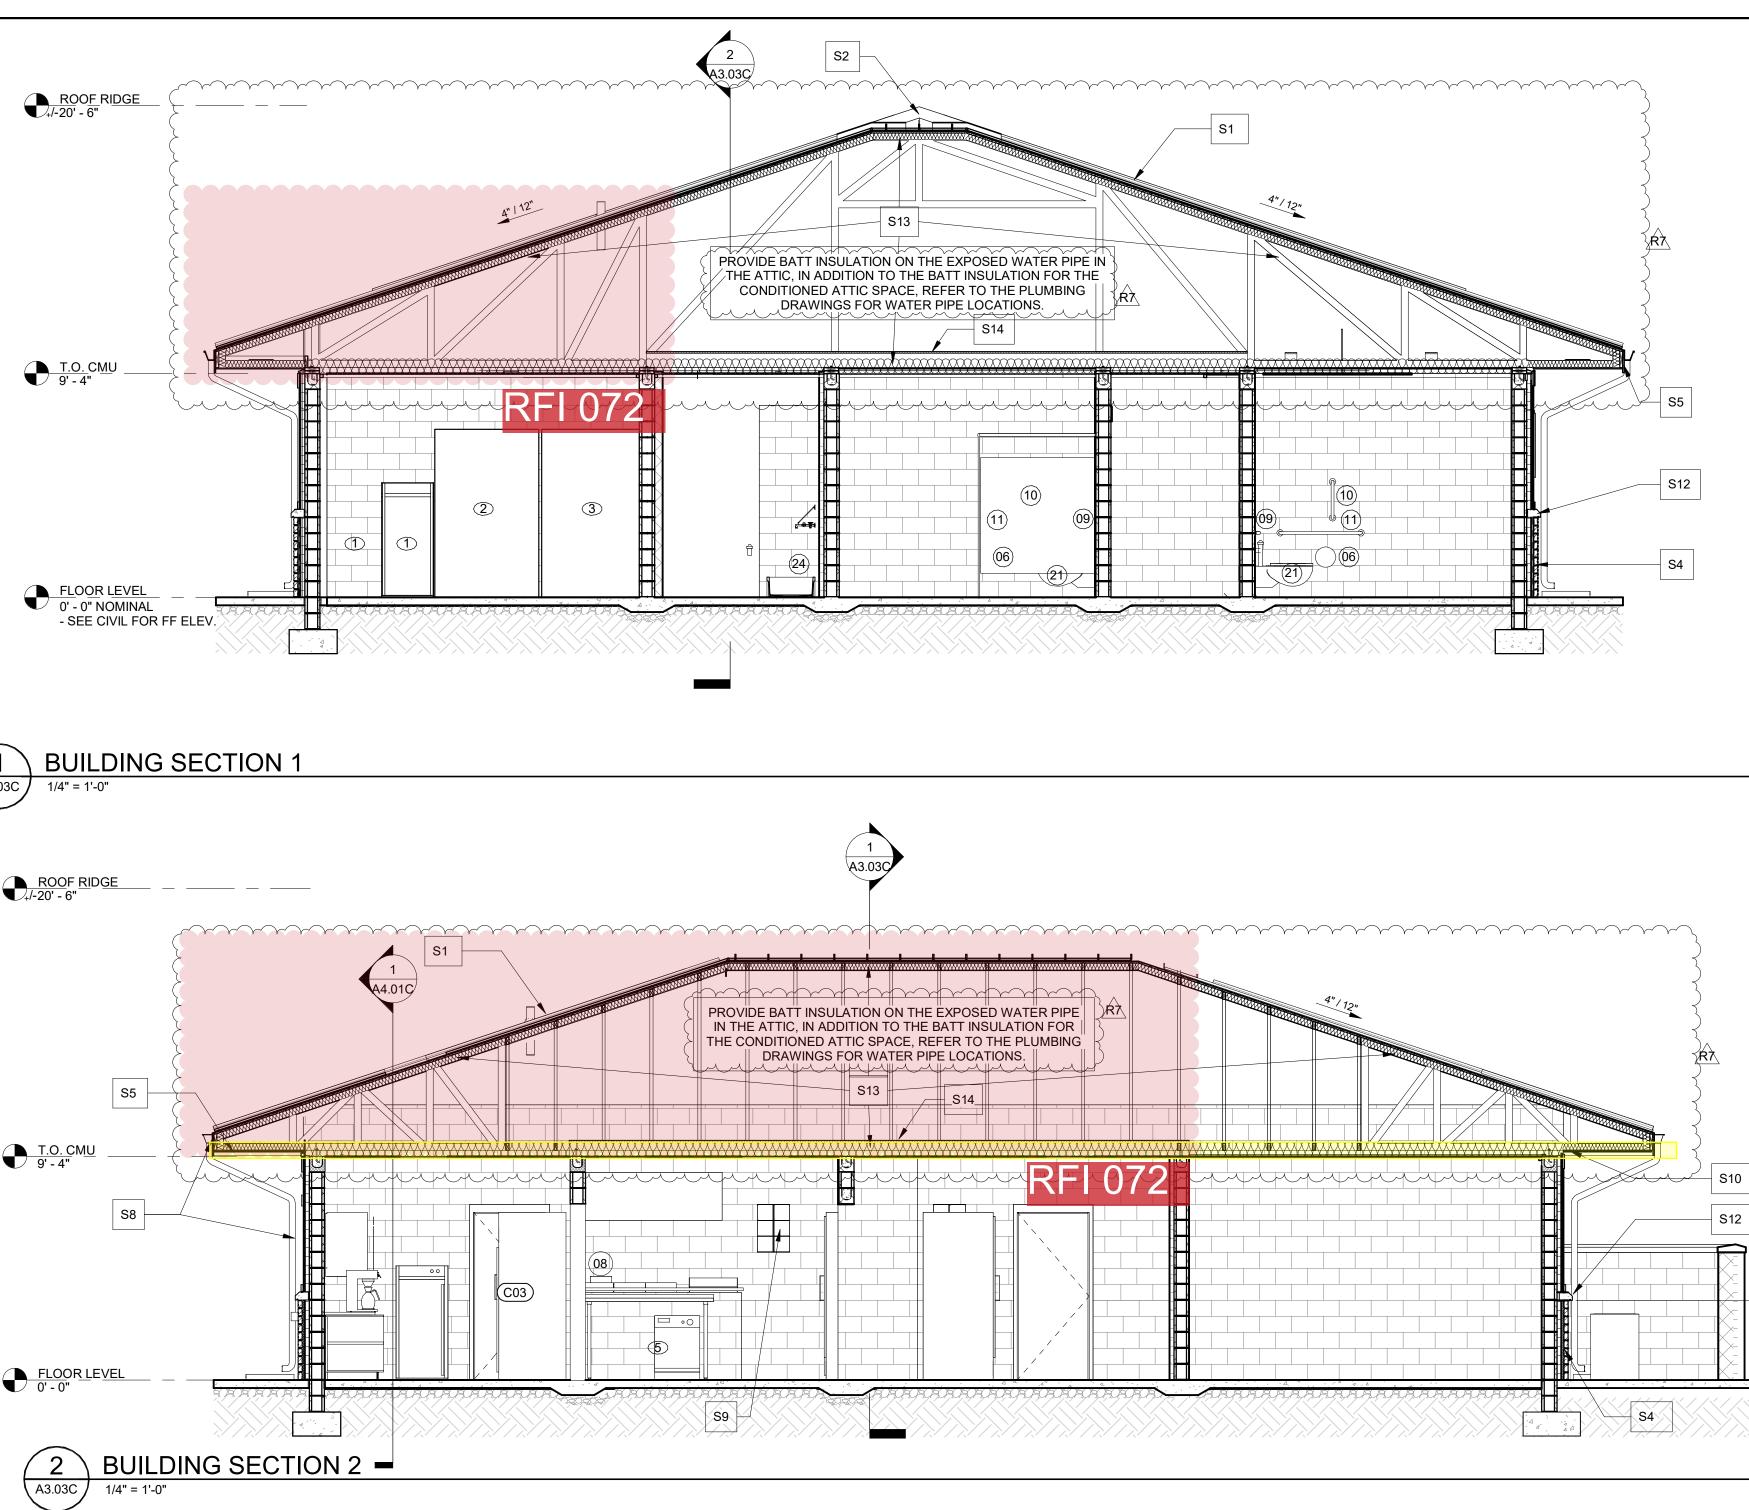

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	GEORGIA
	THE GROVE BUILDING "C" - SOFTBALL BUILDING 1089 HWY 81, LOGANVILLE, GA 30052 PREPARED FOR: WALTON COUNTY
	SUBMITTALS / REVISIONS         NO       DATE       DESCRIPTION         A3       04/21/2023       Addendum 3         A4       04/28/2023       Addendum 4         R1       06/13/2023       Permit Revisions         R7       11/20/2024       RFI#072 Conditioned         Mech Attic       Mech Attic         DESCRIPTION       Mech Attic         DESCRIPTION       Mech Attic         DESCRIPTION       DESCRIPTION         DESCRIPTION       Mech Attic         DESCRIPTION       DESCRIPTION         DESCRIPTION       DOCUMENTS         SHEET TITLE       SOFTBALL BUILDING - BUILDING SECTIONS
Ŕ	PROJECT NO. 22010 DRAWN BY STAFF CHECKED BY NR SHEET NO. As indicated As indicated
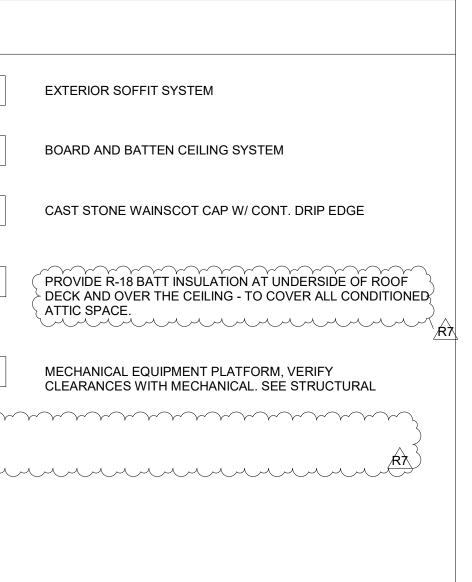
# **BUILDING F**

## PLAN GENERAL NOTES

1. SEE ENLARGED PLAN AND DETAILS FOR ADDITIONAL INFORMATION.

2. ALL FLOOR TO SLOPE AT 1/8" PER FOOT, UNO, COORDINATE W/PLUMBING & STRUCTURAL.

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4. COORDINATE ALL CASEWORK AND OFCI. ITEMS W/ OWNER.

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6. SEAL ALL PENETRATIONS OF CONDUIT, MECHANICAL DUCT WORK, PIPING, IN ALL SUBSTRATES, INTERIOR AND EXTERIOR WALLS, CEILINGS FLOORS

7. ARCHITECTURAL BUILDING FFE. LISTED AS 0'-0", COORDINATE ACTUAL W/CIVIL.

8. PROVIDE MASONRY CONTROL JOINTS AS REQUIRED. COORDINATE ANY EXPANSION/CONTROL/CONSTRUCTION JOINTS. VERIFY W/ ARCH. AND STRUC. FOR ANY DISCREPANCIES THAT OCCUR DURING THE

CONSTRUCTION PHASE. 9. SEALANT AT EXPANSION JOINT TO MATCH ADJACENT

WALL COLOR. 10. ALL NEW MASONRY JOINTS TO BE CONCAVED

TOOLED.

11. ALL DOWN SPOUTS TO CONNECT UNDERGROUND UNLESS OTHERWISE NOTED, COORDINATE W/ CIVIL AS REQUIRED.

12. ALL EXPOSED STEEL TO BE SHOP PRIMED AND FIELD PAINTED. 13. INSTALL NECESSARY BLOCKING BEHIND DESIGNATED LOCATION OF SIGNAGE.

14. HOSE-BIBB WITH LOCKABLE BOX, PROVIDE FREEZE-PROOF TYPE FOR EXTERIOR LOCATION, SEE PLUMBING.

15. CAULK ALL DOOR & WINDOW FRAMES AT THE JOINT BETWEEN THE FRAME & THE ADJACENT SUBSTRATE.

16. CAULK ALL JOINTS BETWEEN FIXED CASEWORK, PLUMBING FIXTURES, & BACKSPLASH TO WALL TRANSITION JOINT.

## **ROOM FINISH SCHEDULE**

ROOM									
NUMBER	ROOM NAME	FLOOR	NORTH	EAST	SOUTH	WEST	BASE	CEILING	NOTES
F01	STAGE	SC-2						DMDA3	
F02	STAIR 1	SC-2							
F03	STAIR 2	SC-2							
F04	HALL	SC-2	-					$\sim$	
F05	GREEN ROOM	SC-1	PNT-3	PNT-3	PNT-5	PNT-3	RB-1	PLW-1	)
F06	RESTROOM	EP-1 )	PČT-3	PCT-3	PCT-3	PCT-3	SLB	PLW-1	3
F07	DECK	SC-2 🌶	ß						P
F08	RESTROOM	EP-1	PCT-3	PCT-3	PCT-3	PCT-3	SLB	PLW-1	2
F09	ELECTRICAL/ AUDIO	SC-1	PNT-3	PNT-3	PNT-3	PNT-3		FLW-1	AA
F10	STORAGE	SC-1	PNT-3	PNT-3	PNY-9	PNT-3	- <del></del> D-1	( PLW-1 र्	
F11	RAMP	SC-2	-	-	-	-	-	m	
F12	STAIR 3	SC-2							
F13	LOADING DOCI	K SC-2	-	-	-	-	-	-	
MATER	IAL FINISH	MA	TERIAL	DESCR					
FLOOR									
BASE	BB-1 SLB	BUBBER COVED BASE BRUSHED STAINLESS STEEL BASE A4							
WALL	CMU CMU-E	CONCRETE							
CEILING	PLW-1 DMD FC-1	PLYWOOD DOVETAIL FIBER CEM	METAL DE	CKING - P	-	TED			

NOTES:

1. "E" DENOTES EPOXY.

2. SEE SPECS FOR PRIMER AND FINISH SYSTEMS. 3. SEE FINISH LEGEND ON SHEET A9.10F

### **PARTITION TYPES**

TYPE	SYMBOL	ASSEMBLY	WALL THK.	WALL HT.	FIRE RATING	REMARKS	
N01		8" CMU	7-5/8"	9'-4" AFF.	NONE		
N02		8" CMU W/ 1 1/2" Z METAL FURRING, 1 1/2" RIGID INSUL. AND 5/8" HIGH IMPACT GYP. BD.	9-3/4"	9'-4" AFF.	NONE	PROVIDE WOOD FRAMED WALL WITH PLYWOOD SHEATHING ON UNCONDITIONED SIDE, ON TOP CMU WALL, EXTENDS TO ROOF DECK.	
PLAN KEYNOTES							
1	ROOF OUTLINE	E ABOVE, TYP.		7	MECHANICAL UN MECHANICAL	IIT ABOVE, SEE	
2	SEALED CONC	RETE SLAB BROOM	FINISH, SEE CI'	VIL 8	KNOX BOX, VERIFY LOCATION W/ BUILDING OFFICIAL		
3	SEALED CONC	RETE SLAB		9	MASONRY WALL CONTROL JOINT, TYP.		
4	PRE-FINISHED	DOWNSPOUT, TYP.		10	KNOX BOX, VER	IFY LOCATION W/ BUILDING	

PRE-FINISHED DOWNSPOUT METAL GUARD TYP

FLOOR DRAIN, TYP. SEE PLUMBING

- 17. COORDINATE BUILDING SITE ORIENTATION/LAYOUT WITH CIVIL.
- 18. FOR CONCRETE PAVING SEE SITE/CIVIL

DETAILS.

REQUIREMENTS.

19. SEE SITE DRAWINGS FOR ALL EXT. SLAB JOINT

20. SEE STRUCTURE FOR ALL FOOTING & SLAB

21. AS REQUIRED PROVIDE AND INSTALL KNOXBOX AT **BUILDING ENTRANCE** 

PER LOCAL CODE OFFICIAL DIRECTIONS AND REQUIREMENTS. MODEL OF KNOXBOX. TO BE APPROVED BY LOCAL CODE OFFICIALS. KNOXBOX TO BE MODEL 3200 - 10 KEY CAPACITY - COLOR BLACK. VERIFY INSTALLATION LOCATION W/ ARCH. RECESSED MOUNTED ON BUILDING. - PROVIDE SMOOTH FACE BLOCK. BEHIND KNOXBOX AS REQUIRED TO MATCH ADJACENT BUILDING BLOCK.

22. PROVIDE ROUNDED CORNER ON ALL EXPOSED CMU CORNER, INCLUDING BUT NOT LIMITED TO DOOR JAMBS AND OTHER OPENINGS.

23. SEE A0.02F FOR RESTROOM ACCESSORIES, GRAB BAR SIZES AND MOUNTING HEIGHTS & PLUMBING FIXTURES LEGEND. SEE PLUMBING FOR FIXTURE SPEC. 24. ALL PLUMBING IN UNCONDITIONED SPACES SHALL

BE INSULATED.

25. SEE SHEET A4 SERIES FOR WALL SECTIONS & DETAILS.

26. SEE SHEET A6 SERIES FOR RCP.

27. SEE SHEET A7 SERIES FOR ROOF PLANS.

A3


OFFICIALS


11 LETTER BUILDING SIGN, VERIFY W/ OWNER

28. SEE SHEET A8 SERIES FOR DOOR SCHEDULE & DETAILS.

29. SEE SHEET A8 SERIES FOR WINDOW SCHEDULE & DETAILS.

30. SEE SHEET A9 SERIES FOR ARCHITECTURAL WOODWORK AND FINISH LEGEND

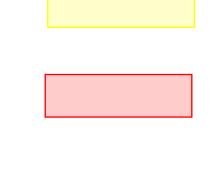

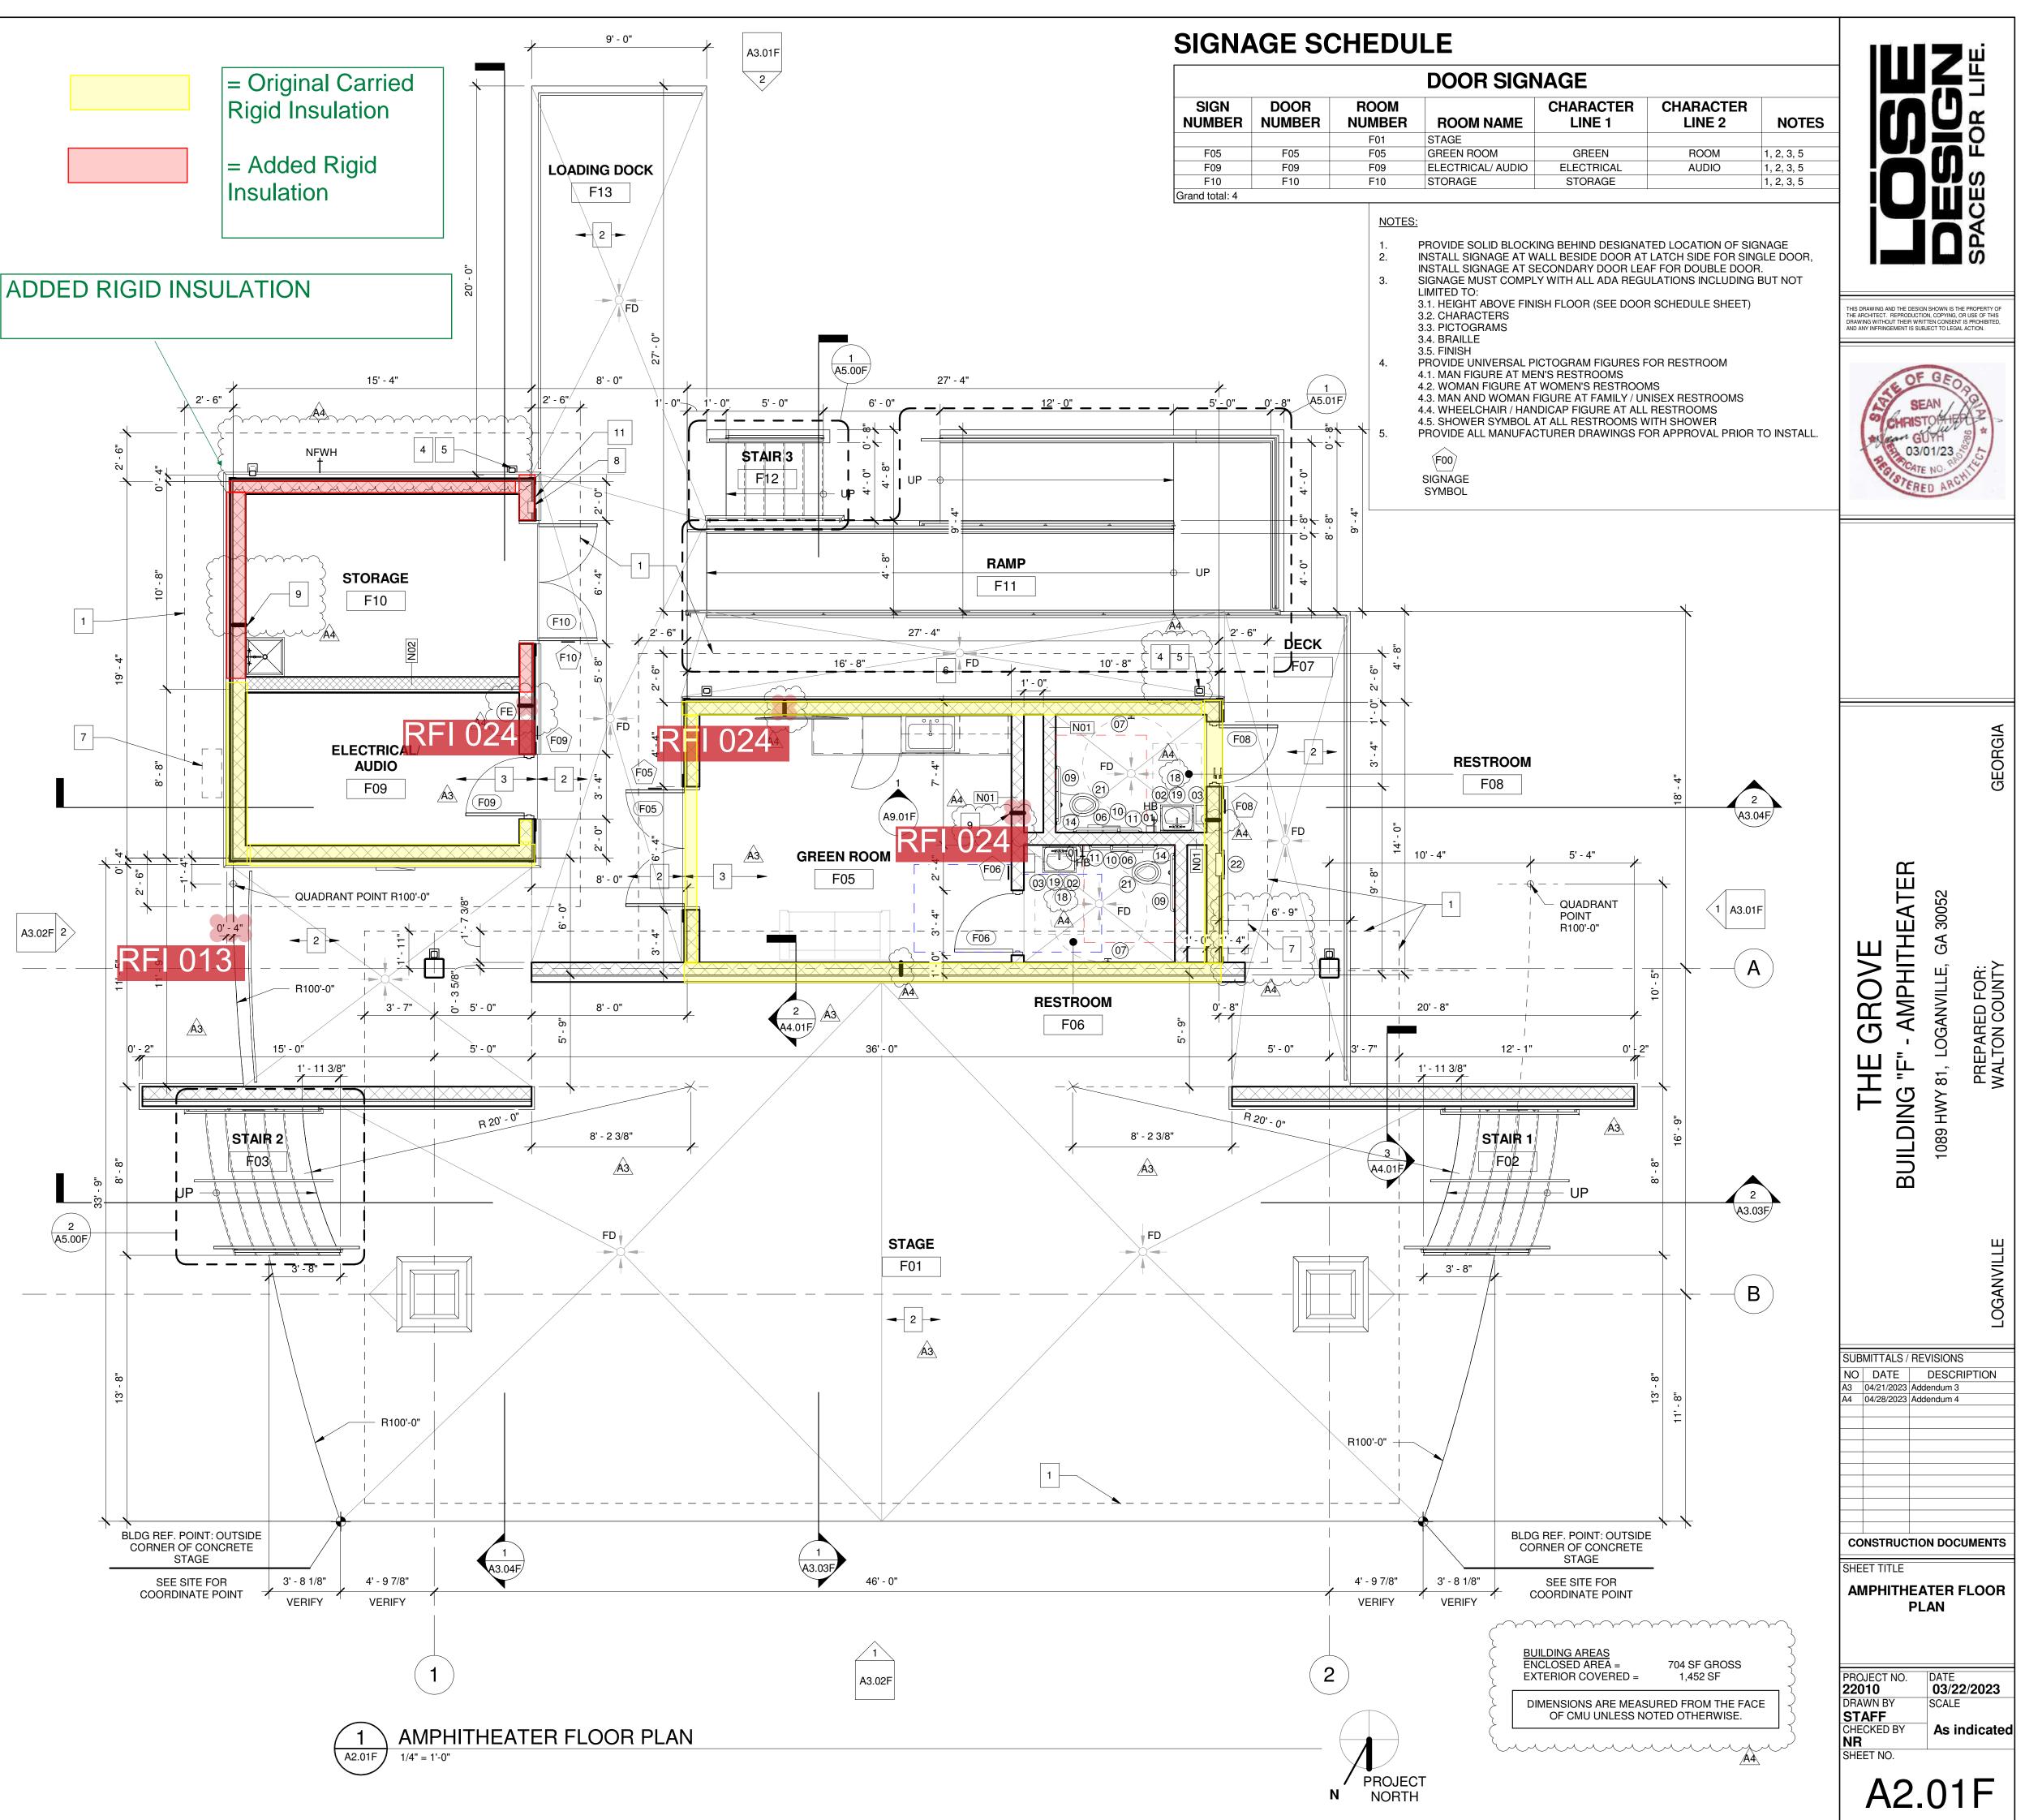

#### **GENERAL NOTES**

1. ELEVATION MARKS TO BE VERIFIED IN FIELD WITH MATERIAL AND ASSEMBLY DIMENSIONS AS PROVIDED BY BUILDING SYSTEM MANUFACTURER.

- 2. DIMENSIONS ARE FROM FACE OF FIXTURE TO FINISH FACE WALL (U.N.O.)
- 3. ARCHITECTURAL BUILDING FFE. LISTED AS 0'-0", COORDINATE ACTUAL W/ CIVIL
- 4. SEE SHEET A2 SERIES FOR FLOOR PLANS
- 5. SEE SHEET A4 SERIES FOR SECTIONS & DETAILS
- 6. SEE SHEET A6 SERIES FOR RCP.
- 7. SEE SHEET A7 SERIES FOR ROOF PLANS
- 8. SEE SHEET A8 SERIES FOR DOOR SCHEDULE AND DETAILS
- 9. SEE SHEET A8 SERIES FOR WINDOW SCHEDULE & DETAILS
- 10. SEE SHEET A9.10 FOR FINISH LEGEND

S1

S2

S3

S4

S5


S6

S7

S8

S9

### **SECTION KEYNOTES**

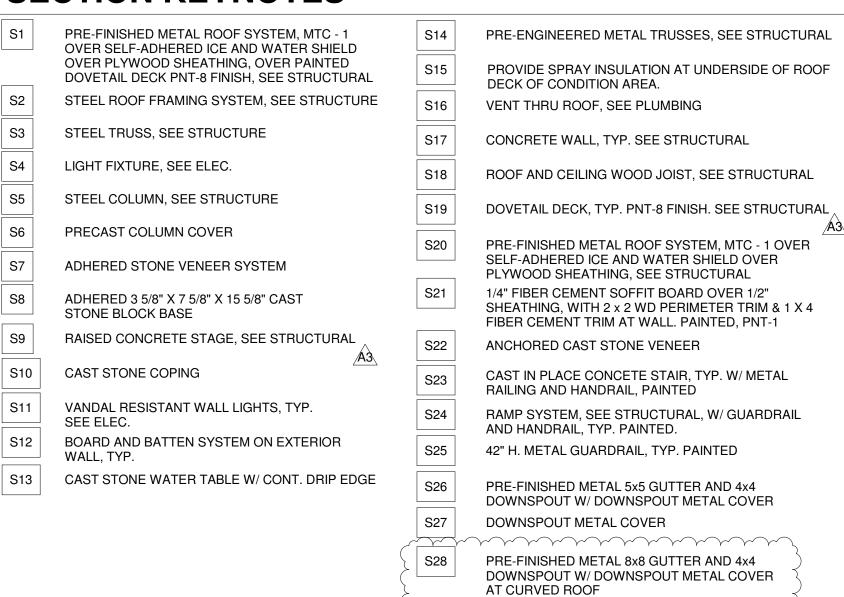

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Ady \_\_\_\_\_

NO ATTIC VENTILATION WHERE RAFTERS

ARE INSULATED WITH SPRAY INSULATION

NOTE :

