
Walton County The Grove

Change Proposal #9 Building J VE Permit Changes Rev I

General Contractor:

Reeves Young
45 Peachtree Industrial Boulevard N.W.
Sugar Hill, GA 30518
770-271-1159

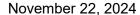



Walton County, GA The Grove, a Walton County Parks & Recreation Facility

Attn: John Ward, County Manager
Jeff Prine, Capital Project Manager –
Ascension Program Management

Change Proposal #9 - Building J (Maintenance) VE Permit Revisions Rev 1

The below change proposal is for the cost associated with the design changes incorporated in the VE permit set for building J. These changes include additional HM openings, eyewash station, water heater, and storefront frame added. Please see below for further supporting documentation.

UPDATE: Per conversations with Jeff Prine of APM on 11.22.24, only one HM Opening will be added to the Maintenance building in lieu of what is shown on the permitted VE set. The pricing update is reflected below.

Description	Qty	Unit	Unit Price	Total
Lighting Changes	1	LS	\$12,651.72	\$12,651.72
Plumbing (Eyewash Station & WH-3)	1	LS	\$3,503.00	\$3,503.00
Added HM Frames and Doors	1	LS	\$3,790.00	\$3,790.00
Added ALM Frame	1	LS	Void	Void
Total Subcontractor Cost	1	LS		\$19,944.72
Payment & Performance Bond	0.597	%	\$119.07	\$119.07
General Liability Insurance	0.811%	%	\$161.75	\$161.75
Builders Risk Insurance	0.174%	%	\$34.70	\$34.70
RY Overhead and Profit	10	%	\$1,994.47	\$1,994.47
TOTAL				\$22,254.72

	equire any additional information, please nail at <u>iarnold@reevesyoung.com.</u>	do not hesitate to contact
Sincerely, Reeves Young, LLC		
Isaiah Arnold		
Project Manager		
45 Peachtree Industrial Blvd, Suite Sugar Hill, GA 30518		
Approval Lose Design (Architect of Record)	Signature:	Date:
Ascension PM (Capital Project Manager)	Signature: Thomas J. Prine	Date: 11.25.2024
Walton County	Signature:	Date:



November 12, 2024

Walton County, GA The Grove, a Walton County Parks & Recreation Facility

Attn: John Ward, County Manager
Jeff Prine, Capital Project Manager –
Ascension Program Management

Change Proposal #9 - Building J (Maintenance) VE Permit Revisions/

The below change proposal is for the cost associated with the design changes incorporated in the VE permit set for building J. These changes include additional HM openings, eyewash station, water heater, and storefront frame added. Please see below for further supporting documentation.

Description	Qty	Unit	Unit Price	Total
Lighting Changes	1	LS	\$12,651.72	\$12,651.72
Plumbing (Eyewash Station & WH-3)	1	LS	\$3,503.00	\$3,503.00
Added HM Frames and Doors	1	LS	\$7,580.00	\$7,580.00
Added ALM Frame	1	LS	\$1,749.00	\$1,749.00
Total Subcontractor Cost	1	LS		\$25,483.72
Payment & Performance Bond	0.597	%	\$152.14	\$152.14
General Liability Insurance	0.811%	%	\$206.67	\$206.67
Builders Risk Insurance	0.174%	%	\$44.34	\$44.34
RY Overhead and Profit	10	%	\$2,548.37	\$2,548.37
TOTAL				\$28,435.24

If you have any questions or require any additional information, please do not hesitate to contact us at (470) 725-0022 or via email at iarnold@reevesyoung.com.

Sincerely,

Reeves Young, LLC

Isaiah Arnold

Project Manager

doubt and

<u>Approval</u>		
Lose Design (Architect of Record)	Signature:	Date:
Ascension PM (Capital Project Manager)	Signature:	Date.
Walton County	Signature:	Date:

ES&C GA, Inc.

1861 Trinity Creek Drive Dacula, GA 30019 US +13055278862 Jonathan@escofga.com

Estimate

ADDRESS ESTIMATE 1053
Reeves Young DATE 09/25/2024

45 Peachtree Industrial Blvd, Sugar Hill, GA 30518, United States of America

DATE	ACTIVITY	DESCRIPTION	QTY	RATE	AMOUNT
	Change Order	This change order pertains to the electrical changes made to Building J. Drawings dated 09.19.2024.	1	0.00	0.00
	Material	Misc. Material: ~ Conduit ~ Couplings ~ Connectors ~ Wire #12 ~ Boxes ~ Switch ~ Mud Rings ~ Straps ~ Screws ~ Wire Nuts	1	583.09	583.09
	Material	Lighting Fixtures: ~ EM (15) ~ EM1 (2) ~ Exit Signs (2) ~ D (3) ~ OS (1)	1	2,150.37	2,150.37
	Labor	Below is a cost breakout for Labor associated with the scope of work being performed. 3 electricians x 1 week each	150	57.46	8,619.00
	Tax	Tax Rate @ 6%	0.06	2,733.46	164.01
	Overhead/Profit	Overhead/Profit @ 10%	0.10	11,352.46	1,135.25

THIS IS AN ESTIMATE ONLY. TOTAL \$12,651.72

In order to proceed with this scope of work, ES&C GA. Inc. stipulates that our invoice must be signed alongside a change order directive signed by either the client or the general contractor.

Accepted By

Accepted Date



Michael T. Meehan

michael@meehanmechanicalinc.com

GA Registrations:

Class II Conditioned Air (non-restricted) CN210414 Class II Master Plumber (non-restricted) MP210322

Date: 10/2/2024

Isaiah Arnold Project Manager

Project: The Grove - Building J

Change Order Request: Conformed Set Changes - Building J

Scope Of Work: Addition of Eye Wash and WH-3

qty	Materials		
1	Eye Wash	Guardian G1814P	397.00
1	WH-3	Chronomite R-75L/208	540.00
1	Piping	Copper/PVC Fittings (1 lot)	225.00
1	*Mixing Valve	Guardian G6020 - ASSE 1071 Thermostatic mixing Valve	884.00
8 hrs	Labor	2 men, 4hrs @ \$125	1000.00
	Subtotal		3046.00
	OH&P	15%	457.00
•	TOTAL		3503.00

^{*}The ASSE 1071 Mixing Valve offered above is required by code for emergency eyewashes. Unlike the standard ASSE 1070 mixing valves used for lavatories, the 1071 for tepid water emergency plumbing fixtures fails to cold to prevent scalding.

Labor and materials listed above include slab work already in place.

Let me know if you have any questions.

Respectfully Submitted, Michael Meehan

Performance Construction Services, LLC 499 Tuggle Greer Drive **Buford, GA 30518** O. 770-217-7545 F. 770-217-7357

CHANGE ORDER REQUEST #5

Date:	October 2, 2024
Job Name:	The Grove Park
Job Location:	1089 Highway 81, GA 30052
We propose the following c	hanges in scope of work:
 Additional Doors, Frame Building J – HM 140 J08A J10C 10% Mark-up 	es, & Hardware: A Galvanized Frame & Door w/ Finish Hardware WC To pay for one additional HM opening. WC to clarify which opening is to remain.
	nges in the scope of work of the added sum of: ed Eighty Dollars and No Cents (\$7,580.00).
Payment as follows: ACCEPTANCE OF CHANGE	ORDER
Date Of Acceptance	
PO #	

Change Order



Clearvue Glass and Mirror Co.
Printed: Oct 9, 2024 1900 W Oak Cir Ste B, Marietta, GA 30062-2248

Phor	ne: 404-524-5616				
_	10. 104 324 3010	,			
_					
Owner Info Isaiah Arnold					
45 Peachtree In	dustrial Blvd Sug	ar Hill, GA 30518	/		
Cell: +14707250	022				
27-24 The Grove					
Job Info 1089 HWY 81					
Loganville, GA 3005	2				
Change Order ID	ı				
27-24-CC-0001					
CO ID		Created / Approved Da	ate		Price
27-24-CC-0001		Created:		Oct 9, 2024	\$1,749.00
				·	
		Descrip	xion		
Added Aluminum Frame at I	Building J				
Items	Cost Types	Description	Qty / Unit	Unit Price	Price
Added Frame Building J			1	\$1,749.00	\$ 1,749.00
1010 - Aluminum Systems					
Status		Signature	Date		
Approved by:					
		Approval Co	omments		

Please Note: A signature of Approval OR Electronic Acceptance is required before change order is effective. This change order becomes part of the existing contract.

TOTAL AMOUNT OF CHANGE ORDER: \$1

\$1,749.00

CONFORMED SET


THE GROVE - BUILDING "J" MAINTENANCE FACILITY

WALTON CO, GA

PREPARED FOR: WALTON COUNTY PARKS AND RECREATION DEPARTMENT

DESIGN SPACES FOR LIFE.

THIS CRAWING AND THE DESIGN SHOWN IS THE PROPERTY OF THE ARCHITECT. REPRODUCTION, COPYING OR USE OF THIS DRAWING WITHOUT THEIR WRITTEN CONSENT IS PROHESTED AND BARY WERENDELEMIT IS SUBJECT TO LEGAL ACTION.

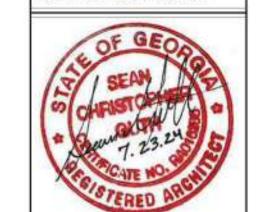

VICINITY MAP



OWNER

WALTON COUNTY PARKS & RECREATION DEPT

111 SOUTH BROAD ST
MONROE, GA 30655
PHONE: (770) 266-1680
CONTACT: JODY JOHNSON
EMAIL: JEJOHNSON@CO.WALTON.GA.US

ASCENSION PROGRAM MANAGEMENT

2990 SUMMIT LANE MONROE, GA 30655 PHONE: (404) 992-5050 CONTACT: JEFF PRINE EMAIL: JPRINE@ASCENSION-PM.COM



PLANS PREPARED BY

ARCHITECT

LOSE DESIGN, LLC.
220 W. CROGAN STREET
SUITE 100

LAWRENCEVILLE, GEORGIA 30046
PHONE: 770-338-0017
CONTACT: NELSON RUIZ
EMAIL: NRUIZ@LOSE.DESIGN

LANDSCAPE ARCHITECT/CIVIL

LOSE DESIGN, LLC.
220 W. CROGAN STREET
SUITE 100

LAWRENCEVILLE, GEORGIA 30046
PHONE: 770-338-0017
CONTACT: AARON ST. PIERRE

CONSULTANTS

STRUCTURAL ENGINEER
WILLIAM J PELTIER & ASSOCIATES, INC.
270 LANGLY DR
LAWRENCEVILLE, GA 30046
P:770-963-0654
CONTACT: WILLIAM PELTIER, P.E., S.E.

EMAIL: WJP@WILLIAMJPELTIER.COM

MECHANICAL ENGINEER

SAVANT ENGINEERING, LLC 5064 ROSWELL ROAD SUITE D-301 SANDY SPRINGS, GA 30342 P: 678-548-1739 CONTACT: RYAN ROBERTSON

ELECTRICAL ENGINEER

SAVANT ENGINEERING, LLC
5064 ROSWELL ROAD SUITE D-301
SANDY SPRINGS, GA 30342
P: 678-548-1739
CONTACT: SLADE HOLLADAY

PLUMBING ENGINEER

SAVANT ENGINEERING, LLC

5064 ROSWELL ROAD SUITE D-301
SANDY SPRINGS, GA 30342
P: 678-548-1739
CONTACT: BRIAN WARD
EMAIL: BWARD@SAVANTENG.COM

PROJECT NO. DATE
22010 09/19/24
DRAWN BY SCALE
STAFF
CHECKED BY
NR
SHEET NO.


A0.00J

ING "J" - MAINTENANC
1089 HWY 81, LOGANVILLE, GA

SUBMITTALS / REVISIONS
NO DATE DESCRIPTION

CONFORMED SET

COVER

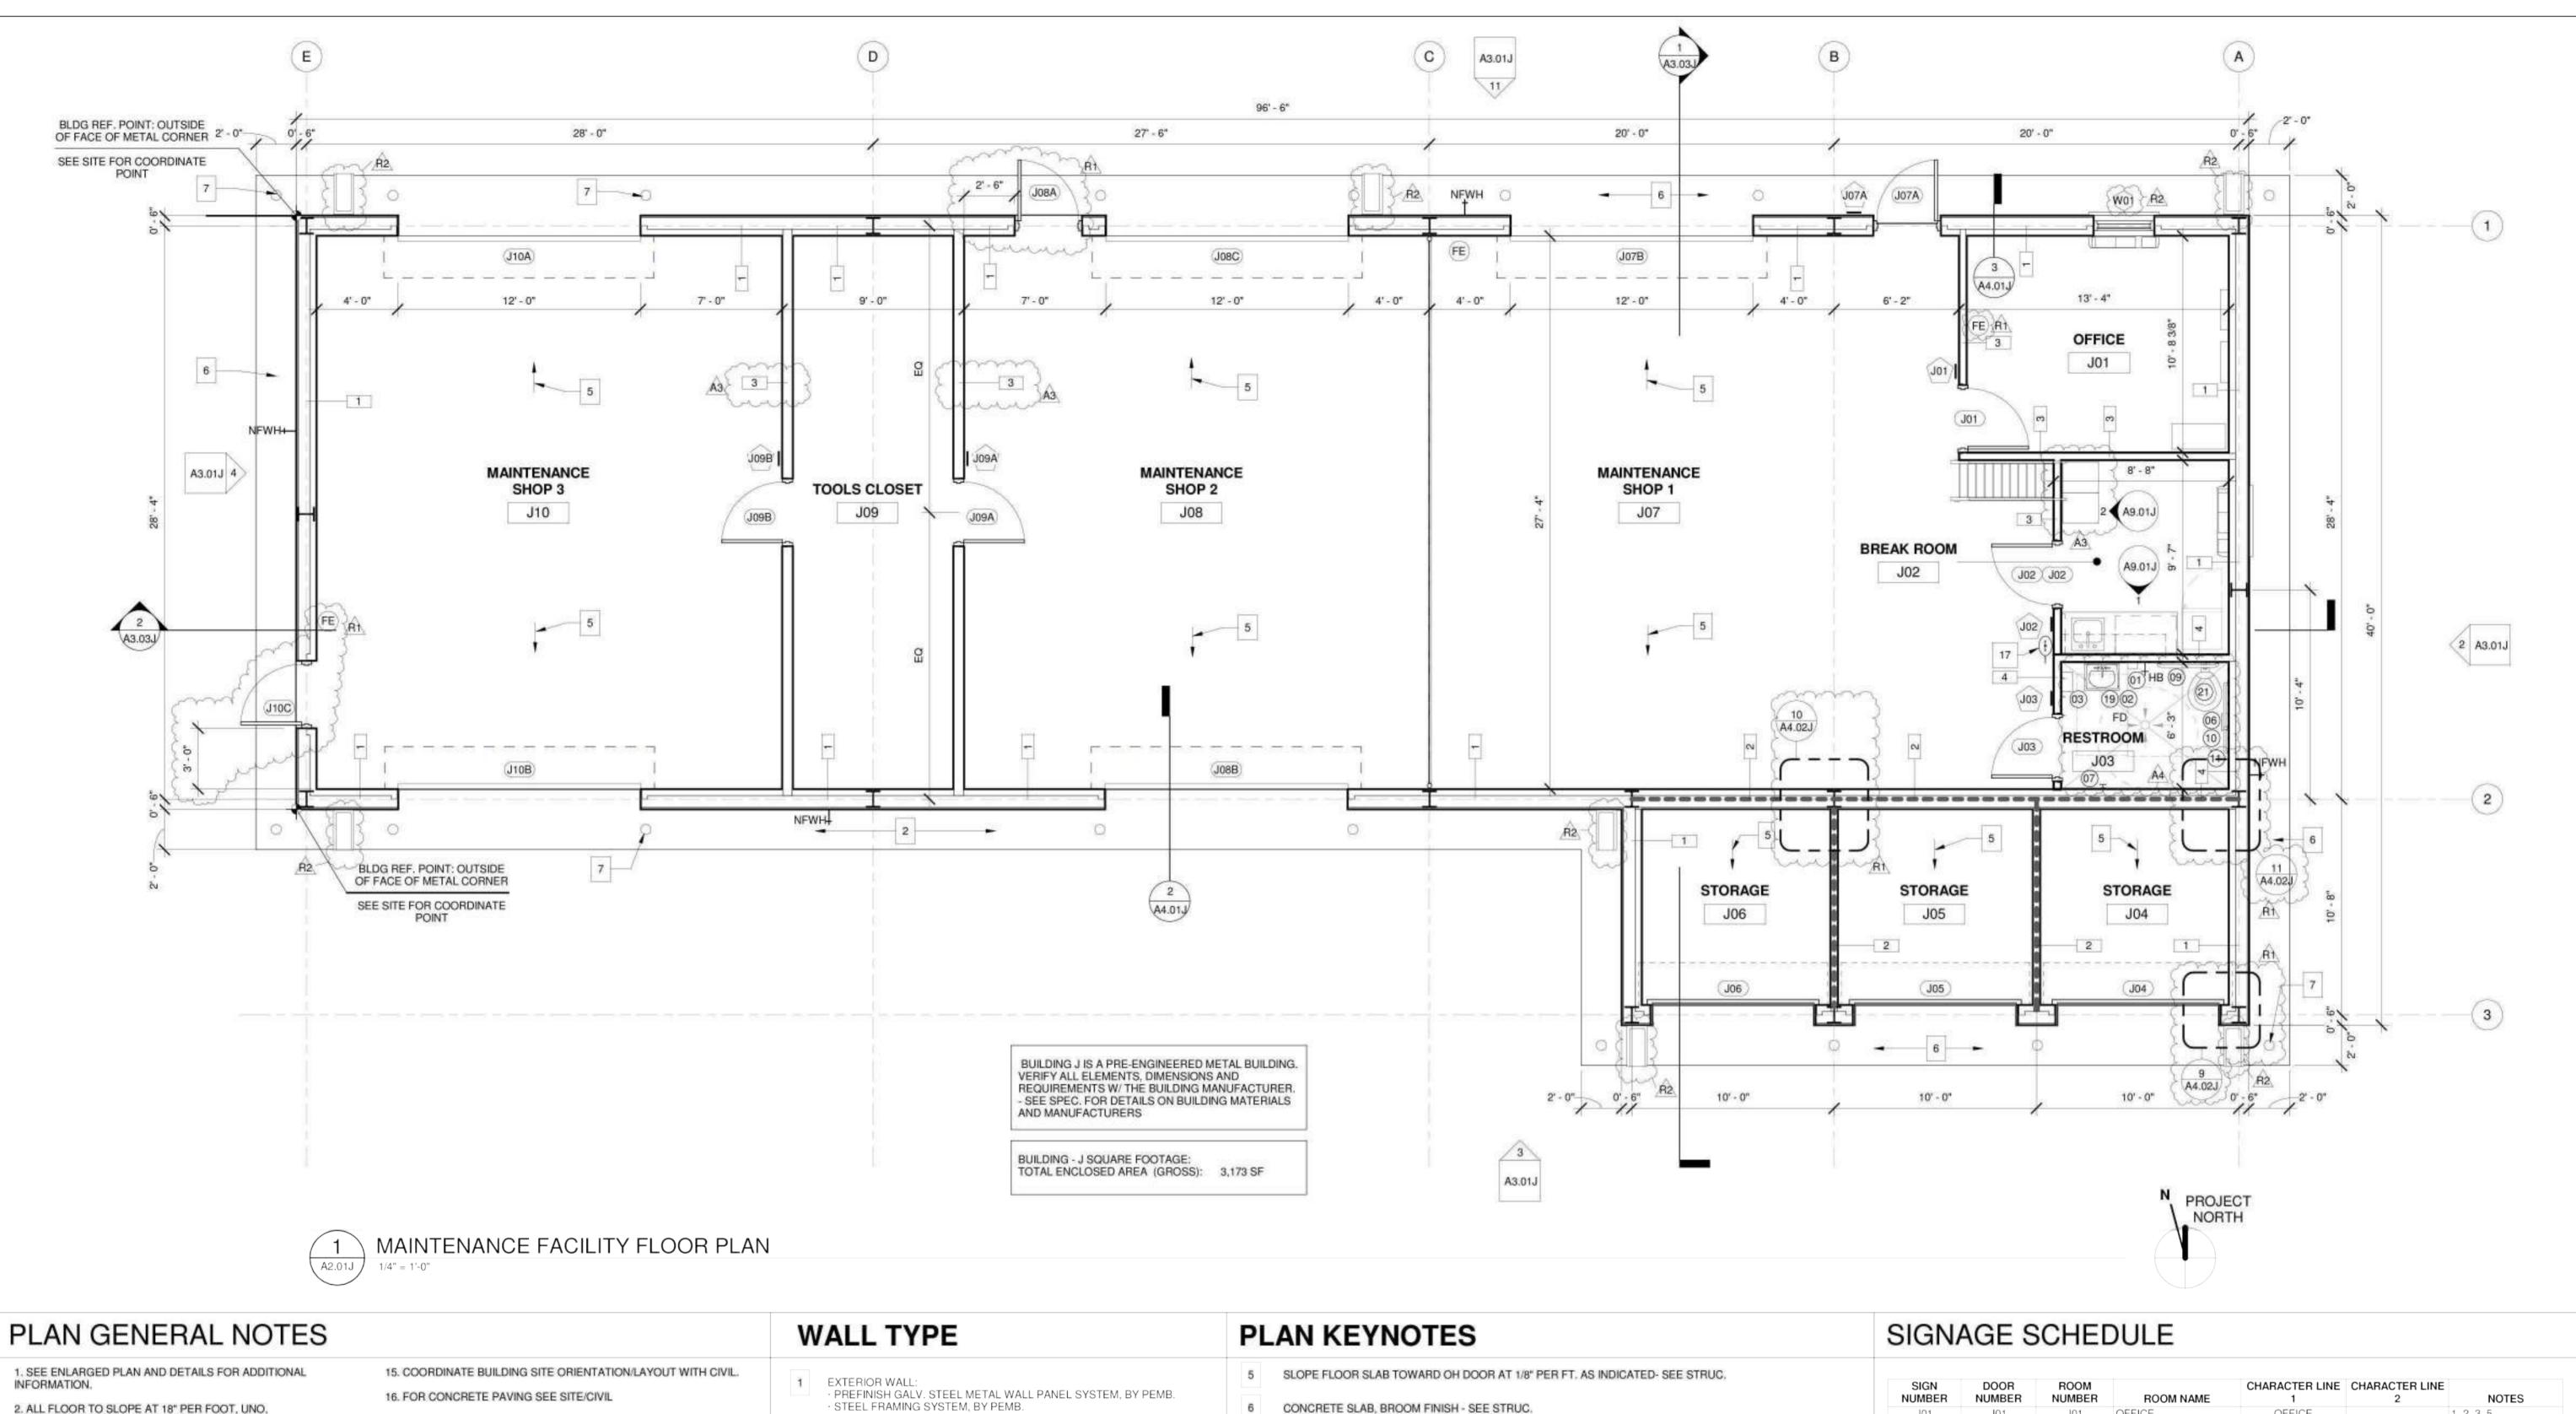

2. ALL FLOOR TO SLOPE AT 18" PER FOOT, UNO. COORDINATE W/ PLUMBING & STRUCTURAL.

3. COORDINATE ALL CASEWORK AND OFCI ITEMS W/ OWNER.

4. ALL ELECTRIC AND PLUMBING DEVICES ON EXT. WALLS TO BE "CENTERED" ON CMU VERTICALLY AND HORIZONTALLY

(W.P. OUTLETS, HOSE BIBBS, ETC). 5. SEAL ALL PENETRATIONS OF CONDUIT, MECHANICAL DUCT WORK, PIPING, IN ALL SUBSTRATES, INTERIOR AND EXTERIOR

6. ARCHITECTURAL BUILDING FFE. LISTED AS 0'-0",

WALLS, CEILINGS FLOORS

NOT USED

CONSTRUCTION PHASE.

COORDINATE ACTUAL W/ CIVIL,

7. RUN ALL DOWN SPOUTS TO UNDERGROUND, COORDINATE W/ CIVIL, U.N.O.

8. ALL EXPOSED STEEL TO BE SHOP PRIMED AND FIELD PAINTED.

10. INSTALL NECESSARY BLOCKING BEHIND DESIGNATED

LOCATION OF SIGNAGE. 11. HOSE-BIBB WITH LOCKABLE BOX, PROVIDE FREEZE-PROOF

12. CAULK ALL DOOR & WINDOW FRAMES AT THE JOINT

TYPE FOR EXTERIOR LOCATION, SEE PLUMBING.

BETWEEN THE FRAME & THE ADJACENT SUBSTRATE. 13. CAULK ALL JOINTS BETWEEN FIXED CASEWORK, PLUMBING

FIXTURES, & BACKSLASH TO WALL TRANSITION JOINT. 14. COORDINATE ANY EXPANSION/CONTROL/CONSTRUCTION JOINTS WITH EXISTING CONSTRUCTION, VERIFY W/ ARCH, AND STRUC. FOR ANY DISCREPANCIES THAT OCCUR DURING THE

17. SEE SERIES SEE STRUCTURAL FOR ALL SLAB JOINT DETAILS.

SEE STRUCTURAL FOR ALL FOOTING & SLAB REQUIREMENTS.

19. SEE SHEET A3 SERIES FOR EXTERIOR ELEVATIONS AND BUILDING

20. SEE SHEET A4 SERIES FOR WALL SECTIONS & DETAILS.

21. SEE SHEET A6 SERIES FOR RCP.

22. SEE SHEET A7 SERIES FOR ROOF PLANS.

23. SEE SHEET AS SERIES FOR DOOR SCHEDULE & DETAILS.

24. SEE SHEET AS SERIES FOR WINDOW SCHEDULE & DETAILS. 25. SEE SHEET A9 SERIES FOR ARCHITECTURAL WOODWORK, ROOM

FINISH SCHEDULE AND FINISH LEGEND 26. AS REQUIRED PROVIDE AND INSTALL KNOXBOX AT BUILDING

ENTRANCE PER LOCAL CODE OFFICIAL DIRECTIONS AND REQUIREMENTS, MODEL OF KNOXBOX, TO BE APPROVED BY LOCAL CODE OFFICIALS. KNOXBOX TO BE MODEL 3200 - 10 KEY CAPACITY - COLOR BLACK. VERIFY INSTALLATION LOCATION W/ ARCH, RECESSED MOUNTED ON BUILDING WITH FLASHING TO DRAIN. - PROVIDE BLOCKING BEHIND KNOXBOX AS REQUIRED

27. MAIN DISCONNECT, SEE ELECTRICAL

28. KWH METER, SEE ELECTRICAL

LEGEND. SEE PLUMBING FOR FIXTURE SPEC.

FOR MOUNTING PER MANUFACTURER.

29. ELECTRICAL PANEL, SEE ELECTRICAL

31. SEE A0.02J FOR RESTROOM ACCESSORIES & PLUMBING FIXTURES

· VINYL SCRIM WALL INSULATION, SEE SHEET A4.1J FOR DETAILS.

 \cdot 5 8" PLYWOOD UP TO 8'-0" AFF ON PEMB GIRT FRAMING SYSTEM. PROVIDE 5 8" GYP. BD. AT INTERIOR AT OFFICE, BREAKROOM, & RESTROOM. - SEE INTERIOR PARTITION FOR MORE INFORMATION.

INTERIOR PARTITION AT STORAGE (1 HR RATED): · 2x4 WOOD FRAMING AT 16" OC · 5/8" P.T. PLYWOOD PANEL OVER 5/8" TYPE X GYP BD. AT EACH SIDES

 WALL TO EXTEND TO BOTT. OF ROOF STRUC. · PROVIDE 3/4" DEFLECTION AT PARTITION HEAD · SEE A4.01J / A4.02J FOR DETAILS.

INTERIOR PARTITION: · 2x4 WOOD FRAMING AT 16" OC · W/ 5 8" GYP. BD. AT EXPOSED SIDES · WALL TO EXTEND 8'-0" AFF

· SEE A4.01J / A4.02J FOR DETAILS INTERIOR PARTITION AT WET AREA: · 2x4 WOOD FRAMING AT 16" OC

· W/ 5 8" MOISTURE RESISTANT GYP. BD. PANEL AT EXPOSED SIDES · PROVIDE SOUND BATT INSULATION AROUND RESTROOM. · WALL TO EXTEND 8'-0" AFF · SEE A4.01J / A4.02J FOR DETAILS.

* WRAP CERAMIC TILE AROUND RESTROOM UP TO 6'-0"*

1 HR U.L. WALL ASSEMBLY NO. U305, SEE SHEET A0.09J

7 CONCRETE FILLED STEEL BOLLARD, TYP. SEE 3 / A4.02J

8 SLOPE FLOOR AT 1/2" PER FT. AT ALL CORNER CONDITION AND COLUMN LOCATIONS

9 WALL LOUVER FOR MECHANICAL SYSTEM - SEE MECH.

10 THRU-WALL PTAC SYSTEM, SEE MECH.

11 THRU-WALL EXHAUST FAN, SEE MECH.

12 CONC. PAVING, TYP. - SEE SITE / CIVIL

13 SUSPENDED UNIT HEATER, TYP. - SEE MECH.

14 HOSE-BIBB WITH LOCKABLE BOX, PROVIDE FREEZE-PROOF TYPE - SEE PLUMBING

15 2" W X 1/2" H WITH MARBLE ADA TRANSITION THRESHOLD AT DOOR W/ 1/4" BEVELED EDGE

16 ROOF EDGE, TYP. - SEE ROOF PLAN

17 EMERGENCY EYE-WASH STATION - SEE PLUMB.

18 BASE CABINET W/ PLAS. LAM. FIN. & SINK - SEE A9.01J

19 TANKLESS WATER HEATER UNIT. PLACE ON A STAND. SEE MECH / PLUMB.

20 REDUCED PRESSURE BACKFLOW PREVENTION UNIT - SEE PLUMBING

21 ELECTRICAL PANELS, TERMINAL BOARDS AND CONTROLS - SEE ELECT.

SIGN NUMBER	DOOR NUMBER	ROOM NUMBER	ROOM NAME	CHARACTER LINE 1	CHARACTER LINE 2	NOTES	
J01	J01	J01	OFFICE	OFFICE		1, 2, 3, 5	
J02	J02	J02	BREAK ROOM	BREAK ROOM		1, 2, 3, 5	
J03	J03	J03	RESTROOM	RESTROOM		1, 2, 3, 4, 5	
J07A	J07A	J07	MAINTENANCE SHOP 1	MAINTENANCE	SHOP	1, 2, 3, 5	
J09A	J09A	J09	TOOLS CLOSET	TOOLS	CLOSET	1, 2, 3, 5	

NOTES:

PROVIDE SOLID BLOCKING BEHIND DESIGNATED LOCATION OF SIGNAGE

INSTALL SIGNAGE AT WALL BESIDE DOOR AT LATCH SIDE FOR SINGLE DOOR, INSTALL SIGNAGE AT SECONDARY DOOR LEAF FOR DOUBLE DOOR. SIGNAGE MUST COMPLY WITH ALL ADA REGULATIONS INCLUDING BUT NOT LIMITED TO:

3.1. HEIGHT ABOVE FINISH FLOOR (SEE DOOR SCHEDULE SHEET) 3.2. CHARACTERS

3.3. PICTOGRAMS 3.4. BRAILLE

3.5. FINISH PROVIDE UNIVERSAL PICTOGRAM FIGURES FOR RESTROOM

4.1. MAN FIGURE AT MEN'S RESTROOMS

4.2. WOMAN FIGURE AT WOMEN'S RESTROOMS


4.3. MAN AND WOMAN FIGURE AT FAMILY / UNISEX RESTROOMS

4.4. WHEELCHAIR / HANDICAP FIGURE AT ALL RESTROOMS

4.5. SHOWER SYMBOL AT ALL RESTROOMS WITH SHOWER PROVIDE ALL MANUFACTURER DRAWINGS FOR APPROVAL PRIOR TO INSTALL.

J00

SIGNAGE SYMBOL

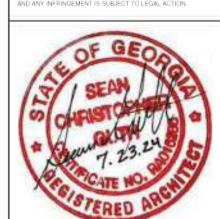

SUBMITTALS / REVISIONS

NO DATE DESCRIPTION A3 04/21/2023 Addendum 3 A4 04/28/2023 Addendum 4 06/13/2023 Permit Revisions 7/15/2024 VE Changes

DING


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CONFORMED SET

MAINTENANCE FACILITY FLOOR PLAN

PROJECT NO. 09/19/24 22010 DRAWN BY SCALE STAFF 1/4" = 1'-0" CHECKED BY

SHEET NO.

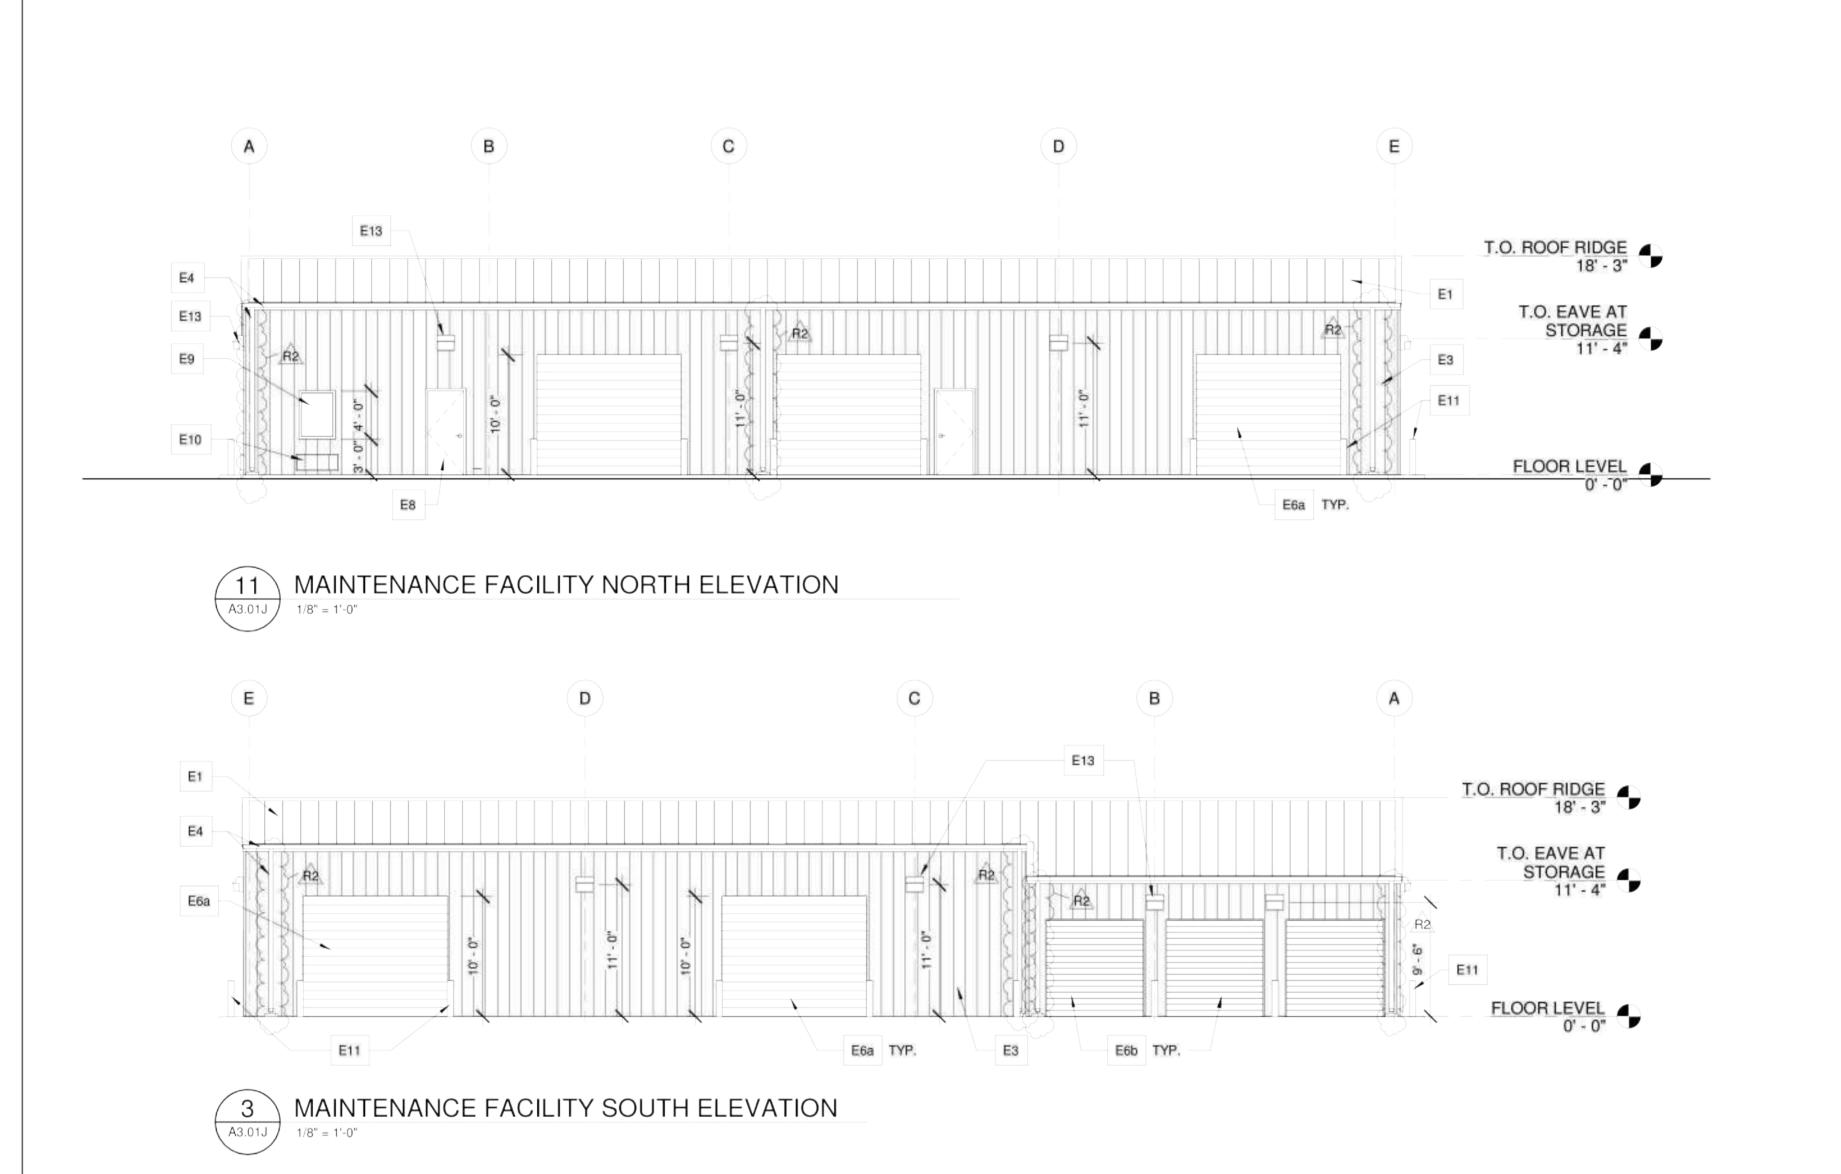

PRE-FINISHED GALV. STEEL SECTIONAL SERVICE DOOR. - SEE DOOR SCHEDULE

E7 PRE-FINISHED GRAVITY VENTILATOR AT ROOF, TYP. - SEE MECH


HOLLOW METAL DOOR AND FRAME, PAINTED, TYP. - SEE DOOR SCHEDULE


WINDOW & HOLLOW METAL WINDOW FRAME PAINTED, TYP. - SEE WINDOW SCHEDULE

SEE SHEET A8 SERIES FOR WINDOW SCHEDULE & DETAILS.

10. SEE SHEET A9 SERIES FOR ARCHITECTURAL WOODWORK

AND FINISH LEGEND.

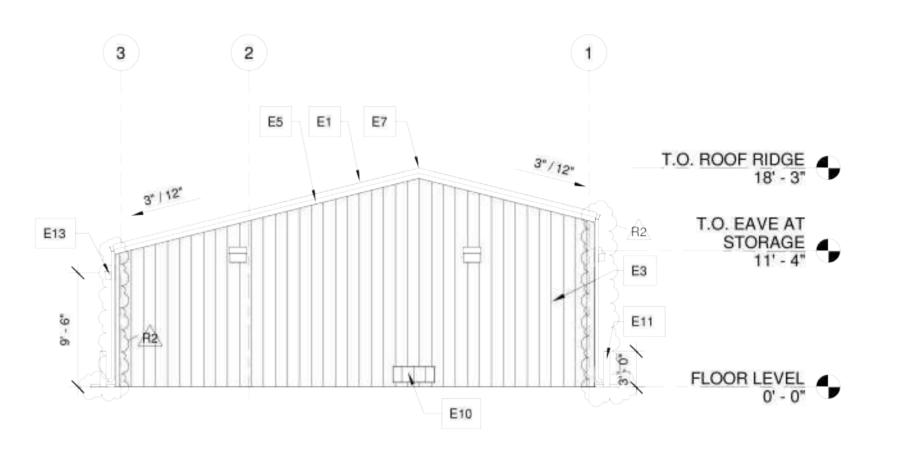

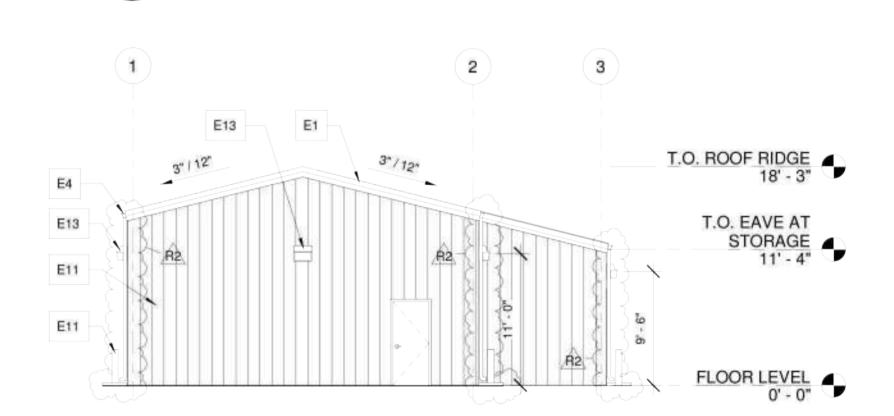

MAINTENANCE FACILITY EAST ELEVATION

(2) A3.01J


1/8" = 1'-0"



2. ELEVATION MARKS TO BE VERIFIED IN FIELD WITH MATERIAL AND ASSEMBLY DIMENSIONS. E2 PRE-FINISHED ALUMINUM DRAINABLE LOUVER W/INSECT SCREEN. TYP. E3. DIMENSIONS ARE FROM FINISH FLOOR, (U.N.O.) E4. SEE STRUCTURE FOR ALL FOOTING & SLAB REQUIREMENTS. 5. SEE SHEET A4 SERIES FOR WALL SECTIONS & DETAILS. 6. SEE SHEET A6 SERIES FOR RCP. E11 STEEL BOLLARD, CONCRETE FILLED, PAINTED, PROVIDE DRY OWNER. E12 PRE-FINISHED ALUMINUM DRAINABLE LOUVER W/INSECT SCREEN. TYP. E13 STEEL COLUMN AND BEAM FRAME, PAINTED, PROVIDE BY OWNER. E12 STEEL COLUMN AND BEAM FRAME, PAINTED, PROVIDE PROV	GENERAL NOTES	ELEVATION KEYNOTES		FINISH NOTES	EXTERIOR FINISH SC	HEDULE	
COLOR SCHEDIII E NOTES	2. ELEVATION MARKS TO BE VERIFIED IN FIELD WITH MATERIAL AND ASSEMBLY DIMENSIONS. 3. DIMENSIONS ARE FROM FINISH FLOOR. (U.N.O.) 4. SEE STRUCTURE FOR ALL FOOTING & SLAB REQUIREMENTS.	PRE-FINISHED ALUMINUM DRAINABLE LOUVER W/ INSECT SCREEN. TYP. E3 PEMB. PRE-FINISHED GALV, METAL WALL PANELS, TYP.	E11 STEEL BOLLARD, CONCRETE FILLED, PAINTED. TYP SEE 3 / A4.02J E12 STEEL COLUMN AND BEAM FRAME, PAINTED, PROVIDE ZINC RICH EPOXY COAT W/ ACRYLIC URETHANE TOP COAT, TYP. E13 EXTERIOR WALL MOUNTED LIGHT FIXT, TYP SEE ELEC.	2. "E" DENOTES EPOXY 3. "X" DENOTES EXTERIOR 4. SEE SPECS FOR PRIMER AND FINISH STYLES	BEAMS & COLUMNS BOLLARDS DOORS & DOOR FRAMES GUTTER SYSTEM OVERHEAD DOORS ROOF, RIDGE VENT, CAPS TRIM WALL PANELS: EXTERIOR METAL + 2X4 + 1/2" PLYWOOD	STEEL GROUTED STEEL HOLLOW METAL PRE-FINISHED METAL STEEL PRE-FINISHED METAL PRE-FINISHED METAL PRE-FINISHED METAL	PNT-6 MTL-1 PRE-FINSHED, ARCH TO SELECT MTL-1 MTL-1
SEE SHEET A7 SERIES FOR ROOF PLANS. PRE-FINISHED GALV. STEEL OVERHEAD COILING SERVICE DOOR SEE DOOR SCHEDULE PRE-FINISHED GALV. STEEL OVERHEAD COILING SERVICE DOOR	SEE SHEET A6 SERIES FOR ROOF PLANS.	PRE-FINISHED GALV. STEEL OVERHEAD COILING SERVICE DOOR	iMAGE / VERBIAGE TO BE PROVIDED BY OWNER	COLOR SCHEDULE NOTES			

SUBMIT SPECIFIED COLORS FOR REVIEW.

SUBMIT MANUFACTURER'S STANDARD COLORS FOR REVIEW AND SELECTION FOR METAL APPLICATIONS.

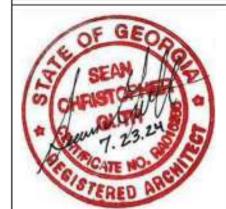

SUBMITTALS / REVISIONS

NO DATE DESCRIPTION A3 04/21/2023 Addendum 3 R2 7/15/2024 VE Changes

BUILDING

CONFORMED SET

MAINTENANCE FACILITY EXTERIOR


ELEVATIONS

PROJECT NO. DATE **09/19/24** DRAWN BY SCALE STAFF
CHECKED BY
NR

As indicated

A3.01J

SHEET NO.

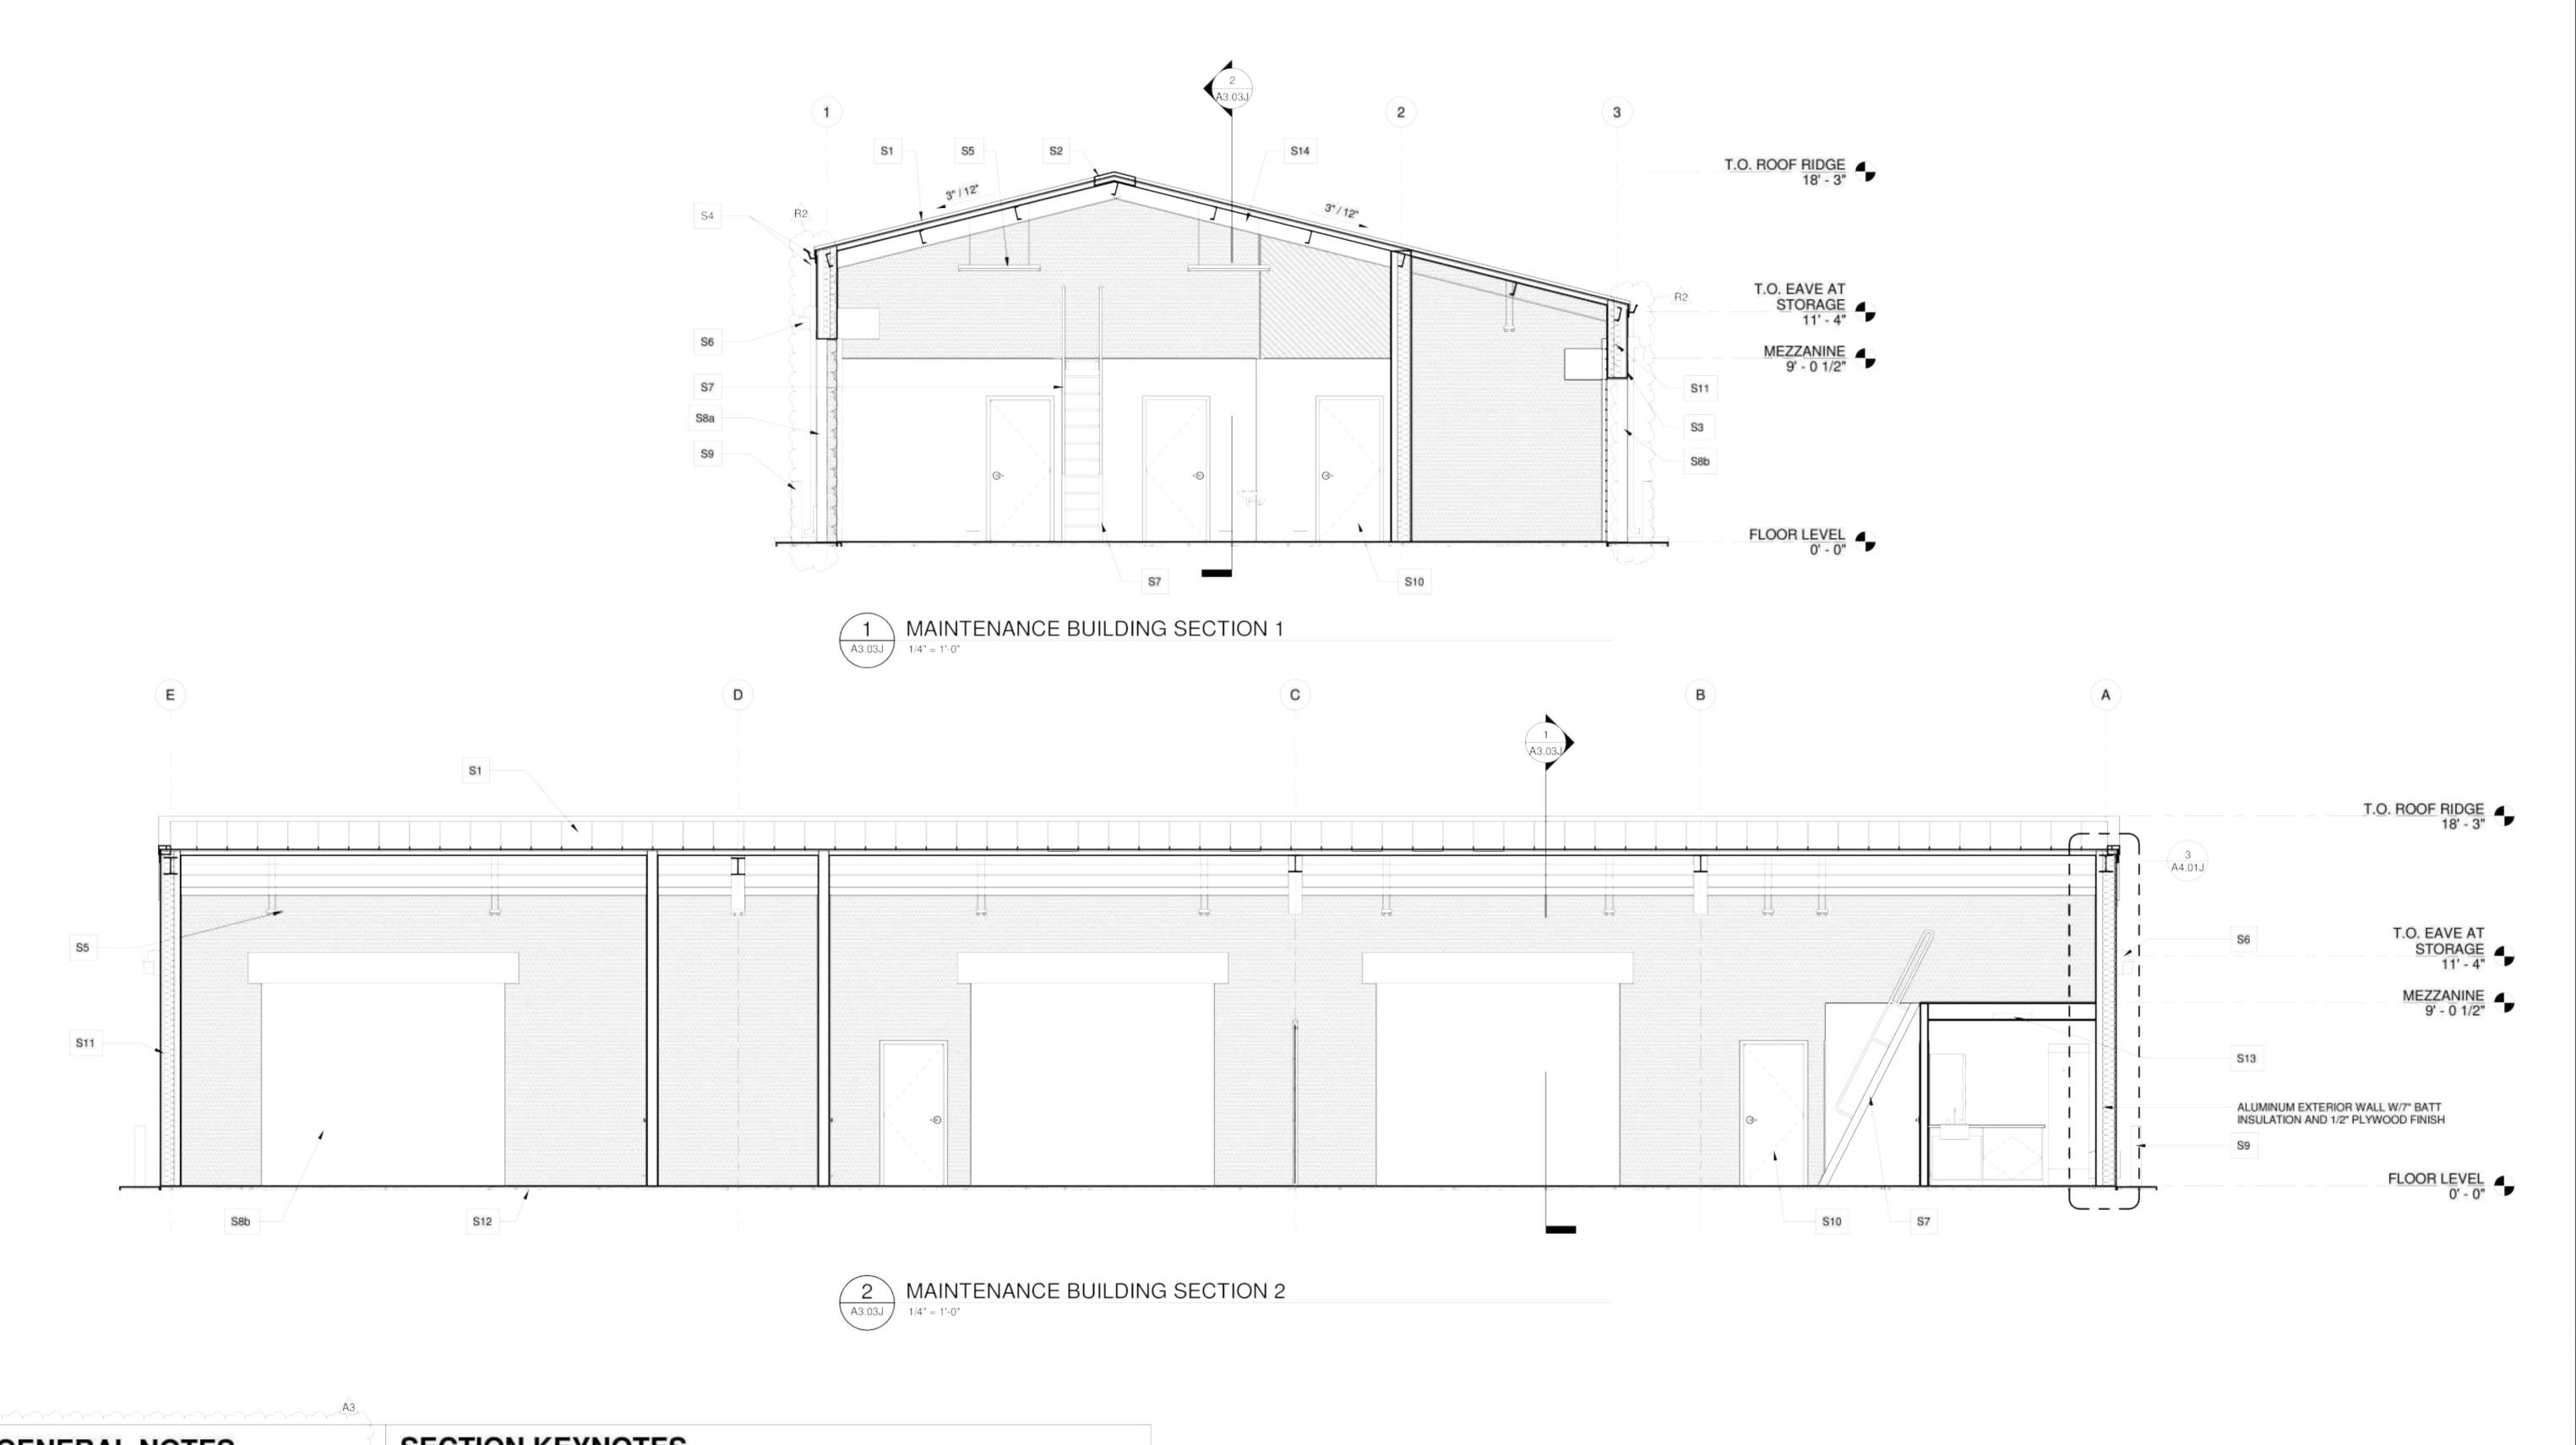

GENERAL NOTES

- ARCHITECTURAL BUILDING FFE. LISTED AS 0'-0", COORDINATE ACTUAL W/ CIVIL
- ELEVATION MARKS TO BE VERIFIED IN FIELD WITH MATERIAL AND ASSEMBLY DIMENSIONS.
- DIMENSIONS ARE FROM FINISH FLOOR. (U.N.O.)
- SEE STRUCTURE FOR ALL FOOTING & SLAB REQUIREMENTS.
- SEE SHEET A4 SERIES FOR WALL SECTIONS & DETAILS.
- SEE SHEET A6 SERIES FOR RCP.
- SEE SHEET A7 SERIES FOR ROOF PLANS.
- SEE SHEET AS SERIES FOR DOOR SCHEDULE & DETAILS.
- SEE SHEET A8 SERIES FOR WINDOW SCHEDULE & DETAILS.
- 10. SEE SHEET A9 SERIES FOR ARCHITECTURAL WOODWORK AND FINISH LEGEND.

SECTION KEYNOTES

- S1 PEMB, PRE-FINISHED GALV, METAL ROOFING, 3/12 SLOPE, TYP.
- S2 METAL ROOF CAP
- S3 PEMB. PRE-FINISHED GALV. METAL WALL PANELS, TYP.
- S4 5X5 PRE-FIN. ALUM GUTTER & 4X4 DOWNSPOUT SYSTEM, TYP. R2 S13 RECESSED LIGHT SEE ELEC.
- S5 LINEAR HANGING LIGHTS, TYP.
- S6 EXTERIOR WALL PACK LIGHT SEE ELECT.
- S7 METAL SHIP LADDER
- PRE-FINISHED GALV, STEEL OVERHEAD COILING SERVICE DOOR. SEE DOOR SCHEDULE
- S9 STEEL BOLLARD, CONCRETE FILLED, PAINTED. TYP. SEE 3/A4.02J


PRE-FINISHED GALV. STEEL SECTIONAL SERVICE DOOR. - SEE DOOR SCHEDULE

SINGLE WOOD DOOR AND FRAME, PAINTED. TYP. - SEE MECH. S11 W/7* BATT INSULATION

S12 CONCRETE SLAB, BROOM FINISH - SEE STRUC

STEEL COLUMN AND BEAM FRAME, PAINTED. PROVIDE ZINC RICH EPOXY COAT W/ ACRYLIC URETHANE TOP COAT. TYP.

SHEET NO.

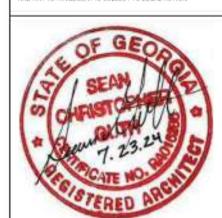


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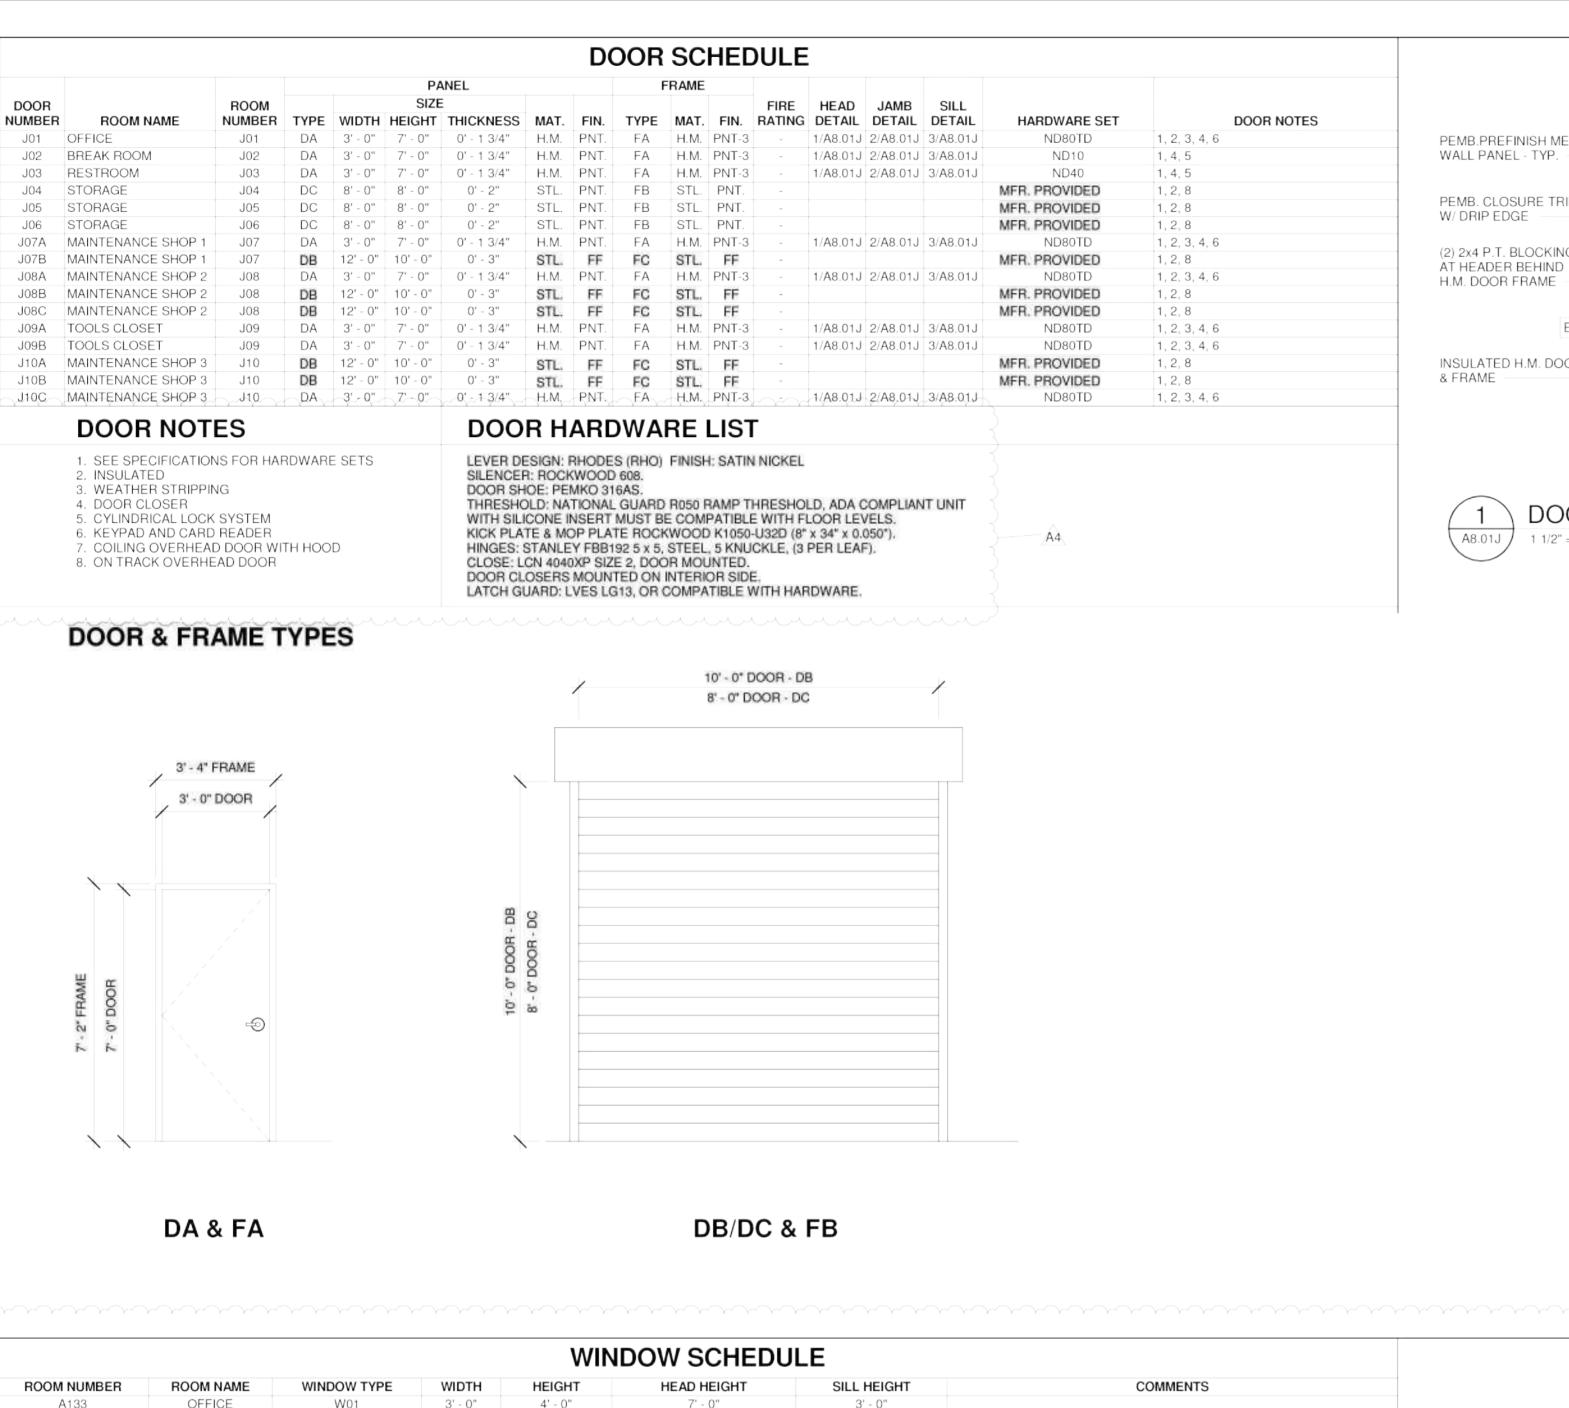
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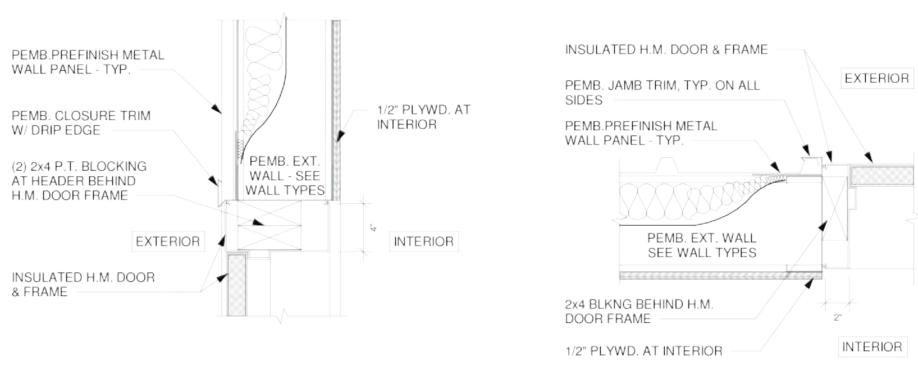
SUBMITTALS / REVISIONS NO DATE DESCRIPTION A3 04/21/2023 Addendum 3 R2 7/15/2024 VE Changes CONFORMED SET

> MAINTENANCE **BUILDING SECTIONS**

PROJECT NO. DATE **09/19/24** DRAWN BY SCALE STAFF CHECKED BY As indicated NR





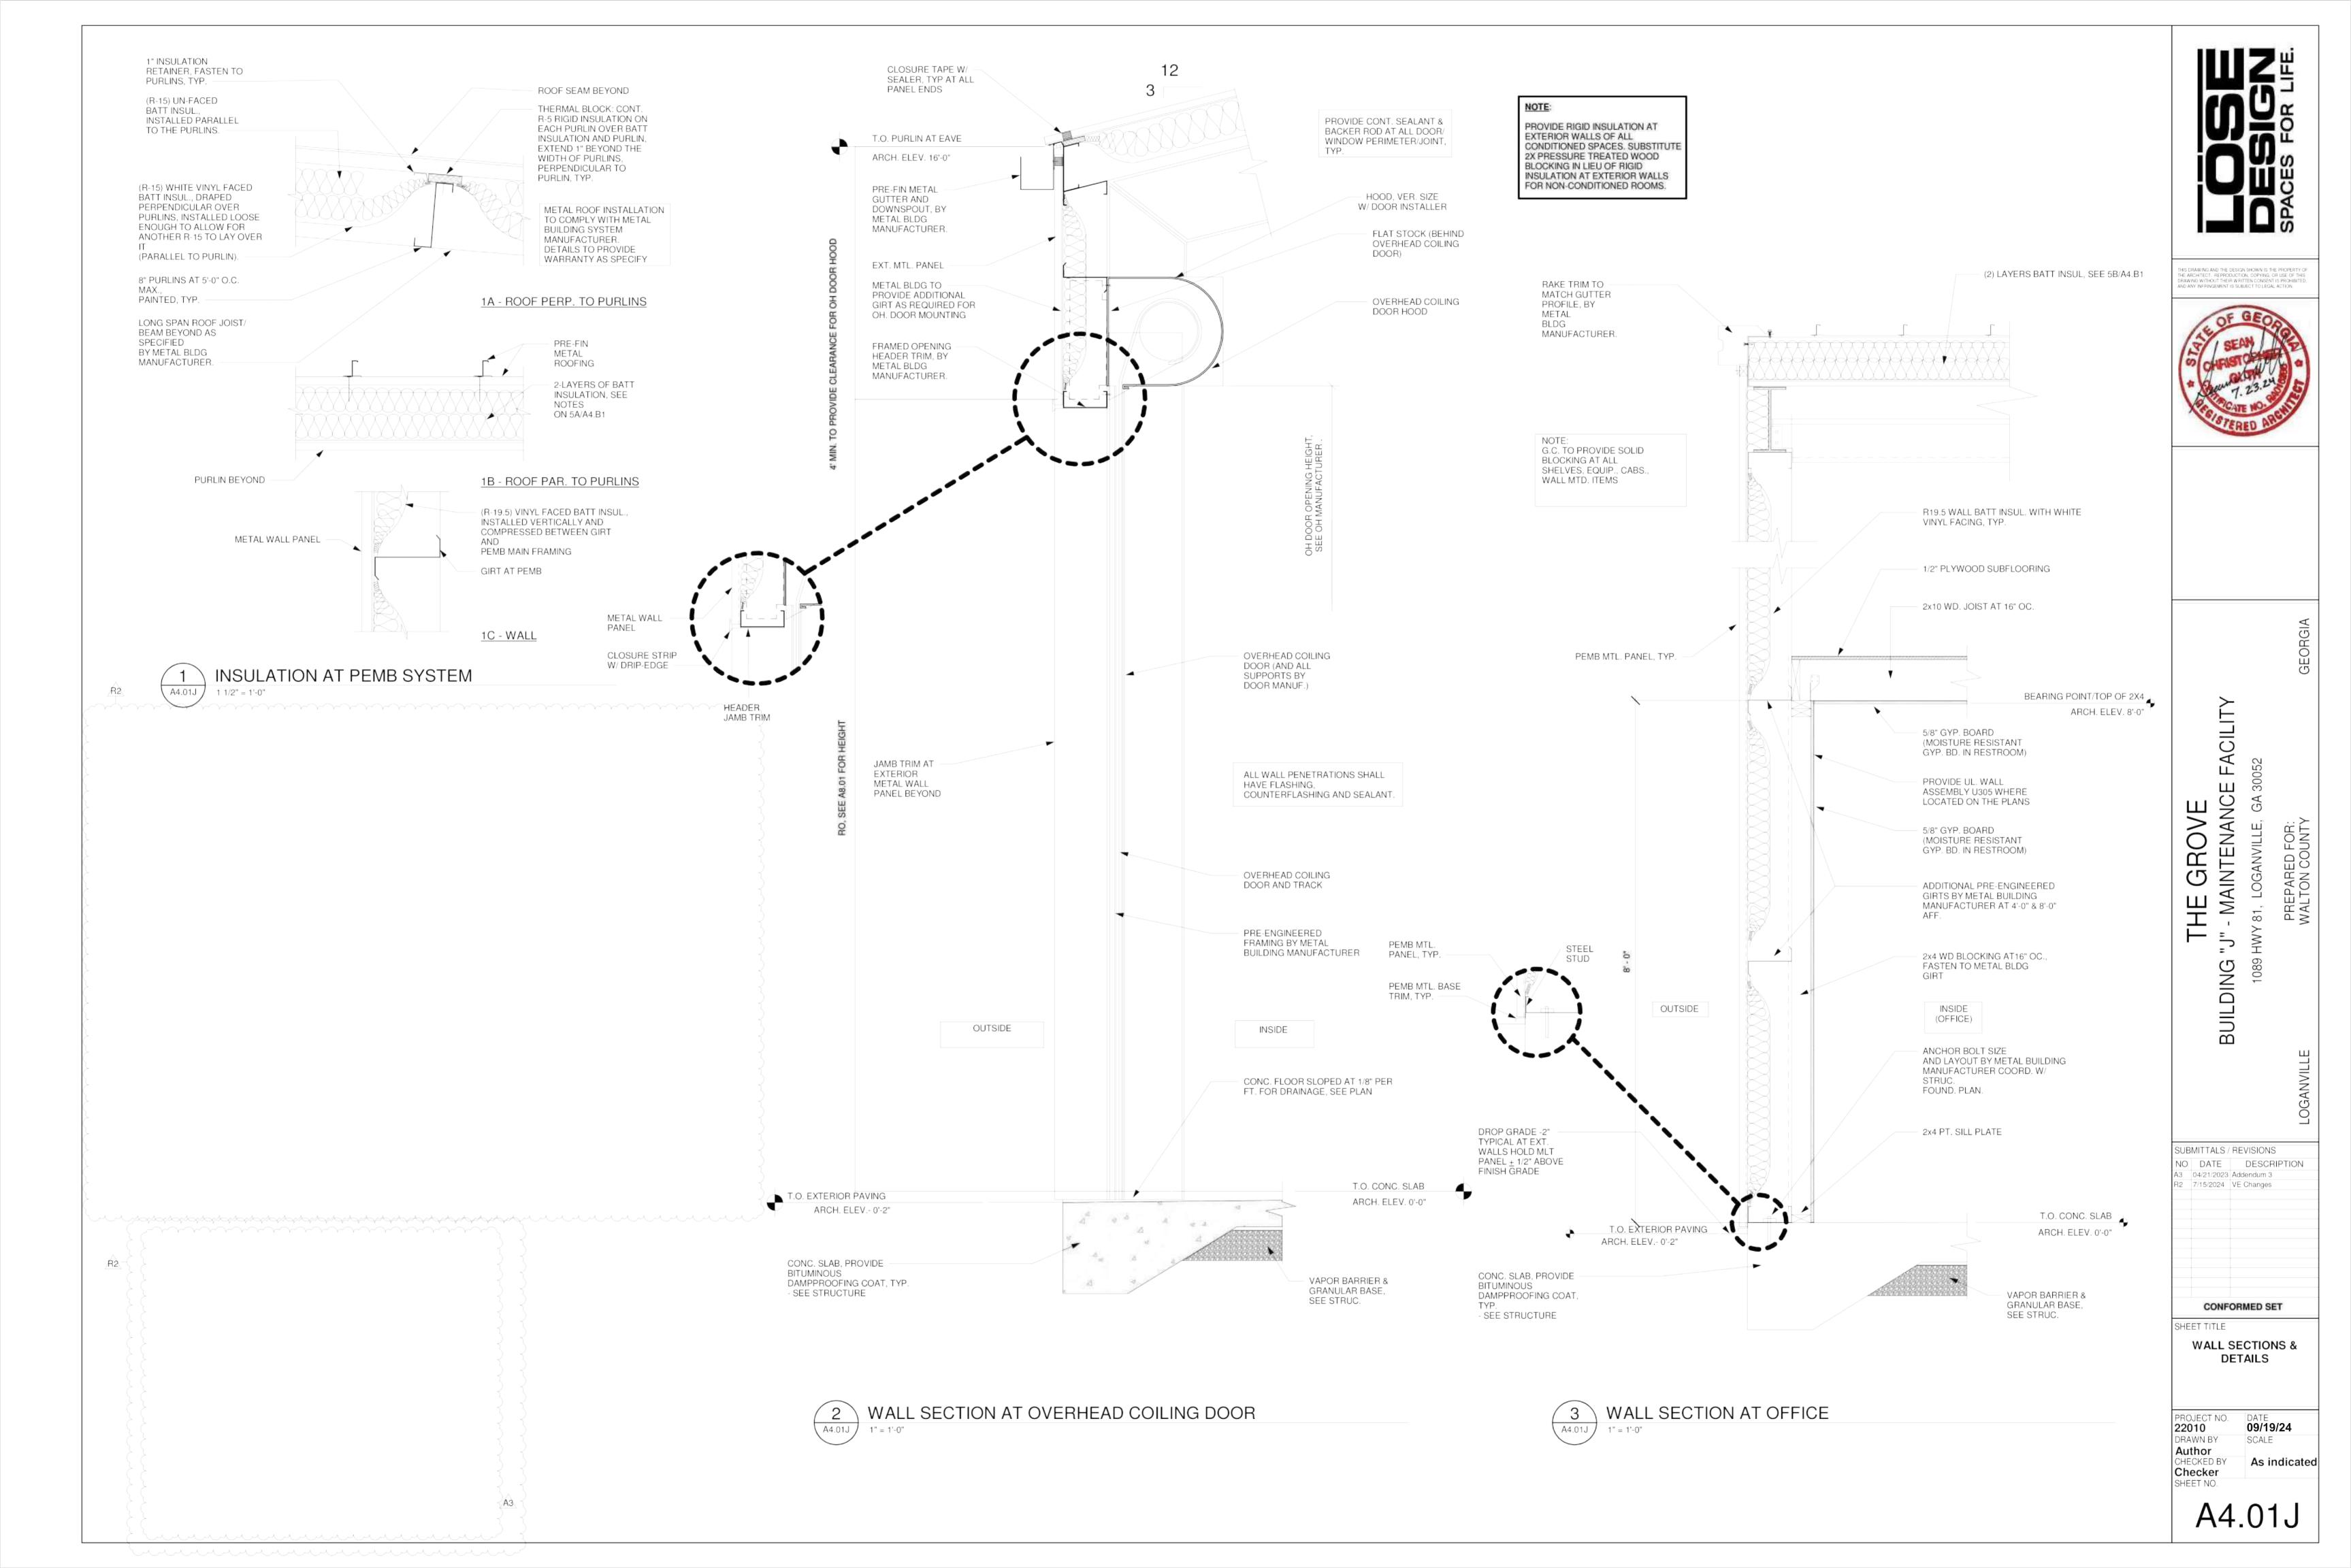


A8.01J

1 1/2" = 1'-0"

DOOR JAMB DETAIL

1 DOOR HEAD DETAIL
1 1/2" = 1'-0"

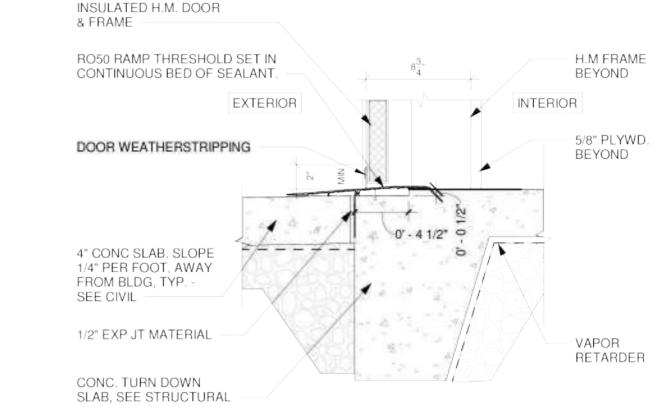

3 DOOR SILL DETAIL
1 1/2" = 1'-0"

DRAWING WITHOUT THEIR WRITTEN CONSENT IS PROHIBITED, AND ANY INFRINGEMENT IS SUBJECT TO LEGAL ACTION.

FERED ARGE

ARED FOR: ON COUNTY

HWY 81, LOGANVILL
PREPARED FO

ANVILLE

EVISIONS

DESCRIPTION

ddendum 4

SUBMITTALS / REVISIONS

NO DATE DESCRIPTION

A4 04/28/2023 Addendum 4

R2 7/15/2024 VE Changes

CONFORMED SET

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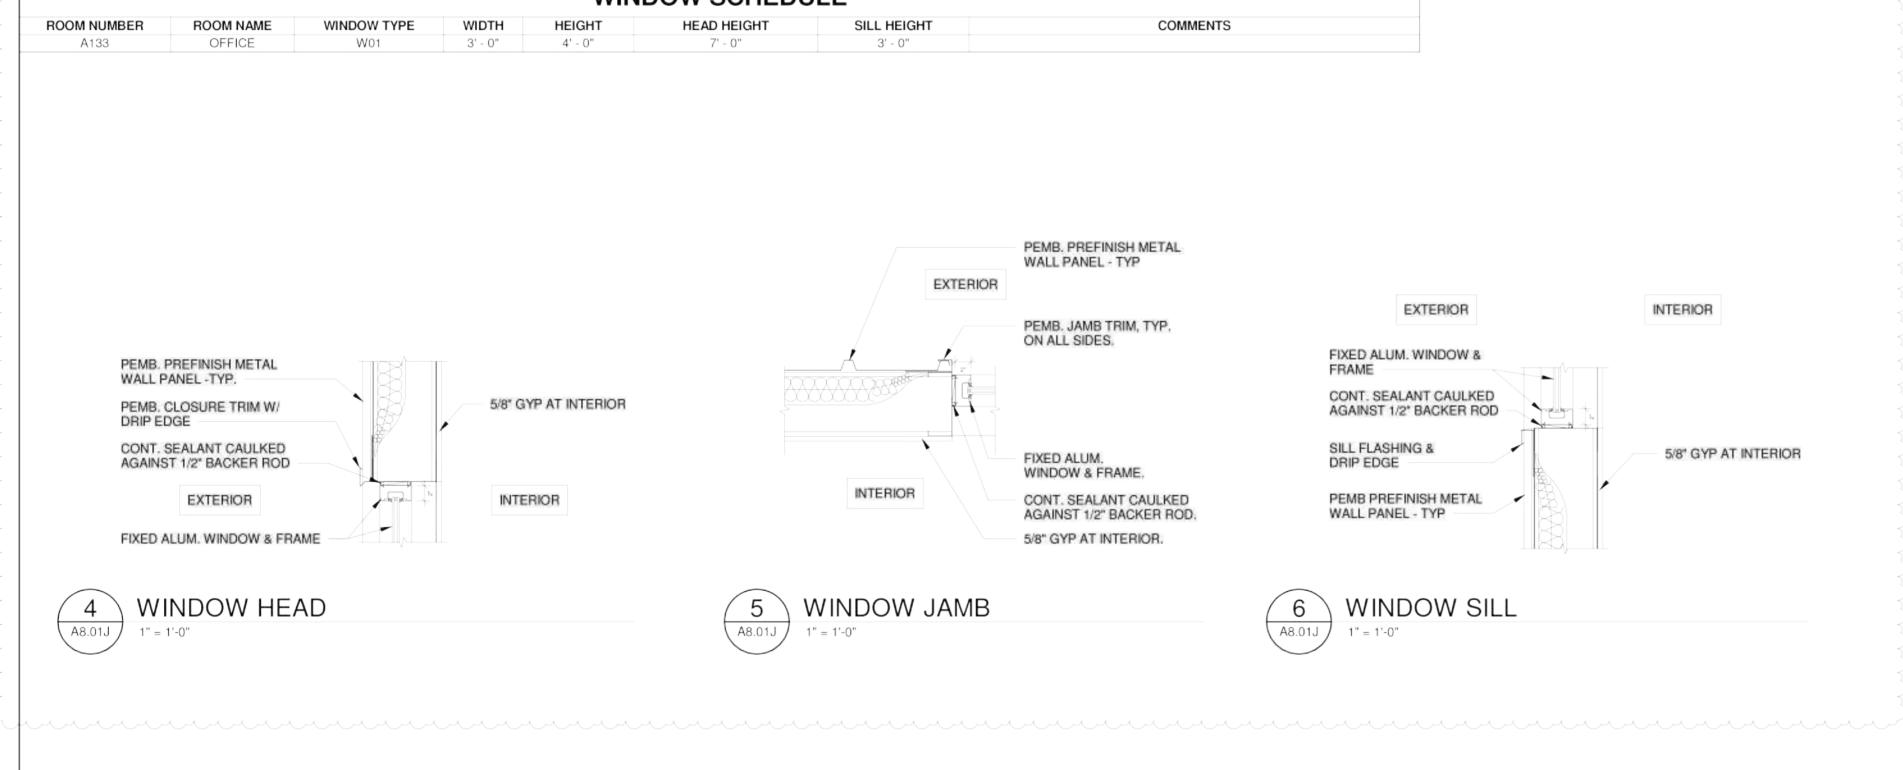
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CONFORMED SET

DOOR SCHEDULE, WINDOW INFORMATION, AND DETAILS

PROJECT NO. DATE 09/19/24
DRAWN BY SCALE STAFF CHECKED BY NR SHEET NO.

A8 01.



	Branch Panel: J Location: OFFICE J01 Supply From: Mounting: SURFACE Enclosure: NEMA 1					Volts: Phases: Wires:		3 Wye				A.I.C. Rating: 22,000 Mains Type: MLO Mains Rating: 400.00 A	
CKT	Circuit Description	Trip	Poles		A		В		С	Poles	Trip	Circuit Description	CK
1	LIGHTING	20 A	1 1	732	720	5.40	540		-	1	20 A	RCPT - RR/STORAGE	2
3	R2 RCPT - MAINT, SHOP 1 +	20 A	1	-	-	540	540	200	400	1	20 A	RCPT - OFFICE	4
5 7	RCPT - MAINT, SHOP 2 +	20 A	1	200	540			360	180	1	20 A	BREAKROOM TV + R2	6
	RCPT - MAINT, SHOP 3 +	20 A		360	540	000	4500		-	1	20 A	RCPT - BREAKROOM	8
9	EXTERIOR RECPTS	20 A	1		-	900	1500	167	0	1	20 A	AUTOMATIC FLUSH VALVES SPARE	10
13	AIR COMPRESSOR	30 A	3	167	2450	-	-	167	U	- '	20 A	SPARE	12
15	AIR CONFRESSOR	30 A	3	107	2450	167	2450		-	2	20 A	PTHP-1	16
17						107	2450	750	2450				18
19	AIR COMPRESSOR	20 A	2	750	2450	_		730	2430	2	20 A	PTHP-2	20
21				730	2430	2250	750		-				22
23	30A RECPT	30 A	2			2230	730	2250	750	2	20 A	AIR COMPRESSOR	24
25				750	750			2230	730				26
27	AIR COMPRESSOR	20 A	2	7 30	730	750	750		-	2	20 A	AIR COMPRESSOR	28
29	R2 COUNTER RECEPTACLE +	20 A	1		-	730	730	540	540	1	20 A	COUNTER RECEPTACLE +	30
31	COUNTER RECPTACLE +	20 A	1	540	540			340	340	1	20 A	COUNTER RECEPTACLE + R2	32
33	STORAGE RECEPTACLE	20 A	1	340	340	540	540		_	1	20 A	STORAGE RECPTALE	34
35	STORAGE RECEITABLE	20 A	'		-	340	340	2250	2250	-	20 /	STORAGE RECFTALE	36
37	30A RECEPT	30 A	2	2250	2250	-		2230	2230	2	30 A	30A RECPT	38
39				2200	2230	2250	2250		-				4(
41	30A RECPT	30 A	2		-	2230	2230	2250	2250	2	30 A	30A RECPT	42
43				750	750			2230	2230				44
45	AIR COMPRESSOR	20 A	2	7 50	7 30	750	750		-	- 2	20 A	AIR COMPRESSOR	46
47	EF-5	20 A	1			700	700	23	100	1	20 A	EF-2	48
49	EF-6	20 A	1	23	100			20	100	1	20 A	EF-3	50
51	EF-7	20 A	1	20	100	23	100			1	20 A	EF-4	52
53	UH-5	20 A	1		-	20	100	100	100	1	20 A	UH-4	54
55	UH-1	20 A	1	100	100			100	100	1	20 A	UH-2	56
57	UH-3	20 A	1	100	,,,,,	100	100			1	20 A	UH-6	58
59	UH-7	25 A	1					100	1800				60
61				7800	1800					2	40 A	WH-1	62
63	WH-2	100 A	2			7800	329			1	20 A	EXTERIOR LIGHTING	64
65	SPARE	20 A	1					0	250				66
67	SPARE	20 A	1	0	250					2	20 A	AIR COMPRESSOR	68
69	SPARE	20 A	1	11 22		0	180			1	20 A	TELEPHONE RACK	70
71	SPARE	20 A	1					0	0	1	20 A	SPARE	72
73	SPARE	20 A	1	0	0					1	20 A	SPARE	74
75	SPARE	20 A	1			0	0			1	20 A	SPARE	76
77	SPARE	20 A	1			-		0	0	1	20 A	SPARE	78
79	SPARE	20 A	1	0	0					1	20 A	SPARE	80
81	SPARE	20 A	1			0	0			1	20 A	SPARE	82
83	SPARE	20 A	1			1		0	0	1	20 A	SPARE	84
			tal Load:	2693	21 VA	2630	08 VA	1945	59 VA				
			al Amps:		.12 A		.02 A		.16 A				
Load Cla	assification	-	nnected I			mand Fa		1	nated D	emand		Panel Totals	
LIGHTIN			1038 VA			125.00%		2500	1298 V			Total Conn. Load: 72689 VA	
RECEPT			7560 VA			100.00%			7560 V			Total Est. Demand: 72949 VA	
HVAC			9799 VA			100.00%			9799 V			Total Conn. Current: 201.77 A	
HEATING	G		0 VA	_		0.00%			0 VA	-	Tota	al Est. Demand Current: 202.49 A	
KITCHE			0 VA			0.00%			0 VA		-	Coinc. Heat/AC Current: 27.20 A	
	ST MOTOR		0 VA			0.00%			0 VA			st. Demand Current-NC: 202.49 A	
MOTOR			19992 V	Ą		100.00%	, 0		19992 V	Ά		Il Est. Demand Load-NC 72949 VA	
				2	-	0.00/			V		. 0.00		

100.00%

+ DENOTES PROVIDE GFCI CIRCUIT BREAKER

34300 VA

DENOTES PROVIDE AFCI CIRCUIT BREAKER

MECHANICAL EQUIPMENT CONNECTION SCHEDULE												
UNIT TYPE MARK	UNIT INDENTIFIER	PANEL NAME	CIRCUIT NUMBER	FEEDER SIZE	DISCONNECTING MEANS	LOAD	NOTES					
EF	1	J	1	2#12,1#12(G),1/2"C.	MRS	23.00 W	1, 3					
EF	2	J	48	2#12,1#12(G),1/2"C.	MRS	100W	1					
EF	3	J	50	2#12,1#12(G),1/2"C.	MRS	100W	1					
EF	4	J	52	2#12,1#12(G),1/2"C.	MRS	100W	1					
EF	5	J	47	2#12,1#12(G),1/2"C.	MRS	23.00 W	1, 3					
EF	6	J	49	2#12,1#12(G),1/2"C.	MRS	23.00 W	1, 3					
EF	7	J	51	2#12,1#12(G),1/2"C.	MRS	23.00 W	1, 3					
PTHP	1	J	14,16	2#12,1#12(G),1/2"C.	MRS	2828 KW	1					
PTHP	2	J	18,20	2#12,1#12(G),1/2"C.	MRS	2828 KW	1					
UH	1	J	55	2#12,1#12(G),1/2"C.	MRS	100W	1					
UH	2	J	56	2#12,1#12(G),1/2"C.	MRS	100W	1					
UH	3	J	57	2#12,1#12(G),1/2"C.	MRS	100W	1					
UH	4	J	54	2#12,1#12(G),1/2"C.	MRS	100W	1					
UH	5	J	53	2#12,1#12(G),1/2"C.	MRS	100W	1					
UH	6	J	58	2#12,1#12(G),1/2"C.	MRS	100W	1					
UH	7	J	59	2#10,1#10(G),3/4"C.	30/2/1/NF	2 KW	1					
WH	1	J	60,62	2#8,1#10(G),3/4"C.	60/2/1/NF	6.2 KW	1					
WH	2	J	61,63	2#3,1#8(G),1"C.	100/2/1/NF	15.6 KW	1					

34300 VA


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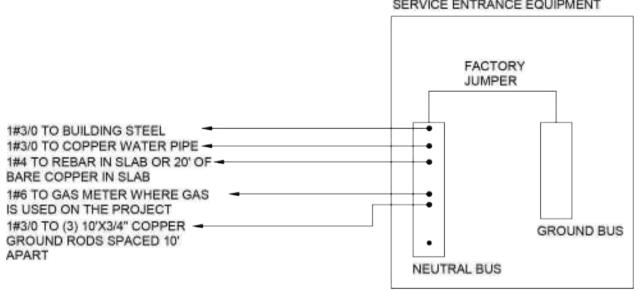
MISCELLANEOUS

THER CONTINUOUS

* DENOTES PROVIDE LOCK-ON CIRCUIT BREAKER

- PROVIDE OVERCURRENT PROTECTION AND BRANCH CIRCUITS PER UL LISTED REQUIREMENTS FOR EQUIPMENT SERVED. REFER TO MANUFACTURER DATA AND EQUIPMENT CUT-SHEETS FOR ROUGHIN LOCATIONS OF ELECTRICAL CONNECTIONS AND INTERCONNECTIONS FOR ALL EQUIPMENT, COORDINATE EXACT NAMEPLATE DATA OF EQUIPMENT BEING INSTALLED WITH MECHANICAL CONTRACTOR. THIS MEANS FOR THE ELECTRICAL CONTRACTOR TO MEET WITH THE MECHANICAL CONTRACTOR AND ACQUIRE A COPY OF THE SHOP DRAWINGS FOR THE EXACT PIECES OF EQUIPMENT THAT WILL BE INSTALLED. THE ELECTRICAL CONTRACTOR SHALL COMPARE THE MANUFACTURER'S DATA SHEETS FOR THE ACTUAL EQUIPMENT THAT IS BEING USED WITH THE ELECTRICAL PLANS PRIOR TO ORDERING THE ELECTRICAL GEAR. IF THERE ARE ANY DIFFERENCES BETWEEN WHAT THE MECHANICAL CONTRACTOR IS PLANNING TO USE AND WHAT THE ELECTRICAL PLANS INDICATE, THE ELECTRICAL CONTRACTOR SHALL BRING THE DISCREPANCIES TO THE ATTENTION OF THE GENERAL CONTRACTOR AND THE CONTRACTORS SHALL WORK OUT ANY ADDITIONAL MONIES REQUIRED WITHOUT ANY COST TO THE OWNER, IF THIS ON SITE COORDINATION DOES NOT HAPPEN, IT WILL BE ASSUMED THAT THE ELECTRICAL CONTRACTOR SHALL ABSORB ANY AND ALL COSTS THAT MAY BE ASSOCIATED WITH THE MECHANICAL CONTRACTOR'S EQUIPMENT. NOTE THAT THE MECHANICAL CONTRACTOR MAY USE DIFFERENT MANUFACTURERS THAN THE DESIGN INTENT PLANS INDICATE AND THESE DIFFERENT MANUFACTURERS MAY HAVE DIFFERENT ELECTRICAL REQUIREMENTS.
- 2. DUCT SMOKE DETECTORS SHALL BE FURNISHED BY MECHANICAL CONTRACTOR, INSTALLED BY ELECTRICAL CONTRACTOR AND CONNECTED BY ELECTRICAL CONTRACTOR. EC SHALL FURNISH AND INSTALL REMOTE ANNUNCIATORS VISIBLE IN THE CEILING BELOW FOR THE SMOKE DUCT DETECTORS IN THIS EQUIPMENT.
- 3. EXTEND AND CONNECT EXHAUST FAN TO LOCAL LIGHTING CIRCUIT WITHIN THIS ROOM. FAN SHALL BE CONTROLLED BY LOCAL LIGHT SWITCH AND SWITCHED WITH THE LIGHTS.
- 4. INDOOR UNIT POWERED FROM OUTDOOR UNIT. PROVIDE WITH MRS ON INDOOR UNIT IN ORDER TO COMPLY WITH CODE.



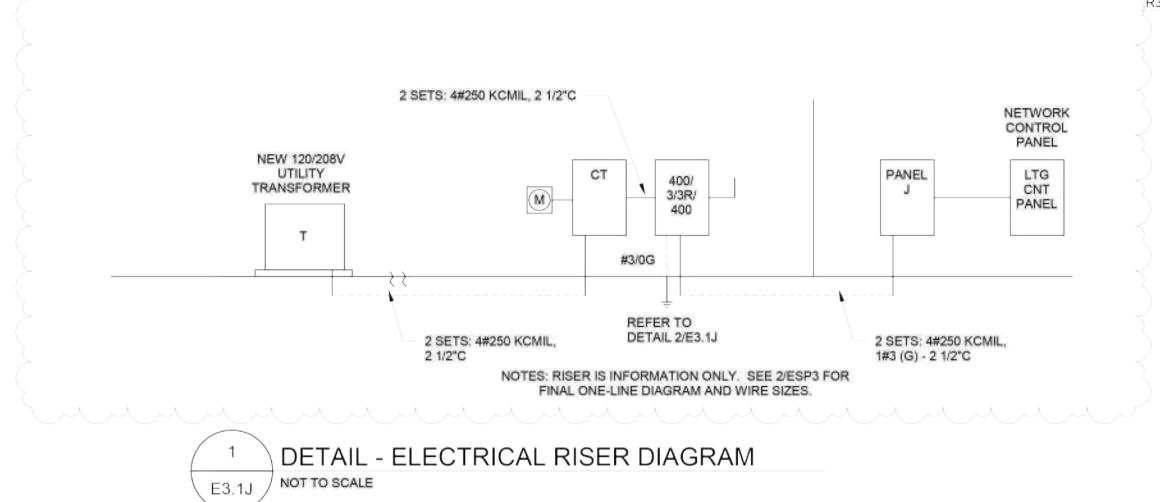

1. PROVIDE TEST WELL FOR EACH GROUND ROD. 2. ALL CONNECTORS SHALL BE UL LISTED NON-REVERSIBLE TYPE OR CADWELDS. 3. PROVIDE (3) ADDITIONAL DRILLED HOLES IN BUS BAR FOR FUTURE USE. 4. ALL ISOLATED GROUND CONDUCTORS SHALL TERMINATE ON THE GROUND BUS.

5. PROVIDE #6 JUMPER ACROSS ANY WATER METER OR WATER FILTER.

EXTERIOR EMERGENCY LIGHT TO BE NORMALLY OFF

EXIT/EMERGENCY COMBO, MOUNT AND ADD FACES AND

LED WALL PACK TO BE ON AT NIGHT

ARROWS AS SHOWN

∖ E3.1J /

LIGHTING CONTROL SCHEDULE CIRCUITS CONTROLLED TYPE OF LIGHTING SCHEDULE BUILDING MOUNTED RELAYS RELAYS STREET POLES SIGNAGE RELAYS HP2-4,6 RELAYS SEASONAL RECPTS

NOTES: 1. ALL CIRCUITS ARE ROUTED THRU RELAYS IN LIGHTING CONTROL PANEL.

EMER/DECO-DBR-LT-D

ELX-627

OWP-FC-211-LED-7500L-DIM10-MVOLT-40K-BZ

LIGHTING FIXTURE SCHEDULE **FIXTURE** MARK MANUFACTURER MODEL VOLTAGE LAMP DESCRIPTION 24-OVHP-LED-4000L-DIM10-MVOLT-40K-85 ARCHITECTURAL RECESSED LED 2X4. PROVIDE ELITE LIGHTING 120 V 37W LED GRID/FLANGE MOUNT KIT WHERE APPLICABLE. ELITE LIGHTING 4-OC1-LED-3000L-DIM10-MVOLT-35K-85 120 V 25W LED 4' LED STRIP LIGHT 2-OC1-LED-3000L-DIM10-MVOLT-35K-85 2' LED STRIP LIGHT ELITE LIGHTING 120 V 23W LED ELITE LIGHTING ELM-LED-803 STANDARD EMERGENCY LIGHT 120 V INCLUDED

5W LED

56W LED

INCLUDED

120 V

120 V


120 V

COORDINATE FINISHES WITH ARCHITECT.

HE WILLIAMS

ELITE LIGHTING

ORACLE

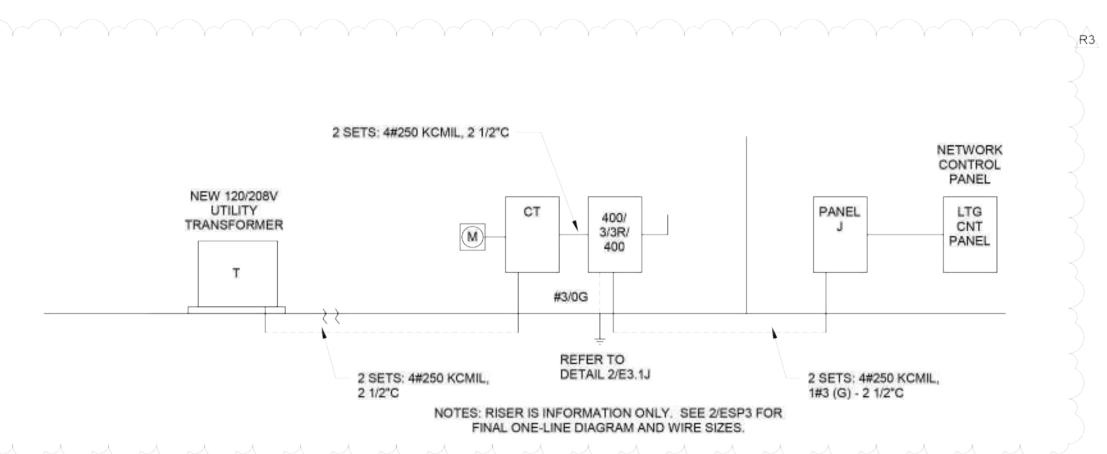

SERVICE ENTRANCE EQUIPMENT

DETAIL - SERVICE ENTRANCE GROUNDING

SUBMITTALS / REVISIONS NO DATE DESCRIPTION 06/13/23 PERMIT REVISIONS 09/19/24 VE Conformed Set

DING

BUIL

CONFORMED SET

DETAILS & SCHEDULES - ELECTRICAL

PROJECT NO. 22010 09/19/24 DRAWN BY SCALE SSH CHECKED BY As indicated SWL SHEET NO. SHEET ___OF_40

SAVANT Engineering, LLC 5064 Roswell Road, Suite D-301 Sandy Springs GA 30342 770.319.7400 Project 22140 ©2022 COA#: PEF004211 EXPIRES: 6/30/2024

	ELECTRIC WATER HEATER SCHEDULE									
	TAG	TANK SIZE	KW	VOLT/PHASE	RECOVERY	SET POINT	BASIS OF DESIGN	LOCATION	NOTES	
	<u>WH-1</u>		6.2	208/1		110F	CHRONOMITE M-30-L	TOILET ROOM(S)		
R3	WH-2		15.6	208/1		110F	CHRONOMITE R-75L/208	BREAK ROOM J02		
	WH-3		15.6	208/1		110F	CHRONOMITE R-75L/208	MAINT. SHOP1 J07		

NOTE	E TO GENER	AL CONTRACT	OR (GC) AND	SUB-CONTI	RACTORS: N	MECHANICA	L, PLUMBIN
AND	ELEVATOR	SUBMITTALS S	HALL HAVE A	N APPROVA	L SIGNATUR	RE FROM T	HE
ELEC	CTRICAL SUB	CONTRACTOR	RINDICATING	THAT THE E	LECTRICAL	CONTRAC	TOR HAS
REVI	EWED THE S	SUBMITTALS A	ND HAS COM	PARED THE	ELECTRICA	LREQUIRE	MENTS OF
THE	SUBMITTED	EQUIPMENT W	VITH THE PLA	NS AND HAS	MADE ANY	REQUIRED)
ADJU	JSTMENTS 1	O THE ELECT	RICAL GEAR.	ANY MECHA	NICAL OR F	LUMBING	SUBMITTAL
THAT	THAS A POV	VER REQUIREM	MENT THAT IS	SUBMITTED	WITHOUT	THE SIGNA	TURE
		HE ELECTRICA					


PLUMBING LEGEND SANITARY LINE COLD WATER HOT WATER HOT WATER RETURN VENT PIPE - - - - -STORM LINE BALL VALVE \bowtie GATE VALVE FLOOR CLEANOUT FLOOR CLEANOUT FCO VTR VENT THRU ROOF PIPE UP \circ PIPE DOWN ତ _{RD} **ROOF DRAIN**

PLUMBING NOTES

- 1. PLUMBING SHALL BE IN ACCORDANCE WITH 2018 INTERNATIONAL PLUMBING CODE AND APPLICABLE LOCAL CODES.
- FURNISH APPROPRIATE ADAPTERS FOR CONNECTION OF DISSIMILAR PIPING
- 4. ALL EXTERIOR GAS PIPE SHALL BE PAINTED W/ BLACK RUST INHIBITIVE PAINT.


FLOOR CLEANOUT EQUAL TO JAY R. SMITH MODEL 4020.

- WATER PIPE SHALL BE TYPE "L" HARD DRAWN COPPER WITH 95-5 LEAD FREE SOLDER JOINTS,
- 6. PIPE HANGERS FOR WATER PIPE SHALL BE EQUAL TO PHD 155 WITH INSULATION SHIELD.
- 7. TEST WATER PIPING AT A HYDROSTATIC PRESSURE OF 125 PSI AND HOLD FOR TWENTY-FOUR
- 8. ALL DOMESTIC COLD WATER, HOT WATER RETURN, & HOT WATER PIPE SMALLER THAN 1-1/2" SHALL BE INSULATED WITH 1" THICK FIBERGLASS PIPE INSULATION WITH ALL SERVICE JACKET. HOT WATER & HOT WATER RETURN PIPE 1-1/2" AND GREATER SHALL SHALL HAVE 1-1/2" THICK FIBERGLASS PIPE INSULATION AS DESCRIBED.
- 9. DOMESTIC WATER SHUT-OFF VALVES SHALL BE WATTS SERIES FBV-4 FOR HOT & COLD WATER PIPE, ACCEPTABLE MANUFACTURES ARE WATTS, NIBCO AND CRANE OR APPROVED EQUAL.
- 10. WATER HAMMER ARRESTOR (WHA) TO BE EQUAL WATTS 15M2 & SHALL BE LOCATED ACCESSIBLE ABOVE A CEILING & OUT OF WALL.
- 11. SANITARY AND VENT PIPE BELOW SLAB SHALL BE SCHEDULE 40 DWV PVC, OR HUB & SPIGOT CAST IRON.
- 12. SANITARY AND VENT PIPE ABOVE SLAB SHALL BE SCHEDULE 40 DWV PVC, DWV COPPER, OR HUBLESS CAST IRON. PVC NOT ALLOWED IN PLENUM.
- ↑ 13. TEST DRAINAGE AND VENT PIPING AT TEN FEET OF WATER COLUMN.
- 14. FLOOR DRAIN, 3" FD, SHALL BE EQUAL TO JAY R. SMITH MODEL 2010C-P050-NB. PROVIDE W/ ZURN Z1021 TRAP PRIMER BELOW SINK.
- 15. NON-FREEZE HOSE BIBB (NFWH) SHALL BE ANTI-SIPHON, VACUUM BREAKER PROTECTED EQUAL TO WOODFORD MODEL 67. HOSE BIBB (HB) EQUAL TO WOODFORD MODEL 24.
- 16. CONTRACTOR SHALL SUBMIT (MINIMUM 3) SETS OF SHOP DRAWINGS AND EQUIPMENT CUT SHEETS TO THE ARCHITECT FOR APPROVAL PRIOR TO STARTING ANY WORK. ANY EQUIPMENT REQUIRING AN ELECTRICAL CONNECTION SHALL FIRST BE REVIEWED AND APPROVED BY THE ELECTRICAL CONTRACTOR VERIFYING THAT THE ELECTRICAL CONTRACTOR HAS COMPARED THE ELECTRICAL REQUIREMENTS OF THE SUBMITTED EQUIPMENT WITH THE PLANS AND HAS MADE ANY REQUIRED ADJUSTMENTS TO THE ELECTRICAL GEAR. ANY SHOP DRAWING THAT IS SUBMITTED WITHOUT THE SIGNATURE APPROVAL OF THE ELECTRICAL CONTRACTOR WILL BE RETURNED WITHOUT COMMENT.
- 17. PLUMBING CONTRACTOR SHALL FIELD VERIFY LOCATION OF ALL EXISTING WATER, VENT, & SANITARY PIPE PRIOR TO START OF WORK. CONTRACTOR TO NOTIFY ARCHITECT AND ENGINEER OF ANY DISCREPANCIES PRIOR TO COMMENCEMENT OF SAID WORK.
- 18. THE PLUMBING PLANS ARE INTENDED TO BE DIAGRAMMATIC AND ARE BASED ON ONE MANUFACTURER'S EQUIPMENT. THEY RE NOT INTENDED TO SHOW EVERY ITEM IN ITS EXACT LOCATION, EXACT DIMENSIONS, OR ALL OF THE DETAILS OF THE EQUIPMENT. THE CONTRACTOR SHALL OBTAIN MANUFACTURER'S DATA ON ALL EQUIPMENT TO VERIFY THE ACTUAL DIMENSIONS CHARACTERISTICS, ENTRY LOCATIONS, ETC., AND TO INSURE MINIMUM CLEARANCES ARE

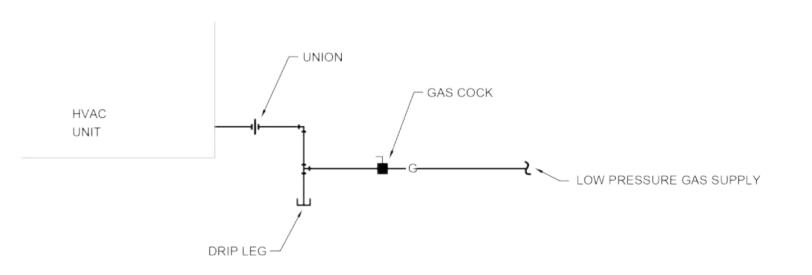


FLEXIBLE CONNECTORS ARE NOT ALLOWED




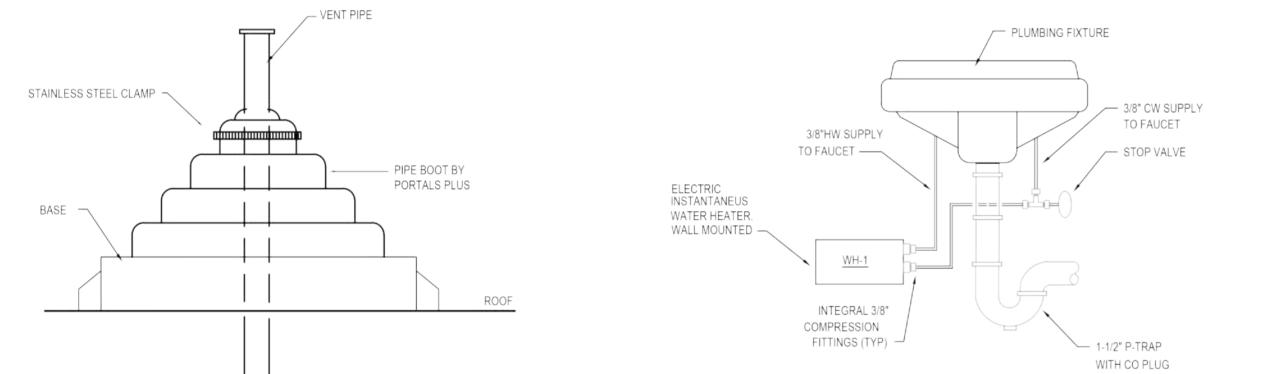





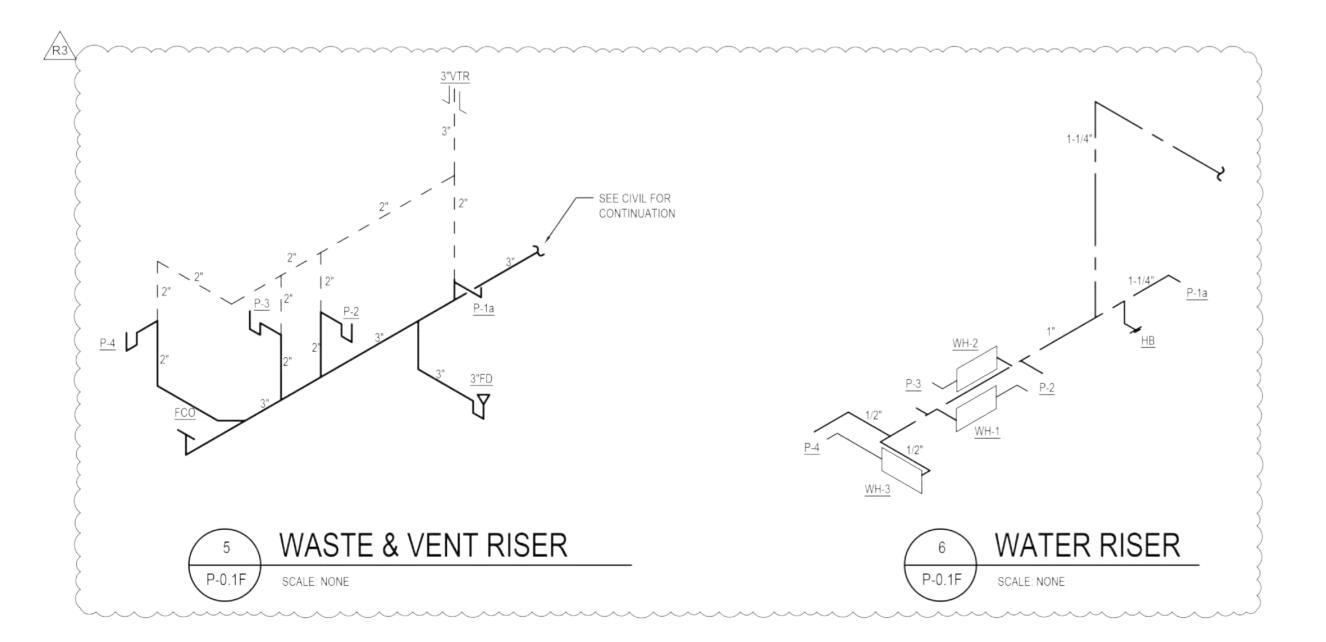

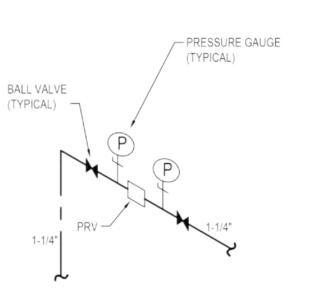

VALVE ASSEMBLY DETAIL P-0.1F SCALE: NONE



FACILI⁻

HE GROVE - MAINTENANC

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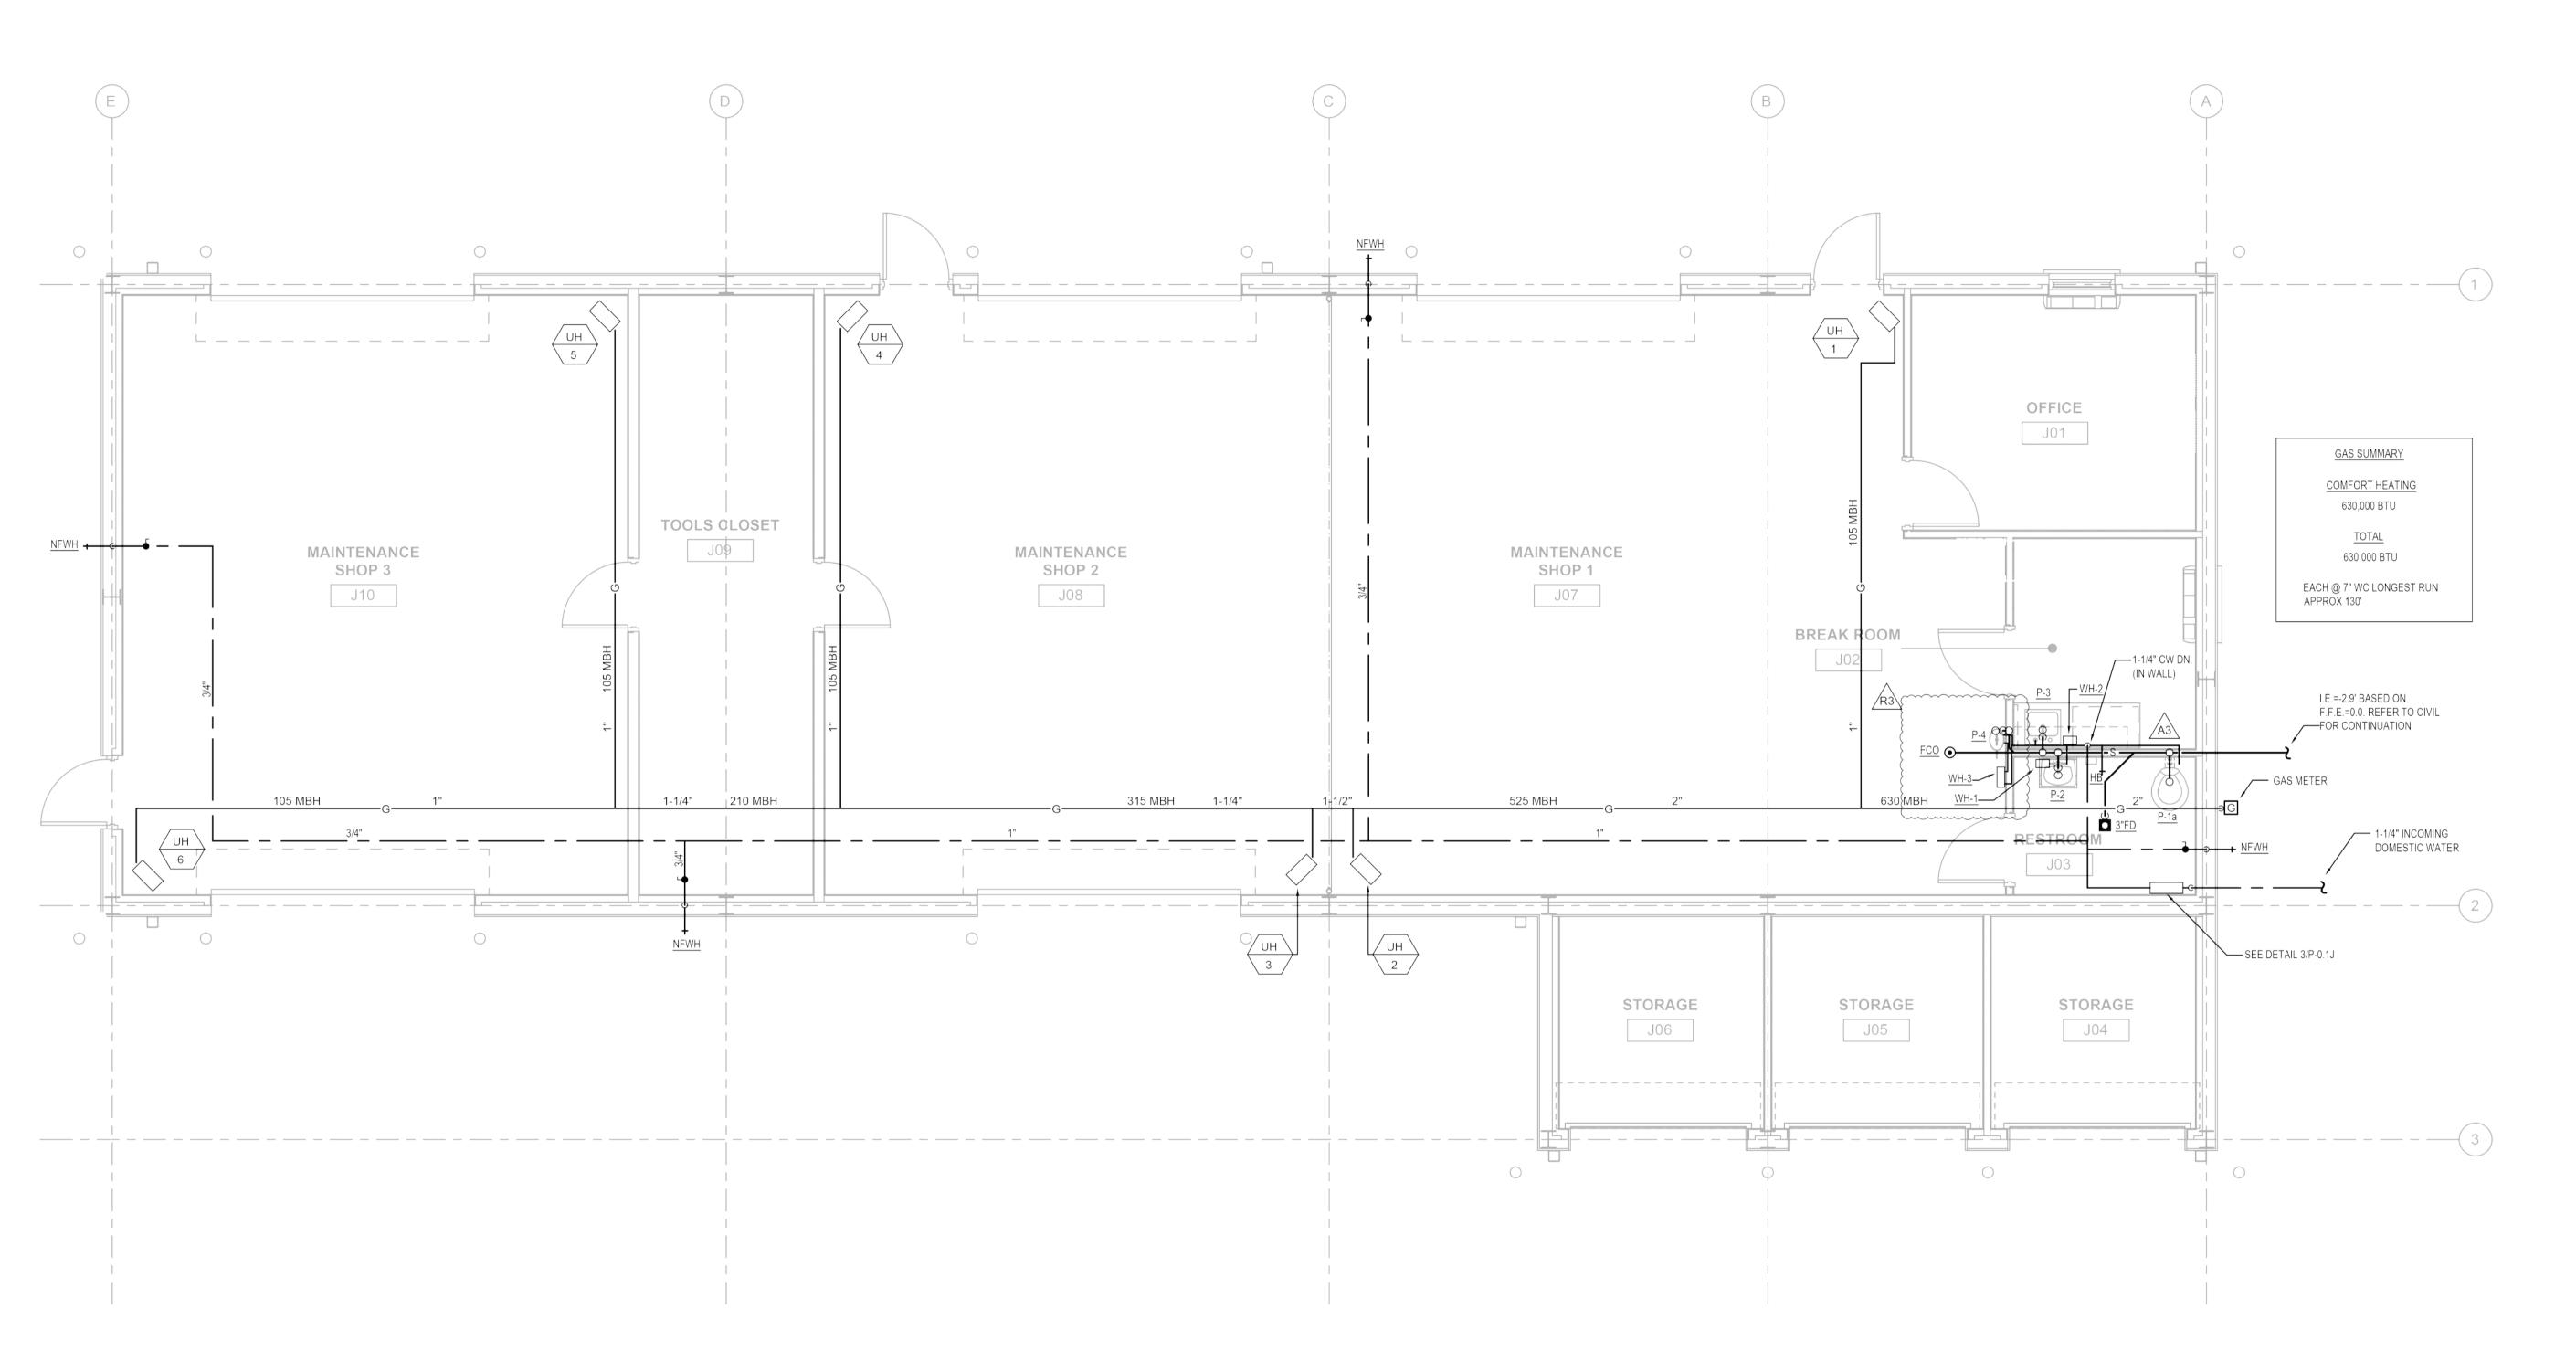
PREPARED FO WALTON COUN

SUBMITTALS / REVISIONS NO DATE DESCRIPTION
A3 4/21/23 ADDENDUM 3 R3 09/19/24 VE Conformed Set CONFORMED SET

SCHEDULES, NOTES & DETAILS **PLUMBING**

DATE 09/19/24 SCALE **22010**DRAWN BY CHECKED BY AS NOTED
TAN
SHEET NO. SHEET ___OF_40_

P-0.1J









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<u>۲</u>

THE GROVE

3 "J" - MAINTENANCE FA

9 HWY 81, LOGANVILLE, GA 3005

PREPARED FOR:
WALTON COUNTY

SUBMITTALS / REVISIONS

NO DATE DESCRIPTION

A3 4/21/23 ADDENDUM 3

R3 09/19/24 VE Conformed Set

BUILDING

CONFORMED SET

FLOOR PLAN -PLUMBING

PROJECT NO. DATE
22010 09/19/24

DRAWN BY SCALE
BBW
CHECKED BY 1/4"=1'-0"
TAN
SHEET NO. SHEET __OF_40_

P-1.1J

ELECTRICAL LEGEND

HA-1,3,5

HA-1,3,5 ADJACENT TO ARROW INDICATES HOMERUN OF CIRCUIT 1,3,5 TO PANEL HA. SLASH MARKS INDICATE THE NUMBER OF #12 CONDUCTORS, EQUIPMENT GROUNDING CONDUCTORS ARE REQUIRED BUT ARE NOT SHOWN, NO MARKS INDICATE TWO #12 CONDUCTORS AND ONE #12 GROUND. NUMBER(S) AND LOWER CASE LETTER(S) INDICATE CIRCUIT AND SWITCH LEG B a DESIGNATION, RESPECTIVELY, CAPITAL LETTERS DESIGNATE FIXTURE TYPE.

1. ALL MOUNTING HEIGHTS ARE TO CENTERLINE OF DEVICES UNO, AND SHALL BE THE MOUNTING HEIGHT USED, UNLESS

SPECIFICALLY INDICATED OTHERWISE ON THE DRAWINGS. 2. ALL SYMBOLS INDICATED IN THIS LEGEND MAY NOT NECESSARILY BE USED ON THE PLANS.

REFER TO SPECIFICATIONS FOR DEVICE AND EQUIPMENT SPECIFICATIONS.

4. REFER TO ARCHITECTURAL REFLECTED CEILING PLANS FOR EXACT LOCATION OF LIGHTING FIXTURES.

5. MOUNTING HEIGHTS FOR LIGHT SWITCHES, RECEPTACLE, FIRE ALARM DEVICES, AND ETC., COMPLY WITH A.D.A. DO NOT VARY

THESE DIMENSIONS. REFER TO ARCHITECTURAL PLANS FOR EXACT DEVICE LOCATIONS AND DIMENSIONS.

RECESSED OR SURFACE MOUNTED FIXTURE, SHADING INDICATES EMERGENCY FIXTURE

→ → → STRIP FIXTURE - MOUNTING AS INDICATED, SHADING INDICATES EMERGENCY FIXTURE RECESSED OR SURFACE MOUNTED DOWNLIGHT, SHADING INDICATES EMERGENCY FIXTURE

○ H WALL MOUNTED FIXTURE, SHADING INDICATES EMERGENCY FIXTURE

SURFACE OR RECESSED DIRECTIONAL FIXTURE

1€ CEILING OR WALL MOUNTED EXIT SIGN, ARROWS DENOTE DIRECTION OF EGRESS, DARKENED QUADRANT

INDICATES FACE TRACK LIGHTING, TRACK LENGTH AS INDICATED

WALL MOUNTED EMERGENCY LIGHTING UNIT AND LIGHT HEADS

O OH CEILING OR WALL MOUNTED JUNCTION BOX, HEIGHT AS INDICATED

FLUSH FLOOR MOUNTED JUNCTION BOX

CEILING MOUNTED OCCUPANCY OR VACANCY SENSOR SINGLE POLE TOGGLE SWITCH - 48" AFF

S₃ THREE-WAY TOGGLE SWITCH - 48" AFF

S4 FOUR-WAY TOGGLE SWITCH - 48" AFF

SD SINGLE POLE DIMMER SWITCH - 48" AFF

S_{3D} THREE-WAY DIMMER SWITCH - 48" AFF

S_{4D} FOUR-WAY DIMMER SWITCH - 48" AFF

SK KEY OPERATED SWITCH - 48" AFF ST TIMER OPERATED SWITCH - 48" AFF

SP SINGLE POLE TOGGLE SWITCH WITH PILOT LIGHT IN TOGGLE MOUNT 48" AFF

Sos Svs occupancy or vacancy sensor wall-mounted 48" AFF

SVS/D VACANCY SENSOR DIMMER SWITCH WALL-MOUNTED 48" AFF (TV)+ CABLE BOX-MOUNTING HEIGHT AS INDICATED. PROVIDE 1"C FROM BOX TO ABOVE ACCESSIBLE CEILING.

DUPLEX RECEPTACLE - 18" AFF OR AT HEIGHT INDICATED, NEMA 5-20R

FLUSH CEILING BOX WITH DUPLEX RECEPTACLE, NEMA 5-20R

FLUSH CEILING BOX WITH QUAD RECEPTACLE, NEMA 5-20R DOUBLE DUPLEX RECEPTACLE - 18" AFF OR AT HEIGHT INDICATED, NEMA 5-20R

DUPLEX GROUND FAULT CIRCUIT INTERRUPTER RECEPTACLE - 18" AFF OR AT HEIGHT INDICATED, NEMA 5-20R

WP ● WEATHERPROOF DUPLEX GROUND FAULT CIRCUIT INTERRUPTER RECEPTACLE - 36" AFF UNLESS NOTED, NEMA 5-20R

PROVIDE HEAVY DUTY WEATHER RESISTANT IN-USE RECEPTACLE COVERS AT ALL

EXTERIOR ELECTRICAL WALL OUTLETS. ■ DUPLEX RECEPTACLE - ISOLATED GROUND - 18* AFF UNLESS NOTED, NEMA 5-20R

DUPLEX RECEPTACLE, TOP RECEPTACLE SWITCHED - 18" AFF UNLESS NOTED, NEMA 5-20R

➡ DOUBLE DUPLEX RECEPTACLE - ISOLATED GROUND - 18" AFF UNLESS NOTED, NEMA 5-20R

■ DOUBLE DUPLEX RECEPTACLE, TOP RECEPTACLE SWITCHED - 18" AFF UNLESS NOTED, NEMA 5-20R

→ SINGLE RECEPTACLE STRAIGHT BLADE - TYPE AND MOUNTING AS INDICATED

○H SPECIAL PURPOSE RECEPTACLE - TYPE AND MOUNTING AS INDICATED

SURFACE MOUNTED MULTI-OUTLET RACEWAY SYSTEM FOR CONDUCTORS AND DEVICES AS SPECIFIED. LENGTH AS INDICATED

POWER AND TELEPHONE POLE

FLUSH FLOOR BOX WITH DOUBLE DUPLEX RECEPTACLE, NEMA 5-20R

FLUSH FLOOR BOX WITH DUPLEX RECEPTACLE, NEMA 5-20R FLUSH FLOOR BOX WITH COMBINATION TELEPHONE/DATA OUTLET

CONDUIT INSTALLED CONCEALED IN WALLS AND/OR ABOVE CEILING

CONDUIT INSTALLED CONCEALED IN/OR BELOW FLOOR SLAB OR BELOW GRADE

 CONDUIT INSTALLED EXPOSED ISOLATED GROUND CONDUCTOR

FLEXIBLE METALLIC CONDUIT 6' MAXIMUM LENGTH

SYSTEMS GROUND

—∘/→ CONDUIT TURNING UP/CONDUIT TURNING DOWN CONDUIT TERMINATION, STUB-OUT WITH THREADED OR SET SCREW CAP

____ GROUND BUS BAR

EQUIPMENT BACKBOARD - 3/4" X 4' X 8' PLYWOOD, UNLESS NOTED

PANELBOARD - SURFACE OR FLUSH MOUNTED

→ NON-FUSED DISCONNECT SWITCH - RATING/POLES/ENCLOSURE AS INDICATED (e.g. 30/3/3R/NF)

── FUSED DISCONNECT SWITCH - RATING/POLES/ENCLOSURE/FUSE AS INDICATED (e.g. 60/3/3R/F40)

MOTOR, HORSEPOWER AS INDICATED, 'F' INDICATES FRACTIONAL HORSEPOWER

S_M MOTOR RATED SWITCH WITH THERMAL OVERLOAD PROTECTION

SPD SURGE PROTECTIVE DEVICE - REFER TO SPECIFICATIONS TRANSFORMER - VOLTAGE/PHASE/KVA AS INDICATED OR SCHEDULED

ABBREVIATIONS:

AFF ABOVE FINISHED FLOOR AIC AVAILABLE INTERRUPTING CURRENT AL ALUMINUM ATS AUTOMATIC TRANSFER SWITCH AWG AMERICAN WIRE GAGE BOH BACK OF HOUSE C CONDUIT CL CENTERLINE COMP COMPRESSOR COND CONDENSER KVA KILOVOLT AMPERES KW KILOVOLT AMPERES KILOVOLT AMPERES KW KILOVOLT AMPERES KW KILOVOLT AMPERES KW KILOVOLT AMPERES KW KILOVOLT AMPERES KILO	
COND CONDENSER MLO MAIN LUGS ONLY CU COPPER OR CONDENSING UNIT MOCP MAXIMUM OVERCURRENT PROTECTION	
DN DOWN MRS MOTOR-RATED SWITCH	
EC ELECTRICAL CONTRACTOR MSB MAIN SWITCHBOARD	
EDF ELECTRIC DRINKING FOUNTAIN MTS MANUAL TRANSFER SWITCH	
EF EXHAUST FAN N NEW EM EMERGENCY NF NONFUSIBLE	
EM EMERGENCY NF NONFUSIBLE EOMH ELECTRICALLY OPERATED, MECHANICALLY HELD NIC NOT IN CONTRACT	
EQ EQUAL NL NIGHT LIGHT; UNSWITCHED, "ON" 24/7	
EQUIP EQUIPMENT P POLE	
EXD EXISTING TO BE DEMOLISHED PH. Ø PHASE	
EXR EXISTING TO BE RELOCATED PNL PANEL	
EXT EXISTING TO REMAIN POE POWER OVER ETHERNET	
F FUSED POS POINT OF SALE	
FAAP FIRE ALARM ANNUNCIATOR PANEL REC RECEPTACLE	
FACP FIRE ALARM CONTROL PANEL REF REFRIGERATOR	
FLA FULL LOAD AMPERES RTU ROOF TOP UNIT	
FLRBOX FLOORBOX SER SERVICE ENTRANCE RATED	
FTR FUTURE SPD SURGE PROTECTIVE DEVICE	
G,GND GROUND SWBD SWITCHBOARD	
GAP GENERATOR ANNUNCIATOR PANEL TC TIMECLOCK	
GEN GENERATOR TR TAMPER RESISTANT	
GFCI GROUND FAULT CIRCUIT INTERRUPTER TYP TYPICAL	
HP HORSEPOWER OR HEAT PUMP UH UNIT HEATER IG ISOLATED GROUND UNO UNLESS NOTED OTHERWISE	
	,
99B 113721	
* SECULATION OF THE PROPERTY O	
VA VOLT-AMPERES W WATTS	
WAP WIRELESS ACCESS POINT	
WH WATER HEATER	
WP WEATHER PROOF	
XFMR TRANSFORMER	

ELECTRICAL GENERAL NOTES

GENERAL CONTRACTOR TO PROVIDE COMBINED RE-BAR / CONDUIT / PLUMBING PIPE LAYOUT SUBMITTAL FOR COORDINATION PRIOT TO INSTALLATION OF ANY OF THESE ITEMS.

PER SPEC SECTION 260533 THE FOLLOWING CONDUITS ARE ALLOWED GRC, ARC, IMC, PVC, EMT, FLEX, ENT, RNC, AND LFNC MC AND ROMEX ARE NOT ALLOWED.

PROJECT NO. 22010 SAVANT DRAWN BY SSH Engineering, LLC SWL 5064 Roswell Road, Suite D-301

Sandy Springs GA 30342 770.319.7400

COA#: PEF004211 EXPIRES: 6/30/2024

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Project 22140





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SUBMITTALS / REVISIONS NO DATE DESCRIPTION 04/21/23 ADDENDUM 3


09/19/24 VE Conformed Set

CONFORMED SET

LEGENDS -

ELECTRICAL

09/19/24 SCALE CHECKED BY 12" = 1'-0" SHEET NO. SHEET ___OF_40

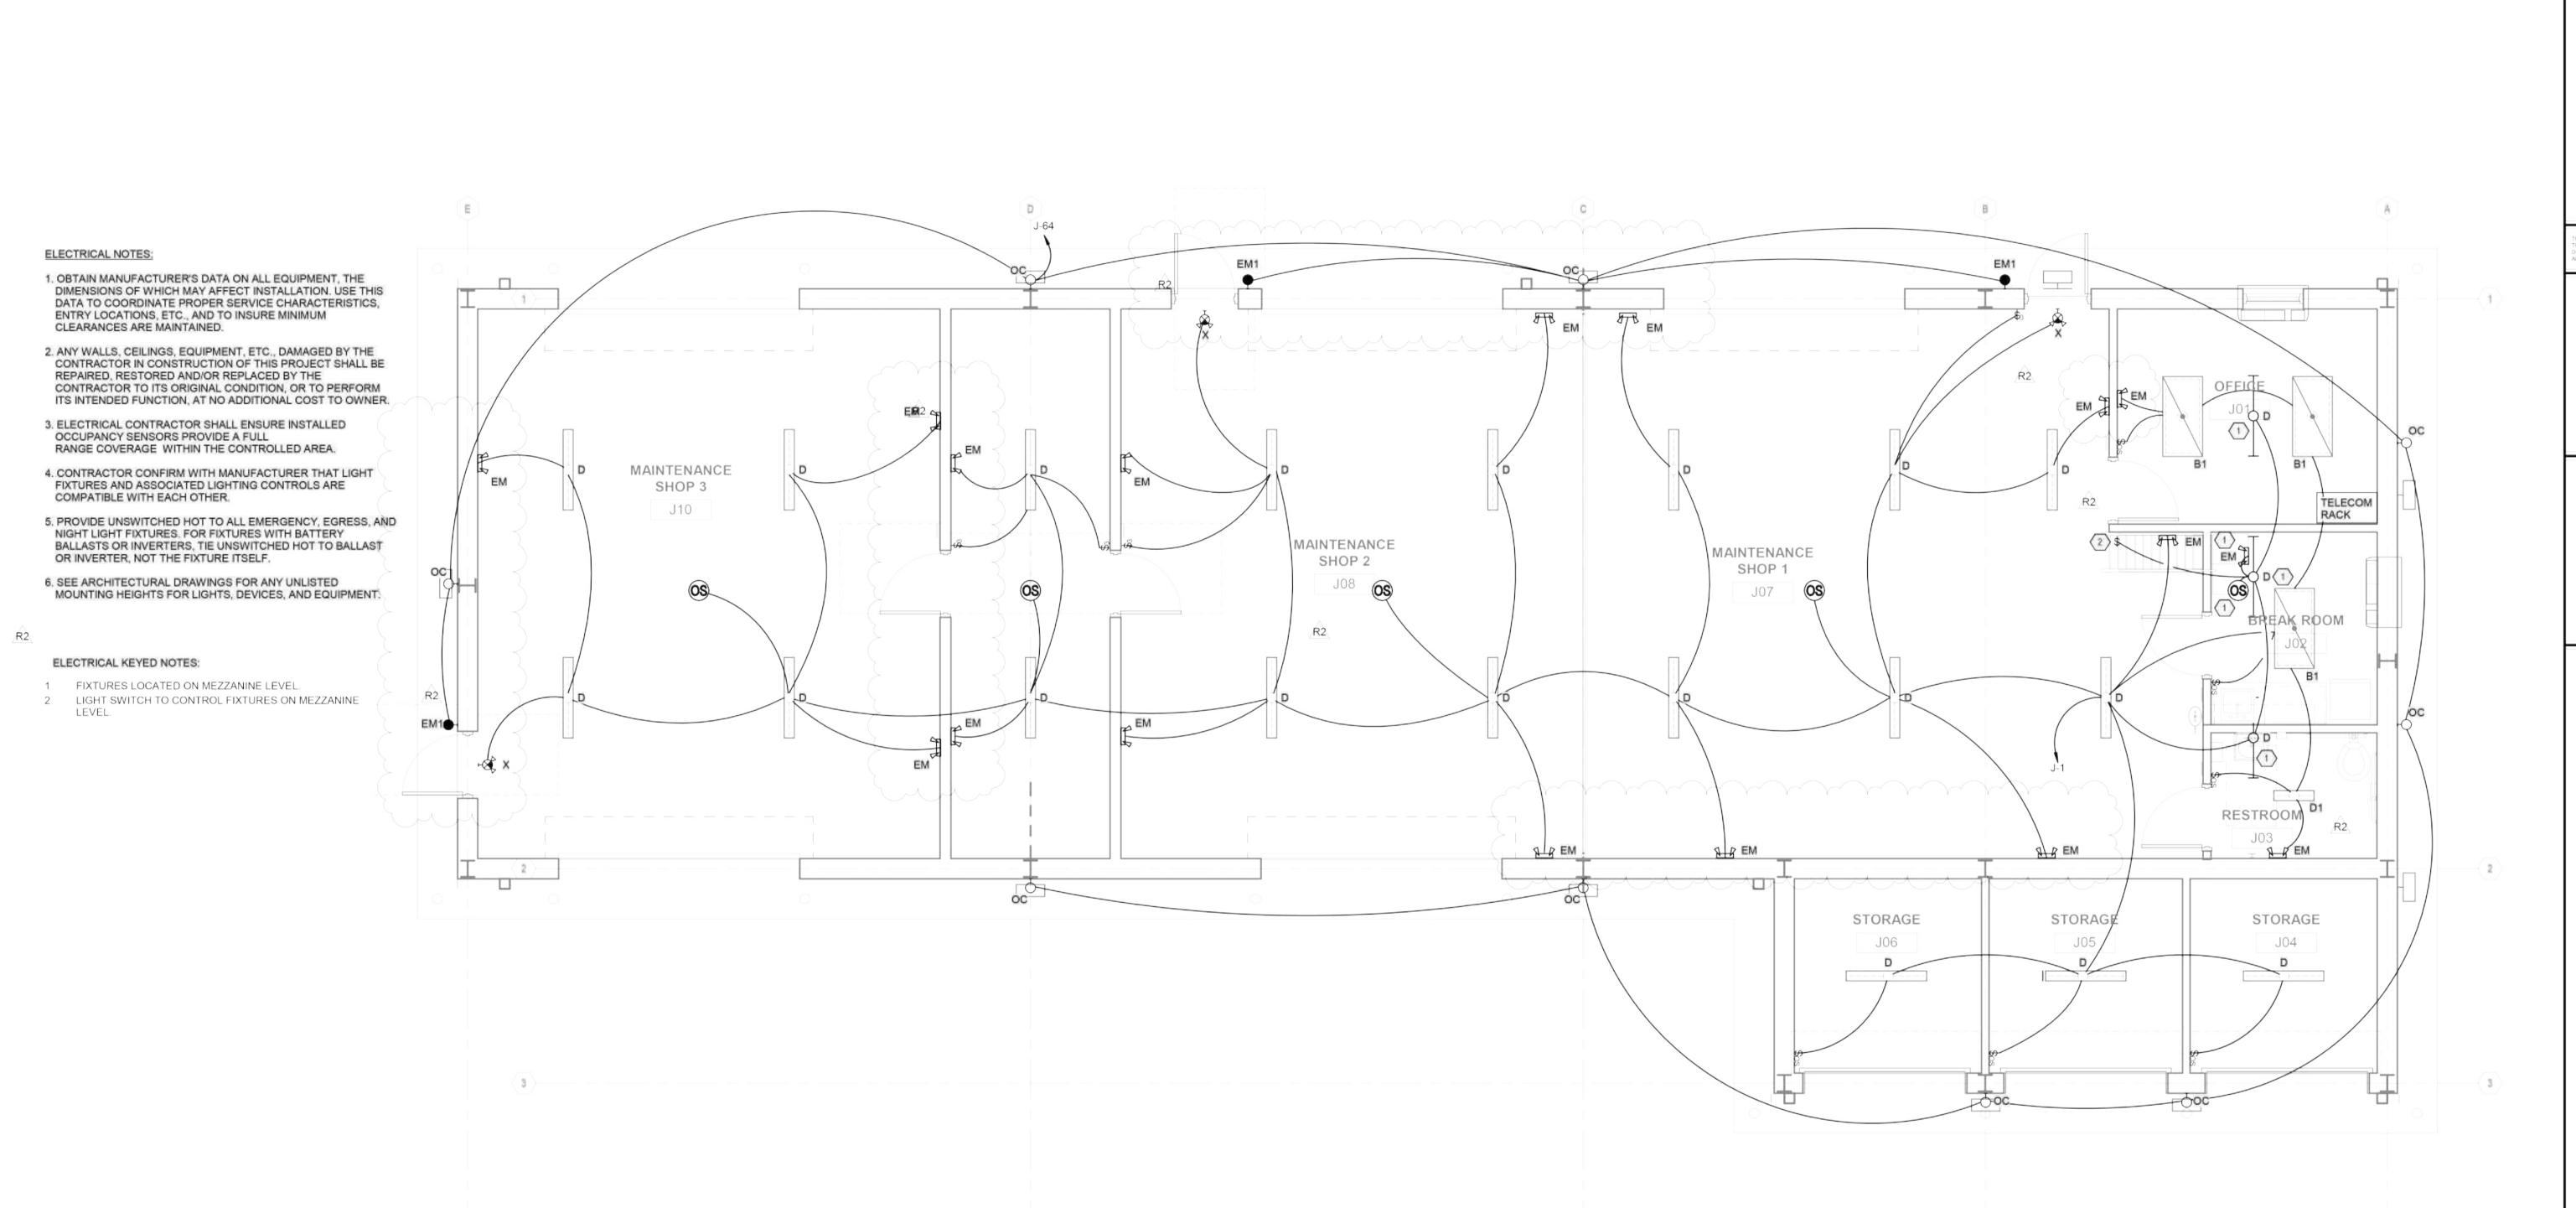

MAINTENANCE FACILITY FLOOR PLAN - LIGHTING

E2.1J 1/4" = 1'-0"

SAVANT Engineering, LLC 5064 Roswell Road, Suite D-301 Sandy Springs GA 30342 770.319.7400 Project 22140 ©2022 COA#: PEF004211

EXPIRES: 6/30/2024

SUBMITTALS / REVISIONS NO DATE DESCRIPTION
R2 06/13/23 PERMIT REVISIONS 3 09/19/24 VE Conformed Set

BUILDING

CONFORMED SET

MAINTENANCE FACILTY FLOOR PLAN -LIGHTING

PROJECT NO. DATE
22010 09/19/24

DRAWN BY SCALE

SSH
CHECKED BY 1/4" = 1'-0"

SWL
SHEET NO. SHEET ___OF_40