24.40.002



Formal notice is hereby given that Verizon Wireless	(utility contractor) proposes to place a
small cell node - Tamarron SC1 within the right-	of-way of 1383 Jordan Ranch Blvd, Katy, TX 7749
as follows:	(street)
***Detail scope of work listed in attached construction	
· · · · · · · · · · · · · · · · · · ·	ained on the road right-of-way as directed by Waller County
Road & Bridge in accordance with governing laws. Our firm f control measures as those complying with applicable portion required for adoption by the "Transportation Code" (Ch 251)	s of the <u>Texas Manual on Uniform Traffic Control Devices</u>
The location and description of the proposed work and appul drawings attached to this notice.	rtenances is more fully shown by three (3) copies of
Construction is proposed to begin on or after the _1	5th day of January 20 24. Firm:
IM Hodges, Inc. on behalf of Verizon Wireless Address:	SH26 Jake Cherokee
	Henderson, TX 75652
Signature: Becky Capt Pho	ne: 817-528-7875
Older A constitution On a MANA	hada Girah da 3
Title: Site Acquisition Specialist Ema	
APPR This application is hereby approved subject to the following unders	A THE RESERVE OF THE PERSON OF
It is expressly understood that the said Waller County does not here County Road; and it is further understood that in the future, shoul widen, increase, add to, decrease, or in any manner change the smoved at the direction of the Waller County Engineer or Road Adm	ld Waller County, for any reason, need to work, improve, relocate, structure of this road or right of way, this line, if affected, will be
inconvenience to traffic and adjacent property owners. Permit sha	and adequate provisions shall be made to cause a minimum of Il be effective upon acceptance date of Formal Notice presentation portunity of a six (6) month extension after a written request is sent
APPROVED BY WALLER COUNTY ROAD & BRIDGE DEPT.	Traffic Controls Required:   N
Was Mill	Traffic Controls Reviewed By:  Bond: Y N Bond Amount (\$):
County Engineer or Road Administrator	Floodplain Dev. Permit Required: Y N
	Permit #: Precinct #: 4
1-19-24	R&B Inspector: Vint Henser
Date	

### PERMIT TO CONSTRUCT UTILITY IN WALLER COUNTY RIGHT-OF-WAY

**ROAD: 1383 Jordan Ranch Blvd, Katy** 

DATE: 1/24/2024

To: JM Hodges, Inc.
[Verizon Wireless]
SH 26 Lake Cherokee
Henderson, TX 75652
Permit # 24.UP.002

The location on the right-of-way of your proposed buried line as shown by the accompanying notice dated 01/15/2024 is approved.

Your attention is directed to Art. 1436A (for power lines) and Art. 1416 (for communication lines) Vernon's Annotated Texas Civil Statutes with particular attention to the following provisions:

- 1. The Court Commission may designate the place along the right-of-way where such lines shall be constructed.
- 2. Emplacement of buried lines shall be a minimum of 36 inches below the flow line of the existing ditch. For installations parallel to the right-of-way, the utility shall be located within three (3) feet of the edge of the right-of-way, unless otherwise approved by the County.
- 3. All placement of lines beneath roadways and asphalt or concrete paved driveways shall be jacked or bored. No open cut will be allowed within five feet of the edge of roadways or such driveways. Open cuts on unpaved driveways shall be performed only with a trenching machine and shall not be excavated. In such cases the trench shall be backfilled and compacted. The driveway surface shall be restored to its original condition. Any variance to these requirements shall have the Commissioners' Court approval.
- 4. All buried water lines shall be marked thoroughly with detectable tracer wire. All other lines shall be marked thoroughly with detectable underground warning tape. Public to be safe-guarded by use of construction signs and barricades. Identification markers shall be placed along right-of-way lines, that is readily identifiable, indicating name of Company, type of line and emergency contact number.
- 5. Restore roads to their original condition. Trench is to be back-tracked, dragged, graded and filled as necessary to minimize erosion and sedimentation resulting from the proposed installation. Ditches are to be left clear for drainage.
- 6. The Court Commission may require the owner to relocate this line, for valid reasons under the law by giving thirty (30) days written notice.


The contractor must notify the County Engineer at (979) 826-7670, forty-eight (48) hours prior to starting construction of the line in order that we may have a representative present. An inspection of the line installation is required prior to backfilling the excavation to confirm proper cover depth.

SPECIAL PROVISIONS:

### WALLER COUNTY COMMISSIONERS' COURT

Carbe	tt "Trey" J. Duhon III, County Judge
	D. L.
It is ORDERED by the Court on motion by Co	mmissioner , duly
seconded by Commissioner	_, that the above and foregoing request be
and the same is hereby approved, with	_ members present voting in giver and
members present voting opposed. The	e County Engineer is authorized to comply
with the above requests.	1 20 / 100
Date	
Debbie Hollan, County Clerk	
4	
Deputy	
ED	

# Frequency Both Same Entire Both Frequency Bo

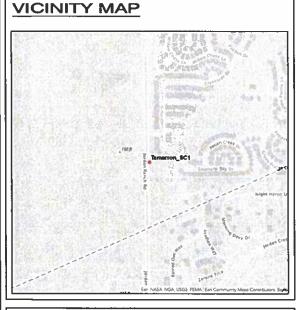

	Sheet List Table
Sheet Number	Sheet Title
1	TITLE
2	NOTES
3	TAMARRON_SCI OVERALL SITE PLAN
4	TAMARRON_SC1
5	TAMARRON_SC1 POWER DESIGN
6	TAMARRON_SC1 POWER DESIGN (2)
7	ELEVATION
8	SPEC SHEET 1
9	SPEC SHEET 2
10	SPEC SHEET 3
11	GROUNDING
12	ONE LINE AND LOAD ANALYSIS
13	DETAILS
14	DETAILS 2
15	TCP
16	SWPPP

SITE NAME:

# VERIZON SMALL CELL WALLER CO. PKG 2

## verizon

CONSTRUCTION PLANS FOR PROPOSED ANTENNA SITES

VZW SITE NAME	MGD LOCATION CODE	LAT	LONG	E911 ADDRESS	KEY MAP
TAMARRON_SC1	5000923464	29,762467	-95.901545	1383 JORDAN RANCH BLVD, KATY, TX 77494	482H





VERIZON

SMALL CELL NODE

CONSTRUCTION PLANS FOR

PROPOSED ANTENNA

SITES

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DESIGNED: JG DRAWN: JG CHECKED: JG

JOB #:

TITLE

### GENERAL NOTES:

THE GENERAL CONTRACTOR MUST VERIFY ALL DIMENSIONS, CONDITIONS AND ELEVATIONS BEFORE STARTING WORK, ALL DISCREPANCIES SHALL BE CALLED TO THE ATTENTION OF THE ENGINEER AND SHALL BE RESOLVED BEFORE PROCEEDING WITH THE WORK. ALL WORK SHALL BE PERFORMED IN A WORKMAN LIKE MANNER IN ACCORDANCE WITH ACCEPTED CONSTRUCTION PRACTICES.

IT IS THE INTENTION OF THESE DRAWINGS TO SHOW THE COMPLETED INSTALLATION. THE CONTRACTOR SHALL BE RESPONSIBLE FOR ALL TEMPORARY BRACING, SHORING, TIES, FORM WORK, ETC. IN ACCORDANCE WITH ALL NATIONAL, STATE, AND LOCAL ORDINANCES, TO SAFELY EXECUTE ALL WORK AND SHALL BE RESPONSIBLE FOR SAME. ALL WORK SHALL BE IN ACCORDANCE WITH LOCAL CODES.

THE CONTRACTOR SHALL USE ADEQUATE NUMBER OF SKILLED WORKMEN WHO ARE THOROUGHLY TRAINED AND EXPERIENCED IN THE NECESSARY CRAFTS AND WHO ARE COMPLETELY FAMILIAR WITH THE SPECIFIED REQUIREMENTS AND METHOD NEEDED FOR PROPER PERFORMANCE OF THE WORK.

CONSTRUCTION CONTRACTOR AGREES THAT IN ACCORDANCE WITH GENERALLY ACCEPTED CONSTRUCTION PRACTICES, CONSTRUCTION CONTRACTOR WILL BE REQUIRED TO ASSUME SOLE AND COMPLETE RESPONSIBILITY FOR JOB SITE CONDITIONS DURING THE COURSE OF CONSTRUCTION OF THE PROJECT, INCLUDING THE SAFETY OF ALL PERSONS AND PROPERTY. THIS REQUIREMENT SHALL BE MADE TO APPLY CONTINUOUSLY AND NOT BE LIMITED TO NORMAL WORKING HOURS. CONSTRUCTION CONTRACTOR FURTHER AGREES TO INDEMNIFY AND HOLD DESIGN ENGINEER HARMLESS FROM ANY AND ALL LIABILITY, REAL OR ALLEGED, IN CONNECTION WITH PERFORMANCE OF WORK ON THIS PROJECT.

SITE GROUNDING SHALL COMPLY WITH VERIZON WIRELESS GROUNDING STANDARDS, LATEST EDITION, AND COMPLY WITH VERIZON WIRELESS GROUNDING CHECKLIST, LATEST VERSION. WHEN NATIONAL AND LOCAL GROUNDING CODES ARE MORE STRINGENT THEY SHALL GOVERN.

ALL WORK SHALL COMPLY WITH OSHA AND STATE SAFETY REQUIREMENTS. PROCEDURES FOR THE PROTECTION OF EXCAVATIONS, EXISTING CONSTRUCTION AND UTILITIES SHALL BE ESTABLISHED PRIOR TO FOUNDATION INSTALLATION. IF TEMPORARY LIGHTING AND MARKING IS REQUIRED BY THE FEDERAL AVIATION ADMINISTRATION (FAA), IT IS THE CONTRACTOR'S RESPONSIBILITY TO MAINTAIN THE NECESSARY LIGHTS AND NOTIFY THE PROPER AUTHORITIES IN THE EVENT OF A PROBLEM.

ALL WORK SHALL BE ACCOMPLISHED IN ACCORDANCE WITH ALL LOCAL, STATE, AND FEDERAL CODES AND ORDINANCES. THE MOST STRINGENT CODE WILL APPLY IN THE CASE OF DISCREPANCIES OR DIFFERENCES IN THE CODE REQUIREMENTS.

ANY DAMAGE TO ADJACENT PROPERTIES SHALL BE CORRECTED AT THE CONTRACTOR'S EXPENSE.

THE CONTRACTOR IS RESPONSIBLE FOR PROVIDING AMPLE NOTICE TO THE BUILDING INSPECTION DEPARTMENT TO SCHEDULE THE REQUIRED INSPECTIONS. A MINIMUM OF 24 HOURS OF NOTICE SHALL BE GIVEN AND THE BUILDING INSPECTION DEPARTMENTS HAVE REQUESTED THAT GROUPS OF TWO OR THREE SITES BE SCHEDULED AT ONE TIME IF POSSIBLE.

CONSTRUCTION MANAGER WILL CONFIRM FAA APPROVAL OF TOWER LOCATION BY ISSUING TOWER RELEASE FORM, NO TOWER SHALL BE CONSTRUCTED UNTIL THE TOWER RELEASE FORM IS ISSUED TO THE CONTRACTOR.

THE COMPLETE BID PACKAGE INCLUDES THESE CONSTRUCTION DRAWINGS ALONG WITH THE FINAL RF DESIGN AND TOWER STRUCTURAL ANALYSIS. CONTRACTOR IS RESPONSIBLE FOR REVIEW OF TOTAL BID PACKAGE PRIOR TO BID SUBMITTAL.

CONTRACTOR SHALL VERIFY LOCATION OF ALL EXISTING UTILITIES WITHIN CONSTRUCTION LIMITS PRIOR TO CONSTRUCTION.

THE CONTRACTOR IS RESPONSIBLE FOR MAINTAINING POSITIVE DRAINAGE ON THE SITE AT ALL TIMES. SILT AND EROSION CONTROL SHALL BE MAINTAINED ON THE DOWNSTREAM SIDE OF THE SITE AT ALL TIMES. ANY DAMAGE TO ADJACENT PROPERTIES SHALL BE CORRECTED AT THE CONTRACTOR'S EXPENSE.

CLEARING OF TREES AND VEGETATION ON THE SITE SHOULD BE HELD TO A MINIMUM. ONLY THE TREES NECESSARY FOR CONSTRUCTION OF THE FACILITIES SHALL BE REMOVED. ANY DAMAGE TO PROPERTY OUTSIDE THE LEASE PROPERTY SHALL BE REPAIRED BY THE CONTRACTOR.

ALL SUITABLE BORROW MATERIAL FOR BACK FILL OF THE SITE SHALL BE INCLUDED IN THE BID. EXCESS TOPSOIL AND UNSUITABLE MATERIAL SHALL BE DISPOSED OF OFF SITE AT LOCATIONS APPROVED BY GOVERNING AGENCIES PRIOR TO DISPOSAL.

SEEDING AND MULCHING OF THE SITE SHALL BE ACCOMPLISHED AS SOON AS POSSIBLE AFTER COMPLETION OF THE SITE DEVELOPMENT. THE CONTRACTOR IS RESPONSIBLE FOR PROVIDING AND MAINTAINING AN ADEQUATE COVER OF VEGETATION OVER THE SITE FOR A ONE YEAR PERIOD.

PERMITS: OBTAIN AND PAY FOR REQUIRED PERMITS, LICENSES, FEES, INSPECTIONS, ETC.

RECORD DRAWINGS: MAINTAIN A RECORD OF ALL CHANGES, SUBSTITUTIONS BETWEEN WORK AS SPECIFIED AND INSTALLED. RECORD CHANGES ON A CLEAN SET OF CONTRACT DRAWINGS WHICH SHALL BE TURNED OVER TO THE CONSTRUCTION MANAGER UPON COMPLETION OF THE PROJECT.

THE CONTRACTOR SHALL VISIT THE SITE BEFORE BIDDING ON THE WORK CONTAINED IN THIS DESIGN PACKAGE.

### **EXCAVATION & GRADING NOTES:**

- 1. ALL CUT AND FILL SLOPES SHALL BE 3:1 MAXIMUM.
- ALL EXCAVATIONS ON WHICH CONCRETE IS TO BE PLACED SHALL BE SUBSTANTIALLY HORIZONTAL ON UNDISTURBED AND UNFROZEN SOIL AND BE FREE FROM LOOSE MATERIAL AND EXCESS GROUND WATER. DEWATERING FOR EXCESS GROUND WATER SHALL BE PROVIDED IF REQUIRED.
- CONCRETE FOUNDATIONS SHALL NOT BE PLACED ON ORGANIC MATERIAL. IF SOUND SOIL IS NOT REACHED
  AT THE DESIGNATED EXCAVATION DEPTH, THE UNSATISFACTORY SOIL SHALL BE EXCAVATED TO ITS FULL
  DEPTH AND EITHER BE REPLACED WITH MECHANICALLY COMPACTED GRANULAR MATERIAL OR THE EXCAVATION
  BE FILLED WITH CONCRETE OF THE SAME QUALITY SPECIFIED FOR THE FOUNDATION.
- 4. ANY EXCAVATION OVER THE REQUIRED DEPTH SHALL BE FILLED WITH EITHER MECHANICALLY COMPACTED GRANULAR MATERIAL OF CONCRETE OF THE SAME QUALITY SPECIFIED FOR THE FOUNDATION. CRUSHED STONE MAY BE USED TO STABILIZE THE BOTTOM OF THE EXCAVATION. STONE, IF USED, SHALL NOT BE USED AS COMPILING CONCRETE THICKNESS.
- AFTER COMPLETION OF THE FOUNDATION AND OTHER CONSTRUCTION BELOW GRADE, AND BEFORE BACK FILLING, ALL EXCAVATIONS SHALL BE CLEAN OF UNSUITABLE MATERIAL SUCH AS VEGETATION, TRASH, DEBRIS, AND SO FORTH.
- 6. BACK FILL SHALL BE:
  - APPROVED MATERIALS CONSISTING OF EARTH, LOAM, SANDY CLAY, SAND, GRAVEL, OR SOFT SHALE;
  - FREE FROM CLODS OR STONES OVER 2-1/2" MAXIMUM DIMENSIONS;
  - IN LAYERS AND COMPACTED.
- 7. SITE FILL MATERIAL AND FOUNDATION BACK FILL SHALL BE PLACED IN LAYERS, MAXIMUM 6" DEEP BEFORE COMPACTION. EACH LAYER SHALL BE SPRINKLED IF REQUIRED AND COMPACTED BY HAND OPERATED OR MACHINE TAMPERS TO 95% OF MAXIMUM DENSITY, AT THE OPTIMUM MOISTURE CONTENT 2% AS DETERMINED BY ASTM DESIGNATION D-698, UNLESS OTHERWISE APPROVED. SUCH BACK FILL SHALL NOT BE PLACED BEFORE 3 DAYS AFTER PLACEMENT OF CONCRETE.
- 8. THE FOUNDATION AREA SHALL BE GRADED TO PROVIDE WATER RUNOFF AND PREVENT WATER FROM STANDING. THE FINAL GRADE SHALL SLOPE AWAY IN ALL DIRECTIONS FROM THE FOUNDATION AND SHALL THEN BE COVERED WITH 4" DEEP COMPACTED STONE OR GRAVEL.
- 9. CONTRACTOR SHALL PROVIDE ALL EROSION AND SEDIMENTATION CONTROL MEASURES AS REQUIRED BY LOCAL CITY, COUNTY AND STATE CODES AND ORDINANCES TO PROTECT EMBANKMENTS FROM SOIL LOSS AND TO PREVENT ACCUMULATION OF SOIL AND SILT IN STREAMS AND DRAINAGE PATHS LEAVING THE CONSTRUCTION AREA. THIS MAY INCLUDE SUCH MEASURES AS SILT FENCES. STAW BALE SEDIMENT BARRIERS AND CHECK DAMS.
- 10 FILL PREPARATION
  - REMOVE ALL VEGETATION, TOPSOIL, DEBRIS, WET AND UNSATISFACTORY SOIL MATERIALS, OBSTRUCTIONS, AND DELETERIOUS MATERIALS FROM GROUND SURFACE PRIOR TO PLACING FILLS. PLOW STRIP OR BREAK UP SLOPED SURFACES STEEPER THAT 1 VERTICAL TO 4 HORIZONTAL SO FILL MATERIAL WILL BOND WITH EXISTING SURFACE. WHEN SUBGRADE OR EXISTING GROUND SURFACE TO RECEIVE FILL HAS A DENSITY LESS THAN THAT REQUIRED FOR FILL, BREAK UP GROUND SURFACE TO DEPTH REQUIRED, PULVERIZE, MOISTURE-CONDITION OR AERATE SOIL AND RECOMPACT TO REQUIRED DENSITY.
- 11. REPLACE THE EXISTING WEARING SURFACE ON AREAS WHICH HAVE BEEN DAMAGED OR REMOVED DURING CONSTRUCTION OPERATIONS. SURFACE SHALL BE REPLACE TO MATCH EXISTING ADJACENT SURFACING AND SHALL BE OF THE SAME THICKNESS. NEW SURFACE SHALL BE FREE FROM CORRUGATIONS AND WAVES. EXISTING SURFACING MAY BE EXCAVATED SEPARATELY AND REUSED IF INJURIOUS AMOUNTS OF EARTH, ORGANIC MATERIAL, OF OTHER DELETERIOUS MATERIALS ARE REMOVED PRIOR TO REUSE. FURNISH ALL ADDITIONAL RESURFACING MATERIAL AS REQUIRED. BEFORE SURFACING IS REPLACED, SUBGRADE SHALL BE GRADED TO CONFORM TO REQUIRED SUBGRADE ELEVATIONS, AND LOOSE OR DISTURBED MATERIALS SHALL BE THOROUGHLY COMPACTED. DEPRESSIONS IN THE SUBGRADE SHALL BE FILLED AND COMPACTED WITH APPROVED SELECTED MATERIAL. SURFACING SHALL NOT BE USED FOR FILLING DEPRESSIONS IN THE SUBGRADE.
- 12. PROTECT EXISTING SURFACING AND SUBGRADE IN AREAS WHERE EQUIPMENT LOADS WILL OPERATE. USE PLANKING OR OTHER SUITABLE MATERIALS DESIGNED TO SPREAD EQUIPMENT LOADS. REPAIR DAMAGE TO EXISTING GRAVEL SURFACING OR SUBGRADE WHERE SUCH DAMAGE IS DUE TO THE CONTRACTOR'S OPERATIONS. DAMAGED GRAVEL SURFACING SHALL BE RESTORED TO MATCH THE ADJACENT UNDAMAGED GRAVEL SURFACING AND SHALL BE OF THE SAME THICKNESS.
- DAMAGE TO EXISTING STRUCTURES AND UTILITIES RESULTING FROM CONTRACTOR'S NEGLIGENCE SHALL BE REPAIRED / REPLACED TO OWNER'S SATISFACTION AT CONTRACTOR'S EXPENSE.
- 14. CONTRACTOR SHALL COORDINATE THE CONSTRUCTION SCHEDULE WITH PROPERTY OWNER SO AS TO AVOID INTERRUPTIONS TO PROPERTY OWNER'S OPERATIONS.
- 15. ENSURE POSITIVE DRAINAGE DURING AND AFTER COMPLETION OF CONSTRUCTION.
- 5. RIPRAP SHALL BE CLEAN, HARD, SOUND, DURABLE, UNIFORM IN QUALITY, AND FREE OF ANY DETRIMENTAL QUANTITY OF SOFT, FRIABLE, THIN, ELONGATED OR LAMINATED PIECES, DISINTEGRATED MATERIAL, ORGANIC MATTER, OIL, ALKALI, OR OTHER DELETERIOUS SUBSTANCE.





VERIZON

SMALL CELL NODE

CONSTRUCTION PLANS FOR

PROPOSED ANTENNA

SITES

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**NOTES** 

PKG 2

FLOODPLAIN: TAMARRON\_SC | OVERALL SITE PLAN: THE PROPERTY SHOWN HEREON (EITHER TOTAL OR IN PORTION) IS LOCATED IN FLOOD INSURANCE RATE MAP 45473C0350E DATED 2/18/2009 UNSHADED ZONE X - AREAS DETERMINED TO BE OUTSIDE THE 0.2 PERCENT ANNUAL FLOOD CHANCE FLOODPLAIN.

BENCHMARK: TAMARRON\_SC! OVERALL SITE PLAN: BENCHMARKS SHOWN HEREON REFERENCED TO HARRIS COUNTY FLOODPLAIN MARKER NO. 190073R, FROM THE INTERSECTION OF FROM H10(WEST) AND PEDERSON RD. GO SOUTH ON TEXAS HERITAGE PARKWAY, GO SOUTH ON TEXAS HERITAGE PARKWAY 0.36 MILES TO THE BRIDGE OVER WILLOW FORK.

NOTE:

ALL EXISTING LANDSCAPING AND OR PRIVATE UTILITIES AFFECTED BY CONSTRUCTION TO BE RESTORED TO ORIGINAL STATE UPON COMPLETION

NOTE:


TOTAL ESTIMATED LENGTH OF PROPOSED UNDERGROUND CONDUIT: ±316'

NODE INFORMATION:

LATITUDE/LONGITUDE: 29.762467, -95.901545 E911 ADDRESS: 1383 JORDAN RANCH BLVD. CITY: CYPRESS ZIP CODE: 77433 **KEY MAP: 482H** 

POWER SOURCE COORDINATES:

LATITUDE/LONGITUDE: 29.76322202, -95.90142049

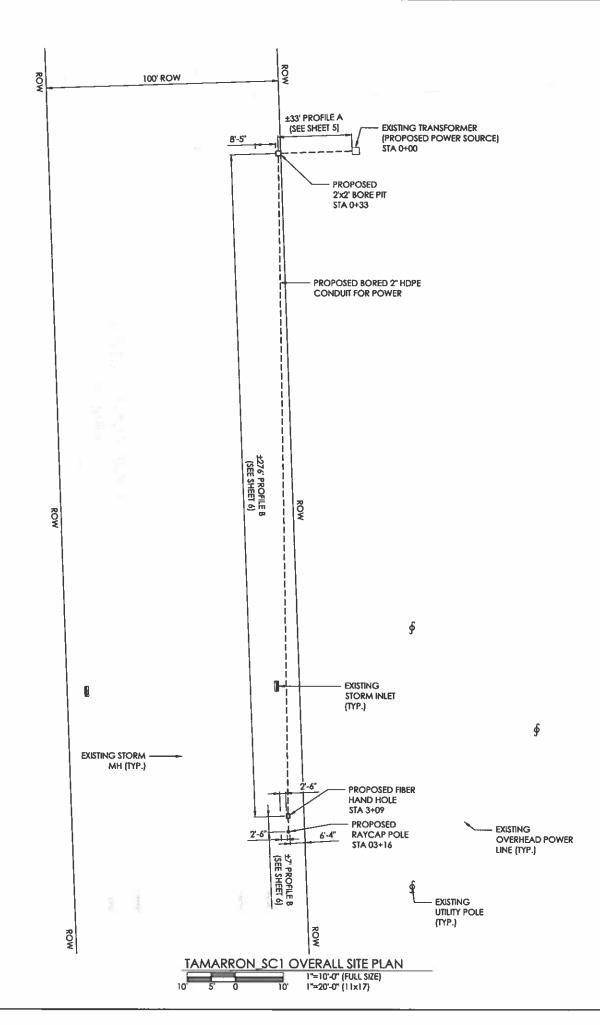



**POWER SOURCE** (FOR CONSTRUCTION USE ONLY)





**VERIZON** SMALL CELL NODE CONSTRUCTION PLANS FOR PROPOSED ANTENNA SITES

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DESIGNED: JG DRAWN: JG CHECKED: JG

JOB #: 23\_VIS-016

TAMARRON\_SC1 **OVERALL SITE PLAN** 



FLOODPLAIN:
TAMARRON\_SC1: THE PROPERTY SHOWN HEREON (EITHER TOTAL OR IN PORTION) IS
LOCATED IN FLOOD INSURANCE RATE MAP 45473C0350E DATED 2/18/2009
UNSHADED ZONE X - AREAS DETERMINED TO BE OUTSIDE THE 0.2 PERCENT ANNUAL
FLOOD CHANCE FLOODPLAIN.

BENCHMARK:

TAMARRON\_SC1: BENCHMARKS SHOWN HEREON REFERENCED TO HARRIS
COUNTY FLOODPLAIN MARKER NO. 190073R. FROM THE INTERSECTION OF FROM
L-10 (WEST) AND PEDERSON RD. GO SOUTH ON TEXAS HERITAGE PARKWAY, GO SOUTH ON TEXAS HERITAGE PARKWAY 0.36 MILES TO THE BRIDGE OVER WILLOW FORK.

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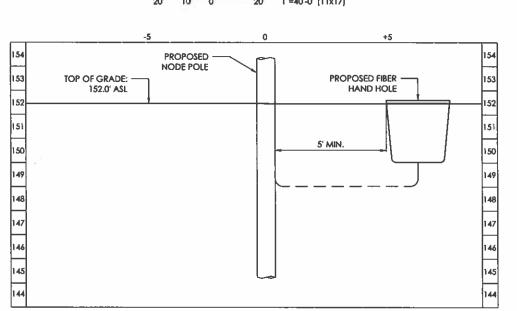
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POWER SOURCE COORDINATES:


LATITUDE/LONGITUDE: 29.76322202, -95.90142049

100' ROW EXISTING STORM -MH (TYP.) PROPOSED FIBER HAND HOLE - PROPOSED RAYCAP POLE TAMARRON\_SC1 SITE PLAN 1"=20'-0" (FULL SIZE) 1"=40'-0" (11x17)



TAMARRON\_SC1 PROFILE SCALE: 1" = 2'-0"

**AZIMUTHS** (FOR CONSTRUCTION USE ONLY)

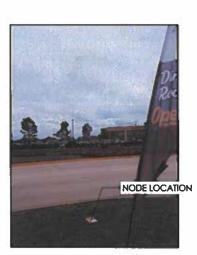

SITE PHOTO (FOR CONSTRUCTION USE ONLY)





**VERIZON** SMALL CELL NODE CONSTRUCTION PLANS FOR PROPOSED ANTENNA SITES

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DESIGNED: JG DRAWN: JG


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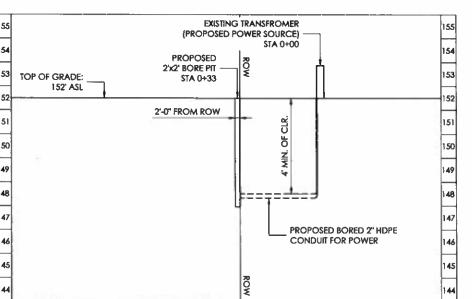
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TAMARRON\_SC1

NOTE:

ALL EXISTING LANDSCAPING AND OR PRIVATE UTILITIES AFFECTED BY CONSTRUCTION TO BE RESTORED TO ORIGINAL STATE UPON COMPLETION





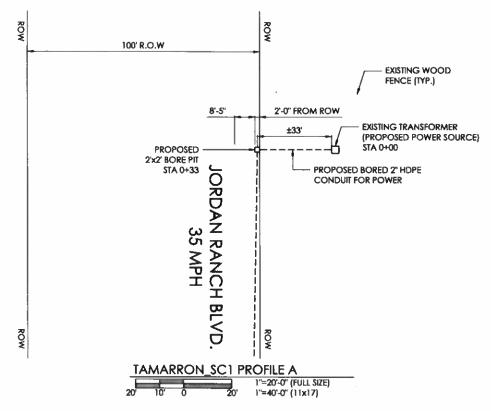





VERIZON

SMALL CELL NODE

CONSTRUCTION PLANS FOR

PROPOSED ANTENNA

SITES


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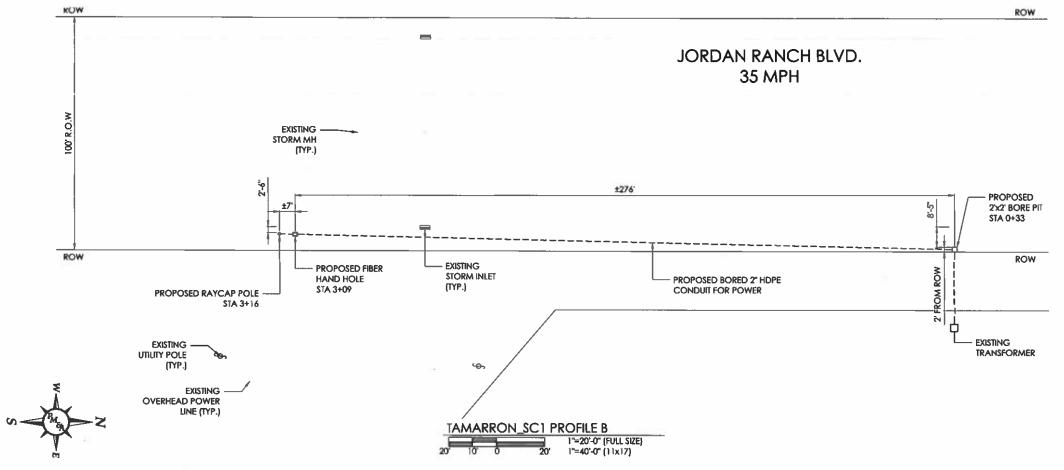



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TAMARRON\_SC1
POWER DESIGN





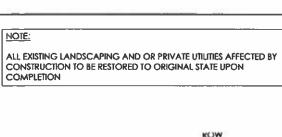

1"=2'-0" (FULL SIZE) 2' 1"=4'-0" (11x17)

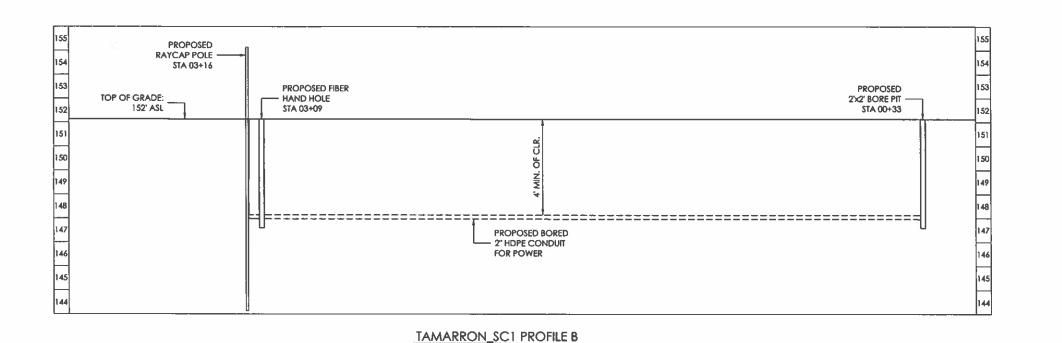



VERIZON

SMALL CELL NODE

CONSTRUCTION PLANS FOR

PROPOSED ANTENNA

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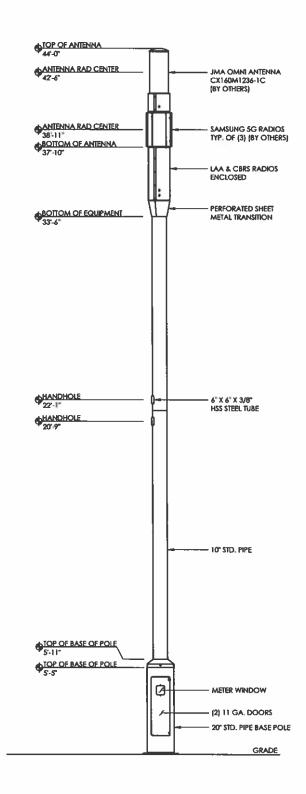
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TAMARRON\_SC1
POWER DESIGN 2









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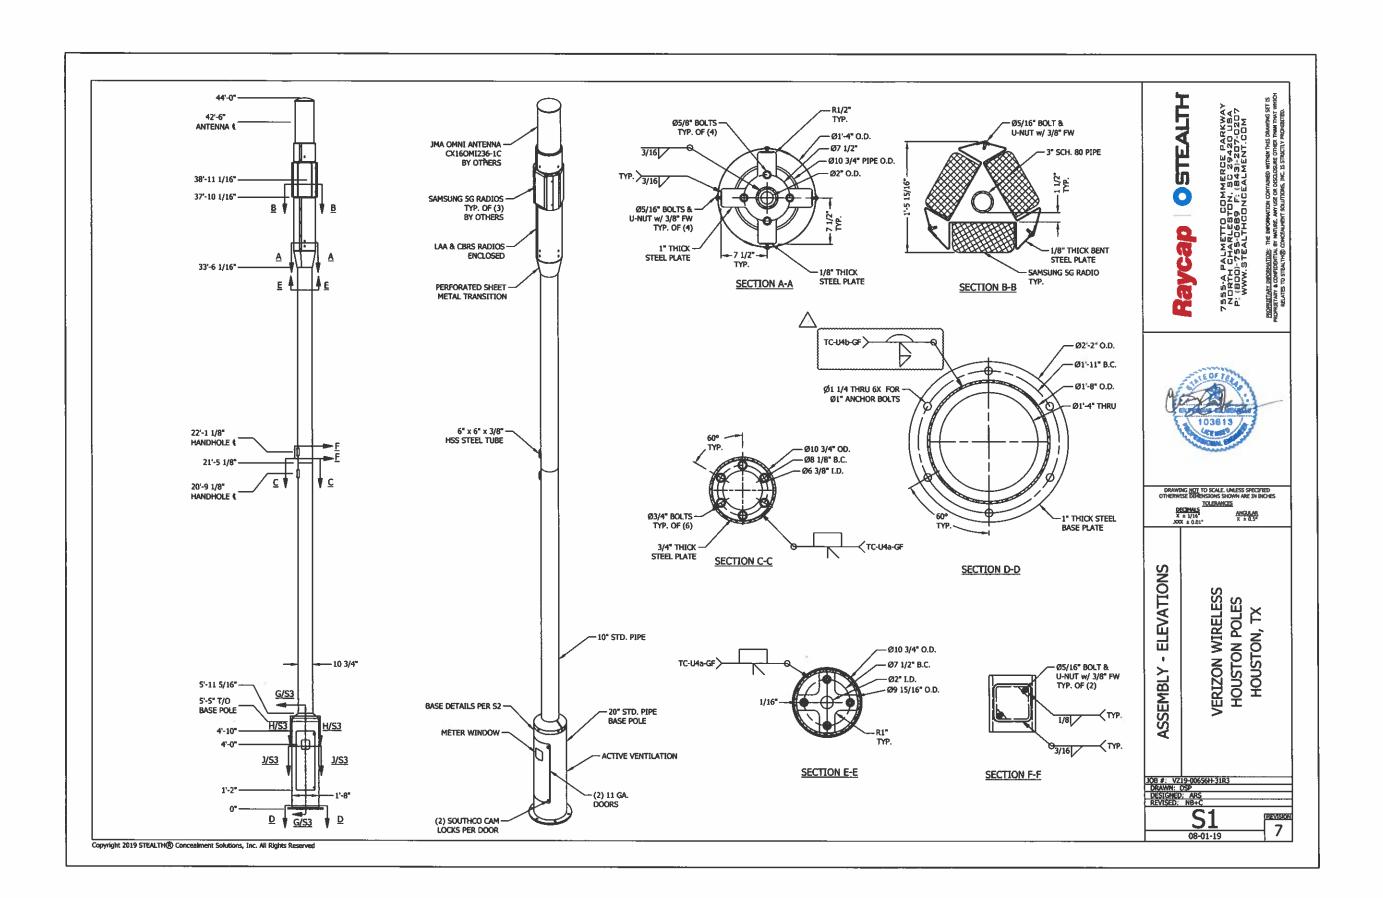
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**ELEVATION** 

7 OF 16

ELEVATION VIEW 4G RAYCAP STEALTH POLE NOT TO SCALE








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### **SPEC SHEET 1**






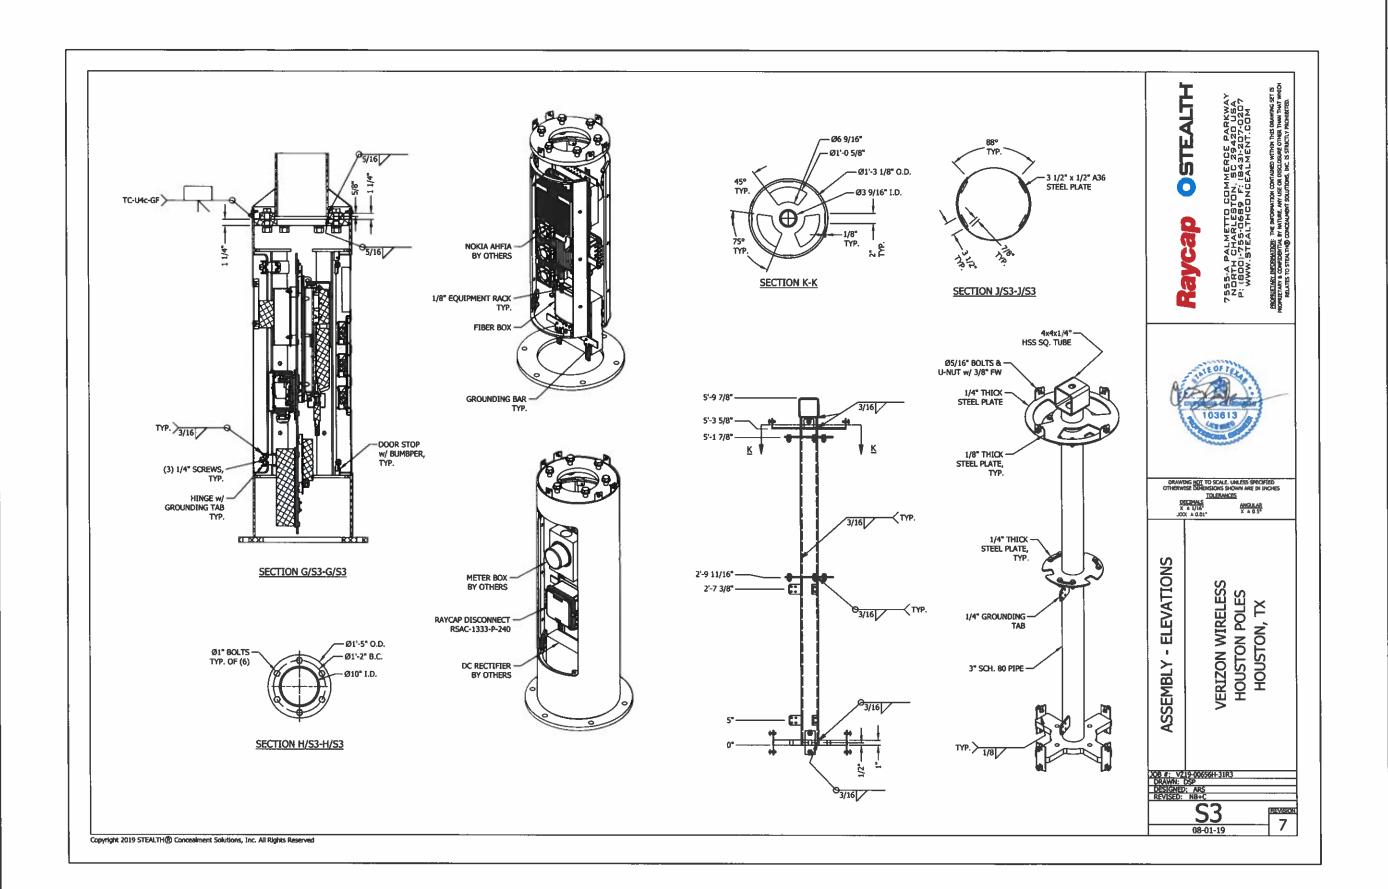

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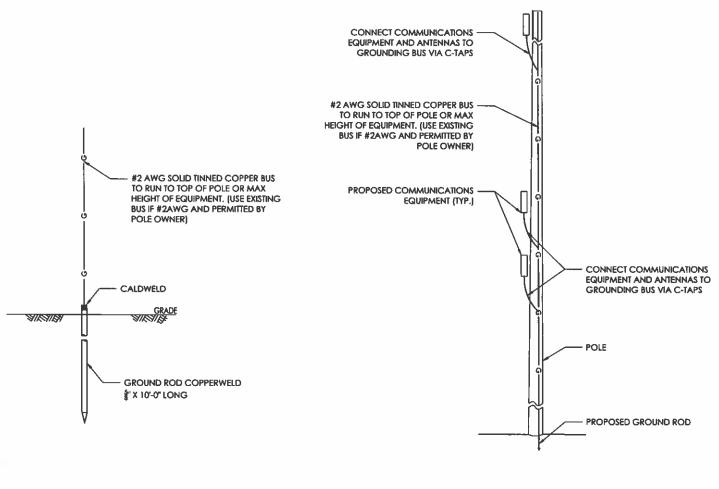


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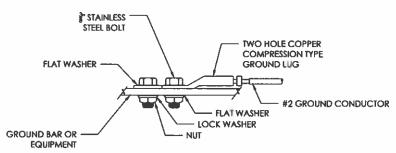
86101

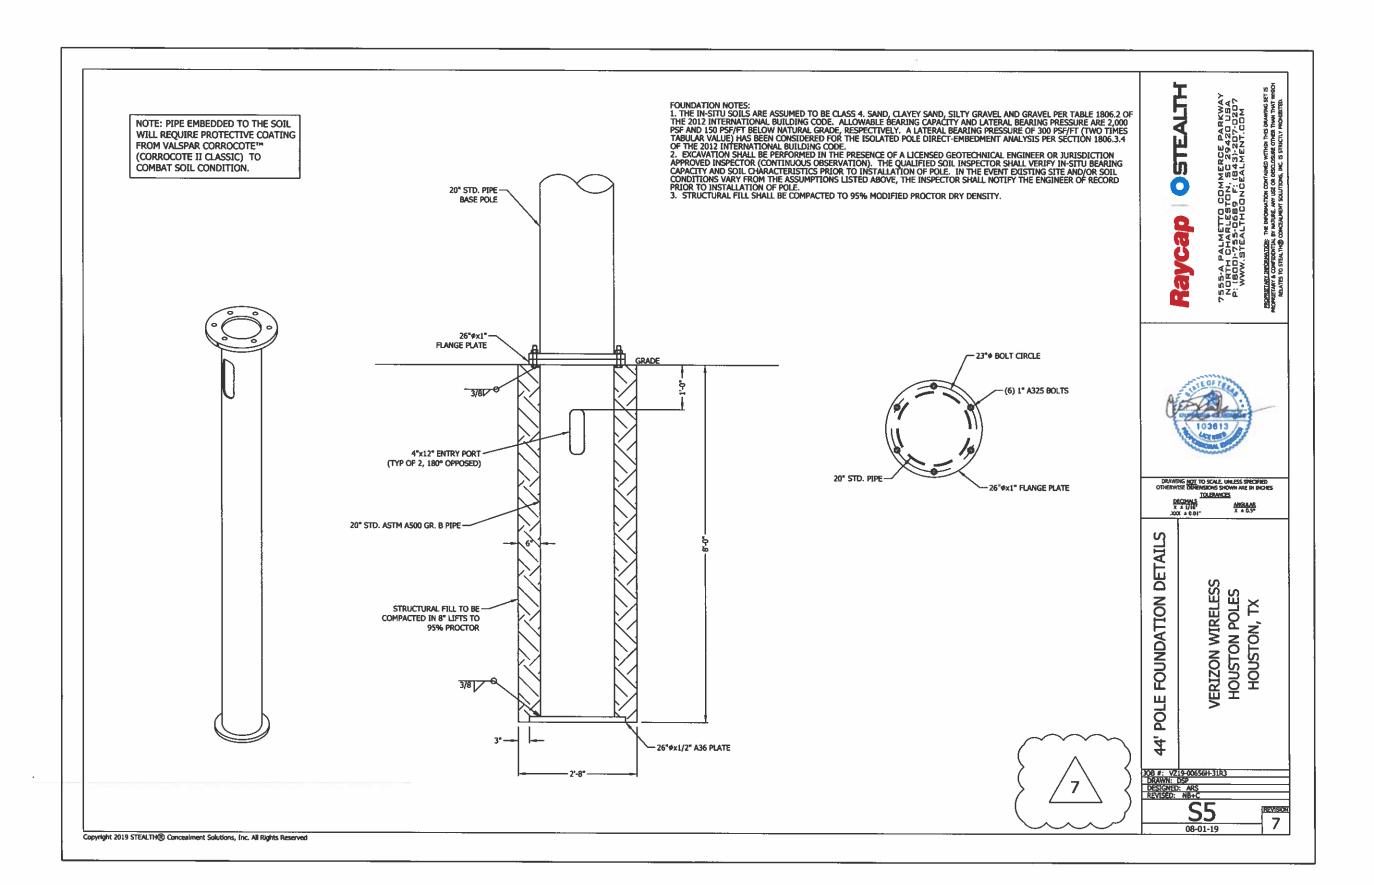

GROUND ROD AND BUS DETAIL SCALE: N.T.S.

POLE BUS GROUNDING DETAIL

\$CALE: N.T.S.



MECHANICAL GROUND CONNECTION

SCALE: N.T.S.





VERIZON

SMALL CELL NODE

CONSTRUCTION PLANS FOR

PROPOSED ANTENNA

SITES


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B	86101 CENSE	

DESIGNED: JG
DRAWN: JG
CHECKED: JG

J0B ∦: PKG 2

**GROUNDING** 

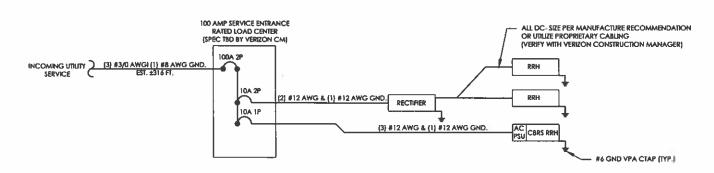

### TAMAARRON\_SC1 ONE LINE DIAGRAM NOT TO SCALE

P	AMEL NAME		LOCATION:			VOI	TAGE:	206	Y/ 120V	3 PHA	Œ	MOUNTING / ENCLOSURE:	EXISTING /	15	NEMA 3R
(P)	LV PAN	EL	SMALL CELL NODE			MA	M C/8:	100				AVAIL FAULT CURRENT:	4		
	12/20/2018					IUS R	ATING:	100	AMPS			SHORT CIRCUIT RATING:	14,000		
AMPS	POLES	TYPE	CIRCUIT DESCRIPTION	K	% (	776	A		С	ÇKT	KVA	CIRCUIT DESCRIPTION	TYPE	POLES	AMPS
			BLANK	0,0	× l	1	0.36			2	0.38	RECTIFIER		1	
			TBLANK	0.0	20	3		0.38		4	0.34	1		1 ² .	10
			BLANK	0.0	<b>%</b>	5	0.75			6		CBRS		1	HO
			BLANK	Q.	X0	7					0.00	BLANK		1	
			BLANK	0.0	<b>*</b>	9 "				10	0.00	BLAK		1	
			I BLAR	0.0	20	11	310			12	0.00	BLANK		1	
				PH	ASE TO	TAL	1,15	0.4	0.3	1(VA		531.7			$\overline{}$
* HACR TYP	E BREAKER								1	1		TOTAL CONNECTED LOAD	1	KVA	10 A
" GROUND	FAULT CIRC	UIT INTERA	NUPTER BREAKER				ŞU	8 PEED L	JUGS	1					
" ARC FAU	LT CIRCUIT	MTERRUPT	TER BREAKER			1	0	- 0	1 6	1		TOTAL DEMAND LOAD	1	KVA	10 A

4G LOAD ANALYSIS

NOT TO SCALE





VERIZON

SMALL CELL NODE

CONSTRUCTION PLANS FOR


PROPOSED ANTENNA


SITES


10.	DATE	REVISIONS
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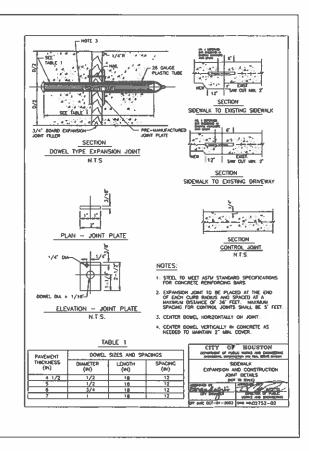
DESIGNED: JG
DRAWN: JG
CHECKED: JG
CHECKED: JG
PKG 2


ONE LINE AND LOAD ANALYSIS




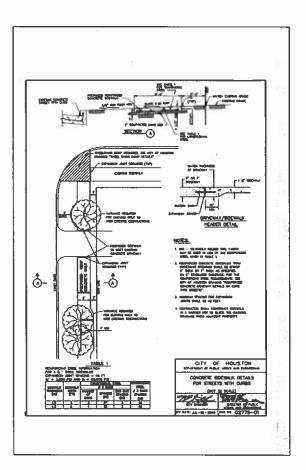


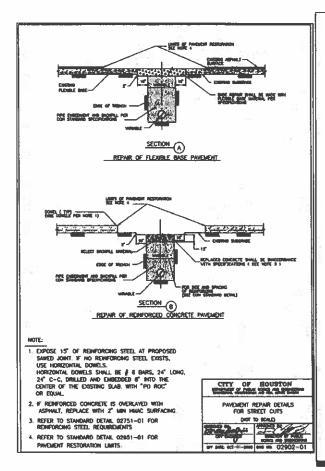

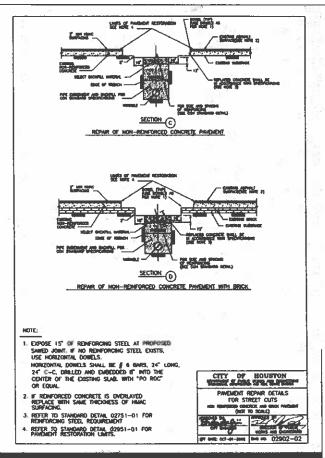

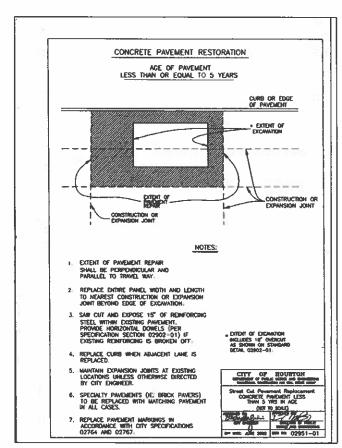

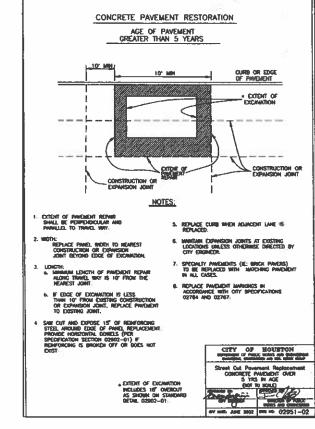

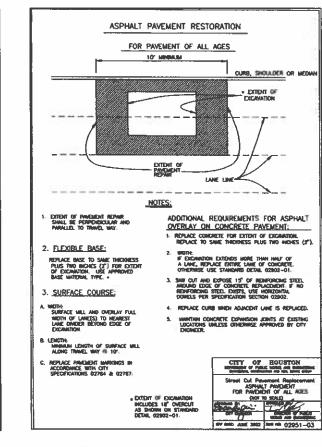





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EA.	RICK W WARS	7	CHECKED: JG
13	86101	3	JOB #:
. 3	COMIL C		PKG 2

**DETAILS** 

### GENERAL CONSTRUCTION DET

EXISTING GRADE


### TYPICAL DETAIL "B" INDUSTRY STANDARD

12"x12" CONCRETE ENCASEMENT

### 12" BELOW FINISHED GRADE


DIRECT BURIED HOPE

TYPICAL DETAIL "C" INDUSTRY STANDARD

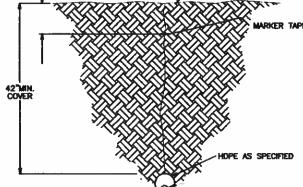


### INDUSTRY STANDARD TYPICAL DETAIL "D"

CRUSS SECTION OF NNERDUCT(S)
AND/OR HDPE(S) AS SPECIFIED

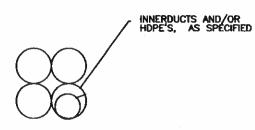


INDUSTRY STANDARD TYPICAL DETAIL "E"

HDPE WITH CABLE CROSS SECTION

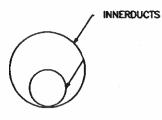


### TYPICAL DETAIL "H" INDUSTRY STANDARD


DIRECTIONAL BORE HOPE

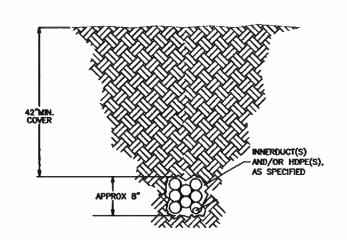


### INDUSTRY STANDARD TYPICAL DETAIL "F"

JACK AND BORE MAIN TRACK

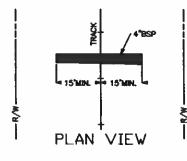

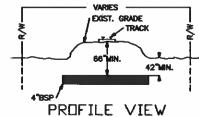

### INDUSTRY STANDARD TYPICAL DETAIL "G"

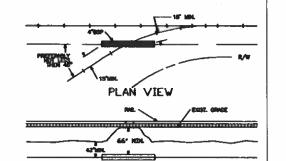

PROFILE VIEW



NO. DATE

0 06/13/23

1 11/28/23

DESIGNED: JG DRAWN: JG CHECKED: JG

> JOB #: PKG 2

**DETAILS 2** 

verizon

**VERIZON** 

SMALL CELL NODE CONSTRUCTION PLANS FOR PROPOSED ANTENNA SITES

REVISIONS

1ST SUBMITTAL

2ND SUBMITTAL


14 OF 16

	12" EXIST	TING GRADE
12" MIN. BELOW FINISHED GRADE		ED CABLE (ER TAPE
54" MIN. COVER		
	S AND/	RDUCT(S) /OR HDPE(S), PECIFIED
<u> </u>	CONI	
12"x12" CONCRETE		PECIFIED
MOTE:		


BACKFILL MUST BE MADE WITH ROCK FREE MATERIAL

### TYPICAL DETAIL "A" INDUSTRY STANDARD

TRENCH PLACEMENT
CONDUIT(S), HOPE(S) OR DIRECT BURIED CABLE.

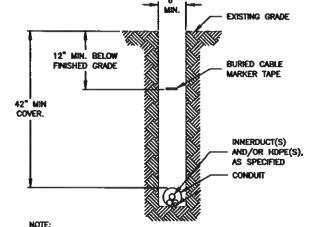

BACKFILL MUST BE MADE WITH ROCK FREE MATERIAL

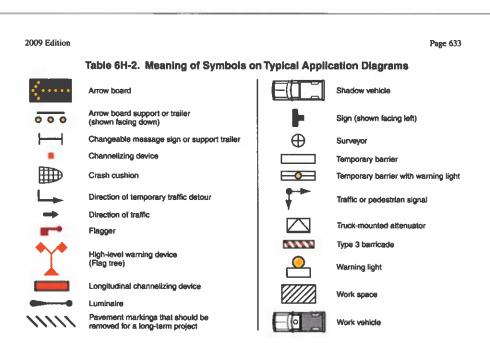

### Table 6H-3. Meaning of Letter Codes on Typical Application Diagrams

Bood Tone	Distance Between Signs**				
Road Type	A	В	С		
Urban (low speed)*	100 feet	100 feet	100 feet		
Urban (high speed)*	350 feet	350 feet	350 feet		
Rural	500 feet	500 feet	500 feet		
Expressway / Freeway	1,000 feet	1,500 feet	2,640 leet		

- \* Speed category to be determined by highway agency
- "The column headings A, B, and C are the dimensions shown in Figures 6ft-1 through 6ft-46. The A dimension is the distance from the transition or point of restriction to the first sign. The B dimension is the distance between the first and second signs. The C dimension is the distance between the second and third sign. Che "first sign" is the sign in a three-sign earlies that is closest to the TTC zone. The "third sign" is the sign that is furthest upstream from the TTC zone.]

Table 6H-4. Formulas for Determining Taper Length

Speed (S)	Taper Length (L) in feet
40 mph or less	WS <sup>2</sup>
40 mpir or less	60
45 mph or more	L= W\$


Where: L = taper length in feet

W = width of offset in feet

S = posted speed limit, or off-peak 85th-percentile
speed prior to work starting, or the anticipated
operating speed in mph

Sect. 6H.01

December 2009

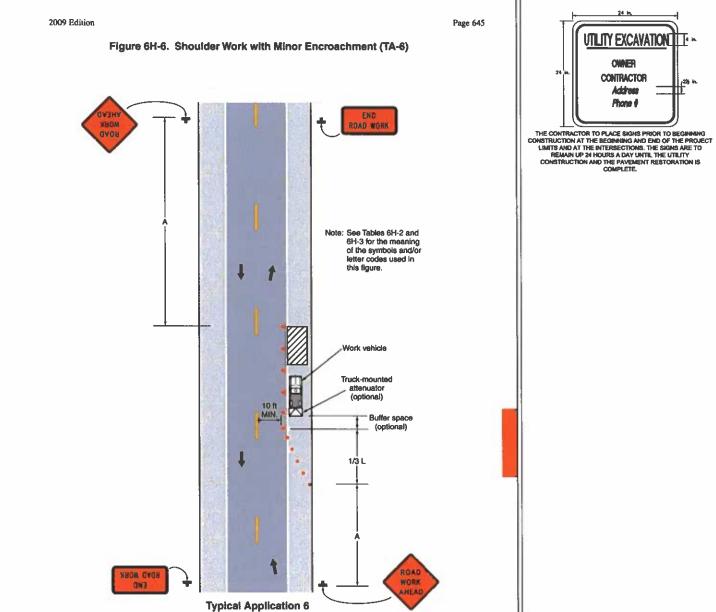





**UTILITY EXCAVATION** 

CWALER CONTRACTOR Address

Phone #

Sect. 681.01

**VERIZON** SMALL CELL NODE CONSTRUCTION PLANS FOR PROPOSED ANTENNA SITES

NO.	DATE	REVISIONS
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> JOB # PKG 2

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