


MAINTENANCE PLANS FOR
ADAMS LAKE DAM
LAND LOT 136, 7TH DISTRICT
FAYETTE COUNTY, GEORGIA
JANUARY 31, 2025
REVISED MARCH 28, 2025

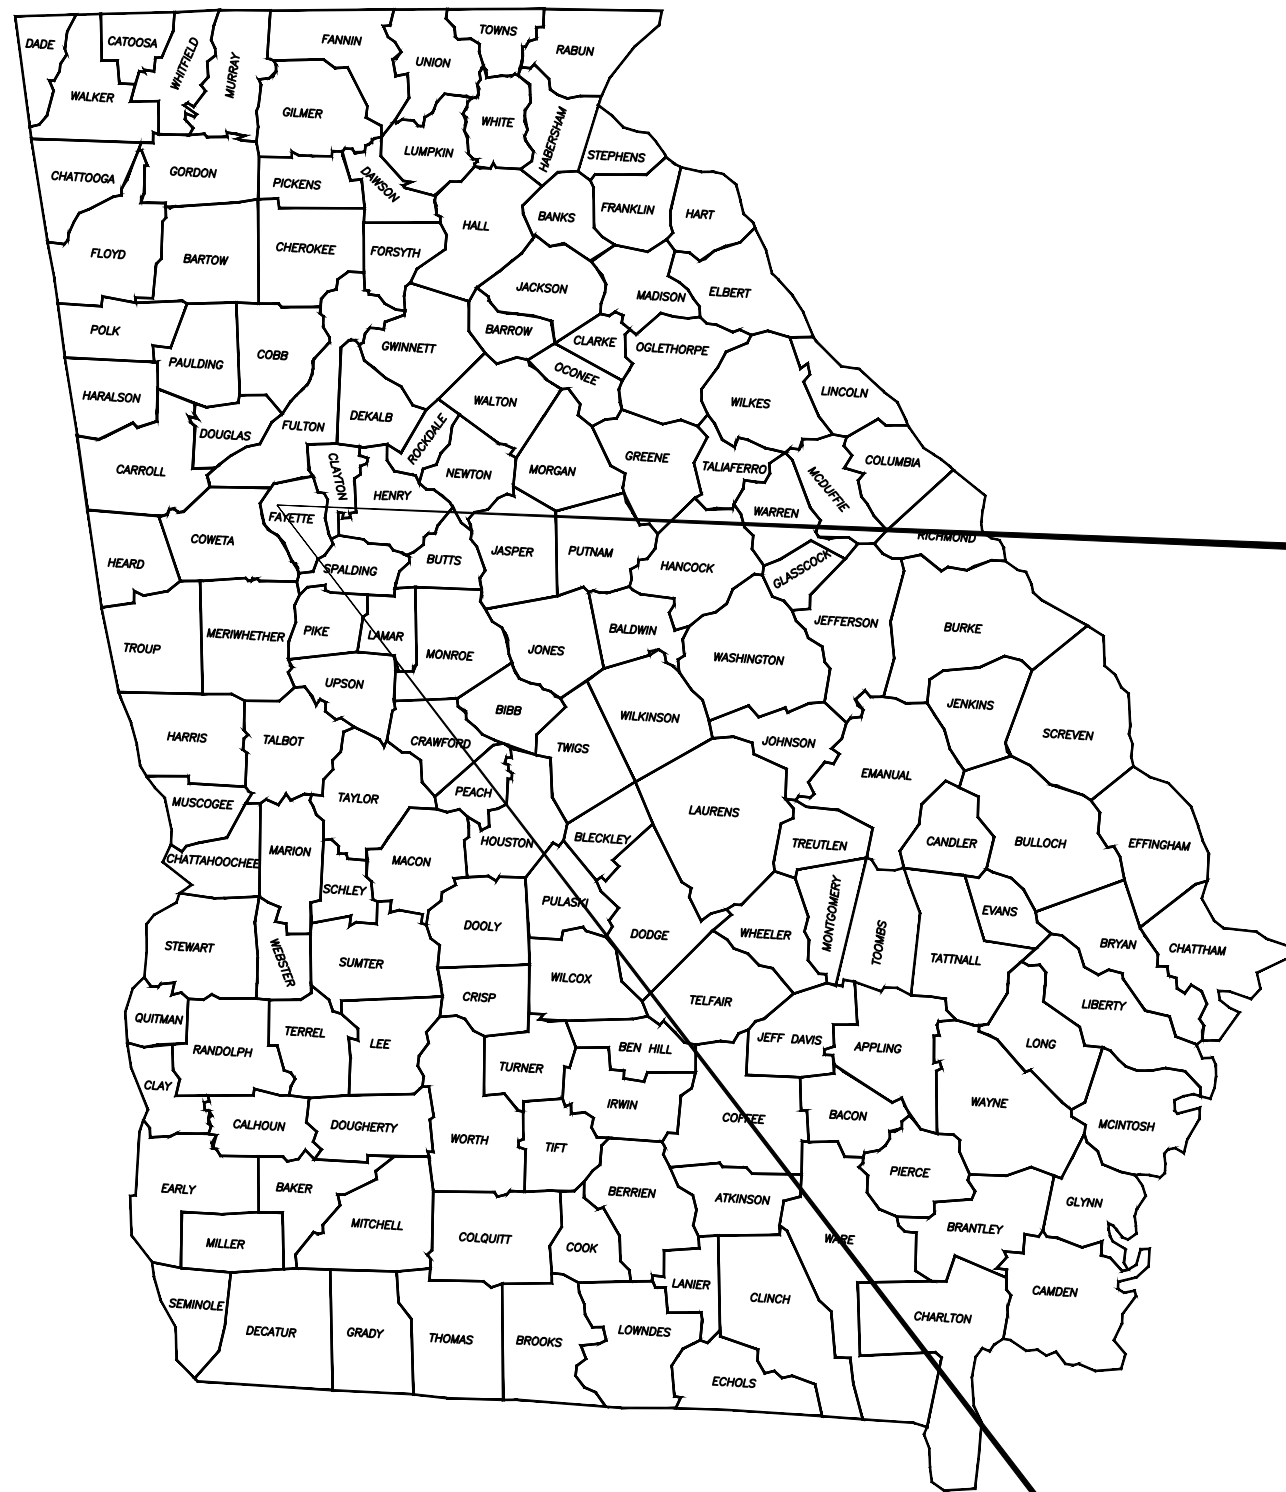

THE CONTRACTOR SHALL CONDUCT WORK IN ACCORDANCE WITH THE REQUIREMENTS OF APPLICABLE REGULATIONS OF THE OCCUPATIONAL SAFETY AND HEALTH ADMINISTRATION (OSHA) AND ALL LOCAL, STATE AND FEDERAL RULES AND REGULATIONS.



PERMITTEE (CONTRACTOR):
TO BE DETERMINED

PLANS PREPARED FOR:
SCOTT LANGFORD, PE
PUBLIC WORKS DIRECTOR & TOWN ENGINEER
TOWN OF TYRONE
950 SENOIA ROAD
TYRONE, GEORGIA 30290
CELL: (770) 487-4038
EMAIL: scott.langford@tyronega.gov

PLANS PREPARED BY:
SCHNABEL ENGINEERING, LLC
6445 SHILOH ROAD, SUITE A
ALPHARETTA, GEORGIA 30005

24-HOUR ENGINEER CONTACT:
J. TYLER COATS, P.E.
PHONE: (770) 781-8008
CELL: (770) 324-2460
EMAIL: tcoats@schnabel-eng.com


24-HOUR EROSION CONTROL CONTACT
CONTRACTOR (TO BE DETERMINED)

Sheet List Table	
Sheet Number	Sheet Title
01	COVER SHEET
02	GENERAL NOTES
03	EXISTING SITE PLAN
04	PROPOSED SITE PLAN
05	WAVE BERM PROFILE
06	WAVE BERM DETAILS
07	STORM DRAIN RIPRAP APRON DETAILS
08	ES&PC PLAN - CLEARING
09	ES&PC PLAN - GRADING
10	ES&PC PLAN - FINAL
11	ES&PC PLAN - DETAILS
12	ES&PC PLAN - NOTES (SHEET 1 OF 2)
13	ES&PC PLAN - NOTES (SHEET 2 OF 2)
14	GSWCC CHECKLIST

*ES&PC = EROSION, SEIDMENTATION, & POLLUTION CONTROL

PROJECT DESCRIPTION

THE PROJECT INVOLVES IMPROVEMENTS AND MODIFICATIONS TO AN EXISTING EARTHEN EMBANKMENT DAM. THE PROPOSED MEASURES INCLUDE CLEARING AND GRUBBING OF TREES AND OTHER INAPPROPRIATE VEGETATION FROM THE EMBANKMENT SLOPES AND IN THE VICINITY OF THE SIPHON SPILLWAY PLUNGE POOL, INSTALLING A RIPRAP-ARMORED WAVE PROTECTION BERM ALONG THE UPSTREAM SLOPE, AND REGRADING AND ARMORING THE STORM DRAIN OUTLET CHANNEL IN THE RIGHT ABUTMENT WITH RIPRAP. ALL DISTURBED AREAS NOT RECEIVING RIPRAP SHALL BE STABILIZED WITH PERMANENT VEGETATION.

DESIGNED BY: MCG	DRAWN BY: MCG	CHECKED BY: JTC	1	ADDRESS TOWN OF TYRONE COMMENTS	3/28/25
J. TYLER COATS, P.E.					
GEORGIA PROFESSIONAL ENGINEER NO. PE035603  DATE: 03-28-2025			REV	DESCRIPTION	DATE



ADAMS LAKE DAM
TOWN OF TYRONE
FAYETTE COUNTY, GEORGIA

COVER SHEET



PROJECT NOS.:
SCHNABEL: 24170041.000
OWN OF TYRONE: PW-2024-10


DATE: JANUARY 2025

SHEET
01 OF 14

1. SCHNABEL ENGINEERING, LLC IS SOLELY RESPONSIBLE FOR THE PREPARATION OF THE MAINTENANCE PLANS FOR THE SUBJECT DAM. ADHERENCE TO THESE PLANS, AS WELL AS ADHERENCE TO GOVERNMENT AND COUNTY REGULATIONS, ARE THE SOLE RESPONSIBILITY OF THE CONTRACTOR.
2. CONTRACTOR TO VERIFY ALL CONDITIONS, ELEVATIONS AND DIMENSIONS BEFORE BEGINNING CONSTRUCTION. ANY DISCREPANCIES SHALL BE REPORTED TO THE ENGINEER FOR JUSTIFICATION AND/OR CORRECTION BEFORE PROCEEDING WITH THE WORK. CONTRACTOR TO ASSUME RESPONSIBILITY FOR DISCREPANCIES THAT ARE NOT REPORTED. ALL DIMENSIONS SHOULD BE READ OR CALCULATED.
3. CONTRACTOR TO HAVE ALL UTILITIES FIELD LOCATED AND CLEARLY MARKED PRIOR TO THE START OF ANY CONSTRUCTION ACTIVITY.
4. THE CONTRACTOR SHALL CONDUCT ALL WORK IN ACCORDANCE WITH THE REQUIREMENTS OF THE OCCUPATIONAL SAFETY AND HEALTH ADMINISTRATION (OSHA) AND ALL LOCAL, STATE AND FEDERAL RULES AND REGULATIONS. PROPER SAFETY PROCEDURES ARE OF SPECIAL CONCERN ON THE PROJECT CONSIDERING THAT WORKERS MAY BE WORKING OR NEAR EXCAVATIONS.
5. ALL MATERIALS AND WORK PERFORMED SHALL COMPLY WITH THE TECHNICAL SPECIFICATIONS OF THE PROJECT.
6. CONTRACTOR TO PROVIDE ENGINEER WITH AN AS-BUILT, FIELD-RUN TOPOGRAPHIC SURVEY PERFORMED BY A GEORGIA REGISTERED SURVEYOR AT THE CONCLUSION OF THE PROJECT. SURVEY TO BE PROVIDED IN .PDF AND .DWG FORMAT.



1. CONTRACTOR SHALL BUILD, MAINTAIN AND OPERATE ANY TEMPORARY DIKES, COFFERDAMS, CHANNELS, FLUMES, SUMPS AND OTHER TEMPORARY DIVERSION AND PROTECTIVE WORKS NEEDED TO DIVERT SURFACE WATER FROM THE CONSTRUCTION WORK WHILE CONSTRUCTION IS IN PROGRESS. DIVERSION OR RETENTION OF SURFACE WATERS WILL BE CONTINUED UNTIL SUCH TIME AS DETERMINED BY THE ENGINEER.
2. FOUNDATIONS FOR CONCRETE, AND OTHER PARTS OF THE CONSTRUCTION SITE, SHALL BE DEWATERED AND KEPT FREE OF STANDING WATER OR EXCESSIVELY MUDDY OR SOFT CONDITIONS AS NEEDED FOR PROPER EXECUTION OF THE CONSTRUCTION WORK.
3. DEWATERING METHODS FOR FOUNDATION CONSTRUCTION OR SUBGRADE PREPARATION THAT CAUSE A LOSS OF FINES FROM FOUNDATION OR SUBGRADE AREAS WILL NOT BE PERMITTED.
4. CONTRACTOR WILL BE RESPONSIBLE FOR ANY DAMAGES INCURRED AS A RESULT OF THE LACK OF ADEQUATE SURFACE OR SUBSURFACE WATER CONTROL.
5. CONTRACTOR IS TO PROVIDE THE ENGINEER WITH A WATER CONTROL PLAN FOR REVIEW AND ACCEPTANCE PRIOR TO THE START OF CONSTRUCTION. THE CONTRACTOR MAY UTILIZE THE EXISTING SIPHON SPILLWAY TO FACILITATE LOWERING/DRAINING OF THE LAKE. IF THE CONTRACTOR INTENDS TO USE THE SIPHON SPILLWAY, THE SUBMITTED CONTROL OF WATER PLAN SHALL INCLUDE THIS INTENTION AND INCLUDE CLOSE AND TIMELY COORDINATION WITH THE TOWN OF TYRONE WITH REGARD TO USE OF THE SIPHON SPILLWAY.
6. A MINIMUM OF SEVEN (7) DAYS' PRIOR TO PERFORMING WORK ALONG THE UPSTREAM SLOPE OF THE DAM, THE CONTRACTOR SHALL LOWER AND MAINTAIN THE POOL ELEVATION OF THE LAKE IN A LOWERED STATE THAT IS A MINIMUM OF THREE (3) VERTICAL FEET BELOW THE EXTENT OF ANY PROPOSED WORKS OF IMPROVEMENTS.
7. THE CONTRACTOR'S CONTROL OF WATER PLAN SHALL INCLUDE CONSIDERATIONS AND ACTIVITIES ASSOCIATED WITH THE REMOVAL, DISPOSAL, AND/OR RELOCATION OF FISH AND OTHER AQUATIC SPECIES PRIOR TO OR DURING THE DEWATERING OF THE LAKE. THE CONTRACTOR SHALL COORDINATE WITH THE TOWN OF TYRONE TO DETERMINE ACCEPTABLE REMOVAL, DISPOSAL, AND/OR RELOCATION METHODS.

1. ALL AREAS TO RECEIVE STRUCTURAL FILL TO BE CLEARED AND STRIPPED FREE OF TOPSOIL, ROOTS, STUMPS, ORGANICS AND ALL OTHER DELETERIOUS MATERIAL.
2. SUBGRADE AREAS WHICH ARE EXCESSIVELY WET, SOFT, OR DEEMED OTHERWISE UNSUITABLE BY THE ENGINEER, SHALL BE UNDERCUT AND REPLACED WITH FILL MATERIALS AS RECOMMENDED BY THE ENGINEER AND COMPACTED IN ACCORDANCE WITH NOTE (4) OF THIS SECTION.
3. AREAS TO RECEIVE STRUCTURAL FILL SHALL BE BENCHED INTO EXISTING SLOPES, DENSIFIED, AND SHALL BE AT SUCH MOISTURE CONTENT THAT THE FILL SOILS CAN BE COMPACTED AGAINST THE SLOPE TO EFFECT A GOOD BOND BETWEEN THE FILL SOILS AND THE EXISTING SOILS.
4. STRUCTURAL FILL TO BE PLACED IN MAXIMUM 9-INCH LOOSE LIFTS AND COMPACTED TO AT LEAST 95% OF THE MAXIMUM STANDARD PROCTOR DRY DENSITY AND BETWEEN OPTIMUM AND 4% ABOVE OPTIMUM MOISTURE CONTENT AS DETERMINED BY THE STANDARD PROCTOR TEST (ASTM D-698), HAND COMPACTED FILL, INCLUDING FILL COMPACTED BY MANUALLY DIRECTED POWER TAMPERS TO BE PLACED IN MAXIMUM 6-INCH LOOSE LIFTS AND COMPACTED TO AT LEAST 95% OF THE MAXIMUM STANDARD PROCTOR DRY DENSITY AND BETWEEN OPTIMUM AND 4% ABOVE OPTIMUM MOISTURE CONTENT AS DETERMINED BY THE STANDARD PROCTOR TEST (ASTM D-698).
5. ALL FILL SOILS TO BE PLACED UNDER THE OBSERVATION OF THE ENGINEER OR HIS REPRESENTATIVE.
6. CONTRACTOR SHALL ANTICIPATE THE NEED TO IMPORT EARTH FILL MATERIAL TO SUPPLEMENT ON-SITE SOILS, IF THE ON-SITE MATERIAL IS NOT OF SUFFICIENT QUANTITY TO ACHIEVE THE PROPOSED GRADE. SHOULD THE ON-SITE MATERIAL NOT MEET PROJECT REQUIREMENTS OR BE OF INSUFFICIENT QUANTITY, CONTRACTOR SHALL IDENTIFY AN OFFSITE BORROW SOURCE THAT MEETS PROJECT REQUIREMENTS AND SUBMIT SOIL SAMPLES TO THE ENGINEER FOR REVIEW AND APPROVAL.
7. UTILIZE SHEEPSFOOT ROLLER TO COMPACT SOILS IN MASS GRADING/FILLING ACTIVITIES. MECHANICAL HAND TAMPERS WILL BE USED TO COMPACT SOIL AROUND, ABOVE OR ADJACENT TO STRUCTURES AND/OR CONDUITS WHERE THE USE OF LARGE SHEEPSFOOT ROLLERS MAY DAMAGE STRUCTURES. MECHANICAL HAND TAMPERS WILL BE USED WITHIN 3 FEET OF ALL STRUCTURES.

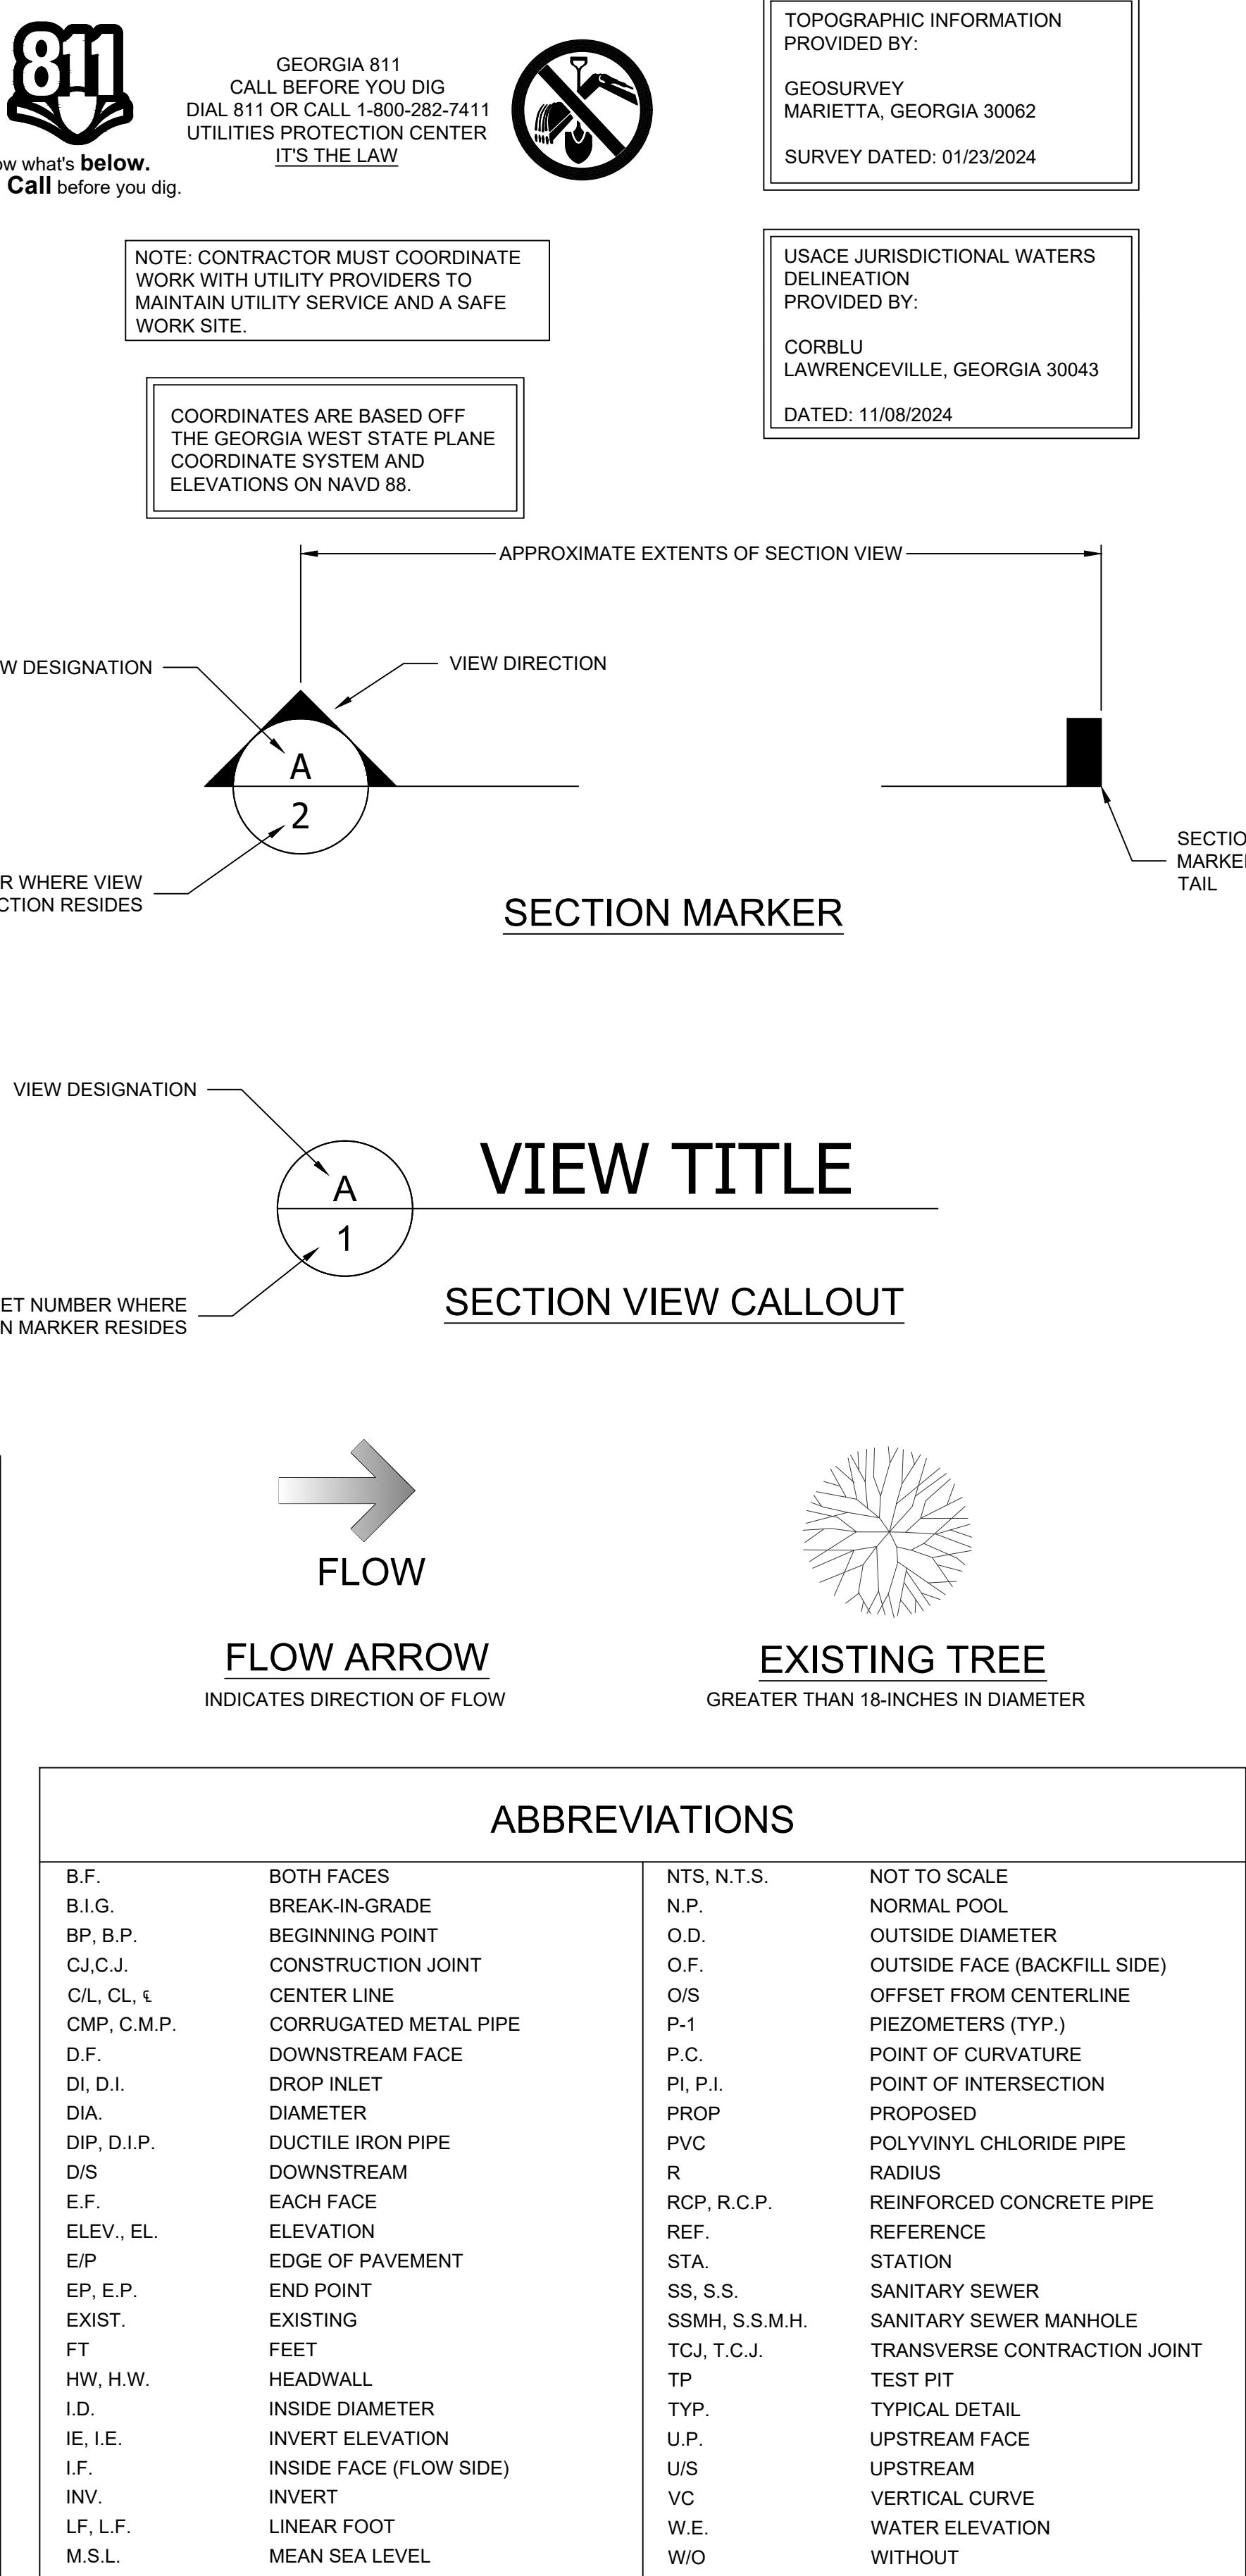


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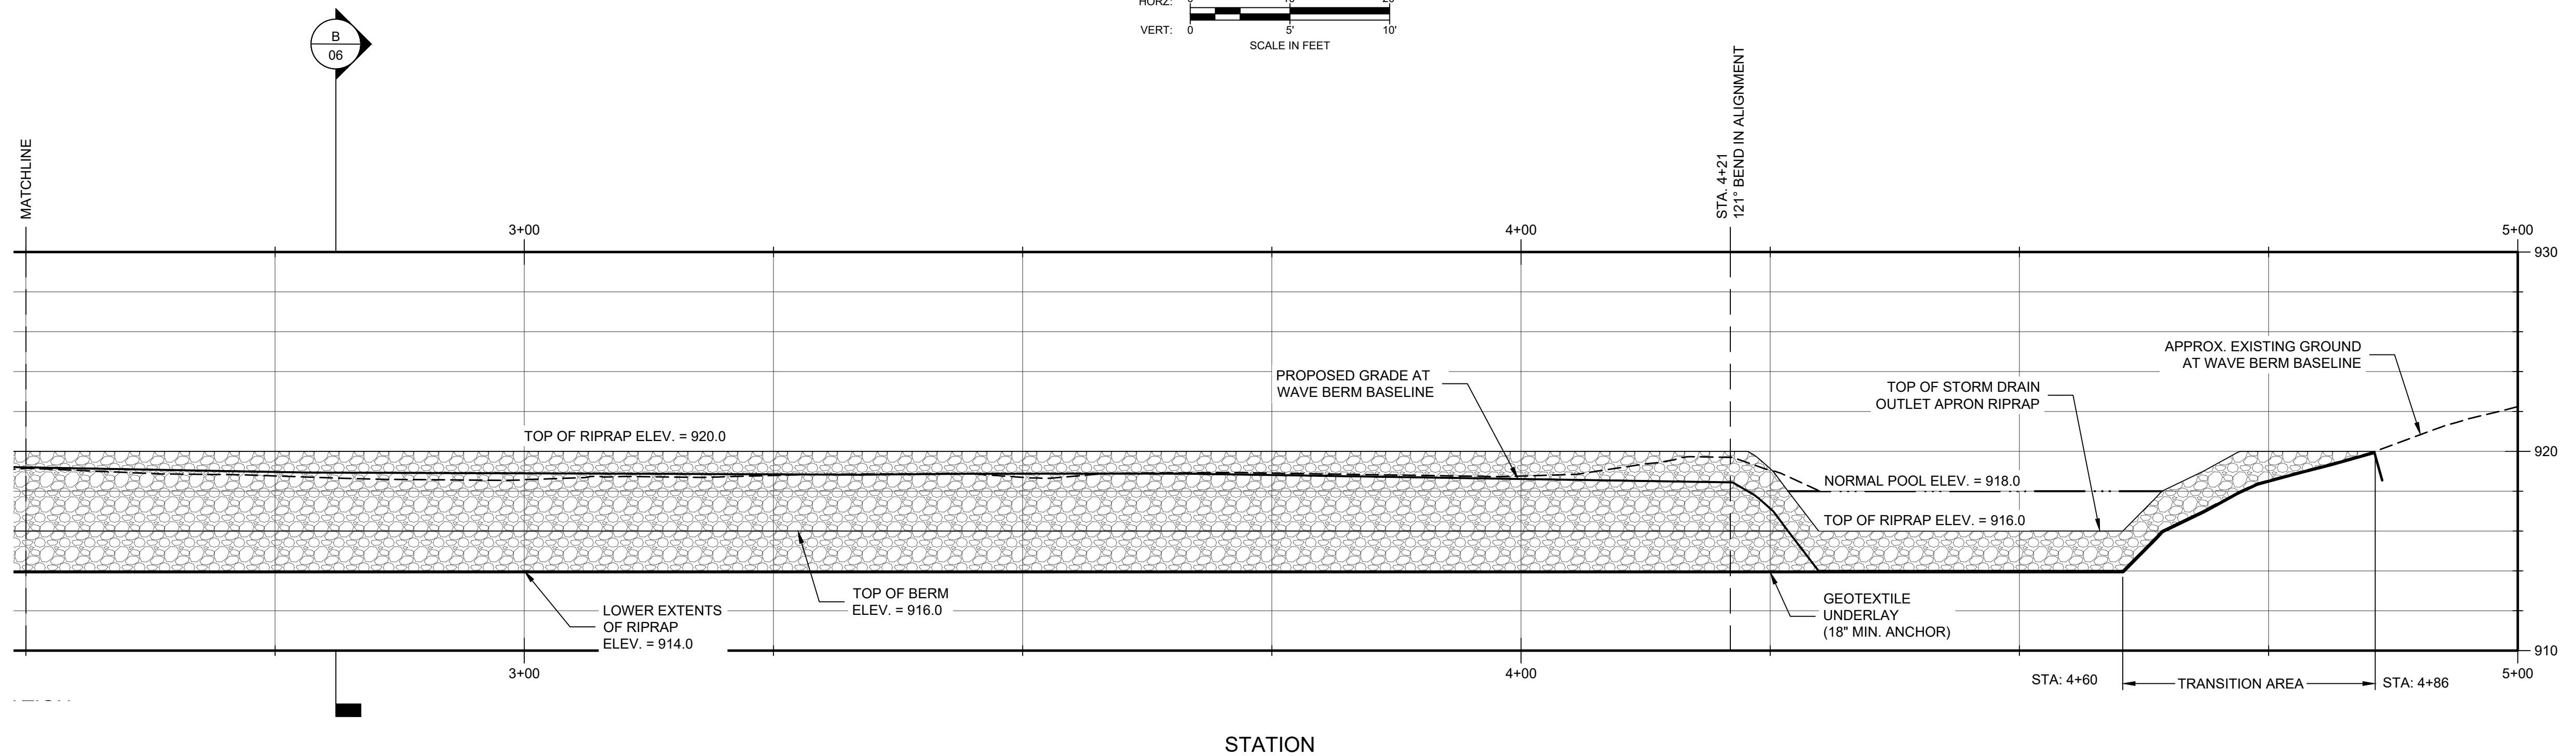
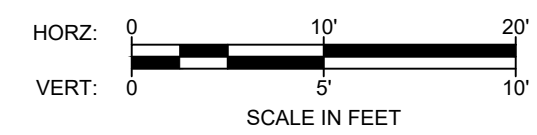
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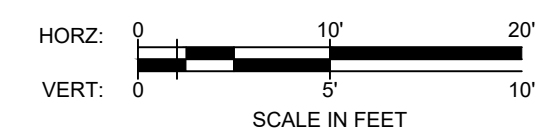
3/28/25	ADDRESS TOWN OF TYRONE COMMENTS	CHECKED BY: JTC	DESIGNED BY: MCG	DATE: 02-12-2025	DESCRIPTION
1		DRAWN BY: MCG		J. TYLER COATS, P.E.	REV
GEORGIA REGISTERED PROFESSIONAL ENGINEER No. 35603 JONATHAN TYLER 02-12-2025					
Schnabel ENGINEERING 6445 Shiloh Road, Suite A / Alpharetta, GA 30005 / Phone: 770-781-8008 / Fax: 770-781-8003 / schnabel-eng.com					
ADAMS LAKE DAM TOWN OF TYRONE FAYETTE COUNTY, GEORGIA					
PROPOSED SITE PLAN					
PROJECT NOS.: SCHNABEL: 24170041.000 TOWN OF TYRONE: PW-2024-10					
DATE: JANUARY 2025					
SHEET 04 OF 14					

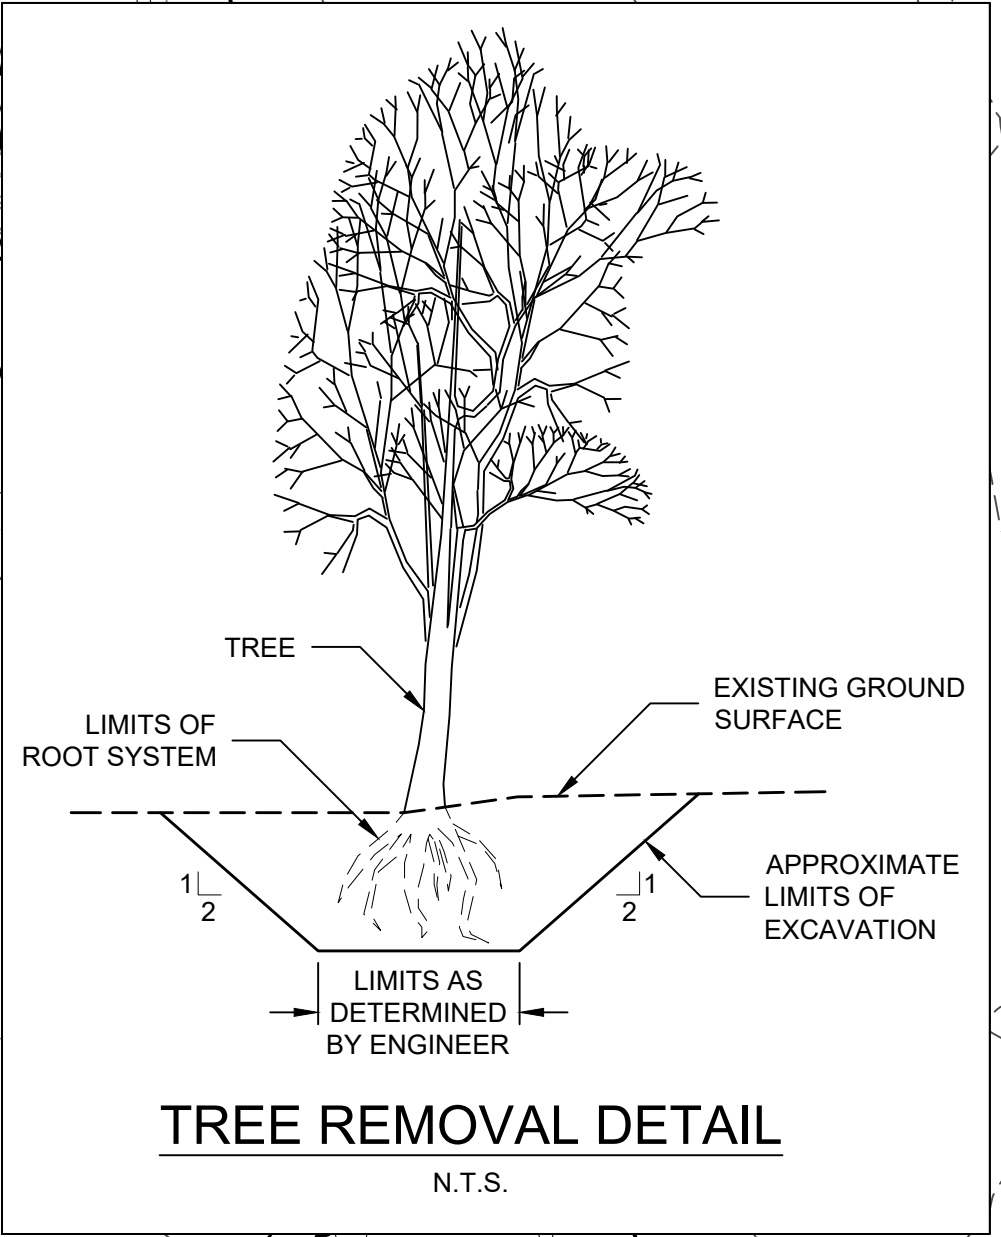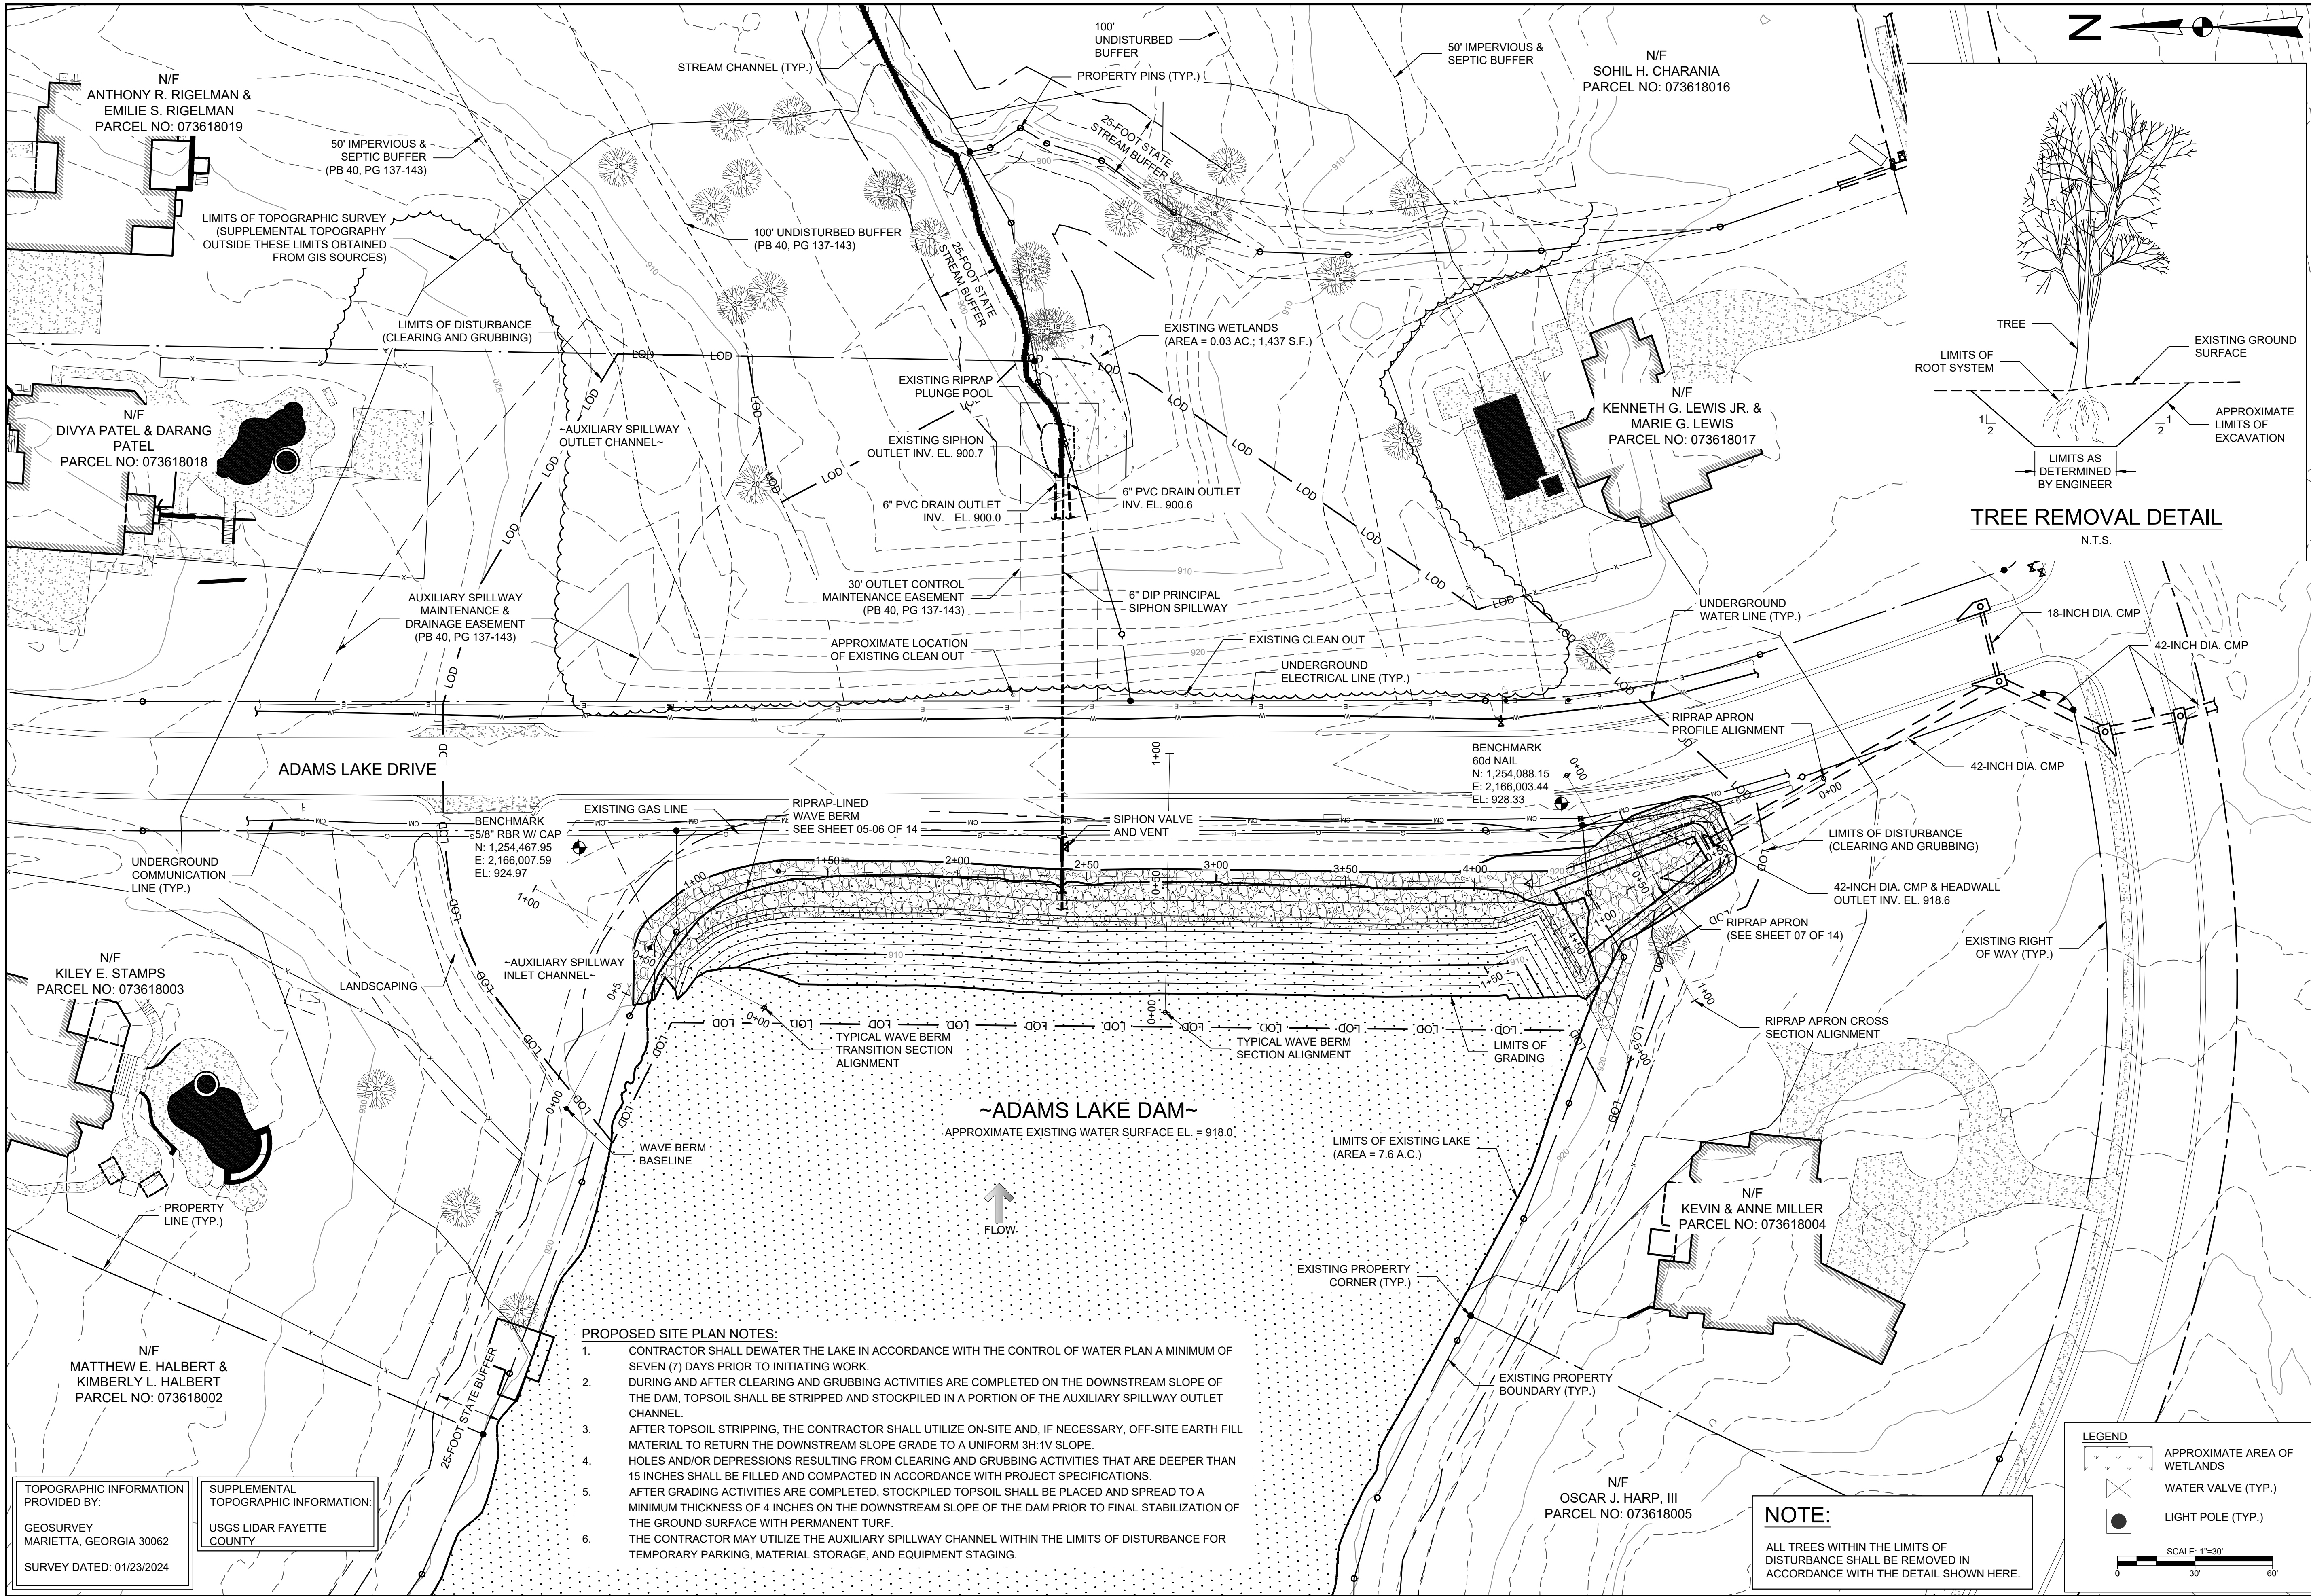

WAVE BERM ELEVATION

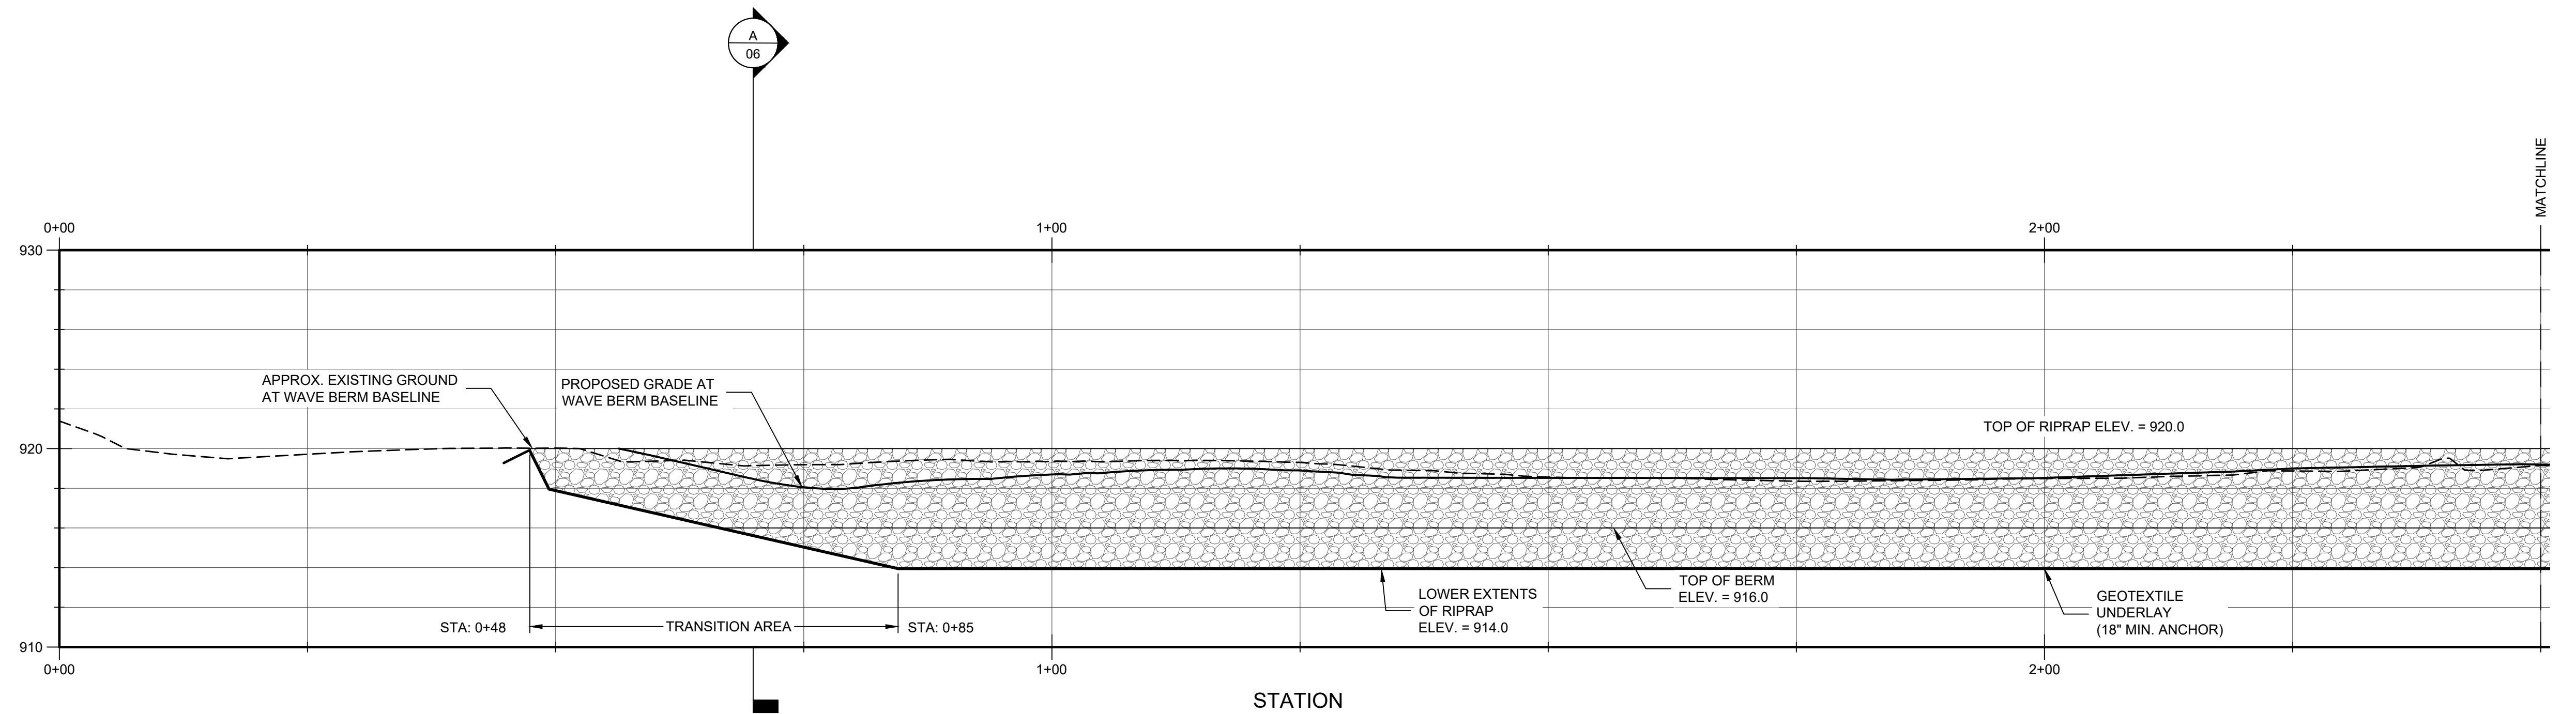



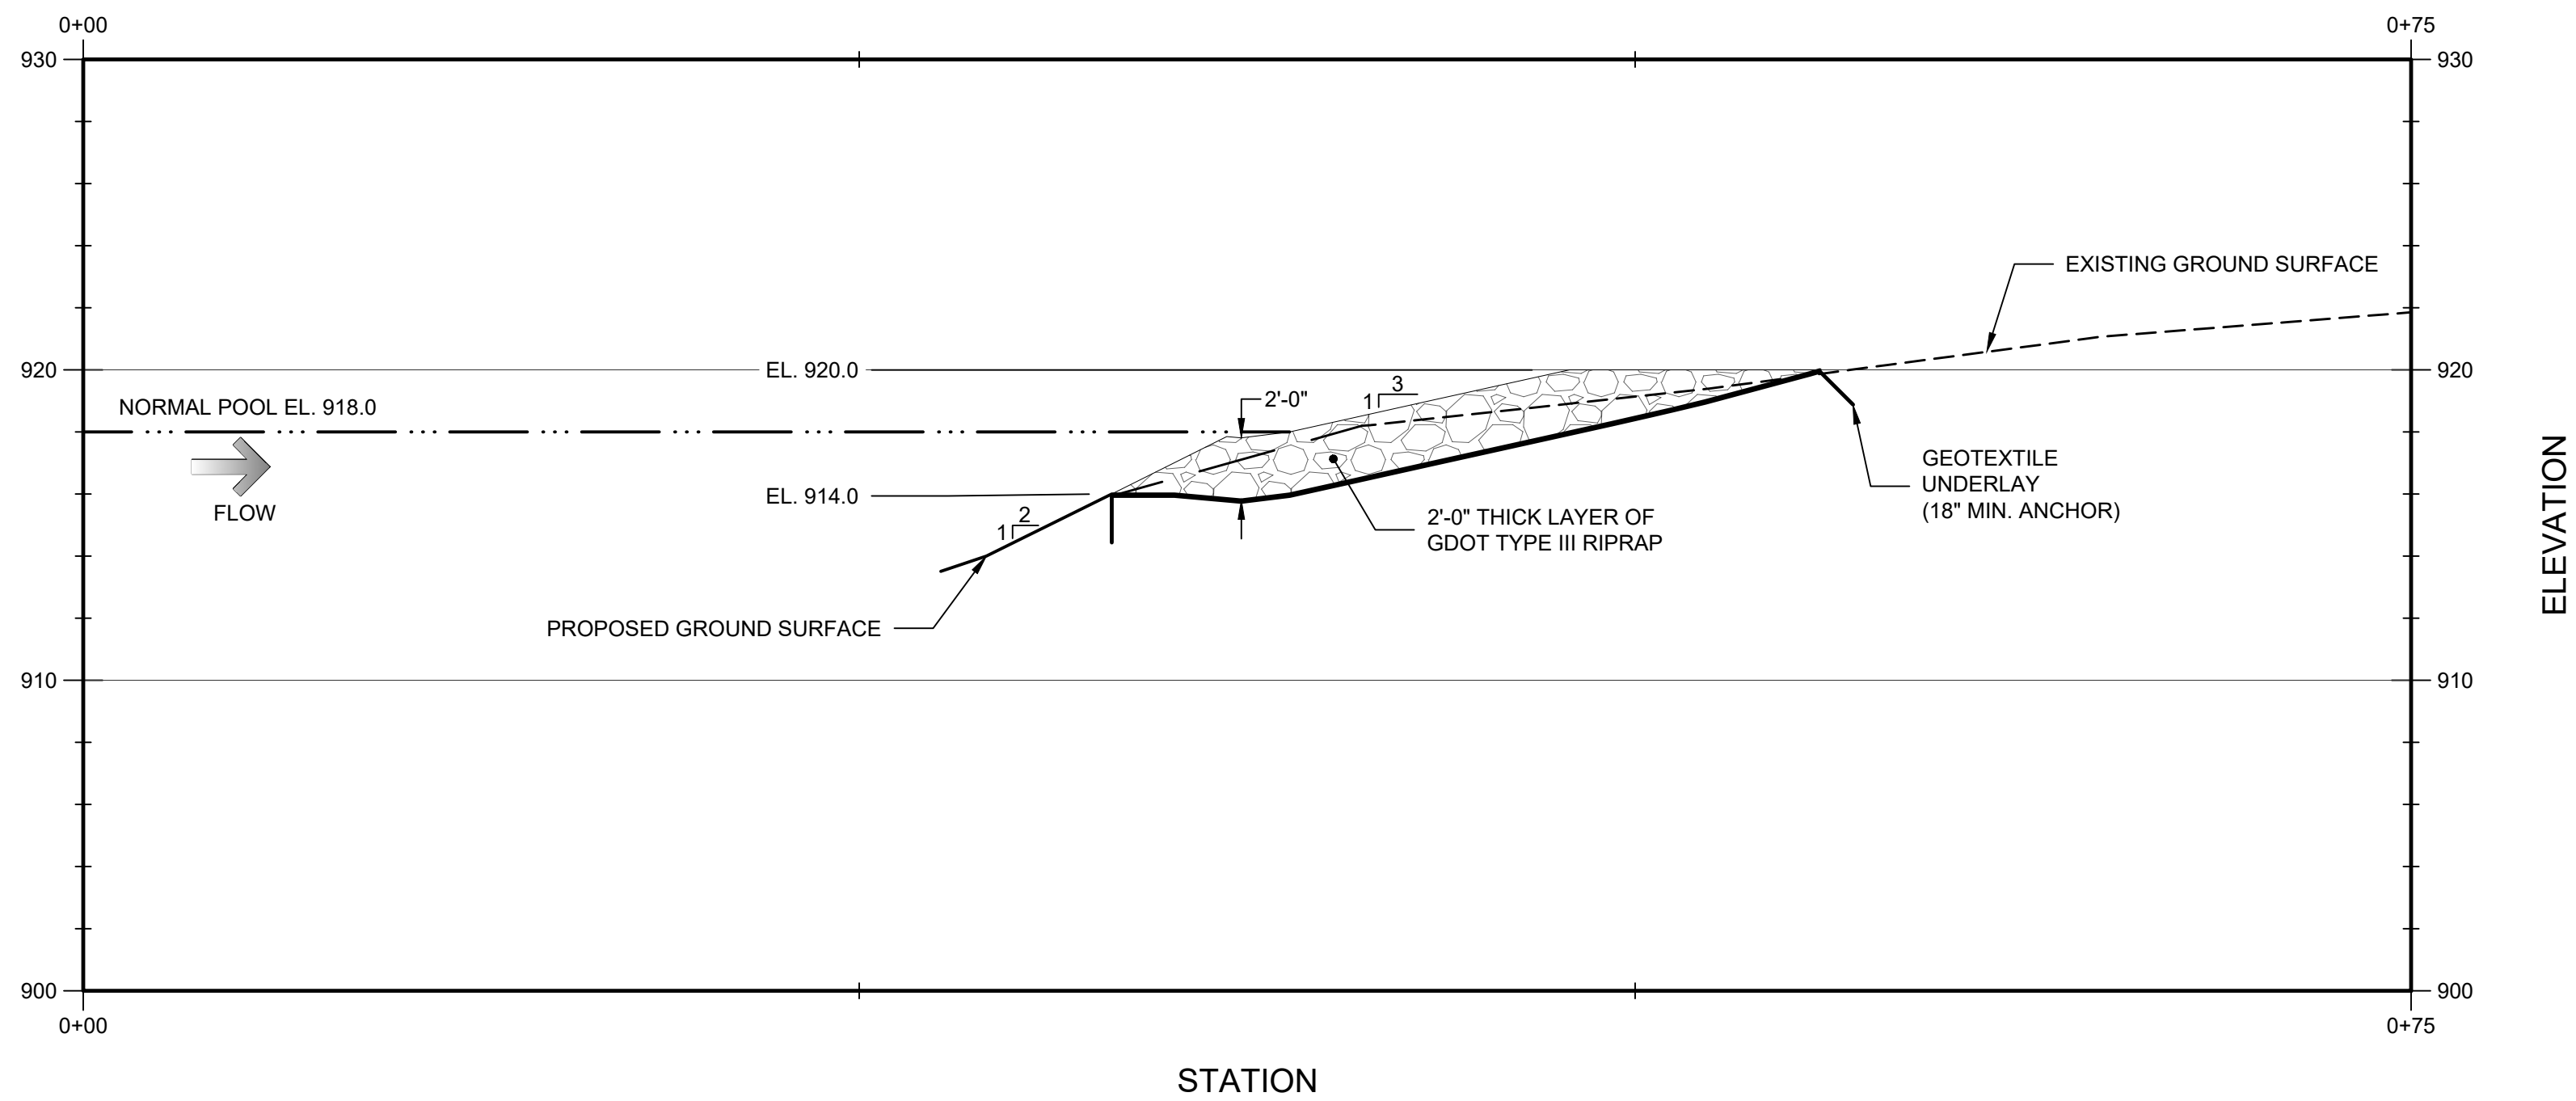
WAVE BERM ELEVATION




NOTES:

1. SEE DETAILS ON SHEET 06-07 OF 14 REGARDING RIPRAP SIZES AND THICKNESS.

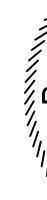 Schnabel ENGINEERING		6445 Shiloh Road, Suite A / Alpharetta, GA 30005 / Phone: 770-781-9008 / Fax: 770-781-9003 / schnabel-eng.com	
ADAMS LAKE DAM TOWN OF TYRONE FAYETTE COUNTY, GEORGIA		WAVE BERM PROFILE	
		PROJECT NOS.: SCHNABEL: 2417/0041.000 TOWN OF TYRONE: PW-2024-10	
DATE: JANUARY 2025		SHEET	
		05 OF 14	




TYPICAL WAVE BERM TRANSITION SECTION

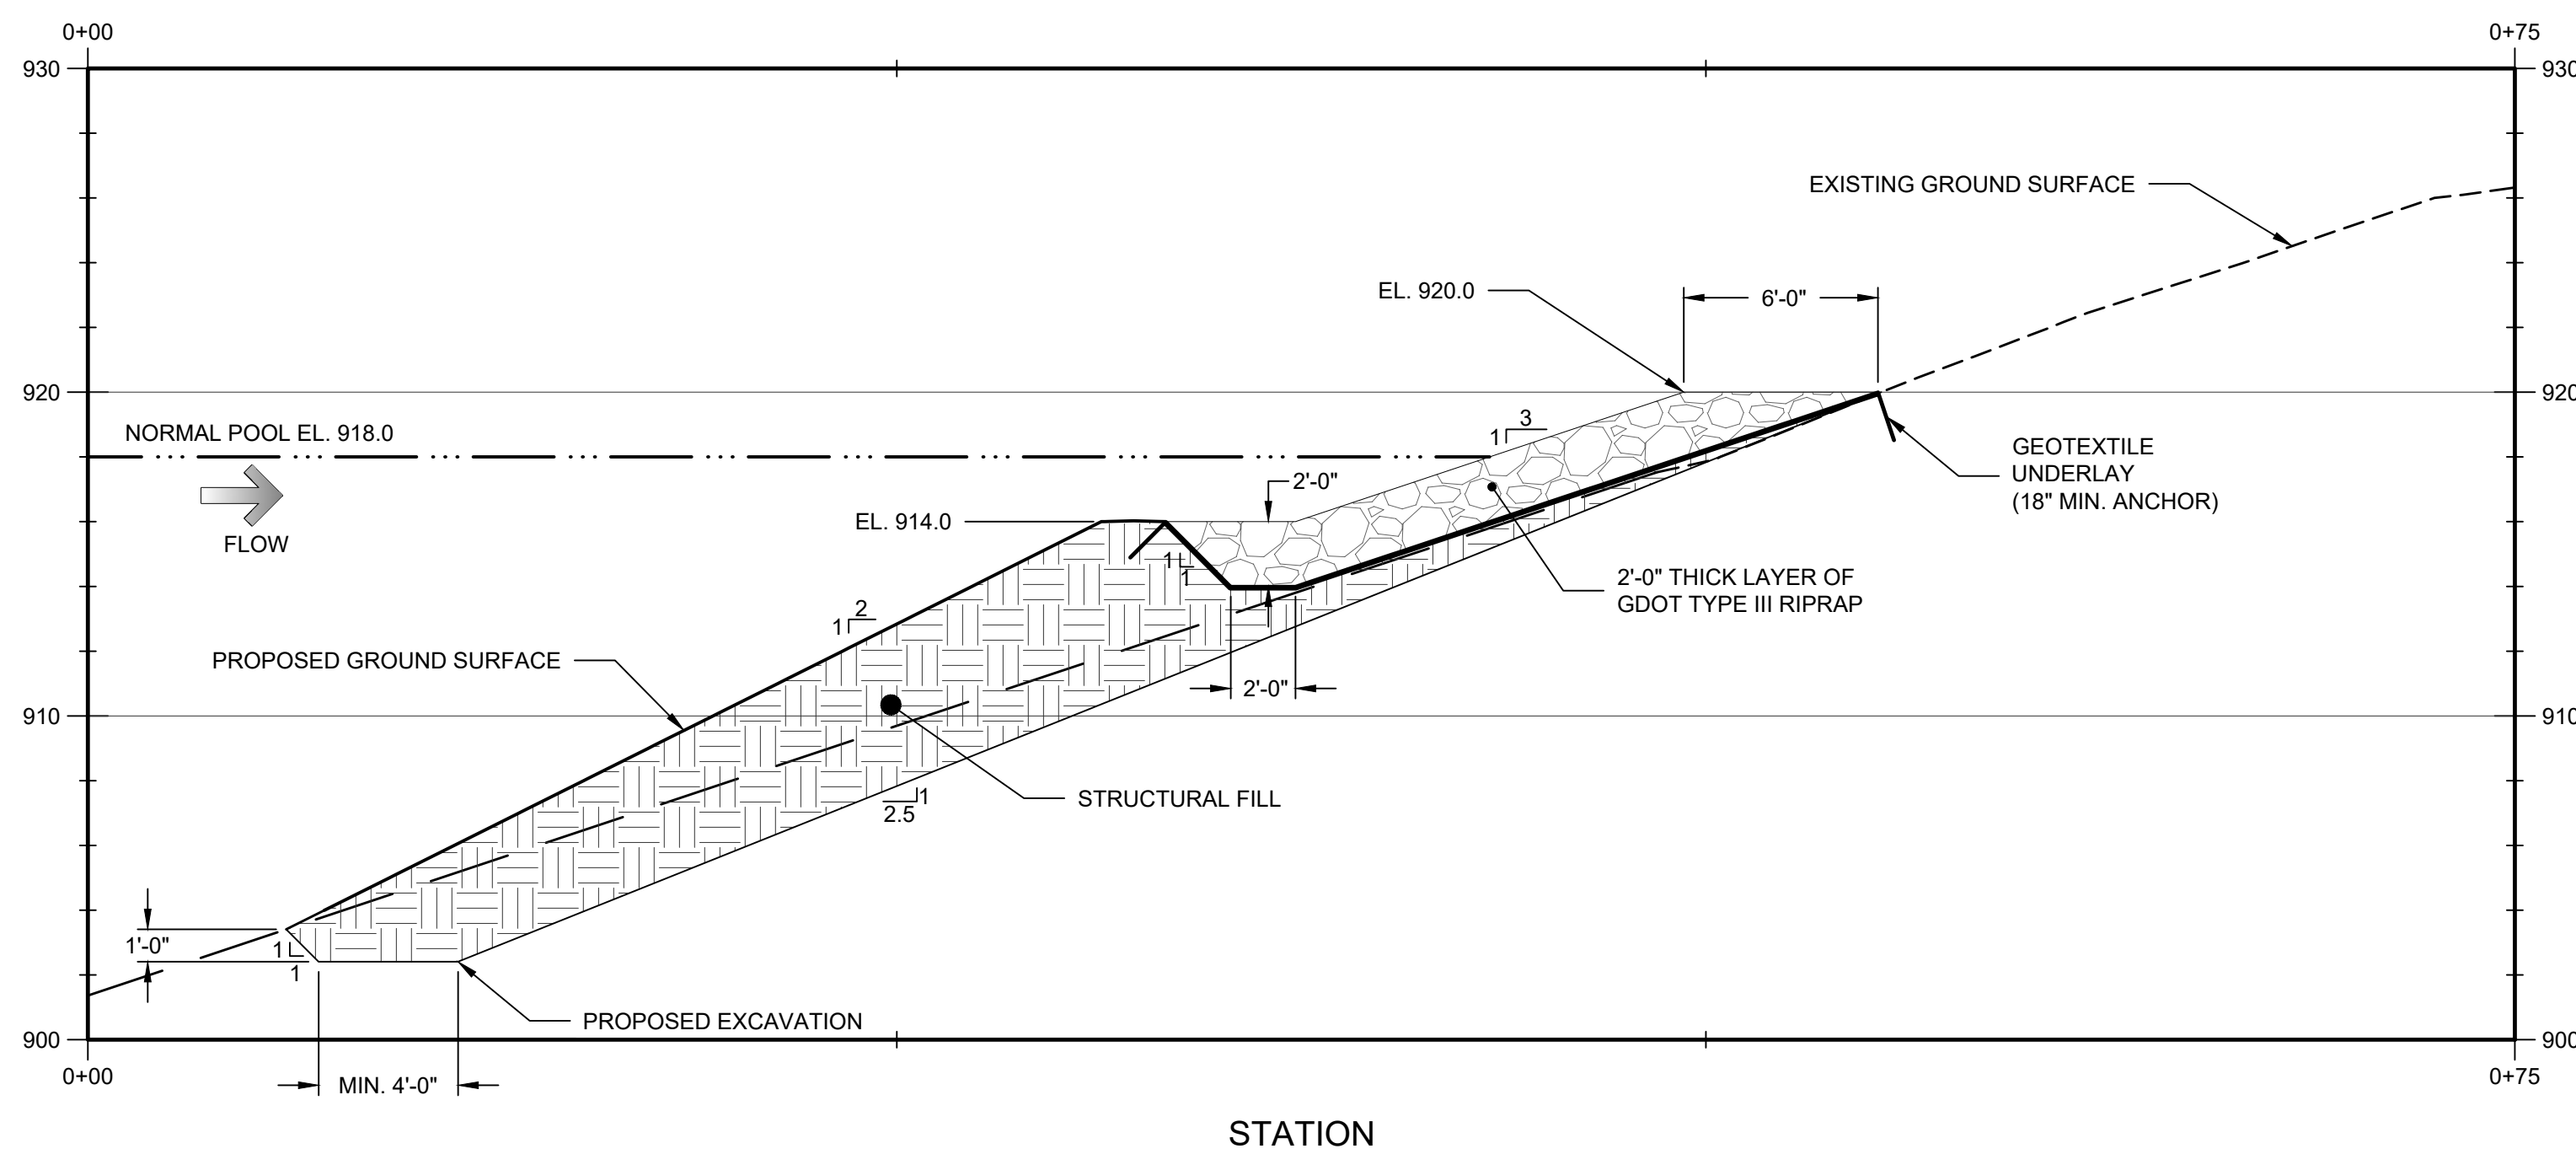


TYPICAL WAVE BERM SECTION


Scale: 1"=5'

- NOTES:
1. CONSTRUCT THE ROCK ARMORED WAVE BERM TO FULL SECTION BETWEEN STA. 0+85 AND STA. 4+60. TRANSITION TO EXISTING EMBANKMENT FROM APPROX. STA. 0+48 TO STA. 0+85 AND FROM STA. 4+60 TO APPROX. STA. 4+86.
 2. THE RIPRAP THICKNESS IN THE TRANSITION AREAS SHALL REMAIN 2'-0" THICK NORMAL TO THE SLOPE.
 3. THE EXISTING GROUND SURFACE BELOW NORMAL POOL (EL. 918.0) IS BASED ON THE 2004 RENOVATION PLANS AND SHOULD BE CONSIDERED APPROXIMATE. DISCREPANCIES SHOULD BE DISCLOSED TO THE ENGINEER'S REPRESENTATIVE PRIOR TO PLACEMENT OF EARTHFILL.
 4. PRIOR TO THE PLACEMENT AND COMPACTION OF EARTHFILL TO CONSTRUCT THE WAVE BERM, EXISTING UPSTREAM SLOPE SOIL SHALL BE EXCAVATED TO THE EXTENTS SHOWN IN THE TYPICAL WAVE BERM SECTION TO FACILITATE BERM SOIL PLACEMENT AND COMPACTION ACTIVITIES.

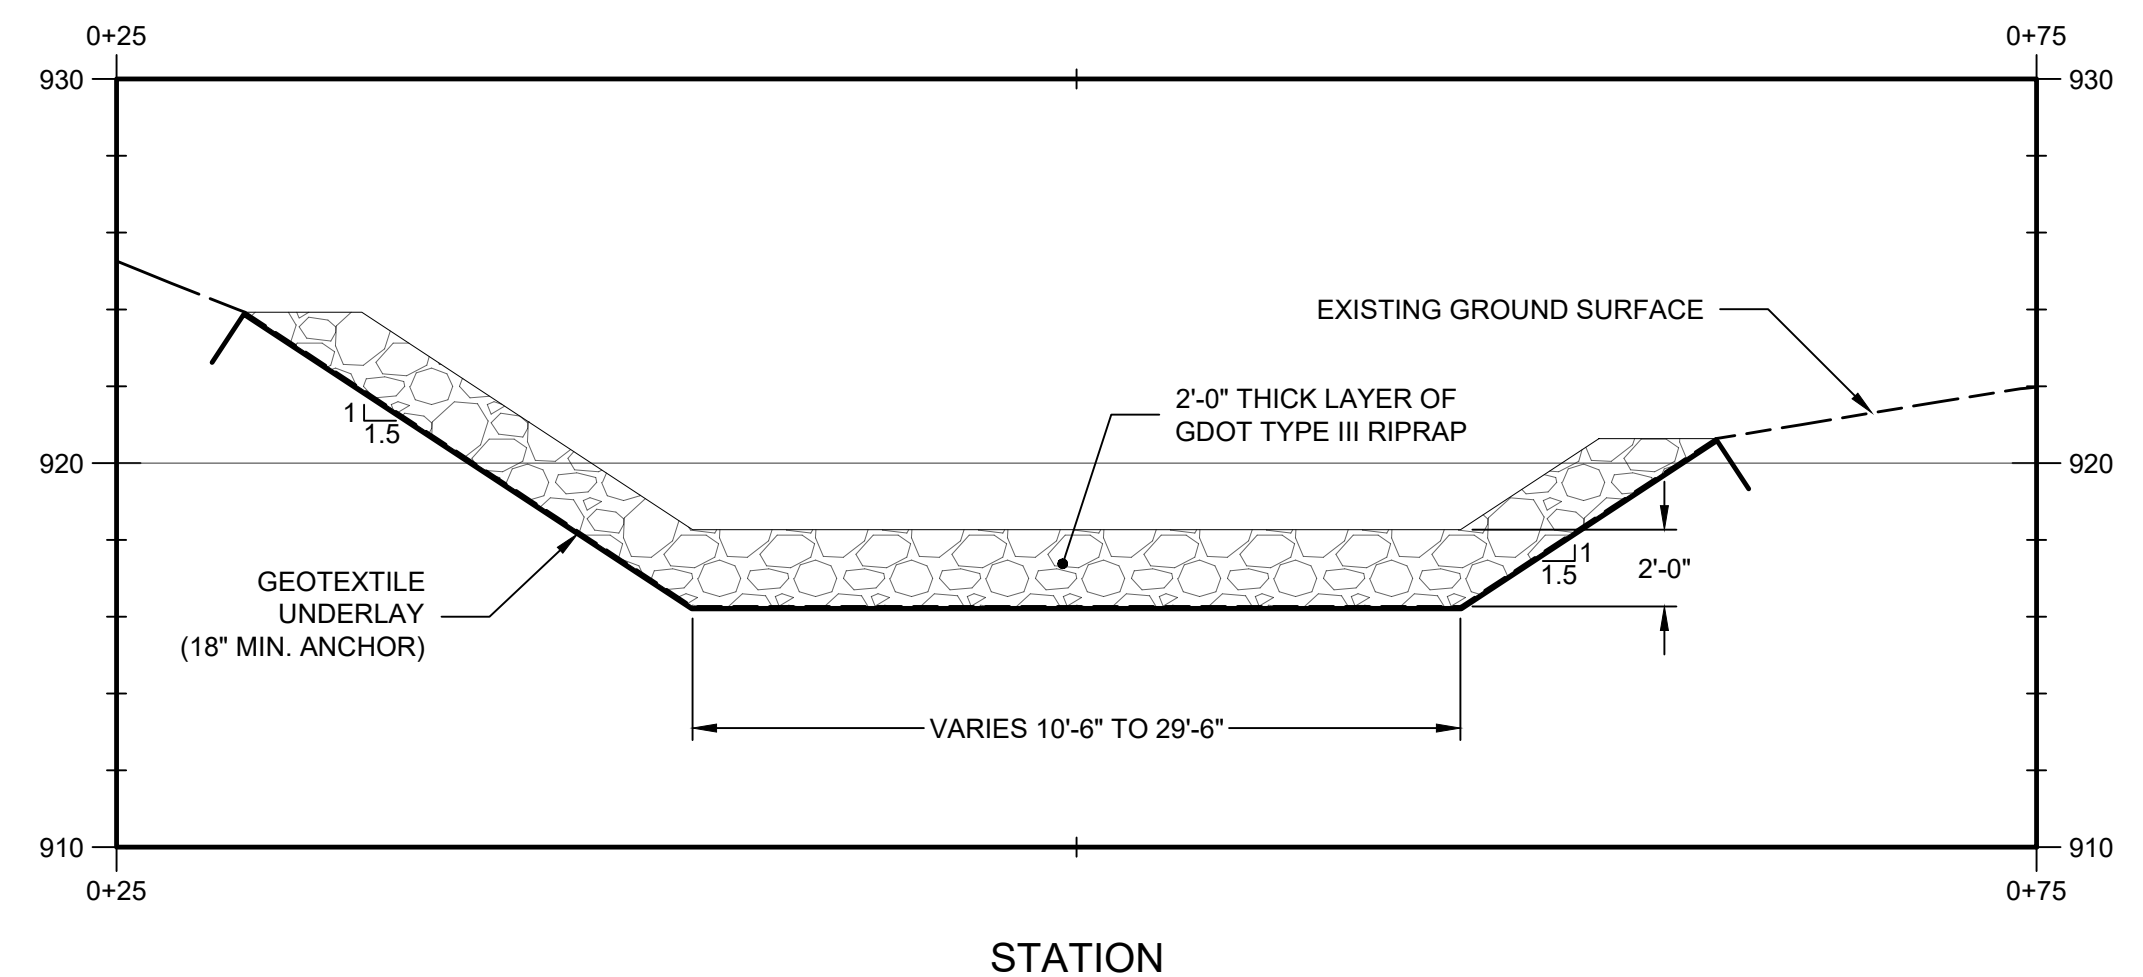

RIPRAP APRON CROSS SECTION

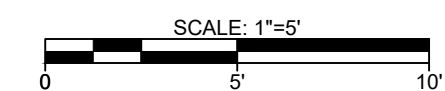


DESIGNED BY: MCG	DRAWN BY: MCG	CHECKED BY: JTC	1	ADDRESS TOWN OF TYRONE COMMENTS	3/28/25
J. TYLER COATS, P.E.					
GEORGIA PROFESSIONAL ENGINEER NO. FE035603  DATE: 03-28-2025			REV	DESCRIPTION	DATE



ADAMS LAKE DAM TOWN OF TYRONE FAYETTE COUNTY, GEORGIA	WAVE BERM DETAILS
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PROJECT NOS.: SCHNABEL: 24170041.000 TOWN OF TYRONE: PW-2024-10
DATE: JANUARY 2025
SHEET 06 OF 14



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- ## NOTES

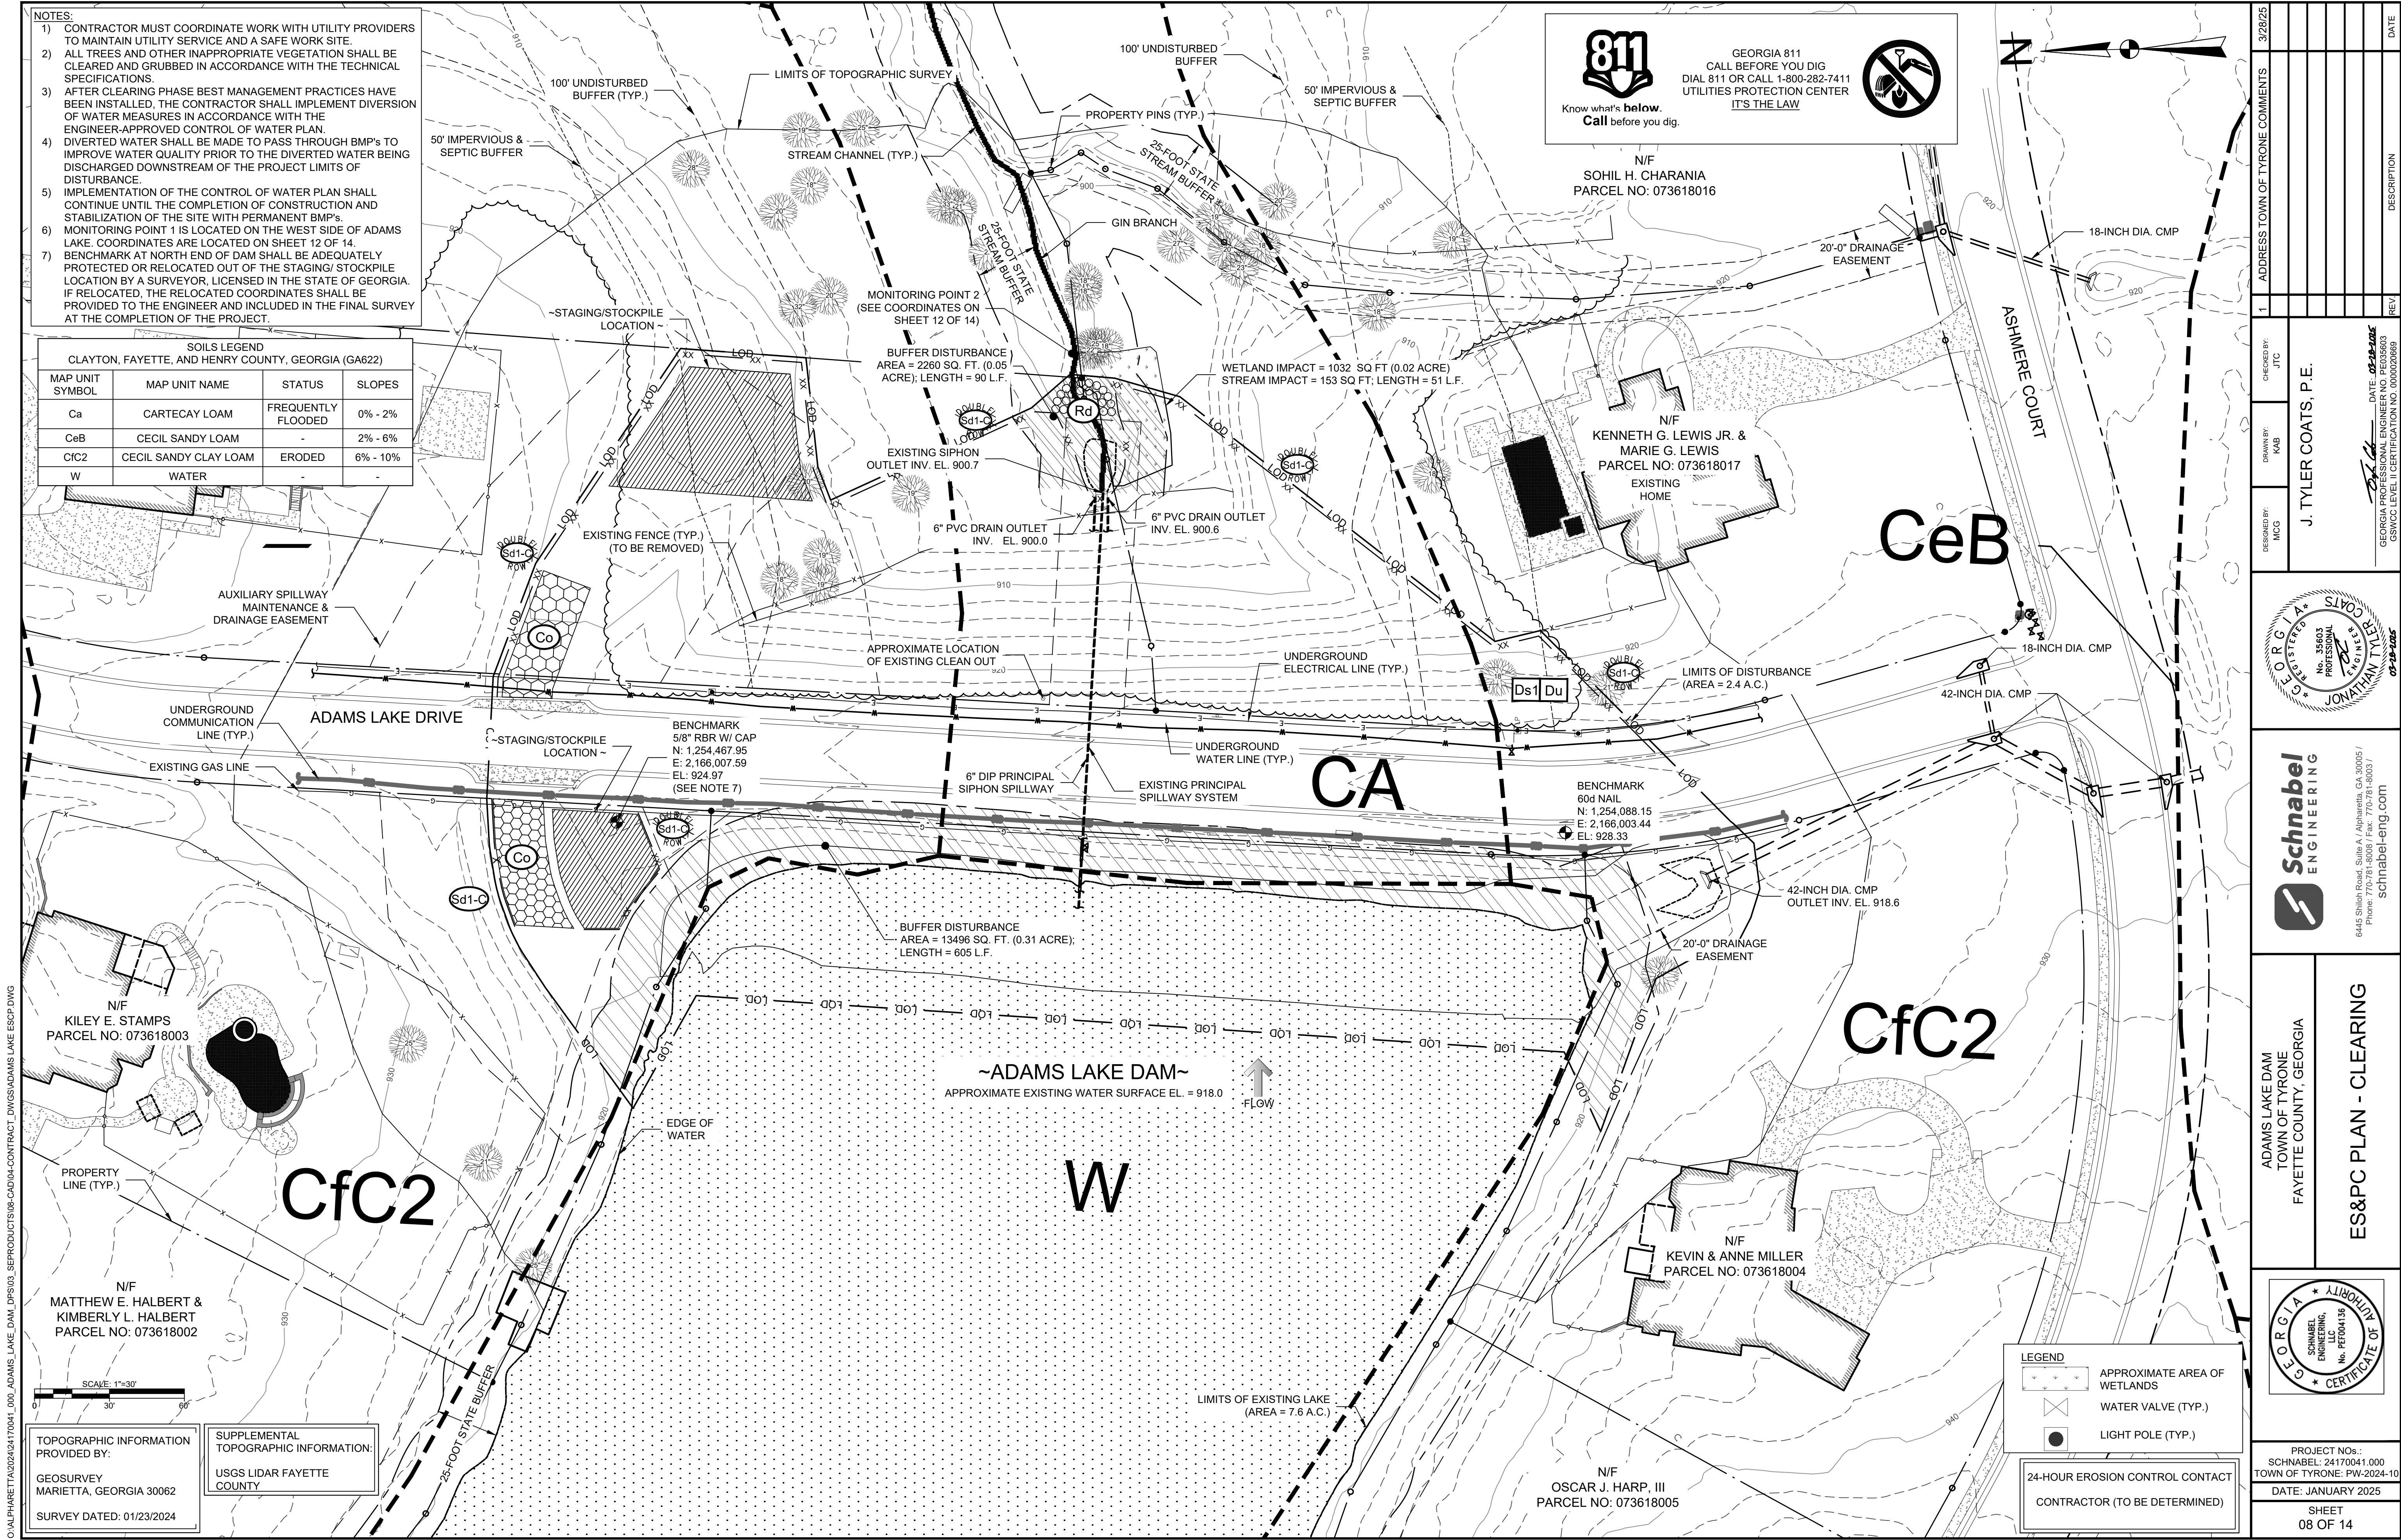- 1) CONTRACTOR MUST COORDINATE WORK WITH UTILITY PROVIDERS TO MAINTAIN UTILITY SERVICE AND A SAFE WORK SITE.
- 2) ALL DISTURBED AREAS ARE TO BE PERMANENTLY VEGETATED, SLOPES TRACKED IN AND MATTED WITHIN 7 DAYS OF ACHIEVING FINAL GRADE.
- 3) CONTRACTOR SHALL MAINTAIN CONTROL AND DIVERSION OF WATER MEASURES THROUGHOUT GRADING PHASE ACTIVITIES, AND IMPLEMENT BMPs FOR DIVERTED WATER.
- 4) MONITORING POINT 1 IS LOCATED ON THE WEST SIDE OF ADAMS LAKE. COORDINATES ARE LOCATED ON SHEET SHEET 12 OF 14.



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N/F
SOHIL H. CHARANIA
PARCEL NO: 073618016

N/F
KENNETH G. LEWIS JR. &
MARIE G. LEWIS
PARCEL NO: 073618017

N/F
KEVIN & ANNE MILLER
PARCEL NO: 073618004

N/F
OSCAR J. HARP, III
PARCEL NO: 073618005

N/F
ANTHONY R. RIGELMAN &
EMILIE S. RIGELMAN
PARCEL NO: 073618019

N/F
DIVYA PATEL & DARANG
PATEL
PARCEL NO: 073618018

N/F
KILEY E. STAMPS
PARCEL NO: 073618003

N/F
MATTHEW E. HALBERT &
KIMBERLY L. HALBERT
PARCEL NO: 073618002

TOPOGRAPHIC INFORMATION
PROVIDED BY:

GEOSURVEY
MARIETTA, GEORGIA 30062

SURVEY DATED: 01/23/2024

SUPPLEMENTAL
TOPOGRAPHIC INFORMATION:

USGS LIDAR FAYETTE
COUNTY

MONITORING POINT 2
(SEE COORDINATES ON
SHEET 12 OF 14)

BUFFER DISTURBANCE
AREA = 2260 SQ. FT. (0.05
ACRE); LENGTH = 90 L.F.

WETLAND IMPACT = 1032 SQ FT (0.02 ACRE)
STREAM IMPACT = 153 SQ FT; LENGTH = 51 L.F.

STING FENCE (TYP.

APPROXIMATE LOCATION
OF EXISTING CLEAN OUT


BENCHMARK

BENCHMARK
60d NAIL
N: 1,254,088.1
E: 2,166,003.4
EL: 928.33

AREA = 13496.0 SQ. FT. (0.31 ACRE); LENGTH = 605 L.F.

~ADAMS LAKE DAM~
APPROXIMATE EXISTING WATER SURFACE EL. = 918.0

$\rho = 918.0$


FLOW

LEGEND

APPROXIMATE AREA OF
WETLANDS

WATER VALVE (TYP.)

LIGHT POLE (TYP.)

24-HOUR EROSION CONTROL CONTACT
CONTRACTOR (TO BE DETERMINED)

3/28/2025	ADDRESS TOWN OF TYRONE COMMENTS	
REV	DESCRIPTION	DATE


DESIGNED BY: MCG	CHECKED BY: JTC
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DRAWN BY: KAB	DATE: <u>03-10-2005</u>
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J. TYLER COATS, P.E.

GEORGIA PROFESSIONAL ENGINEER NO. FE035603
 GSWCC LEVEL II CERTIFICATION NO. 0000020669

[Signature]




ADAMS LAKE DAM
TOWN OF TYRONE
FAYETTE COUNTY, GEORGIA

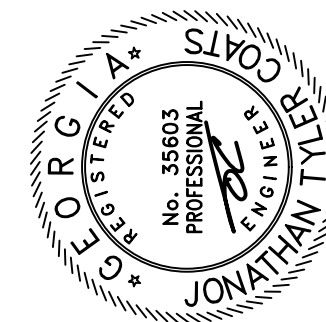ES&PC PLAN - GRADING



PROJECT NOS.: SCHNABEL: 24170041.000 TOWN OF TYRONE: PW-2024-10
DATE: JANUARY 2025
SHEET 09 OF 14

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O:\ALPHARETTA\2024\170041_000_ADAMS_LAKE_DAM_DPS\03_SEPRODUCTS\09-CAD\04-CONTRACT_DWG\ADAMS LAKE COVER SHEET AND NOTES.DWG

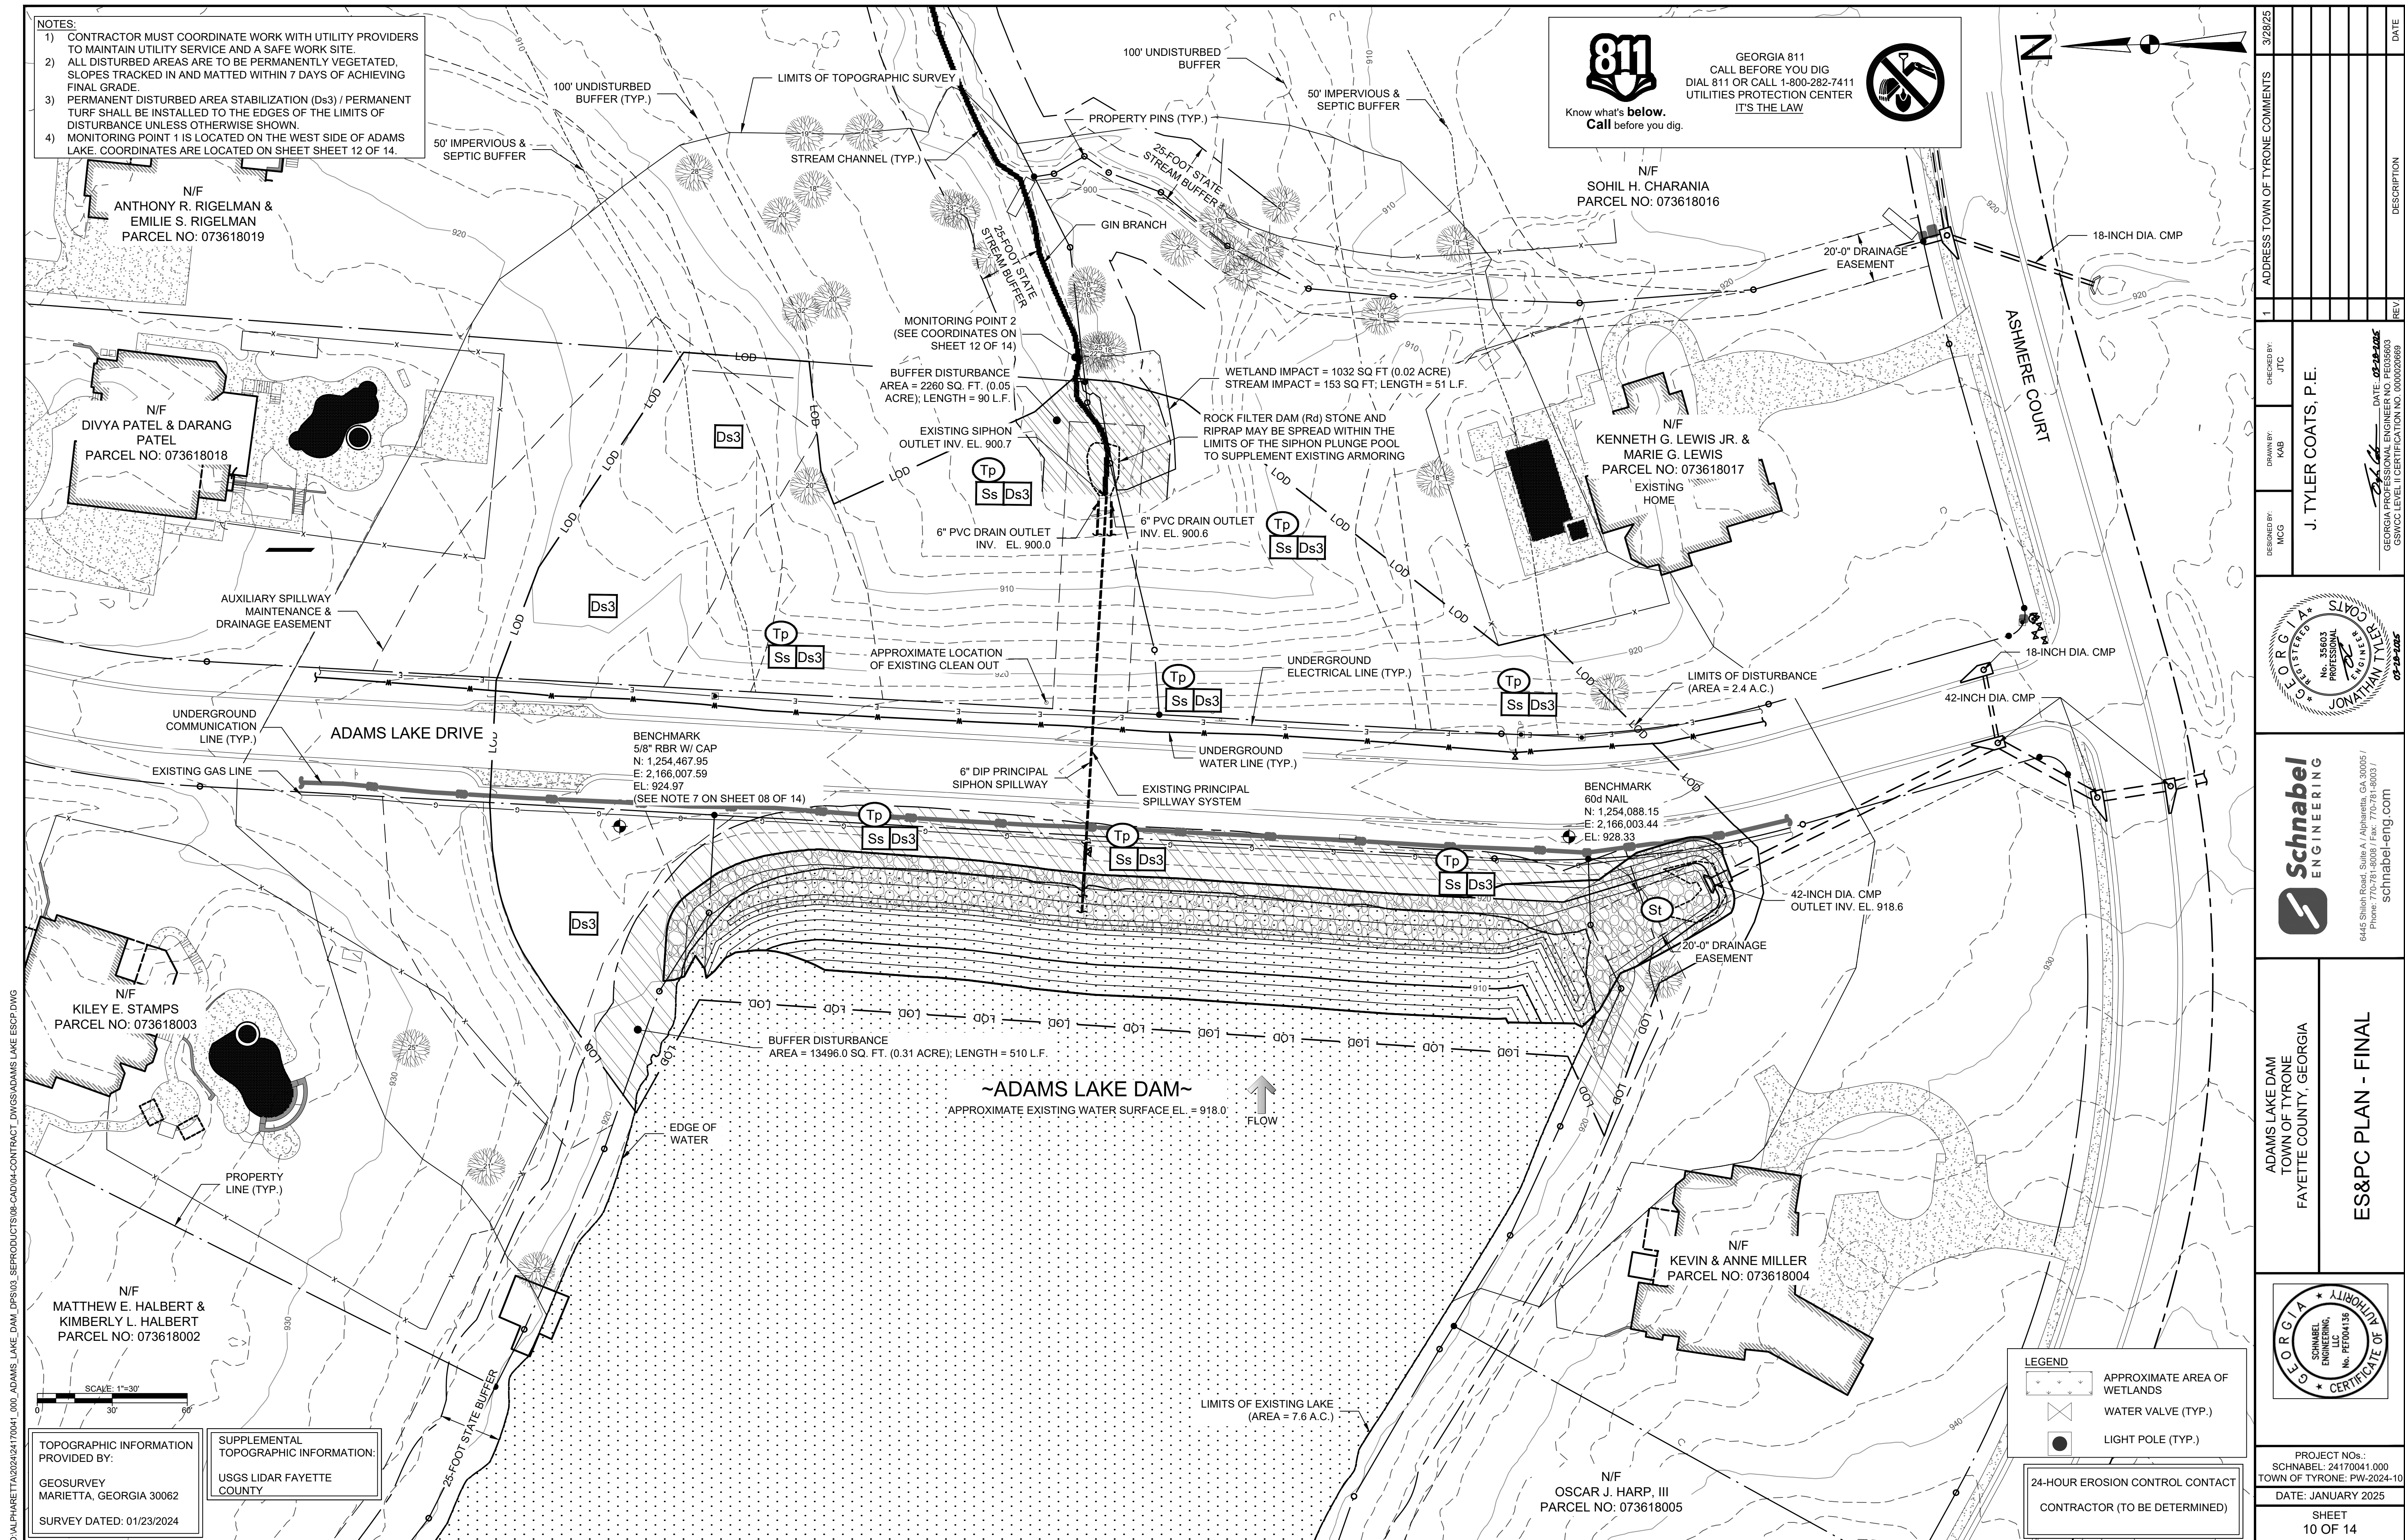SITE DESCRIPTION

PROJECT TYPE: DAM REHABILITATION

PROJECT DESCRIPTION: THE PROJECT INVOLVES IMPROVEMENTS AND MODIFICATIONS TO AN EXISTING EARTHEN EMBANKMENT DAM. THE PROPOSED MEASURES INCLUDE CLEARING AND GRUBBING OF TREES AND OTHER INAPPROPRIATE VEGETATION FROM THE EMBANKMENT SLOPES AND IN THE VICINITY OF THE SIPHON SPILLWAY PLUNGE POOL, INSTALLING AN RIPRAP ARMORED WAVE PROTECTION BERM ALONG THE UPSTREAM SLOPE, AND REGRADING AND ARMORING THE STORM DRAIN OUTLET CHANNEL IN THE RIGHT ABUTMENT WITH RIPRAP. ALL DISTURBED AREAS NOT RECEIVING RIPRAP SHALL BE STABILIZED WITH PERMANENT VEGETATION.

SEE TIMELINE BELOW FOR INTENDED SEQUENCE OF MAJOR ACTIVITIES WHICH DISTURB SOILS FOR MAJOR PORTIONS OF THE SITE.

PROJECT AREA: 2.4 AC

DISTURBED AREA: 2.4 AC

SCS CURVE NUMBER (PRE-CONSTRUCTION): 68

SCS CURVE NUMBER (POST-CONSTRUCTION): 68

STREAM BUFFERS & WETLANDS

STATE WATERS LOCATED ON OR WITHIN 200' OF THIS SITE HAVE BEEN DELINEATED. NON-EXEMPT ACTIVITIES SHALL NOT BE CONDUCTED WITHIN THE 25' OR 50' UNDISTURBED STREAM BUFFERS AS MEASURED FROM THE POINT OF WRESTED VEGETATION WITHOUT FIRST ACQUIRING THE NECESSARY VARIANCES AND PERMITS. BASED ON CORRESPONDENCE WITH THE LOCAL ISSUING AUTHORITY, TOWN OF TYRONE, A STREAM BUFFER VARIANCE IS REQUIRED.

WETLANDS ARE PRESENT WITHIN 200' FEET OF THE PROJECT SITE. CONSTRUCTION PLANS HAVE BEEN DESIGNED FOR ENCROACHMENT INTO WETLANDS.

UPSTREAM BUFFER IMPACT AREA: 13,496 SQ FT 0.31 AC

DOWNSTREAM BUFFER IMPACT AREA: 2,260 SQ FT 0.05 AC

TOTAL BUFFER IMPACT AREA: 15,756 SQ FT 0.36 AC

UPSTREAM BUFFER IMPACT LENGTH: 605 LF

DOWNSTREAM BUFFER IMPACT LENGTH: 90 LF

TOTAL BUFFER IMPACT LENGTH: 695 LF

WETLAND IMPACT AREA: 1032 SQ FT 0.02 AC

STREAM DISTURBANCE: 153 SQ FT 0.004 AC

CONSTRUCTION SCHEDULE

		2025		
		APRIL	MAY	JUNE
ITEM A				
ITEM B				
ITEM C				
ITEM D				
ITEM E				

SCOPE ITEMS

- INSTALL AND MAINTAIN EROSION AND SEDIMENT CONTROL MEASURES.
- PROVIDE WATER CONTROL DURING CONSTRUCTION ACTIVITIES.
- CLEAR, GRUB, AND STRIP PROJECT AREA.
- COMPLETE EARTHWORK FOR ABUTMENT DRAINAGE APRON AND PLACE SLOPE PROTECTION RIPRAP.
- VEGETATE ALL AREAS AS REQUIRED DURING CONSTRUCTION OF THE PROJECT AS REQUIRED BY THE SEDIMENT AND EROSION CONTROL PLAN.

GENERAL NOTES

EROSION CONTROL PROGRAM - CLEARING WILL BE KEPT TO A MINIMUM. VEGETATION AND/OR MULCH WILL BE APPLIED TO APPLICABLE AREAS IMMEDIATELY AFTER GRADING IS COMPLETED. SILT FENCES AND RIP-RAP WILL BE EMPLOYED TO PREVENT EROSION IN AREAS OF CONCENTRATED WATER FLOWS.

SEDIMENT CONTROL PLAN - ALL DISTURBED AREAS ARE TO BE VEGETATED. SEDIMENT CONTROL WILL BE ACCOMPLISHED BY THE VEGETATING OF ALL DISTURBED AREAS AND THE INSTALLATION OF SILT FENCES.

STANDARDS & SPECIFICATIONS - ALL DESIGNS AND ALL WORK WILL BE DONE IN ACCORDANCE WITH THE STANDARDS AND SPECIFICATIONS OF THE PUBLICATION ENTITLED "MANUAL FOR EROSION & SEDIMENT CONTROL IN GEORGIA".

MAINTENANCE PROGRAM - ALL EROSION AND SEDIMENT CONTROL MEASURES WILL BE CHECKED DAILY AND ANY DEFICIENCIES NOTED WILL BE CORRECTED BY THE END OF EACH DAY. ADDITIONAL EROSION AND SEDIMENT CONTROL MEASURES WILL BE INSTALLED IF DEEMED NECESSARY BY ON-SITE INSPECTION. CLEANOUT OF SEDIMENT BARRIERS WILL BE DONE IN ACCORDANCE WITH THE SPECIFICATIONS AND DISPOSED OF BY SPREADING ON SITE. SEDIMENT BARRIERS WILL REMAIN UNTIL DISTURBED AREAS ARE STABILIZED. SEDIMENT FENCES AND BARRIERS WILL THEN BE REMOVED AND SURROUNDING AREAS VEGETATED. GUIDELINES FOR THE MAINTENANCE OF THE ESTABLISHED VEGETATED AREAS ARE TO BE PROVIDED TO THE OWNER WHEN DISTURBED AREAS ARE STABILIZED.

LIMITS OF DISTURBANCE SHALL BE NO GREATER THAN 50 ACRES AT ANY ONE TIME WITHOUT PRIOR WRITTEN AUTHORIZATION FROM THE EPD DISTRICT OFFICE.

THE SURFACE AREA OF ERODIBLE MATERIAL, AT ONE TIME, SHALL NOT EXCEED 17 ACRES.

BUFFER REVEGETATION PLAN

DISTURBED AREAS WITHIN THE 25-FOOT STATE STREAM BUFFER SHALL BE STABILIZED WITH NATIVE, NON-INVASIVE SPECIES AFTER THE COMPLETION OF ACTIVITIES WITHIN THE BUFFER ZONE. THE FOLLOWING PERMANENT, NATIVE, RIPARIAN PLANT SPECIES SHALL BE UTILIZED TO RE-VEGETATED THE BUFFER ZONE:

SPECIES	REGION	STREAM ZONE	WILDLIFE VALUE	NOTES
ALNUS SERRULATA (SMOOTH ALDER)	M.P.C	SHRUB	MODERATE, COVER	RAPID GROWTH, STABILIZES STREAMBANK, SUN
CEPHALANTUS OCCIDENTALIS (BUTTONBUSH)	M.P.C	SHRUB	MODERATE, COVER	RAPID GROWTH, STABILIZES STREAMBANK, SUN
ILEX VERTICILLATA (WINTERBERRY)	M.P.	SHRUB	MODERATE, COVER	RAPID GROWTH, STABILIZES STREAMBANK, SUN
SALIX NIGRA (BLACK WILLOW)	M.P.C	SHRUB & TREE	NESTING	RAPID GROWTH, FULL SUN

A MINIMUM OF TWO (2) VARIETIES OF THE SPECIES INDICATED IN THE TABLE ABOVE SHALL BE UTILIZED FOR BUFFER REVEGETATION PURPOSES, AS USE WILL BE HIGHLY DEPENDENT UPON AVAILABILITY AND SUPPLY FROM LOCAL DISTRIBUTORS. THE ABOVE LIST MAY BE SUPPLEMENTED OR AMENDED WITH OTHER NATIVE PLANTS INCLUDED IN TABLE 6-1.2 OF THE MANUAL FOR EROSION AND SEDIMENT CONTROL IN GEORGIA, 2016 EDITION (GREEN BOOK).

SOIL PREPARATION AND MAINTENANCE ARE ESSENTIAL FOR THE ESTABLISHMENT OF PLANTED VEGETATION. SOIL FERTILITY, WEED CONTROL, AND HERBACEOUS COVER IMPROVEMENTS MAY BE NECESSARY TO FACILITATED ESTABLISHMENT OF PLANTED VEGETATION. REVEGETATION PLANTINGS SHOULD BE INSTALLED EARLY IN THE GROWING SEASON TO PROMOTE ESTABLISHMENT AND FUTURE HARDINESS. PLANTS TO BE USED SHALL BE SUPPLIED EITHER AS CONTAINER-GROWN PLANTS, OR BALLED AND BURLAPPED PLANTS. PLANTINGS SHOULD BE SPACED GENERALLY EVERY THREE (3) TO FIVE (5) HORIZONTAL FEET. PLANTINGS SHOULD BE A MINIMUM OF THREE (3) FEET FROM THE POINT OF WRESTED VEGETATION.

GIVEN THAT THE PROPOSED PLANTINGS WILL OCCUR ADJACENT TO AN ESTABLISHED LAKE, WHERE PRIOR DISTURBANCES HAVE OCCURRED DUE TO ROADWAY CONSTRUCTION, DREDGING ACTIVITIES, AND LANDSCAPING, THE PROPOSED DENSITY OF BUFFER REVEGETATION PLANTINGS SHOULD ACHIEVE GOALS OF SEDIMENT FILTERING AND PROVISION OF DETRITAL NUTRIENTS FOR AQUATIC ORGANISMS. ADDITIONAL CONSIDERATIONS AND POINTS OF EMPHASIS MAY BE REFERENCED IN THE GREEN BOOK SECTION ASSOCIATED WITH BUFFER ZONES.



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CALL BEFORE YOU DIG
DIAL 811 OR CALL 1-800-282-7411
UTILITIES PROTECTION CENTER
IT'S THE LAW



NOTE: CONTRACTOR MUST COORDINATE WORK WITH UTILITY PROVIDERS TO MAINTAIN UTILITY SERVICE AND A SAFE WORK SITE.

CERTIFICATIONS

- I CERTIFY THAT THE PERMITTEE'S EROSION, SEDIMENTATION AND POLLUTION CONTROL PLAN PROVIDES FOR AN APPROPRIATE AND COMPREHENSIVE SYSTEM OF BEST MANAGEMENT PRACTICES REQUIRED BY THE GEORGIA WATER QUALITY CONTROL ACT AND THE DOCUMENT "MANUAL FOR EROSION AND SEDIMENT CONTROL IN GEORGIA" (MANUAL) PUBLISHED BY THE GEORGIA SOIL AND WATER CONSERVATION COMMISSION AS OF JANUARY 1 OF THE YEAR IN WHICH THE LAND-DISTURBING ACTIVITY WAS PERMITTED, PROVIDES FOR THE SAMPLING OF THE RECEIVING WATER(S) OR THE SAMPLING OF THE STORM WATER OUTFALLS AND THAT THE DESIGNED SYSTEM OF BEST MANAGEMENT PRACTICES AND SAMPLING METHODS IS EXPECTED TO MEET THE REQUIREMENTS CONTAINED IN THE GENERAL NPDES PERMIT NO. GAR100001.
- I CERTIFY UNDER PENALTY OF LAW THAT THIS PLAN WAS PREPARED AFTER A SITE VISIT TO THE LOCATIONS DESCRIBED HEREIN BY MYSELF OR MY AUTHORIZED AGENT, UNDER MY DIRECT SUPERVISION.
- I CERTIFY UNDER PENALTY OF LAW THAT THIS DOCUMENT AND ALL ATTACHMENTS WERE PREPARED UNDER MY DIRECTION OR SUPERVISION IN ACCORDANCE WITH A SYSTEM DESIGNED TO ASSURE THAT QUALIFIED PERSONNEL PROPERLY GATHER AND EVALUATE THE INFORMATION SUBMITTED. BASED ON MY INQUIRY OF THE PERSON OR PERSONS WHO MANAGE THE SYSTEM, OR THOSE PERSONS DIRECTLY RESPONSIBLE FOR GATHERING THE INFORMATION, THE INFORMATION SUBMITTED IS, TO THE BEST OF MY KNOWLEDGE AND BELIEF, TRUE, ACCURATE AND COMPLETE. I AM AWARE THAT THERE ARE SIGNIFICANT PENALTIES FOR SUBMITTING FALSE INFORMATION, INCLUDING THE POSSIBILITY OF FINE AND IMPRISONMENT FOR KNOWING VIOLATIONS.

SIGNATURE

03-18-2025
DATE

J. TYLER COATS, P.E.
GEORGIA PROFESSIONAL ENGINEERING LICENSE NO. 35603
GSWCC LEVEL II CERTIFICATION NO. 0000020669

"I CERTIFY THAT AN INSPECTION OF THE INSTALLATION OF BEST MANAGEMENT PRACTICES, AS SHOWN ON THE PLANS, WILL BE MADE WITHIN 7 DAYS AFTER INITIAL CONSTRUCTION ACTIVITIES BEGIN."

ENGINEER

03-18-2025
DATE

WASTE MATERIALS SHALL NOT BE DISCHARGED INTO WATERS OF THE STATE, EXCEPT AS AUTHORIZED BY A SECTION 404 PERMIT

IT IS EXPECTED THAT THE FOLLOWING NON-STORM WATER DISCHARGES WILL OCCUR FROM THE SITE DURING THE CONSTRUCTION PERIOD:

PAVEMENT WASH WATERS (WHERE NO SPILLS OR LEAKS OF TOXIC OR HAZARDOUS MATERIALS HAVE OCCURRED).

UNCONTAMINATED GROUNDWATER (FROM DEWATERING EXCAVATION IF ANY).

INVENTORY FOR POLLUTION PREVENTION PLAN:

THE MATERIALS OR SUBSTANCES LISTED BELOW ARE EXPECTED TO BE PRESENT ON SITE DURING CONSTRUCTION:

CEMENT	PETROLEUM BASED PRODUCTS
DETERGENTS	WOOD
PAINTS	MASONRY BLOCKS
CONCRETE	CLEANING SOLVENTS
TAR	
FERTILIZER	

SPILL PREVENTION:

THE FOLLOWING ARE THE MATERIAL MANAGEMENT PRACTICES THAT WILL BE USED TO REDUCE THE RISK OF SPILLS OR OTHER ACCIDENTAL EXPOSURE OF MATERIALS AND SUBSTANCES TO STORM WATER RUNOFF.

GOOD HOUSEKEEPING:

THE FOLLOWING GOOD HOUSEKEEPING PRACTICES WILL BE FOLLOWED ONSITE DURING THE CONSTRUCTION PROJECT.

AN EFFORT WILL BE MADE TO STORE ONLY ENOUGH PRODUCT REQUIRED TO DO THE JOB.

ALL MATERIALS STORED ONSITE WILL BE STORED IN A NEAT, ORDERLY MANNER IN THEIR APPROPRIATE CONTAINERS AND, IF POSSIBLE, UNDER ROOF OR OTHER ENCLOSURE.

PRODUCTS WILL BE KEPT IN THEIR ORIGINAL CONTAINERS WITH THE ORIGINAL MANUFACTURER'S LABEL. SUBSTANCES WILL NOT BE MIXED WITH ONE ANOTHER UNLESS RECOMMENDED BY THE MANUFACTURER. WHENEVER POSSIBLE, ALL OF A PRODUCT WILL BE USED UP BEFORE DISPOSING OF THE CONTAINER. MANUFACTURER'S RECOMMENDATIONS FOR PROPER USE AND DISPOSAL WILL BE FOLLOWED. THE SITE SUPERINTENDENT WILL INSPECT DAILY TO INSURE PROPER USE AND DISPOSAL OF MATERIALS ONSITE.

HAZARDOUS PRODUCTS:

THESE PRACTICES ARE USED TO REDUCE THE RISKS ASSOCIATED WITH HAZARDOUS MATERIALS: PRODUCTS WILL BE KEPT IN ORIGINAL CONTAINERS UNLESS THEY ARE NOT RESEALABLE. ORIGINAL LABELS AND MATERIAL SAFETY DATA WILL BE RETAINED. THEY CONTAIN IMPORTANT PRODUCT INFORMATION. IF SURPLUS PRODUCT MUST BE DISPOSED OF, MANUFACTURER'S OR LOCAL AND STATE RECOMMENDED METHODS FOR PROPER DISPOSAL WILL BE FOLLOWED.

THE FOLLOWING PRODUCT SPECIFIC PRACTICES WILL BE FOLLOWED ONSITE:

PETROLEUM PRODUCTS: ALL ONSITE VEHICLES WILL BE MONITORED FOR LEAKS AND RECEIVE REGULAR PREVENTIVE MAINTENANCE TO REDUCE THE CHANCE OF LEAKAGE. PETROLEUM PRODUCTS WILL BE STORED IN TIGHTLY SEALED CONTAINERS WHICH ARE CLEARLY LABELED. ANY ASPHALT SUBSTANCES USED ONSITE WILL BE APPLIED ACCORDING TO THE MANUFACTURER'S RECOMMENDATIONS.

FERTILIZERS: FERTILIZERS USED WILL BE APPLIED ONLY IN THE MINIMUM AMOUNTS RECOMMENDED BY THE MANUFACTURER. ONCE APPLIED, FERTILIZER WILL BE WORKED INTO THE SOIL TO LIMIT EXPOSURE TO STORM WATER. STORAGE WILL BE IN A COVERED SHED. THE CONTENT OF ANY PARTIALLY USED BAGS OF FERTILIZER WILL BE TRANSFERRED TO A SEALABLE PLASTIC BIN TO AVOID SPILLS.

PAINTS: ALL CONTAINERS WILL BE TIGHTLY SEALED AND STORED WHEN NOT REQUIRED FOR USE. EXCESS PAINT WILL NOT BE DISCHARGED INTO THE STORM SEWER SYSTEM BUT WILL BE PROPERLY DISPOSED OF ACCORDING TO MANUFACTURER'S INSTRUCTIONS OR STATE AND LOCAL REGULATIONS.

CONCRETE TRUCKS: CONCRETE TRUCKS WILL NOT BE ALLOWED TO WASH OUT OR DISCHARGE SURPLUS CONCRETE OR DRUM WASH WATER OUTSIDE OF DESIGNATED AREA AS SHOWN ON THE PLANS.

IN ADDITION TO THE GOOD HOUSEKEEPING AND MATERIAL MANAGEMENT PRACTICES DISCUSSED IN THE PREVIOUS SECTIONS OF THIS PLAN, THE FOLLOWING PRACTICES WILL BE FOLLOWED FOR SPILL PREVENTION AND CLEANUP:

MANUFACTURER'S RECOMMENDED METHODS FOR SPILL CLEANUP WILL BE CLEARLY POSTED AND SITE PERSONNEL WILL BE MADE AWARE OF THE PROCEDURES AND THE LOCATION OF THE INFORMATION AND CLEANUP SUPPLIES.

MATERIALS AND EQUIPMENT NECESSARY FOR SPILL CLEANUP WILL BE KEPT IN THE MATERIAL STORAGE AREA ONSITE. EQUIPMENT AND MATERIALS WILL INCLUDE BUT NOT BE LIMITED TO BROOMS, DUST PANS, MOPS, RAGS, GLOVES, GOGGLES, KITTY LITTER, SAND, SAWDUST, AND PLASTIC AND METAL TRASH CONTAINERS SPECIFICALLY FOR THIS PURPOSE.

ALL SPILLS WILL BE CLEANED UP IMMEDIATELY AFTER DISCOVERY.

THE SPILL AREA WILL BE KEPT WELL VENTILATED, AND PERSONNEL WILL WEAR APPROPRIATE PROTECTIVE CLOTHING TO PREVENT INJURY FROM CONTACT WITH HAZARDOUS SUBSTANCES.

SPILLS OF TOXIC OR HAZARDOUS MATERIAL WILL BE REPORTED TO THE APPROPRIATE STATE OR LOCAL GOVERNMENT AGENCY, REGARDLESS OF THE SIZE.

THE SPILL PREVENTION PLAN WILL BE ADJUSTED TO INCLUDE MEASURES TO PREVENT THIS TYPE OF SPILL FROM REOCCURRING AND HOW TO CLEANUP THE SPILL IF THERE IS ANOTHER ONE. A DESCRIPTION OF THE SPILL, WHAT CAUSED IT, AND THE CLEANUP MEASURES WILL ALSO BE INCLUDED.

THE SITE SUPERINTENDENT RESPONSIBLE FOR THE DAY-TO-DAY SITE OPERATIONS WILL BE THE SPILL PREVENTION AND CLEANUP COORDINATOR. HE WILL DESIGNATE AT LEAST THREE OTHER SITE PERSONNEL WHO WILL RECEIVE SPILL PREVENTION AND CLEANUP TRAINING. THESE INDIVIDUALS WILL EACH BECOME RESPONSIBLE FOR A PARTICULAR PHASE OF PREVENTION AND CLEANUP. THE NAMES OF RESPONSIBLE SPILL PERSONNEL WILL BE POSTED IN THE MATERIAL STORAGE AREA AND IN THE OFFICE TRAILER ONSITE.

WASTE MATERIALS:

ALL WASTE MATERIALS WILL BE COLLECTED AND STORED IN A SECURELY LIDDED METAL DUMPSTER. THE DUMPSTER WILL MEET SOLID WASTE MANAGEMENT REGULATIONS. ALL TRASH AND CONSTRUCTION DEBRIS FROM THE SITE WILL BE DEPOSITED IN THE DUMPSTER. THE DUMPSTER WILL BE EMPTIED A MINIMUM OF ONCE PER WEEK OR MORE OFTEN IF NECESSARY, AND TRASH BE HAULED AS REQUIRED BY LOCAL REGULATIONS. NO CONSTRUCTION WASTE WILL BE BURIED ON-SITE.

ALL PERSONNEL WILL BE INSTRUCTED ON PROPER PROCEDURES FOR WASTE DISPOSAL. A NOTICE STATING THESE PRACTICES WILL BE POSTED ON THE JOBSITE, AND THE CONTRACTOR WILL BE RESPONSIBLE FOR SEEING THAT THESE PROCEDURES ARE FOLLOWED.

HAZARDOUS WASTES:

ALL HAZARDOUS WASTE MATERIALS WILL BE DISPOSED OF IN THE MANNER SPECIFIED BY LOCAL, STATE AND/OR FEDERAL REGULATIONS AND BY THE MANUFACTURER OF SUCH PRODUCTS. THE JOBSITE SUPERINTENDENT, WHO WILL ALSO BE RESPONSIBLE FOR SEEING THAT THESE PRACTICES ARE FOLLOWED, WILL INSTRUCT SITE PERSONNEL IN THESE PRACTICES. MATERIAL DATA SAFETY SHEETS (MSDS'S) FOR EACH SUBSTANCE WITH HAZARDOUS PROPERTIES THAT IS USED ON THE JOBSITE WILL BE OBTAINED AND USED FOR PROPER MANAGEMENT OF POTENTIAL WASTES THAT MAY RESULT FROM THESE PRODUCTS. AN MSDS WILL BE POSTED IN THE IMMEDIATE AREA WHERE SUCH PRODUCT IS STORED AND/OR USED, AND ANOTHER COPY OF EACH MSDS WILL BE MAINTAINED IN THE ESPCP FILE AT THE JOBSITE. CONSTRUCTION TRAILER OFFICE. EACH EMPLOYEE WHO MUST HANDLE A SUBSTANCE WITH HAZARDOUS PROPERTIES WILL BE INSTRUCTED ON THE USE OF MSDS SHEETS AND THE SPECIFIC INFORMATION IN THE APPLICABLE MSDS FOR THE PRODUCT HE/SHE IS USING, PARTICULARLY REGARDING SPILL CONTROL TECHNIQUES.

SANITARY WASTES:

A MINIMUM OF ONE PORTABLE SANITARY UNIT WILL BE PROVIDED FOR EVERY TEN (10) WORKERS ON THE SITE. ALL SANITARY WASTE WILL BE COLLECTED FROM THE PORTABLE UNITS A MINIMUM OF ONE TIME PER WEEK BY A LICENSED PORTABLE FACILITY PROVIDER IN COMPLETE COMPLIANCE WITH LOCAL AND STATE REGULATIONS.

ALL SANITARY UNITS WILL BE LOCATED IN AN AREA WHERE THE LIKELIHOOD OF THE UNIT CONTRIBUTING TO STORM WATER DISCHARGES IS NEGLIGIBLE. ADDITIONAL CONTAINMENT BMP'S MUST BE IMPLEMENTED, SUCH AS GRAVE BAGS OR SPECIALLY DESIGNED PLASTIC SKID CONTAINERS AROUND THE BASE, TO PREVENT WASTES FROM CONTRIBUTING TO STORM WATER DISCHARGES. THE LOCATIONS OF SANITARY WASTE UNITS MUST BE IDENTIFIED ON THE INTERMEDIATE GRADING PHASE EROSION AND SEDIMENT CONTROL PLAN (SHEET 2) BY THE CONTRACTOR ONCE THE LOCATION HAS BEEN DETERMINED.

PRODUCT SPECIFIC PRACTICES:

PETROLEUM BASED PRODUCTS - CONTAINERS FOR PRODUCTS SUCH AS FUELS, LUBRICANTS, AND TARS WILL BE INSPECTED DAILY FOR LEAKS AND SPILLS. THIS INCLUDES ON-SITE VEHICLES AND MACHINERY DAILY INSPECTIONS AND REGULAR PREVENTATIVE MAINTENANCE OF SUCH EQUIPMENT. EQUIPMENT MAINTENANCE AREAS WILL BE LOCATED AWAY FROM STATE WATER, NATURAL DRAINS AND STORM WATER DRAINAGE INLETS. IN ADDITION, TEMPORARY FUELING TANKS SHALL HAVE A SECONDARY CONTAINMENT LINER TO PREVENT/MINIMIZE SITE CONTAMINATION. DISCHARGE OF OILS, FUELS, AND LUBRICANTS IS PROHIBITED. PROPER DISPOSAL METHODS WILL INCLUDE COLLECTION IN A SUITABLE CONTAINER AND DISPOSAL AS REQUIRED BY LOCAL AND STATE REGULATIONS.

PAINTS/FINISHES/SOLVENTS - ALL PRODUCTS WILL BE STORED IN TIGHTLY SEALED ORIGINAL CONTAINERS WHEN NOT IN USE. EXCESS PRODUCT WILL NOT BE DISCHARGED TO THE STORM WATER COLLECTION SYSTEM. EXCESS PRODUCT, MATERIAL USED WITH THESE PRODUCTS, AND PRODUCT CONTAINERS WILL BE DISPOSED OF ACCORDING TO MANUFACTURER'S SPECIFICATION AND RECOMMENDATIONS.

CONCRETE TRUCK WASHING - NO CONCRETE TRUCKS WILL BE ALLOWED TO WASH OUT OR DISCHARGE SURPLUS CONCRETE OR DRUM WASH WATER OUTSIDE OF DESIGNATED AREA AS SHOWN ON THE PLANS.

FERTILIZER/HERBICIDES - THESE PRODUCTS WILL BE APPLIED AT RATES THAT DO NOT EXCEED THE MANUFACTURER'S SPECIFICATIONS OR ABOVE THE GUIDELINES SET FORTH IN THE CROP ESTABLISHMENT OR IN THE GSWCC MANUAL FOR EROSION AND SEDIMENT CONTROL IN GEORGIA. ANY STORAGE OF THESE MATERIALS WILL BE UNDER ROOF IN SEALED CONTAINERS.

BUILDING MATERIALS - NO BUILDING OR CONSTRUCTION MATERIALS WILL BE BURIED OR DISPOSED OF ON-SITE. ALL SUCH MATERIAL WILL BE DISPOSED OF BY PROPER WASTE DISPOSAL PROCEDURES.

SPILL CLEANUP AND CONTROL PRACTICES:

LOCAL, STATE AND MANUFACTURER'S RECOMMENDED METHODS FOR SPILL CLEANUP WILL BE MADE AVAILABLE TO SITE PERSONNEL.

MATERIAL AND EQUIPMENT NECESSARY FOR SPILL CLEANUP WILL BE KEPT IN THE MATERIAL STORAGE AREAS. TYPICAL MATERIALS AND EQUIPMENT INCLUDES, BUT IS NOT LIMITED TO, BROOMS, DUSTPANS, MOPS, RAGS, GOGGLES, CAT LITTER, SAND, SAW DUST, AND PROPERLY LABELED PLASTIC AND METAL WASTE CONTAINERS.

SPILL PREVENTION PRACTICES AND PROCEDURES WILL BE REVIEWED AFTER A SPILL AND ADJUSTED AS NECESSARY TO PREVENT FUTURE SPILLS.

ALL SPILLS WILL BE CLEANED UP IMMEDIATELY UPON DISCOVERY. ALL SPILLS WILL BE REPORTED AS REQUIRED BY LOCAL, STATE, AND FEDERAL REGULATIONS.

FOR SPILLS THAT IMPACT SURFACE WATER (LEAVE A SHEEN ON SURFACE WATER), THE NATIONAL RESPONSE CENTER (NRC) WILL BE CONTACTED WITH 24 HOURS AT 1-800-424-8802.

FOR SPILLS OF AN UNKNOWN AMOUNT, THE NATIONAL RESPONSE CENTER (NRC) WILL BE CONTACTED WITHIN 24 HOURS.

FOR SPILLS GREATER THAN 25 GALLONS AND NO SURFACE WATER IMPACTS, THE GEORGIA EPD WILL BE CONTACTED WITHIN 24 HOURS.


FOR SPILLS LESS THAN 25 GALLONS AND NO SURFACE WATER IMPACTS, THE GEORGIA EPD WILL BE CONTACTED WITHIN 24 HOURS.

THE CONTRACTOR SHALL NOTIFY THE LICENSED PROFESSIONAL WHO PREPARED THIS PLAN IF MORE THAN 1320 GALLONS OF PETROLEUM IS STORED ON-SITE. (THIS INCLUDES CAPACITIES OF EQUIPMENT), OR IF ANY ONE PIECE OF EQUIPMENT HAS A CAPACITY OF 860 GALLONS. THE CONTRACTOR WILL NEED A SPILL PREVENTION CONTAINMENT AND COUNTERMEASURES PLAN PREPARED BY THAT LICENSED PROFESSIONAL.

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SCALE: 1" = 2000'

SITE VICINITY MAP

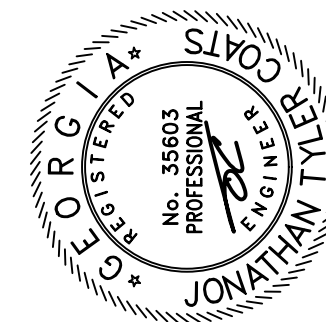

ADAMS LAKE DAM
TOWN OF TYRONE
FAYETTE COUNTY, GEORGIA

ES&PC PLAN - NOTES (SHEET
1 OF 2)



PROJECT NO.s:
SCHNABEL: 24170041.000
TOWN OF TYRONE: PW-2024-10

DATE: JANUARY 2025

SHEET
12 OF 14

24-HOUR EROSION CONTROL CONTACT
CONTRACTOR (TO BE DETERMINED)

