

APPLICATION NO.	PLANNING COMMISSION DATE	TOWN COUNCIL DATE
23TYR-CA0001	N/A	1/04/2024

# STAFF REPORT CERTIFICATE OF APPROPRIATENESS

ADDRESS	OWNER	PARCEL NO.	EX. ZONING	PROPOSED ZONING	FUTURE LAND USE	SURROUNDING ZONING	SITE IMPROVEMENTS	ACREAGE
1400 Senoia Road	74-South LLC	072604009	C-2	N/A	Commercial Corridor	North: C-1 South: C-1 & C-2 East: Ol West: SR-74 & M-2	N/A	9.45 ac

### **SUMMARY & HISTORY**

The applicant 74-South LLC has submitted an application for a certificate of appropriateness for 1400 Senoia Road to construct a 30,000 square foot Highway-Commercial flex building. This property began the application process prior to the revision of the SR-74 overlay and therefore the entire first building is required to meet the architectural requirements at that time. The other buildings on site would not have been required to meet the architectural requirements per the previous version of the ordinance. Those standards required buildings fronting SR-74 to be 80% brick, glass, or stone with no long flat walls providing visual relief every 20 feet.

Upon staff's review of the proposed landscape plan, site plan, and architectural renderings, the property appears to meet all of the SR-74 Overlay Standards as written at the time of initial submission of their application. Staff recommends approval of this certificate of appropriateness with the condition that any remaining Technical Review Committee (TRC) comments be resolved.

## COMPREHENSIVE PLAN & FUTURE DEVELOPMENT MAP COMPATABILITY

This petition is consistent with the Town's comprehensive plan and future development map. The Future Land Use designation for this property is Commercial Corridor which encourages high-quality architectural buildings in commercial zoning classifications with special attention placed on limiting ingress/egress from SR-74.





# **ORDINANCE COMPATABILITY**

This petition is consistent with the Town's zoning ordinance. The architectural renderings meet the minimum standards outlined for the Quality Growth Overlay as written at the time of this submission. The submission also meets the minimum requirements for a Certificate of Appropriateness as outlined in section 109–84 of the land development code.

Staff still has minor outstanding TRC comments regarding the site, specifically needed legal information on the proposed sewer easement. Staff recommends approval with the condition that all TRC comments and outstanding requirements be completed.



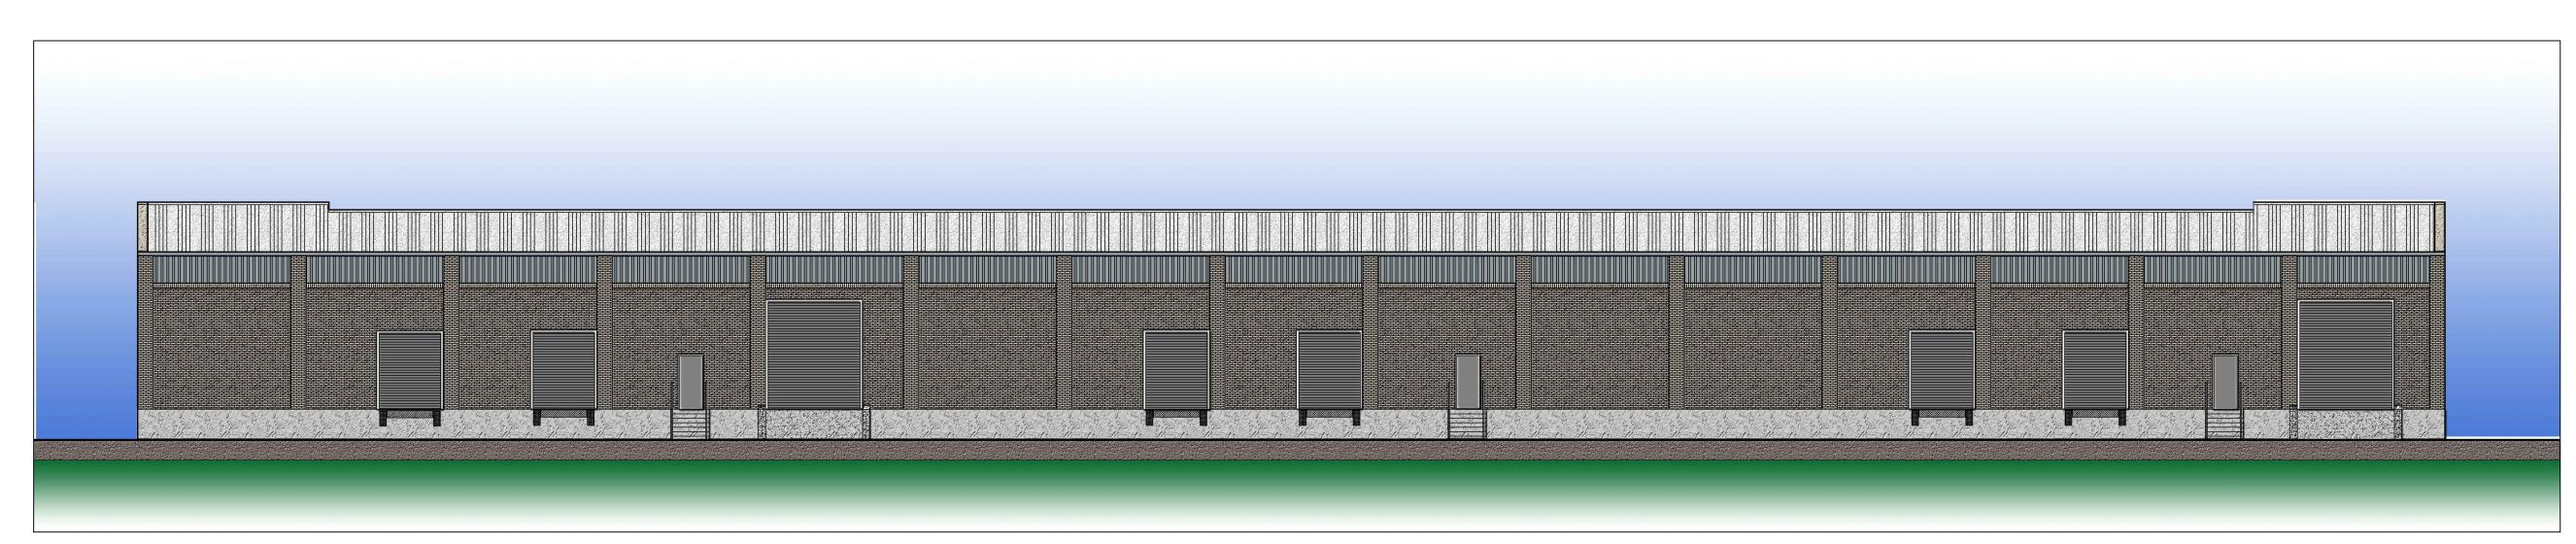


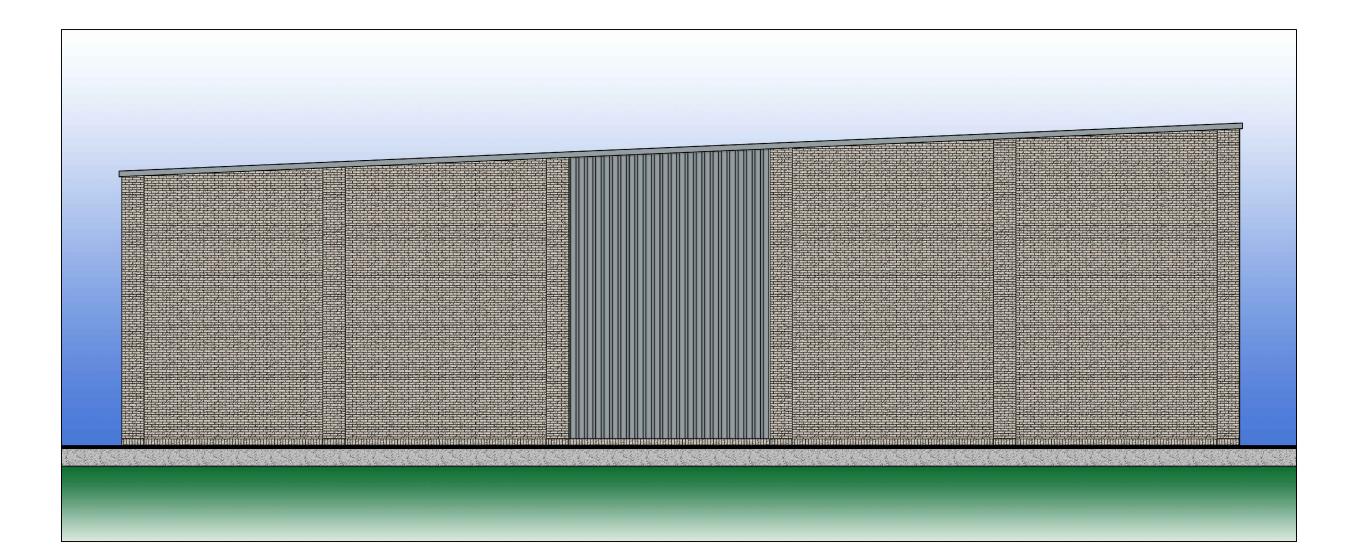







A New Building at
TYRONE
BUSINESS PARK
1400 SENOIA ROAD, BUILDING 100
TYRONE, GEORGIA 30290

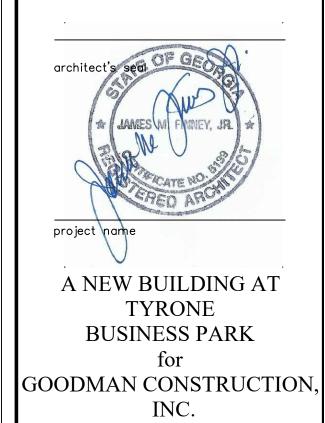


COLOR RENDERINGS

drawn
JMF
checked
JMF
project no.
RRDA-22-030
date
02/25/2023
sheet no.

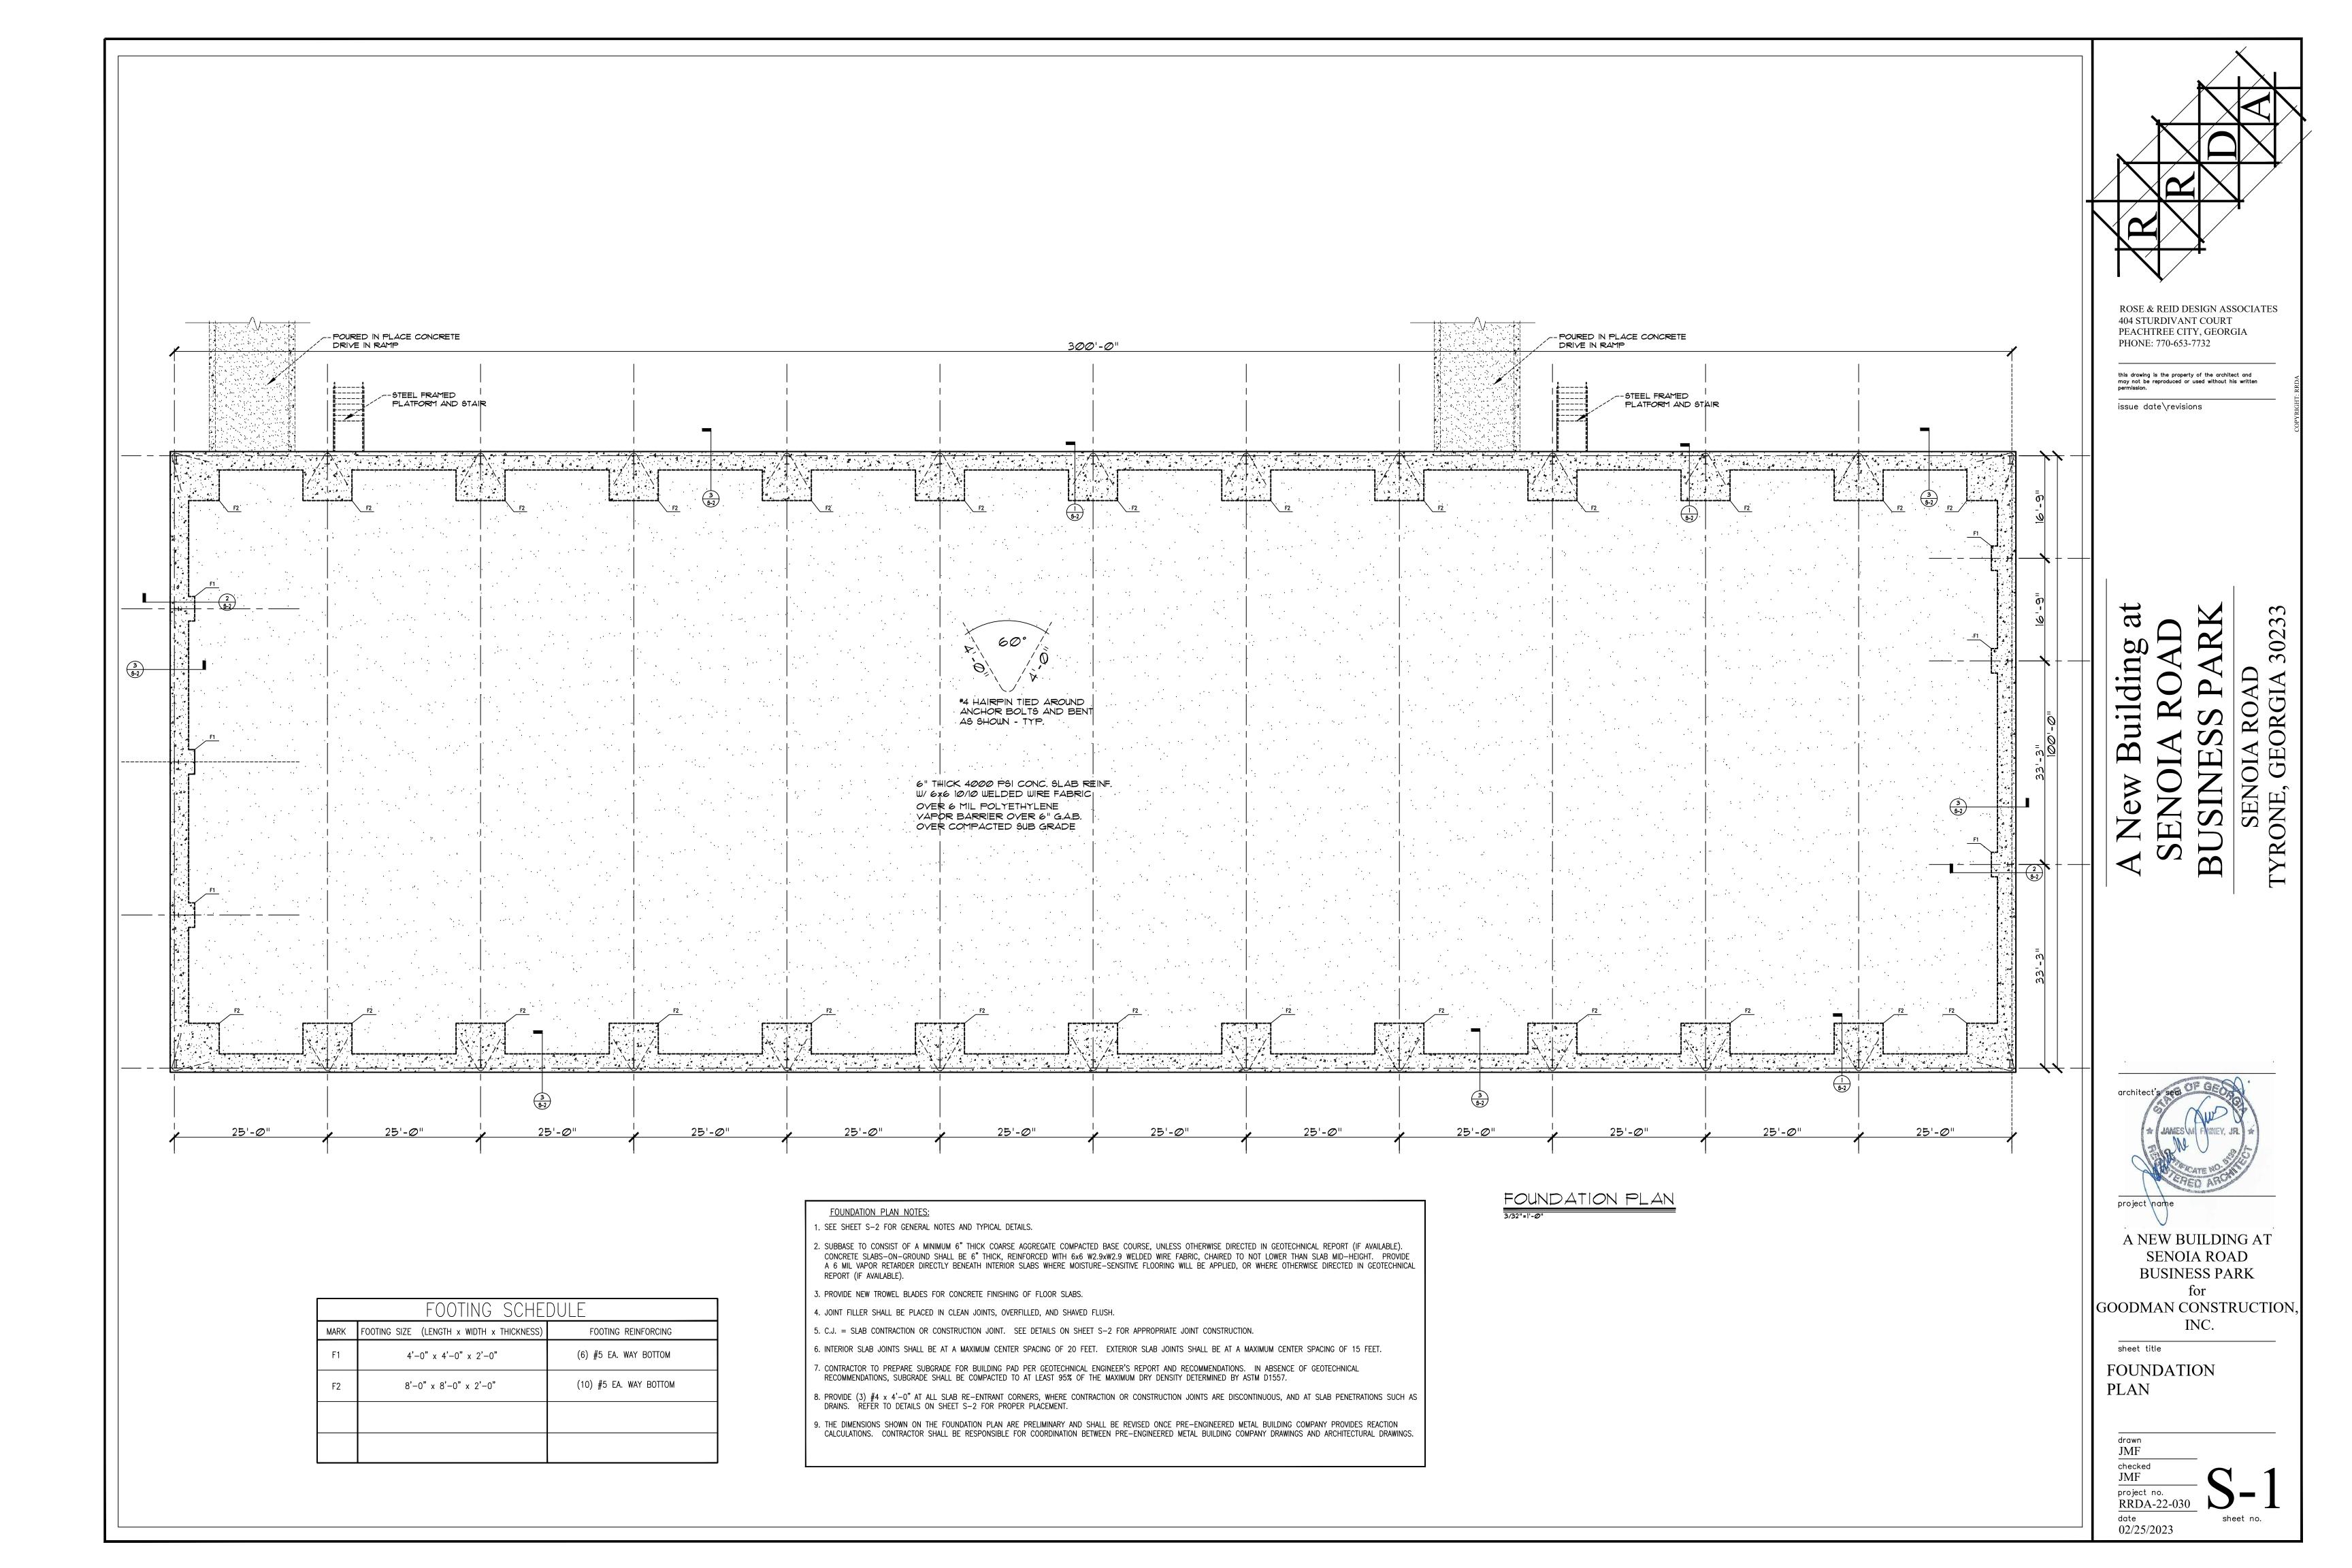

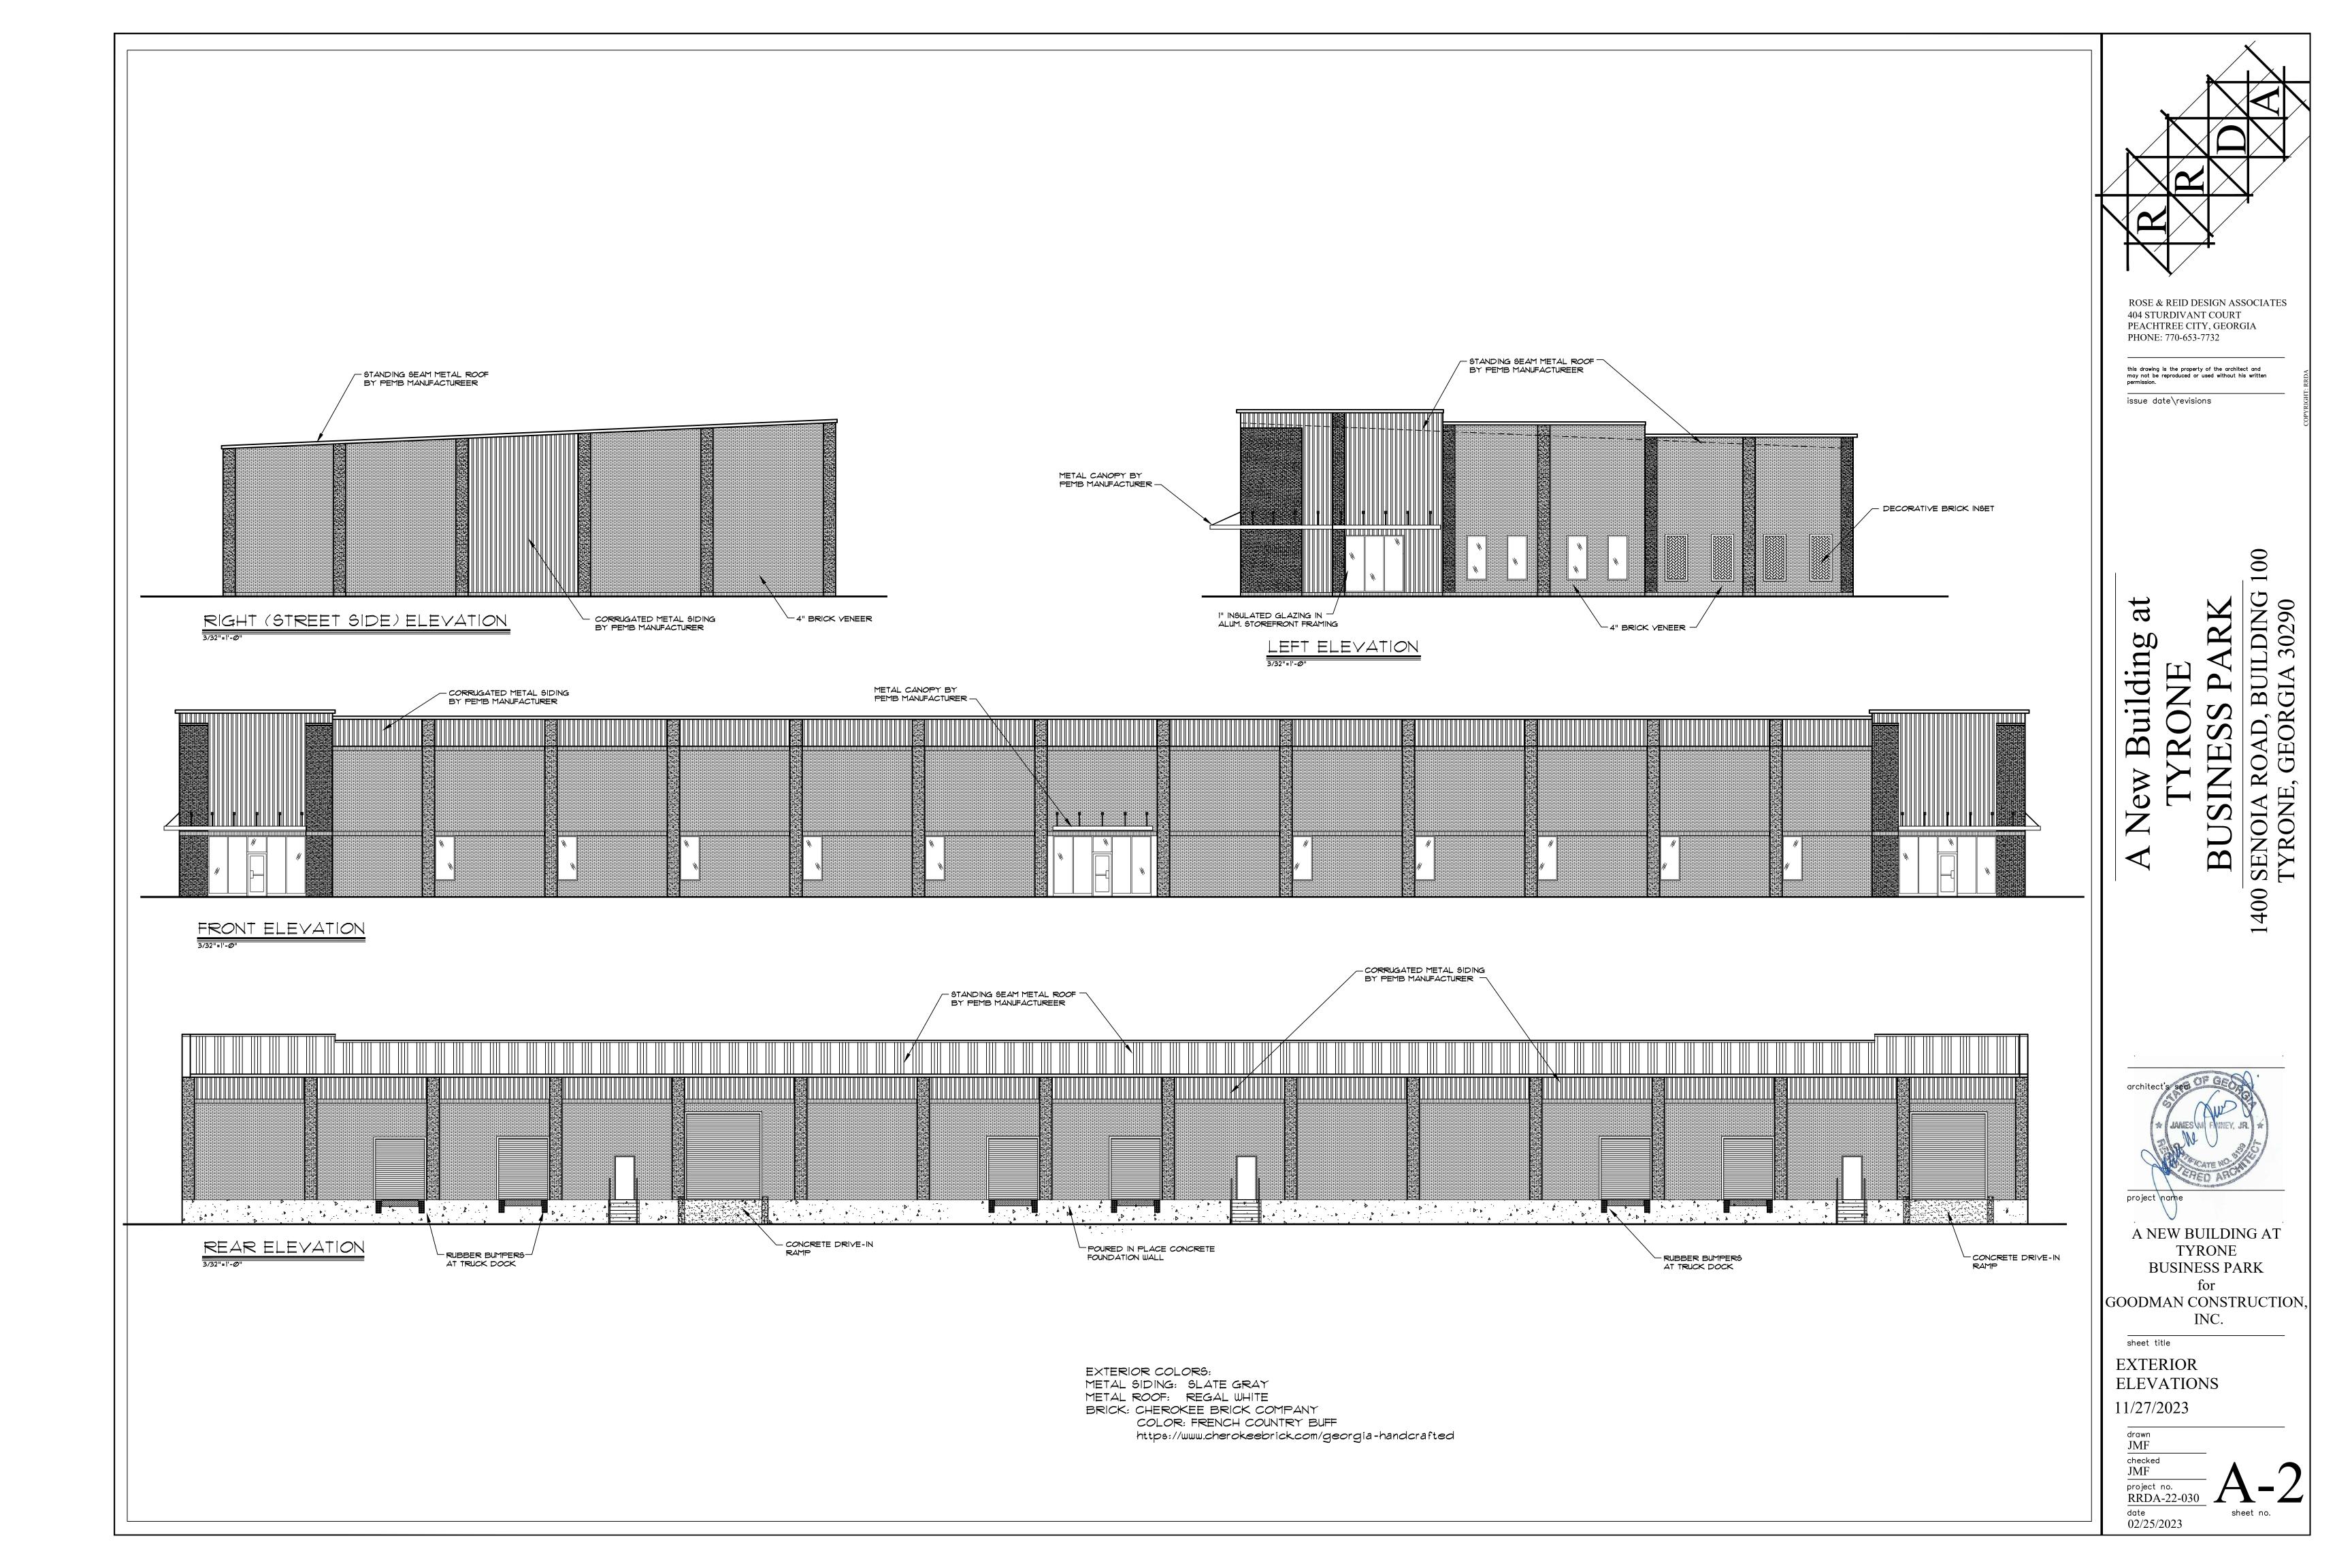

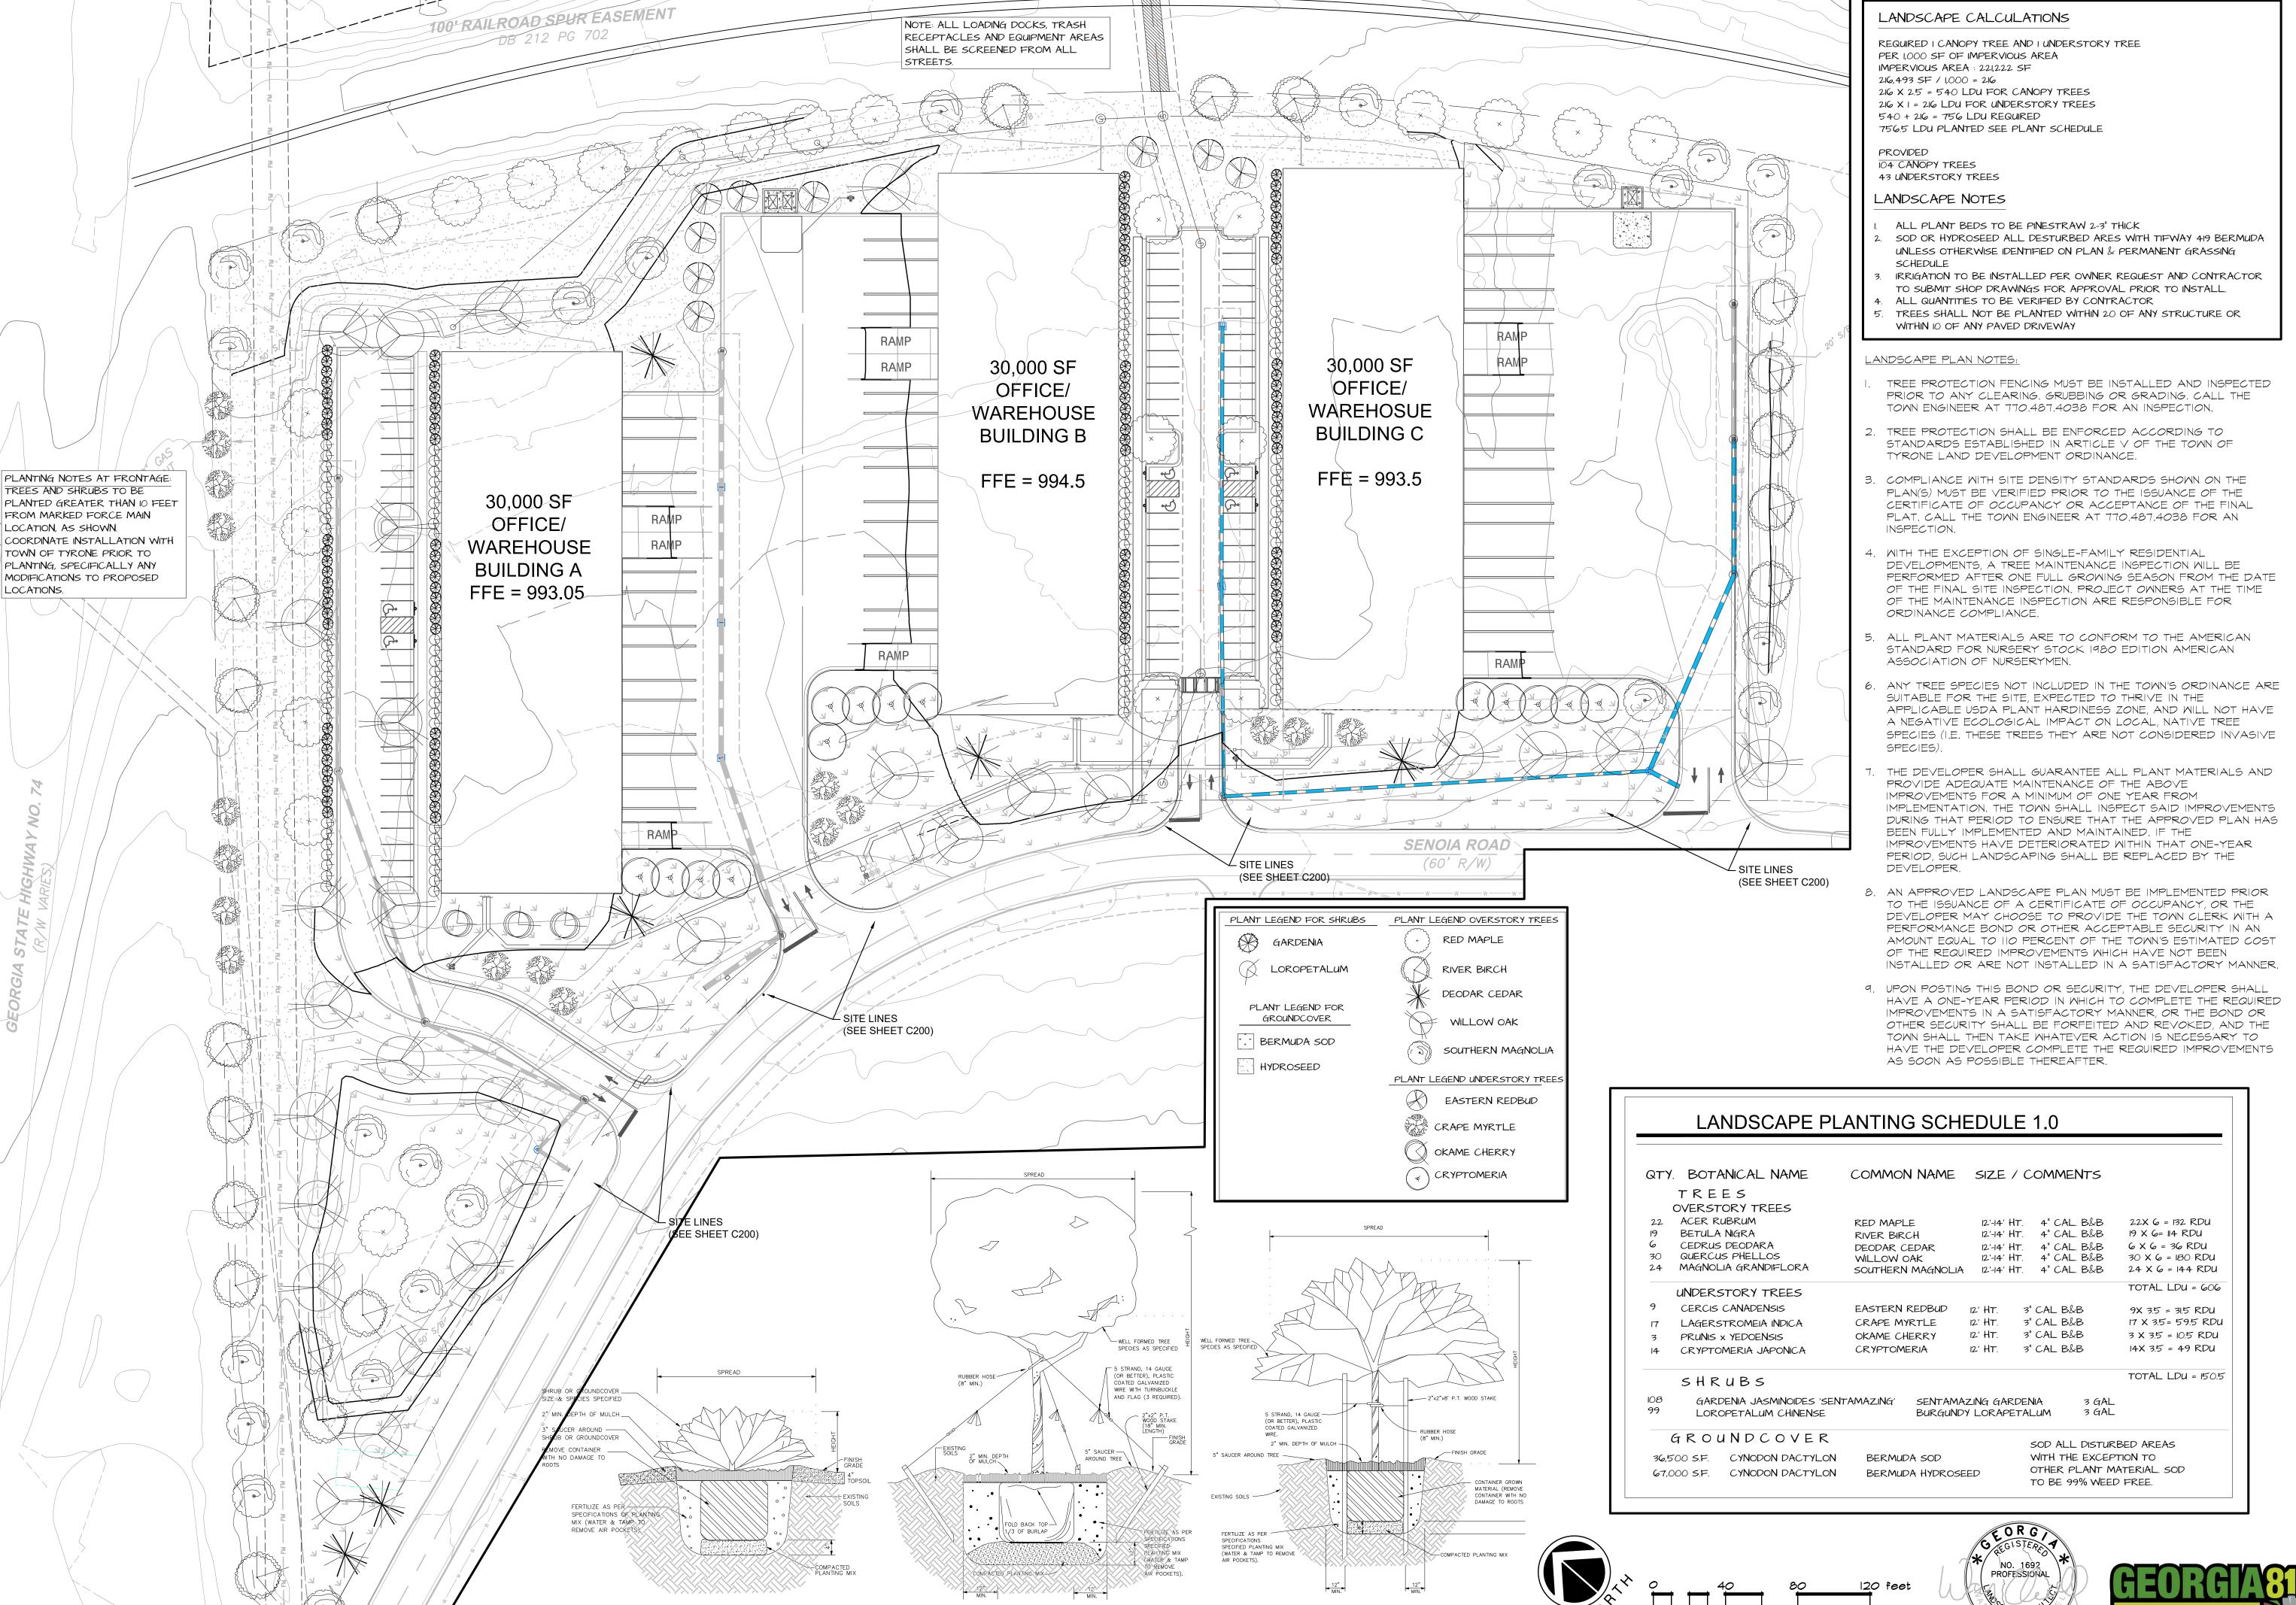

LARGE TREE PLANTING DETAIL

SHRUB AND GROUNDCOVER DETAIL

SMALL TREE PLANTING DETAIL

(2" CALIPER OR SMALLER)

N.T.S.

INTEGRATED Science & Engineering





DOW L. WAL


Date: Drawn by: Check by: 2/9/22 LBW JLW Project #: Design by: Review by: 1633.2101 JLW JLW 1. ISSUED FOR REVIEW

SITE DEVELOPMENT PLANS
FOR
74 SOUTH BUSINESS PARK

LANDSCAPE PLAN

DRAWING NO. L100

Know what's **below. Call** before you dig.

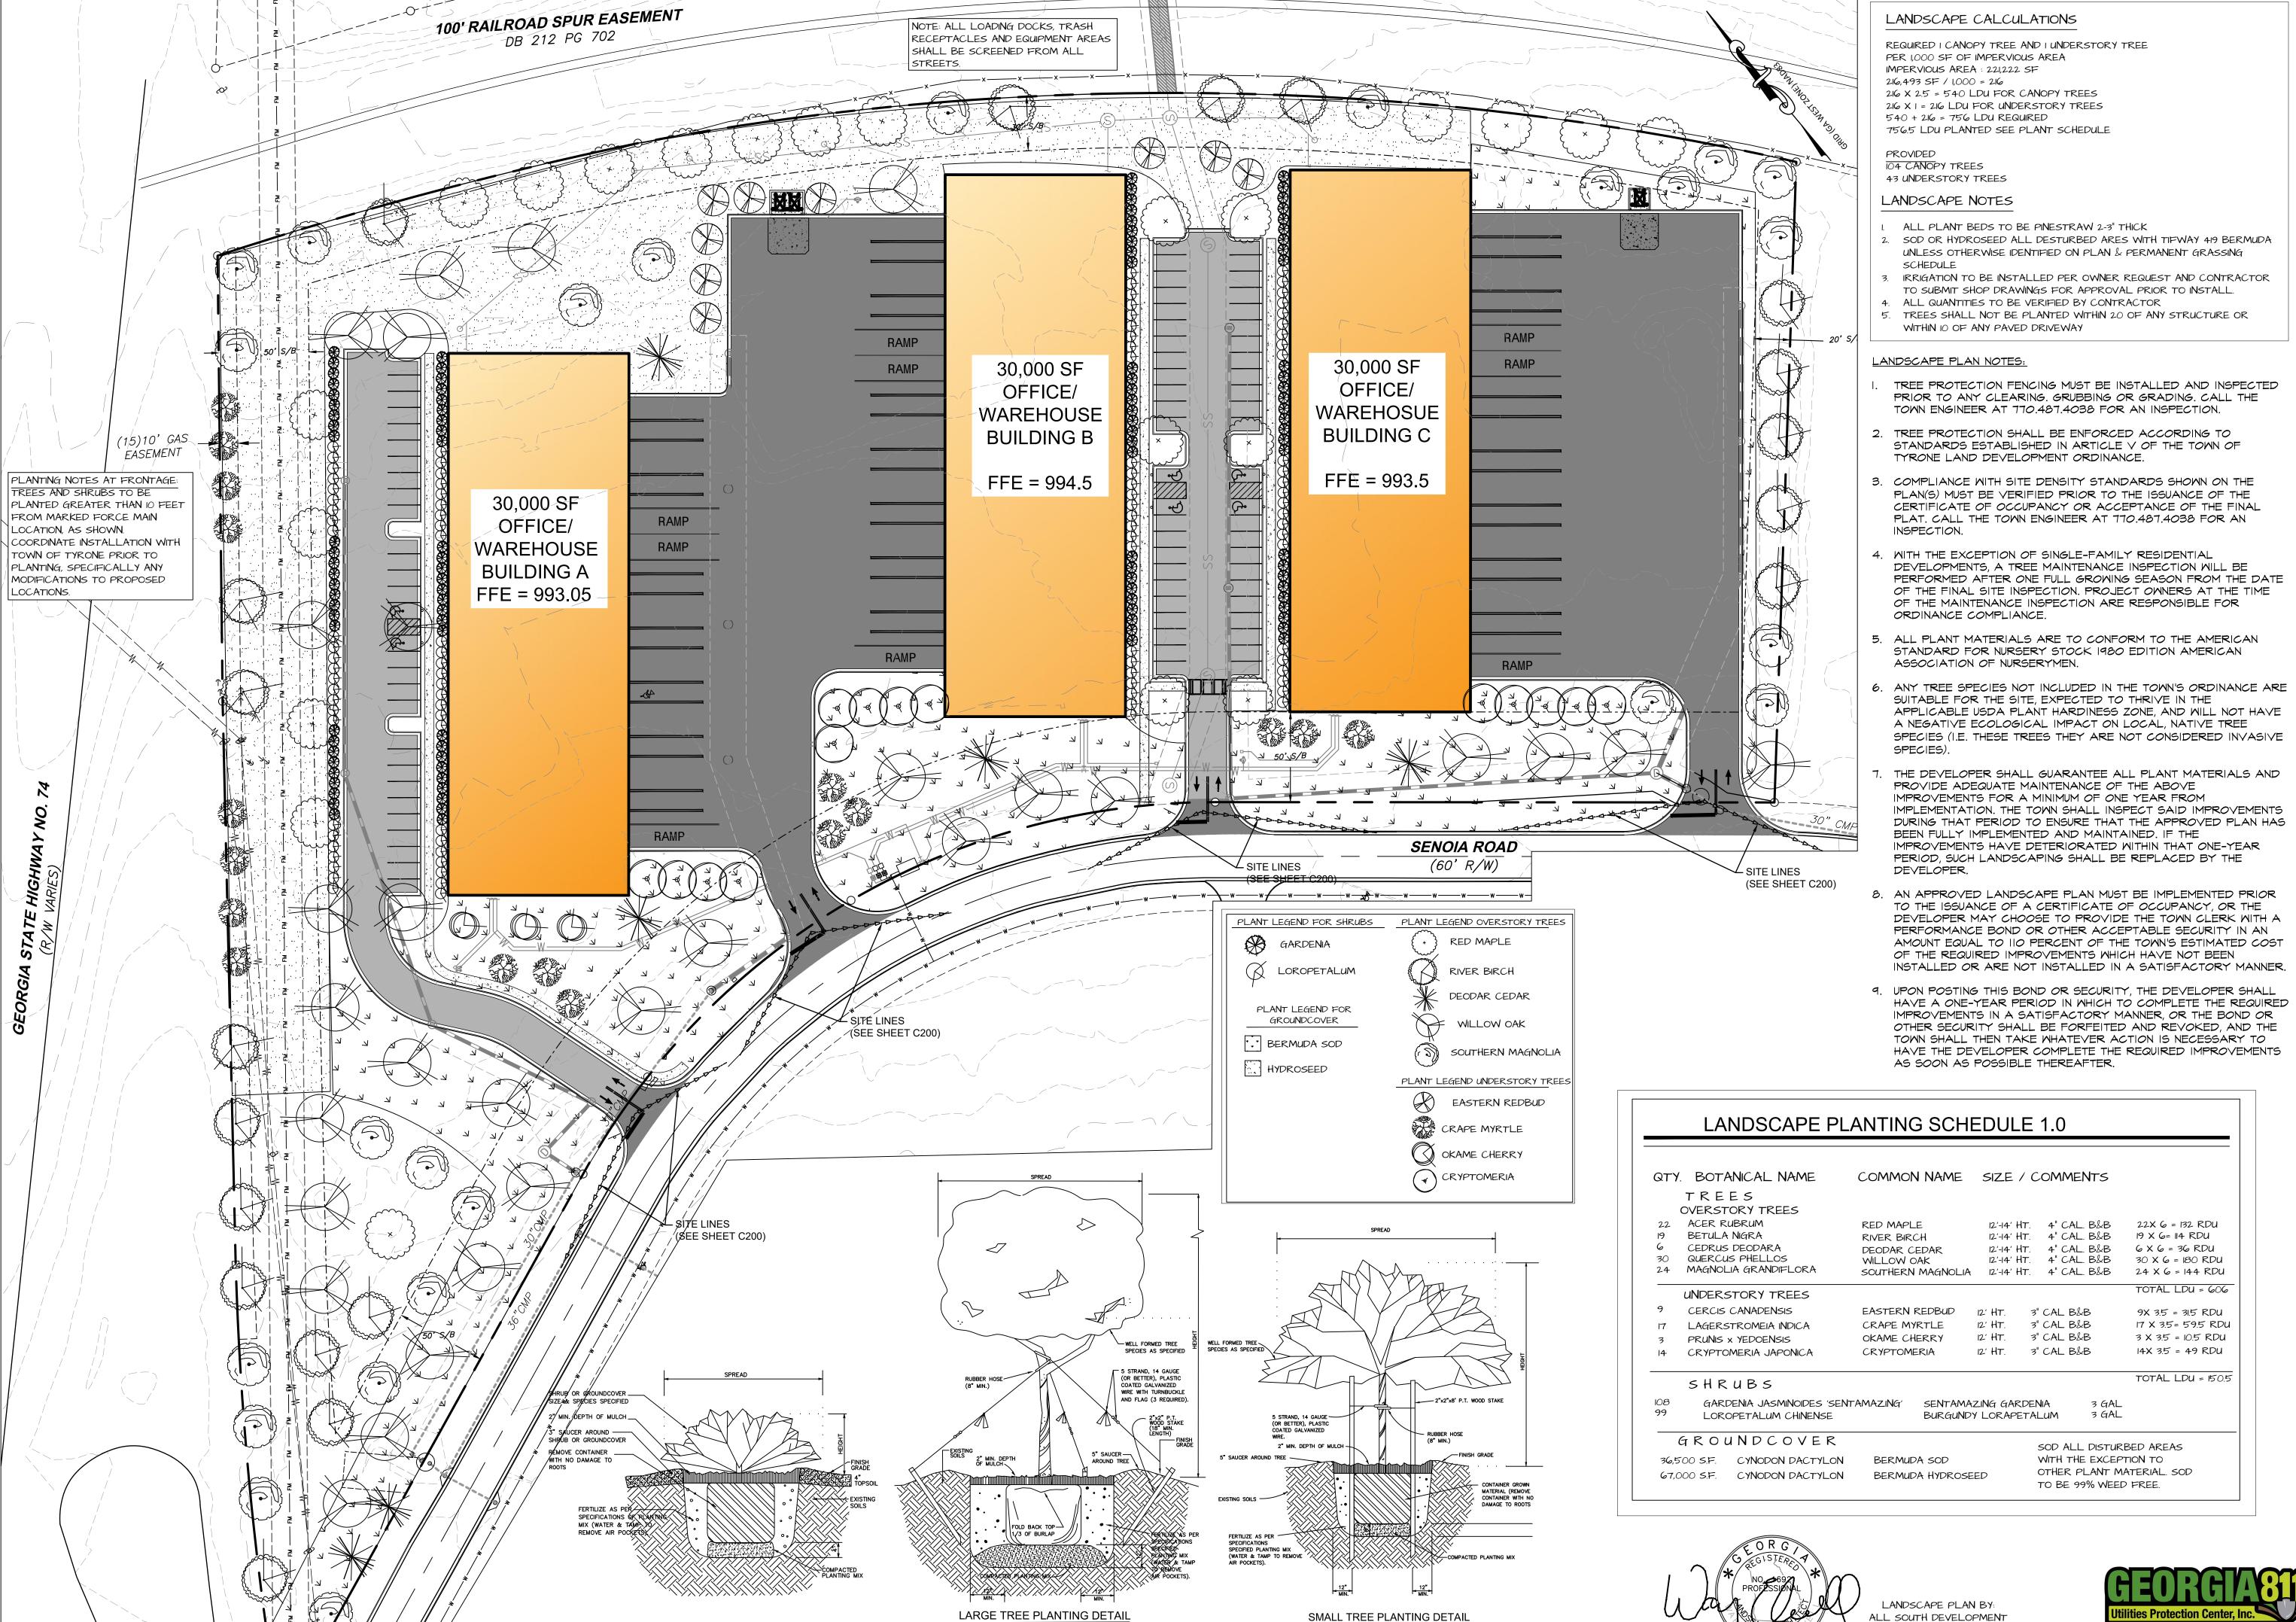

(CALIPER GREATER THAN 2") N.T.S.

SHRUB AND GROUNDCOVER DETAIL

(2" CALIPER OR SMALLER) N.T.S.

INTEGE Science Engineer





by:				
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<b>4</b> 0,	3.	ISSUED FOR PERMIT	5/2/23	JLW
	2.	ISSUED FOR PERMIT	2/24/23	JLW
7	1.	ISSUED FOR REVIEW	5/20/22	JLW
	Rev.	Rev. Description	Date	Apr

FOR BUSINESS SOU

DRAWING NO. Know what's **below**. **Call** before you dig.

P.O. BOX 2290

PEACHTREE CITY, GA 30269

# **GENERAL NOTES:**

- OWNER/DEVELOPER:

  ISLAND INVESTORS

  350 ALLISON DR. NE

  ATLANTA, GA 30342

  CONTACT: RANDY WRIGHT

  EMAIL: RANDY@ISLANDINV.COM
  PHONE: 404-316-1101
- 2. ARCHITECT:

  ROSE AND REID DESIGN ASSOCIATES

  OAK MANOR OFFICE PARK

  PEACHTREE CITY, GA 30269

  CONTACT: JIM FINNEY

  PHONE: 770-632-6161
- 3. ENGINEER / SURVEYOR:

  INTEGRATED SCIENCE & ENGINEERING, INC.

  1039 SULLIVAN ROAD, STE. 200

  NEWNAN, GA 30265

  CONTACT: JASON L. WALLS, P.E.

  EMAIL: JWALLS@INTSE.COM

  PHONE: 678-552-2106
- 4. SITE DATA:
  PARCEL: 16, 17, AND TRACT "B" POWERS COURT
  TAX PARCEL ID NUMBER: 072604010, 072604009
  ZONING: C-2 (HIGHWAY COMMERCIAL)
  USE: COMMERCIAL BUSINESS PARK
- 5. SITE AREA: 9.454 ACRES
  DISTURBED AREA: 9.5 ACRES
- 6. SETBACKS:
  FRONT: 50 FEET (BUILDING)
  SIDE: 20 FEET (BUILDING)
  REAR: 30 FEET (BUILDING)
- 7. BUILDING AREA: 90,000 SF 3 BUILDINGS AT 30,000 SF EACH
- 8. IMPERVIOUS SURFACE CALCULATIONS: PROPOSED: 4.97 AC (52.6%)
  OPEN SPACE: 4.484 AC (47.4%)
- PARKING SUMMARY:
  WAREHOUSE (81,000 SF) @ 1 SPACE PER 2000 SF = 41 SPACES
  OFFICE (9,000 SF) @ 1 SPACE PER 250 SF = 36 SPACES
- TOTAL REQUIRED PARKING = 77 SPACES
- TOTAL PROVIDED PARKING = 78 SPACES (INCLUDING 6 ADA SPACES)
- 10. NO PORTIONS OF THIS PROPERTY LIE WITHIN A FLOOD ZONE OF THE FLOOD INSURANCE RATE MAP, COMMUNITY PANEL #13113C0077E DATED SEPTEMBER 26, 2008.
- 11. WETLANDS AND STATE WATERS ARE NOT PRESENT ON SITE, OR WITHIN 200 FEET OF THE PROPOSED DEVELOPMENT. WETLAND INFORMATION TAKEN FROM THE U.S. FISH AND WILDLIFE SERVICE NATIONAL WETLANDS INVENTORY.
- 12. <u>UTILITIES:</u> WATER SERVICES PROVIDED BY THE FAYETTE COUNTY WATER SYSTEM. SEWER SERVICE TO BE PROVIDED BY CONNECTION TO PUBLIC SEWER (FULTON COUNTY SEWER DEPARTMENT) THROUGH COORDINATION WITH THE TOWN OF TYRONE.
- 13. <u>STORMWATER MANAGEMENT NARRATIVE:</u> THE SITE CURRENTLY IS CURRENTLY WOODED WITH SMALL PINES AND UNDERGROWTH COVERING UP THE PARTIALLY DEVELOPED PROPERTY FROM PREVIOUSLY APPROVED PLANS FOR A MEDICAL OFFICE PARK. THE PARTIAL DEVELOPMENT INCLUDES FULL CLEARING AND GRADING OF THE PROPRTY, THE INSTALLATION OF WATER/SEWER/STORM UTILITIES, AND PARKING LOT CONSTRUCTION (LESS THE ASPHALT). THESE IMPROVEMENTS WILL B FULLY REMOVED FROM THE SITE LESS PORTIONS OF THE UNDERGROUND UTILITIES THAT REMAIN FOR FUTURE DEVELOPMENT. STORMWATER MANAGEMENT FOR THE PROPERTY IS PROVIDED BY AN EXISTING REGIONAL DETENTION FACILITY BUILT AS PART OF THE ORIGINAL POWERS COURT COMMERCIAL SUBDIVISION AND THE ADJACENT MILLBROOK VILLAGE RESIDENTIAL DEVELOPMENT. WATER QUALITY IS CURRENTLY PROVIDED BY TWO EXISTING ONSITE PROPRIETARY STRUCTURES INSTALLED IN 2007 AS PART OF THE PREVIOUS PROJECT. THE WATER QUALITY STRUCTURES AS SIZED FOR THE PREVIOUS DEVELOPMENT ARE ALSO SIZED APPROPRIATELY FOR THE NEW DEVELOPMENT. EACH STRUCTURE SHALL BE INSPECTED AND CLEANED OUT PRIOR TO CONSTRUCTION OF THE NEW FACILITY. STORMWATER WILL THEN FLOW INTO THE EXISTING POWERS COURT MUNICIPAL STORM DRAIN SYSTEM WHICH THEN DISCHARGES INTO AN UN-NAMED TRIBUTARY T FLAT CREEK, CARRYING THE STORMWATER TO A SERIES OF IN-GROUND DETENTION BASINS WHICH DETAIN THE WATERS WITHIN THE VOLUME OF THE BASINS AND REDUCE THE PEAK OUTFLOW BY THE USE OF OUTLET CONTROL ORIFICES AND RESTRICTION STRUCTURES. THE STORMWATER IS CONTINUES ALONG THE UN-NAMED TRIBUTARY TO FLAT CREEK AND A LARGER FLOOD PLAIN AREA DOWNSTREAM FROM THE PROPERTIES.
- 14.
  15. THIS PROPERTY IS LOCATED IN GROUNDWATER RECHARGE AREA PER THE MAPS PROVIDED IN GA DNR'S HYDROLOGIC ATLAS 18 (1989 EDITION). THIS PLAN COMPLIES ACCORDINGLY WITH THE LOCAL ORDINANCE OF THE TOWN OF TYRONE, GA.
- 16. THIS PROPERTY HAS BEEN PREVIOUSLY CLEARED AND PARTIALLY DEVELOPED, THEREFORE THERE ARE NO SPECIMEN TREES ON THIS SITE FOR WHICH TO BE ACCOUNTED. EXISTING CURB AND GUTTER AND STORM TO BE REMOVED AS INDICATED ON SHEET C100 AND UNDERBRUSH TO BE CLEARED.
- 17. A STORMWATER FACILITY MAINTENANCE AGREEMENT IS REQUIRED FOR THE NEW DEVELOPMENT, TO BE PROVIDED AT TIME OF AS-BUILTS AND PROJECT CLOSE OUT PROCEDURES AND DUE BEFORE CERTIFICATE OF OCCUPANCY FOR THE FIRST BUILDING. PROCESS INCLUDES RE-FILLING PLAT WITH ANY AND ALL EASEMENTS.
- 18. OWNER/DEVELOPER, OR THEIR SUCCESSORS, MUST MAINTAIN ALL STORMWATER CONTROL MEASURES, INCLUDING BUT NOT LIMITED TO, STORMWATER MANAGEMENT FACILITIES, WATER QUALITY TREATMENT BMP'S, PROPRIETARY STRUCTURE, STORMWATER CONVEYANCES, LONG-TERM EROSION CONTROL BMP'S, ETC. AS NECESSARY AND IN ACCORDANCE WITH THE TOWN OF TYRONE'S STORMWATER MANAGEMENT ORDINANCES

	SHEET INDEX
SHEET#	TITLE
C000	COVER
C001	GENERAL NOTES
C100	EXISTING CONDITIONS AND DEMOLITION PLAN
C200	SITE PLAN
C300	GRADING AND DRAINAGE PLAN
C301	DETAILED GRADING PLAN - RAMPS
C350	STORM PIPE PROFILES
C351	STORMPIPE CHARTS
C400	UTILITY PLAN
C450	SEWER EXTENSION PLAN
C500	EROSION COVER
C501	COMPREHENSIVE MONITORING PLAN
C502	N.P.D.E.S. CHECKLIST
C510	INITIAL PHASE EROSION & SEDIMENTATION CONTROL PLAN
C511	INITIAL PHASE EROSION & SEDIMENTATION CONTROL - SEWER EXT
C520	INTERMEDIATE PHASE EROSION & SEDIMENTATION CONTROL PLAN
C521	INTERMEDIATE PHASE EROSION & SEDIMENTATION CONTROL - SEWER EXT
C530	FINAL PHASE EROSION & SEDIMENTATION CONTROL PLAN
C531	FINAL PHASE EROSION & SEDIMENTATION CONTROL - SEWER EXT
C600	EROSION DETAILS
C601	EROSION DETAILS
C602	EROSION DETAILS
C700	CONSTRUCTION DETAILS
C701	CONSTRUCTION DETAILS
C702	CONSTRUCTION DETAILS
C703	CONSTRUCTION DETAILS
C704	CONSTRUCTION DETAILS
C705	CONSTRUCTION DETAILS
C706	CONSTRUCTION DETAILS
C707	CONSTRUCTION DETAILS
C708	CONSTRUCTION DETAILS
C709	CONSTRUCTION DETAILS
L100	LANDSCAPE PLAN

# PREPARED FOR



# PROJECT LOCATION TYRONE FAYETTE COUNTY, GA

# SITE DEVELOPMENT PLANS FOR 74 SOUTH BUSINESS PARK

LAND LOT 116 OF THE 7TH DISTRICT, FAYETTE COUNTY, GEORGIA 1400-1420 SENOIA ROAD, TYRONE, GEORGIA 30290

GPS LOCATION OF THE CONSTRUCTION EXIT LAT: 33.293397°N LONG: 84.344617°W

# SITE LOCATION MAP (N.T.S.)







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	3.	ISSUED FOR PERMIT	5/5/23	٦٢/
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	1.	ISSUED FOR REVIEW	5/20/22	JLV
	Rev.	Rev. Description	Date	Ap


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Project #: Design by: Review by:
1633,2101 JLW JLW
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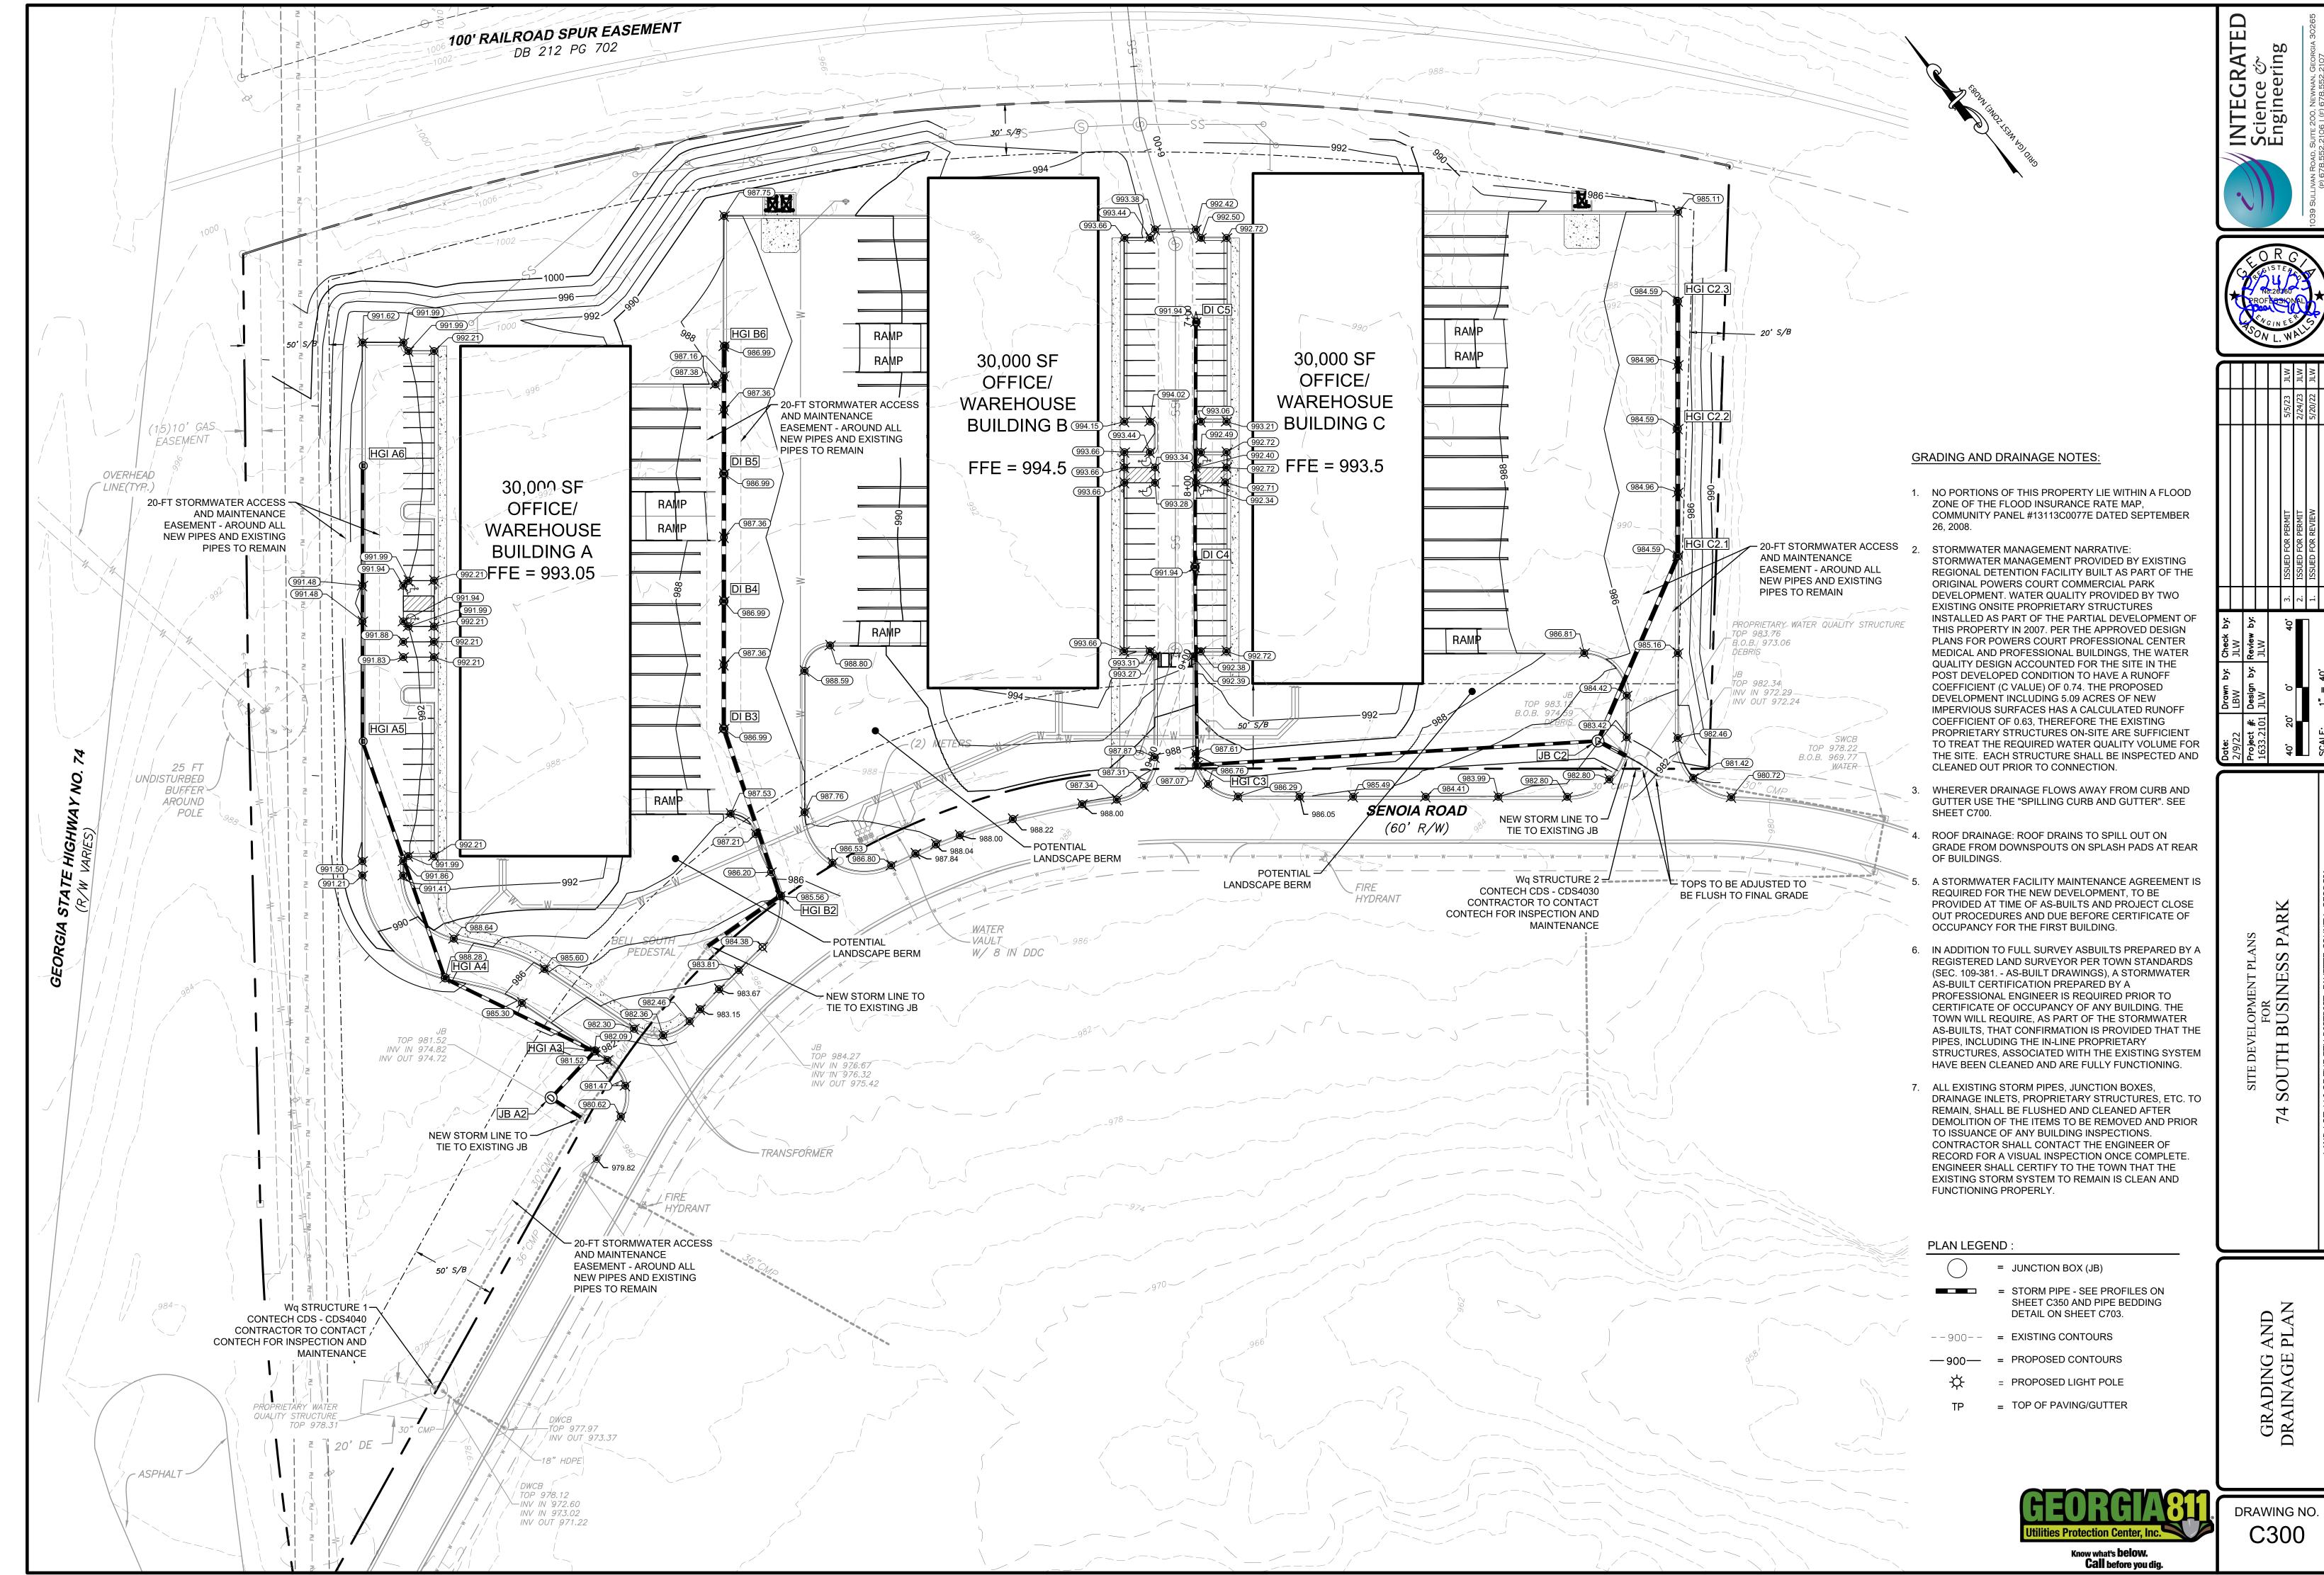
SITE DEVELOPMENT PLANS FOR 74 SOUTH BUSINESS PARK

COVER




DRAWING NO.



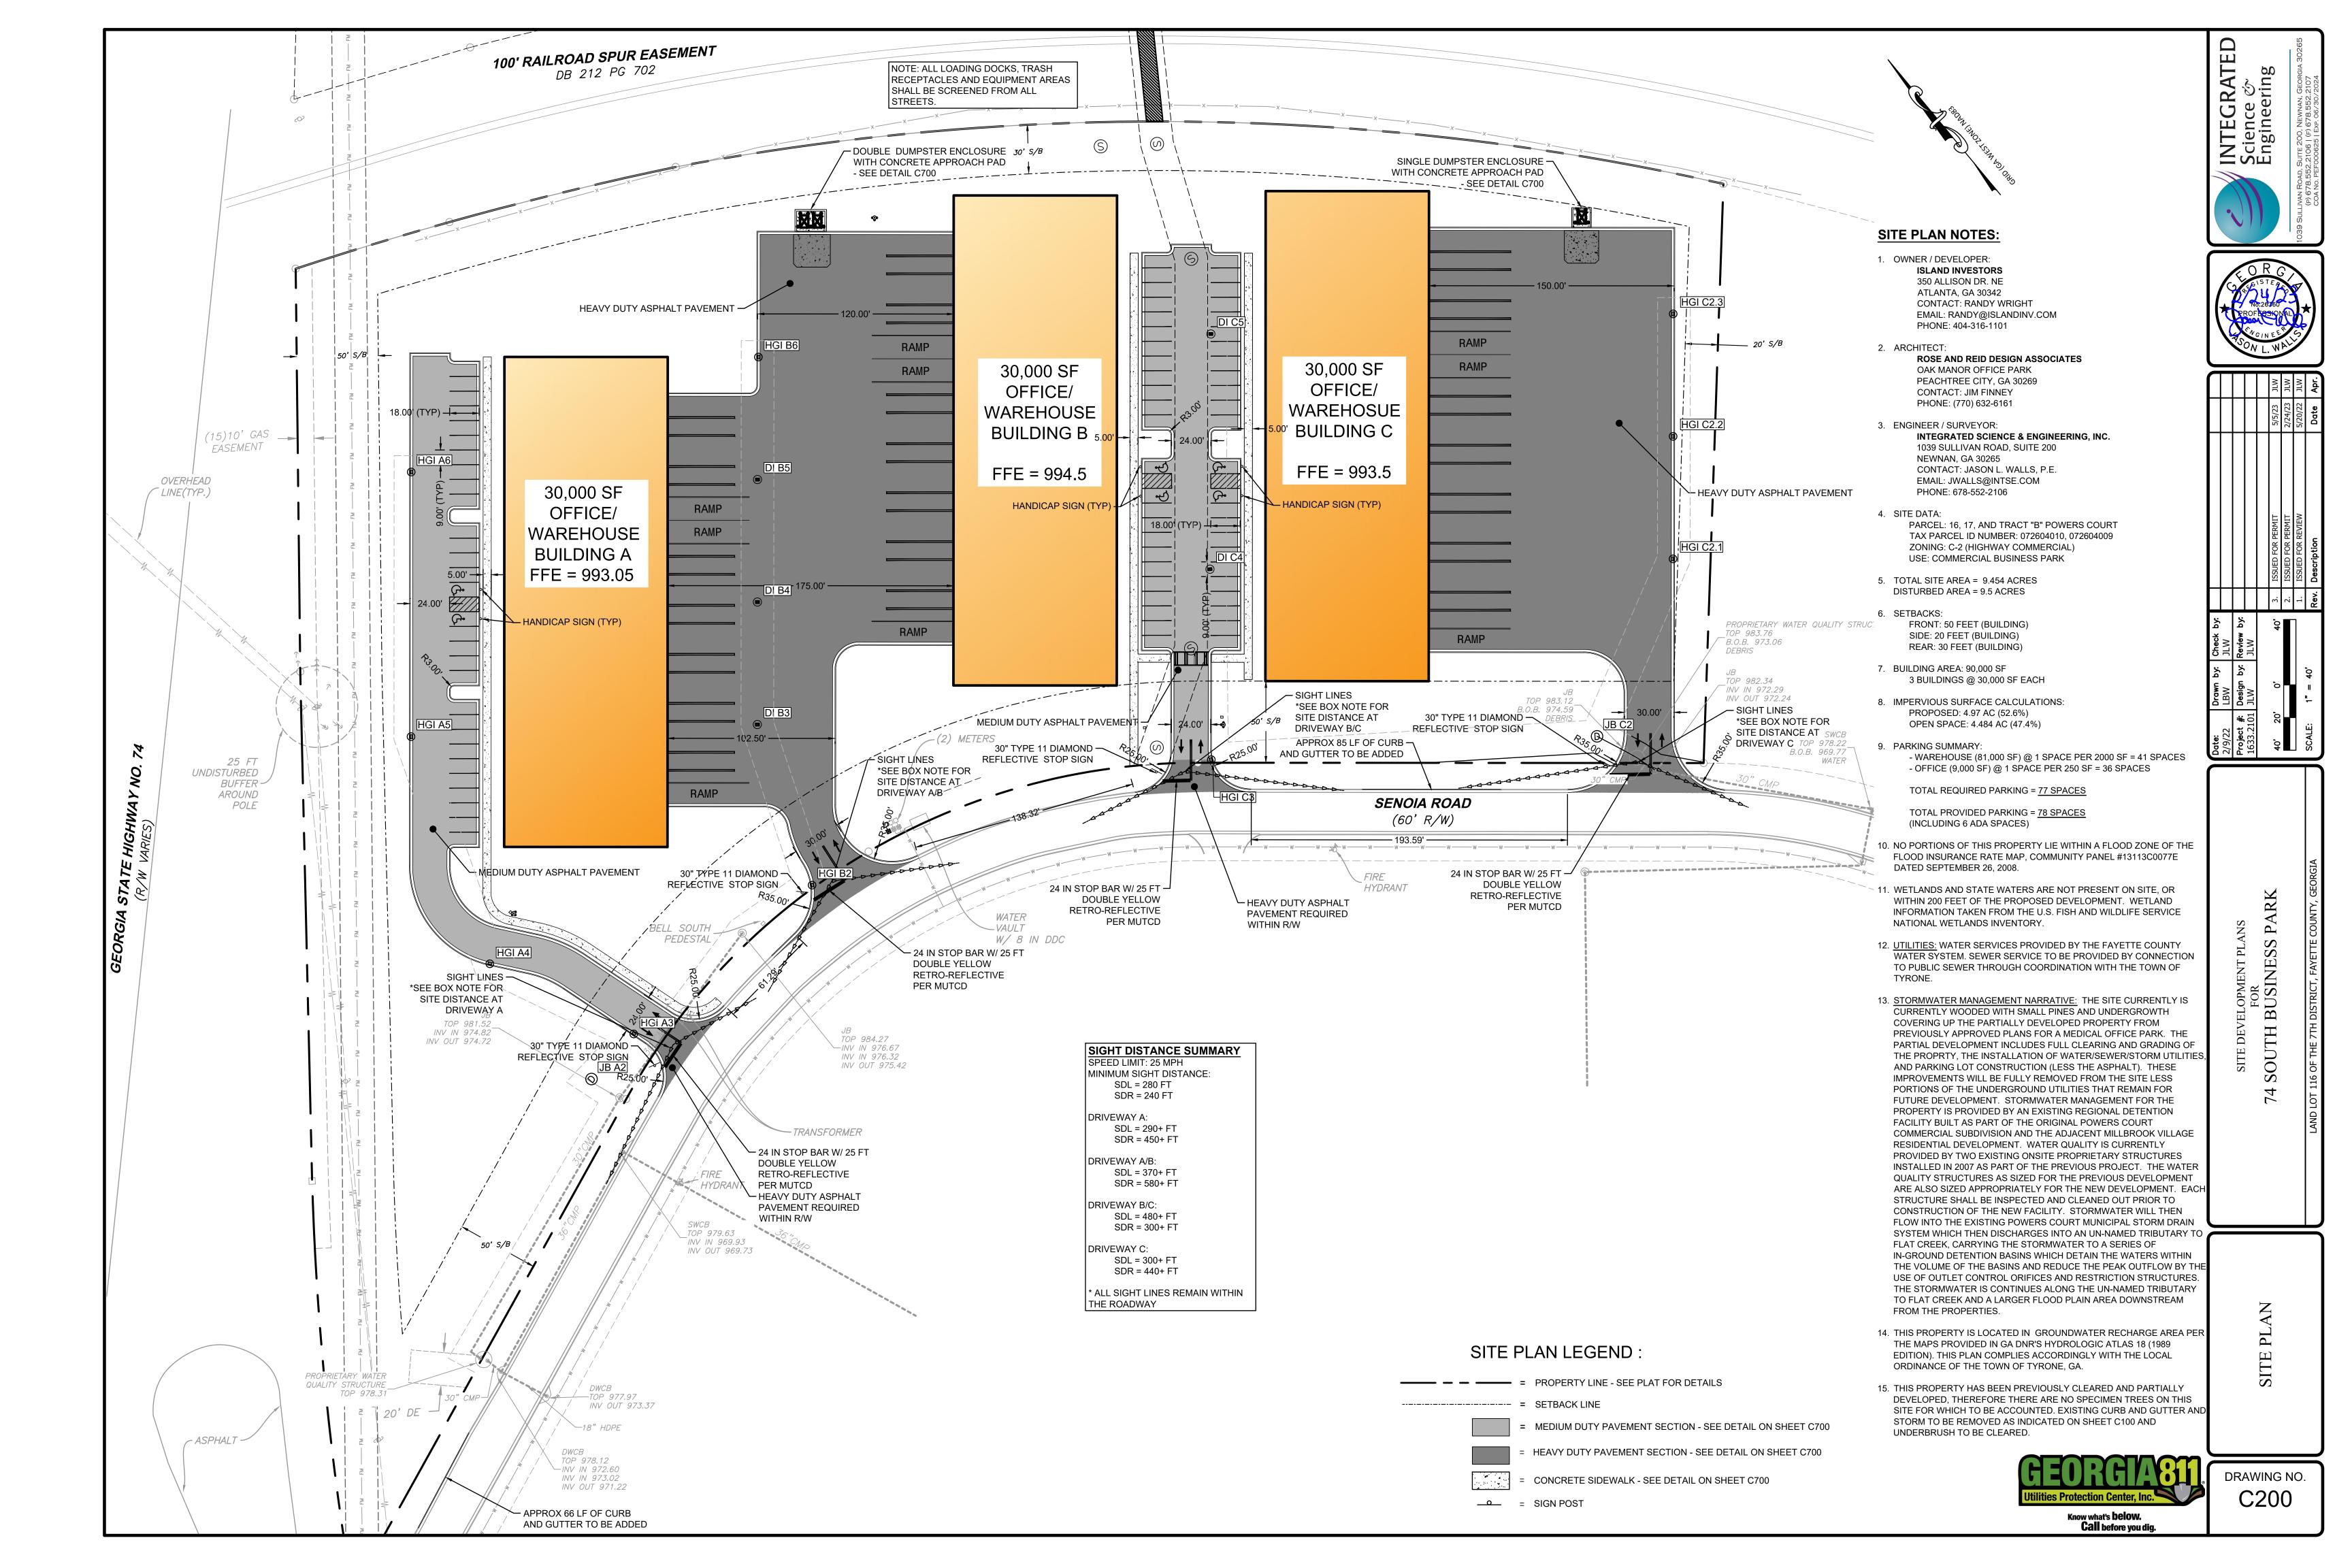



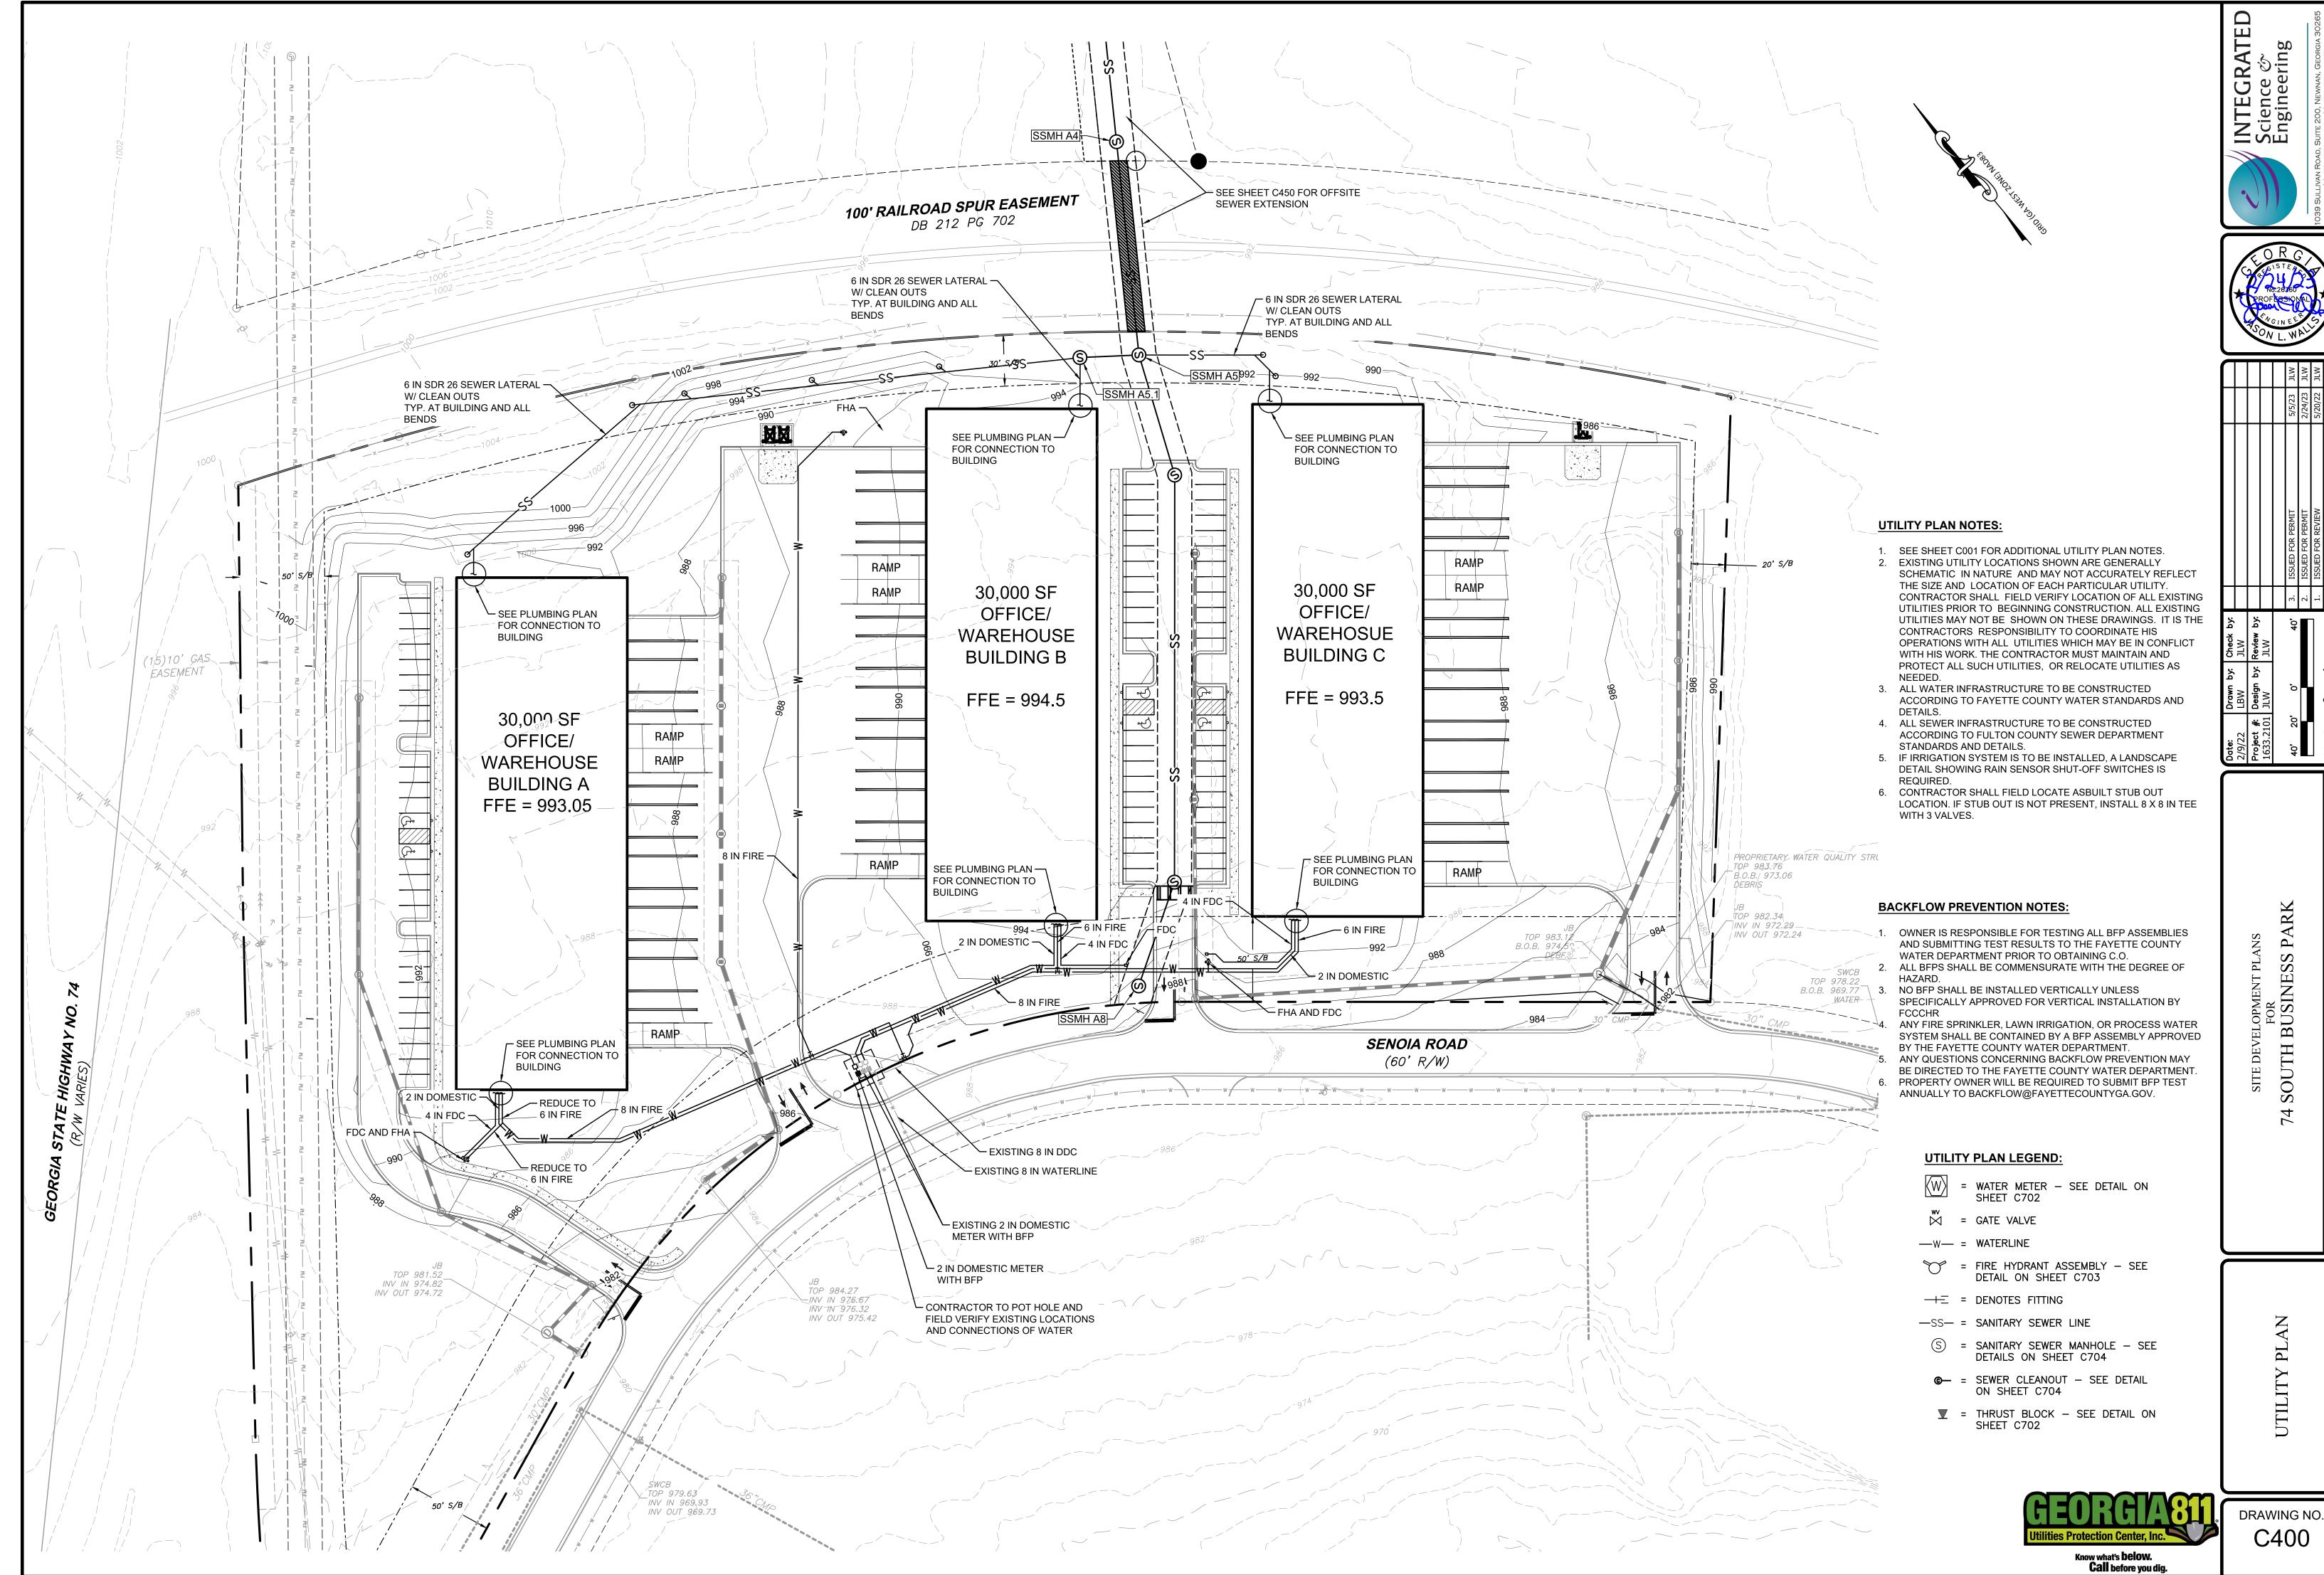







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- 40′		Rev.	Rev. Description	Date

DRAWING NO.

CONTRACTOR TO COORDINATE WITH TOWN OF TYRONE WHEN TYING INTO SEWER MANHOLE AT PUMP STATION TO AVOID ANY CONFLICTS WITH GENERATOR, CONTROL PANEL, AND EXISTING UTILITIES APPROX 100 FT JACK AND BORE -COORDINATE FIELD WORK -WITHIN FENCE LINE WITH TOWN OF TYRONE. AVOID **ALL UTILITIES** \$\$MH/ TOP 979.35\_ INV IN/974.15 INV OUT 9,73.35 20 FT SANITARY SEWER EASEMENT EXISTING PUMP STATION WITHIN FENCED IN **ENCLOSURE** TOP 978.44 B.O.B. 972.34 FULL OF WATER-

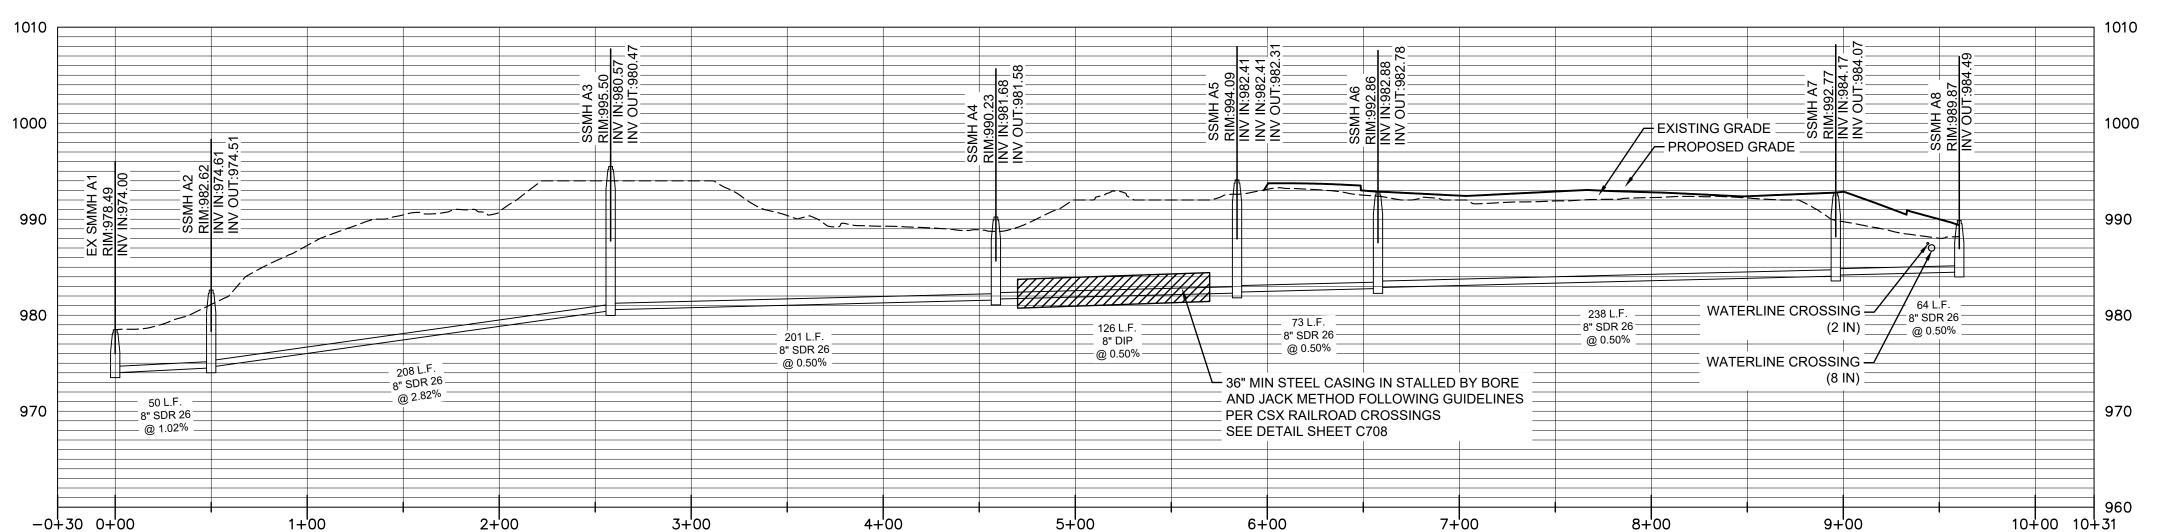

SANITARY SEWER LINE A
VERT 1"=10'
HORZ 1"=50'

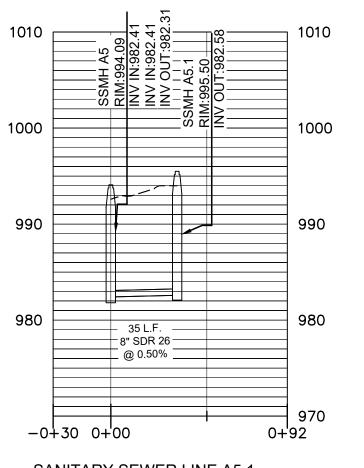

SANITARY SEWER LINE A5.1 VERT 1"=10'

HORZ 1"=50'

# **Sanitary Sewer Notes**

- 1. All wastewater pipe construction shown on these plans must conform to Fulton County Standards and Specifications, including Sanitary Sewer Regulations latest copy.
- 2. No sanitary sewer shall be accepted by the Town of Tyrone without an as-built drawing showing the horizontal and vertical alignment of the sewer system, the location of all manholes, sewer connections, piping materials, required easement limits and junctions, and property lines.
- 3. Contractor must field verify the location and elevation of all known and unknown underground utilities.
- 4. All temporary and permanent wastewater easements must be dressed and grassed to control erosion prior to acceptance. Trees shall not be planted in the permanent easement area, or within 10-feet of a Town of Tyrone sewer main.
- 5. As-built drawings and maintenance bond(s) must be submitted and are required prior to inspection and acceptance. Digital as-built will be required. Note that digital as-builts will be required at the completion of
- 6. Neoprene couplings with stainless steel bands and shear rings are required for joining different types of sanitary sewer pipes.
- 7. Pools shall not drain into wastewater pipe systems. Pools shall drain into an approved individual onsite wastewater management system.
- 8. Low pressure air testing required for all wastewater pipe systems. This test must meet all requirements as outlined in UNI-B-06 or current revision. A Town of Tyrone Inspector must be present during testing.
- 9. Contractor shall field verify the locations and invert elevations of wastewater pipes for a connection to existing wastewater systems.
- 10. Contractor is to cut and remove the pipe only upon final approval by the Town of Tyrone Inspector.
- 11. All wastewater lines and laterals with less than one-foot of clearance to another utility line shall be constructed with a concrete saddle to maintain separation.
- 12. No fill shall be placed on a sanitary sewer easement without approval by the Director of PW. All sanitary manholes must extend to the ground surface.
- 13. For all projects utilizing individual onsite wastewater management systems design and provisions shall be in conformance with Fayette County Public Health Department regulations.
- 14. Eight-inches (8") or larger pipe lines shall be TV inspected. A virus free portable storage drive(USB Flash Drive) and written inspection log in compliance with NASSCO requirements and certified by a Georgia Registered Engineer or Registered Land Surveyor shall be provided when as-builts are submitted. All videos shall include PACP and MACP completed forms. A copy of the operator's current NASSCO certification shall be submitted.
- 15. USF 7635 Box required for wastewater cleanouts in paved area per Fulton County Standard Detail 709.
- 16. Compaction of the back fill of all trenches shall be compacted to at least 90% Standard Proctor density. Backfill material shall be free from roots, stumps, or other foreign debris, and shall be placed at or near optimum moisture content. Correction of any trench settlement within a year from the date of approval will be the responsibility of the contractor. Compaction of the back fill of all trenches located under pavement shall be compacted to at least 95% Standard Proctor density.
- 17. Sanitary sewer laterals should be marked with 4"x4"post with min. 4-feet above ground. The top 1' should be painted green. Each lateral is to be brought to the ground surface in accordance with Fulton County
- 18. All required off site easements shall be dedicated to Town of Tyrone prior to Utility permitting. All public on- site easements for other than single family residential projects that will be final platted shall be dedicated to Town of Tyrone prior to permit approval.
- 19. For residential projects where onsite sanitary sewer easements are to be dedicated to Town of Tyrone, the following applies: Sanitary sewer easement inside property line to be shown in final plat for recording.
- 20. For all projects containing PVC wastewater pipes, also include the following notes: (see attached condition for PVC).
  - Pipe shall be ASTM D3034, SDR26 in 14 foot laying lengths with elastomeric sealed joints in accordance with ASTM D3212.
  - b. Pipe bedding shall be #57, sharp, angular, crushed stone. Bedding shall extend a minimum of 4" below the pipe and extend to the top of the pipe. The bedding shall be compacted by "slicing with a flat shovel". The width of the ditch must be in accordance with OSHA Safety Standards.
  - c. Initial backfill: After bedding, complete initial backfill with #57 stone. If no rock is encountered, initial backfill shall extend to a height 611 above of the top of the pipe, otherwise initial backfill shall extend to 12" above the top of the pipe.

d. Fittings for lateral connections shall be 45° WYES and bends. Provide PVC pipe stoppers for each

- lateral. Provide special watertight connections at manholes and transitions to ductile iron pipe as recommended by the pipe manufacturer.e. After installation, a deflection test is required. Initial deflection shall be limited to 3% of the
- undeflected diameter. A second test shall be made at least 8 months after the installation but before final acceptance. At that time deflection shall be limited to 5% of the undeflected diameter. nanholes located within a paved area shall have concentric cone sections and flange down frames and
- 21. All manholes located within a paved area shall have concentric cone sections and flange down frames and covers. All manholes located within an unpaved area shall have eccentric cone sections with bolt down flange up frame and covers, or hinged cast in place lockable covers. All manholes located within a flood prone area shall have eccentric cone sections with bolt down gasketed flange up frame and covers. Raise top of manholes in landscape areas to 0.5-feet above grade.
- 22. Issuance of this permit does not in any way imply that wastewater taps for building permits will be issued. Contact the Department of Public Works, at (770) 487-4038 for further information.
- 23. Any changes to the sewer drawings must be approved by Town of Tyrone.
- 24. Notify Town of Tyrone Inspector 24-hours prior to construction.

INTEGRATE Science & Engineering





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	3.	ISSUED FOR PERMIT	5/5/23	JL
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	1.	ISSUED FOR REVIEW	5/20/22	JL
	Rev.	Rev. Description	Date	Αb
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2/9/22 LBW JLW

Project #: Design by: Review by:
1633.2101 JLW JLW

50' 25' 0' 50' 3. ISSUED FOR


SCALE: 1" = 50' 1. ISSUED FOR

FOR 74 SOUTH BUSINESS PARK

SEWER EXTENSION PLAN

DRAWING NO. C450



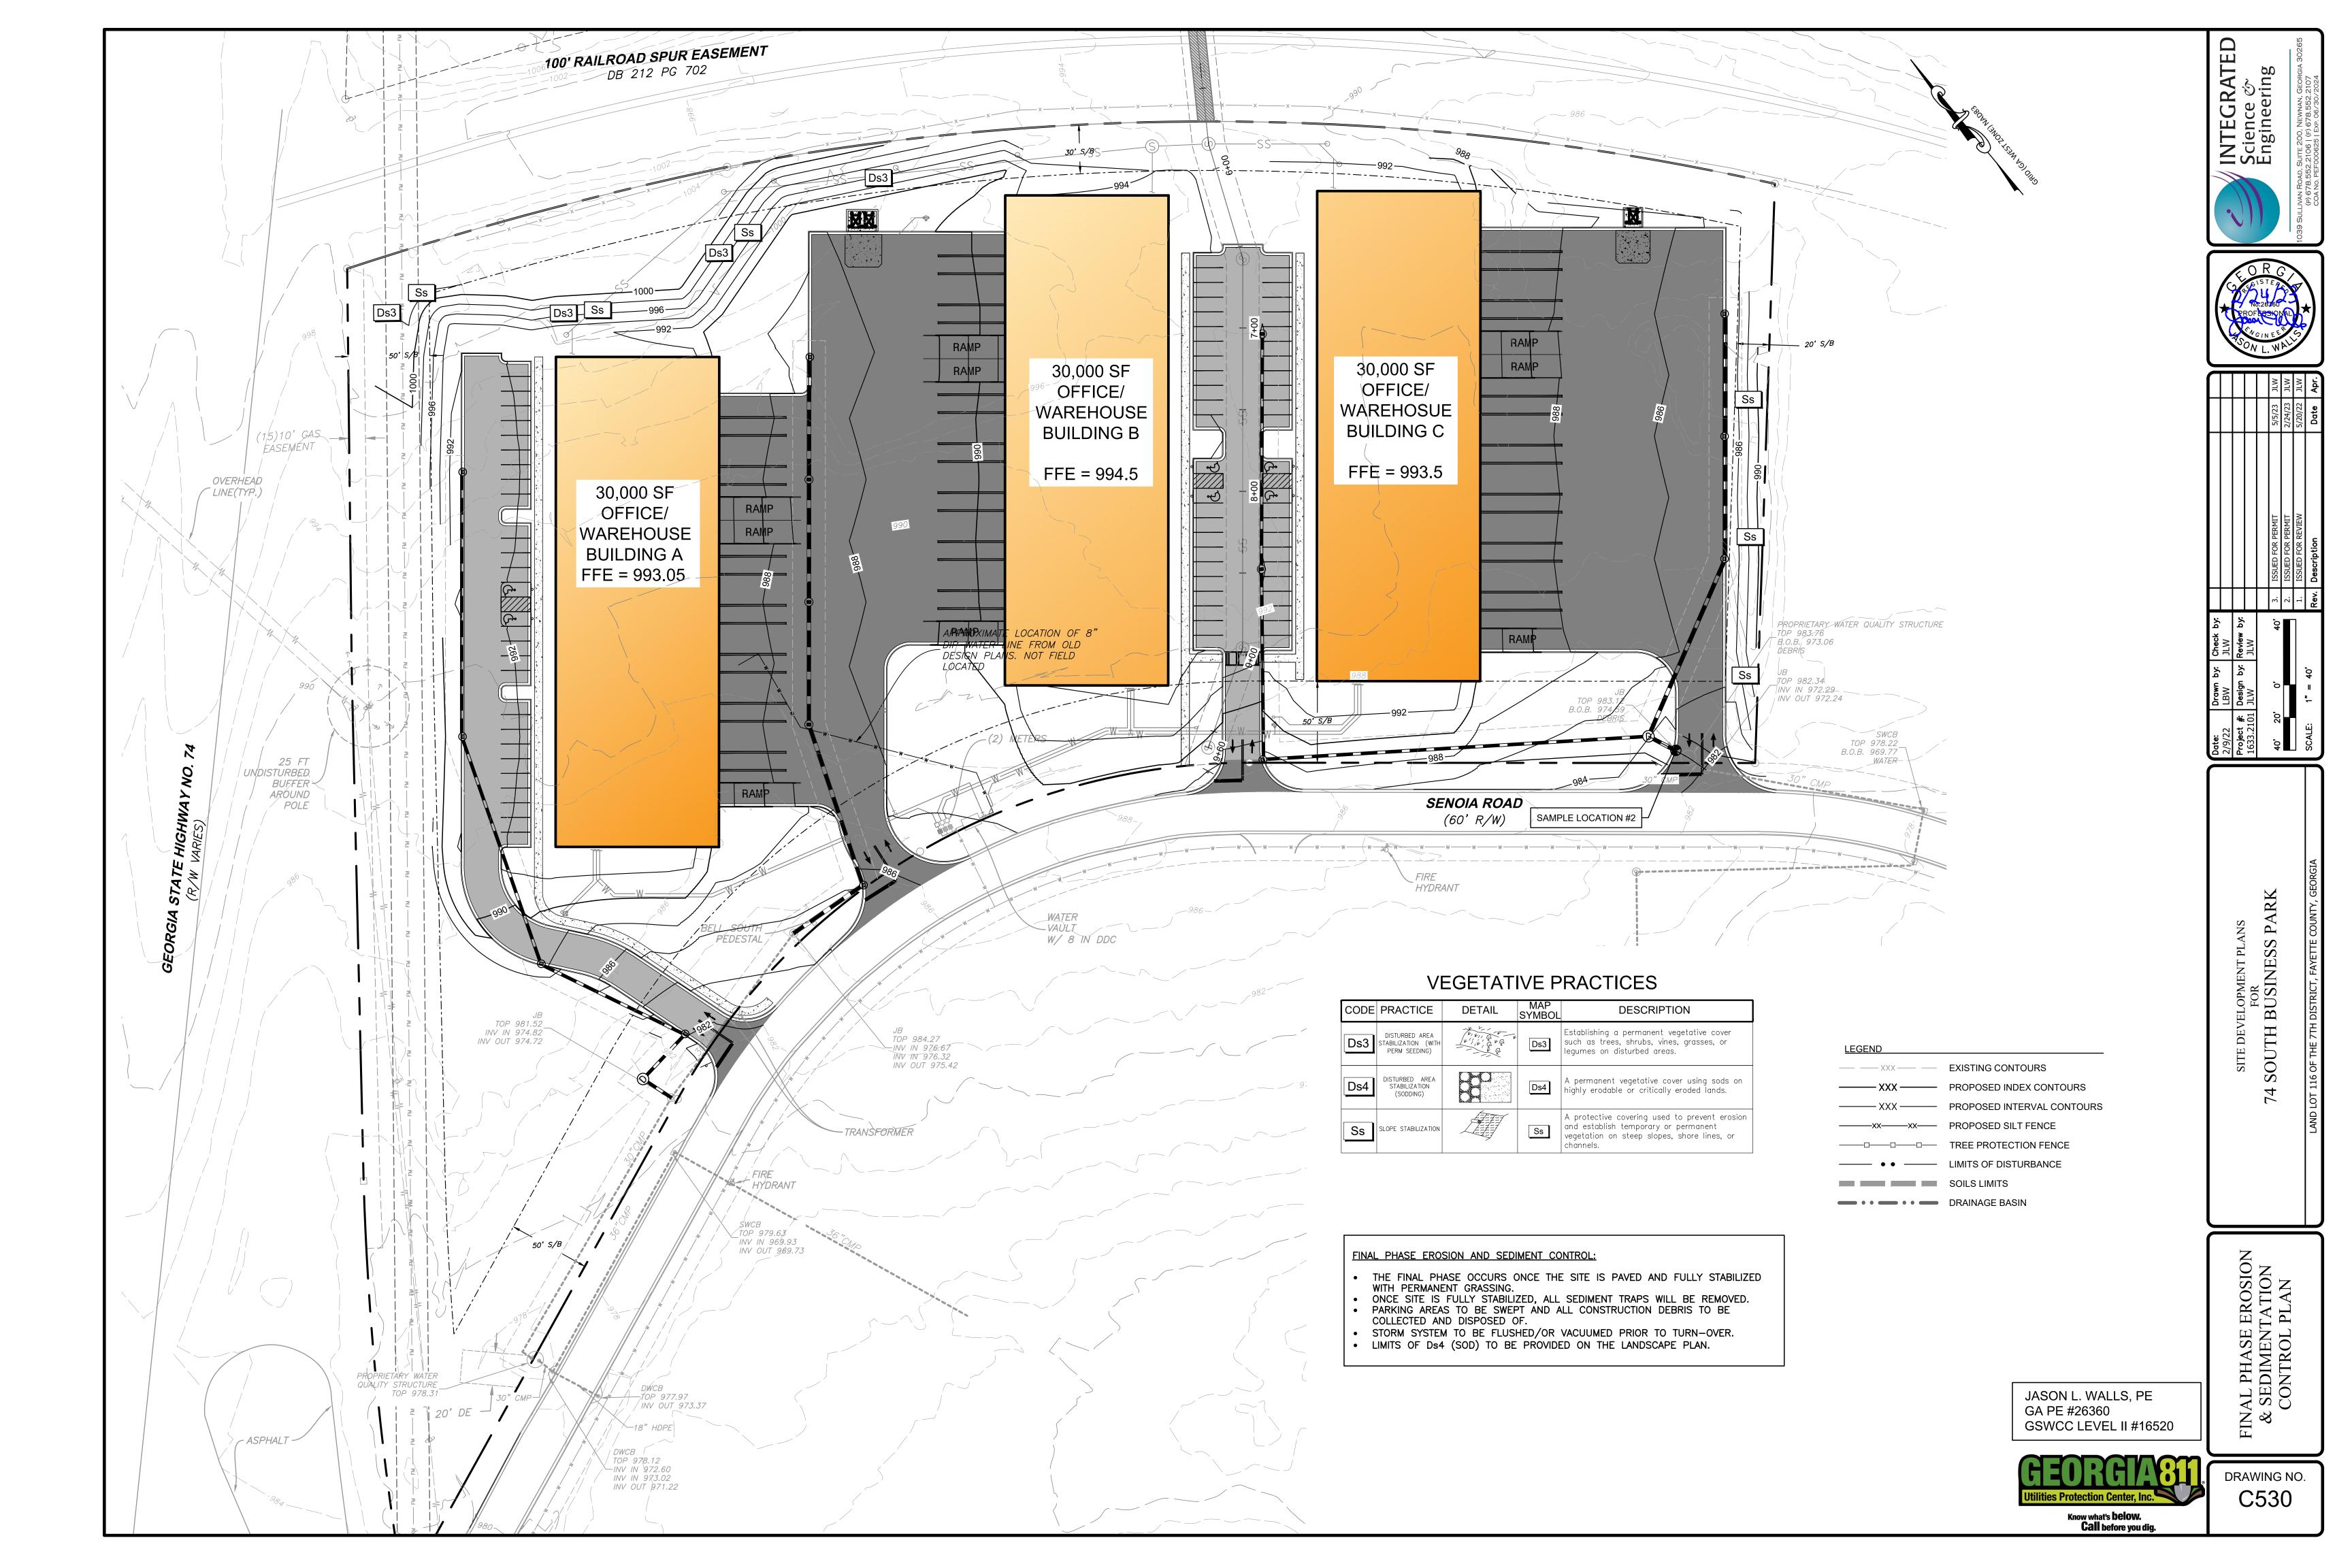

-EXP. JOINT 20' O.C.-

-AS INDICATED-

SECTION A

3000 PSI CONCRETE ----

CONCRETE SIDEWALK DETAIL

-USE EXPANSION JOINT MATERIAL IF CAST AGAINST BUILDING


- SUBGRADE TO BE COMPACTED TO 98% STANDARD PROCTOR

MEDIUM-DUTY PAVEMENT SECTION SCALE: N.T.S.

APPROVED FILL IN 6" COMPACTED LIFTS.

GRADE

SCALE: N.T.S.

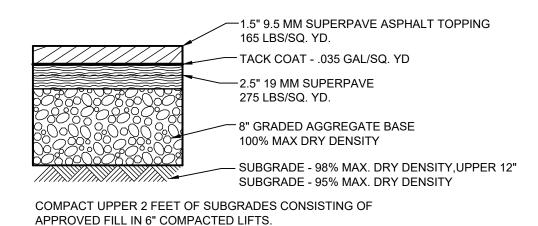

1 1/2" ASPHALTIC CONC. TOPPING —

COMPACTED BACKFILL

TRENCH WIDTH VARIES

100% STD. PROCTOR

HEAVY-DUTY PAVEMENT SECTION

- EXIST. PAVEMENT


SCALE: N.T.S.

PAVEMENT PATCH DETAIL

SCALE: N.T.S.


- 6X6 WWR IN TOP 1/3 6" 4000 PSI 6" GAB COMPACTED TO CONCRETE -98% STANDARD PROCTOR

HEAVY-DUTY CONCRETE PAVING DETAIL SCALE: N.T.S.

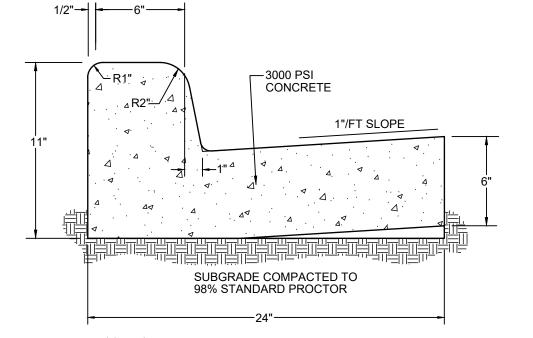

- 1. 1/2" PREFORMED EXPANSION JOINTS REQUIRED AT ALL STRUCTURES & CURB RETURNS.
- 2. MAXIMUM DISTANCE BETWEEN EXPANSION JOINTS = 40.0'.
- 3. DISTANCE BETWEEN DUMMY JOINTS = 20'.
- 4. CONCRETE STRENGTH = 3000 PSI, SLUMP = 2", FINISH SHALL BE SMOOTHED & EVENED WITH A WOODEN FLOAT.
- 5. OTHER CURB & GUTTER SECTIONS WILL BE EVALUATED AS APPROPRIATE BY THE ENGINEER.


# STANDARD 24" CURB & GUTTER DETAIL SCALE: N.T.S.

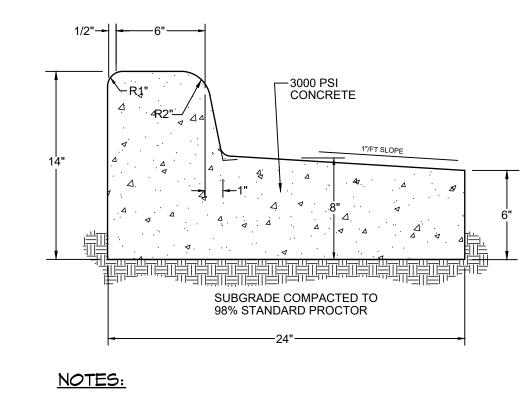

- 1. 1/2" PREFORMED EXPANSION JOINTS REQUIRED AT ALL STRUCTURES & CURB RETURNS.
- 2. MAXIMUM DISTANCE BETWEEN EXPANSION JOINTS = 40.0'.
- 3. DISTANCE BETWEEN DUMMY JOINTS = 20'.
- 4. CONCRETE STRENGTH = 3000 PSI, SLUMP = 2", FINISH SHALL BE SMOOTHED & EVENED WITH A WOODEN FLOAT.
- 5. OTHER CURB & GUTTER SECTIONS WILL BE EVALUATED AS APPROPRIATE BY THE ENGINEER.


# SPILLING 24" CURB & GUTTER DETAIL

# SCALE: N.T.S.

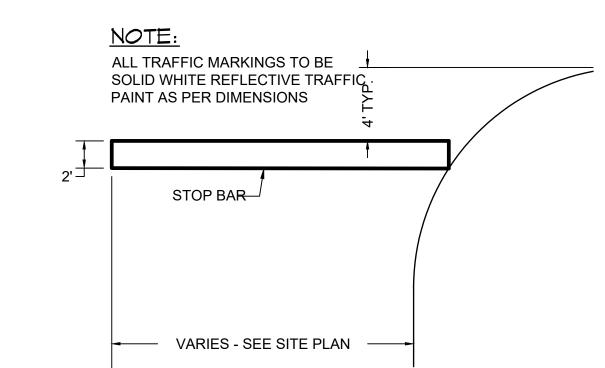

TYPICAL PAVEMENT MARKINGS SCALE: N.T.S.

# 2'-0"

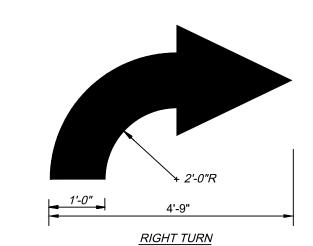


NOTE

1. WORDS AND ARROWS FOR DRIVEWAYS SHALL BE APPLIED ACCORDING TO REQUIREMENTS AS OUTLINED IN SECTION 3B-20 OF THE MANUAL ON UNIFORM TRAFFIC CONTROL DEVICES FOR STREETS AND HIGHWAYS.

<u>LEFT TURN</u>


2. ALL TRAFFIC FLOW ARROWS TO BE SOLID WHITE REFLECTIVE TRAFFIC PAINT OR MEET LOCAL REQUIREMENTS.


# PARKING LOT FLOW ARROWS SCALE: N.T.S.

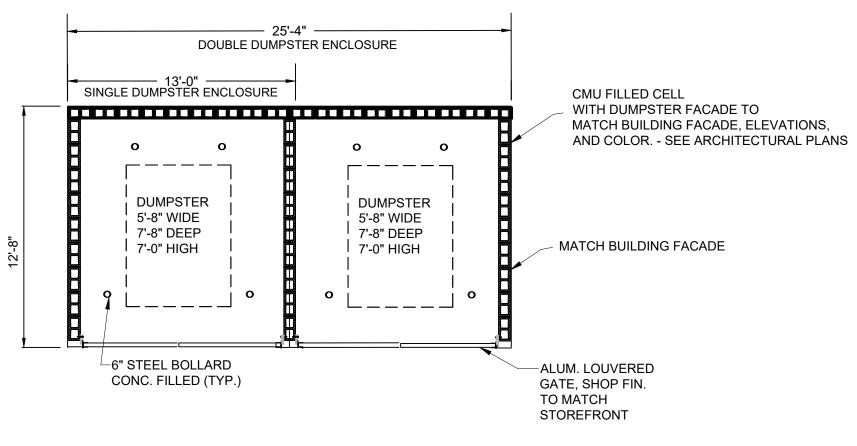


NOTE: DUMPSTERS TO BE SET ON 8" THICK CONCRETE PAD AT DIMENSIONS DETAILED ABOVE. 4,000 psi FIBER REINFORCED CONCRETE SHOULD BE USED. SLAB SHALL INCLUDE 12" TURN DOWN FOOTINGS AT WALL LOCATIONS.

DUMPSTER ENCLOSURE DETAIL SCALE: N.T.S.

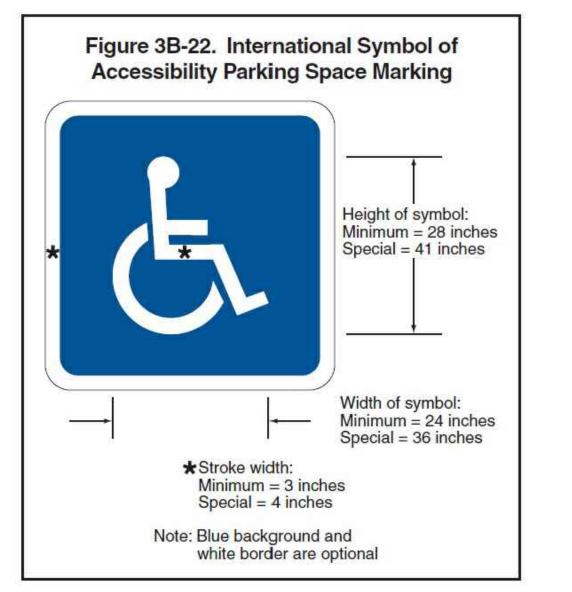

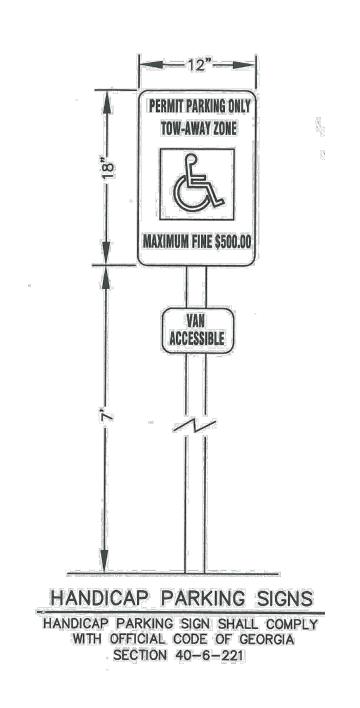

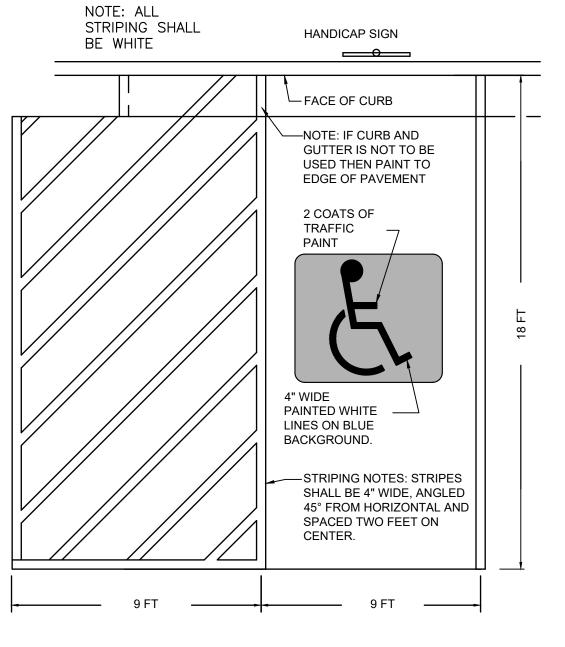

\_ 8" CONCRETE SLAB

— SAWCUT (TYP.)

UNDISTURBED EARTH (TYP.)

3,000 PSI MIN

HANDICAP STRIPING DETAIL SCALE: N.T.S.

Know what's **below**. **Call** before you dig.

DRAWING NO. C700

CONSTRUCTION DETAILS

VELOPMENT PLANS FOR I BUSINESS PARK


SOUTH


INTEGRATI Science ぐ Engineering


HANDICAP PAVEMENT MARKING DETAIL

SCALE: N.T.S.


HANDICAP STRIPING DETAIL SCALE: N.T.S.

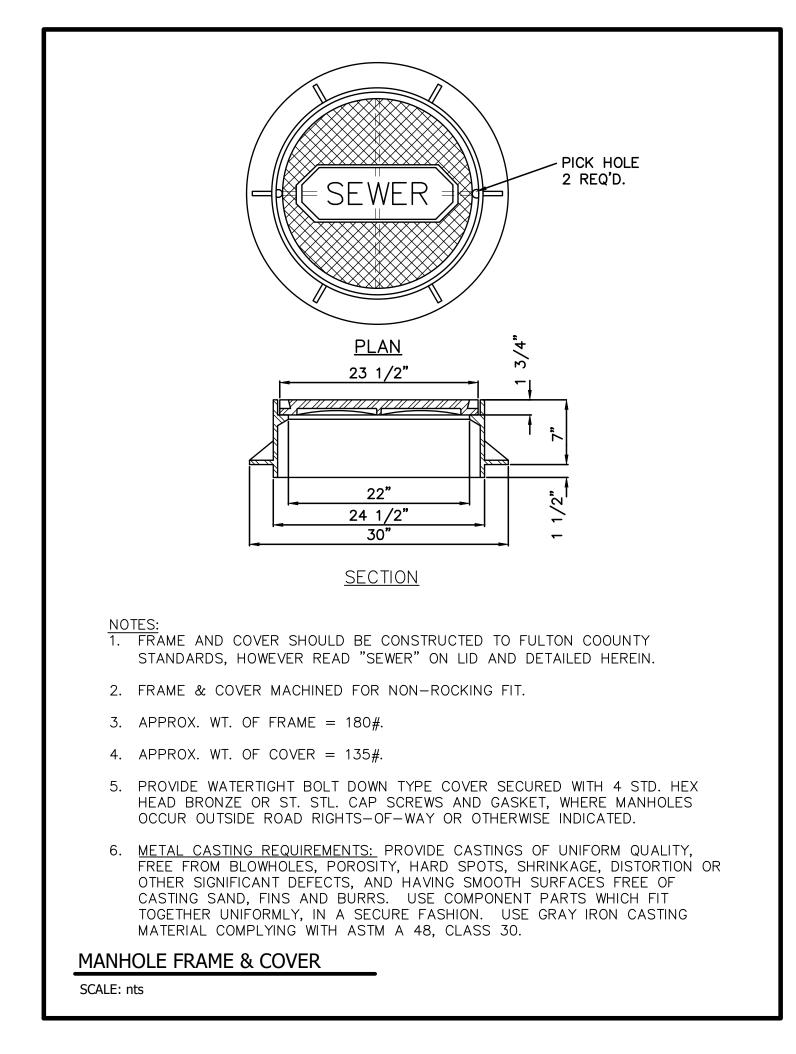

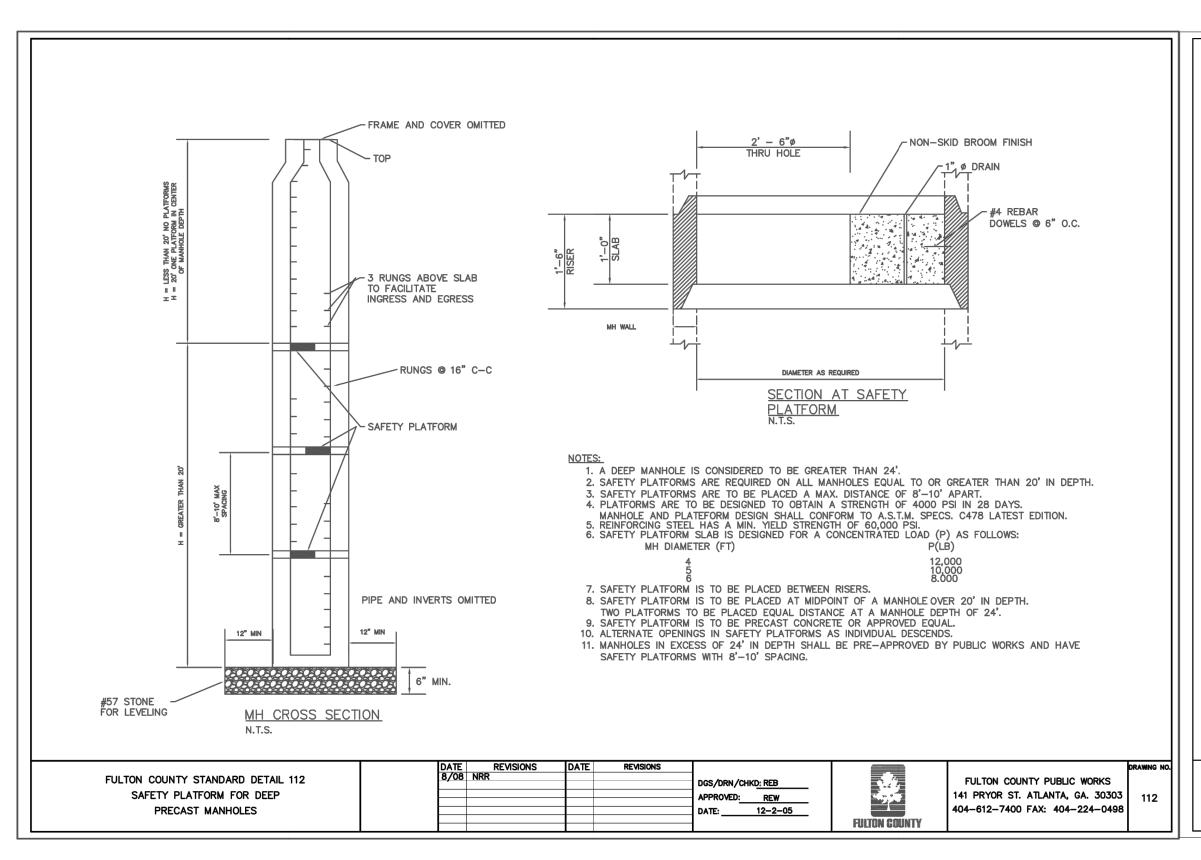

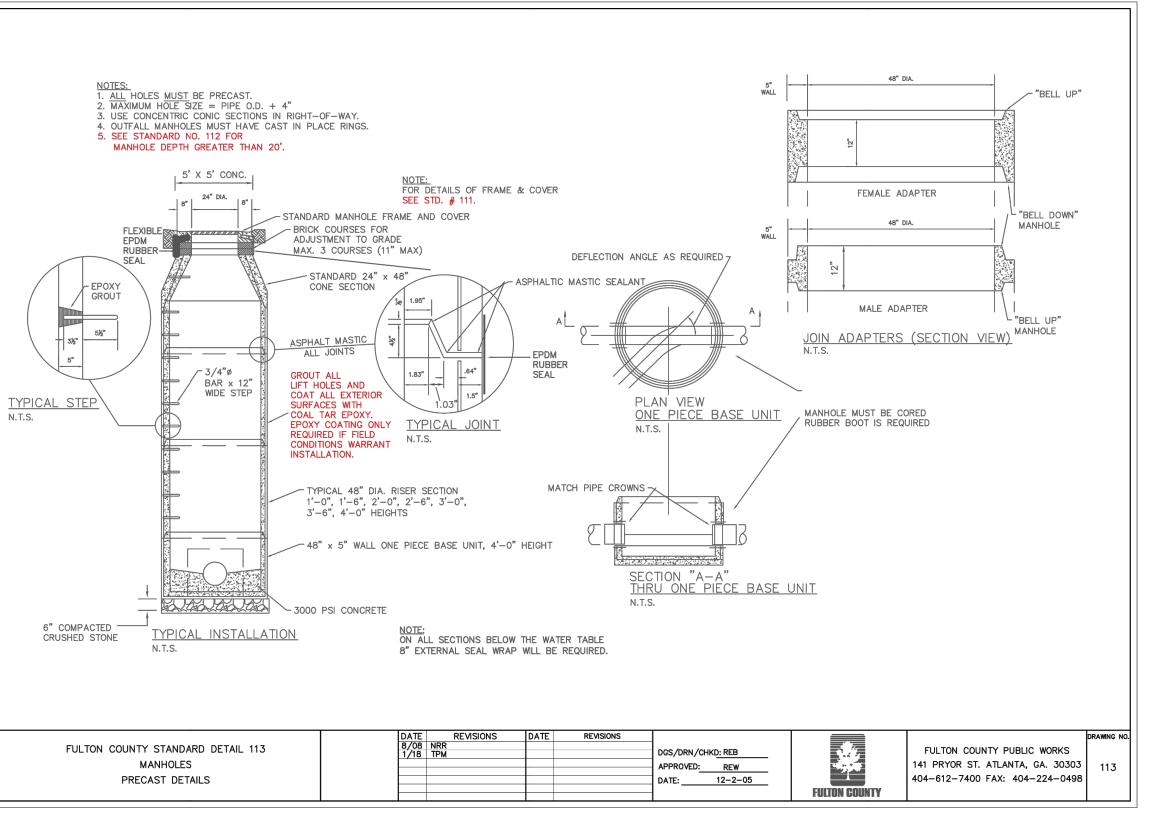



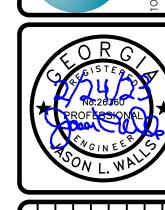


-	:	C			
5/20/22	ISSUED FOR REVIEW	1.			
2/24/23	ISSUED FOR PERMIT	2.			
2/2/53	ISSUED FOR PERMIT	3.			
			JLW	01 JLW	01
			Review by:	# Design by: Review by:	#
			JLW	LBW	
			Check by:	Drawn by: Check by:	

VELOPMENT PLANS FOR I BUSINESS PARK SOUTH


CONSTRUCTION DETAILS



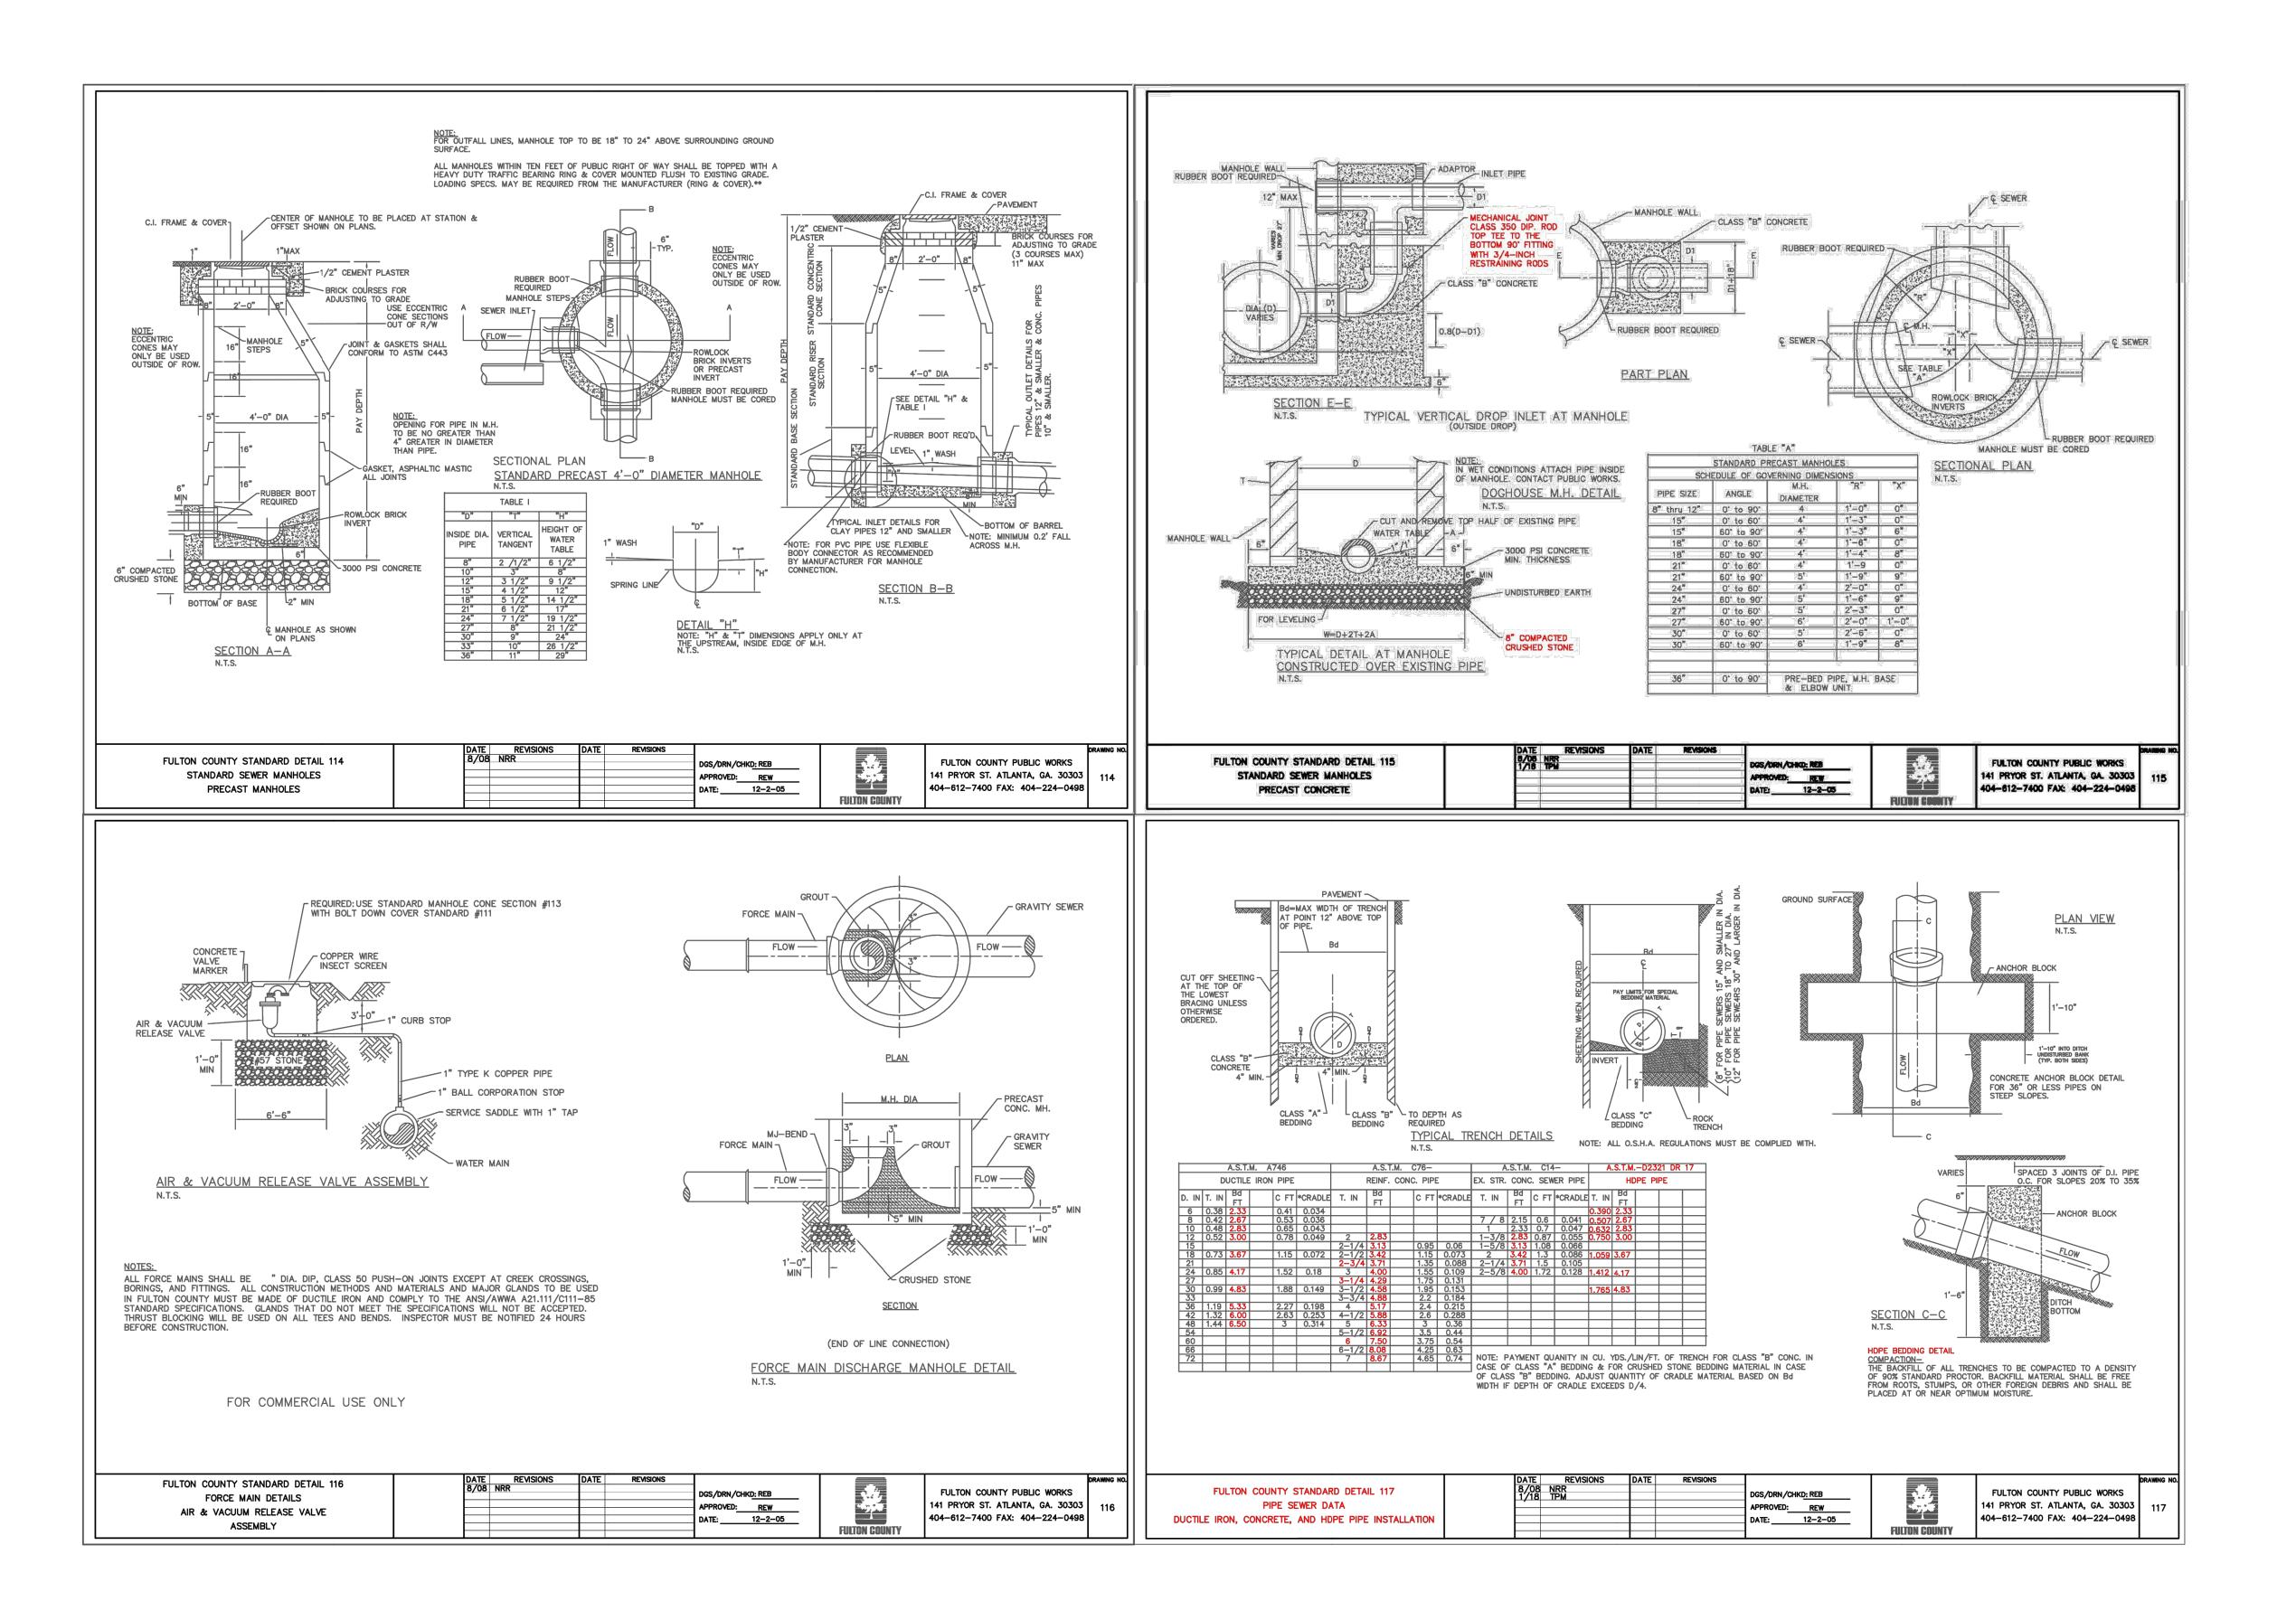

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Science &
Engineering
Scill Bullivan Road, Suite 200, Newnan, Georgia 30265



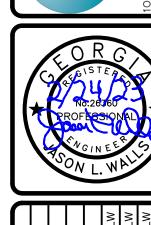

1							
	Date:	Drawn by:	Drawn by: Check by:				
	2/9/22	LBW	JLW				
	Project #:	Project #:   Design by:  Review by:	Review by:				
	1633.2101 JLW	JLW	JLW				
				3.	ISSUED FOR PERMIT	5/5/23	
				2.	ISSUED FOR PERMIT	2/24/23	
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SITE DEVELOPMENT PLANS FOR 74 SOUTH BUSINESS PARK

> CONSTRUCTION DETAILS

tilities Protection Center, Inc.

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