

LAND DEVELOPMENT APPLICATION

APPLIC	ANT A.C.E. Buildi	g Service Inc. (Kyle Reuter)TELEPHONE 920-682-6105							
	2E10	C. Octhi-Ctroot	Manito			WI		54220	
MAILING	GADDRESS 3510	(Street)	(City)	WUC		(Stat	e)	(Zip)	-
	-	,	(Oity)				,		
PROPE	RTY OWNER Grov	wth Garage, LLC (Dave Kalista)			TEL	.EPHO	NE 920-90	5-2588	-
	N. 110	00 Lakoviow Dr	Kowan	noo		WI		54216	
MAILIN	GADDRESS N. 118	(Street)	Kewau (City)	nee		(Stat	e)	(Zip)	_
		(0.1.001)	(4)/			,	,	(-1)	
REQUE	ST FOR:	Comprehensive Plan Amendmen	nt	X	Conditi	ional U	se		
	X	Site/Architectural Plan Approval			Annexa				
	<u>· · · </u>	Subdivision Plat or CSM Review		X			rd of Appe	als	
		Zoning District Change			Other	00,000	a or Appo		
		-				V			
STATU	S OF APPLICANT:	Owner	Agent	В	uyer		Other		
	00	.d Ct				DE	MD		
	CT LOCATION 33r								_
PRESE	NT ZONING B-2 B	usiness District	RE	QUESTE	D ZONI	NG <u>N</u> /A	1		_
PROP	OSED LAND USE	No change in land use requested	- New 2,80	00 SF Pre	e-Engine	ered M	etal Buildir	ng	
PARCE	L #_053162408190	009; 0531624082007		ACI	REAGE_C).311			
LEGAL	DESCRIPTION All	of lots 19 & 20, Block 8 of the "Ch	as. Sayers	Subdivis	sion #4" (Volume	e 3, Plats,	Page 82, Manitowo	en
LLO/IL									
	NC	OTE: Attach a one-page written	descriptio	n of you	ır propo:	sal or i	request.		
		that he/she has familiarized himsel ersigned further hereby certifies the							
Signed	21	M Work			Date	2	/17/202	5	
Signed		y Owner)		-	Date_		111/202	J	_
		INCRUMENTAL SECTION							-
Fee Re	guired			Schedul	l <u>e</u>				
\$ 350 Comprehensive Plan Amendment				Applicat	ion Subm	ittal Dat	e		
\$ t/b/d \$ t/b/d	Site/Architectural P CSM Review (\$10 I	Date F		e(s) Paid					
Subdivision Plat (fee to be determined)						D-4-			_
\$ 350 \$ 350	Zoning District Cha Conditional Use	Ž		Plan(S)	Submittal	Date			_
\$ t/b/d \$ 350	Annexation Request Variance/Board of	st (State Processing Fees Apply) Appeals		Plan Co	mm Appe	arance	**		
\$ t/b/d	Other	. in the second							
¢ 550	TOTAL EL	EE DAID APPLICATION	DI ANG & EI	EE RECEI	VED BV				



February 21, 2025

City of Two Rivers **Building Inspections Office** 1717 E Park Street Two Rivers, WI 54241

Re: Proposed Building for Growth Garage, LLC

Attention: Zoning Administrator

A.C.E Building Service, Inc. proposes to construct a new 2,800 square foot commercial facility on the northwest corner lot at the intersections of 33rd Street and State HWY 42 in the City of Two Rivers, Wisconsin. The building will consist of a pre-engineered steel framed structure with architectural metal accent panels, aluminum storefront framing, and contrasting building colors to create visual interest as depicted in the conceptual renderings.

Due to the size of the lot, the building will see asphalt paving placed on all sides with vegetative buffers on the north, east, and south sides of the building. To accommodate safe flow of traffic, it is requested that a variance for the 5' vegetation side yard requirement as noted in Section 11-1-11C(15) is granted. The plans indicate a concrete curb and gutter section installed to prevent stormwater runoff from entering the adjacent property. Traffic will enter the property from the existing driveway approach on 33rd Street, and proceed in a one-way directional manner around the building to the parking area on the north side of the property. When exiting, the vehicles will continue in a oneway directional manner around the west side of the building and exit the property via the same driveway approach on 33rd Street.

There are (8) parking stalls and (1) van accessible ADA parking stall proposed for the project. Site constraints prevent additional parking. The initial use of the building is planned to be a private gym. Based on code section 10-1-13 of the Municipal Code, we assume the parking stall requirement to be 1 per 300 square feet of usable space or 9.3 spaces. Due to the constraints of the site, we request approval of (9) total parking spaces in lieu of (10).

There shall be landscape beds installed along portions of the south and east faces of the building that will contain shrubs, perennial plantings, and stone mulch. The remainder of the east, north, and west faces of the building will include an 18" wide stone mulch bed at the building perimeter. Downspouts will be connected to new storm sewer which will connect to the existing storm sewer in HWY 42 right-of-way.

The building will be equipped with wall pack exterior lighting on the north and west building elevations. These fixtures will be selected to direct light downward so as to not directly illuminate neighboring properties. Decorative wall sconce light fixtures will be installed on the south and east elevations of the building to provide both illumination and aesthetic value.

Construction is expected to begin in spring of 2025 and completed late summer / early fall of 2025. If there are any questions pertaining to the proposed project, please contact me.

Respectfully submitted,

Christopher Herzog President A.C.E. Building Service, Inc.

3510 S. 26th Street Manitowoc, WI 54220 | 920.682.6105 | www.acebuildingservice.com



Manitowoc County Parcel Viewer



Author: Public Date Printed: 2/24/2025



The burden for determining fitness for use rests entirely upon the user of this website. Manitowoc County and its co-producers will not be liable in any way for accuracy of the data and they assume no responsibility for direct, indirect, consequential, or other damages.

CONDITIONAL USE PERMIT City of Two Rivers

Document Number

Permit No. 2025-02

Before the City Council of the City of Two Rivers, Manitowoc County, Wisconsin, regarding the premises at $\underline{1012} - \underline{33^{rd}}$ Street in the City of Two Rivers, Manitowoc County, State of Wisconsin, further described as:

CHAS SAYER`S SUB 4 LOT 19 BLK 8 & CHAS SAYER`S
SUB 4 LOT 20 BLK 8
Inspections Department
City of Two Rivers

Inspections Department City of Two Rivers PO Box 87 Two Rivers, WI 54241-0087

Parcel ID Number: 053-162-408-200.07 & 053-

162-408-190.09

Zoning Classification of the Premises is: B-2 Business District/Conditional Use for operation of a warehouse. Mailing Address of the Premises Operator: N1188 Lakeview Drive, Kewaunee WI 54216

WHEREAS, the Zoning Code and Zoning District Map of the above named municipality, pursuant to State Statute, state that the premises may not be used for the purpose hereinafter described but that upon petition such use may be approved by the municipality as a Conditional Use in particular circumstances as defined by the standards in the Zoning Ordinance; and

Petition therefore having been made, and public hearing held thereon, and the City Council of the City of Two Rivers having determined that by reason of the nature, character and circumstances of the proposed use, and of the specific and contemporary conditions, permit of such use upon the terms and conditions hereinafter prescribed would be consistent with the requirements of the Zoning Ordinance.

Now, therefore, it is permitted, subject to compliance with the terms and conditions hereinafter stated, that the Premises may be used for the purpose of the operation of a warehouse.

Permitted by action of the City Council of the City of Two Rivers on February 3, 2025. Original filed in the office of the City Clerk of the City of Two Rivers, Wisconsin

The Conditions of this Permit are:

- 1. This Permit shall become effective upon the execution and recording by the Owner of the Premises as acceptance hereof.
- 2. This Permit is subject to the conditions herein and is subject to amendment and termination in accordance with the provisions of the Zoning Code of this Municipality.
- 3. The operation of the use permitted shall be in strict conformity to the approved conditions identified with this Petition for this Permit and such plans are incorporated herein by reference as if set forth in detail herein.
- 4. This Permit shall be void unless proper application, pursuant to the Building and Zoning Codes of this Municipality, for appropriate Building and Zoning Use Permits in conformity to this Permit, is made on or before April 7, 2027.
- 5. Any substantial change to the use or site as the conditions permitted by the issuance of this Permit would require approval by the Plan Commission and City Council as an amendment to this Permit.
- 6. This Permit is specifically issued to owner David Kalista and shall lapse upon a change in ownership or tenancy of the subject premises or if the land use ceases operation for more than 12 months. This permit may be reissued only after proper application is made to the City as if this permit were being newly issued.

Conditions/Conditions of Operations:

- a. Hours of operation: 5AM 10PM. Seven days per week.
- b. Signage in accord with the City's Sign Code.

SIGNATURES OF PROPERTY OWNER(S) AND PERMITEE(S):

As Owner(s) of the Subject Property, I/we accept and understand the above-described conditions.


Printed Name:	Printed Name:		
STATE OF WISCONSIN MANITOWOC COUNTY			
Personally came before me thisday of and to be the person(s	, 2025, the above named s) who executed the foregoing instrument and acknowledge the		
same.	y who executed the foregoing motivation and down onedge the		
Notary Public			
Printed NameCounty, Wisconsir			
My commission expires:	' -		
Greg Buckley, City Manager	 Amanda Baryenbruch, City Clerk		
STATE OF WISCONSIN MANITOWOC COUNTY Personally, came before me thisday of2025, t person(s) who executed the foregoing instrument and ack	the above-named Greg Buckley and Amanda Baryenbruch known to be th nowledge the same.		
Printed Name: Notary Public, Manitowoc County, Wisconsin My commission expires:			
THIS INSTRUMENT WAS DRAFTED BY: Adam Taylor, Zoning Administrator			



PROPOSED WAREHOUSE

33RD ST. TWO RIVERS, WI 54241



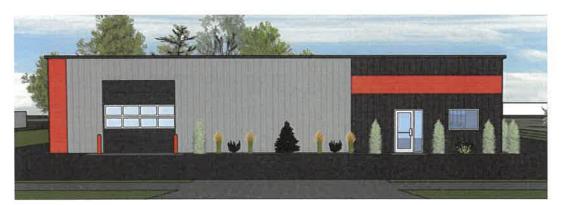





2,000 PSF PRESUMED (SAND, SILTY SAND, CLAYEY SAND, SILTY GRAVEL, CLAYEY GRAVEL)

IF ACTUAL CONDITIONS DIFFER FROM ABOVE, CONTACT ENGINEER.

FLOORS AND FOUNDATIONS - 3000 PSI MIN. IN 28 DAYS

EXTERIOR SLABS - 4000 PSI MIN IN 28 DAYS, AIR ENTRAINED 5-7%

BUTLER MANUFACTURING COMPANY 1540 GENESEE ST. KANSAS CITY, MO 64102 METAL BUILDING

GENERAL NOTES

1. ALL WORK SHALL COMPLY WITH ALL STATE AND LOCAL CODES

2. PROPOSED BUILDING AREA = 2.800 SO FT

3. PROPOSED BUILDING VOLUME - CU FT +/-

4. CLASS OF CONSTRUCTION - TYPE IIB

5. BUILDING OCCUPANCY - 5-1 STORAGE MODERATE HAZARD

6. BUILDING IS NOT PROTECTED BY AUTOMATIC SPRINKLER 7. ALL EXIT DOORS TO BE EQUIPPED WITH:

A. EXIT LIGHTS

PROPER EXIT HARDWARE
 LEVER HANDLES THAT DO NOT REQUIRE TWISTING
 OF THE WRIST

C. THRESHOLDS THAT DO NOT EXCEED 1/2"

8. FIRE EXTINGUISHERS TO BE PROVIDED IF REQUIRED BY CODE

9. SMOKE DETECTORS TO BE PROVIDED IF REQUIRED BY CODE

SHEET INDEX

TITLE SHEET
TS SHEET INDEX, TITLE SHEET, ENGINEERING/ DESIGNER INFORMATION

ARCHITECTURAL
A1.0 PROPOSED FLOOR PLAN, SECTIONS, DOOR/HARDWARE/FINISH SCHEDULES

A2.0 ELEVATIONS
S1.0 PROPOSED FOUNDATION PLAN, DETAILS
S1.1 ALTERNATE FOUNDATION PLAN, DETAILS


EXTERIOR LIGHTING EXTERIOR LIGHTING PLAN

CE BUILDING SERVICE

PROPOSED BUILDING GROWTH GARAGE, LLC 33RD ST. TWO RIVERS, WI 54241

THIS PLAN AND IDEAS EXPRESSED HERE-IN ARE THE PROPERTY OF A.C.E. BUILDING SERVICE, INC. THESE PLANS SHALL NOT BE SHARED BY VISUAL MEANS OR REPRODUCED WITHOUT THE CONSENT OF A.C.E. BUILDING SERVICE, INC.

SHEET INFORMATION A.C.E. JOB NO. 369/24 DATE: 11/15/202 DRAWN BY: KDR SCALE: SEE SHEET

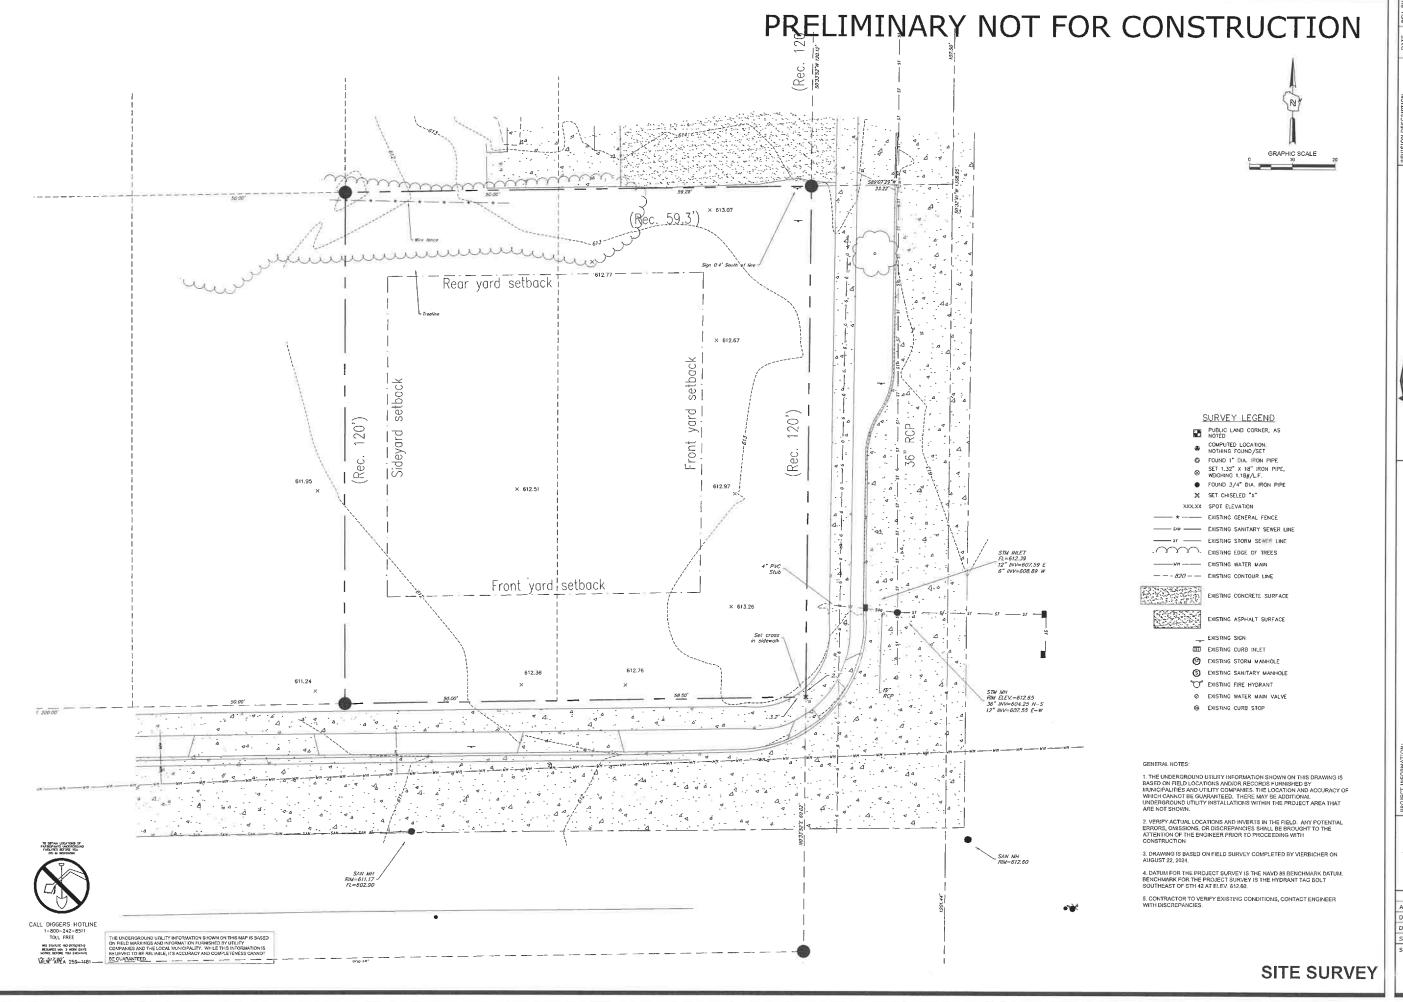


C.E. BUILDING SERVICE

GROWTH GARAGE,

THIS PLAN AND IDEAS EXPRESSED HERE-IN ARE THE PROPERTY OF A.C.E. BUILDING SERVICE, INC. THESE PLANS SHALL NOT BE SHARED BY VISUAL MEANS OR REPRODUCED WITHOUT THE CONSENT OF A.C.E. BUILDING SERVICE, INC.

260/23

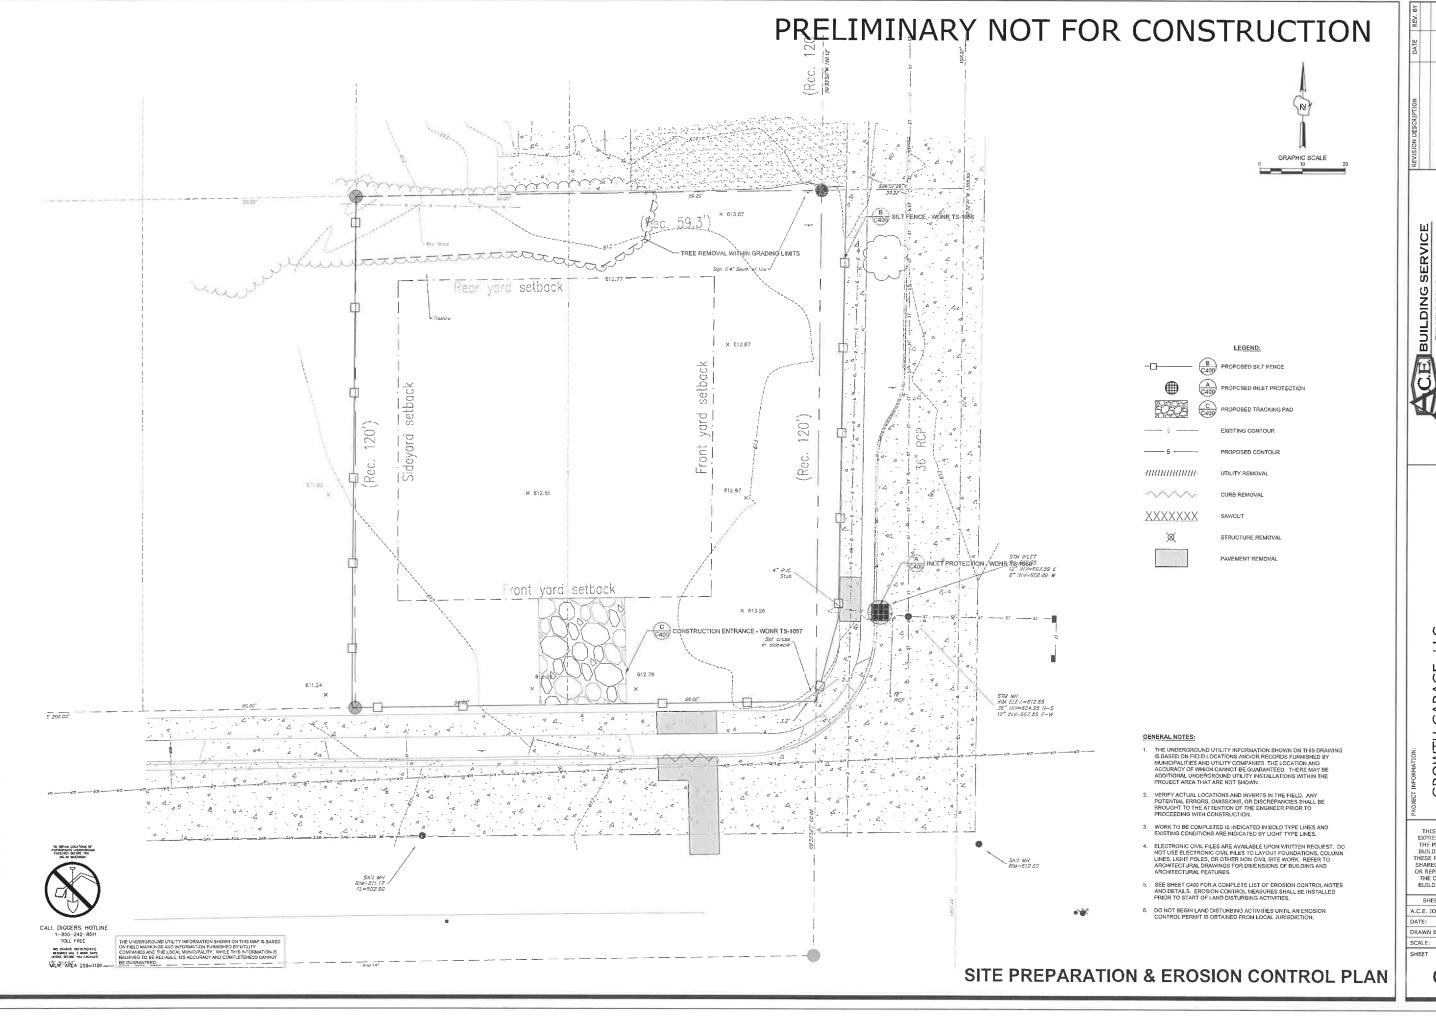

REVISION DESCRIPTION DATE REV. BY

SUILDING SERVICE
OUR REPUTATION IS OUR FOUNDATION
OUR REPUTATION IS OUR FOUNDATION
OF WARMAN ACTED III PRINCESSUATE COM

3510 SOUTH 26TH STREET - MANI PHONE: 920-682-6105 • WWW.A ERVISING PROFESSIONAL:

GROWTH GARAGE, LLC

THIS PLAN AND IDEAS XPRESSED HERE-IN ARE HE PROPERTY OF A.C.E. UILDING SERVICE, INC. ESE PLANS SHALL NOT BI HARED BY VISUAL MEANS REPRODUCED WITHOUT THE CONSENT OF A.C.E.

 SHEET INFORMATION


 A.C.E. JOB NO.
 260/23


 DATE:
 11/02/2025

 DRAWN BY:
 KJB

 SCALE:
 1" = 30'

PRELIMINARY NOT FOR CONSTRUCTION

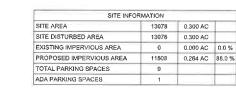

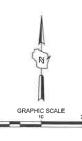

LEGEND:









GENERAL NOTES:


- AND CURB AND GUTTER SHALL BE COMPLETED PER MUNICIPAL AND/OR COUNTY REQUIREMENTS AND STANDARDS.


SITE DIMENSION PLAN

CE BUILDING SERVICE

GARAGE, GROWTH

A.C.É. JOB NO. DRAWN BY: SCALE:

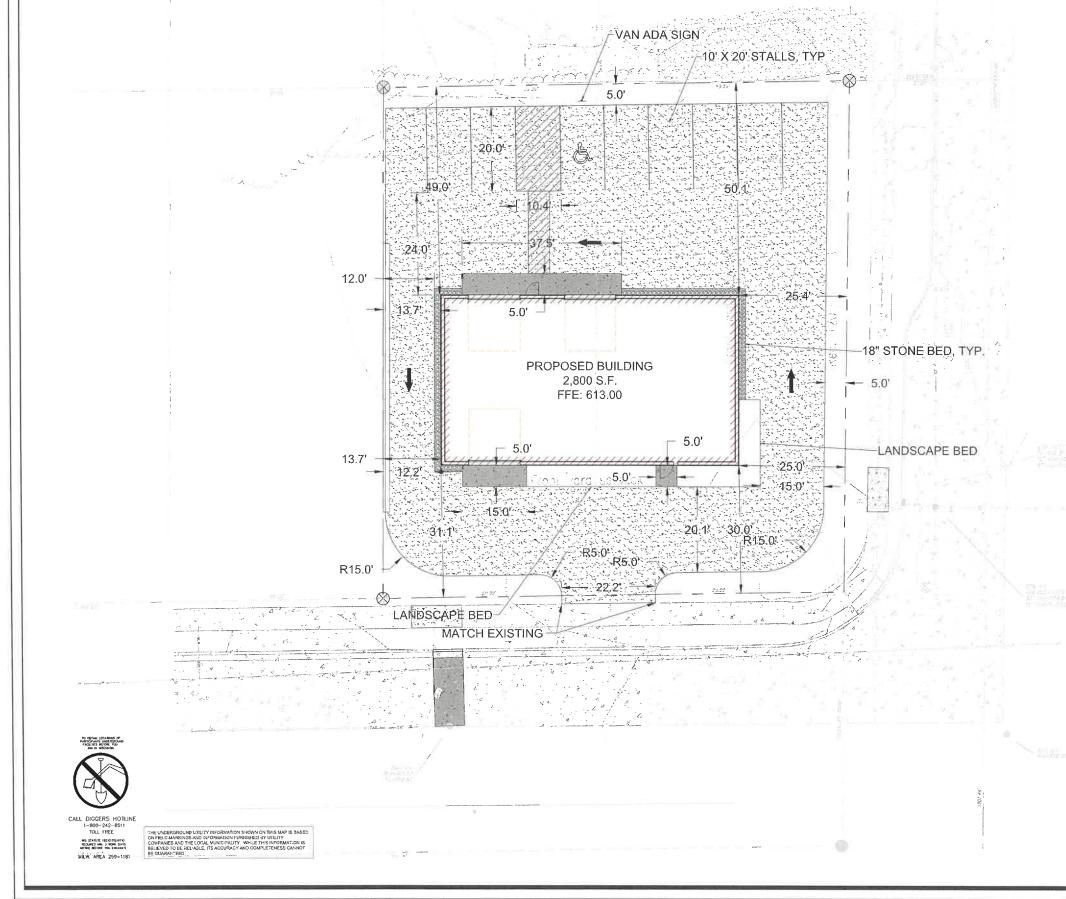

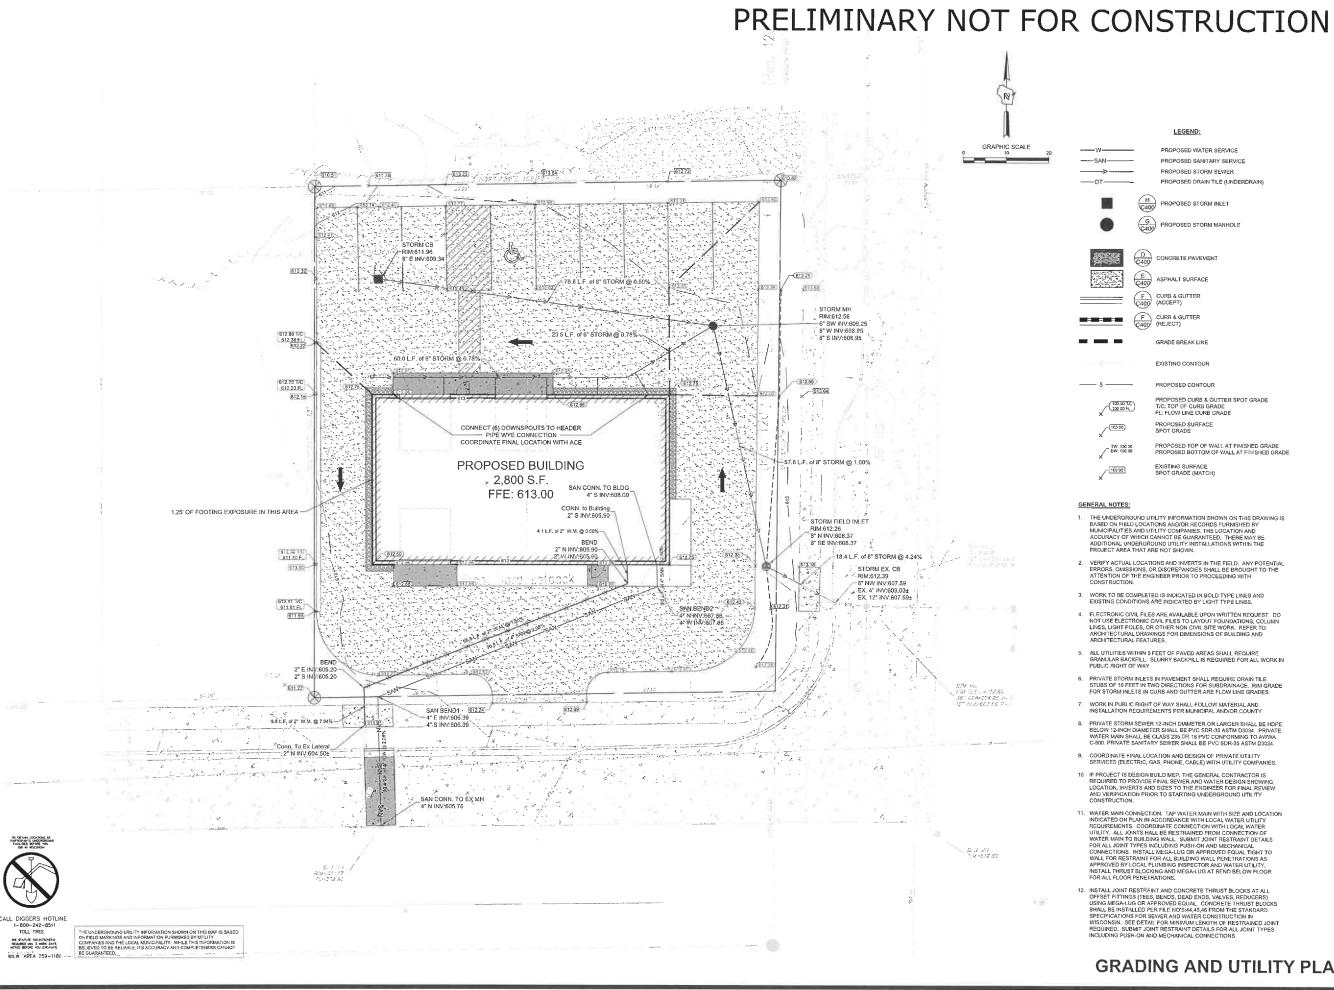



PROPOSED SANITARY SERVICE PROPOSED STORM SEWER PROPOSED DRAIN TILE (UNDERDRAIN)

H PROPOSED STORM INLET G PROPOSED STORM MANHOLE

C400 (REJECT)

- 2. VERIFY ACTUAL LOCATIONS AND INVERTS IN THE FIELD. ANY POTENTIAL VEIGHT ANY POLECTIONS AND INVERTISING THE FIELD. ANY POTENTIA ERRORS, OMISSIONS, OR DISCREPANCIES SHALL BE BROUGHT TO THE ATTENTION OF THE ENGINEER PRIOR TO PROCEEDING WITH CONSTRUCTION.
- ELECTRONIC CIVIL FILES ARE AVAILABLE UPON WRITTEN REQUEST. DO NOT USE ELECTRONIC CIVIL FILES TO LAYOUT FOUNDATIONS, COLLIMN LINES, USHT POLES, OR OTHER NON CIVIL SITE WORK, REFER TO ARCHITECTURAL DRAWINGS FOR DIMENSIONS OF BUILDING AND ARCHITECTURAL EXTRESS.
- STUBS OF 10 FEET IN TWO DIRECTIONS FOR SUBDRAINAGE. RIM GRADE FOR STORM INLETS IN CURB AND GUTTER ARE FLOW LINE GRADES.

- 10. IF PROJECT IS DESIGN BUILD MEP, THE GENERAL CONTRACTOR IS REQUIRED TO PROVIDE FINAL SEWER AND WATER DESIGN SHOWING LOCATION, INVERTS AND SIZES TO THE REGINERE FOR FINAL REVIEW AND VERIFICATION PRIOR TO STARTING UNDERGROUND UTILITY CONSTRUCTION.
- WATER MAIN CONNECTION. 1AP WATER MAIN WITH SIZE AND LOCATION INDICATED ON PLANI HA CCORDANCE WITH LOCAL WATER UTILITY REQUIREMENTS. COORDINATE CONNECTION WITH LOCAL WATER UTILITY. ALL JOINTS HALL BE RESTRAINED FROM CONNECTION OF WATER MAIN TO BUILDING WALL. SUBMIT JOINT RESTRAINT DETAILS FOR ALL JOINT IT PERS INCLUDING PUSH-O HAD NO MECHANICAL CONNECTIONS. INSTALL MEGA-LUG OR APPROVED EQUAL TIGHT TO WALL FOR RESTRAINT FOR ALL BUILDING WALL PENTERATIONS AS APPROVED BY LOCAL PLUMBING INSPECTOR AND WATER UTILITY, INSTALL THRUST BLOCKING AND MEGA-LUG AT BEND BELOW FLOOR FOR ALL GOT PENETRATIONS.
- INSTALL JOINT RESIMENT AND CONCRETE THRUST BLOCKS AT ALL OFFSET HITTINGS (TIES, BENDS, DEAD ENDS, VALVES, REDUCERS) USING MEGA-LUG OR APPROVED EQUAL. CONCRETE THRUST BLOCKS SHALL BE INSTALLED PER FILE NO SAH, 45, 46 FROM THE STANDARD SHALL BE INSTALLED PER FILE NO SAH, 45, 46 FROM THE STANDARD SHALL BE INSTALLED PER FILE NO SAH, 45, 46 FROM THE STANDARD SHALL BE INSTALLED PER FILE OF SHALL BE INSTALLED PER FILE OF SHALL BE INSTALLED FOR THE SHALL BE

GRADING AND UTILITY PLAN


SERVICE CE BUILDING

GARAGE,

GROWTH

THIS PLAN AND IDEAS EXPRESSED HERE-IN ARE THE PROPERTY OF A.C.E. BUILDING SERVICE, INC. HESE PLANS SHALL NOT B

SHEET INFORMATION A.C.E. JOB NO. 260/23 11/02/2025 DRAWN BY: KJB SCALE:

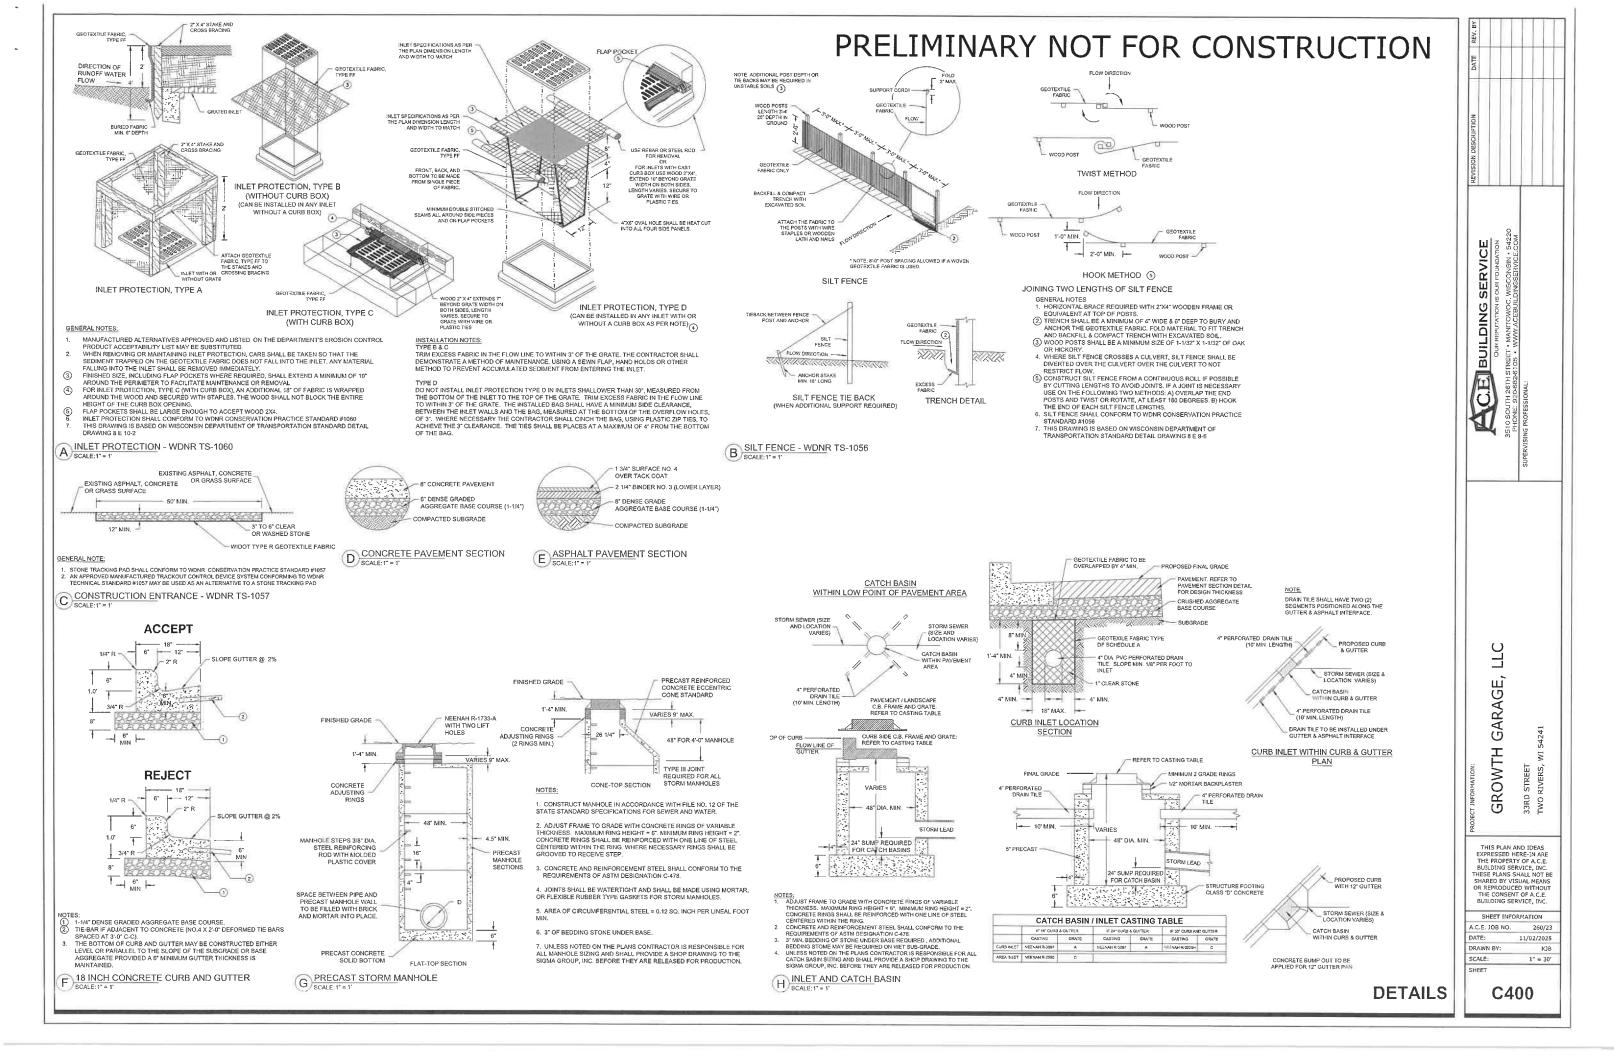

GENERAL

- 1. EXISTING UTILITIES ARE SHOWN FOR INFORMATIONAL PURPOSES ONLY, AND NO RESPONSIBILITY IS ASSUMED BY THE OWNER OR NEER FOR THEIR ACCURACY OR COMPLETENESS.
- CONTRACTOR IS RESPONSIBLE FOR MAKING THEIR OWN DETERMINATION AS TO THE TYPE AND LOCATION OF LINDERGROUNI CONTRACTOR IS RESPONSIBLE FOR MAKING THEIR OWN DETERMINATION AS TO THE TYPE. AND LOCATION OF UNDERGROUND UTILITIES AS MAY BE NECESSARY TO AVOID DAMAGE THERETO, CONTRACTOR SHALL HAVE SITE MARKED BY DIGGETS HOTLINE AND SHALL HAVE FIRM ARKED BY LOGGETS HOTLINE AND SHALL HAVE PRIVATE UTILITIES MARKED BY A PRIVATE UTILITY LOCATOR PRIOR TO CONSTRUCTION. CONTRACTOR SHALL VERIFY ALL ELEVATIONS, LOCATIONS, AND SIZES OF EXISTING UTILITIES AND SHALL CHECK ALL UTILITY CROSSINGS AND PROPOSED CONNECTIONS FOR CONFLICTS DISCREPANCIES PRIOR TO INITIATING CONSTRUCTION. REPORT ANY CONFLICTS OR DISCREPANCIES TO THE ENGINEER SO REDESIGN MAY OCCUR IF NEEDED.
- 3. LENGTHS OF ALL UTILITIES ARE TO CENTER OF STRUCTURES OR FITTINGS AND MAY VARY SLIGHTLY FROM PLANS. LENGTHS SHALL BE VERIFIED IN THE FIELD BY THE CONTRACTOR.

SITE CLEARING:

- 1. EXCEPT FOR STRIPPED TOPSOIL OR OTHER MATERIALS INDICATED TO REMAIN ON OWNER'S PROPERTY, CLEARED MATERIALS SHALL BECOME CONTRACTOR'S PROPERTY AND SHALL BE REMOVED FROM PROJECT SITE
- 2. MINIMIZE INTERFERENCE WITH ADJOINING ROADS, STREETS, WALKS, AND OTHER ADJACENT OCCUPIED OR USED FACILITIES DURING SITE-CLEARING OPERATIONS.
- 3. SALVABLE IMPROVEMENTS: CAREFULLY REMOVE ITEMS INDICATED TO BE SALVAGED AND STORE ON OWNER'S PREMISES WHERE INDICATED.
- 4. UTILITY LOCATOR SERVICE: NOTIFY UTILITY LOCATOR SERVICE FOR AREA WHERE PROJECT IS LOCATED BEFORE SITE CLEARING.
- DO NOT COMMENCE SITE CLEARING OPERATIONS UNTIL TEMPORARY EROSION AND SEDIMENTATION CONTROL MEASURES ARE IN PLACE.
- 6. PROTECT AND MAINTAIN BENCHMARKS AND SURVEY CONTROL POINTS FROM DISTURBANCE DURING CONSTRUCTION
- 7. LOCATE AND CLEARLY FLAG TREES AND VEGETATION TO REMAIN OR TO BE RELOCATED
- 8 PROTECT EXISTING SITE IMPROVEMENTS TO REMAIN FROM DAMAGE DURING CONSTRUCTION: RESTORE DAMAGED IMPROVEMENTS TO THEIR ORIGINAL CONDITION, AS ACCEPTABLE TO OWNER
- 9. LOCATE, IDENTIFY, DISCONNECT, AND SEAL OR CAP OFF UTILITIES INDICATED TO BE REMOVED; ARRANGE WITH UTILITY COMPANIES
- 10. EXISTING UTILITIES: DO NOT INTERRUPT UTILITIES SERVING FACILITIES OCCUPIED BY OWNER OR OTHERS UNLESS PERMITTED BY THE OWNER AND THEN ONLY AFTER ARRANGING TO PROVIDE TEMPORARY UTILITY SERVICES.
- 11, FILL DEPRESSIONS CAUSED BY CLEARING AND GRUBBING OPERATIONS WITH SATISFACTORY SOIL MATERIAL UNLESS FURTHEI EXCAVATION OR EARTHWORK IS INDICATED; PLACE FILL MATERIAL IN HORIZONTAL LAYERS NOT EXCEEDING A LOOSE DEPTH OF 8 7, INCHES, AND COMPACT EACH LAYER TO A DENSITY EQUAL TO ADJACENT ORIGINAL GROUND.
- 12. REMOVE SOD AND GRASS BEFORE STRIPPING TOPSOIL
- 13. STRIP TOPSOIL TO WHATEVER DEPTHS ARE ENCOUNTERED IN A MANNER TO PREVENT INTERMINGLING WITH UNDERLYING SUBSOIL OR OTHER WASTE MATERIALS.
- 14. STOCKPILE TOPSOIL MATERIALS AWAY FROM EDGE OF EXCAVATIONS WITHOUT INTERMIXING WITH SUBSOIL. GRADE AND SHAPE STOCKPILES TO DRAIN SURFACE WATER. COVER TO PREVENT WINDBLOWN DUST.
- 15. REMOVE EXISTING ABOVE- AND BELOW-GRADE IMPROVEMENTS AS INDICATED AND AS NECESSARY TO FACILITATE NEW
- 16. SAWCUT ALL PAVEMENTS FULL DEPTH PRIOR TO REMOVAL; SAWCUTS SHALL BE IN STRAIGHT LINES PERPENDICULAR AND/OR PARALLEL TO EXISTING PAVEMENT JOINTS AND PAVEMENT EDGES.
- 17 REMOVE SURPLUS SOIL MATERIAL, UNSUITABLE TOPSOIL, OBSTRUCTIONS, DEMOLISHED MATERIALS, AND WASTE MATERIALS 10 NCLUDING TRASH AND DEBRIS, AND LEGALLY DISPOSE OF THEM OFF OWNER'S PROPERTY.
- 18. SEPARATE RECYCLABLE MATERIALS PRODUCED DURING SITE CLEARING FROM OTHER NONRECYCLABLE MATERIALS. STORE OR STOCKPILE WITHOUT INTERMIXING WITH OTHER MATERIALS AND TRANSPORT THEM TO RECYCLING FACILITIES.

SITE WATER SERVICE:

- 1. COMPLY WITH STANDARDS OF STATE PLUMBING CODE (SPS CH. 382, 384), LOCAL WATER UTILITY REQUIREMENTS AND STANDARDS OF AUTHORITIES HAVING JURISDICTION FOR FIRE-SUPPRESSION AND WATER SERVICE PIPING INCLUDING MATERIALS, FITTINGS, APPURTENANCES, INSTALLATION, TESTING, SERVICE TAPS, ETC. IN CASE OF CONFLICT BETWEEN THESE SPECIFICATIONS AND STATE PLUMBING CODE OR LOCAL JURISDICTIONAL AUTHORITY, STATE PLUMBING CODE AND LOCAL JURISDICTIONAL AUTHORITY AND AUTHORITY AUTHORITY AND AUTHORITY AND AUTHORITY AND AUTHORITY AND AUTHORITY AND AUTHORITY AND AUTHORITY AUTHORITY AND AUTHORITY AND AUTHORI
- 2. DO NOT INTERRUPT SERVICE TO FACILITIES OCCUPIED BY OWNER OR OTHERS UNLESS PERMITTED BY OWNERS OF SUCH FACILITIES AND THEN ONLY AFTER ARRANGING TO PROVIDE TEMPORARY WATER-DISTRIBUTION SERVICE.
- 3. WATER SERVICE PIPING MAY BE EITHER DUCTILE IRON WATER PIPE OR IPVC WATER PIPE AS ALLOWED BY THE LOCAL WATER UTILITY.
- 4. DUCTILE IRON WATER PIPE CONFORMING TO THE REQUIREMENTS OF THE AMERICAN NATIONAL STANDARD FOR DUCTILE IRON PIPE, CENTRIFUGALLY CAST, AWWA C151A21.51 LATEST REVISION AND REQUIREMENTS OF CHAPTER 8.18.0 OF THE STANDARD SPECIFICATIONS FOR SEWER AND WATER CONSTRUCTION IN WISCOSINI, LATEST EDITION.
- b, CEMENT MORTAR LINING AND INTERNAL AND EXTERNAL BITUMINOUS COATS IN ACCORDANCE WITH SECTION 51.8 OF AWWA C151.
- c. PUSH-ON GASKET PIPE d. PLAIN RUBBER GASKETS

a CLASS 52

- e. BONDING STRAPS TO PROVIDE ELECTRICAL CONDUCTIVITY WITHOUT FIELD TESTING
- 5 JOINTS FOR DUCTILE IRON PIPE JOINTS SHALL BE RUBBER GASKET JOINTS: CONFORM TO THE REQUIREMENTS OF AMERICAN STANDARD FOR RUBBER GASKET JOINTS FOR DUCTILE IRON PRESSURE PIPE AND FITTINGS (ANSI/AWWA C111/A21.11, LATEST EDITION)
- 6. FITTINGS FOR DUCTILE IRON PIPE: CONFORM TO THE REQUIREMENTS OF AMERICAN NATIONAL STANDARD FOR DUCTILE IRON AND GRAY IRON FITTINGS, 3" THROUGH 48" FOR WATER ANSI/AWWA C110/A21.10, LATEST EDITION); CLASS 250 MECHANICAL JOINT PIPE FITTINGS; CEMENT LINED; ALL BELLS; ENTIRE FITTING TARRED; CONDUCTIVE MECHANICAL JOINT (NO LEAD) RUBBER GASKETS, FLANGES, AND BOLTS.
- PVC AWWA PIPE: AWWA 0900, CLASS 235 WITH BELL END WITH GASKET AND WITH SPIGOT END AND MEETING REQUIREMENTS OF CHAPTER 8 20 0 OF THE STANDARD SPECIFICATIONS FOR SEWER AND WATER CONSTRUCTION IN WISCONSIN. FITTINGS SHALL BE IN ACCORDANCE WITH CHAPTER 8 22 0 OF THE STANDARD SPECIFICATIONS FOR SEWER AND WATER CONSTRUCTION IN WISCONSIN MECHANICAL JOINT, DUCTILE IRON FITTINGS: AWWA C153, DUCTILE-IRON COMPACT PATTERN. GLANDS, GASKETS AND BOLTS: AWWA C111, DUCTILE IRON GLANDS, RUBBER GASKETS AND STEEL BOLTS.
- 8. GATE VALVES: CONFORM TO AWWA C-500 AND STANDARD SPECIFICATIONS FOR SEWER AND WATER CONSTRUCTION IN WISCONSIN
- 9. VALVE BOXES: CAST IRON CONFORMING TO ASTM. DESIGNATION A-48, CLASS 20 AND STANDARD SPECIFICATIONS FOR SEWER AND
- 10. FIRE HYDRANTS: TO MEET LOCAL STANDARDS
- 11. WATER MAIN CONNECTION: TAP WATER MAIN WITH SIZE AND LOCATION INDICATED ON PLAN IN ACCORDANCE WITH LOCAL WATER UTILITY REQUIREMENTS. COORDINATE CONNECTION WITH LOCAL WATER UTILITY. ALL JOINTS HALL BE RESTRAINED FROM CONNECTION OF WATER MAIN TO BUILDING WALL. SUBMIT JOINT RESTRAINT DETAILS FOR ALL JOINT TYPES INCLUDING PUSH-ON AND MECHANICAL CONNECTIONS. INSTALL MEGA-LUG OR APPROVED EQUAL TIGHT TO WALL FOR RESTRAINT FOR ALL BUILDING WALL PENETRATIONS AS APPROVED BY LOCAL PLUMBING INSPECTOR AND WATER UTILITY. INSTALL THRUST BLOCKING AND MEGA-LUG AT BEND BELOW FLOOR FOR ALL FLOOR PENETRATIONS
- 12. GENERAL WATER PIPE INSTALLATION: IN ACCORDANCE WITH CHAPTER 4.3.0 OF THE STANDARD SPECIFICATIONS FOR SEWER AND
- 13 INSTALL DUCTH F-IRON, WATER-SERVICE PIPING ACCORDING TO AWWA C600 AND CHAPTER 4.4.0 OF THE STANDARD SPECIFICATIONS
- DUCTILE IRON PIPE SHALL BE ENCASED IN POLYETHYLENE PER AWWA C105, LATEST EDITION AND IN ACCORDANCE WITH 4.4.4 OF THE STANDARD SPECIFICATIONS FOR SEWER AND WATER CONSTRUCTION IN WISCONSIN. ALL JOINTS AND FITTINGS SHALL HAVE POLYETHYLENE ENCASEMENT INSTALLED PER MANUFACTURER'S REQUIREMENTS AND PROCEDURES.
- 15 INSTALL PVC AWWA PIPE ACCORDING TO ASTM F645 AND AWWA M23 AND CHAPTER 4.6.0 OF THE STANDARD SPECIFICATIONS FOR
- 16. INSTALL JOINT RESTRAINT AND CONCRETE THRUST BLOCKS AT ALL OFFSET FITTINGS (TEES, BENDS, DEAD ENDS, VALVES, REDUCERS)
 USING NEGA-LUG OR APPROVED EQUAL. CONCRETE THRUST BLOCKS SHALL BE INSTALLED PER FILE NOS-44, 45.6 FROM THE
 STANDARD SPECIFICATIONS FOR SEWER AND WASTER CONSTRUCTION IN WISCONSIN. SEE DETAIL FOR MINIMUM LENGTH OF
 RESTRAINED JOINT REQUIRED. SUBMIT JOINT RESTRAINT DETAILS FOR ALL JOINT TYPES INCLUDING PUSH-ON AND MECHANICAL CONNECTIONS INSTALL WATER SERVICE PIPING SUCH THAT THERE IS A MINIMUM OF 6' OF COVER OVER THE TOP OF THE WATER SERVICE PIPING.

SITE WATER SERVICE CONT.:

PRELIMENTARY NOT FOR CONSTRUCTION


- BEDDING AND COVER FOR WATER SERVICE PIPING SHALL BE IN ACCORDANCE WITH SECTION 4.3.3 AND FILE NO. 36 OF THE STANDARD SPECIFICATIONS FOR SEWER AND WATER CONSTRUCTION IN WISCONSIN, LATEST EDITION. TRENCH BACKFILL SHALL BE GRANULAR B BACKFILL IN ACCORDANCE WITH SECTION 8.43.4 OF THE STANDARD SPECIFICATIONS FOR SEWER AND WATER CONSTRUCTION IN WISCONSIN, LATEST EDITION ON-SITE.
- INSTALL TRACER WIRE FOR NON-METALLIC WATER SERVICES IN ACCORDANCE WITH SPS SECTION 382.40(8)(K). TRACER WIRE INSULATION COLOR SHALL BE BLUE FOR POTABLE WATER SERVICE PIPING.
- DUCTILE-IRON PIPING, RUBBER GASKETED JOINTS IN ACCORDANCE WITH SECTION 4.4.2 OF THE STANDARD SPECIFICATIONS FOR SEWER AND WATER CONSTRUCTION IN WISCONSIN.
- 20. PVC PIPING GASKETED JOINTS: USING JOINING MATERIALS ACCORDING TO AWWA C900, CONSTRUCT JOINTS WITH ELASTOMERIC SEALS AND LUBRICANTS ACCORDING TO ASTM D2774 OR ASTM D3139 AND PIPE MANUFACTURER'S WRITTEN INSTRUCTIONS
- CONDUCT HYDROSTATIC TESTS IN ACCORDANCE WITH CHAPTER 4.15.0 OF THE STANDARD SPECIFICATIONS FOR SEWER AND WATER CONSTRUCTION IN WISCONSIN
- 22. CLEAN AND DISINFECT WATER SERVICE PIPING IN ACCORDANCE WITH SPS CHAPTER 82.40(8)(1) AND AWWA C651.

- ALL PRIVATE SANITARY SEWER WORK SHALL BE IN ACCORDANCE WITH THE DEPARTMENT OF SAFETY AND PROFESSIONAL SERVICES (DSPS) PLUMBING CODE - CHAPTERS SPS 382 AND SPS 384 AND LOCAL MUNICIPAL REQUIREMENTS.
- ALL PUBLIC SANITARY SEWER WORK SHALL BE IN ACCORDANCE WITH THE STANDARD SPECIFICATIONS FOR SEWER AND WATER CONSTRUCTION IN WISCONSIN, LATEST EDITION (STANDARD SPECIFICATIONS) AND LOCAL MUNICIPAL REQUIREMENTS.
- 3. PVC SEWER PIPE AND FITTINGS: ASTMID 3034, SDR 35, WITH BELL-AND-SPIGOT ENDS WITH RUBBER GASKETED JOINTS IN ACCORDANCE WITH CHAPTER 8.10.0 OF THE STANDARD SPECIFICATIONS FOR SEWER AND WATER CONSTRUCTION IN W LATEST EDITION. JOINTS SHALL CONFORM TO ASTM D-3212.
- MANHOLES: STANDARD PRECAST REINFORCED CONCRETE MANHOLES CONFORMING TO ASTMICATE SECTION 8.39.0 OF THE STANDARD SPECIFICATIONS AND CONFORMING TO FILE NOS. 12, 13 AND 15 OF THE STANDARD SPECIFICATIONS. DIAMETER AND DEPTH
 AS INDICATED ON PLANS. MANHOLE SIZES TO BE VERIFIED BY CONTRACTOR AND SHOP DRAWINGS SHALL BE PROVIDED TO THE ENGINEER FOR REVIEW PRIOR TO ORDERING STRUCTURES.
- MANHOLES DEEPER THAN FOUR FEET SHALL BE PROVIDED WITH MANHOLE STEPS CONFORMING TO SECTION 8.40.0 OF THE
- SEWERS SHALL BE INSTALLED IN CONFORMANCE WITH SECTION 3.2.0 OF THE STANDARD SPECIFICATIONS, INSTALL PROPER SIZE INCREASERS, REDUCERS AND COUPLINGS WHERE DIFFERENT SIZES OR MATERIALS OF PIES AND FITTINGS ARE CON INSTALL TRACER PIPE OVER NON-METALLIC PIPING IN ACCORANCE WITH SPS SECTION 382.30(11)(H) AND 382.36(7)(D).
- PIPE JOINT CONSTRUCTION: FOLLOW PIPING MANUFACTURER'S RECOMMENDATIONS; JOIN PVC SEWER PIPE ACCORDING TO ASTM D2321 AND ASTM D 2212 FOR ELASTOMERIC GASKET JOINTS, JOIN DISSIMILAR PIPE MATERIALS WITH NONPRESSURE-TYPE, FLEXIBLE
- PROVIDE AND INSTALL CLEANOUTS IN ACCORDANCE WITH SPS CHAPTER 382.35. INSTALL CLEANOUTS AND RISER EXTENSIONS FORM SEWER PIPES TO PROPOSED GRADE. INSTALL PIPING SO CLEANOUTS OPEN IN DIRECTION OF FLOW IN SEWER PIPE. USE LIGHT DUTY, TOP LOADING CLASSIFICATION CLEANOUTS IN EARTH OR UNPAYED FOOT TRAFFIC AREAS; USE MEDIUM DUTY, TOP-LOADING CLASSIFICATION CLEANOUTS IN PAYED FOOT TRAFFIC AREAS; USE HEAVY DUTY, TOP-LOADING CLASSIFICATION CLEANOUTS IN PAYED AND CLASSIFICATION CLEANOUTS IN PAYEMENT SURFACE.
- CLASS B COMPACTED TRENCH SECTION (FILE NO. NO. 4 OF STANDARD SPECIFICATIONS) SHALL BE UTILIZED. BEDDING AND COVER MATERIAL SHALL BE IN ACCORDANCE WITH SECTION 8.43.0 OF THE STANDARD SPECIFICATIONS.
- TRENCH BACKFILL MATERIAL SHALL BE GRANULAR BACKFILL IN ACCORDANCE WITH SECTION 8.43.4 OF THE STANDARD SPECIFICATIONS BENEATH AND WITHIN FIVE FEET OF PAVEMENT AREAS; COMPACTED SPOIL BACKFILL IN ACCORDANCE WITH SECTION 8.43.5 OF THE STANDARD SPECIFICATIONS MAY BE USED BENEATH LANDSCAPE AREAS.
- MANHOLE INSTALLATION SHALL BE IN ACCORDANCE WITH SECTION 3.5.0 OF THE STANDARD SPECIFICATIONS, SET MANHOLE RIMS TO ELEVATIONS INDICATED ON PLANS
- AFTER INSTALLATION OF SEWER PIPE CLEAN ALL DEBRIS FROM SEWER AND INSPECT INTERIOR OF PIPING TO DETERMINE WHETHER LINE DISPLACEMENT OR OTHER DAMAGE HAS OCCURRED. CONDUCT DEFLECTION TESTING OF INSTALLED PIPE IN ACCORDANCE WITH SECTION 3.2.6(I)4 OF THE STANDARD SPECIFICATIONS; REPLACE ANY PIPE SECTION NOT PASSING THE DEFLECTION TESTING USING NEW PIPE MATERIALS. TEST NEW BUILDING SEWER IN ACCORDANCE WITH SECTION 5.4.0 OF THE STANDARD SPECIFICATIONS REPLACE LEAKING PIPE USING NEW PIPE MATERIALS AAND REPEAT TESTING UNTIL LEAKAGE IS WITHIN ALLOWANCES SPECIFIED

- ALL PRIVATE STORM SEWER WORK SHALL BE IN ACCORDANCE WITH THE DEPARTMENT OF SAFETY AND PROFESSIONAL SERVICES (DSPS) PLUMBING CODE CHAPTERS SPS 382 AND SPS 384 AND LOCAL MUNICIPAL REQUIREMENTS.
- ALL PUBLIC STORM SEWER WORK SHALL BE IN ACCORDANCE WITH THE STANDARD SPECIFICATIONS FOR SEWER AND WATER CONSTRUCTION IN WISCONSIN, LATEST EDITION (STANDARD SPECIFICATIONS) AND LOCAL MUNICIPAL REQUIREM
- PVC SEWER PIPE AND FITTINGS: ASTMID 3034, SDR 35, WITH BELL-AND-SPIGOT ENDS WITH RUBBER GASKETED JOINTS IN DANCE WITH CHAPTER 8.10.0 OF THE STANDARD SPECIFICATIONS FOR SEWER AND WATER CONSTRUCTION IN WISCONSIN. LATEST EDITION. JOINTS SHALL CONFORM TO ASTM D-3212.
- 4. REINFORCED CONCRETE PIPE: ASTM C76 WITH BELL AND SPIGOT ENDS AND GASKETED JOINTS WITH ASTM C443 RUBBER GASKETS IN ACCORDANCE WITH CHAPTER 8.6.0 OF THE STANDARD SPECIFICATIONS FOR SEWER AND WATER CONSTRUCTION IN WISCONSIN,
- 5. HDPE PIPE: ADS N12 PIPE AS APPROVED ON THE DEPARTMENT OF SAFETY AND PROFESSIONAL SERVICES PLUMBING PRODUCT
- 5. CATCH BASINS: STANDARD PRECAST CONCRETE CATCH BASINS CONFORMING TO CHAPTER 3.6.0 OF THE STANDARD SPECIFICATIONS AND IN GENERAL CONFORMANCE WITH FILE NO. 28 OF THE STANDARD SPECIFICATIONS. DEPTH AND DIAMETER AS INDICATED ON PLANS, CATCH BASIN SIZES TO BE VERIFIED BY CONTRACTOR AND SHOP DRAWINGS SHALL BE PROVIDED TO THE
- FRAMES AND GRATES: AS INDICATED ON PLANS. CONTRACTOR SHALL BE RESPONSIBLE FOR VERIFYING SPECIFIED FRAME/GRATE IS
- MANHOLES: STANDARD PRECAST REINFORCED CONCRETE MANHOLES CONFORMING TO ASTM C478, SECTION 8.39.0 OF THE STANDARD SPECIFICATIONS AND CONFORMING TO FILE NOS. 12, 13 AND 15 OF THE STANDARD SPECIFICATIONS. DIAMETER AND DEPTH AS INDICATED ON PLANS. MANHOLE SIZES TO BE VERIFIED BY CONTRACTOR AND SHOP DRAWINGS SHALL BE PROVIDED TO THE ENGINEER FOR REVIEW PRIOR TO ORDERING STRUCTURES.
- MANHOLES AND CATCH BASINS DEEPER THAN FOUR FEET SHALL BE PROVIDED WITH MANHOLE STEPS CONFORMING TO SECTION
- 10. SEWERS SHALL BE INSTALLED IN CONFORMANCE WITH SECTION 3.2.0 OF THE STANDARD SPECIFICATIONS. INSTALL PROPER SIZE NCREASERS. REDUCERS AND COUPLINGS WHERE DIFFERENT SIZES OR MATERIALS OF PIPES AND FITTINGS ARE CONNECTED INSTALL TRACER PIPE OVER NON-METALLIC PIPING IN ACCORDANCE WITH SPS SECTION 382.30(11)(H) AND 382.36(7)(D)
- PROVIDE AND INSTALL CLEANOUTS IN ACCORDANCE WITH SPS CHAPTER 382.35. INSTALL CLEANOUTS AND RISER EXTENSIONS FORM SEWER PIPES TO PROPOSED GRADE. INSTALL PIPING SO CLEANOUTS OPEN IN DIRECTION OF FLOW IN SEWER PIPE. USE LIGHT DUTY, TOP LOADING CLASSIFICATION CLEANOUTS IN EARTH OR UNPAVED FOOT TRAFFIC AREAS; USE MEDIUM DUTY, TOP-LOADING CLASSIFICATION CLEANOUTS IN PAYED FOOT TRAFFIC AREAS; USE HEAYY DUTY, TOP-LOADING CLASSIFICATION CLEANOUTS IN VEHICULAR TRAFFIC AREAS. SET CLEANOUT FRAMES AND COVERS IN PAVEMENT AREAS FLUSH WITH PAVEMENT SURFACE.
- 12. CLASS B COMPACTED TRENCH SECTION (FILE NO. NO. 4 OF STANDARD SPECIFICATIONS) SHALL BE UTILIZED. BEDDING AND COVER MATERIAL SHALL BE IN ACCORDANCE WITH SECTION 8.43.0 OF THE STANDARD SPECIFICATION
- 13. TRENCH BACKFILL MATERIAL SHALL BE GRANULAR BACKFILL IN ACCORDANCE WITH SECTION 8.43.4 OF THE STANDARD SPECIFICATIONS BENEATH AND WITHIN FIVE FEET OF PAVEMENT AREAS; COMPACTED SPOIL BACKFILL IN ACCORDANCE WITH SECTION 8.43.5 OF THE STANDARD SPECIFICATIONS MAY BE USED BENEATH LANDSCAPE AREAS.
- 14. MANHOLE INSTALLATION SHALL BE IN ACCORDANCE WITH SECTION 3.5.0 OF THE STANDARD SPECIFICATIONS, SET MANHOLE RIMS
- 15. CATCH BASIN INSTALLATION SHALL BE IN ACCORDANCE WITH SECTION 3.6 OF THE STANDARD SPECIFICATIONS. CATCH BASIN EXCAVATION AND PREPARATION SHALL BE IN ACCORDANCE WITH SECTION 3.5.4(A) AND (B) OF THE STANDARD SPECIFICATIONS. FRAMES AND GRATES SHALL BE SET TO THE ELEVATIONS SHOWN ON THE PLANS.
- 16. AFTER INSTALLATION OF SEWER PIPE CLEAN ALL DEBRIS FROM SEWER AND INSPECT INTERIOR OF PIPING TO DETER LINE DISPLACEMENT OR OTHER DAMAGE HAS OCCURRED. CONDUCT DEFLECTION TESTING OF INSTALLED PIPE IN ACCORDANCE WITH SECTION 3.2.6(1)4 OF THE STANDARD SPECIFICATIONS; REPLACE ANY PIPE SECTION NOT PASSING THE DEFLECTION TESTING

- 2. CONTRACTOR SHALL PROVIDE MATERIAL TEST REPORTS FROM A QUALIFIED TESTING AGENCY INDICATING TEST RESULTS FOR CLASSIFICATION ACCORDING TO ASTM D2487 AND LABORATORY COMPACTION CURVES ACCORDING TO ASTM D457 FOR EACH ON-SITE AND OFF-SITE SOIL
- CONTRACTOR SHALL PROVIDE PREEXCAVATION PHOTOS OR VIDEOS SHOWING EXISTING CONDITIONS OF ADJOINING STRUCTURES AND SITE IMPROVEMENTS THAT MIGHT BE MISCONSTRUED AS DAMAGE CAUSED BY EARTHWORK OPERATIONS.
- OLD BUILDING FOUNDATIONS, BUILDING REMNANTS OR UNSUITABLE BACKFILL MATERIAL SHALL BE COMPLETELY REMOVED FROM WITHIN AND A MINIMUM OF 10 FEET BEYOND THE NEW BUILDING PAD AREAS. THE RESULTING EXCAVATION SHALL BE BACKFILLED WITH COMPACTED
- FOUNDATIONS, FOUNDATION WALLS OR CONCRETE FLOOR SLABS SHALL BE REMOVED TO A MINIMUM OF TWO FEET BELOW PROPOSED SUBGRADE WITHIN PROPOSED PARKING AND GREENSPACE AREAS. BASEMENT SLABS LOCATED BELOW 2 FEET FROM PLANNED SUBGRADE ELEVATION MAY BE LEFT IN PLACE BUT SHALL BE BROKEN INTO MAXIMUM 5 INCH PIECES TO FACULITATE DRAINAGE.
- SATISFACTORY SOILS FOR FILL: ASTM D 2487 SOIL CLASSIFICATION GROUPS GW, GP, GM, SW, SP, AND SM. OR A COMBINATION OF THESE GROUPS; FREE OF ROCK OR GRAVEL LARGER THAN 3 INCHES IN ANY DIMENSION, DEBRIS, WASTE, FROZEN MATERIALS, VEGETATION, AND OTHER DELETERIOUS MATTER OR ANY SOIL GROUP OR COMBINATION OF GROUPS APPROVED OF BY THE PROJECT GEOTECHNICAL ENGINEER.
- UNSATISFACTORY SOILS FOR FILL: SOIL CLASSIFICATION GROUPS GC, SC, CL, ML, OL, CH, MH, OH, AND PT ACCORDING TO ASTM D 2487 OR A COMBINATION OF THESE GROUPS UNLESS DEEMED SATISFACTORY BY THE PROJECT GEOTECHNICAL ENGINEER. UNSATISFACTORY SOILS ALSO INCLUDE SOILS NOT MAINTAINED WITHIN 3 PERCENT OF OPTIMUM SOIL MOISTURE CONTENT AT THE TIME OF COMPACTION.
- AGGREGATE BASE COURSE BENEATH PAVEMENTS: SHALL BE 1-1/4" DENSE GRADED BASE COURSE CONFORMING TO SECTION 305 OF THE STATE OF WISCONSIN STANDARD SPECIFICATIONS FOR HIGHWAY AND STRUCTURE CONSTRUCTION, LATEST EDITION.
- ENGINEERED FILL: NATURALLY OR ARTIFICIALLY GRADED MIXTURE OF NATURAL OR CRUSHED GRAVEL, CRUSHED STONE, AND NATURAL OR CRUSHED SAND; ASTMID 2940; WITH AT LEAST 90 PERCENT PASSING A 1-1/2-INCH (37.5-MM) SIEVE AND NOT MORE THAN 12 PERCENT PASSING A NO. 200 SIEVE OR ANY SOIL DEEMED ACCEPTABLE FOR ENGINEERED FILL BY THE PROJECT GEOTECHNICAL ENGINEER. ENGINEERED FILL SHALL BE FREE OF ORGANIC, FROZEN, OR OTHER DELETERIOUS MATERIAL AND HAVE A MAXIMUM PARTICLE SIZE LESS THAN 3 INCHES, CLAY FILLS SHALL HAVE A LIQUID LIMIT OF LESS THAN 49 AND PLASTICITY INDEX BETWEEN 11 AND 25.
- 10. BEDDING COURSE FOR SEWERS AND WATER SERVICE: NATURALLY OR ARTIFICIALLY GRADED MIXTURE OF NATURAL OR CRUSHED GRAVEI CRUSHED STONE, AND NATURAL OR CRUSHED SAND CONFORMING TO THE REQUIREMENTS OF SECTION 8.43.2 OF THE STANDARD SPECIFICATIONS FOR SEWER AND WATER CONSTRUCTION IN WISCONSIN, LATEST EDITION.
- DRAINAGE COURSE BENEATH BUILDING SLABS: NARROWLY GRADED MIXTURE OF WASHED, CRUSHED STONE, OR CRUSHED OR UNCRUSHED GRAVEL; ASTM D 448; COARSE-AGGREGATE GRADING SIZE 57; WITH 100 PERCENT PASSING A 1-1/2-INCH (37,5-MM) SIEVE AND 0 TO 5 PERCENT PASSING A NO. 8 SIEVE
- 12. TRENCH BACKFILL MATERIAL SHALL BE GRANULAR BACKFILL IN ACCORDANCE WITH SECTION 8.43.4 OF THE STANDARD SPECIFICATIONS BENEATH AND WITHIN FIVE FEET OF PAVEMENT AREAS, COMPACTED SPOIL BACKFILL IN ACCORDANCE WITH SECTION 8.43.5 OF THE STANDARD SPECIFICATIONS MAY BE USED BENEATH LANDSCAPE AREAS.
- 13. PIPE COVER MATERIAL: CONFORM TO SECTION 8 43.3 OF THE STANDARD SPECIFICATIONS FOR SEWER AND WATER CONSTRUCTION IN WISCONSIN, LATEST EDITION
- 14. PREVENT SURFACE WATER AND GROUND WATER FROM ENTERING EXCAVATIONS, FROM PONDING ON PREPARED SUBGRADES, AND FROM FLOODING PROJECT SITE AND SURROUNDING AREA.
- 15. SHORING, SHEETING AND BRACING: SHORE, BRACE OR SLOPE BANKS OF EXCAVATION TO PROTECT WORKMEN, BANKS, ADJACENT PAVING, STRUCTURES, AND UTILITIES TO MEET OSHA REQUIREMENTS. DESIGN OF TEMPORARY SUPPORT OF EXCAVATION IS THE RESPONSIBILITY OF THE
- EXCAVATE TO SUBGRADE ELEVATIONS REGARDLESS OF THE CHARACTER OF SURFACE AND SUBSURFACE CONDITIONS ENCOUNTERED. UNCLASSIFIED EXCAVATED MATERIALS MAY INCLUDE ROCK, SOIL MATERIALS, AND OBSTRUCTIONS. NO CHANGES IN THE CONTRACT SUM OR THE CONTRACT TIME WILL BE AUTHORIZED FOR ROCK EXCAVATION OR REMOVAL OF OBSTRUCTIONS.
- PROOF-ROLL SUBGRADE BELOW THE BUILDING SLABS AND PAVEMENTS WITH FULLY LOADED TANDEM AXLE DUMP TRUCK OR RUBBER TIRED VEHICLE OF SIMILAR SIZE AND WEIGHT, TYPICALLY 9 TONS/AXLE, WHERE COHESIVE SOILS ARE ENCOUNTERED OR WITH A SMOOTH DRUMMED VIBRATORY ROLLER WHERE GRANULAR SOILS ARE PRESENT. DO NOT PROOF-ROLL WET OR SATURATED SUBGRADES AND PROOFROLL IN DRY WEATHER, PROOF ROLL IN PRESENCE OF PROJECT GEOTECHNICAL ENGINEER OR TECHNICIAN, SOILS THAT ARE OBSERVED TO RUT OR DEFLECT EXCESSIVELY UNDER THE MOVING LOAD (TYPICALLY > 1") SHALL BE UNDERCUT AND REPLACED WITH PROPERLY COMPACTED ENGINEERED FILL. N PAVEMENT AREAS WHERE UNDERCUTS ARE PERFORMED, THE EDGES OF THE OVEREXCAVATIONS SHALL BE FEATHERED INOT THE SURROUNDING SUITABLE SOIL SO THAT EDGE FAILURE OF THE OVEREXCAVATED AREA DOES NOT OCCUR.
- 18. DUE TO CLAYEY SOILS, IF UNDERCUTS OCCUR WITHIN PAYEMENT AREAS AND THEY ARE BACKFILLED WITH GRANULAR SOILS. THE ROTTOM OF THE OVEREXCAVATION SHALL BE SLOPED TO A DRAINTILE THAT IS IN KIND SLOPED TOWARD THE NEAREST STORM SEWER. MINIMUM SLOPES OF SUCH DRAINTILES SHALL BE 0.5%.
- 19. CONVENTIONAL DISKING AND AERATION TECHNIQUES SHALL BE USED TO DRY SOILS BEFORE PROOF ROLLING, ALLOT FOR PROPER DRYING TIME IN PROJECT SCHEDULE.
- 20. ENGINEERED FILL SHALL BE PLACED IN MAXIMUM LIFTS OF FIGHT INCHES OF LOOSE MATERIAL AND COMPACTED WITHIN 39/LOF OPTIMUM SO MOISTURE CONTENT VALUE AND A MINIMUM OF 95% OF THE MAXIMUM DRY DENSITY AS DETERMINED BY THE MODIFIED PROCTOR TEST ASTM D1557, EACH LIFT OF COMPACTED ENGINEERED FILL SHALL BE OBSERVED AND TESTED BY A QUALIFIED GEOTECHNICAL ENGINEER D
- 21. EXISTING OLD FILL MATERIAL SHALL BE REMOVED BELOW FOOTINGS OR FOUNDATION SUPPORTING FILL. ENGINEERED FILL BELOW FOOTINGS SHOULD HAVE AN IN-PLACE DENSITY OF 95% OF THE MAXIMUM DRY DENSITY AND A MOISTURE CONTENT WITHIN 3% OF OPTIMUM AS DETERMINED BY ASTM D1557, ENGINEERED FILL BELOW FOOTINGS SHALL BE EVALUATED BY IN-FIELD DENSITY TESTS DURING CONSTRUCTION.
- WHERE UNSUITABLE BEARING SOILS ARE ENCOUNTERED IN A FOOTING EXCAVATION. THE EXCAVATION SHALL BE DEEPENED TO COMPETENT BEARING SOIL AND THE FOOTING LOWERED OR AN OVEREXCAVATION AND BACKFILL PROCEDURE PERFORMED. OVEREXCAVATION AND BACKFILL TREATMENT REQUIRES WIDDENING THE DEEPENED EXCAVATION IN ALL DIRECTIONS AT LEAST 6 INCHES BEYOND THE EDGE OF THE FOOTING FOR EACH 12 INCHES OF OVEREXCAVATION DEPTH. THE OVEREXCAVATION SHALL BE BACKFILLED UP TO FOOTING BASE ELEVATION IN MAXIMUM BINCH LOOSE LIFTS WITH SUITABLE GRANULAR FILL INATERIAL AND COMPACTED TO 95% OF THE MAXIMUM DRY DENSITY AND A MOISTURE CONTENT WITHIN 3% OF OPTIMUM AS DETERMINED BY A STIM DISST, SOILS AT FOUNDATION BEARING ELEVATION IN THE FOOTING EXCAVATIONS SHALL BE OBSERVED AND TESTED BY A QUALIFIED GEOTECHNICAL ENGINEER OR TECHNICIAN.
- A MINIMUM OF FOUR INCHES OF DRAINAGE COURSE MAT SHALL BE PLACED BELOW BUILDING FLOOR SLABS, DRAINAGE COURSE SHALL BE COMPACTED TO A MINIMUM OF 95% COMPACTION WITH RESPECT TO THE MODIFIED PROCTOR (ASTM D1557)
- UTILITY TRENCHES FOR SEWER AND WATER SHALL CONFORM TO CLASS B COMPACTED TRENCH SECTION IN ACCORDANCE WITH FILE NO. 4 OF THE STANDARD SPECIFICATIONS FOR SEWER AND WATER CONSTRUCTION IN WISCONSIN, LATEST EDITION.
- BACKFILL UTILITY TRENCHES IN 4 TO 6 INCH LOOSE LIFTS COMPACTED TO 95% OF THE MAXIMUM DRY DENSITY AS DETERMINED BY ASTM D1557. BACKFILL SHALL BE MOISTURE CONDITIONED TO BE WITH 3% OF OPTIMUM MOISTURE CONTENT AS DETERMINED BY ASTM D1557.
- UTILITY BEDDING PLACEMENT: CONFORM TO SECTION 3.2.6 OF THE STANDARD SPECIFICATIONS FOR SEWER AND WATER CONSTRUCTION IN WISCONSIN, LATEST EDITION. BEDDING MATERIAL SHALL BE COMPACTED TO A MINIMUM OF 90% COMPACTION WITH RESPECT TO THE MODIFIED PROCTOR (ASTM D1557).
- COMPACTION TESTING OF UTILITY TRENCHES SHALL BE PERFORMED ONE FOR EVERY 200 CUBIC YARDS OF BACKFILL PLACED OR ONE FOR TEST PER 200 LINEAR FEET OF TRENCH FOR EACH LIFT, WHICHEVER IS LESS. AGGREGATE BASE COURSE BENEATH PAVEMENTS SHALL BE PLACED AND COMPACTED TO 95% OF THE MAXIMUM DRY DENSITY WITH A
- MOISTURE CONTENT WITHIN 3% OF OPTIMUM AS DETERMINED BY ASTMID 1557, AGGREGATE BASE SHALL BE OBSERVED AND TESTED BY A QUALIFIED GEOTECHNICAL ENGINEER OR TECHNICIAN. GRADING GENERAL: UNIFORMLY GRADE AREAS TO A SMOOTH SURFACE, FREE OF IRREGULAR SURFACE CHANGES. COMPLY WITH COMPACTION
- REQUIREMENTS AND GRADE TO CROSS SECTIONS, LINES, AND ELEVATIONS INDICATED. SLOPE GRADES TO DIRECT WATER AWAY FROM BUILDINGS AND TO PREVENT PONDING. 30. TESTING AGENCY: CONTRACTOR SHALL ENGAGE A QUALIFIED INDEPENDENT GEOTECHNICAL ENGINEERING TESTING AGENCY TO PERFORM
- FIELD QUALITY-CONTROL TESTING. FOOTING SUBGRADE TESTING: EACH ISOLATED FOOTING SHALL INCLUDE AT LEAST ONE TEST PROBE. TEST PROBES SHALL BE PERFORMED
- EVERY 20 LINEAR FEET IN CONTINUOUS FOOTINGS. 32. BUILDING SLAB AREA TESTING: AT SUBGRADE AND AT EACH COMPACTED FILL AND BACKFILL LAYER, AT LEAST 1 TEST PER LIFT FOR EVERY 2500 SQ. FT. OR LESS OF BUILDING SLAB, BUT IN NO CASE FEWER THAN 3 TESTS
- 33. PAVEMENT AREA TESTING: AT SUBGRADE AND AT EACH COMPACTED FILL AND BACKFILL LAYER, AT LEAST ONE TEST FOR EVERY LIFT FOR EVERY 2,500 SQUARE FEET OF PAVEMENT AREA, BUT IN NO CASES FEWER THAN 3 TESTS
- 34. FOUNDATION WALL BACKFILL: AT EACH COMPACTED BACKFILL LAYER, AT LEAST 1 TEST PER LIFT FOR EACH 50 FEET OR LESS OF WALL LENGTH, BUT NO FEWER THAN 2 TESTS. 35. WHEN TESTING AGENCY REPORTS THAT SUBGRADES FILLS OR BACKFILLS HAVE NOT ACHIEVED DEGREE OF COMPACTION SPECIFIED. SCADIES
- AND MOISTEN OR AERATE, OR REMOVE AND REPLACE SOIL TO DEPTH REQUIRED; RECOMPACT AND RETEST UNTIL SPECIFIED COM OBTAINED. 36. DISPOSAL: REMOVE SURPLUS SOIL AND WASTE MATERIAL, INCLUDING UNSATISFACTORY SOIL, TRASH, AND DEBRIS, AND LEGALLY DISPOSE OF 1

SPECIFICATIONS

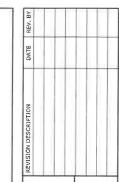


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SHEET INFORMATION A.C.E. JOB NO. 260/23 11/02/2025 SCALE: 1" = 30"



REVISION DESCRIPTION DATE REV. BY

3S10 SOUTH 26TH PHONE: 920682 SUPERVISING PROFESSIONAL:

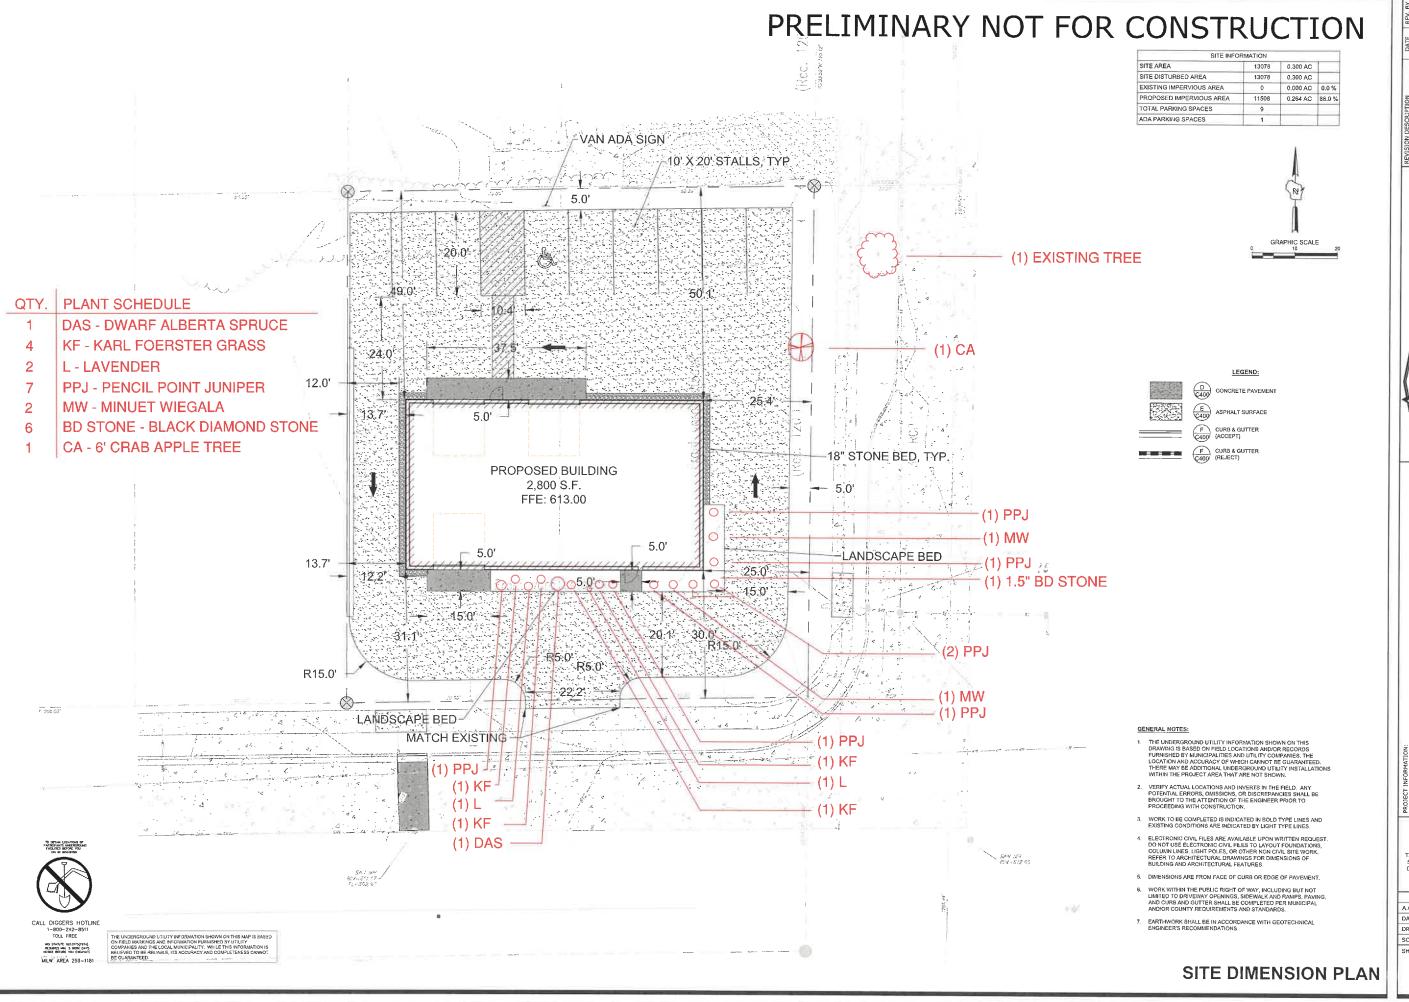GROWTH GARAGE, LLC

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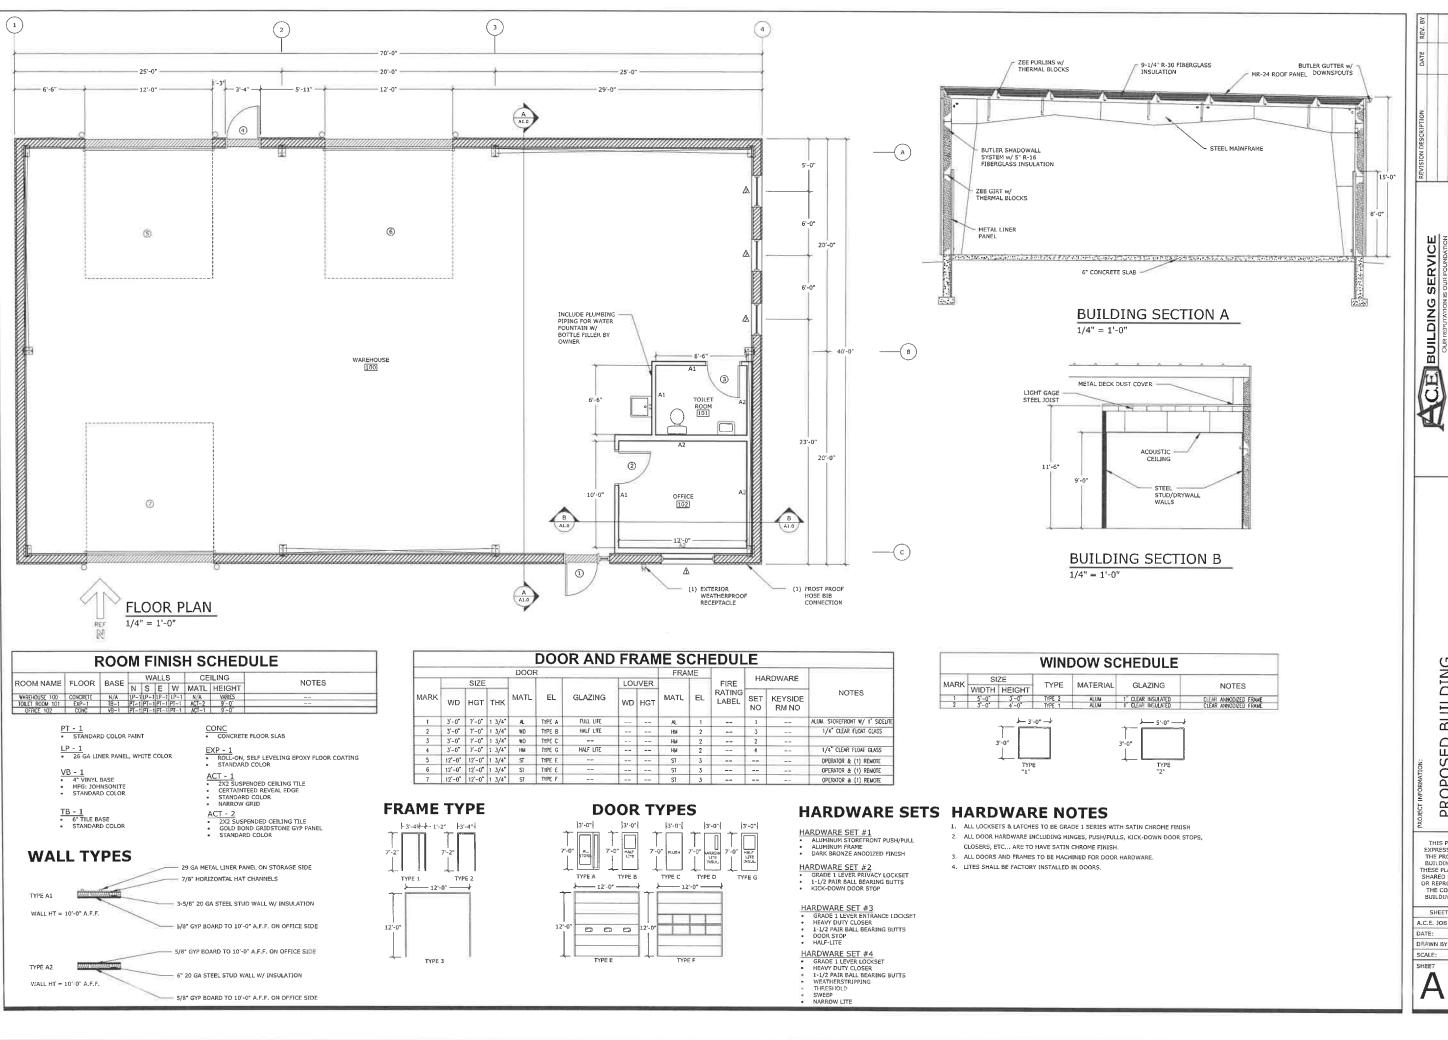
A.C.E. JOB NO. 260/23

DATE: 2/11/25

DRAWN BY: KJB

SCALE: 1' = 30'

SHEET




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PROPOSED B GROWTH GARAGE, LLC 33RD ST. TWO RIVERS, WI 54241

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SHEET INFORMATION A.C.E. JOB NO. 369/24 11/15/202 DRAWN BY: KDR

SCALE: SEE SHEET




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SHEET INFORMATION A.C.E. JOB NO. 359/24 DATE: 11/15/20 DRAWN BY: KDR 11/15/202 SCALE: SHEET SEE SHEET

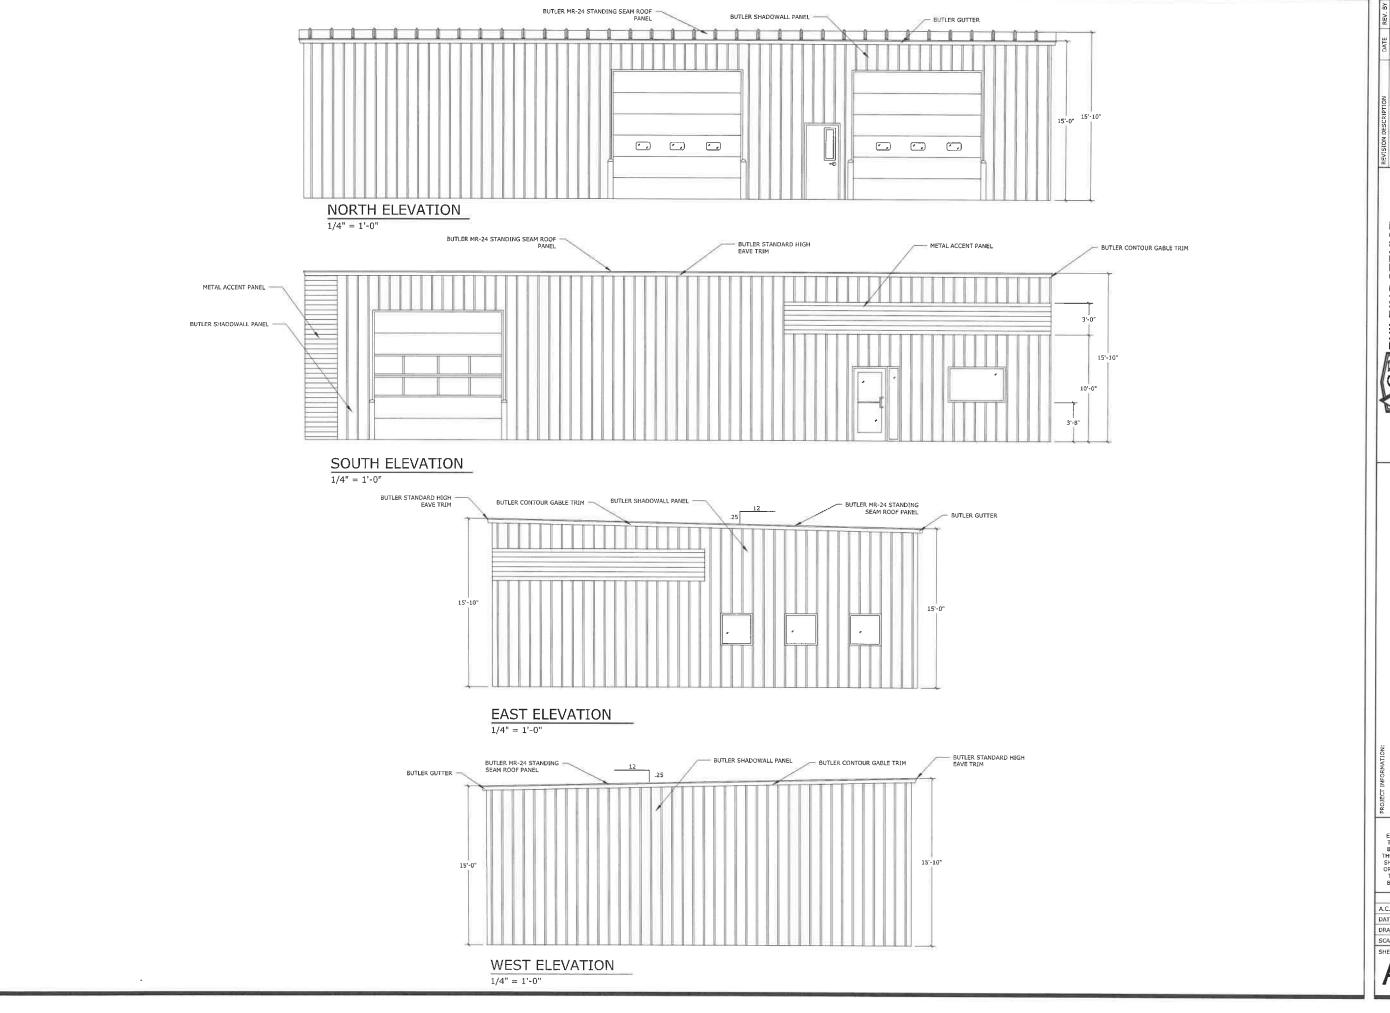

1 4' FROST WALL DETAIL S1.1 SCALE: 1/2" = 1'0"

FOUNDATION NOTES

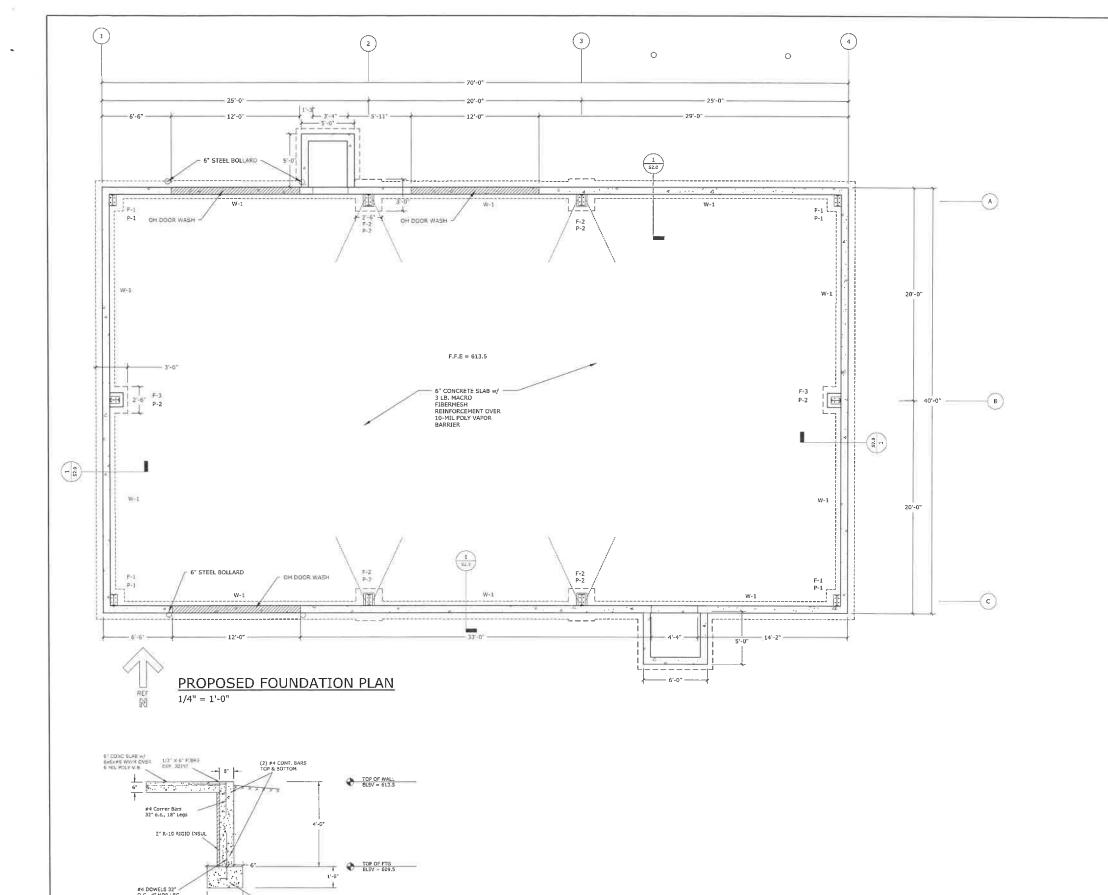PIERS

TOP OF PIER IS ELEV 613.5'

P-1, CORNER PIERS

18" X 18" X 1' PIER REINFORCE W/ 12 #5 VERTICAL BARS EXTENDED INTO FOOTING (OR HOOKED) AND (3)#3 HORIZONTAL TIES

P-2, COLUMN PIERS

16" X 30" X 4' PIER REINFORCE W/ 8 #5 VERTICAL BARS EXTENDED INTO FOOTING (OR HOOKED) AND #3 HORIZONTAL TIES 8" O.C.

PIER FOOTINGS

1'-0" X 2'-0" X 24" FOOTING REINFORCE W/ 2 LAYERS #5 BARS 8" O.C. E/W

2'-6" X 3'-0" X 12" FOOTING REINFORCE W/#4 BARS 8" O.C. E/W

2'-6" X 2'-0" X 12" FOOTING REINFORCE W/#4 BARS 8" O.C. E/W

FOUNDATION WALLS TOP OF WALL IS TOP OF SLAB UNLESS NOTED OTHERWISE

8" X 4' HIGH WALL W/ #4 BARS 12" O.C. VERT & HORZ. TIE VERTICAL BARS TO HOOKS EMBEDDED IN FOOTING

HAIRPINS


1- #5 BAR CONTINUOUS WITH 10' LEGS

CE BUILDING SERVICE

PROPOSED BUILDING
GROWTH GARAGE, LLC
33RD ST.
TWO RIVERS, WI 54241

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SHEET INFORMATION A.C.E. JOB NO. 369/24 11/15/202

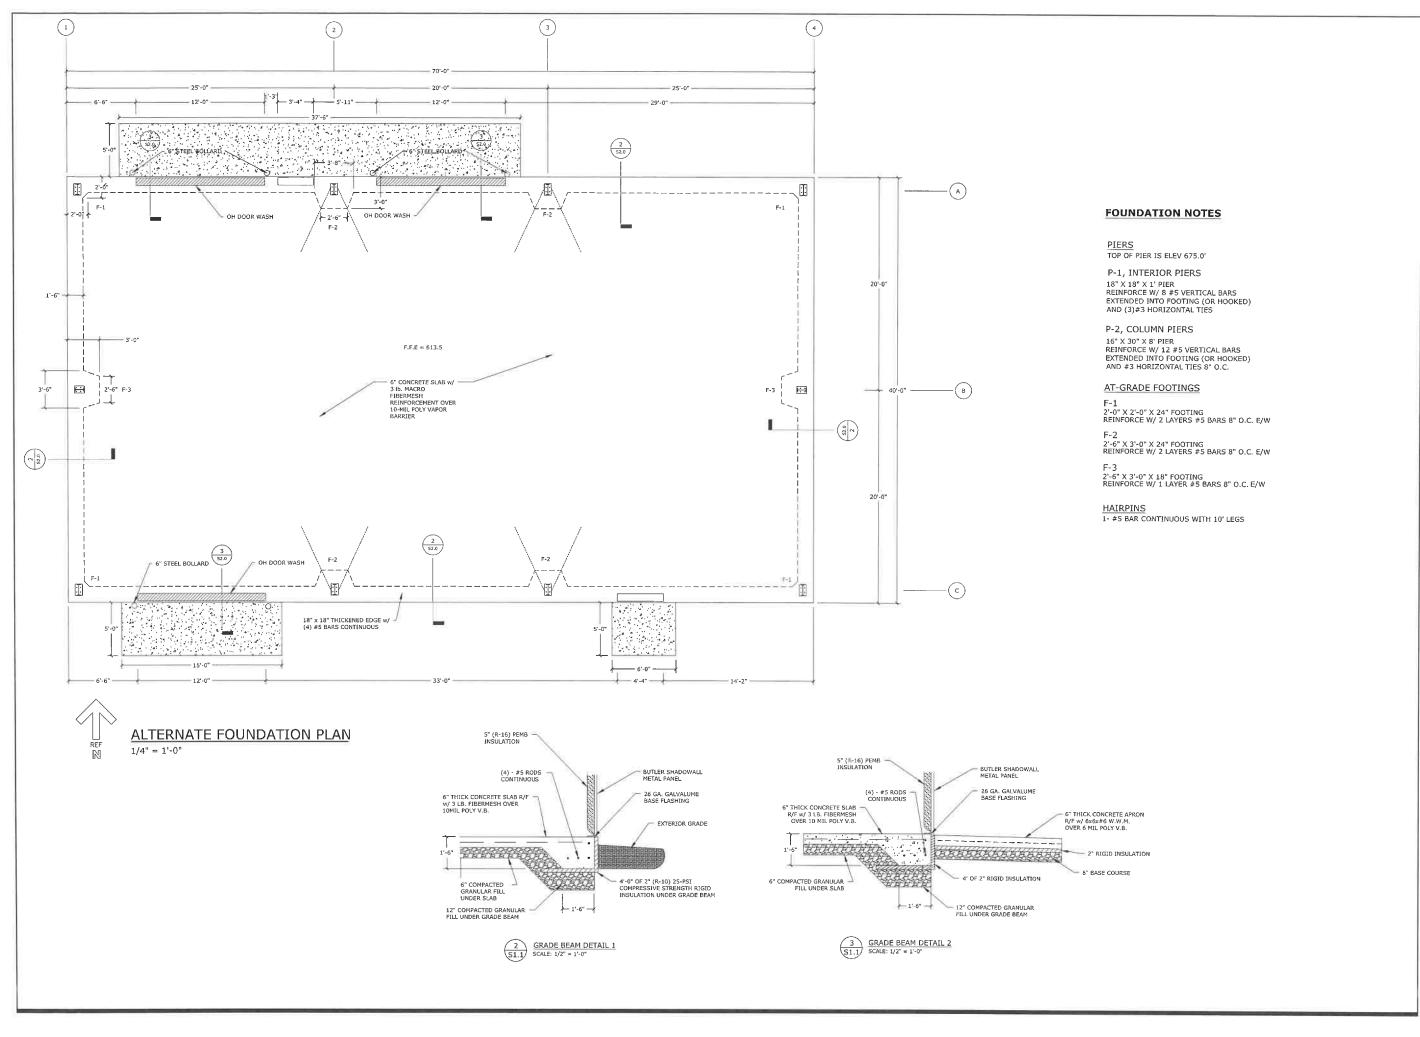

REVISION DESCRIPTION DATE REV. BY

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OUR REPUTATION IS OUR POUNDATION
SELO SOUTH 26TH STREET MANITOWOO, WIT - SETH STREET
PHONE: 320.692.8105. - WWW.ACLEULLDINGSERVICE.CO.


3510 SOUTH 26TH ST PHONE: 920-682-6105 -SUPERVISING PROFESSIONAL:


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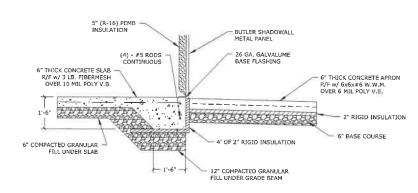
| SHEET INFORMATION |
A.C.E. JOB NO.	369/24
DATE:	11/15/202
DRAWN BY:	KDR
SCALE:	SEE SHEET


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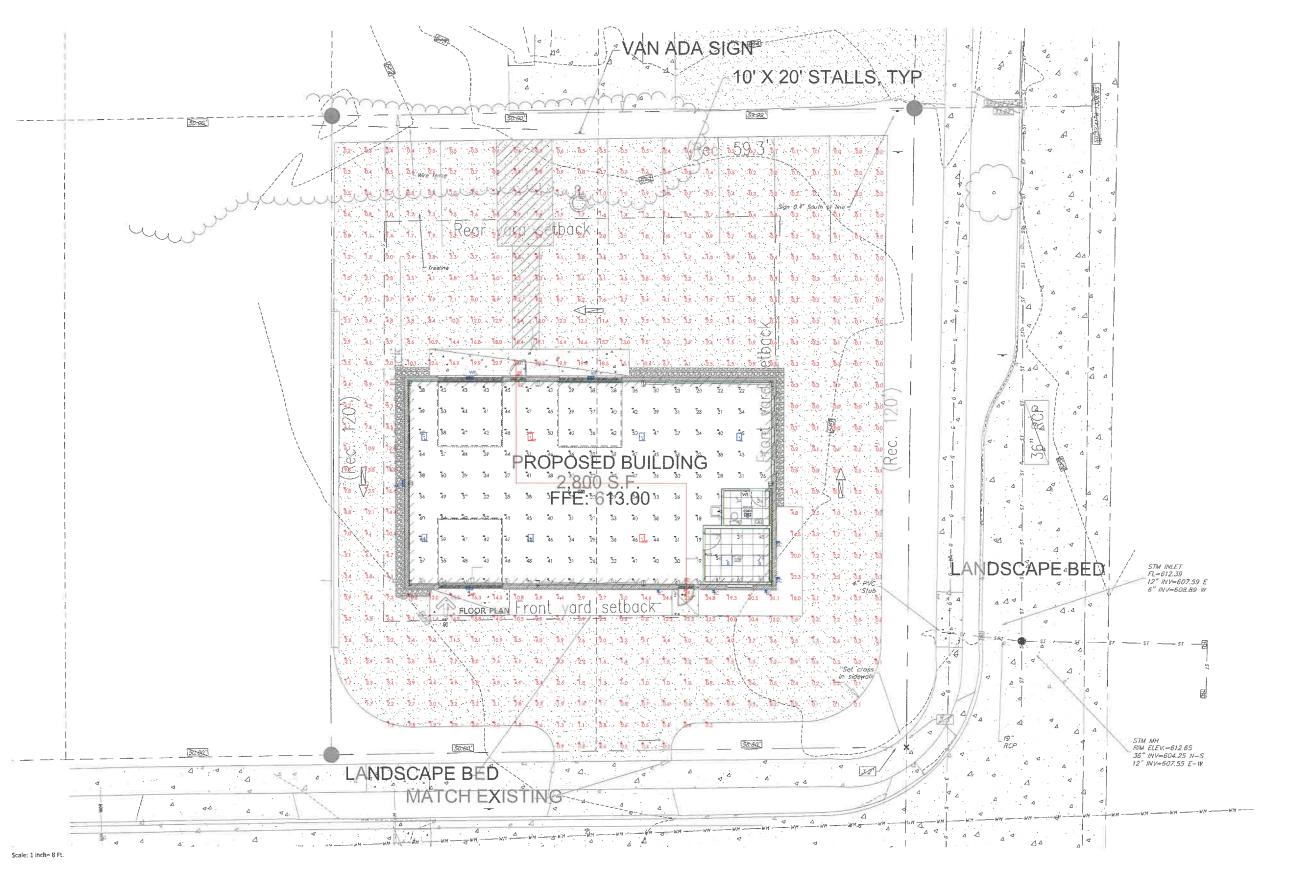
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SHEET INFORMATION A.C.E. JOB NO. 369/24 DATE: 11/15/202 DRAWN BY: KDR SEE SHEET

SCALE:
SHEET

STATE

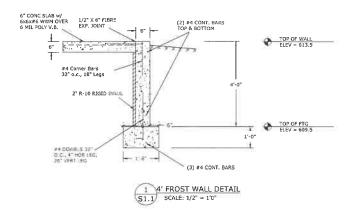ST

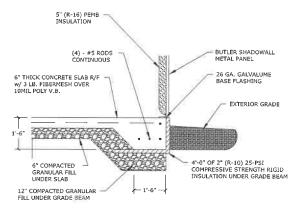

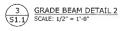Watts 36.2 30 390 156 117.75 400 78 23.55 100

Luminaire Schedule Scenario: GENERAL Symbol Qty Label

2 EC 2 ER 5 H

Description

2X0 LED FLAT PANEL

EXIT EMERGENCY COMBO

LED EMERGENCY WALL PACK W/ NORMAL PC OPERATION

LED HIGHBAY W/INTEGRATED OCC SENSOR

LED HIGHBAY W/INTEGRATED OCC SENSOR AND EMERGENCY BATTERY BACKUP

LED WALL SCONCE

LED FULL CUTOFF WALL PACK

WALL OCCUPANCY SENSOR

Calculation Summary			
Scenario: GENERAL			
Labe!	Units	Avg	Max/Mir
100 Workplane	Fc	38.7	6.4
101 Workplane	Fc	39-3	1.3
102 Workplane	Fc	59.0	2.9
EST EGRESS PATH	Fc	3.8	6.3
LOT CALCS	Fc	3.9	N.A.

To request the Project Quotation for these materials or to place the order, please contact: Sales@LightingDesignSolutions.com or call us at 1-888-357-7070

E/3

es i g n

Lighting Design Solutions, Inc.
Scholaid Office:
PC Box 375
Scholaic W 15476
Scholaic W 15476
Fox: 115.693.2594
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