

REVISIONS

DESCRIPTION

Planning
Olympia
Cleveland Ave SE, Suite 209
Tumwater, WA 98501

ET APARTMENTS

E. BR
51055
51055
SSONAL ENGINEER

JOB NUMBER: C22-229
DRAWING NAME: C22-229 CVPL
DESIGNER: T. BRADLEY
DRAFTING BY: S. ORDONEZ
DATE: OCTOBER, 2023
SCALE: AS NOTED
JURISDICTION: TUMWATER

CV-01
SHEET 1 OF 43



 REVISIONS

 Pring g
 No. DATE
 DESCRIPTION
 BY

 Kent
 Kent
 Image: Control of the principle of the princip

odinville Olympia 321 Cleveland Ave SE, Suite 209 Tumwater, WA 98501 125.806.1869 www.LDCcorp.com F 425.48

Woodinville
321 Clevela

I INVESTORS, LLC

MAKKEI APAKIMI

E. BR 51055 51055 SSTONAL ENGINEERING

JOB NUMBER: C22-229

DRAWING NAME: C22-229 EC-01

DESIGNER: T. BRADLEY

DRAFTING BY: S. ORDONEZ

DATE: OCTOBER, 2023

SCALE: AS NOTED

TUMWATE

EC-01

SHEET 2 OF 4

JURISDICTION:

SILT FENCE NOTES

- FILTER FABRIC SHALL BE PURCHASED IN A CONTINUOUS ROLL CUT TO THE LENGTH OF THE BARRIER TO AVOID USE OF JOINTS. WHEN JOINTS ARE NECESSARY, FILTER CLOTH SHALL BE SPLICED TOGETHER ONLY AT A SUPPORT POST, WITH A MINIMUM 6_INCH OVERLAP, AND SECURELY FASTENED AT BOTH ENDS TO POST.
- 2. POSTS SHALL BE SPACED A MAXIMUM OF 6 FEET APART AND DRIVEN SECURELY INTO THE GROUND (MINIMUM OF 30 INCHES).
- 3. A TRENCH SHALL BE EXCAVATED APPROXIMATELY 8 INCHES WIDE AND 12 INCHES DEEP ALONG THE LINE OF POSTS AND UPSLOPE FROM THE BARRIER.
- 4. WHEN STANDARD STRENGTH FILTER FABRIC IS USED, A WIRE MESH SUPPORT FENCE SHALL BE FASTENED SECURELY TO THE UPSLOPE SIDE OF THE POSTS USING HEAVY_DUTY WIRE STAPLES AT LEAST 1 INCH LONG, TIE WIRES OR HOG RINGS. THE WIRE SHALL EXTEND INTO THE TRENCH A MINIMUM OF 4 INCHES AND SHALL NOT EXTEND MORE THAN 36 INCHES ABOVE THE ORIGINAL GROUND SURFACE.
- 5. THE STANDARD STRENGTH FILTER FABRIC SHALL BE STAPLED OR WIRED TO THE FENCE, AND 20 INCHES OF THE FABRIC SHALL BE EXTENDED INTO THE TRENCH. THE FABRIC SHALL NOT EXTEND MORE THAN 36 INCHES ABOVE THE ORIGINAL GROUND SURFACE. FILTER FABRIC SHALL NOT BE STAPLED TO EXISTING TREES.
- WHEN EXTRA_STRENGTH FILTER FABRIC AND CLOSER POST SPACING IS USED, THE WIRE MESH SUPPORT FENCE MAY BE ELIMINATED. IN SUCH A CASE, THE FILTER FABRIC IS STAPLED OR WIRED DIRECTLY TO THE POSTS WITH ALL OTHER PROVISIONS OF ABOVE NOTES APPLYING.
- 7. FILTER FABRIC FENCES SHALL NOT BE REMOVED BEFORE THE UPSLOPE AREA HAS BEEN PERMANENTLY STABILIZED.
- 8. FILTER FABRIC FENCES SHALL BE INSPECTED IMMEDIATELY AFTER EACH RAINFALL AND AT LEAST DAILY DURING PROLONGED RAINFALL. ANY REQUIRED REPAIRS SHALL BE MADE IMMEDIATELY.

STORM DRAIN INLET PROTECTION NOTES

- PLACE CONCRETE BLOCKS LENGTHWISE ON THEIR SIDES IN A SINGLE ROW AROUND THE PERIMETER OF THE INLET, SO THAT THE OPEN ENDS FACE OUTWARD, NOT UPWARD. THE ENDS OF ADJACENT BLOCKS SHALL ABUT. THE HEIGHT OF THE BARRIER CAN BE VARIED, DEPENDING ON DESIGN NEEDS, BY STACKING COMBINATIONS OF BLOCKS THAT ARE 4 INCHES, AND 12 INCHES WIDE. THE ROW OF BLOCKS SHALL BE AT LEAST 12 INCHES BUT NO GREATER THAN 24 INCHES HIGH.
- 2. PLACE WIRE MESH OVER THE OUTSIDE VERTICAL FACE (OPEN END) OF THE CONCRETE BLOCKS TO PREVENT STONE FROM BEING WASHED THROUGH THE BLOCKS. USE HARDWARE CLOTH OR COMPARABLE WIRE MESH WITH 1/2 INCH OPENINGS.
- 3. PILE STONE AGAINST THE WIRE MESH TO THE TOP OF THE BLOCKS. USE 3/4 TO 3 INCH GRAVEL.
- 4. PLACE WIRE MESH OVER THE DROP INLET SO THAT THE WIRE EXTENDS A MINIMUM OF 1 FT BEYOND EACH SIDE OF THE INLET STRUCTURE. USE HARDWARE CLOTH OR COMPARABLE WIRE MESH WITH 1/2 INCH OPENINGS. IF MORE THAN ONE STRIP OF MESH IS NECESSARY, OVERLAP THE STRIPS. PLACE FILTER FABRIC OVER WIRE MESH.
- 5. PLACE 3/4 INCH GRAVEL OVER THE WIRE MESH. THE DEPTH OF STONE SHALL BE AT LEAST 12 INCHES OVER THE ENTIRE INLET OPENING. EXTEND THE STONE BEYOND THE INLET OPENING AT LEAST 18 INCHES ON ALL SIDES.
- 6. IF THE STONE FILTER BECOMES CLOGGED WITH SEDIMENT, THE STONES MUST BE PULLED AWAY FROM THE INLET AND CLEANED OR REPLACED.

CONSTRUCTION ENTRANCE NOTES

- 1. MATERIAL SHALL BE 4" TO 6" QUARRY SPALLS. (STANDARD SPECIFICATIONS).
- 2. THE ROCK PAD SHALL BE AT LEAST 12 INCHES THICK AND 100 FEET LONG. WIDTH SHALL BE THE FULL WIDTH OF THE VEHICLE INGRESS AND EGRESS AREA. SMALLER PADS MAY BE APPROVED FOR SINGLE-FAMILY RESIDENTIAL AND SMALL COMMERCIAL SITES.
- 3. ADDITIONAL ROCK SHALL BE ADDED PERIODICALLY TO MAINTAIN PROPER FUNCTION OF THE PAD.
- 4. IF THE CONSTRUCTION ENTRANCE FAILS TO REMOVE SEDIMENT, A WHEEL WASHING STATION WILL BE REQUIRED.

CITY OF TUMWATER STANDARD CONSTRUCTION POLLUTION PREVENTION NOTES

- 1. APPROVAL OF THIS CONSTRUCTION SWPPP DOES NOT CONSTITUTE AN APPROVAL OF PERMANENT ROAD OR DRAINAGE DESIGN (E.G., SIZE AND LOCATION OF ROADS, PIPES, RESTRICTORS, CHANNELS, RETENTION/DETENTION/INFILTRATION FACILITIES.
- 2. THE IMPLEMENTATION OF THIS CONSTRUCTION SWPPP AND THE CONSTRUCTION, MAINTENANCE, REPLACEMENT, AND UPGRADING OF THESE CONSTRUCTION SWPPP FACILITIES IS THE RESPONSIBILITY OF THE APPLICANT/CONTRACTOR UNTIL ALL CONSTRUCTION IS COMPLETED AND APPROVED AND VEGETATION/LANDSCAPING IS ESTABLISHED.
- 3. THE BOUNDARIES OF THE CLEARING LIMITS SHOWN ON THIS PLAN SHALL BE CLEARLY FLAGGED IN THE FIELD PRIOR TO CONSTRUCTION. DURING THE CONSTRUCTION PERIOD, NO DISTURBANCE BEYOND THE FLAGGED CLEARING LIMITS SHALL BE PERMITTED. THE FLAGGING SHALL BE MAINTAINED BY THE APPLICANT/CONTRACTOR FOR THE DURATION OF CONSTRUCTION.
- 4. THE CONSTRUCTION SWPPP FACILITIES SHOWN ON THIS PLAN MUST BE CONSTRUCTED IN CONJUNCTION WITH ALL CLEARING AND GRADING ACTIVITIES, AND IN SUCH A MANNER AS TO ENSURE THAT SEDIMENT AND SEDIMENT LADEN WATER DO NOT ENTER THE DRAINAGE SYSTEM, ROADWAYS, OR VIOLATE APPLICABLE WATER STANDARDS.
- 5. THE CONSTRUCTION SWPPP FACILITIES SHOWN ON THIS PLAN ARE THE MINIMUM REQUIREMENTS FOR ANTICIPATED SITE CONDITIONS. DURING THE CONSTRUCTION PERIOD, THESE ESC FACILITIES SHALL BE UPGRADED AS NEEDED FOR UNEXPECTED STORM EVENTS AND TO ENSURE THAT SEDIMENT AND SEDIMENT-LADEN WATER DO NOT LEAVE THE SITE.
- 6. THE CONSTRUCTION SWPPP FACILITIES SHALL BE INSPECTED DAILY BY THE APPLICANT/CONTRACTOR AND MAINTAINED AS NECESSARY TO ENSURE THEIR CONTINUED FUNCTIONING.
- 7. THE CONSTRUCTION SWPPP FACILITIES ON INACTIVE SITES SHALL BE INSPECTED AND MAINTAINED A MINIMUM OF ONCE A MONTH OR WITHIN THE 48 HOURS FOLLOWING A MAJOR STORM EVENT.
- 8. AT NO TIME SHALL MORE THAN 1 FOOT OF SEDIMENT BE ALLOWED TO ACCUMULATE WITHIN A CATCH BASIN TRAP (OR SUMP). ALL CATCH BASINS AND CONVEYANCE LINES SHALL BE CLEANED PRIOR TO PAVING. THE SEDIMENT CLEANING OPERATION SHALL NOT FLUSH SEDIMENT LADEN WATER INTO THE DOWNSTREAM SYSTEM.
- 9. STABILIZED CONSTRUCTION ENTRANCES SHALL BE INSTALLED AT THE BEGINNING OF CONSTRUCTION AND MAINTAINED FOR THE DURATION OF THE PROJECT. ADDITIONAL MEASURES MAY BE REQUIRED TO ENSURE THAT ALL PAVED AREAS ARE KEPT CLEAN FOR THE DURATION OF THE PROJECT.
- 10. DURING THE WET SEASON (OCTOBER TO APRIL INCLUSIVE) UNWORKED SOILS ARE TO BE COVERED AFTER TWO DAYS AND DURING THE DRY SEASON UNWORKED SOILS ARE TO BE COVERED AFTER SEVEN DAYS USING THE APPLICABLE BMPs IN THE

FLOW LINE GRADE 1% MIN

SURFACE AREA DETERMINED AT TOP OF WEIR 1' MIN. OVERFLOW 3.5'-5' 1.5' MIN. 3/4" - 1.5" _DISCHARGE TO STABILIZED NOTE: TRAP MAY BE FORMED BY WASHED GRAVEL CONVEYANCE, OUTLET, OR BERM OF BY PARTIAL OR LEVEL SPREADER RIP RAP— GEOTEXTILE -COMPLETE EXCAVATION. 2"-4" ROCK-

CONVEYANCE SWALE

BMP C123: PLASTIC COVERING

DESIGN AND INSTALLATION SPECIFICATIONS:

- PLASTIC SLOPE COVER MUST BE INSTALLED AS FOLLOWS:
- 1. RUN PLASTIC UP AND DOWN THE SLOPE, NOT ACROSS THE SLOPE.
- 2. PLASTIC MAY BE INSTALLED PERPENDICULAR TO A SLOPE IF THE SLOPE LENGTH IS LESS THAN 10 FEET.
- 3. PROVIDE A MINIMUM OF 8-INCH OVERLAP AT THE SEAMS.
- 4. ON LONG OR WIDE SLOPES, OR SLOPES SUBJECT TO WIND, TAPE ALL SEAMS.
- 5. PLACE PLASTIC INTO A SMALL (12-INCH WIDE BY 6-INCH DEEP) SLOT TRENCH AT THE TOP OF THE SLOPE AND BACKFILL WITH SOIL TO KEEP WATER FROM FLOWING UNDERNEATH.
- 6. PLACE SAND FILLED BURLAP OR GEOTEXTILE BAGS EVERY 3 TO 6 FEET ALONG SEAMS AND TIE THEM TOGETHER WITH TWINE TO HOLD THEM IN
- 7. INSPECT PLASTIC FOR RIPS, TEARS, AND OPEN SEAMS REGULARLY AND REPAIR IMMEDIATELY. THIS PREVENTS HIGH VELOCITY RUNOFF FROM CONTACTING BARE SOIL, WHICH CAUSES EXTREME EROSION.
- 8. SANDBAGS MAY BE LOWERED INTO PLACE TIED TO ROPES. HOWEVER, ALL SANDBAGS MUST BE STAKED IN PLACE.
- PLASTIC SHEETING SHALL HAVE A MINIMUM THICKNESS OF 6 MIL.
- IF EROSION AT THE TOE OF A SLOPE IS LIKELY, A GRAVEL BERM, RIPRAP, OR OTHER SUITABLE PROTECTION SHALL BE INSTALLED AT THE TOE OF THE SLOPE IN ORDER TO REDUCE THE VELOCITY OF RUNOFF.

MAINTENANCE STANDARDS:

- TORN SHEETS MUST BE REPLACED AND OPEN SEAMS REPAIRED.
- COMPLETELY REMOVE AND REPLACE THE PLASTIC IF IT BEGINS TO DETERIORATE DUE TO ULTRAVIOLET RADIATION.
- COMPLETELY REMOVE PLASTIC WHEN NO LONGER NEEDED.

WOOD OR METAL AKES (2 PER BALE)


10 mil PLASTIC LINING -


CALTRANS/FIG4-14.DWG SAC 8-14-02

ACTUAL LAYOUT DETERMINED IN THE FIELD.


THE CONCRETE WASHOUT SIGN (SEE FIG. 4-15)
SHALL BE INSTALLED WITHIN 10 m OF THE
TEMPORARY CONCRETE WASHOUT FACILITY.


• DISPOSE OF OLD TIRES USED TO WEIGHT DOWN PLASTIC SHEETING

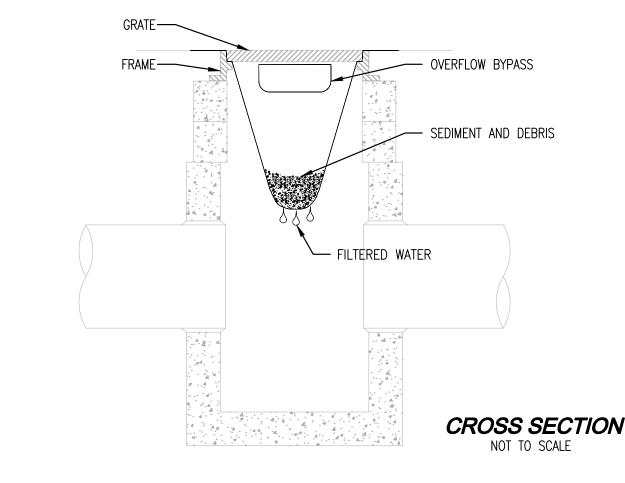

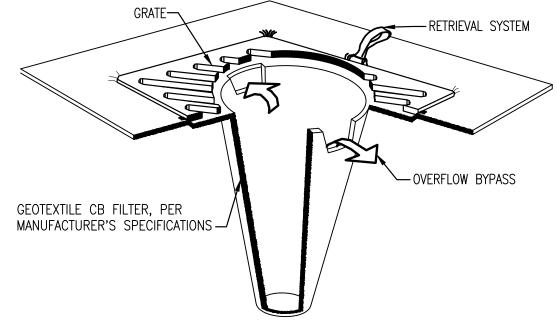

STORM DRAIN INLET PROTECTION w/ CB FILTERS

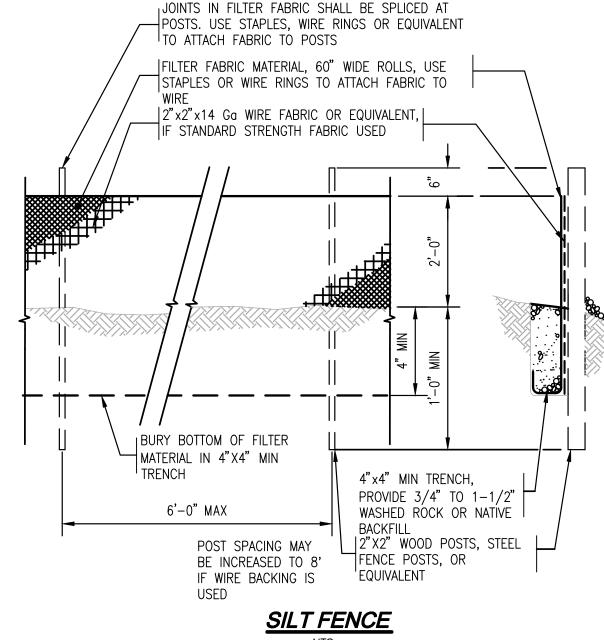

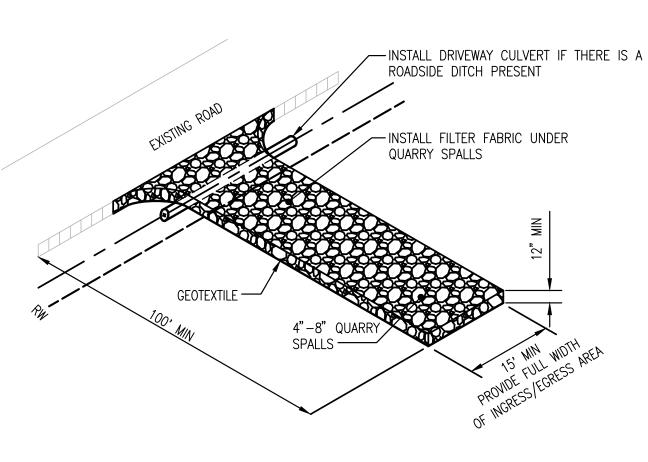

WOOD POST (89 mm x 89 mm x 2.4 m) 200 mm 3.05 mm DIA STEEL WIRE

TUM-21-1322

A PORTION OF SEC 03, TWN 17 N, RGE 2 W, W.M., THURSTON COUNTY, WASHINGTON.

Figure 3.8. Concrete Washout Area A.

CONCRETE WASHOUT SIGN DETAIL

(OR EQUIVALENT)


STAPLE DETAIL

→ 50 mm


CITY OF TUMWATER DRAINAGE DESIGN AND EROSION CONTROL MANUAL

- 10 mil PLASTIC LINING

3m MINIMUM →

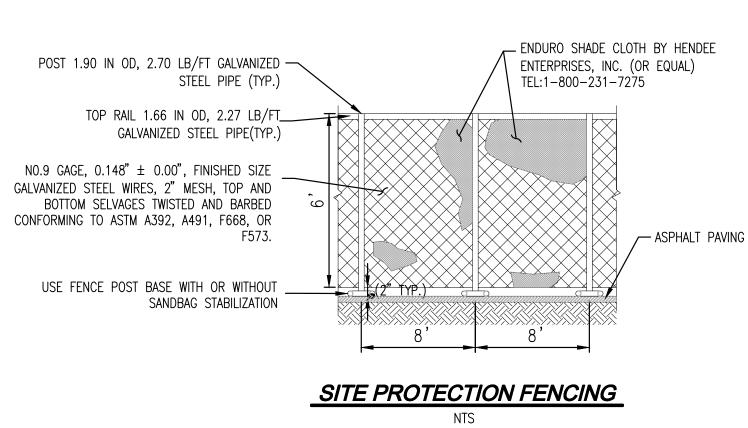

1. DRIVEWAY SHALL MEET THE REQUIREMENTS OF THE PERMITTING AGENCY. 2. IT IS RECOMMENDED THAT THE ENTRANCE BE CROWNED SO THAT RUNOFF DRAINS OFF THE PAD STABILIZED CONSTRUCTION ENTRANCE

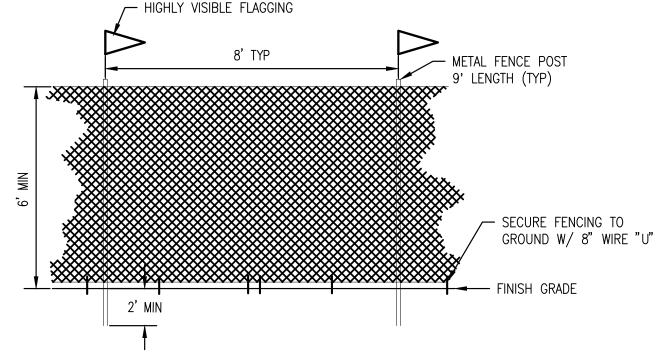

TREE PROTECTION FENCING

DISCLAIMER

TOPOGRAPHIC SURVEY INFORMATION CONTAINED ON THESE PLANS HAS BEEN PROVIDED BY HATTON GODAT PANTIER, INC. LDC, INC. (LAND DEVELOPMENT CONSULTANTS, INC.) ASSUMES NO LIABILITY AS TO THE ACCURACY AND COMPLETENESS OF THIS DATA. ANY DISCREPANCIES FOUND BETWEEN WHAT IS SHOWN ON THE PLANS AND WHAT IS NOTED IN THE FIELD SHOULD BE BROUGHT IMMEDIATELY TO THE ATTENTION OF THE

UTILITY NOTE


THE CONTRACTOR SHALL VERIFY THE LOCATION OF ALL EXISTING UTILITIES PRIOR TO ANY CONSTRUCTION. AGENCIES INVOLVED SHALL BE NOTIFIED WITHIN A REASONABLE TIME PRIOR TO THE START OF CONSTRUCTION.

Call 2 Business Days Before You Dig 811 or 1-800-424-5555 **Utilities Underground Location Center**

RTMEN ORS, Δ, ш



JOB NUMBER: DRAWING NAME: C22-229 E DESIGNER: T. BRADL DRAFTING BY: S. ORDONE OCTOBER, 2 ISCALE: AS NOTE JURISDICTION: TUMWATE

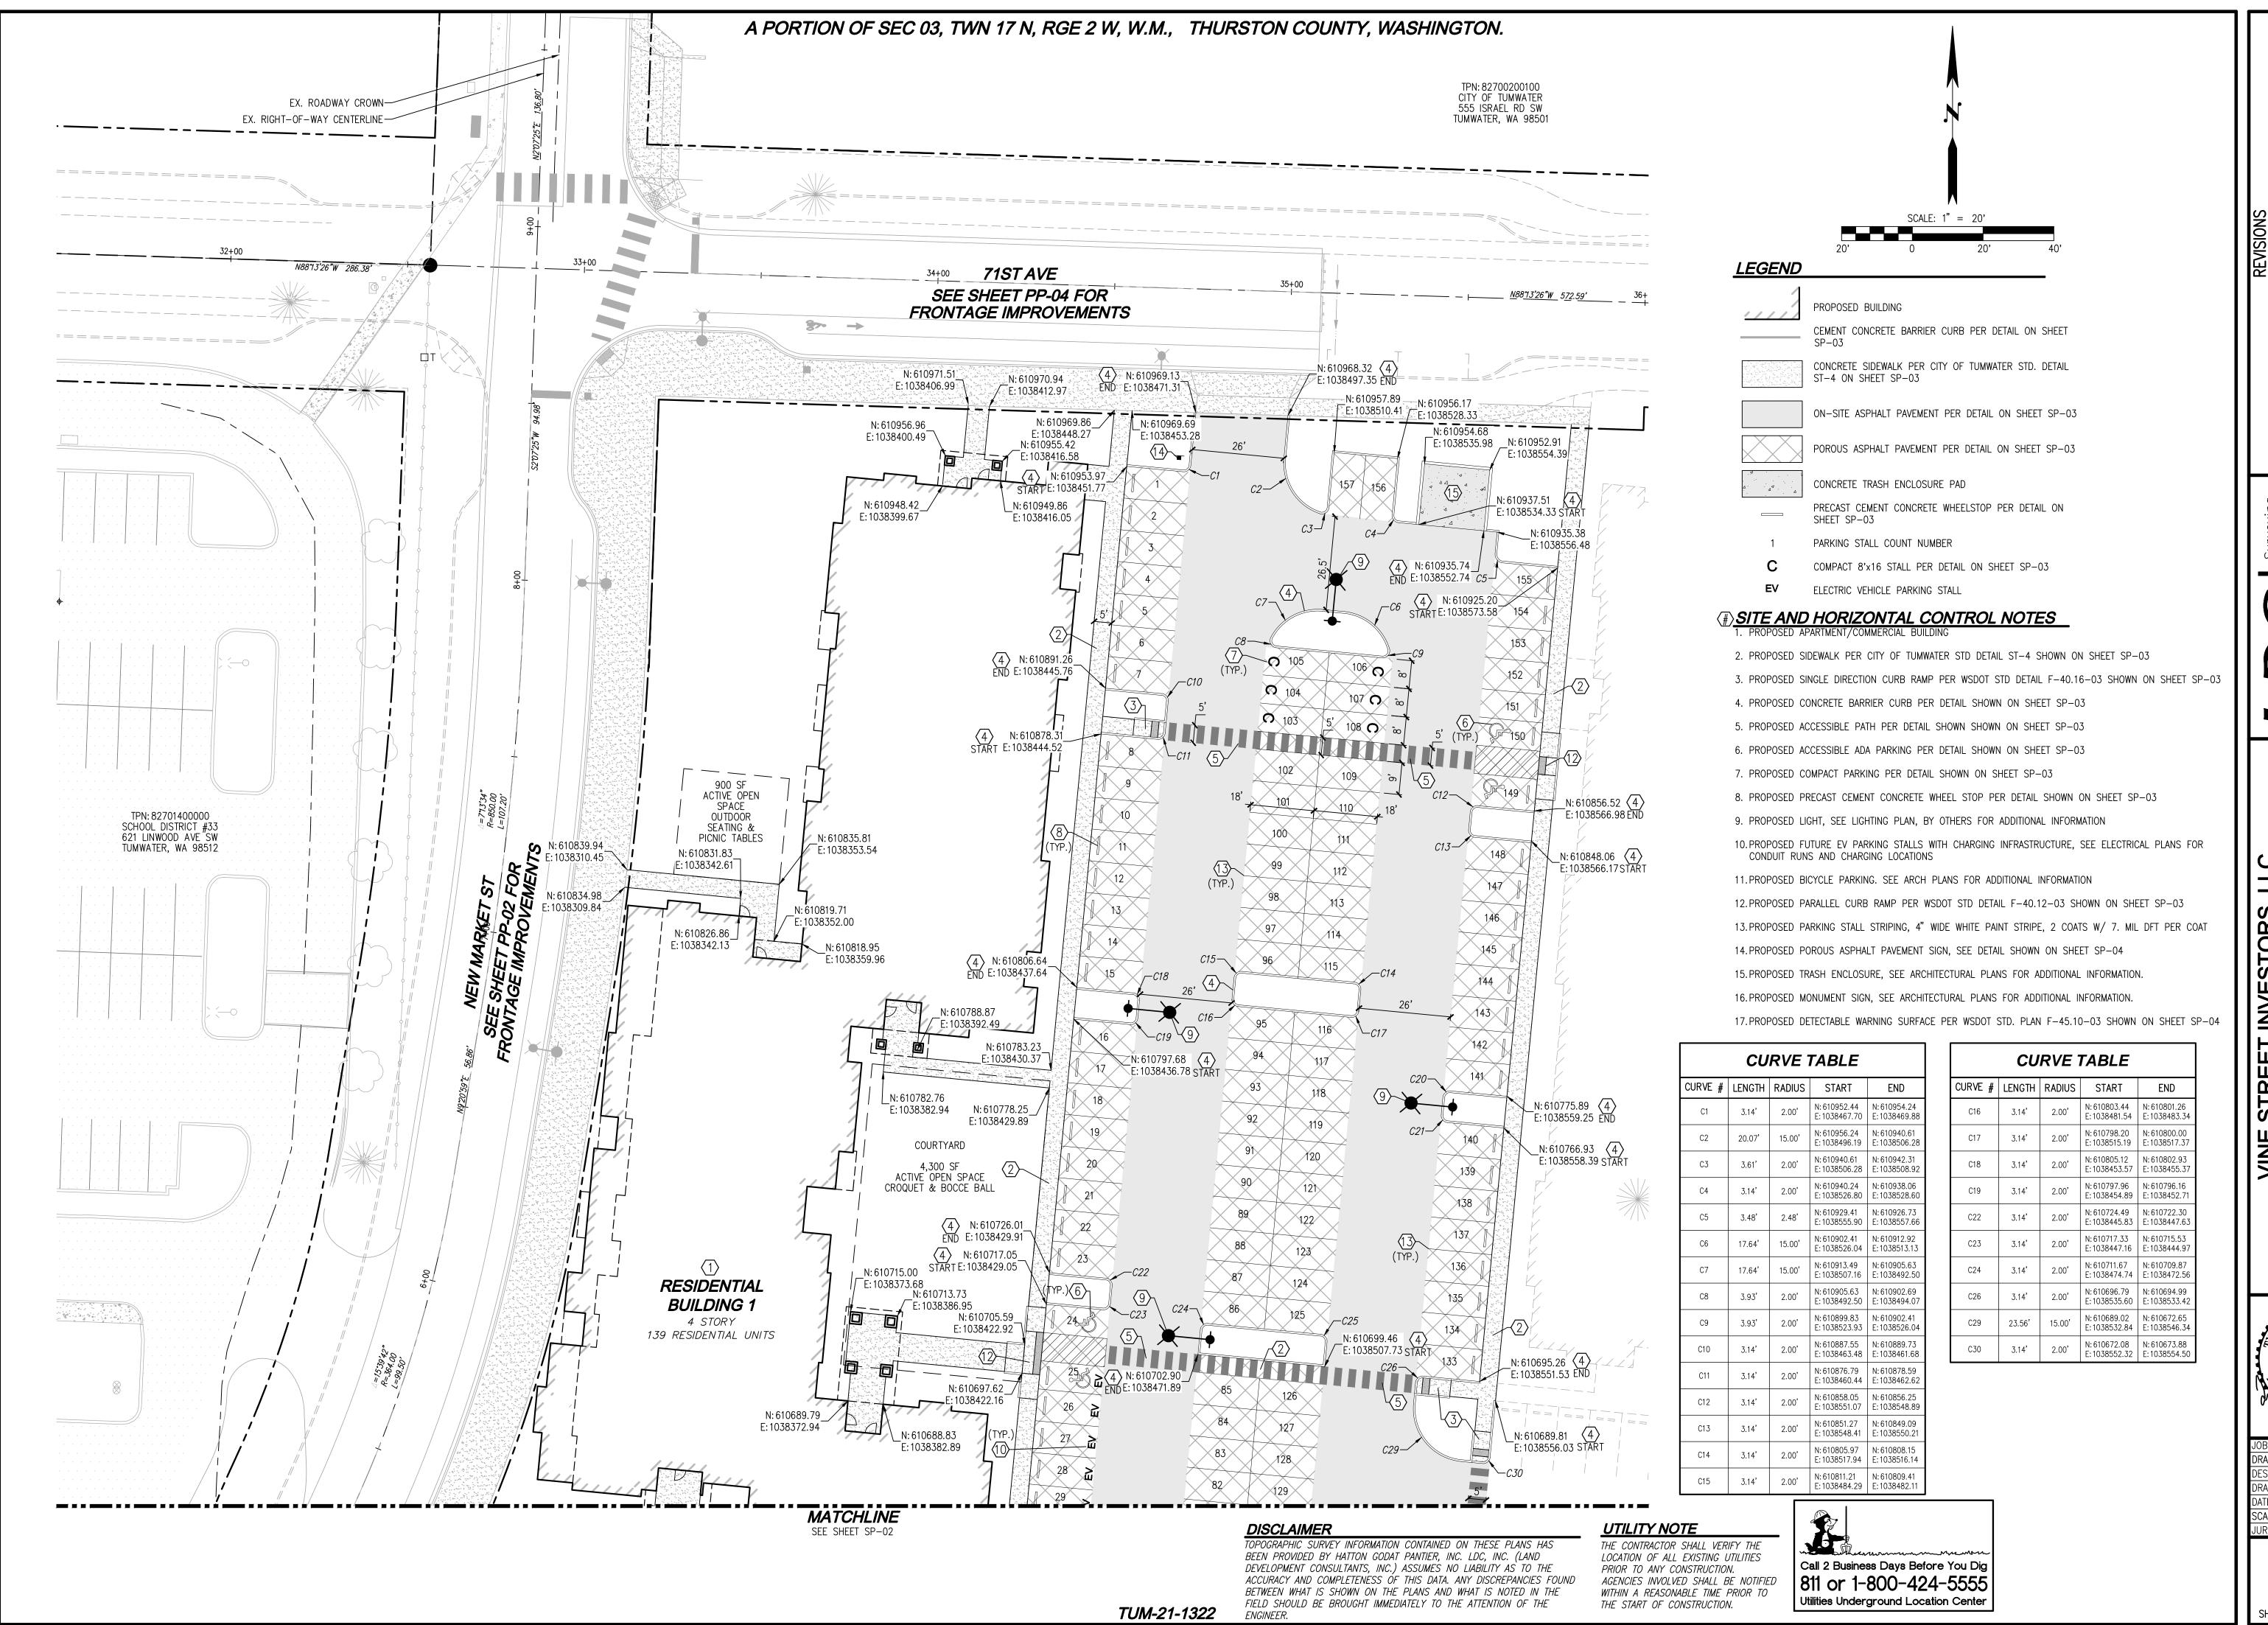

ATE DESCRIPTION BY THE DESCRIPTI

Olympia Planning
Cleveland Ave SE, Suite 209
Tumwater, WA 98501

Woodinville Olyry 321 Cleveland A Tumwater,

NE STREET INVESTORS, LLC
MARKET APARTMEN

E. BR STOSS TONAL ENGINEERINGS

JOB NUMBER: C22–22


DRAWING NAME: C22–229 SP–C

DESIGNER: T. BRADLE

DRAFTING BY: S. ORDONE

DRAWING NAME: C22-229 SP-01
DESIGNER: T. BRADLEY
DRAFTING BY: S. ORDONEZ
DATE: OCTOBER, 2023
SCALE: AS NOTED
JURISDICTION: TUMWATER

SP-01

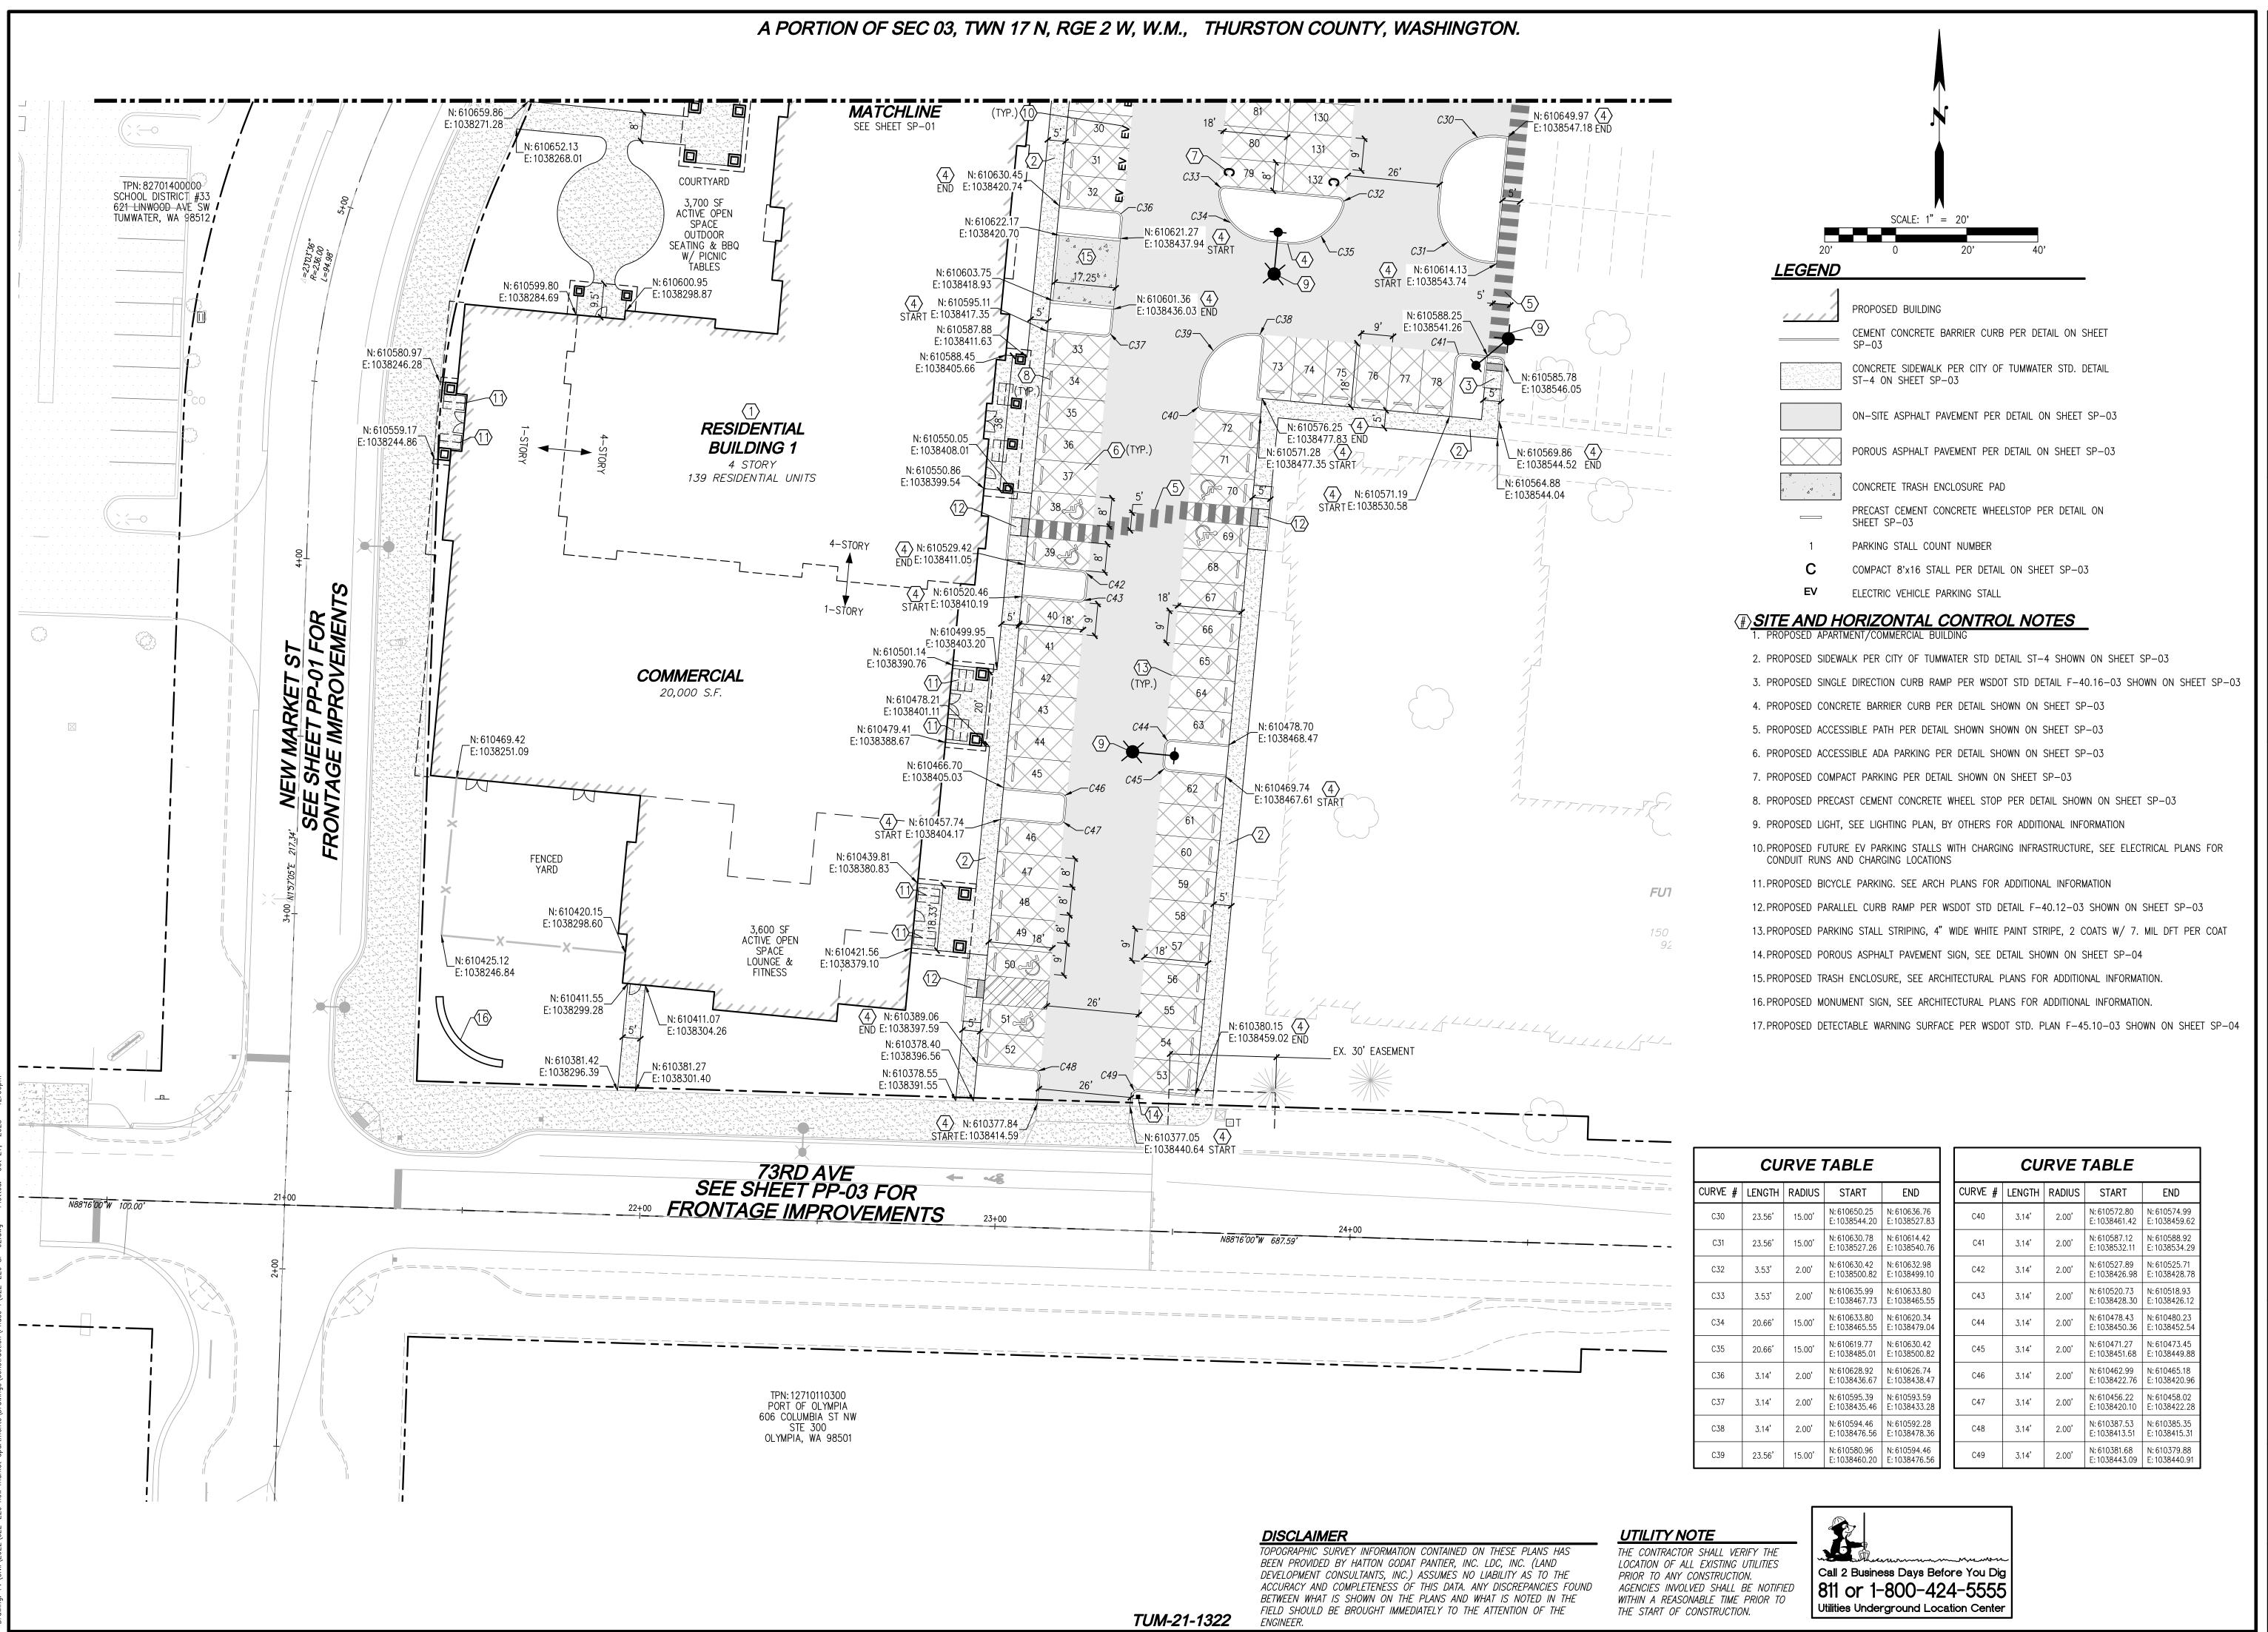

O. DATE DESCRIPTION E

Solinville Olympia K 321 Cleveland Ave SE, Suite 209 Tumwater, WA 98501


IVESTORS, LLC
APARTMENTS


MARKET APARTM


E. BR SIONAL ENGLISHED OF THE STORY OF THE


JOB NUMBER:	C22-22
DRAWING NAM	E: C22-229 SP-C
DESIGNER:	T. BRADLE
DRAFTING BY:	S. ORDONE
DATE:	OCTOBER, 202
SCALE:	AS NOTE
JURISDICTION:	TUMWATE

SP-02

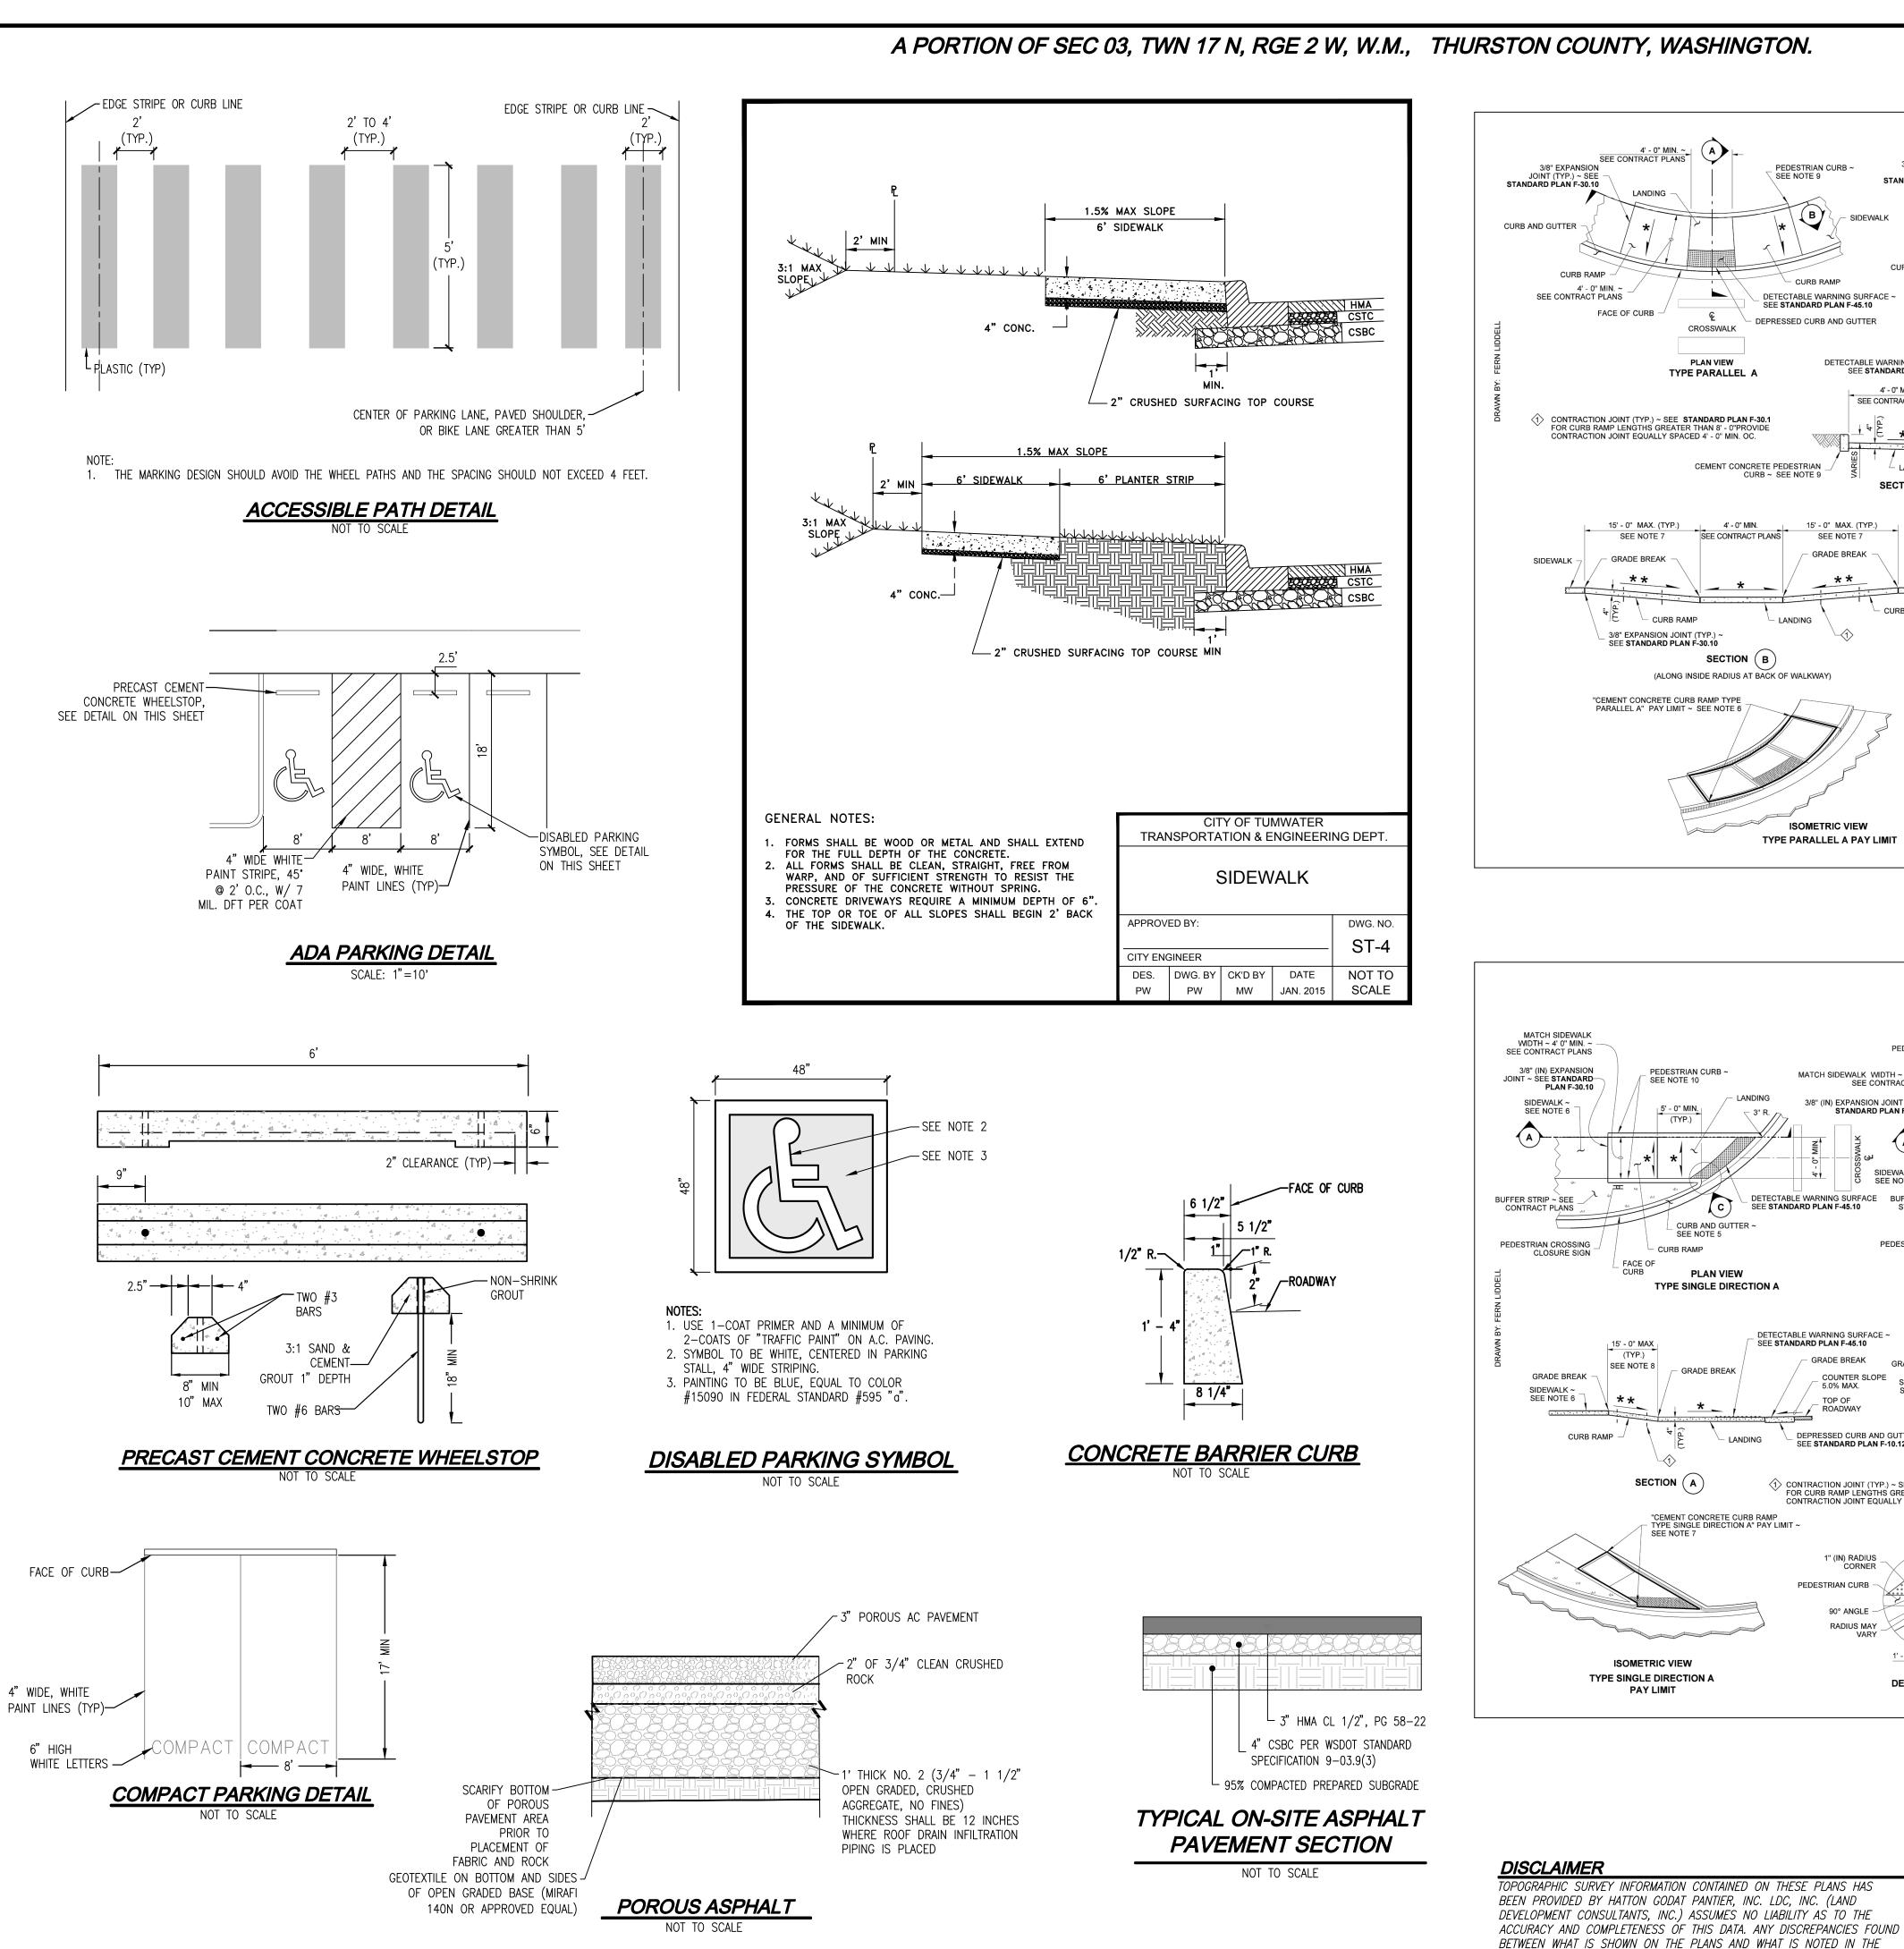

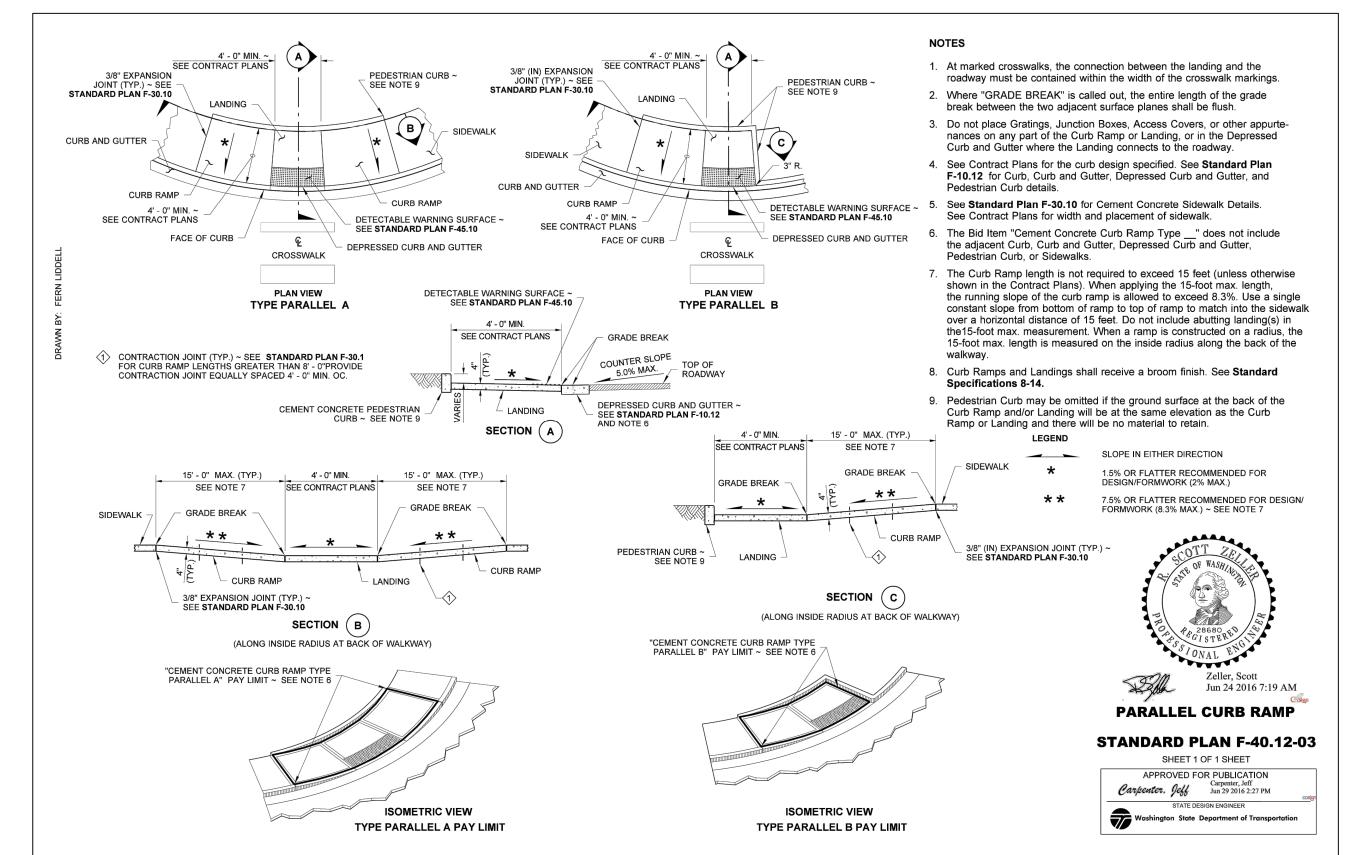

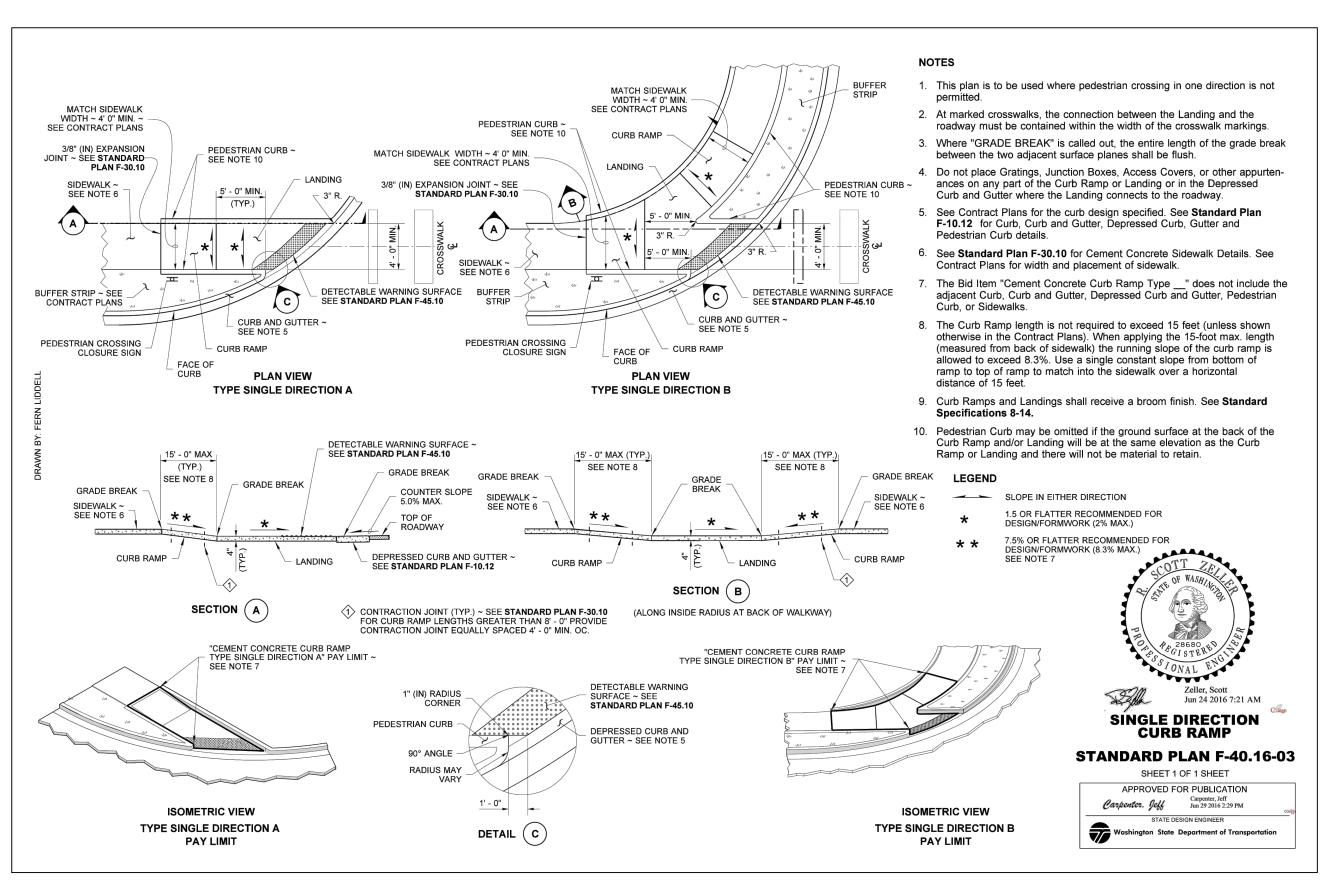

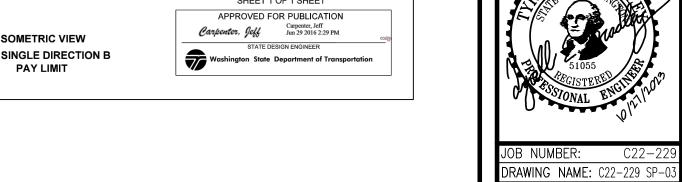

DESIGNER: T. BRADL DRAFTING BY: S. ORDON OCTOBER, AS NOT JURISDICTION: TUMWATE

ARTME

ARKE

Ž

ESTORS,

STREET

SHEET **6** OF **43**


TUM-21-1322


FIELD SHOULD BE BROUGHT IMMEDIATELY TO THE ATTENTION OF THE


UTILITY NOTE

THE CONTRACTOR SHALL VERIFY THE LOCATION OF ALL EXISTING UTILITIES PRIOR TO ANY CONSTRUCTION. AGENCIES INVOLVED SHALL BE NOTIFIED WITHIN A REASONABLE TIME PRIOR TO THE START OF CONSTRUCTION.

Call 2 Business Days Before You Dig 811 or 1-800-424-5555 **Utilities Underground Location Center**

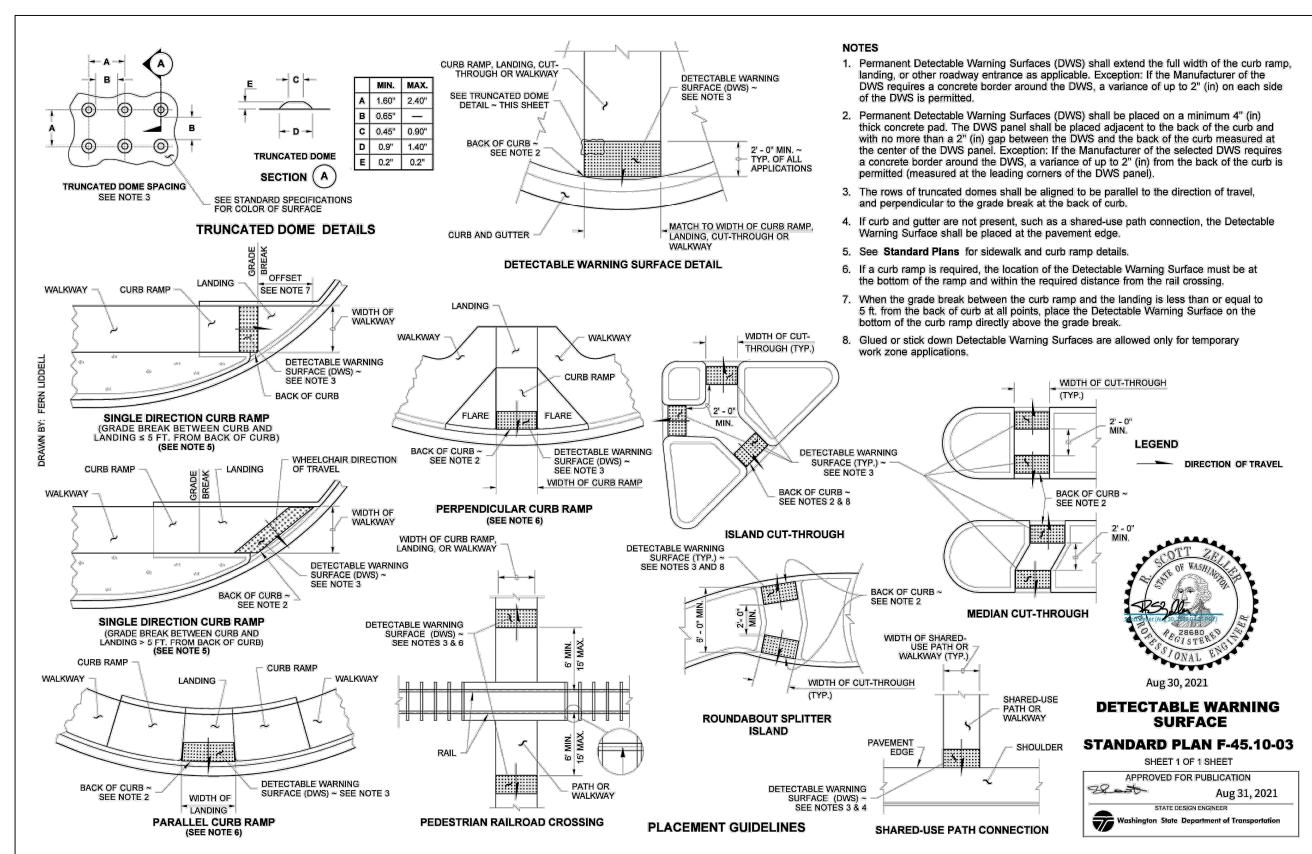


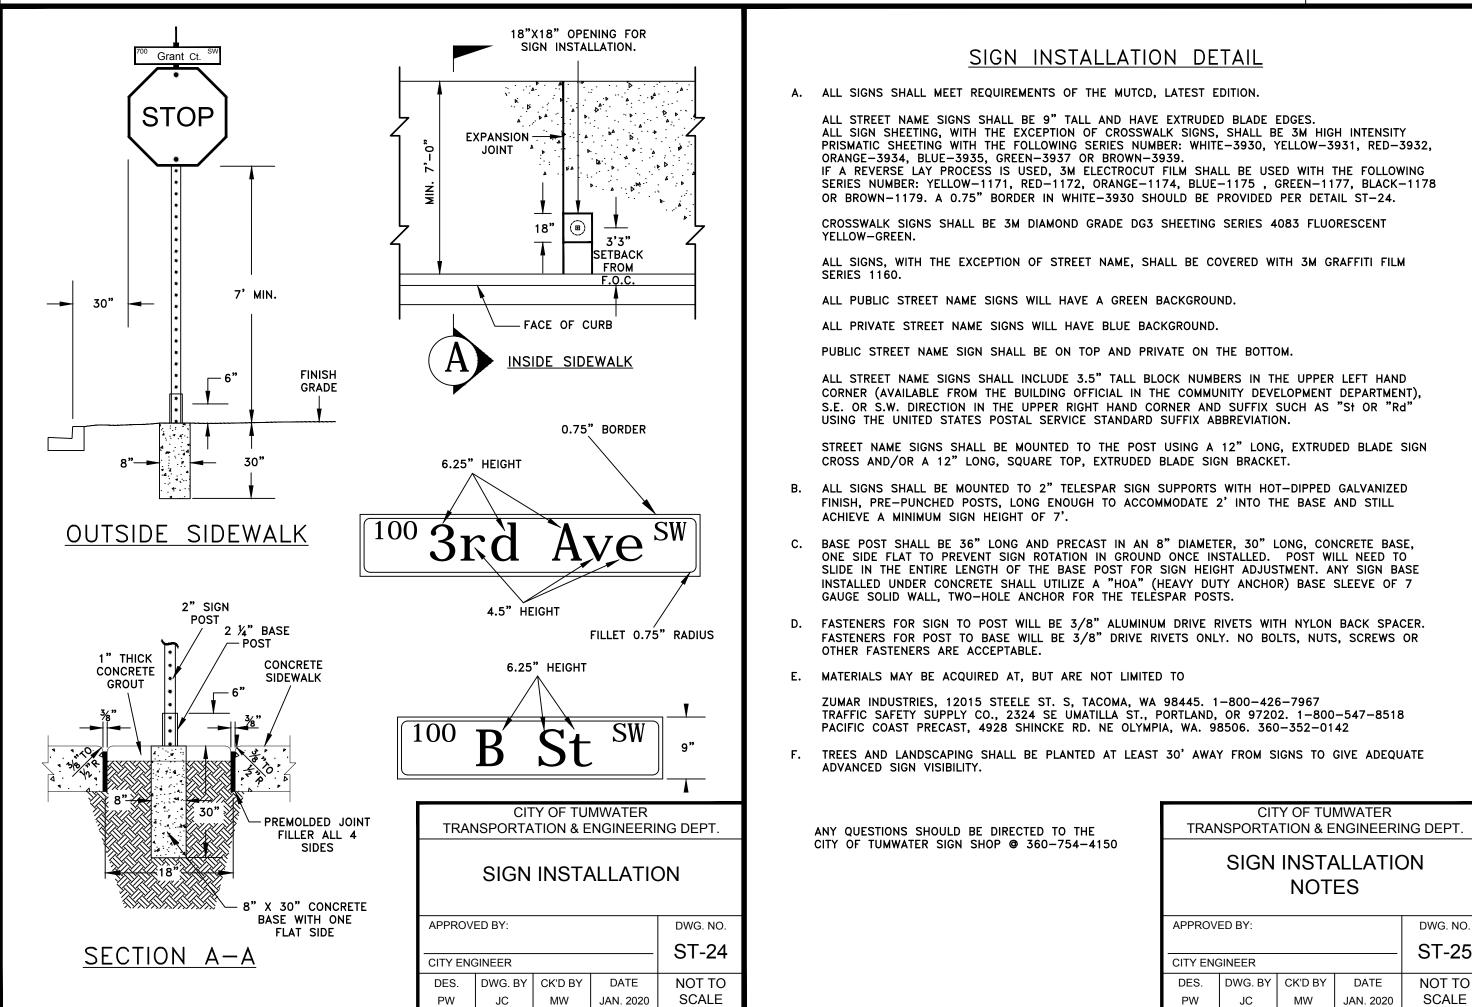

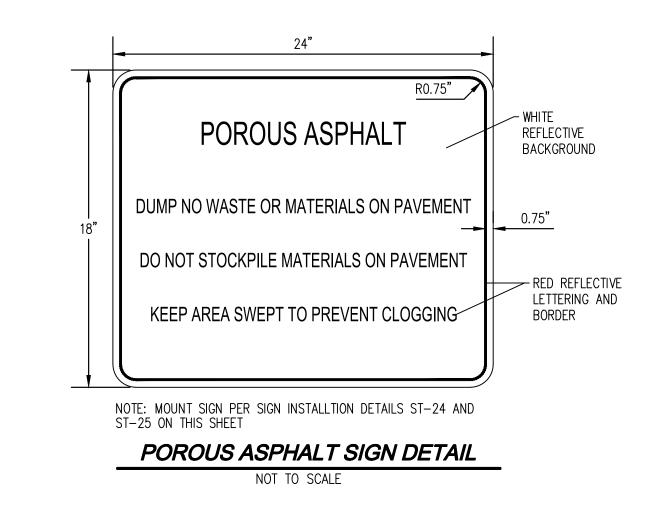

APARTMEN STREET INVESTORS,

ARKE VINE Ž

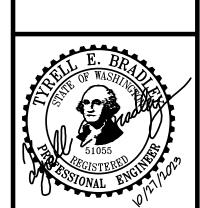

JOB NUMBER: DRAWING NAME: C22-229 SP-DESIGNER: DRAFTING BY: S. ORDONE OCTOBER, 2 SCALE: AS NOTE JURISDICTION: TUMWATE

SHEET **7** OF **43**

DISCLAIMER


TOPOGRAPHIC SURVEY INFORMATION CONTAINED ON THESE PLANS HAS BEEN PROVIDED BY HATTON GODAT PANTIER, INC. LDC, INC. (LAND DEVELOPMENT CONSULTANTS. INC.) ASSUMES NO LIABILITY AS TO THE ACCURACY AND COMPLETENESS OF THIS DATA. ANY DISCREPANCIES FOUND BETWEEN WHAT IS SHOWN ON THE PLANS AND WHAT IS NOTED IN THE FIELD SHOULD BE BROUGHT IMMEDIATELY TO THE ATTENTION OF THE


UTILITY NOTE THE CONTRACTOR SHALL VERIFY THE LOCATION OF ALL EXISTING UTILITIES PRIOR TO ANY CONSTRUCTION. AGENCIES INVOLVED SHALL BE NOTIFIED WITHIN A REASONABLE TIME PRIOR TO THE START OF CONSTRUCTION.


Call 2 Business Days Before You Dig

811 or 1-800-424-5555

Utilities Underground Location Center

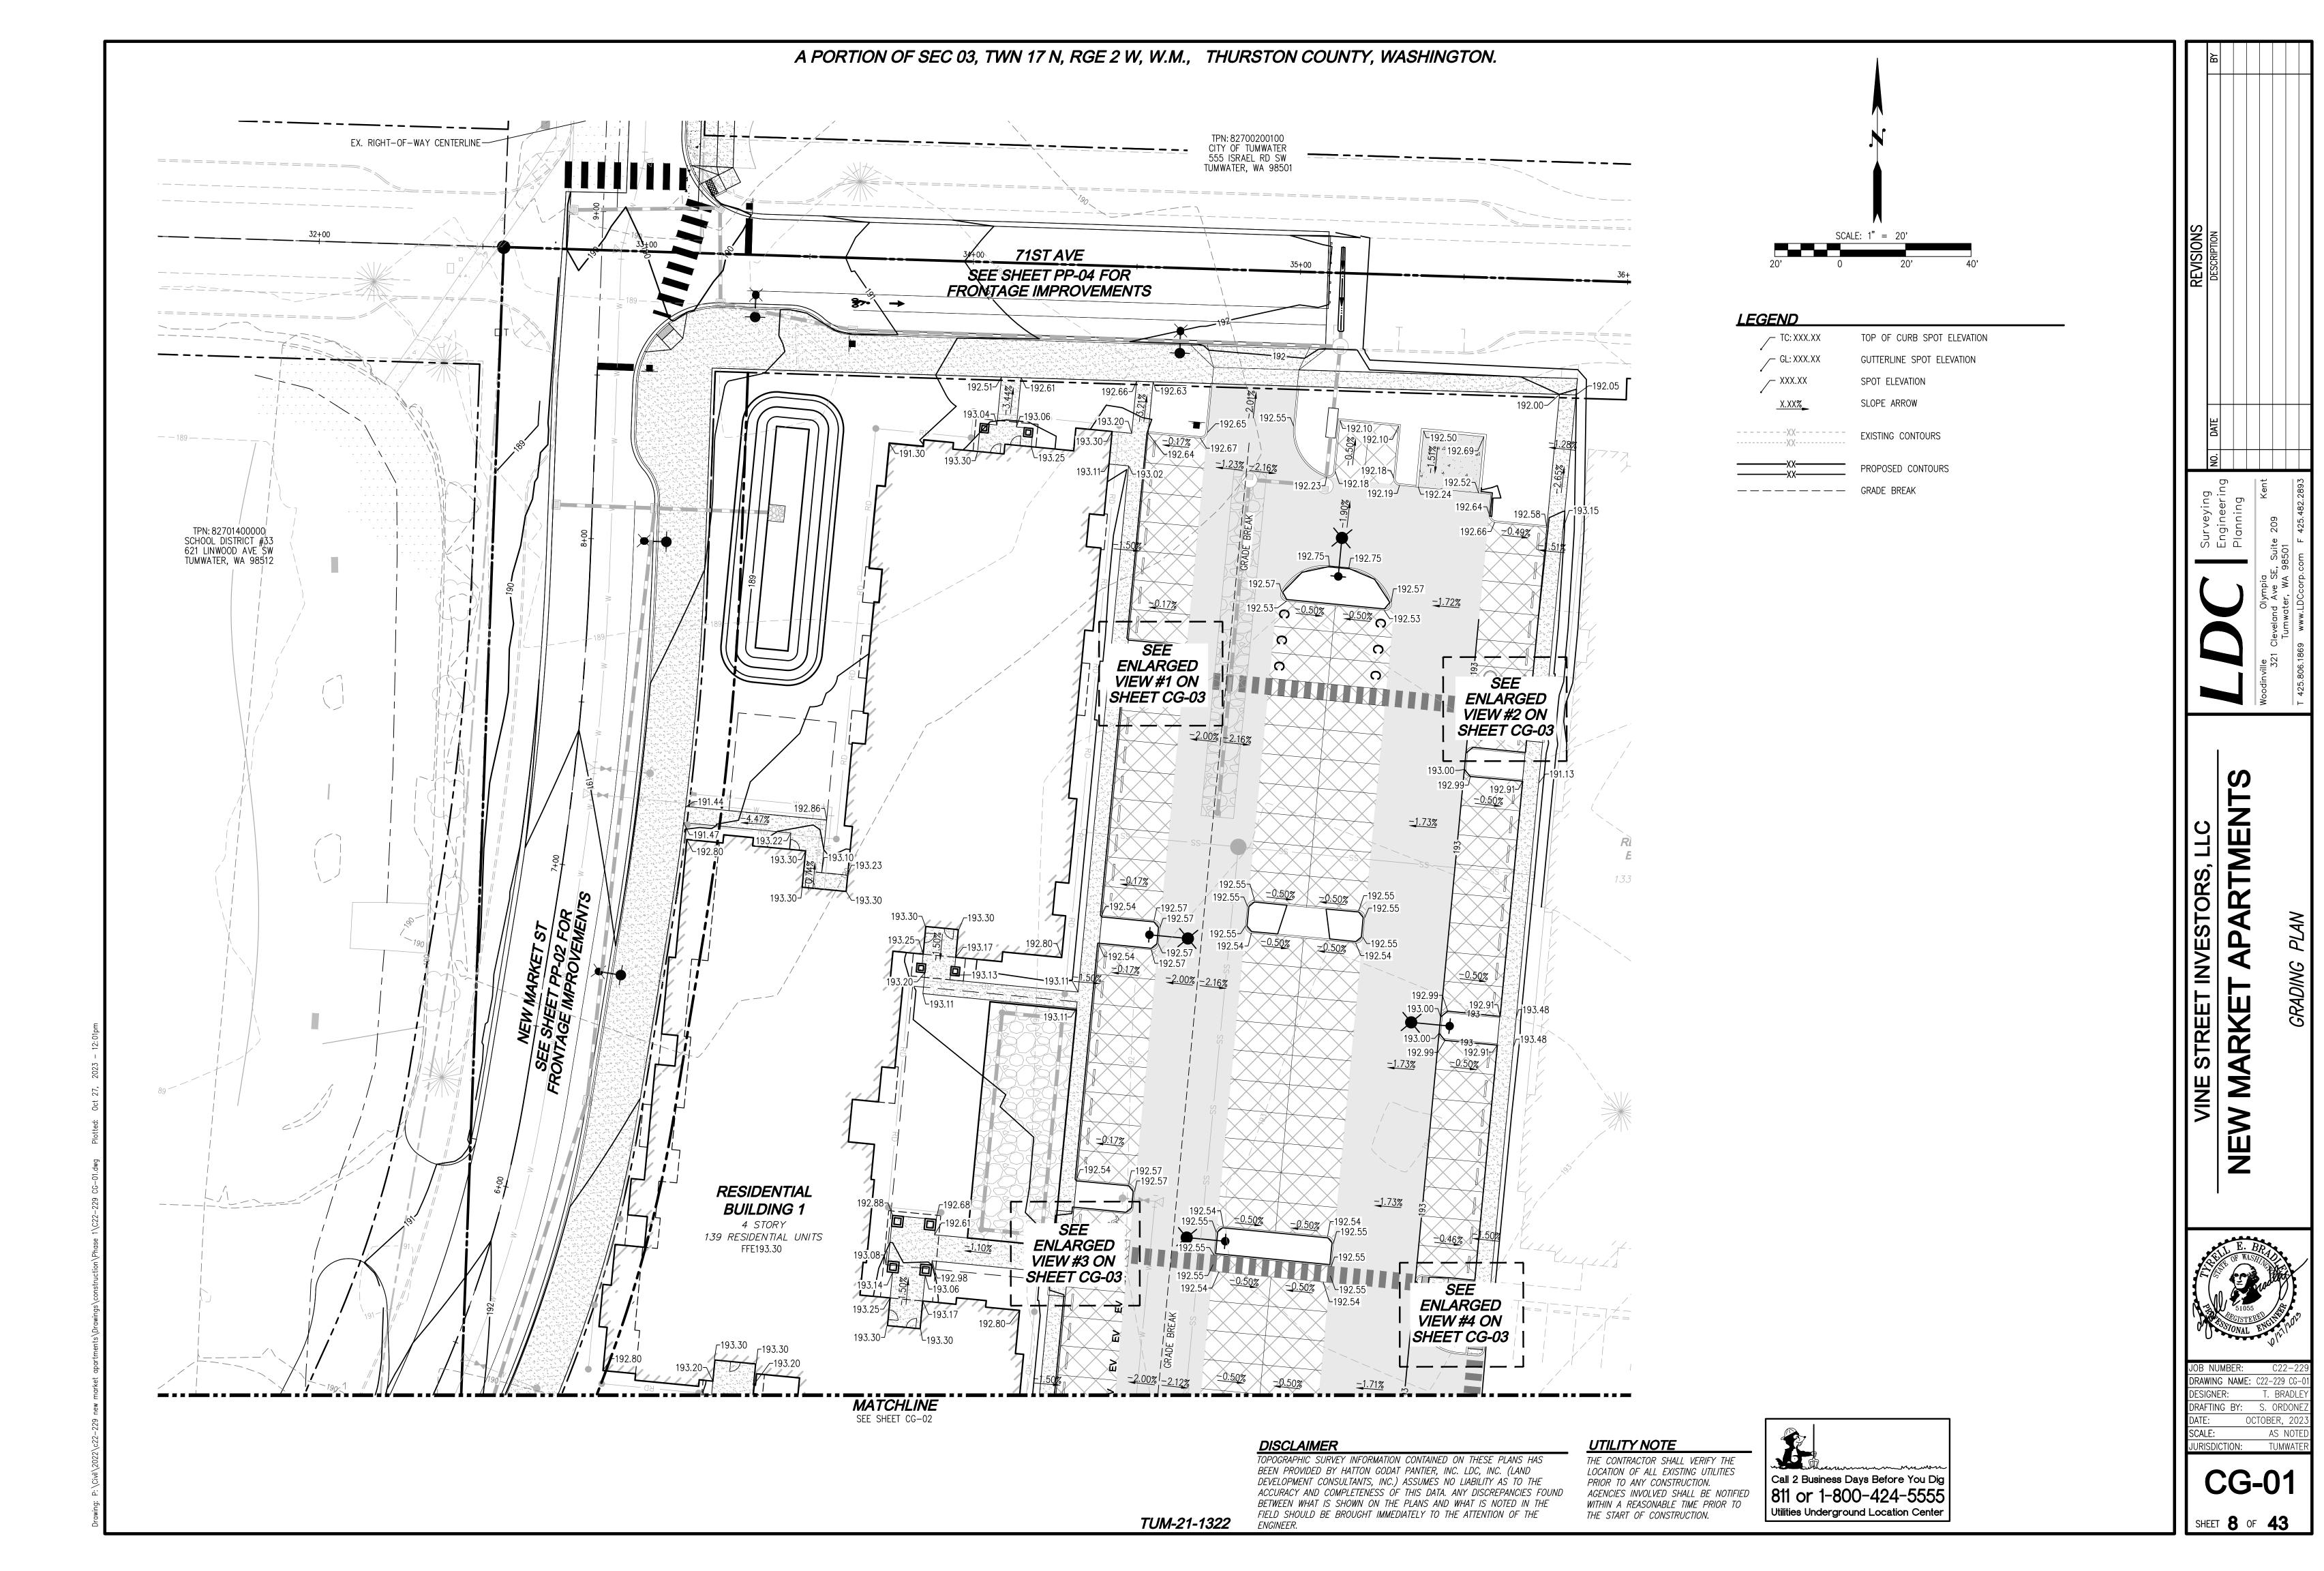

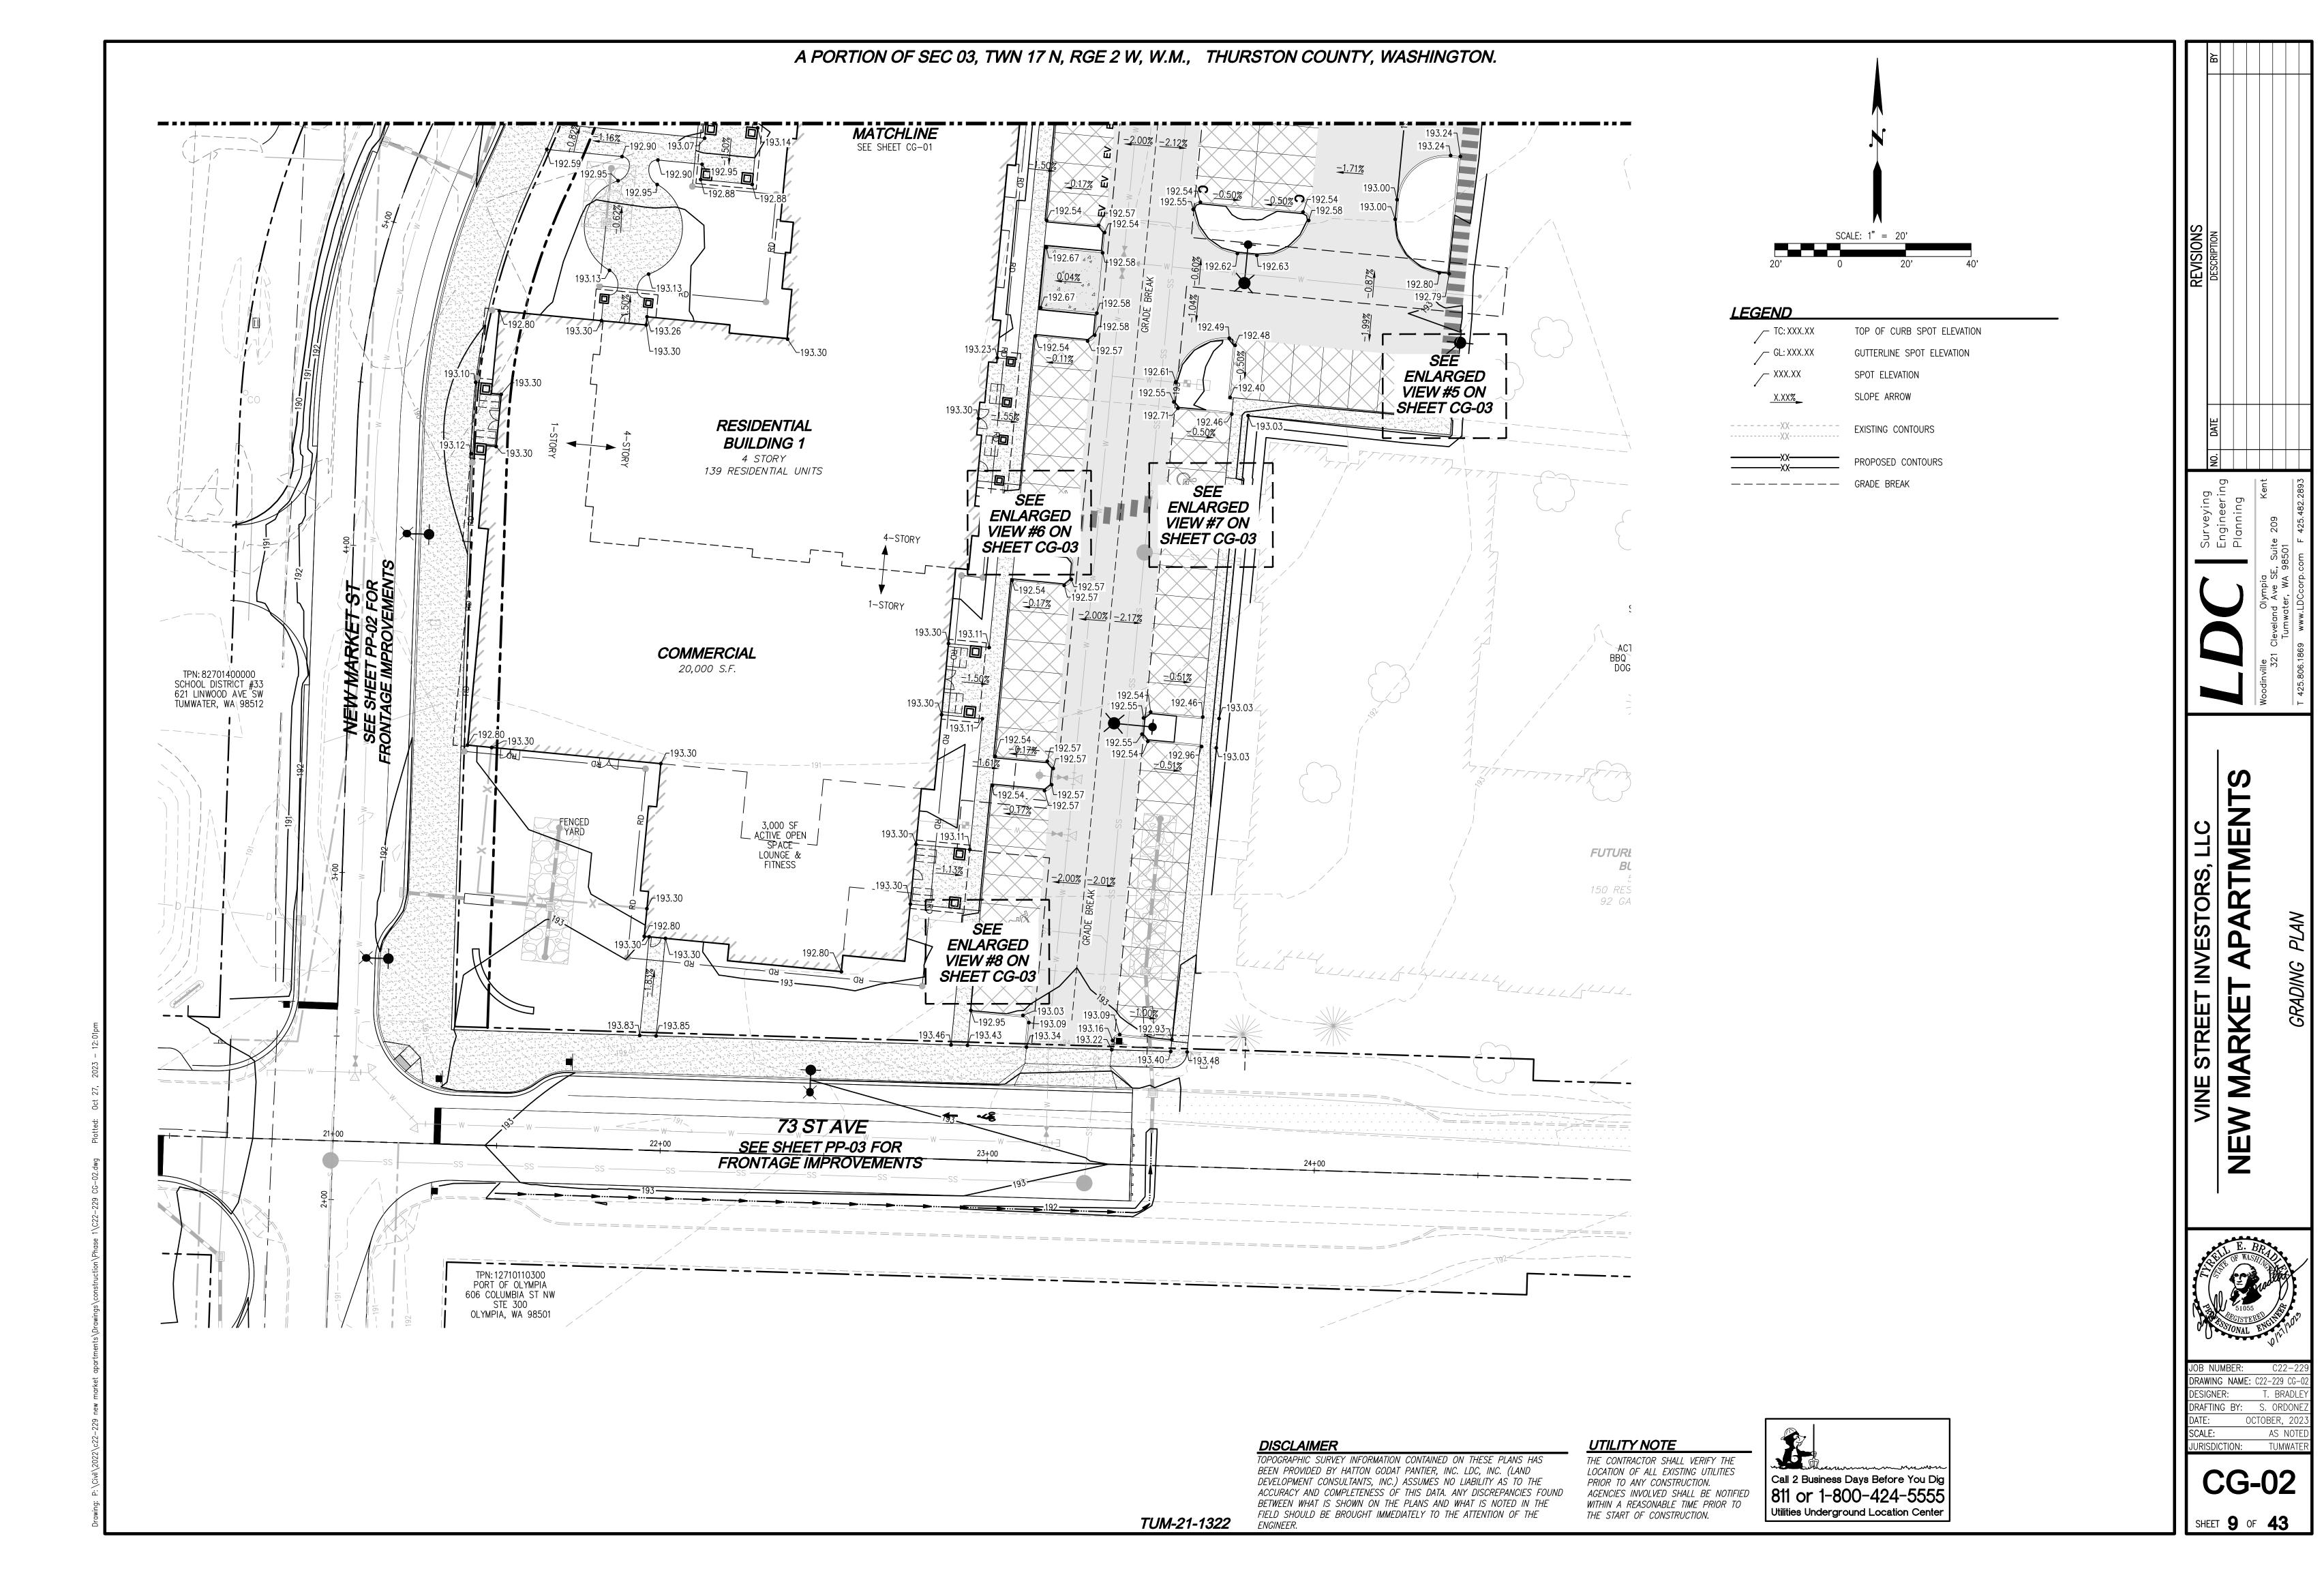

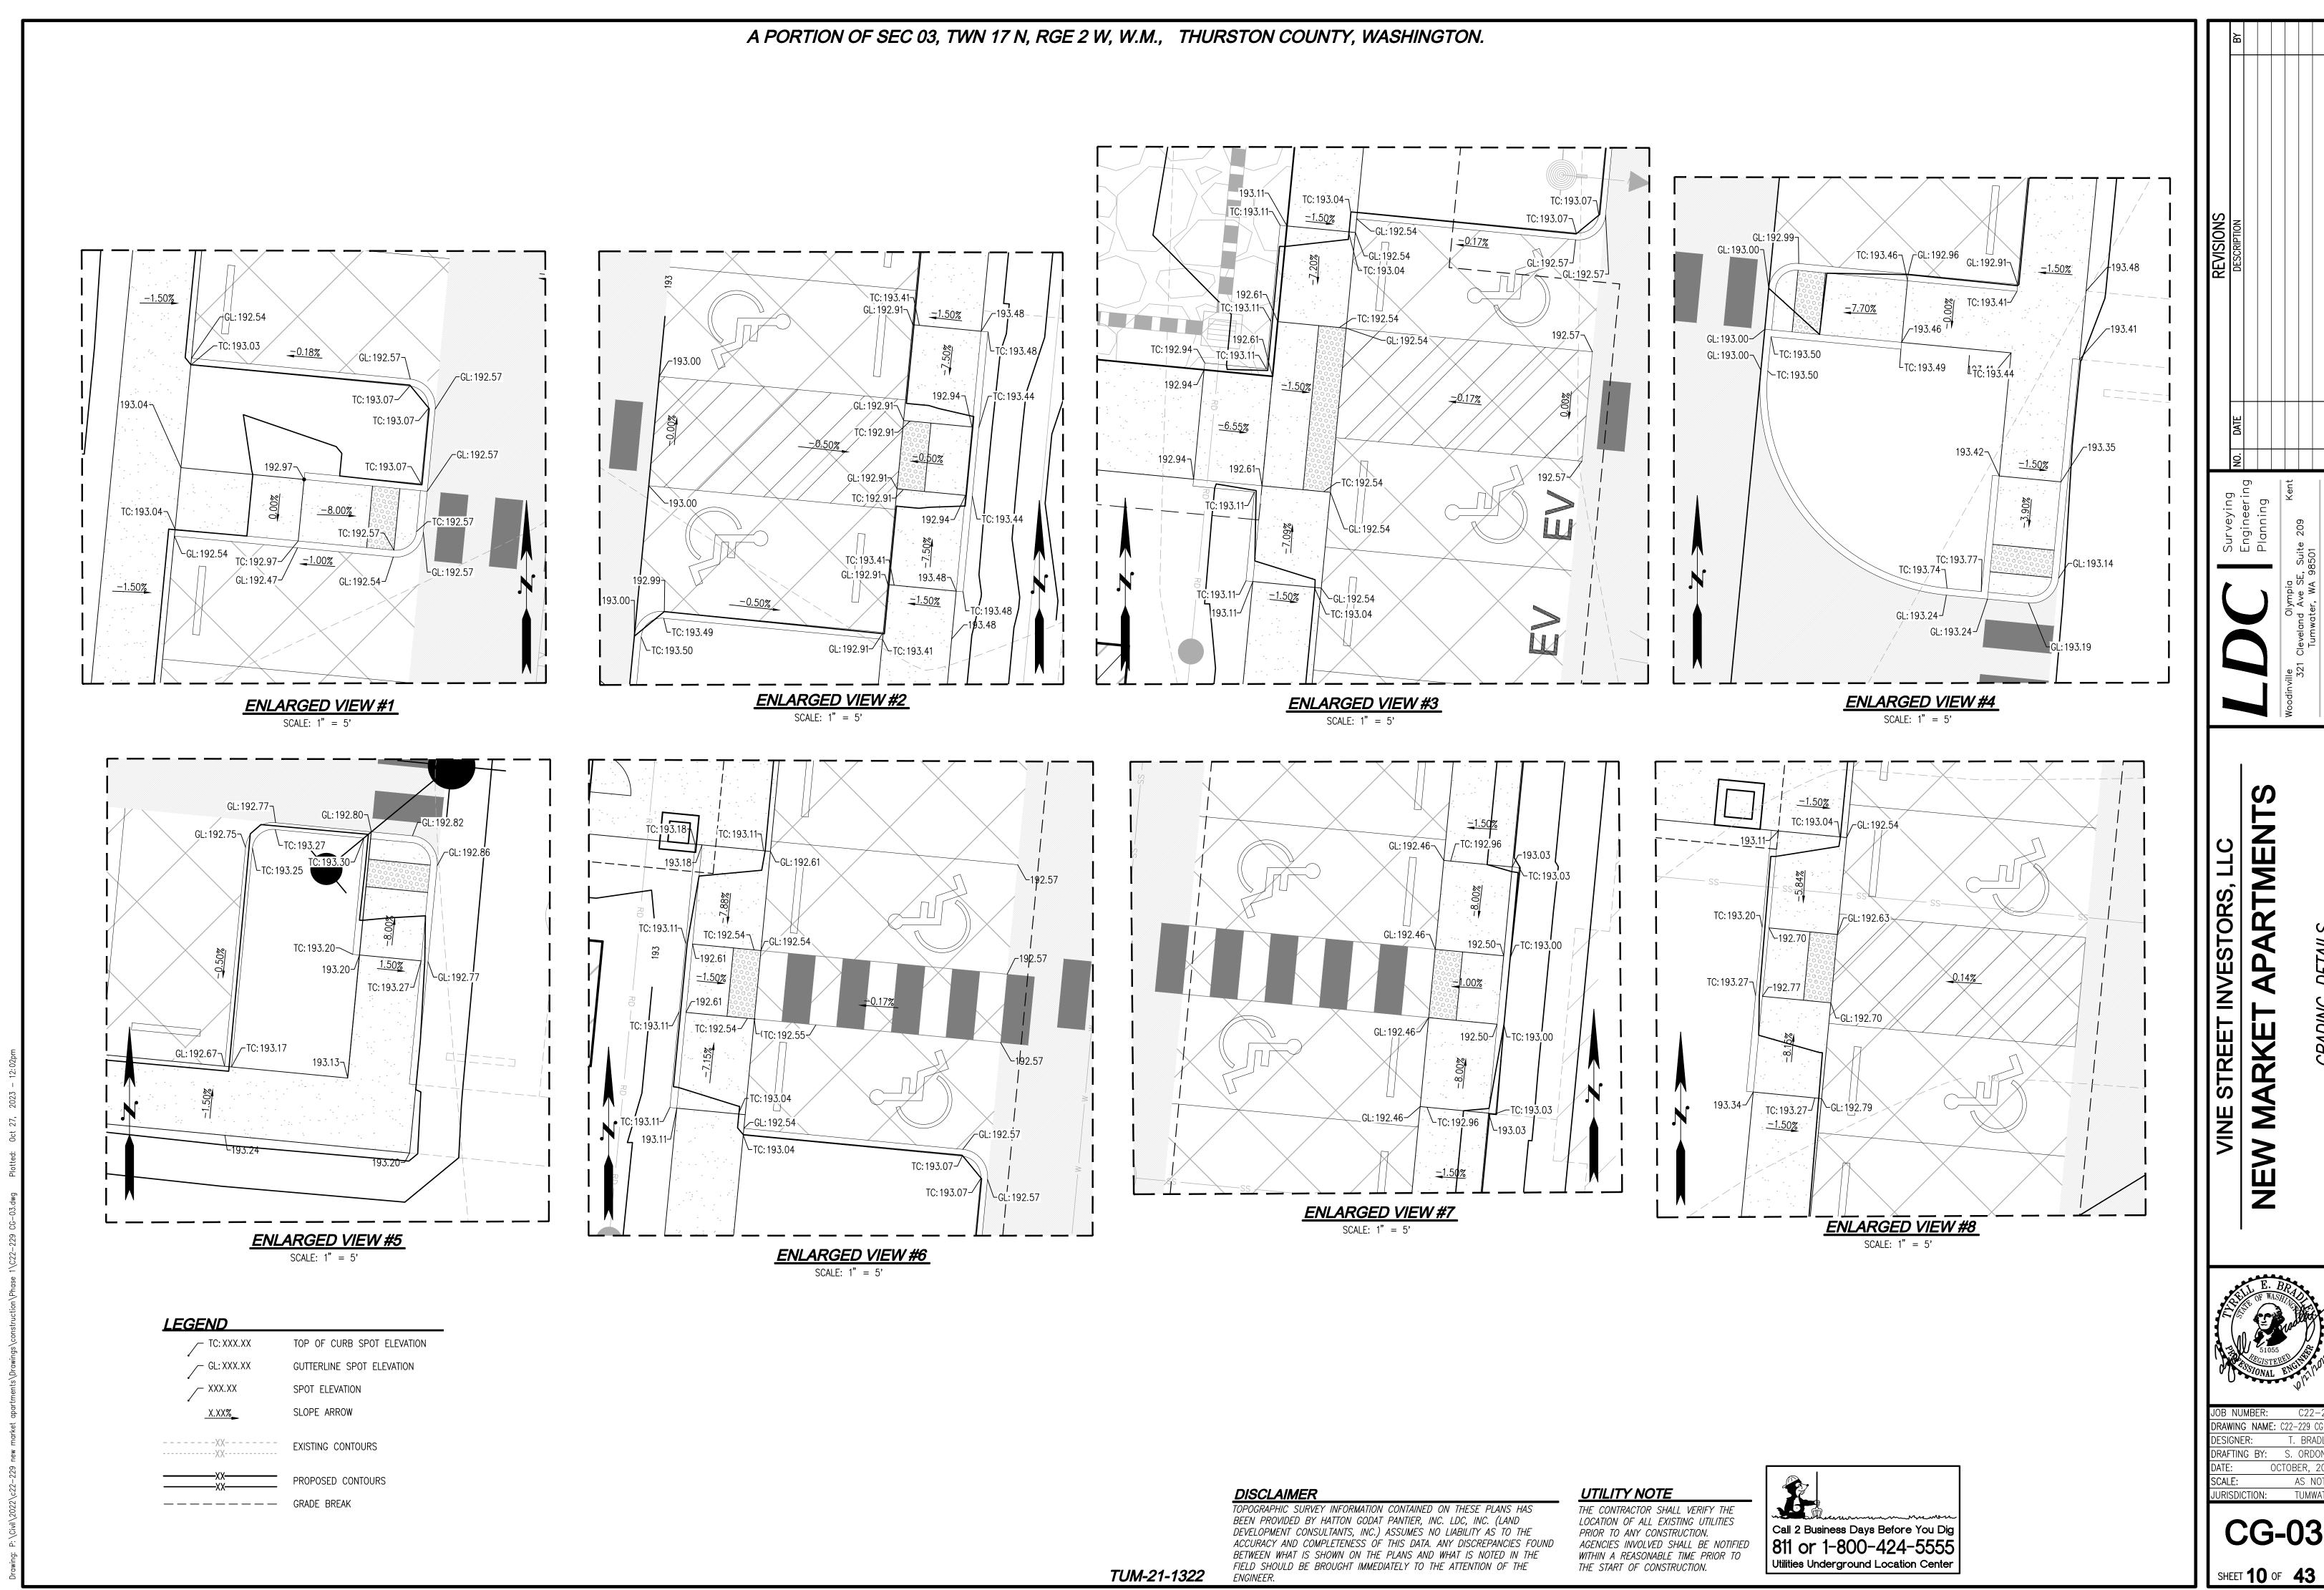


APARTMEN

MARKET

JOB NUMBER: DRAWING NAME: C22-229 CG DESIGNER: DRAFTING BY: S. ORDONE SCALE: AS NOTE JURISDICTION: TUMWATE

CG-03

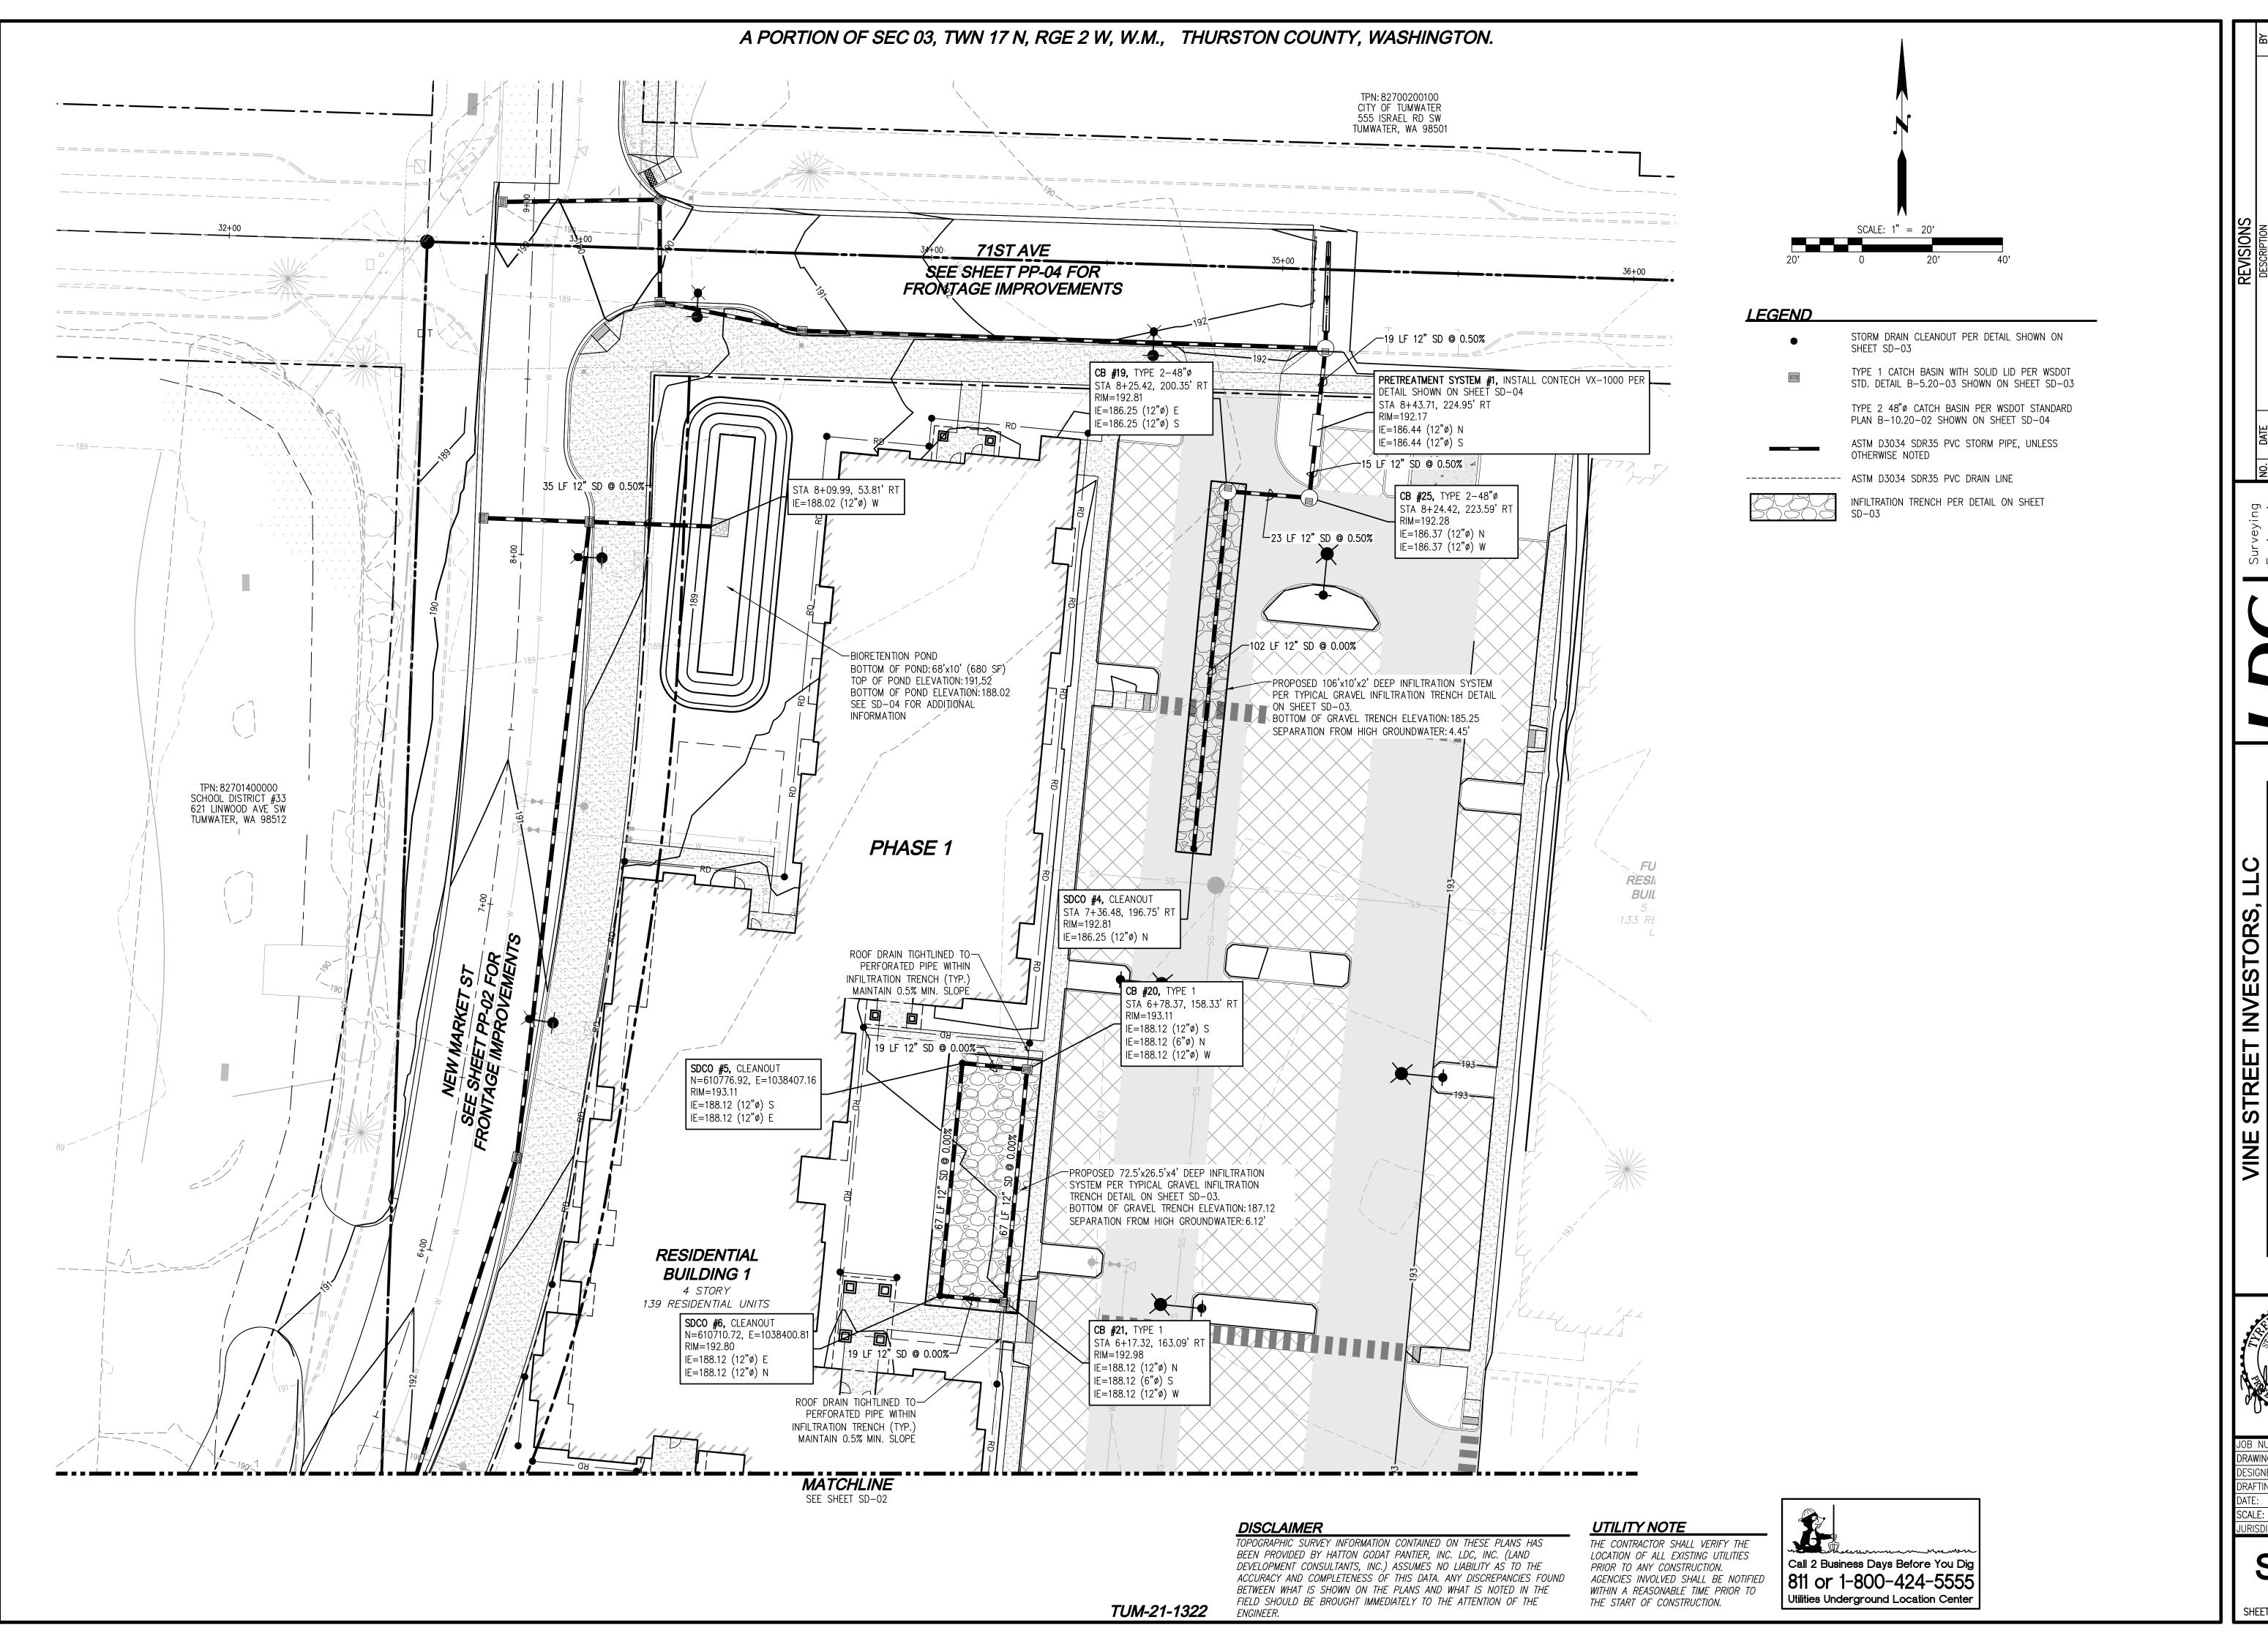

PATE DESCRIPTION

DESCRIPTION

DESCRIPTION

DESCRIPTION

DESCRIPTION

DESCRIPTION

DESCRIPTION

Engineeri
Engineeri
Planning

321 Cleveland Ave SE, Suite 209
Tumwater WA 98501

APARTMENTS L


MARKET APART



JOB NUMBER: C22-229
DRAWING NAME: C22-229 SD-01
DESIGNER: T. BRADLEY
DRAFTING BY: S. ORDONEZ
DATE: OCTOBER, 2023
SCALE: AS NOTED
JURISDICTION: TUMWATER


SD-01

SHEET **11** OF **43**

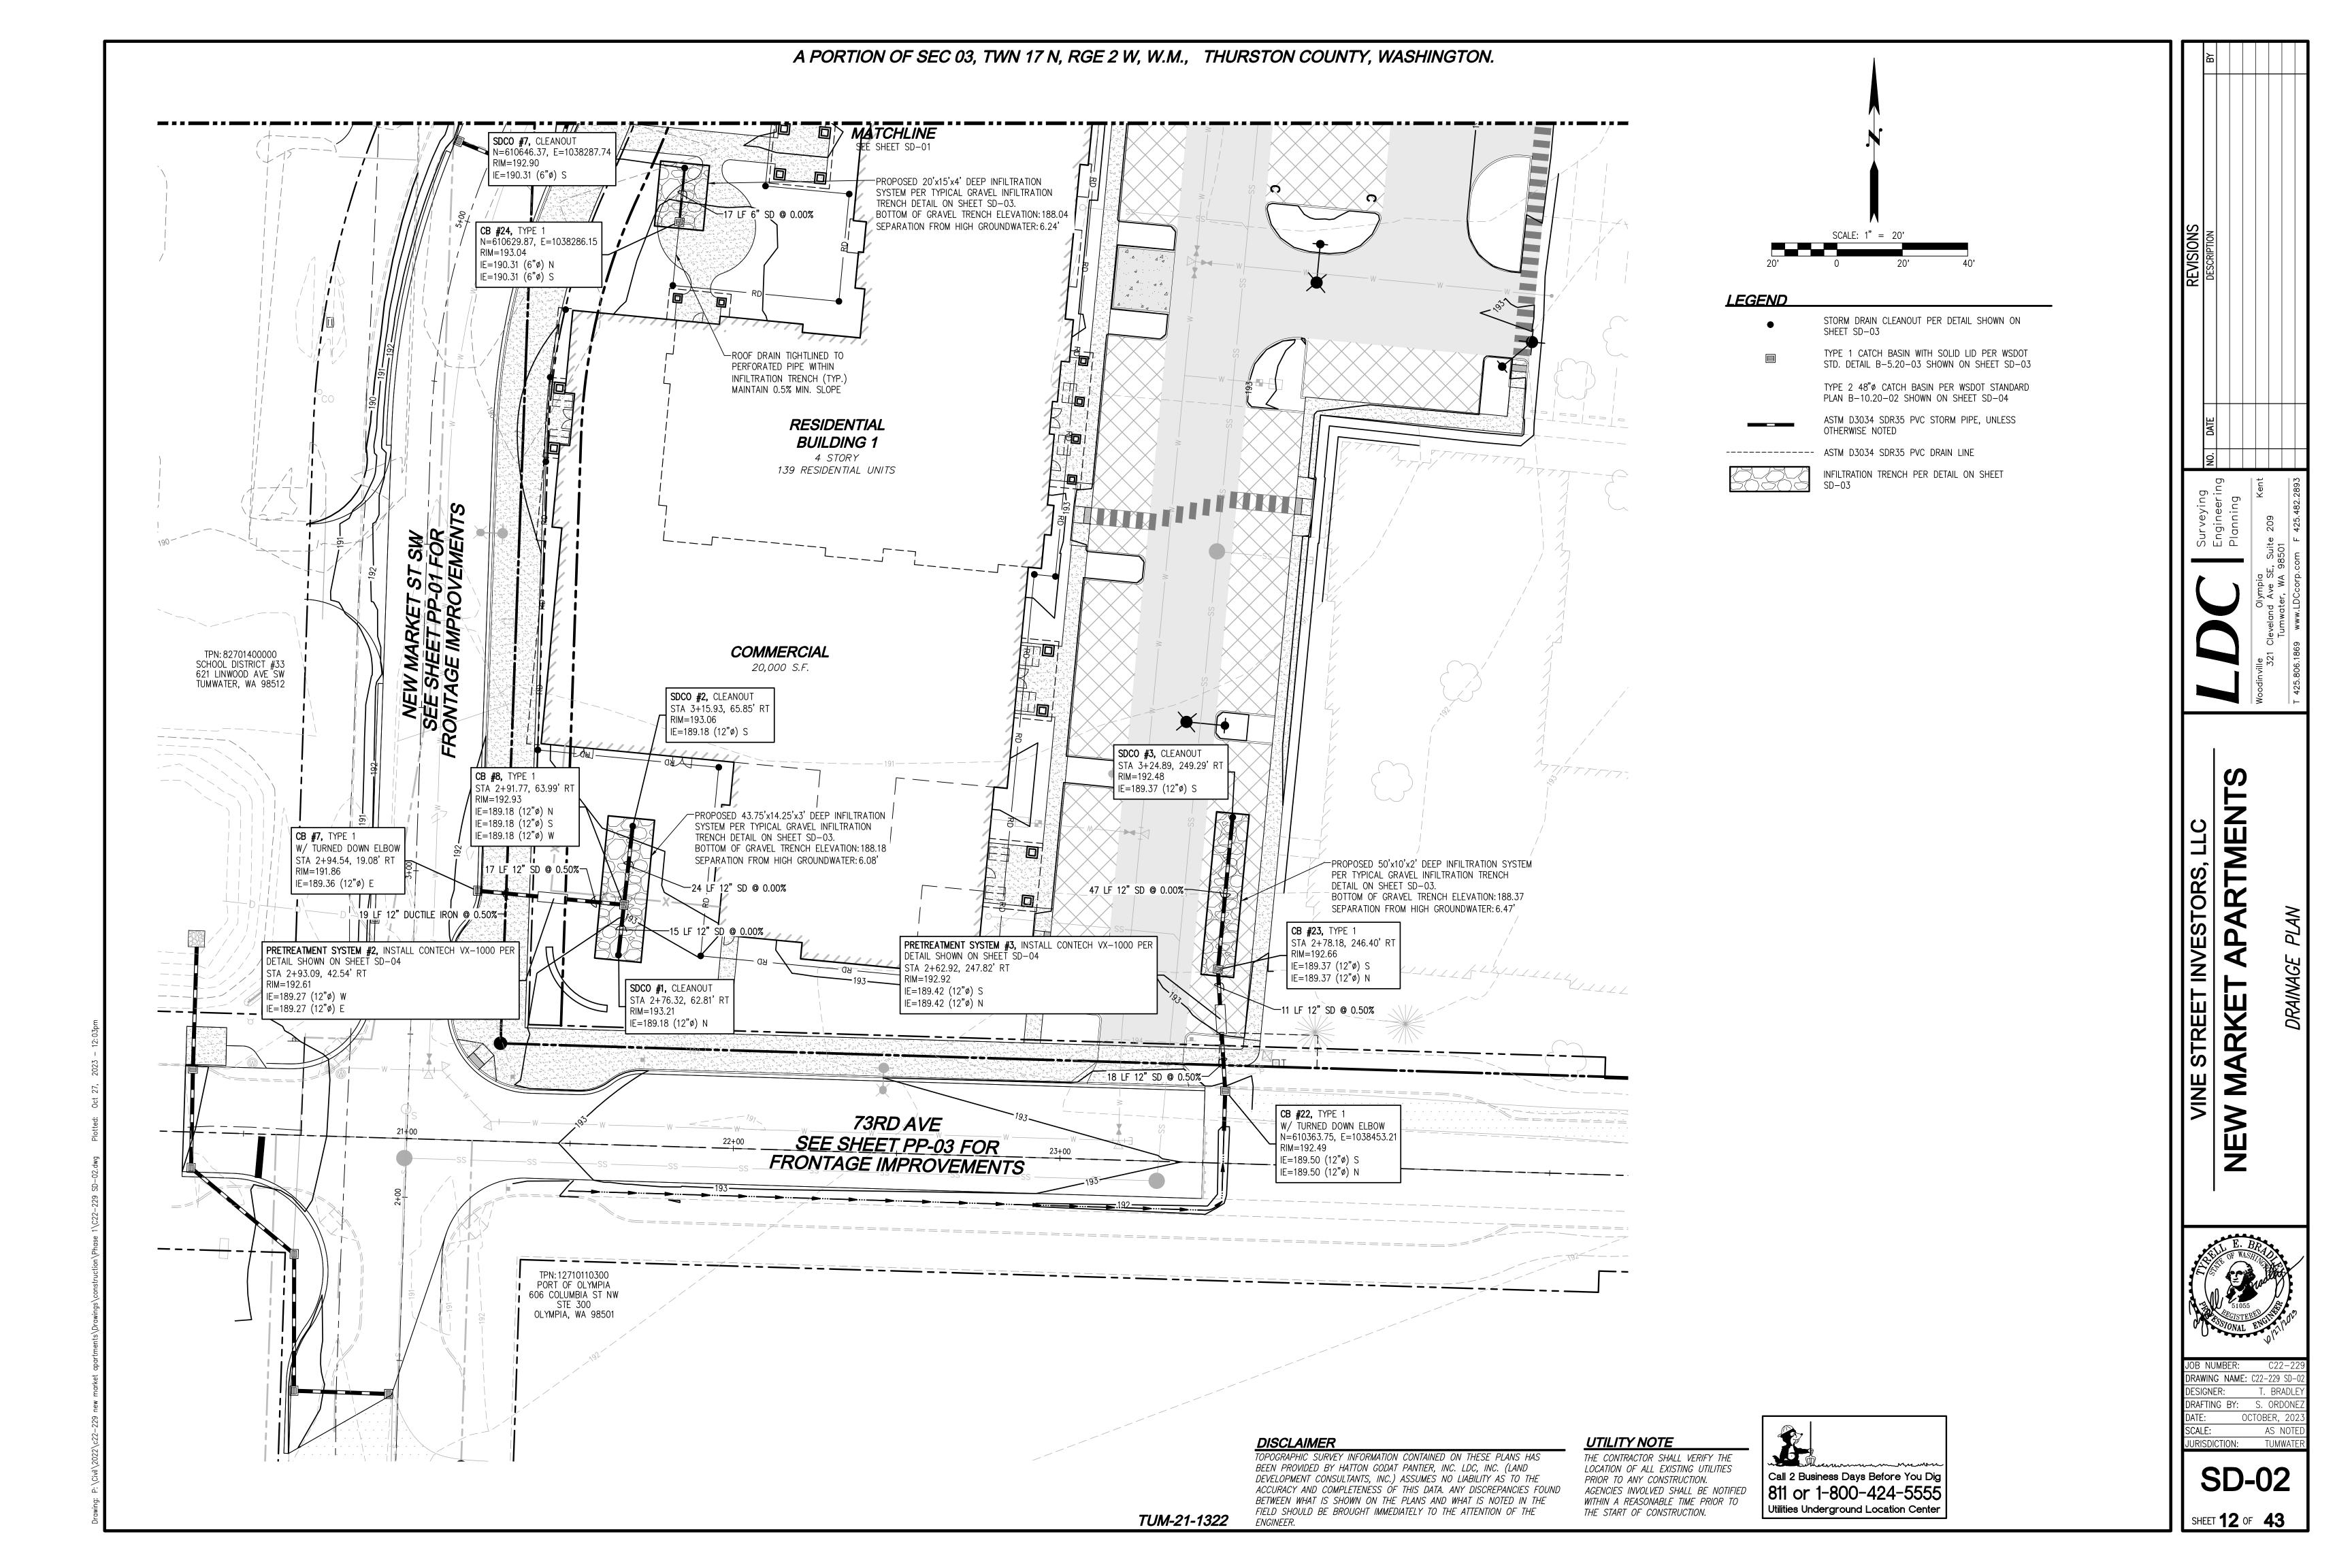

CITY OF TUMWATER STANDARD STORMWATER NOTES

- 1. ALL WORKMANSHIP AND MATERIALS SHALL BE IN ACCORDANCE WITH CITY/COUNTY STANDARDS AND THE MOST CURRENT COPY OF THE STATE OF WASHINGTON STANDARD SPECIFICATIONS FOR ROAD, BRIDGE AND MUNICIPAL CONSTRUCTION (WSDOT/APWA).
- 2. TEMPORARY EROSION/WATER POLLUTION MEASURES SHALL BE REQUIRED IN ACCORDANCE WITH SECTION 1-07.15 OF THE STANDARD SPECIFICATIONS AND THE DRAINAGE DESIGN AND EROSION CONTROL MANUAL ("DRAINAGE MANUAL").
- 3. PROPONENT SHALL COMPLY WITH ALL OTHER PERMITS AND OTHER REQUIREMENTS OF THE GOVERNING AUTHORITY OR AGENCY.
- 4. A PRECONSTRUCTION MEETING SHALL BE HELD PRIOR TO THE START OF CONSTRUCTION OR STAKING OF THE SITE.
- 5. ALL STORM MAINS AND RETENTION/DETENTION AREAS SHALL BE STAKED FOR GRADE AND ALIGNMENT BY AN ENGINEERING OR SURVEY FIRM LICENSED TO PERFORM SUCH WORK.
- 6. STORM DRAIN PIPE SHALL BE AS SPECIFIED IN THE DRAINAGE MANUAL.
- 7. SPECIAL STRUCTURES, OIL/WATER SEPARATORS, AND OUTLET CONTROLS SHALL BE INSTALLED PER PLANS AND MANUFACTURERS RECOMMENDATIONS.
- 8. PROVIDE TRAFFIC CONTROL PLAN(S) AS REQUIRED IN ACCORDANCE WITH MUTCD.
- 9. CALL UNDERGROUND LOCATE LINE 1-800-424-5555 MINIMUM 48 HOURS PRIOR TO ANY EXCAVATIONS.
- 10. ALL SURVEYING AND STAKING SHALL BE PERFORMED BY AN ENGINEERING OR SURVEYING FIRM CAPABLE OF PERFORMING SUCH WORK. THE ENGINEER OR SURVEYOR DIRECTING SUCH WORK SHALL BE LICENSED BY THE STATE OF WASHINGTON.
- 11. THE MINIMUM STAKING OF STORM SEWER SYSTEMS SHALL BE AS FOLLOWS:
- A. STAKE LOCATION OF ALL CATCH BASINS/MANHOLES AND OTHER FIXTURES FOR GRADE AND ALIGNMENT.
- B. STAKE LOCATION, SIZE, AND DEPTH OF RETENTION/DETENTION FACILITY.
- C. STAKE FINISHED GRADE OF ALL STORMWATER FEATURES, INCLUDING BUT NOT LIMITED TO CATCH BASIN/MANHOLE RIM ELEVATIONS, OVERFLOW STRUCTURES, WEIRS, AND INVERT ELEVATIONS OF ALL PIPES IN CATCH BASINS, MANHOLES, AND THOSE PIPES THAT DAYLIGHT.
- 12. PIPE MATERIALS USED FOR STORMWATER CONVEYANCE SHALL BE AS APPROVED BY THE JURISDICTION. PIPE SIZE, SLOPE, COVER, ETC., SHALL BE AS SPECIFIED IN THE DRAINAGE MANUAL.
- 13. ALL DRIVEWAY CULVERTS SHALL BE OF SUFFICIENT LENGTH TO PROVIDE A MINIMUM 3:1 SLOPE FROM THE EDGE OF THE DRIVEWAY TO THE BOTTOM OF THE DITCH. CULVERTS SHALL HAVE BEVELED AND SECTIONS TO MATCH THE SIDE SLOPE.
- 14. IF DRAINAGE OUTLETS (STUB-OUTS) ARE TO BE PROVIDED FOR EACH INDIVIDUAL LOT, THE STUB-OUTS SHALL CONFORM TO THE FOLLOWING:
- A. EACH OUTLET SHALL BE SUITABLY LOCATED AT THE LOWEST ELEVATION ON THE LOT, SO AS TO SERVICE ALL FUTURE ROOF DOWNSPOUTS AND FOOTING DRAINS, DRIVEWAYS, YARD DRAINS, AND ANY OTHER SURFACE OR SUBSURFACE DRAINS NECESSARY TO RENDER THE LOTS SUITABLE FOR THEIR INTENDED USE. EACH OUTLET SHALL HAVE FREE—FLOWING, POSITIVE DRAINAGE TO AN APPROVED STORM WATER CONVEYANCE SYSTEM OR TO AN APPROVED OUTFALL LOCATION.
- B. OUTLETS ON EACH LOT SHALL BE LOCATED WITH A FIVE—FOOT—HIGH, 2"X4" STAKE MARKED "STORM" OR "DRAIN." THE STUB—OUT SHALL VISIBLY EXTEND ABOVE SURFACE LEVEL AND BE SECURED TO THE STAKE.
- C. PIPE MATERIAL SHALL BE AS APPROVED BY THE JURISDICTION. D. DRAINAGE EASEMENTS ARE REQUIRED FOR DRAINAGE SYSTEMS DESIGNED TO CONVEY FLOWS THROUGH INDIVIDUAL LOTS. E. THE DEVELOPER AND/OR CONTRACTOR IS RESPONSIBLE FOR COORDINATING THE LOCATIONS OF ALL STUB—OUT CONVEYANCE LINES WITH RESPECT TO THE UTILITIES (E.G., POWER, GAS, TELEPHONE, TELEVISION). F. ALL INDIVIDUAL STUB—OUTS SHALL BE PRIVATELY OWNED AND MAINTAINED BY THE LOT HOME OWNER.
- 15. THE STORM DRAINAGE SYSTEM SHALL BE CONSTRUCTED ACCORDING TO APPROVED PLANS ON FILE WITH THE JURISDICTION. ANY MATERIAL DEVIATION FROM THE APPROVED PLANS WILL REQUIRE WRITTEN APPROVAL FROM THE JURISDICTION.
- 16. A COPY OF THE APPROVED STORM WATER PLANS MUST BE ON THE JOB SITE WHENEVER CONSTRUCTION IS IN PROGRESS.
- 17. ALL DISTURBED AREAS SHALL BE SEEDED AND MULCHED OR SIMILARLY STABILIZED TO THE SATISFACTION OF THE JURISDICTION. FOR SITES WHERE GRASS HAS BEEN PLANTED THROUGH HYDROSEEDING, THE PERFORMANCE BOND WILL NOT BE RELEASED UNTIL THE GRASS HAS BEEN THOROUGHLY ESTABLISHED, UNLESS OTHERWISE APPROVED BY THE JURISDICTION.
- 18. ALL BUILDING DOWNSPOUTS ON COMMERCIAL SITES SHALL BE CONNECTED TO THE STORM DRAINAGE SYSTEM, UNLESS OTHERWISE APPROVED BY THE JURISDICTION.
- 19. ALL EROSION CONTROL AND STORMWATER FACILITIES SHALL BE REGULARLY INSPECTED AND MAINTAINED BY THE CONTRACTOR DURING THE CONSTRUCTION PHASE OF THE DEVELOPMENT PROJECT.
- 20. THE CONTRACTOR SHALL BE RESPONSIBLE FOR PROVIDING ADEQUATE SAFEGUARDS, SAFETY DEVICES, PROTECTIVE EQUIPMENT, FLAGGERS, AND ANY OTHER NEEDED ACTIONS TO PROTECT THE LIFE, HEALTH, AND SAFETY OF THE PUBLIC, AND TO PROTECT PROPERTY IN CONNECTION WITH THE PERFORMANCE OF WORK COVERED BY THE CONTRACT. ANY WORK WITHIN THE TRAVELED RIGHT—OF—WAY THAT MAY INTERRUPT NORMAL TRAFFIC FLOW SHALL REQUIRE AT LEAST ONE FLAGGER FOR EACH LANE OF TRAFFIC AFFECTED. ALL SECTIONS OF THE CURRENT W.S.D.O.T. STANDARD SPECIFICATIONS FOR TRAFFIC CONTROL SHALL APPLY.
- 21. IT SHALL BE THE SOLE RESPONSIBILITY OF THE CONTRACTOR TO OBTAIN STREET USE AND OTHER RELATED OR REQUIRED PERMITS PRIOR TO ANY CONSTRUCTION ACTIVITY IN THE JURISDICTION'S RIGHT-OF-WAY. IT SHALL ALSO BE THE RESPONSIBILITY OF THE CONTRACTOR TO OBTAIN ALL REQUIRED PERMITS PRIOR TO ANY CONSTRUCTION.
- 22. NO FINAL CUT OR FILL SLOPE SHALL EXCEED TWO (2) HORIZONTAL TO ONE (1) VERTICAL WITHOUT STABILIZATION BY ROCKERY OR BY A STRUCTURAL RETAINING WALL.
- 23. THE PROJECT ENGINEER SHALL VERIFY THE LOCATIONS, WIDTHS, THICKNESSES, AND ELEVATIONS OF ALL EXISTING PAVEMENTS AND STRUCTURES, INCLUDING UTILITIES AND OTHER FRONTAGE IMPROVEMENTS, THAT ARE TO INTERFACE WITH NEW WORK, PROVIDE ALL TRIMMING, CUTTING, SAW CUTTING, GRADING, LEVELING, SLOPING, COATING, AND OTHER WORK, INCLUDING MATERIALS AS NECESSARY TO CAUSE THE INTERFACE WITH EXISTING WORKS TO BE PROPER, WITHOUT CONFLICT, ACCEPTABLE TO THE ENGINEER AND THE JURISDICTION, COMPLETE IN PLACE, AND READY TO USE.
- 24. COMPACTION OF ALL FILL AREAS SHALL BE PER CURRENT APWA SPECIFICATIONS. FILL SHALL BE PROVIDED IN 6" MAXIMUM LIFTS AND SHALL BE COMPACTED TO 95 PERCENT OF ITS MAXIMUM RELATIVE DENSITY.

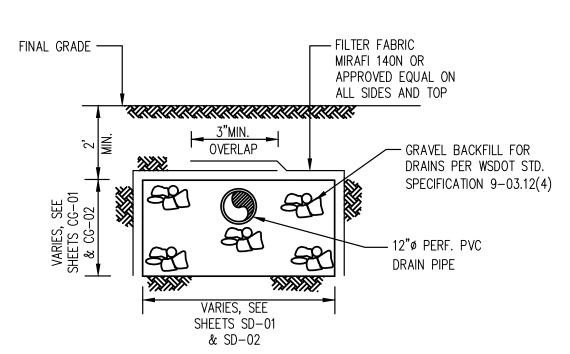

GRAVEL INFILTRATION TRENCH DETAIL

TESTING & SAMPLING FREQUENCY GUIDE

ITEM	TYPE OF TESTS	MINIMUM #	FREQUENCY
GRAVEL BORROW	GRADING & SE	1 EACH	1-4000 TON
SAND DRAINAGE BLANKET	GRADING	1 EACH	1-4000 TON
CSTC	GRADING, SE & FRACTURE	1 EACH	1-2000 TON
CSBC	GRADING, SE & FRACTURE	1 EACH	1-2000 TON
BALLAST	GRADING, SE & FRACTURE	1 EACH	1-2000 TON
BACKFILL/SAND DRAINS	GRADING	1 EACH	1-2000 TON
GRAVEL BACKFILL FOR:			
FOUNDATIONS	GRADING, SE & DUST RATIO	1 EACH	1-100 TON
PIPE BEDDING	GRADING, SE & DUST RATIO	1 EACH	1-100 TON
DRAINS	GRADING	1 EACH	1-100 TON
CEMENT	MIX DESIGN CERTIFICATION	1 EACH	1-JOB
PCC STRUCTURES (SIDEWALK, CURB AND GUTTER FOUNDATIONS)	28 DAY COMPRESSIVE STRENGTH CYLINDERS	2 EACH	1-100 CY
ASPHALT			
	CERTIFICATION	1 EACH	1-JOB
	MIX DESIGN	1 EACH	1-JOB
	COMPACTION	2 EACH	5-200 TON
COMPACTION TESTING:			
SUB GRADE	COMPACTION	1 EACH ²	1–150 LF
CSTC	COMPACTION	1 EACH²	1-150 LF
CSBC	COMPACTION	1 EACH²	1-150 LF
BALLAST	COMPACTION	1 EACH²	1-150 LF
TRENCH BACKFILL	COMPACTION	1 EACH ²	1-150 LF


SE - SAND FOLIWALENC


- 1. A CONTROL LOT SHALL BE A NORMAL DAYS PRODUCTION. FOR MINOR QUANTITIES 200 TONS OR LESS PER DAY, A MINIMUM OF TWO (2) GAUGE READINESS SHALL BE TAKEN.

 2. MINIMUM OF TWO (2) TESTS FOR PROJECTS SHORTER THAN 150'.
- TESTING SHALL BE REQUIRED AT THE DEVELOPER'S OR CONTRACTOR'S EXPENSE. THE TESTING SHALL BE ORDERED BY THE DEVELOPER OR CONTRACTOR AND CHOSEN TESTING LAB SHALL BE APPROVED BY THE CITY CONSTRUCTION INSPECTOR. TESTING SHALL BE DONE ON ALL MATERIALS AND CONSTRUCTION AS SPECIFIED IN THE WSDOT APWA STANDARD SPECIFICATIONS AND WITH FREQUENCY SPECIFIED ABOVE.


THE CITY CONSTRUCTION INSPECTOR AND REVIEW ENGINEER FOR THE PROJECT WILL BE NOTIFIED IMMEDIATELY OF FAILED TEST RESULTS.


ALL TEST RESULTS WILL BE SUBMITTED TO DEVELOPMENT@CI.TUMWATER.WA.US FOR RECORDING WITHIN 48 HOURS OF THE RESULTS BEING MADE AVAILABLE TO THE DEVELOPER OR CONTRACTOR. THE SUBJECT LINE SHALL CONTAIN THE PROJECT NAME AND TUM# AS THEY APPEAR ON THE APPROVED CIVIL PLANS.

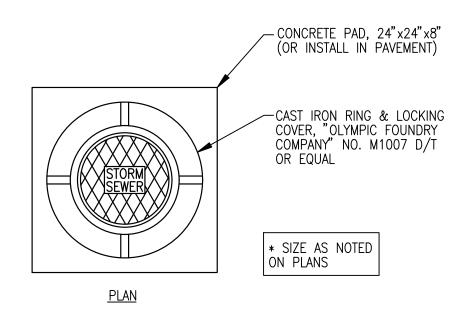

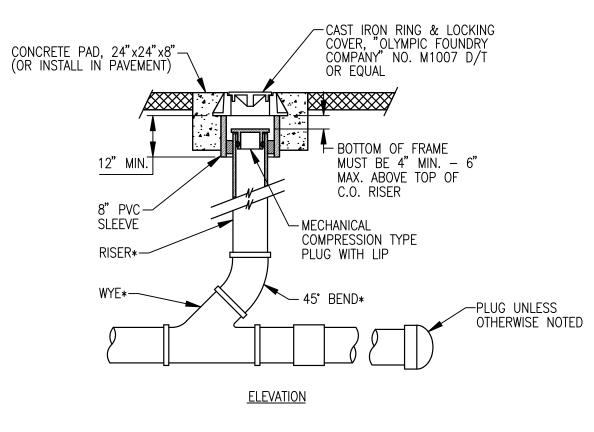

STORM CLEANOUT

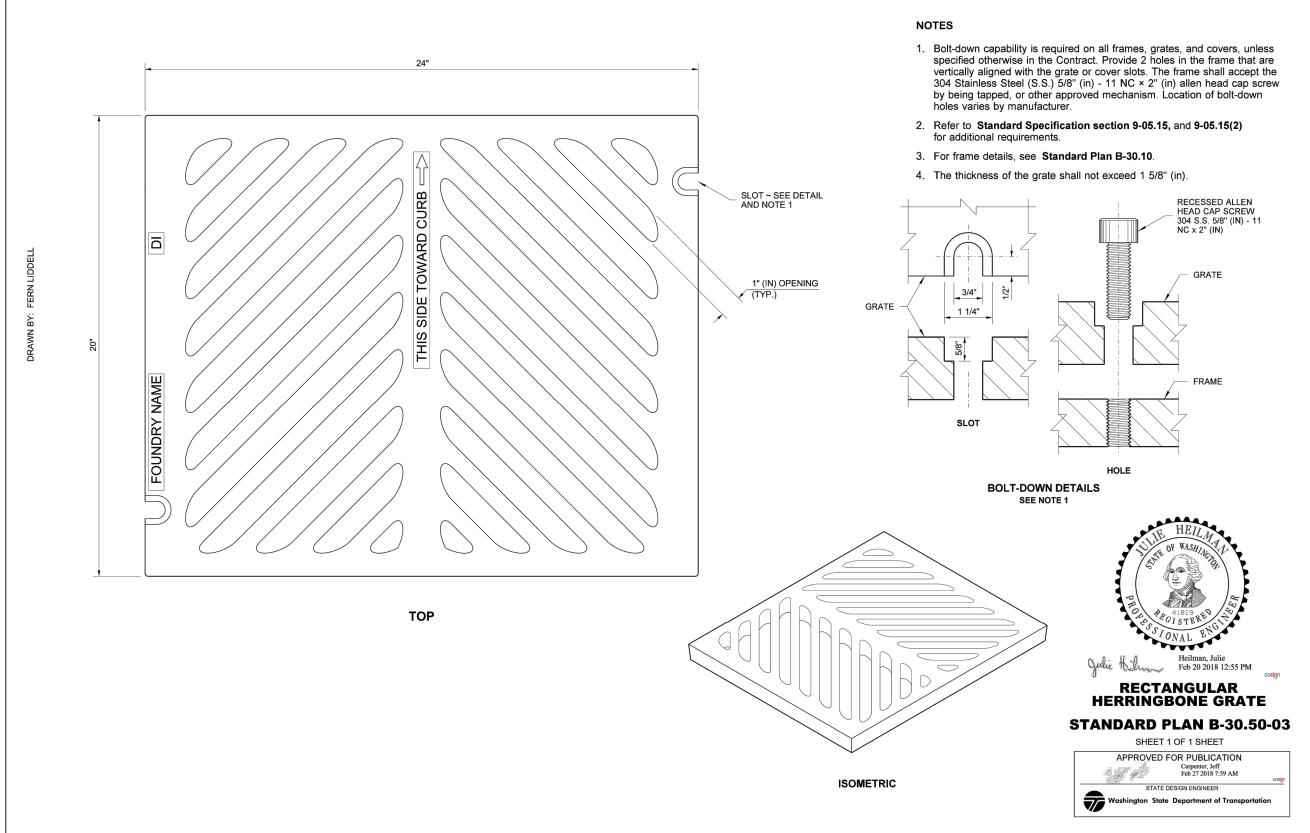

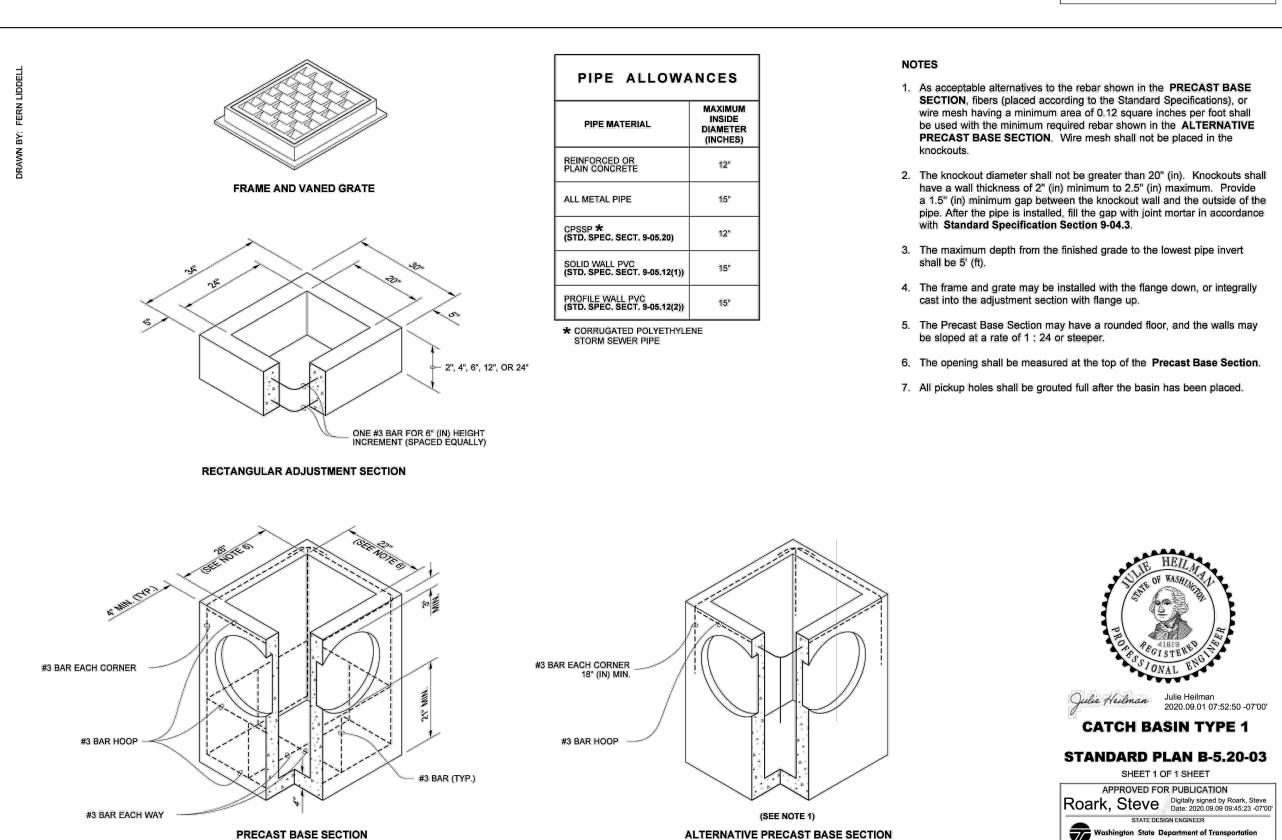

DISCLAIMER

TOPOGRAPHIC SURVEY INFORMATION CONTAINED ON THESE PLANS HAS
BEEN PROVIDED BY HATTON GODAT PANTIER, INC. LDC, INC. (LAND
DEVELOPMENT CONSULTANTS, INC.) ASSUMES NO LIABILITY AS TO THE
ACCURACY AND COMPLETENESS OF THIS DATA. ANY DISCREPANCIES FOUND
BETWEEN WHAT IS SHOWN ON THE PLANS AND WHAT IS NOTED IN THE
FIELD SHOULD BE BROUGHT IMMEDIATELY TO THE ATTENTION OF THE
FNGINFFR.

UTILITY NOTE

THE CONTRACTOR SHALL VERIFY THE LOCATION OF ALL EXISTING UTILITIES PRIOR TO ANY CONSTRUCTION.
AGENCIES INVOLVED SHALL BE NOTIFIED WITHIN A REASONABLE TIME PRIOR TO THE START OF CONSTRUCTION.




DATE DESCRIPTION

DATE DESCRIPTION

Woodinville Olympia 321 Cleveland Ave SE, Suite 209 Tumwater, WA 98501

ET INVESTORS, LLC
ET APARTMENTS

VEW MARKET APA

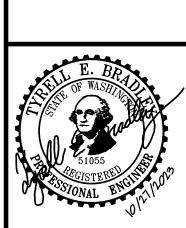

JOB NUMBER: C22-22

DRAWING NAME: C22-229 SD-0

DESIGNER: T. BRADLE

DRAFTING BY: S. ORDONE

DATE: OCTOBER, 202

SCALE: AS NOTE

JURISDICTION: TUMWATE

SD-03

SHEET **13** OF **43**

1999 HIGH GROUNDWATER ELEV: 180.50

BIORETENTION POND

BIORETENTION CONSTRUCTION NOTES

REFERENCE VOLUME V CHAPTER 5 BMP T7.30 OF THE 2019 DOE MANUAL FOR MORE INFORMATION ON BIORETENTION INSTALLATION & REQUIREMENTS.


CONSTRUCTION OF BIORETENTION FACILITY:


- EXCAVATION
- MINIMIZING COMPACTION OF THE BASE AND SIDEWALLS OF THE BIORETENTION AREA IS CRITICAL. NO EXCAVATION DURING WEST OR SATURATED CONDITIONS.
- PRIOR TO PLACEMENT OF BIORETENTION SOIL MIX, THE FINISHED SUBGRADE SHALL:
- •• BE SCARIFIED TO A MINIMUM DEPTH OF 3 INCHES HAVE ANY SEDIMENT DEPOSITED FROM CONSTRUCTION RUNOFF REMOVED. TO REMOVE ALL INTRODUCED SEDIMENT, SUBGRADE SOIL SHOULD BE REMOVED TO A DEPTH OF 3-6 INCHES AND
- REPLACED WITH BIORETENTION SOIL MIX. BE INSPECTED BY THE RESPONSIBLE ENGINEER TO VERIFY
- REQUIRED SUBGRADE CONDITION. SOIL PLACEMENT
- THE SOIL MIXTURE SHALL BE PLACED IN HORIZONTAL LAYERS NOT TO EXCEED 6 INCHES PER LIFT FOR THE ENTIRE AREA OF THE BIORETNETION BMP.
- COMPACT THE BIORETENTION SOIL MIX TO A RELATIVE COMPACTION OF 85 PERCENT OF MODIFIED MAXIMUM DRY DENSITY (ASTM D 1557). COMPACTION CAN BE ACHIEVED BY BOOT PACKING, AND THEN APPLY 0.2 INCHES OF WATER PER 1 INCH OF BIORETNETION SOIL MIX.
- CONSTRUCTION OF BIORETENTION BMPS SHOULD NOT BEGIN UNTIL ALL CONTRIBUTING DRAINAGE AREAS ARE STABILIZED ACCORDING TO EROSION AND SEDIMENT CONTROL BMPS AND TO THE SATISFACTION

BIORETENTION SOIL MIX NOTES

DEFAULT BIORETENTION SOIL MIX (BSM) REQUIREMENTS:

- PERCENT FINES: A RANGE OF 2 TO 4 PERCENT PASSING THE #200 SIEVE IS IDEAL AND FINES SHOULD NOT BE ABOVE 5 PERCENT FOR A PROPER FUNCTIONING SPECIFICATION ACCORDING TO ASTM D422.
- THE AGGREGATE PORTION OF THE BSM SHOULD BE WELL-GRADED. ACCORDING TO ASTM D 2487-98, WELL-GRADED SAND SHOULD HAVE THE FOLLOWING GRADATION COEFFICIENTS:
- COEFFICIENT OF UNIFORMITY EQUAL TO OR GREATER THAN 4 COEFFICIENT OF CURVE GREATER THAN TO EQUAL TO 1 AND
- LESS THAN OR EQUAL TO 3 • COMPOST TO AGGREGATE RATIO: 60-65 PERCENT MINERAL
- AGGREGATE, 35-40 PERCENT COMPOST BY VOLUME. ORGANIC MATTER CONTENT 5-8 PERCENT BY WEIGHT.
- CATION EXCHANGE CAPACITY (CEC) MUST BE >5 MILLIEQUIVALENTS/100 G DRY SOIL.
- COMPOST MUST MEET THE DEFINITION OF "COMPOSTED MATERIAL" IN WAC 173-350-100 AND COMPLIES WITH TESTING PARAMETERS AND OTHER STANDARDS IN WAC 173-350-220.

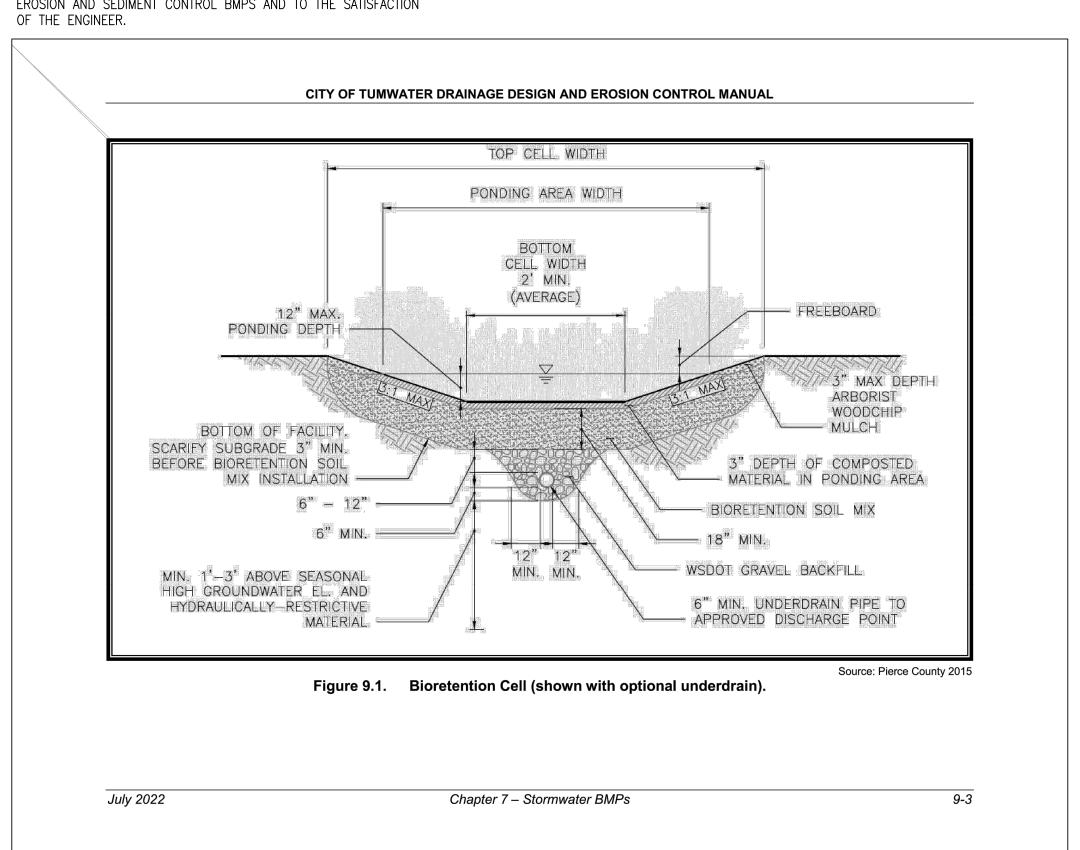

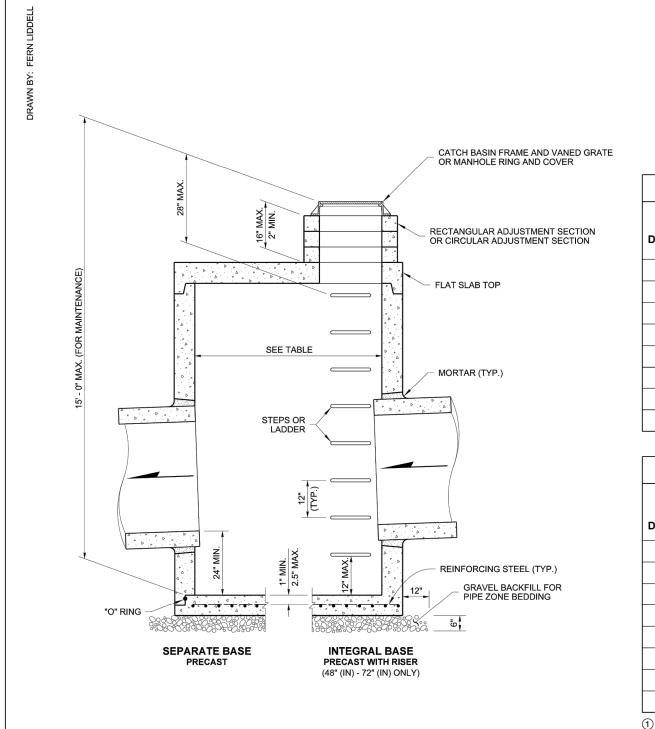

- 1. No steps are required when height is 4' or less.
- 2. The bottom of the precast catch basin may be sloped to facilitate cleaning.
- 3. The rectangular frame and grate may be installed with the flange up or down. The frame may be cast into the adjustment section.
- 4. Knockouts shall have a wall thickness of 2" (in) minimum to 2.5" (in) maximum. Provide a 1.5" (in) minimum gap between the knockout wall and the outside of the pipe. After the pipe is installed, fill the gap with joint mortar in accordance with **Standard Specification Section 9-04.3**.

CATCH BASIN DIMENSIONS						
CATCH MIN. BASIN WALL DIAMETER THICKNESS		MIN. BASE THICKNESS	MAXIMUM KNOCKOUT SIZE	MINIMUM DISTANCE BETWEEN KNOCKOUTS		
48"	4"	6"	36"	8"		
54"	4.5"	8"	42"	8"		
60"	5"	8"	48"	8"		
72"	6"	8"	60"	12"		
84"	8"	12"	72"	12"		
96"	8"	12"	84"	12"		
120"	10"	12"	96"	12"		
144"	12"	12"	108"	12"		

PIPE ALLOWANCES								
CATCH	CATCH PIPE MATERIAL WITH MAXIMUM INSIDE DIAMETER							
BASIN DIAMETER	CONCRETE	ALL METAL	CPSSP 1 PP 4	SOLID WALL PVC ²	PROFILE WALL PVC ³			
48"	24"	30"	24"	30"	30"			
54"	30"	36"	30"	36"	36"			
60"	36"	42"	36"	42"	42"			
72"	42"	54"	42"	48"	48"			
84"	54"	60"	54"	48"	48"			
96"	60"	72"	60"	48"	48"			
120"	66"	84"	60"	48"	48"			
144"	78"	96"	60"	48"	48"			

(See Standard Specification Section 9-05.20) ② (See Standard Specification Section 9-05.12(1))

③ (See Standard Specification Section 9-05.12(2))

CAPACITY, AN UPSTREAM BYPASS STRUCTURE IS REQUIRED.

4 Polypropylene Pipe (See Standard Specification Section 9-05.24)


VORTECHS 1000 DESIGN NOTES


VORTECHS 1000 RATED TREATMENT CAPACITY IS 1.6 CFS, OR PER LOCAL REGULATIONS. IF THE SITE CONDITIONS EXCEED RATED TREATMENT

THE STANDARD INLET/OUTLET CONFIGURATION IS SHOWN. FOR OTHER CONFIGURATION OPTIONS, PLEASE CONTACT YOUR CONTECH

SHEET 1 OF 1 SHEET APPROVED FOR PUBLICATION Carpenter, Jeff Mar 2 2018 10:01 AM



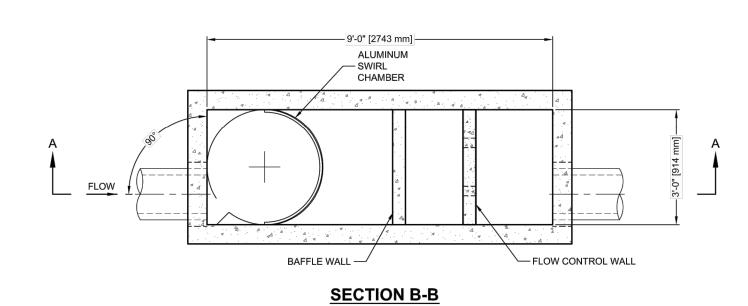

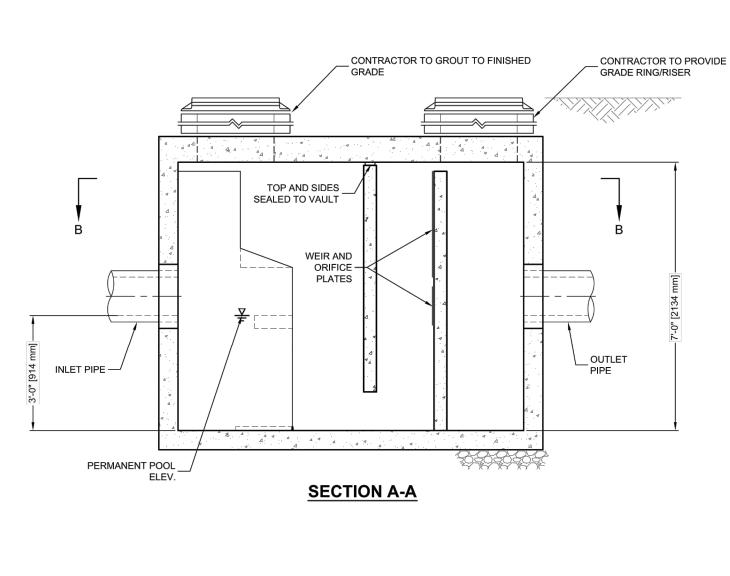

C&NTECH* FRAME AND COVER (DIAMETER VARIES)

N.T.S.

_		<u>PECIFIC</u> UIREME		3		
<u>DAI</u>	11/LQ	OIIVEIVIE		<u> </u>		
STRUCTURE ID				*		
WATER QUALITY	FLOW RAT	E (CFS)		*		
PEAK FLOW RAT	E (CFS)			*		
RETURN PERIOD	OF PEAK F	LOW (YRS)		*		
PIPE DATA:	I.E.	MATERIAL	D	AMETER		
INLET PIPE 1	*	*		*		
INLET PIPE 2	*	*		*		
OUTLET PIPE	*	*		*		
RIM ELEVATION				*		
ANTI-FLOTATION	BALLAST	WIDTH	$\neg \vdash$	HEIGHT		
		*	\neg	*		
NOTES/SPECIAL	REQUIREM	ENTS:				

- GENERAL NOTES

 1. CONTECH TO PROVIDE ALL MATERIALS UNLESS NOTED OTHERWISE.

 2. DIMENSIONS MARKED WITH () ARE REFERENCE DIMENSIONS. ACTUAL DIMENSIONS MAY VARY. 3. FOR FABRICATION DRAWINGS WITH DETAILED STRUCTURE DIMENSIONS AND WEIGHT, PLEASE CONTACT YOUR
- CONTECH REPRESENTATIVE. www.ContechES.com
- 4. VORTECHS WATER QUALITY STRUCTURE SHALL BE IN ACCORDANCE WITH ALL DESIGN DATA AND INFORMATION
- 5. STRUCTURE SHALL MEET AASHTO HS20 AND CASTINGS SHALL MEET AASHTO M306 LOAD RATING, ASSUMING GROUNDWATER ELEVATION AT, OR BELOW, THE OUTLET PIPE INVERT ELEVATION. ENGINEER OF RECORD TO CONFIRM ACTUAL GROUNDWATER ELEVATION.
- 6. INLET PIPE(S) MUST BE PERPEDICULAR TO THE VAULT AND AT THE CORNER TO INTRODUCE THE FLOW TANGENTIALLY TO THE SWIRL CHAMBER. DUAL INLETS NOT TO HAVE OPPOSING TANGENTIAL FLOW DIRECTIONS. 7. OUTLET PIPE(S) MUST BE DOWN STREAM OF THE FLOW CONTROL BAFFLE AND MAY BE LOCATED ON THE SIDE OR END OF THE VAULT. THE FLOW CONTROL WALL MAY BE TURNED TO ACCOMODATE OUTLET PIPE KNOCKOUTS ON THE SIDE

OF THE VAULT.

INSTALLATION NOTES

A. ANY SUB-BASE, BACKFILL DEPTH, AND/OR ANTI-FLOTATION PROVISIONS ARE SITE-SPECIFIC DESIGN CONSIDERATIONS AND SHALL BE SPECIFIED BY ENGINEER OF RECORD. B. CONTRACTOR TO PROVIDE EQUIPMENT WITH SUFFICIENT LIFTING AND REACH CAPACITY TO LIFT AND SET THE

INVERT MINIMUM. IT IS SUGGESTED THAT ALL JOINTS BELOW PIPE INVERTS ARE GROUTED.

VORTECHS STRUCTURE (LIFTING CLUTCHES PROVIDED).
C. CONTRACTOR TO INSTALL JOINT SEALANT BETWEEN ALL STRUCTURE SECTIONS AND ASSEMBLE STRUCTURE. D. CONTRACTOR TO PROVIDE, INSTALL, AND GROUT PIPES. MATCH PIPE INVERTS WITH ELEVATIONS SHOWN. E. CONTRACTOR TO TAKE APPROPRIATE MEASURES TO ASSURE UNIT IS WATER TIGHT, HOLDING WATER TO FLOWLINE

CNTECH NGINEERED SOLUTIONS LLC www.ContechES.com 9025 Centre Pointe Dr., Suite 400, West Chester, OH 45069

VORTECHS 1000 STANDARD DETAIL

DISCLAIMER

TUM-21-1322

TOPOGRAPHIC SURVEY INFORMATION CONTAINED ON THESE PLANS HAS BEEN PROVIDED BY HATTON GODAT PANTIER, INC. LDC, INC. (LAND DEVELOPMENT CONSULTANTS, INC.) ASSUMES NO LIABILITY AS TO THE ACCURACY AND COMPLETENESS OF THIS DATA. ANY DISCREPANCIES FOUND BETWEEN WHAT IS SHOWN ON THE PLANS AND WHAT IS NOTED IN THE FIELD SHOULD BE BROUGHT IMMEDIATELY TO THE ATTENTION OF THE

Vortechs*

UTILITY NOTE

THE CONTRACTOR SHALL VERIFY THE LOCATION OF ALL EXISTING UTILITIES PRIOR TO ANY CONSTRUCTION. AGENCIES INVOLVED SHALL BE NOTIFIED WITHIN A REASONABLE TIME PRIOR TO THE START OF CONSTRUCTION.




Call 2 Business Days Before You Dig 811 or 1-800-424-5555 **Utilities Underground Location Center**

APARTMEN STREET INVESTORS,


VINE

ARKE Ž

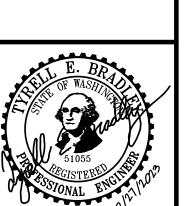

`
C22-229
E: C22-229 SD-04
T. BRADLEY
S. ORDONEZ
OCTOBER, 2023
AS NOTED

JURISDICTION: TUMWATER

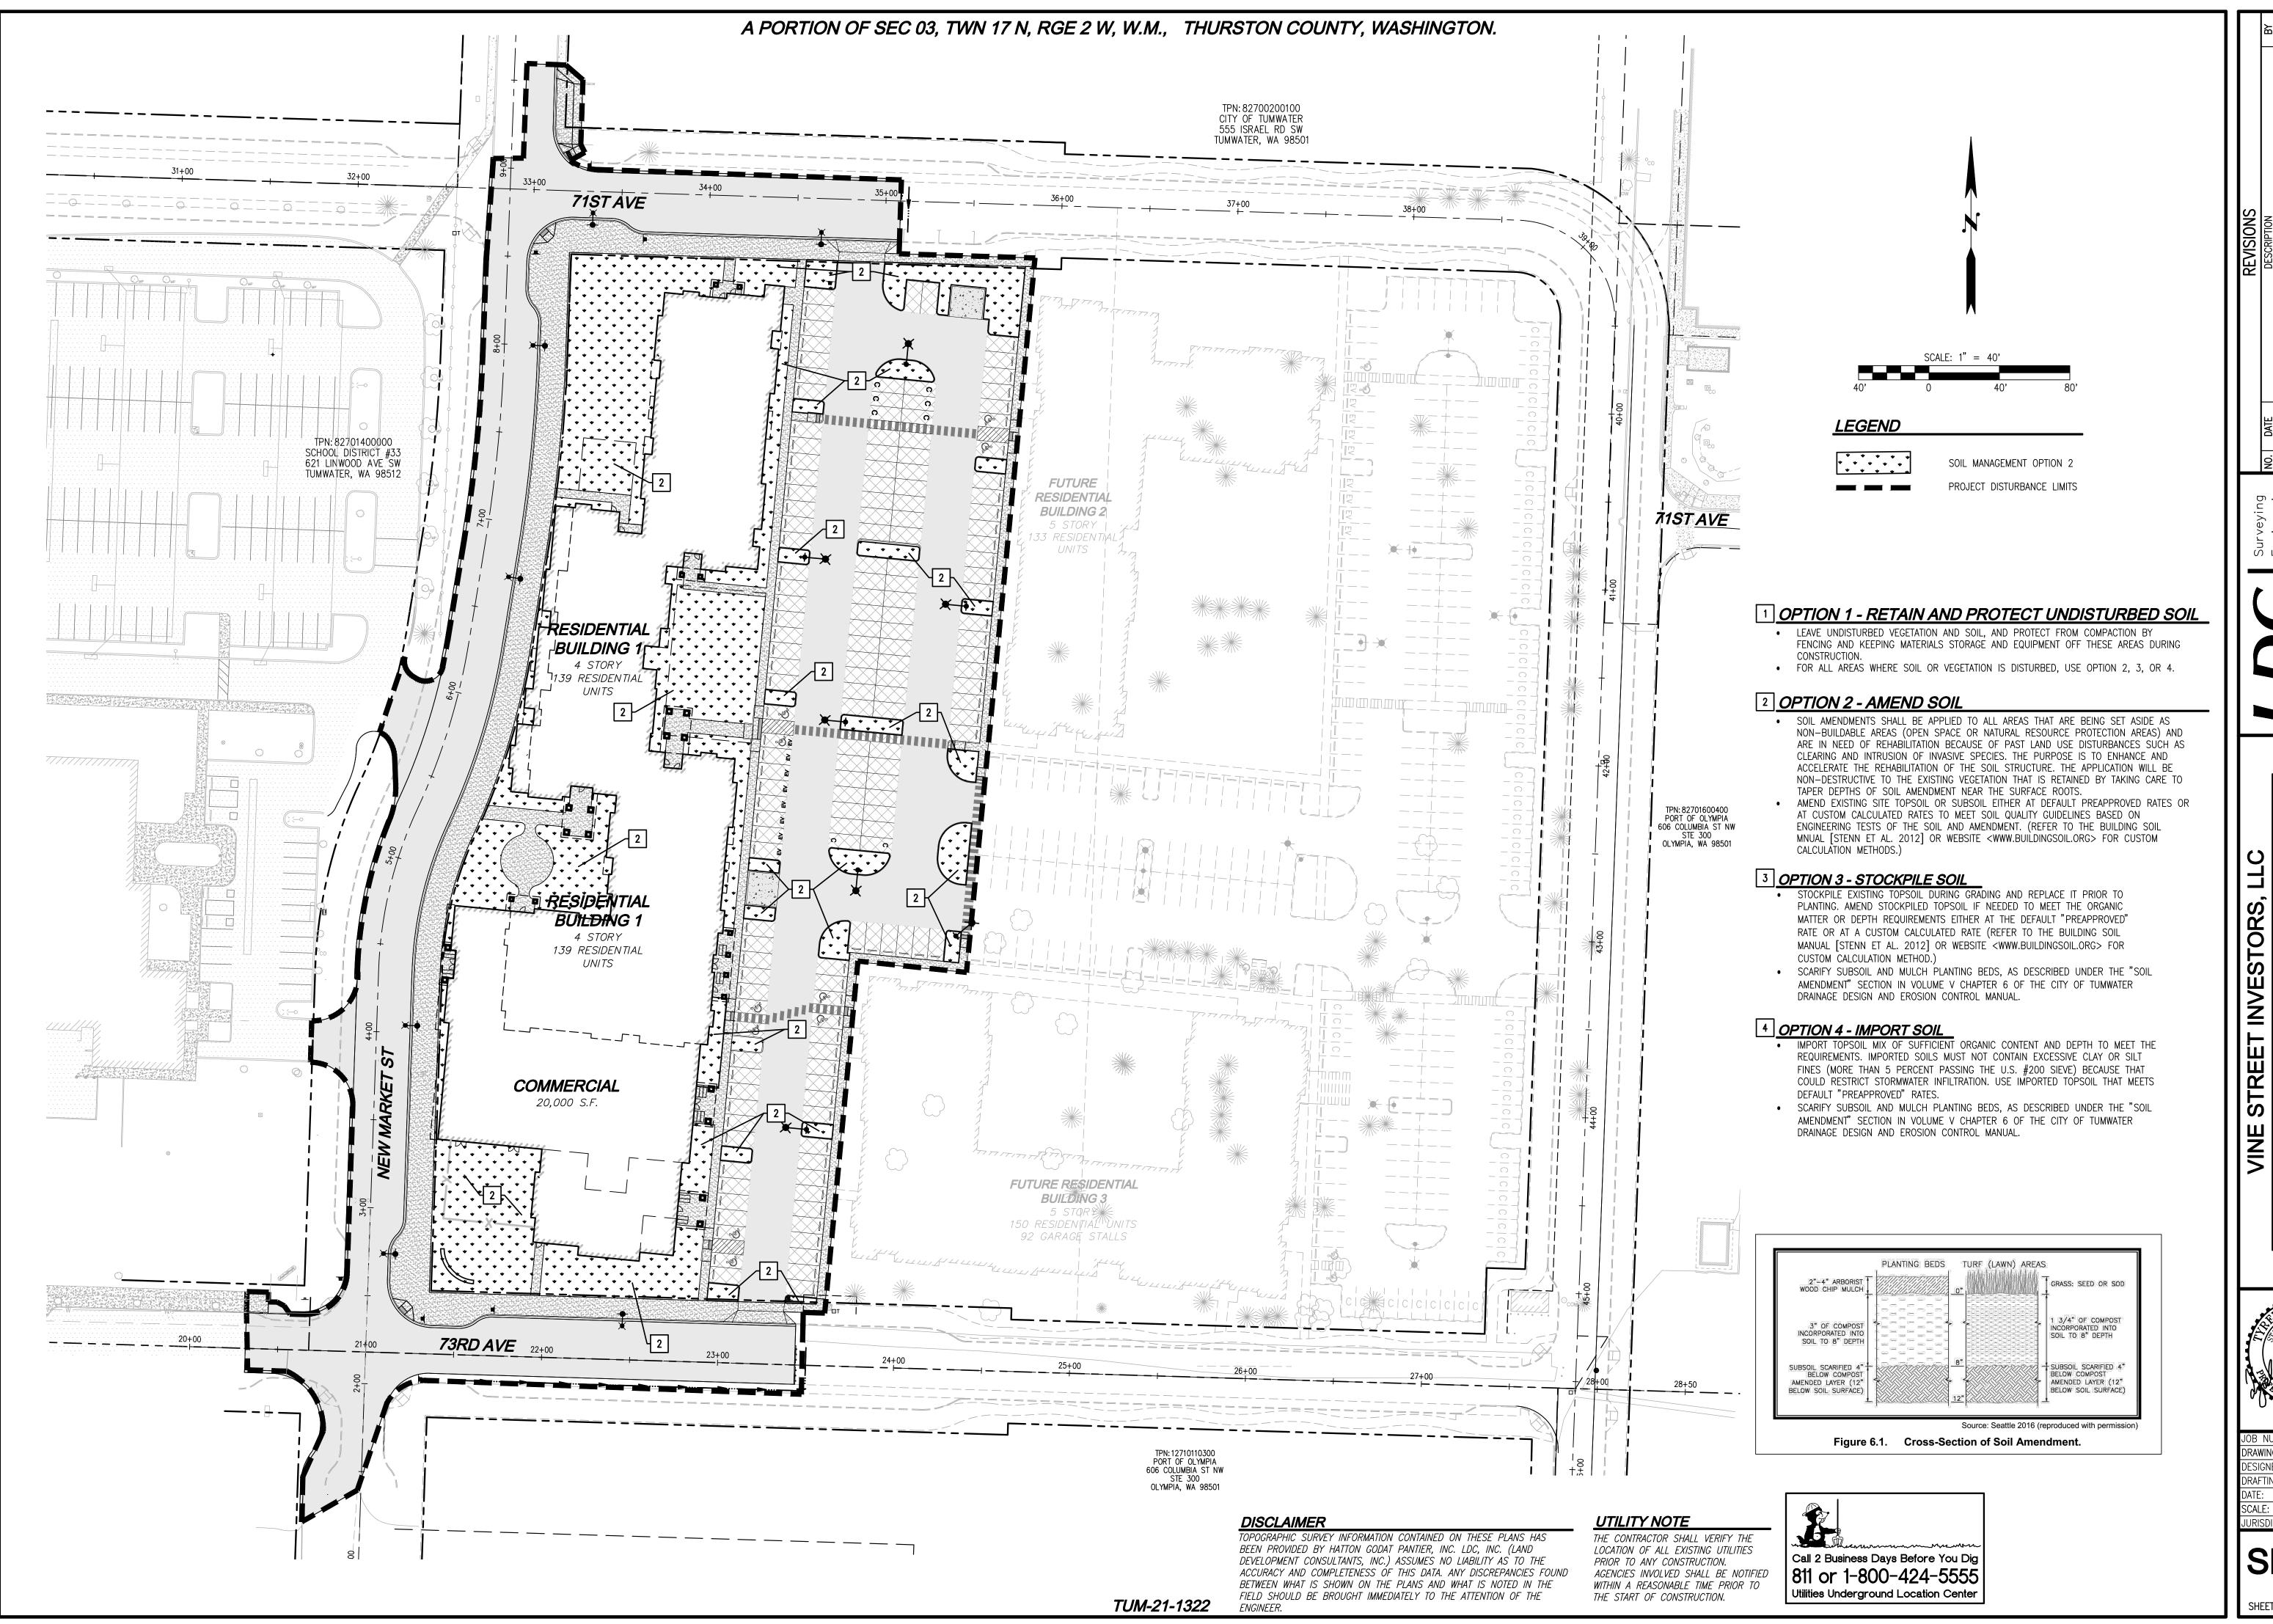

DATE DESCRIPTION BY


Olympia K.
21 Cleveland Ave SE, Suite 209
Tumwater, WA 98501
.1869 www.LDCcorp.com F 425.482.28

Woodinville (321 Cleveland Tumwa')

KET APARTMEN

VINE STREET INVEST


VEW MARKET APA

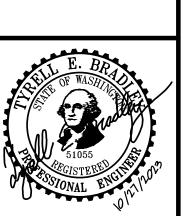

JOB NUMBER: C22-22
DRAWING NAME: C22-229 SMP-I
DESIGNER: T. BRADLE
DRAFTING BY: S. ORDONE
DATE: OCTOBER, 202
SCALE: AS NOTE
JURISDICTION: TUMWATE

SMP-01


SHEET **15** OF **43**

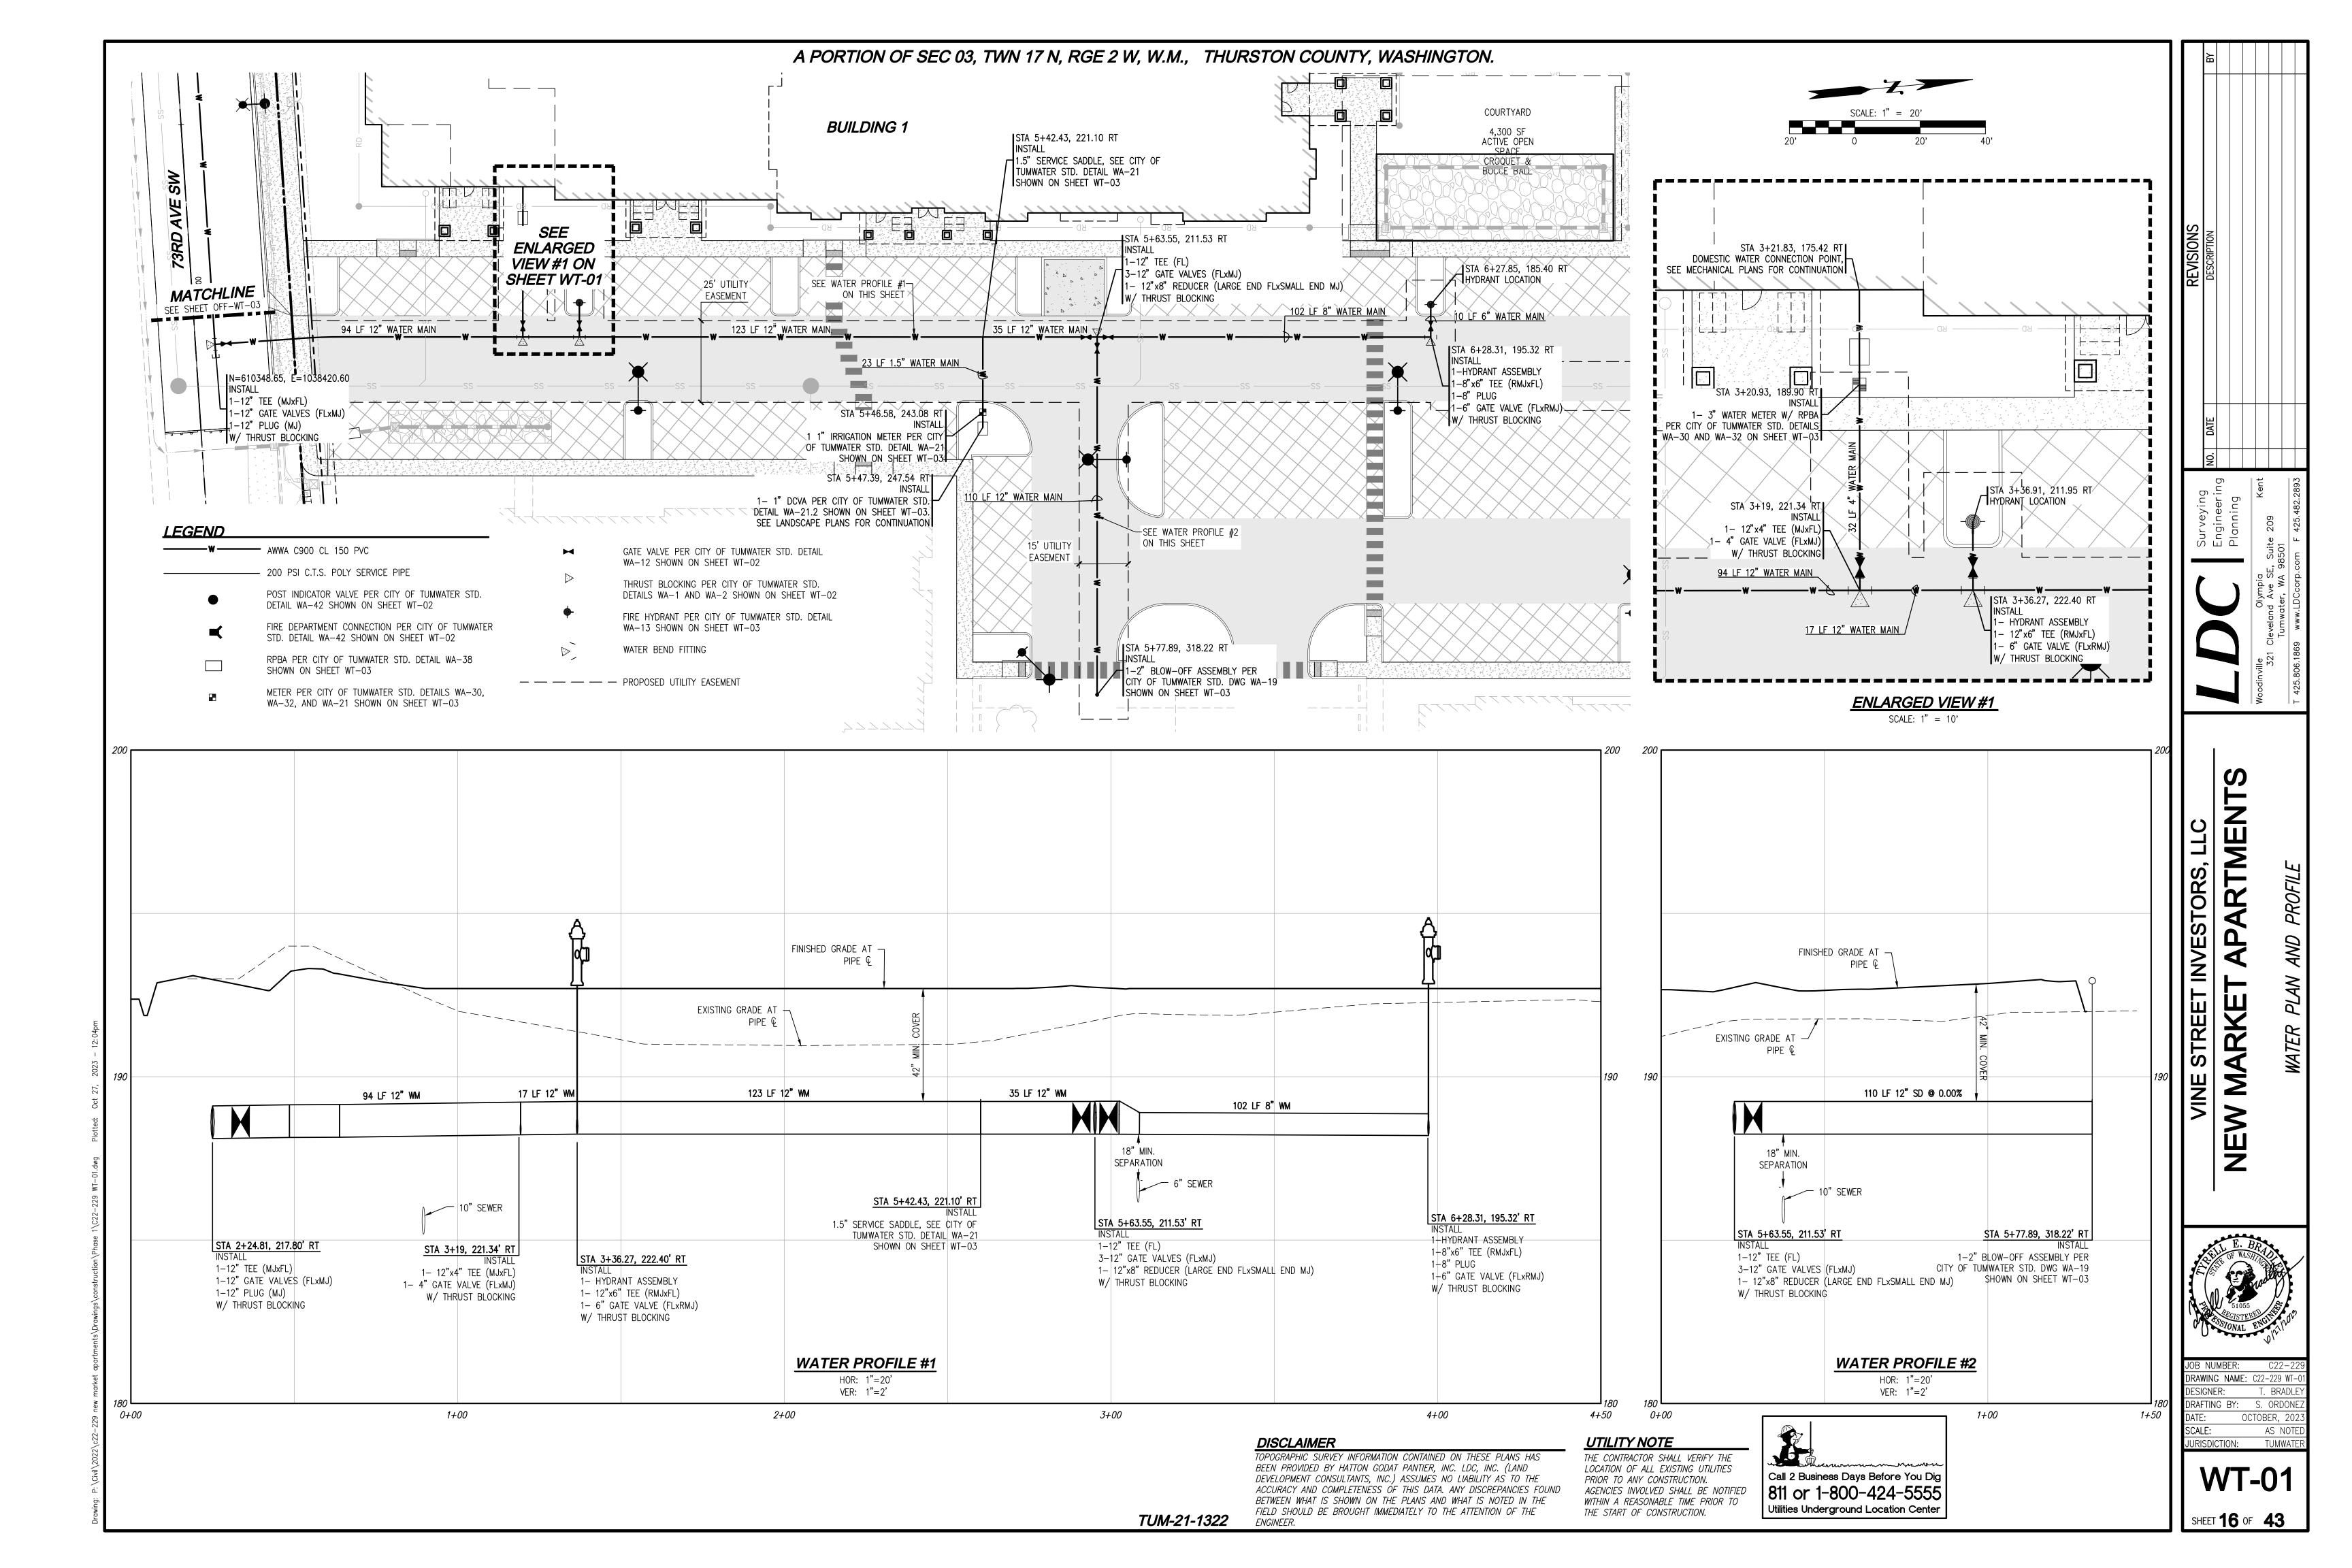


A PORTION OF SEC 03, TWN 17 N, RGE 2 W, W.M., THURSTON COUNTY, WASHINGTON.

CITY OF TUMWATER GENERAL NOTES- WATER

- A. ALL WORKMANSHIP AND MATERIALS WILL BE IN ACCORDANCE WITH CITY OF TUMWATER STANDARDS AND THE 1994 STATE OF WASHINGTON STANDARD SPECIFICATIONS FOR ROAD, BRIDGE AND MUNICIPAL CONSTRUCTION, LATEST EDITION.
- B. A PRECONSTRUCTION MEETING SHALL BE HELD WITH THE CITY PRIOR TO THE START OF
- C. WATER MAINS EQUAL TO OR LESS THAN TWELVE INCHES IN DIAMETER SHALL BE AWWA C900 CLASS 150, C905 CLASS 235, OR DUCTILE IRON CEMENT MORTAR LINED THICKNESS CLASS 50. ALL WATER MAINS LARGER THAN 12 INCHES IN DIAMETER SHALL BE AWWA CO5, CLASS 235 CEMENT MORTAR-LINED THICKNESS CLASS 50 OR DUCTILE IRON.
- D. GATE VALVES SHALL BE RESILIENT WEDGE, NRS (NON RISING STEM) WITH O-RINGS. VALVE ENDS SHALL BE MECHANICAL JOINT OR ANSI FLANGES. VALVES SHALL CONFORM TO AWWA 509-80. VALVES SHALL BE MUELLER, M & H, KENNEDY, CLOW R/W OR WATEROUS SERIES 500. EXISTING VALVES SHALL BE OPERATED BY CITY EMPLOYEES ONLY.
- E. HYDRANTS SHALL BE THE DRY BARREL TYPE AND ONE OF THE FOLLOWING: WATEROUS, M & H, MUELER, OR CLOW. HYDRANTS SHALL BE BAGGED UNTIL SYSTEM IS APPROVED. ALL HYDRANTS SHALL BE EQUIPPED WITH STORZ ADAPTERS.
- F. ALL LINES SHALL BE CHLORINATED AND TESTED IN CONFORMANCE WITH THE ABOVE REFERENCED SPECIFICATION (SEE NOTE A ABOVE).
- G. ALL PIPE AND SERVICES SHALL BE INSTALLED WITH 14 GAUGE COATED COPPER WIRE, WRAPPED AROUND THE PIPE, BROUGHT UP AND TIED OFF AT TOP OF VALVE BOX.
- H. PROVIDE TRAFFIC CONTROL PLAN(S) AS REQUIRED IN ACCORDANCE WITH MUTCD.
- I. ALL WATER MAINS SHALL BE STAKED FOR GRADES AND ALIGNMENT BY AN ENGINEERING OR SURVEYING FIRM CAPABLE OF PERFORMING SUCH WORK.
- J. CALL UNDERGROUND LOCATE AT 1-800-424-5555 A MINIMUM OF 48 HOURS PRIOR TO ANY EXCAVATIONS.
- K. WHERE CONNECTIONS REQUIRE "FIELD VERIFICATION", CONNECTION POINTS WILL BE EXPOSED BY CONTRACTOR AND FITTINGS VERIFIED 48 HOURS PRIOR TO DISTRIBUTING SHUT-DOWN NOTICES.
- L. AT ANY CONNECTION TO AN EXISTING LINE WHERE A NEW VALVE IS NOT INSTALLED, THE EXISTING VALVE MUST BE PRESSURE TESTED TO CITY STANDARDS PRIOR TO CONNECTION. IF AN EXISTING VALVE FAILS TO PASS THE TEST, THE CONTRACTOR SHALL MAKE THE NECESSARY PROVISIONS TO TEST THE NEW LINE PRIOR TO CONNECTION TO THE EXISTING SYSTEM OR INSTALL A NEW VALVE.
- M. NO LOT LINE WATERMAINS ARE ALLOWED.

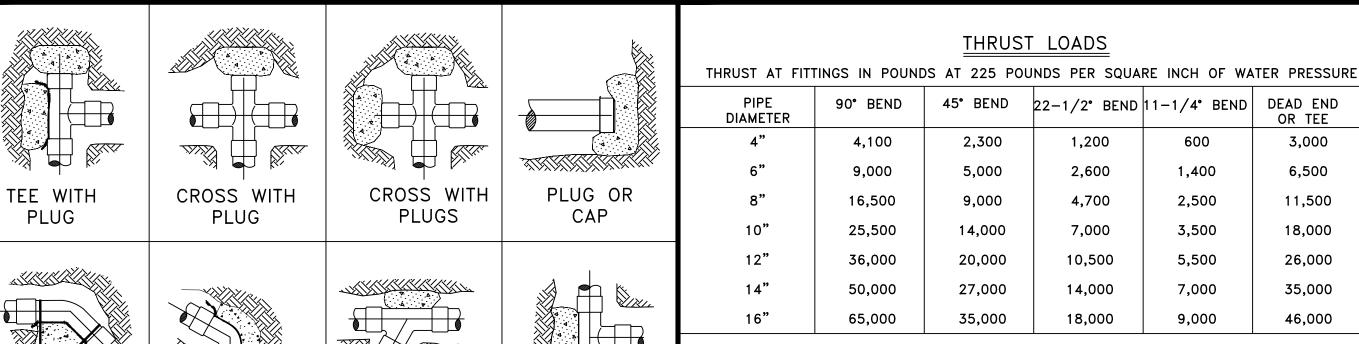

WYE VERTICAL BEND

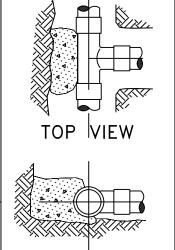

SIDE VIEW TEE

CITY OF TUMWATER

TRANSPORTATION & ENGINEERING DEPT

STANDARD BLOCKING

DETAIL

DES. DWG. BY CK'D BY DATE

PW

DWG. NO.

WA-1

NOT TO

KMC JUNE 2014 SCALE

APPROVED BY

CITY ENGINEER

CLAY

HARD SHALE

1. BLOCKING SHALL BE COMMERCIAL CONCRETE POURED IN PLACE THRUST BLOCK

THRUST LOADS

2,600

4,700

7,000

10,500

14,000

18,000

45° BEND

5,000

9,000

14,000

20,000


27,000

35,000

- WITH PLASTIC SHEETING OR SIMILAR MATERIAL TO ISOLATE THE FITTING. 2. TO DETERMINE THE BEARING AREA OF THE THRUST BLOCK IN SQUARE FEET(S.F.) EXAMPLE: 12" - 90° BEND IN SAND AND GRAVEL 36,000 LBS
- 3000 LB/S.F. = 12 S.F. OF AREA 3. AREAS MUST BE ADJUSTED FOR OTHER PIPE SIZE, PRESSURES AND SOIL
- BLOCKING SHALL BE ADEOUATE TO WITHSTAND FULL TEST PRESSURE AS WELL AS TO CONTINUOUSLY WITHSTAND OPERATING PRESSURE UNDER ALL CONDITIONS OF SERVICE.

SAFE SOIL BEARING LOADS FOR HORIZONTAL THRUSTS WHEN THE DEPTH OF COVER OVER THE PIPE EXCEEDS 2 FEET POUNDS PER SOIL SQUARE FOOT MUCK, PEAT SOFT CLAY 1,000 SAND 2,000 SAND & GRAVEL 3,000 SAND & GRAVEL 4,000 CEMENTED WITH

10,000

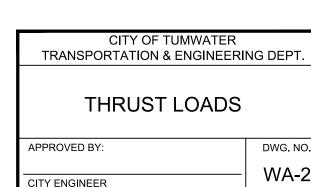

DES. DWG. BY CK'D BY DATE

PW KMC JUNE 2014 SCALE

NOT TO

22-1/2° BEND 11-1/4° BEND DEAD END

600

1,400

2,500

3,500

5,500

7,000

9,000

3,000

6,500


11,500


18,000

26,000

35,000

46,000

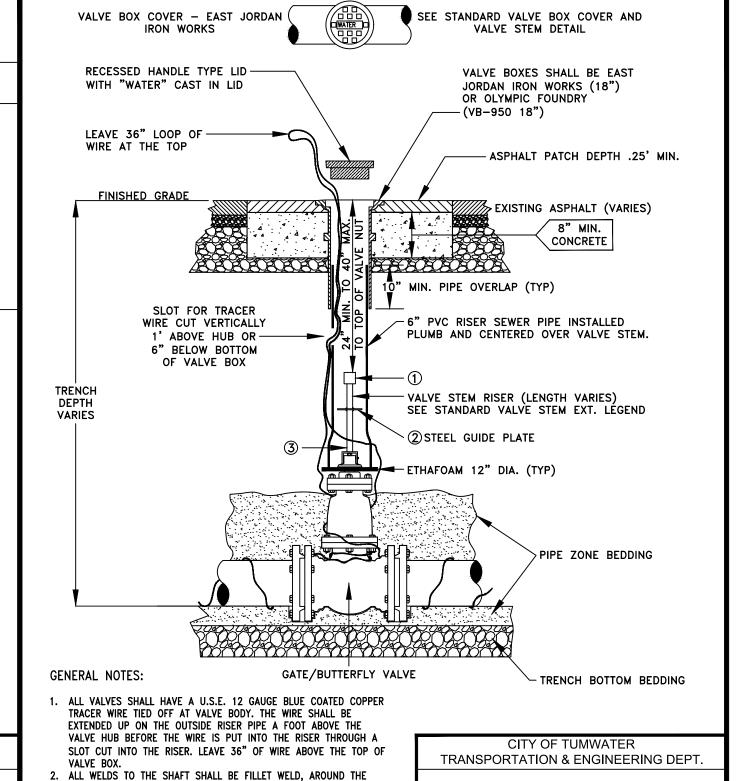

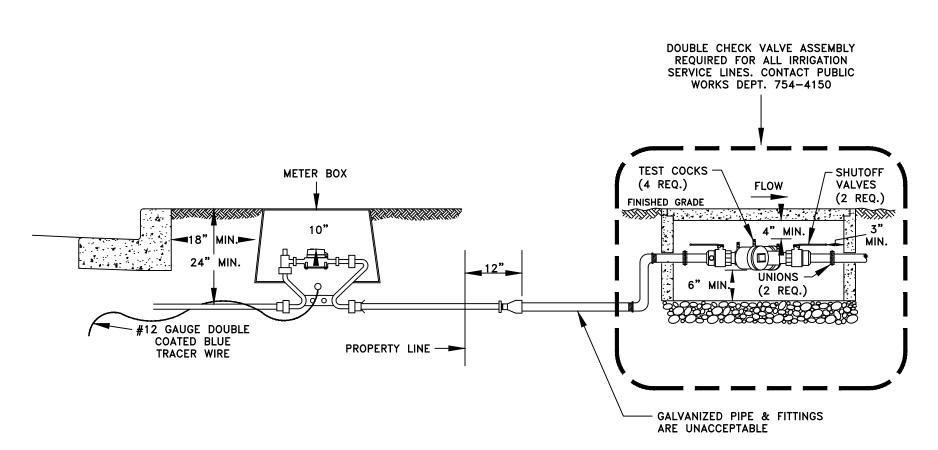

GENERAL NOTES:

METER BOXES SHOULD NOT BE DESIGNED IN DRIVEWAYS, DRIVEWAY APPROACHES, SIDEWALKS OR CONFLICTED AREAS. WHEN POSSIBLE CREATE PLANTER AREAS FOR METER BOX INSTALLATION. STAINLESS STEEL INSERTS ARE REQUIRED FOR ALL PACK JOINTS AND GRIP TIGHT ADAPTERS.

GENERAL NOTES:

1. CONCRETE THRUST BLOCKING TO BE POURED

2. PLASTIC BARRIER SHALL BE PLACED BETWEEN

ANCHOR REBAR SHALL BE 5/8" MINIMUM

ALL THRUST BLOCKS AND FITTIINGS


AGAINST UNDISTURBED EARTH.

- GALVANIZED PIPES AND FITTINGS BETWEEN WATER METER AND BACKFLOW ASSEMBLY ARE NOT I. DOUBLE INSULATED 12 GAUGE BLUE COATED COPPER U.S.E. TONING WIRE SPLICED TO MAINLINE
- TRACER WIRE ON ALL SERVICE LINES. 5. DOUBLE CHECK VALVE ASSEMBLY SHALL BE A WASHINGTON STATE DEPARTMENT OF HEALTH
- APPROVED MODEL. 6. DOUBLE CHECK VALVE ASSEMBLY IS TO LAY HORIZONTAL WITH THE GROUND. THE WATER LINE SHALL BE THOROUGHLY FLUSHED PRIOR TO INSTALLING THE BACKFLOW ASSEMBLY. . THE DOUBLE CHECK VALVE ASSEMBLY SHALL NOT BE PLACED UNDERGROUND IN AN AREA SUBJECT
- 9. A PLUMBING PERMIT IS REQUIRED.
- 10. THE BACKFLOW ASSEMBLY SHALL BE TESTED BY A CERTIFIED BACKFLOW ASSEMBLY TESTER AFTER INSTALLATION AND PRIOR TO ACCEPTANCE. 1. TEST RESULTS SHALL BE SENT TO THE CITY OF TUMWATER CROSS CONNECTION SPECIALIST.

3" MIN.	TF PLA BE STA #12
	GRA ZOI ST/
EER EERING DEPT. METER	WHEN U ENCOUN FOUN AS DI

CITY OF TUMWAT TRANSPORTATION & ENGINE 3/4" & 1" SINGLE M SEDVICE W/DCV/A

SERVICE W/DCVA						
PROV	ED BY:			DWG. NO.		
				WA-21.2		
Y ENC	SINEER					
ES.	DWG. BY	CK'D BY	DATE	NOT TO		
W	PW	KMC	JULY 2014	SCALE		

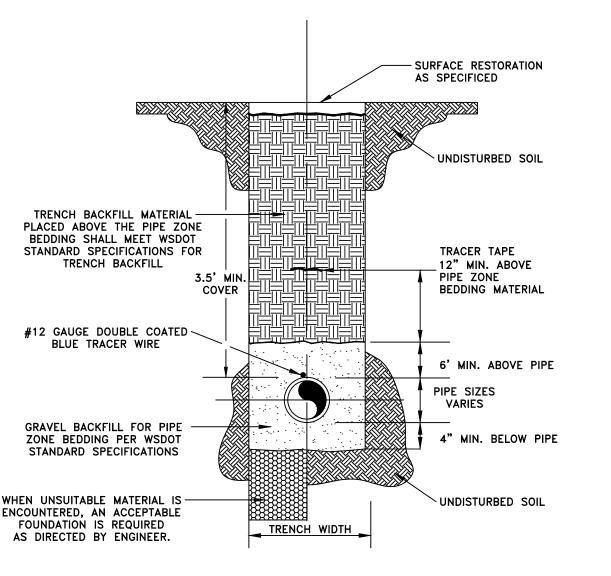


MAXIUM TRENCH WIDTH AT TOP OF PIPE: I.D. PLUS 30" FOR PIPE 15" AND UNDER. (1.5 XI.D.) PLUS 18" FOR PIPE 18" AND OVER.

GENERAL NOTES:

- COMPACTION: THE TESTING REQUIREMENTS SHALL BE PER THE CITY OF TUMWATER DEVELOPMENT GUIDELINES AND PUBLIC WORKS STANDARDS.
- . ALL MATERIALS, WORKMANSHIP, AND INSTALLATION SHALL BE IN CONFORMANCE WITH THE WSDOT STANDARD SPECIFICATIONS FOR ROAD, BRIDGE AND MUNICIPAL CONSTRUCTION OR AS AMENDED BY CITY OF TUMWATER

TRANSPORTATION & ENGINEERING DEPT. WATER TRENCH DETAIL **UNPAVED AREAS**

APPROV	DWG. NO.			
CITY ENG	WA-5.2			
DES.	DWG. BY	CK'D BY	DATE	NOT TO
PW	JC	ВН	JAN. 2020	SCALE

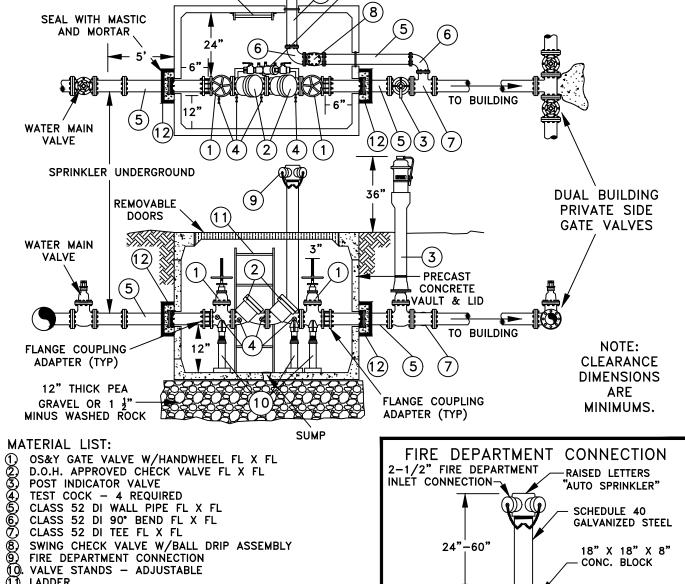

12. RESTRAIN INLET & OUTLET W/MEGALUG MID-SPAN RESTRAINTS AND THRUST BLOCK ADJACENT TO VAULT. **GENERAL NOTES:** 1. THOROUGHLY FLUSH LINES PRIOR TO INSTALLING BACK FLOW ASSEMBLY. PIPE FROM VAULT TO BUILDING SHALL BE CLASS 52 DI. . TAMPER SWITCHES SHALL BE INSTALLED ON 1 AND 3 CONNECTED TO BUILDING FIRE ALARM SYSTEM. 4. WHERE PIPING PASSES THROUGH CONCRETE WALL PROVIDE 2" CLEARANCE W/ WATERPROOF MASTIC OR FLEXIBLE 5. DIAMETER OF PIPE AND FITTINGS TO BE DETERMINED BY

ENTIRE PLATE PER #2 BELOW,

VALVE STEM EXTENSION LEGEND

STEEL WELDED TO GUIDE PLATE.

OPERATING NUT. LENGTH AS REQUIRED.

1 VALVE OPERATING NUT OR 1-7/8" X 1- 7/8" X 2" HIGH GRADE

② 3/16" THICK X 5 1/5" DIA STEEL GUIDE PLATE WELDED TO RISER

(3) 2"X2"X 3/16" SQUARE STRUCTURAL STEEL TUBING TO FIT

LADDER TO BE BOLTED (11)

TO WALL AND FLOOR.

CERTIFIED SPRINKLER DESIGNER. 6. ALL PIPING SHALL BE A MINIMUM OF 4" DIAMETER AS 7. ALL VAULTS SHALL BE EQUIPPED WITH A DRAIN OR BE INSTALLED ABOVE GROUND. 8. ALL FIRE SPRINKLER LINES UP TO THE FIRST VALVE ON THE DCDA SHALL BE DISINFECTED, PRESSURE TESTED, FLUSHED AND TESTED FOR PURITY PER THE CITY OF TUMWATER STANDARDS.

FIRE DEPARTMENT	CONNECTION
1/2" FIRE DEPARTMENT	-RAISED LETTERS
ET CONNECTION—	"AUTO SPRINKLER"
	— SCHEDULE 40
	GALVANIZED STEEL
24"-60"	18" X 18" X 8" — CONC. BLOCK
	SCHEDULE 40 GALVANIZED STEEL WRAPPED WITH 6 MIL PLASTIC
CITY OF TUM\	WATER
TRANSPORTATION & EN	GINEERING DEPT.
DOUBLE CHECK	DETECTOR

STANDARD VALVE BOX

DES. DWG. BY CK'D BY DATE

DWG. NO.

NOT TO

KMC JUNE 2014 SCALE

PPROVED BY:

TY ENGINEER

- BY-PASS W/3/4" DCVA

ASSEMBLY W/FDC

APPROV	DWG. NO.			
				WA-42
CITY ENG	VV/ \ 12			
DES.	DWG. BY	CK'D BY	DATE	NOT TO
PW	PW	KMC	JULY 2014	SCALE

(DCDA) VALVE

DISCLAIMER

TOPOGRAPHIC SURVEY INFORMATION CONTAINED ON THESE PLANS HAS BEEN PROVIDED BY HATTON GODAT PANTIER. INC. LDC. INC. (LAND DEVELOPMENT CONSULTANTS, INC.) ASSUMES NO LIABILITY AS TO THE ACCURACY AND COMPLETENESS OF THIS DATA. ANY DISCREPANCIES FOUND BETWEEN WHAT IS SHOWN ON THE PLANS AND WHAT IS NOTED IN THE FIELD SHOULD BE BROUGHT IMMEDIATELY TO THE ATTENTION OF THE

UTILITY NOTE

THE CONTRACTOR SHALL VERIFY THE LOCATION OF ALL EXISTING UTILITIES PRIOR TO ANY CONSTRUCTION. AGENCIES INVOLVED SHALL BE NOTIFIED WITHIN A REASONABLE TIME PRIOR TO THE START OF CONSTRUCTION.





RTMEN ORS Ш ARKE

JOB NUMBER: DRAWING NAME: C22-229 WT DESIGNER: T. BRADL DRAFTING BY: S. ORDONE OCTOBER, ISCALE: AS NOTE JURISDICTION: TUMWATE

SHEET 17 OF 43

TUM-21-1322

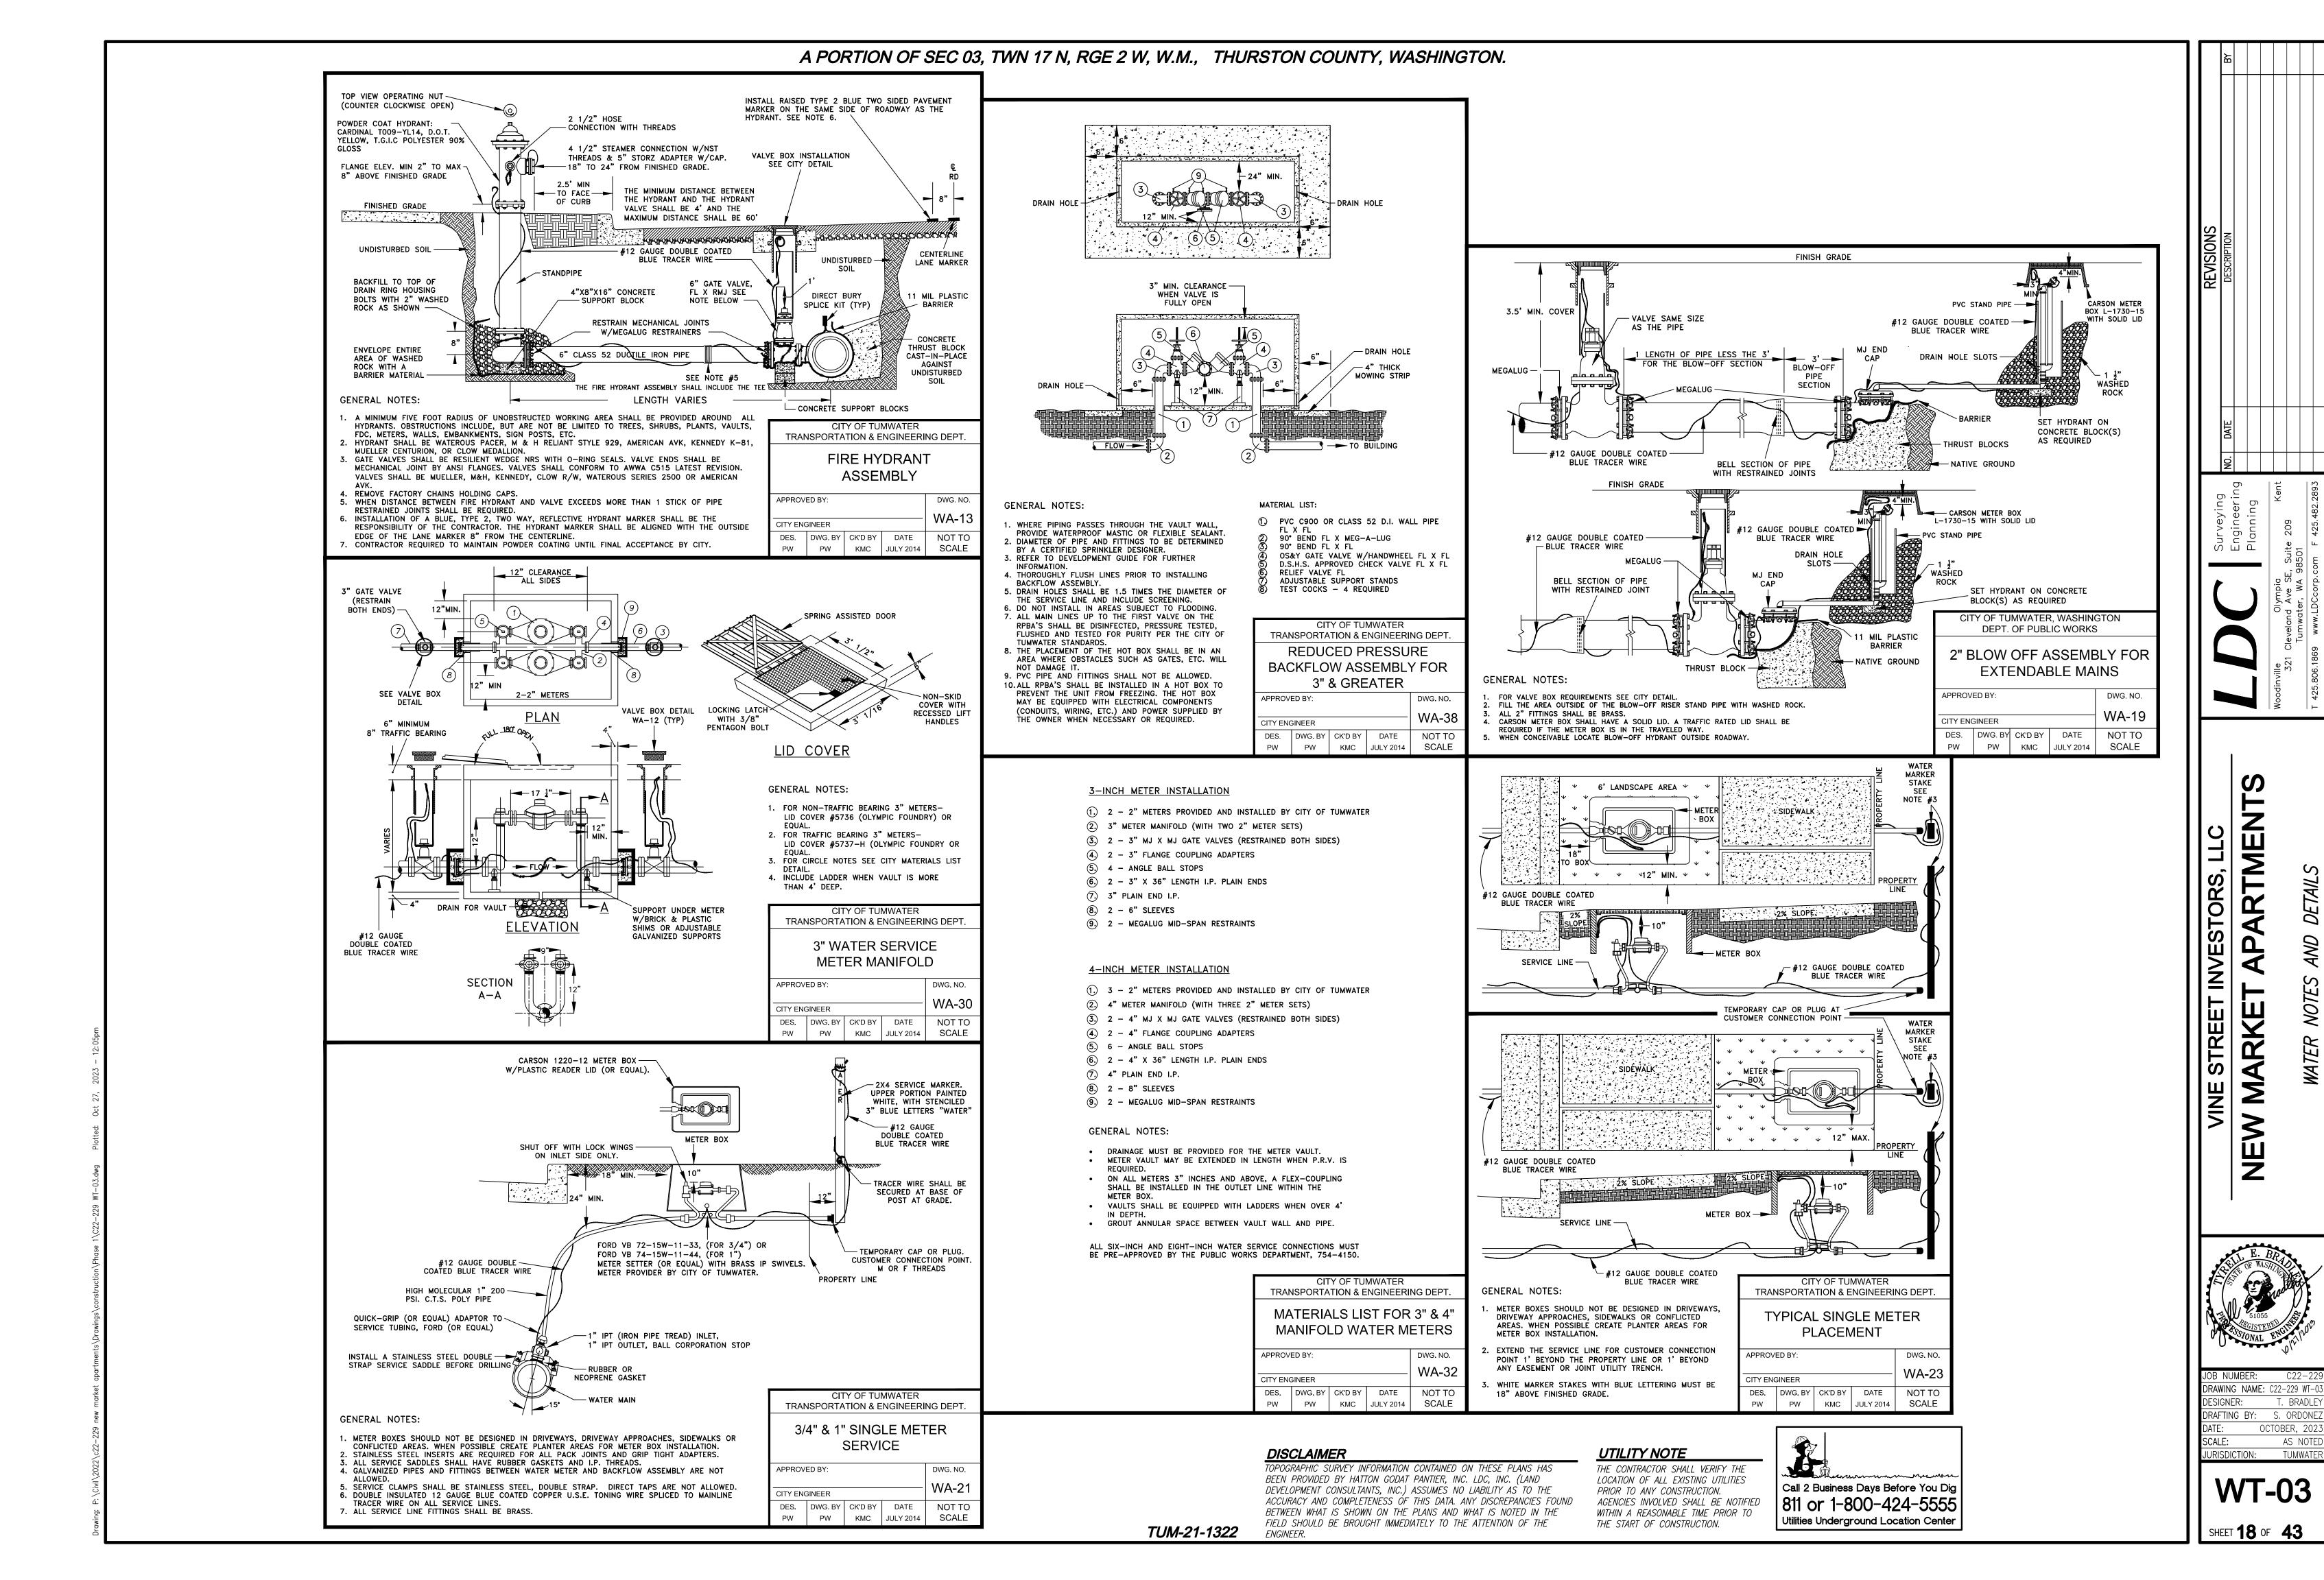


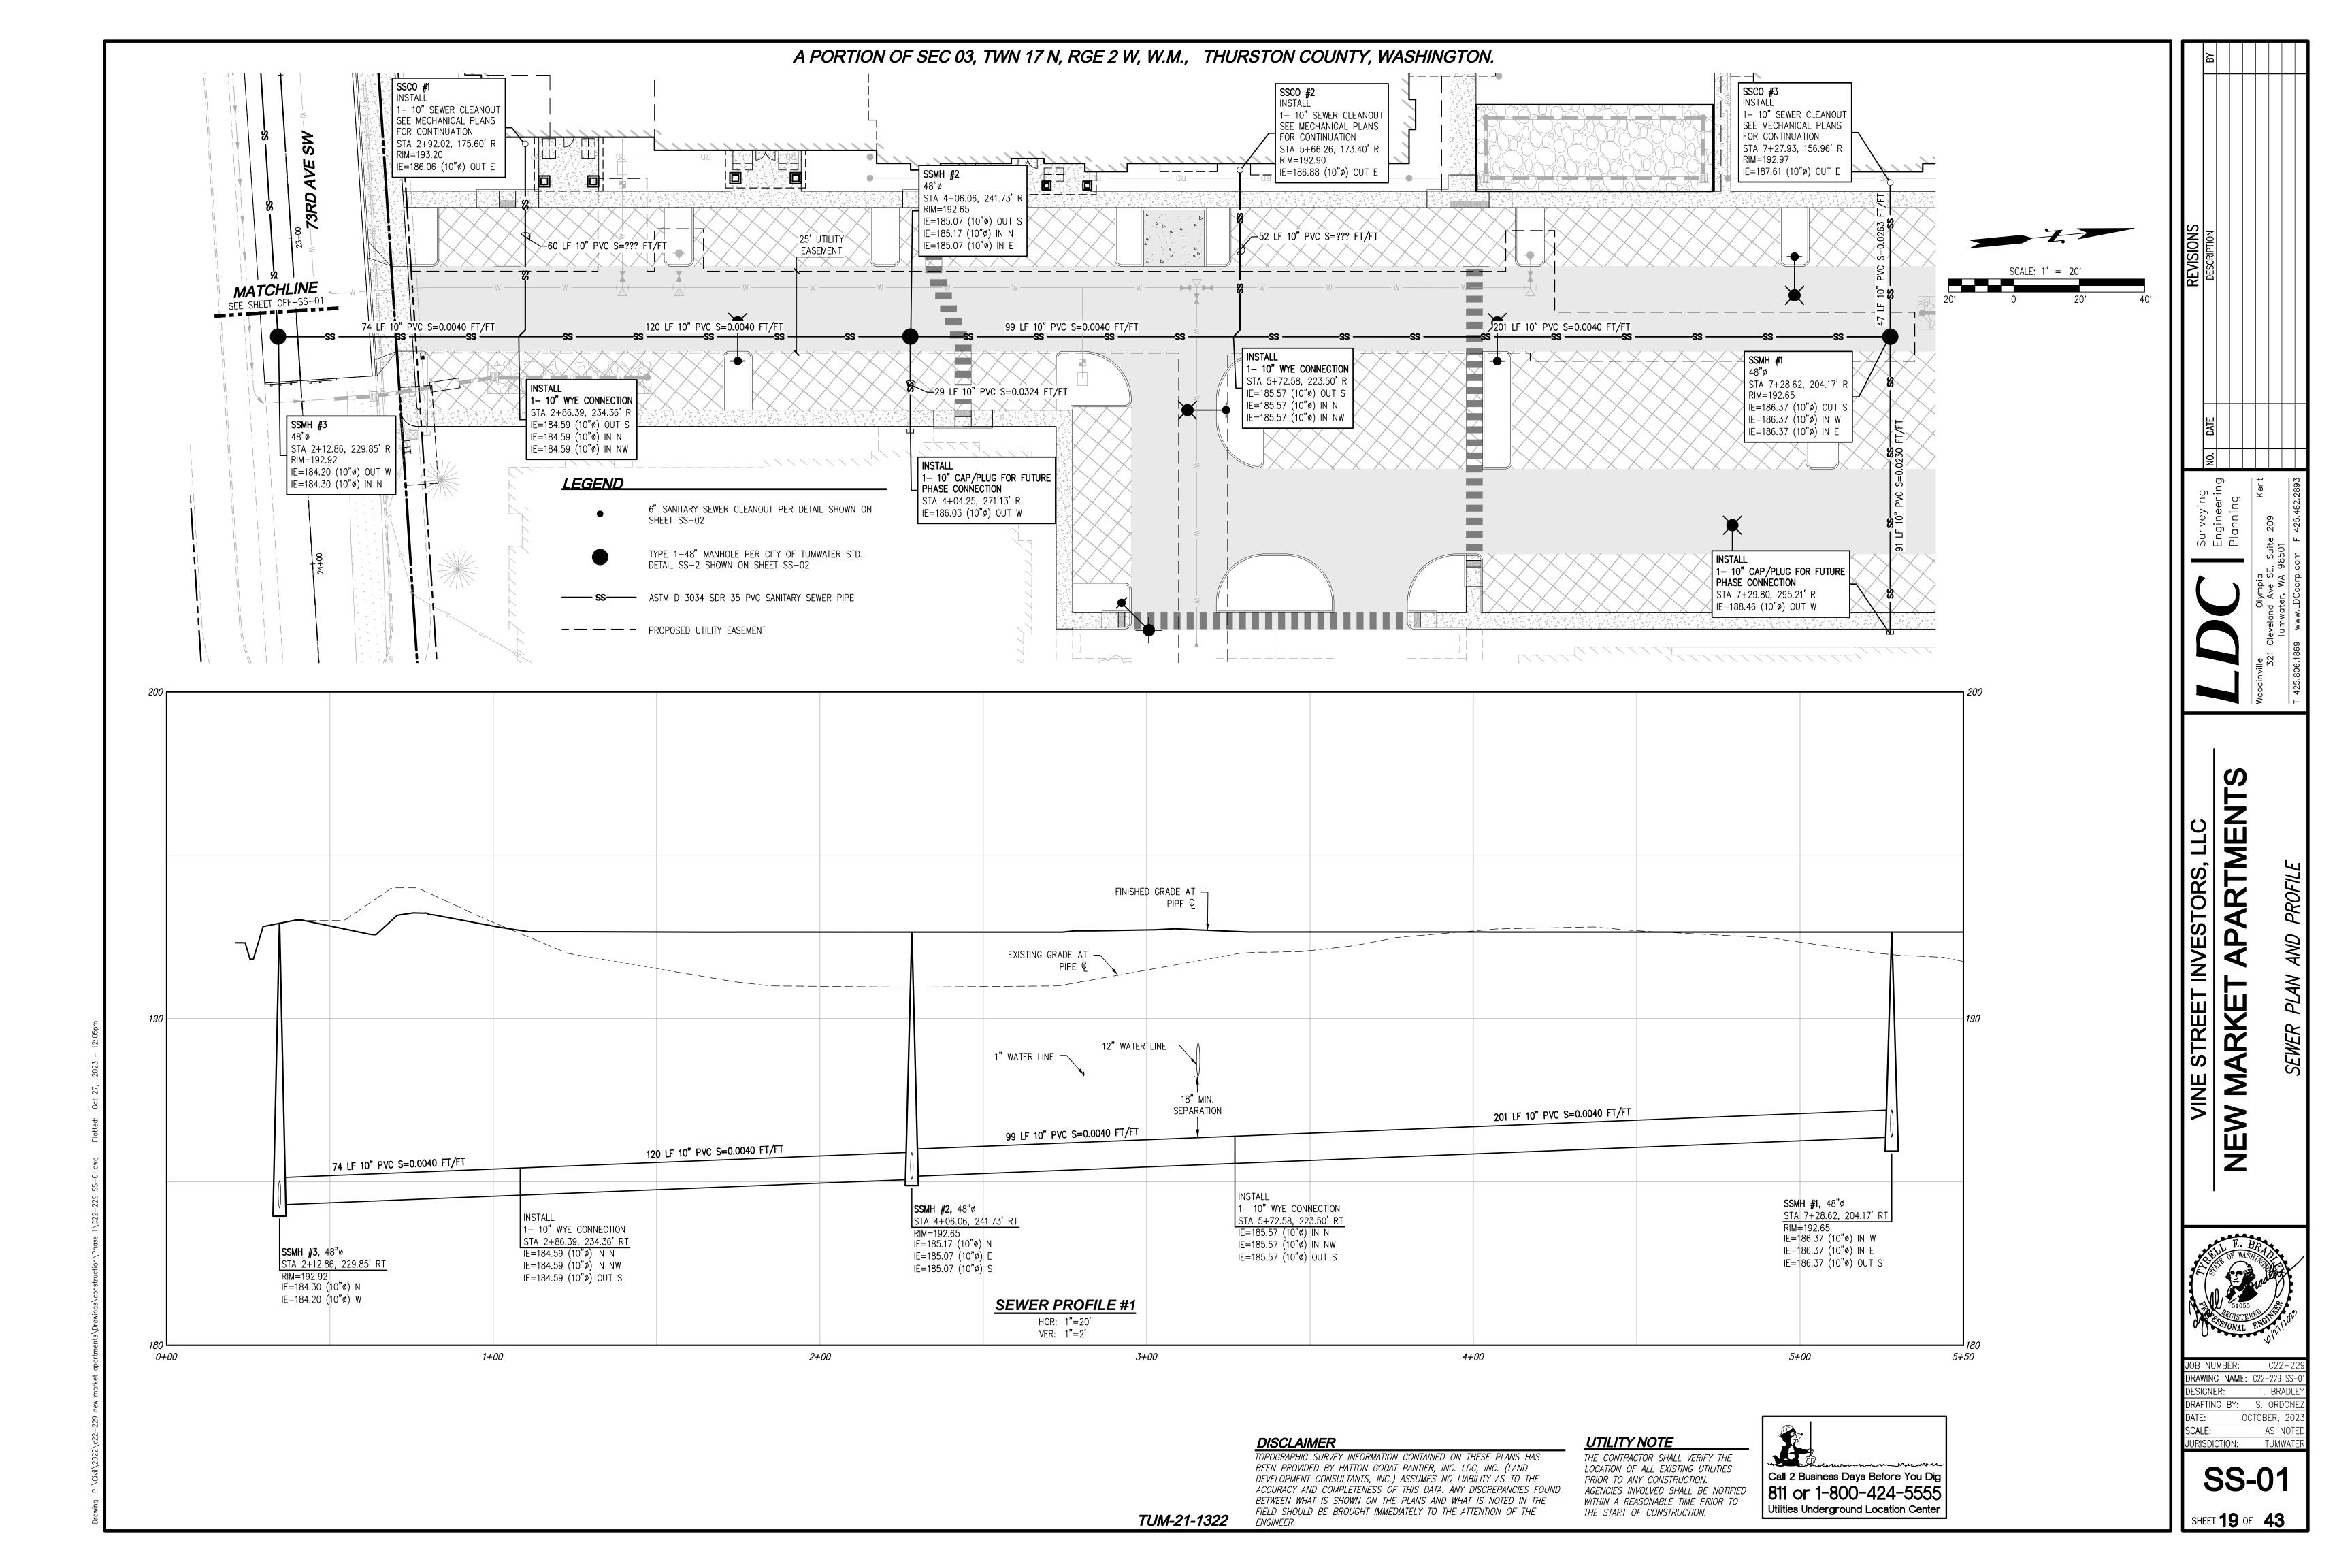

CITY OF TUMWATER GENERAL NOTES SANITARY SEWER


- 1. ALL WORKMANSHIP AND MATERIALS WILL BE IN ACCORDANCE WITH CITY OF TUMWATER STANDARDS AND THE MOST CURRENT EDITION OF THE STATE OF WASHINGTON STANDARD SPECIFICATIONS FOR ROAD, BRIDGE AND MUNICIPAL CONSTRUCTION.
- 2. CITY OF TUMWATER DATUM SHALL BE USED FOR ALL VERTICAL CONTROL. A BENCHMARK LIST IS AVAILABLE FROM THE PUBLIC
- 3. ALL APPROVALS AND PERMITS REQUIRED BY THE CITY OF TUMWATER SHALL BE OBTAINED BY THE CONTRACTOR PRIOR TO THE START OF CONSTRUCTION.
- 4. IF CONSTRUCTION IS TO TAKE PLACE IN THE COUNTY RIGHT-OF-WAY, THE CONTRACTOR SHALL NOTIFY THE COUNTY AND OBTAIN ALL THE REQUIRED APPROVALS AND PERMITS.
- 5. A PRECONSTRUCTION MEETING SHALL BE HELD WITH THE CITY OF TUMWATER CONSTRUCTION INSPECTOR PRIOR TO THE START OF CONSTRUCTION.
- 6. THE CITY OF TUMWATER CONSTRUCTION INSPECTOR SHALL BE NOTIFIED A MINIMUM OF 48 HOURS IN ADVANCE OF A TAP CONNECTION TO AN EXISTING MAIN.
- 7. THE CONTRACTOR SHALL BE FULLY RESPONSIBLE FOR THE LOCATION AND PROTECTION OF ALL EXISTING UTILITIES. THE CONTRACTOR SHALL VERIFY ALL UTILITY LOCATIONS PRIOR TO CONSTRUCTION BY CALLING THE UNDERGROUND LOCATE LINE AT 1-800-424-5555 A MINIMUM OF 48 HOURS PRIOR TO ANY EXCAVATION.
- 8. GRAVITY SEWER MAIN SHALL BE PVC, ASTM D 3034 SDR 35 OF ASTM F 789 WITH JOINTS AND RUBBER GASKETS CONFORMING TO ASTM D 3212 AND ASTM F 477.
- 9. PRECAST MANHOLES SHALL MEET THE REQUIREMENTS OF ASTM C 478. MANHOLES SHALL BE TYPE 1-48" MANHOLES OR LARGER UNLESS OTHERWISE SPECIFIED ON THE PLANS. JOINTS SHALL BE RUBBER GASKETED CONFORMING TO ASTM C 443 AND SHALL BE GROUTED FROM THE INSIDE. LIFT HOLES SHALL BE GROUTED FROM THE OUTSIDE OF THE MANHOLE.
- 10. SIDE SEWER SERVICES SHALL BE PVC, ASTM D 3034 SDR 35 WITH FLEXIBLE GASKETED JOINTS. SIDE SEWER CONNECTIONS SHALL BE MADE BY A TAP TO AN EXISTING MAIN OR A WYE BRANCH FROM A NEW MAIN.
- 11. ALL SEWER MAINS SHALL BE FIELD STAKED FOR GRADES AND ALIGNMENT BY A LICENSED ENGINEERING OR SURVEYING FIRM QUALIFIED TO PERFORM SUCH WORK.
- 12. BEDDING OF THE SEWER MAIN AND COMPACTION OF THE BACKFILL MATERIAL SHALL BE REQUIRED IN ACCORDANCE WITH THE ABOVE MENTIONED SPECIFICATION (SEE NOTE 1).
- 13. TEMPORARY STREET PATCHING SHALL BE ALLOWED FOR AS APPROVED BY THE CITY ENGINEER. TEMPORARY STREET PATCHING SHALL BE PROVIDED BY PLACEMENT AND COMPACTION OF ONE INCH MAXIMUM ASPHALT CONCRETE COLD MIX. CONTRACTOR SHALL BE RESPONSIBLE FOR MAINTENANCE AS REQUIRED.
- 14. EROSION CONTROL MEASURES SHALL BE TAKEN BY THE CONTRACTOR DURING CONSTRUCTION TO PREVENT INFILTRATION OF EXISTING AND PROPOSED STORM DRAINAGE FACILITIES AND ROADWAYS.
- 15. PROVIDE TRAFFIC CONTROL PLAN(S) IN ACCORDANCE WITH THE MANUAL ON UNIFORM TRAFFIC CONTROL DEVICES (MUTCD) AS
- 16. IT SHALL BE THE RESPONSIBILITY OF THE CONTRACTOR TO HAVE A COPY OF THESE APPROVED PLANS ON THE CONSTRUCTION SITE AT ALL TIMES.
- 17. ANY CHANGES TO THE DESIGN SHALL FIRST BE REVIEWED AND APPROVED BY THE PROJECT ENGINEER AND THE CITY OF TUMWATER.
- 18. ALL LINES SHALL BE CLEANED AND PRESSURE TESTED IN CONFORMANCE WITH THE ABOVE REFERENCED SPECIFICATIONS (SEE NOTE 1). A WATER TEST OF ALL MANHOLES IN ACCORDANCE WITH TUMWATER STANDARD IS ALSO REQUIRED. TESTING SHALL TAKE PLACE AFTER ALL UNDERGROUND UTILITIES ARE INSTALLED AND COMPACTION OF THE ROADWAY SUBGRADE IS COMPLETED.
- 19. PRIOR TO BACKFILL, ALL MAINS AND APPURTENANCES SHALL BE INSPECTED AND APPROVED BY THE CITY OF TUMWATER CONSTRUCTION INSPECTOR. APPROVAL SHALL NOT RELIEVE THE CONTRACTOR FOR CORRECTION OF ANY DEFICIENCIES AND/OR FAILURES AS DETERMINED BY SUBSEQUENT TESTING AND INSPECTIONS. IT SHALL BE THE CONTRACTOR'S RESPONSIBILITY TO NOTIFY THE CITY OF TUMWATER FOR THE REQUIRED INSPECTIONS.
- 20. ALL SANITARY SEWER MAINS SHALL BE PLACED IN PUBLIC RIGHT-OF-WAY OF IF IN EASEMENT AREAS, PROVIDE 12 FOOT WIDE PAVED (SIX INCH BALLAST, TWO INCH CRUSHED, TWO INCH ASPHALT) ACCESS TO ALL MANHOLES. NO LOT LINE SEWER MAINS
- 21. ALL MAINS WILL BE DEDICATED TO THE CITY FOR MAINTENANCE WITH APPROPRIATE BILLS OF SALE AND EASEMENTS.
- 22. CITY OWNERSHIP OF THE MAIN AND LATERAL WILL GO TO THE PROPERTY LINE OR EASEMENT IF A CLEANOUT EXISTS AT THIS POINT. IF NO CLEANOUT EXISTS. CITY RESPONSIBILITY ENDS AT THE LIMIT OF THE MAIN.


A PORTION OF SEC 03, TWN 17 N, RGE 2 W, W.M., THURSTON COUNTY, WASHINGTON.

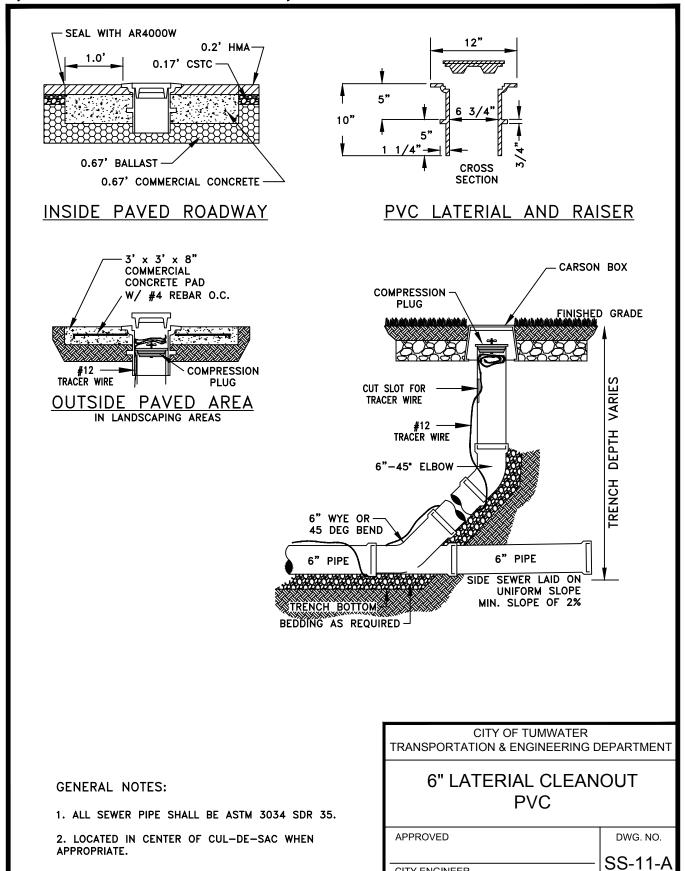

DES. DWG. BY CK'D BY DATE

PW | MW | NOV. 2014 | SCALE

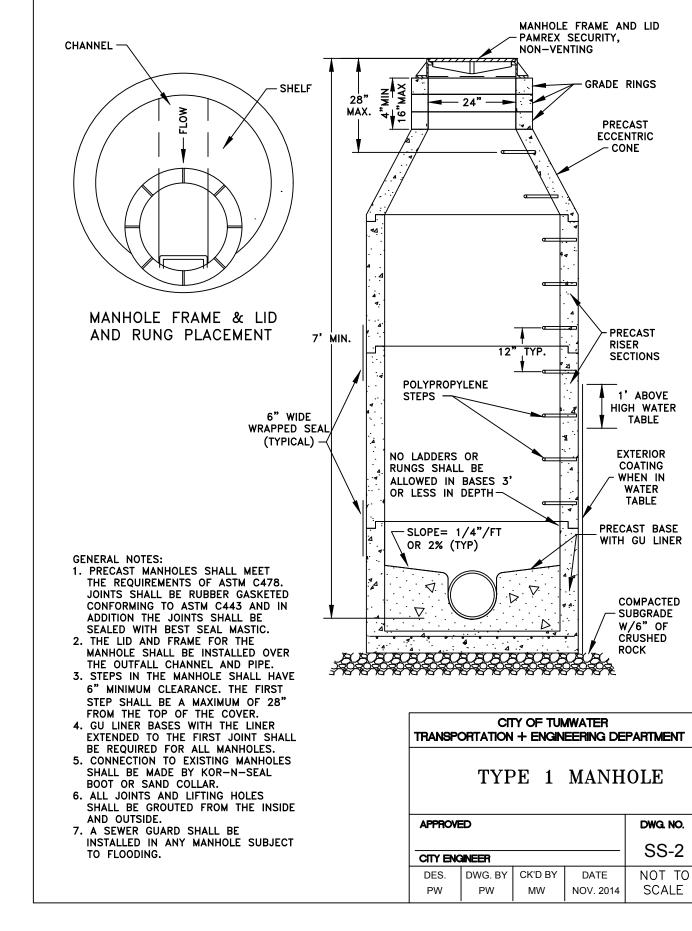

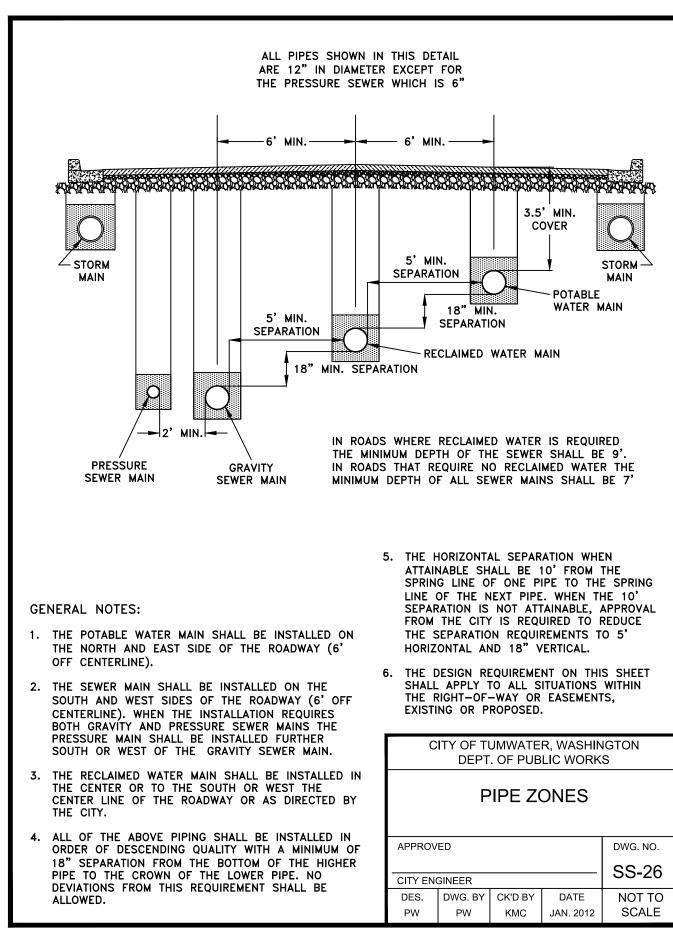

DISCLAIMER

TOPOGRAPHIC SURVEY INFORMATION CONTAINED ON THESE PLANS HAS BEEN PROVIDED BY HATTON GODAT PANTIER, INC. LDC, INC. (LAND DEVELOPMENT CONSULTANTS. INC.) ASSUMES NO LIABILITY AS TO THE ACCURACY AND COMPLETENESS OF THIS DATA. ANY DISCREPANCIES FOUND BETWEEN WHAT IS SHOWN ON THE PLANS AND WHAT IS NOTED IN THE FIELD SHOULD BE BROUGHT IMMEDIATELY TO THE ATTENTION OF THE

UTILITY NOTE


THE CONTRACTOR SHALL VERIFY THE LOCATION OF ALL EXISTING UTILITIES PRIOR TO ANY CONSTRUCTION. AGENCIES INVOLVED SHALL BE NOTIFIED WITHIN A REASONABLE TIME PRIOR TO THE START OF CONSTRUCTION.



	ΑВ				
REVISIONS	DESCRIPTION				
	IE I				

ARTME ORS AP ARKE


Ž

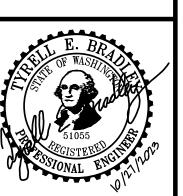

JOB NUMBER:	C22-22
DRAWING NAM	E: C22-229 SS-0
DESIGNER:	T. BRADLE`
DRAFTING BY:	S. ORDONE
DATE:	OCTOBER, 202
SCALE:	AS NOTEI
JURISDICTION:	TUMWATE

SHEET **20** OF **43**

TUM-21-1322

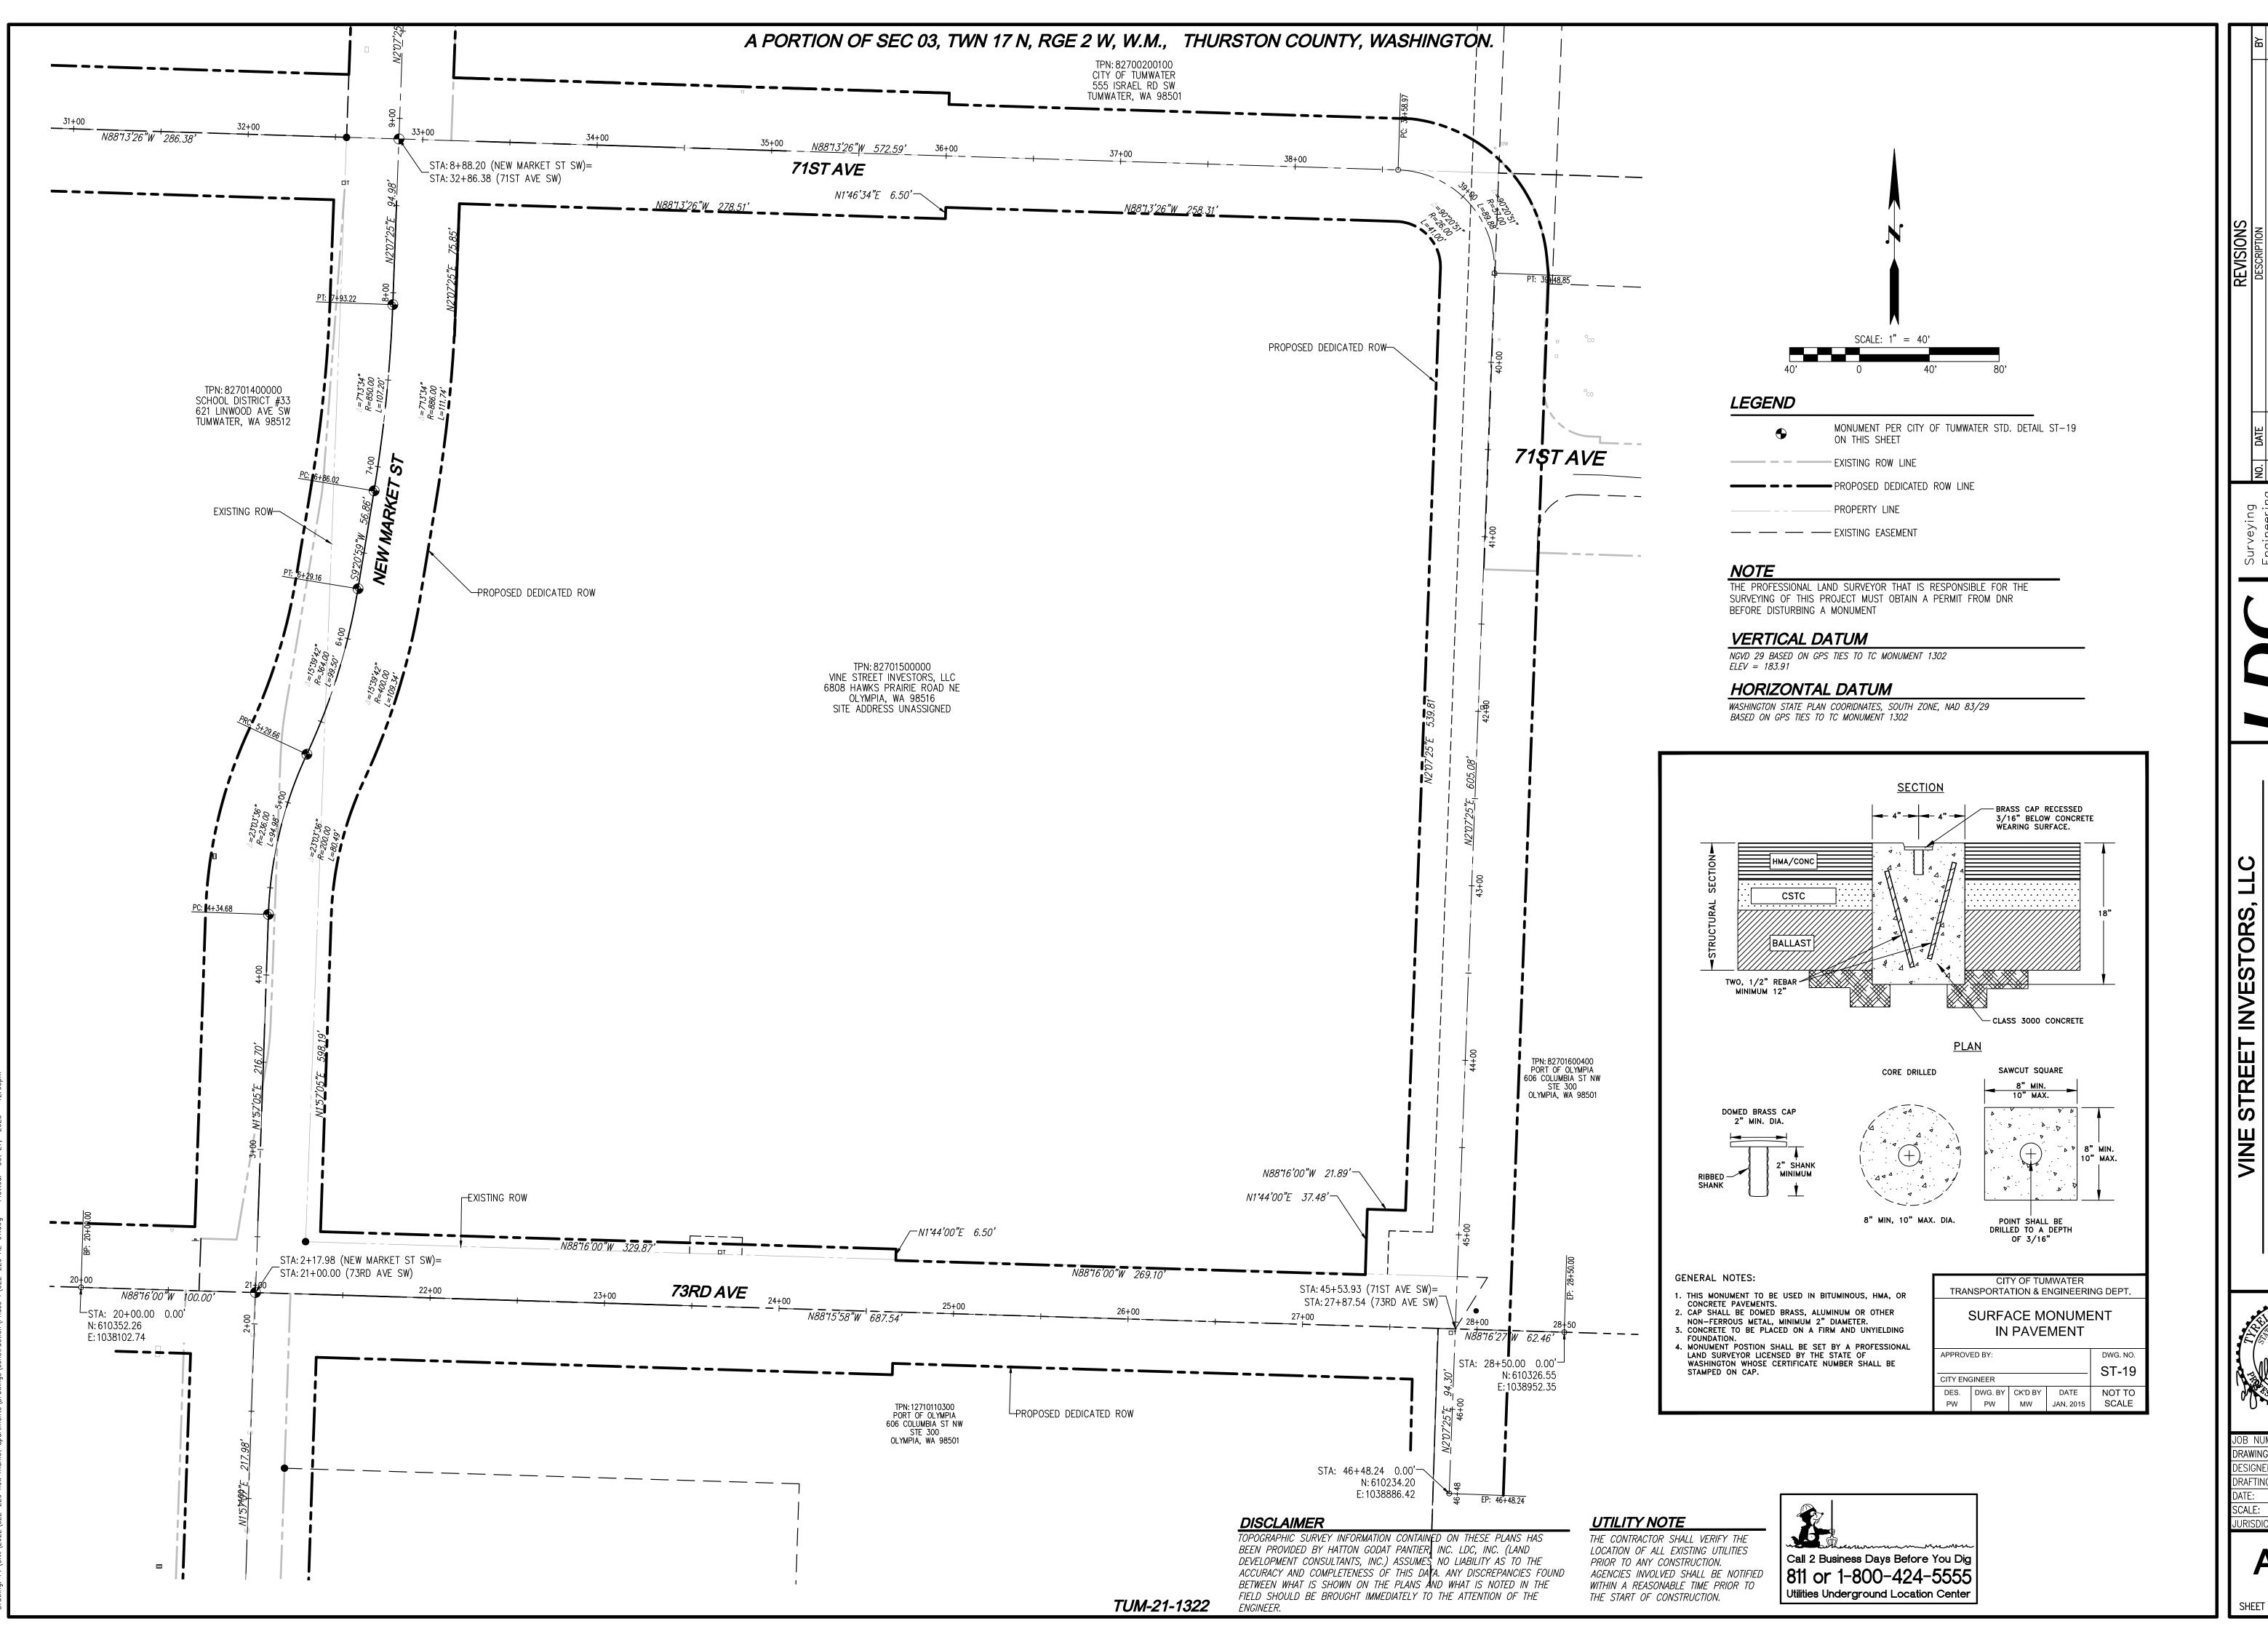

NO. DATE DESCRIPTION BY

ville Olympia 321 Cleveland Ave SE, Suite 209 Tumwater, WA 98501 306.1869 www.LDCcorp.com F 425.482


EW MARKET APARTMENT



JOB NUMBER: C22-229
DRAWING NAME: C22-229 AL-01
DESIGNER: T. BRADLEY
DRAFTING BY: S. ORDONEZ
DATE: OCTOBER, 2023
SCALE: AS NOTED
JURISDICTION: TUMWATER

AL-01

SHEET **21** OF **4**5

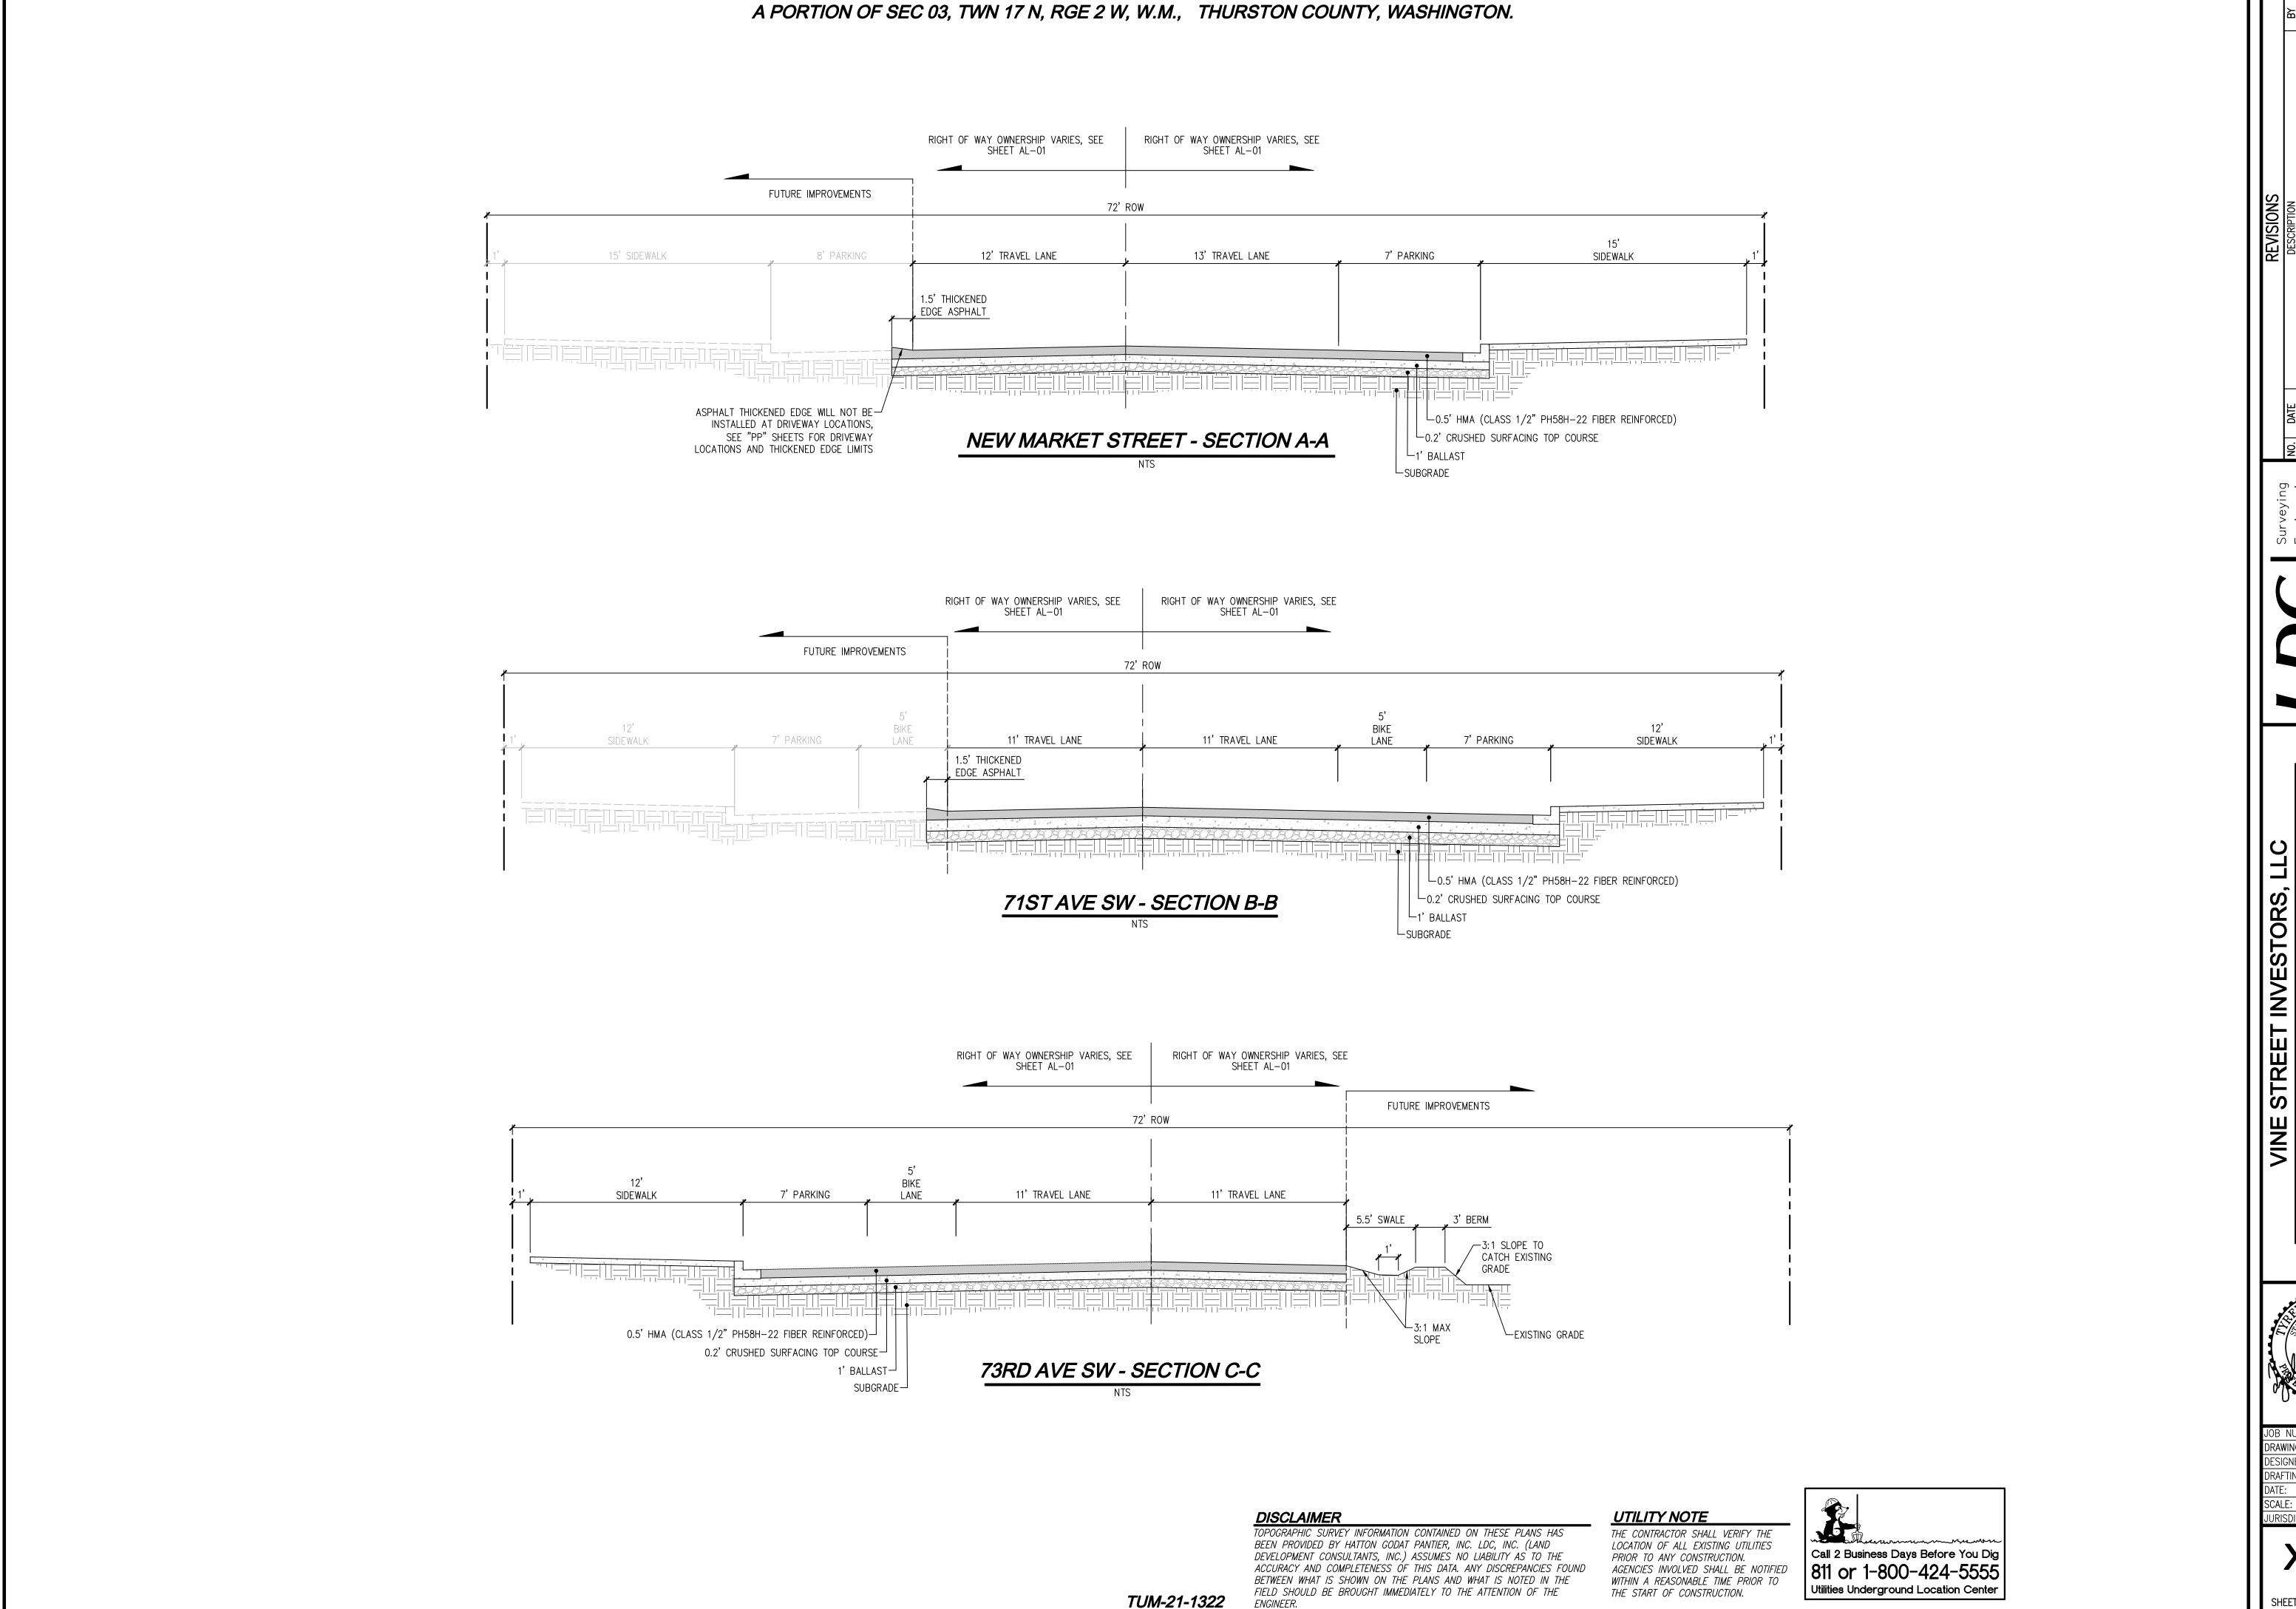


APARTMEN


MARKET

JOB NUMBER: DRAWING NAME: C22-229 XS-DESIGNER: DRAFTING BY: S. ORDONE.

DATE: OCTOBER, 202 SCALE: JURISDICTION: TUMWATER

SHEET **22** OF **43**

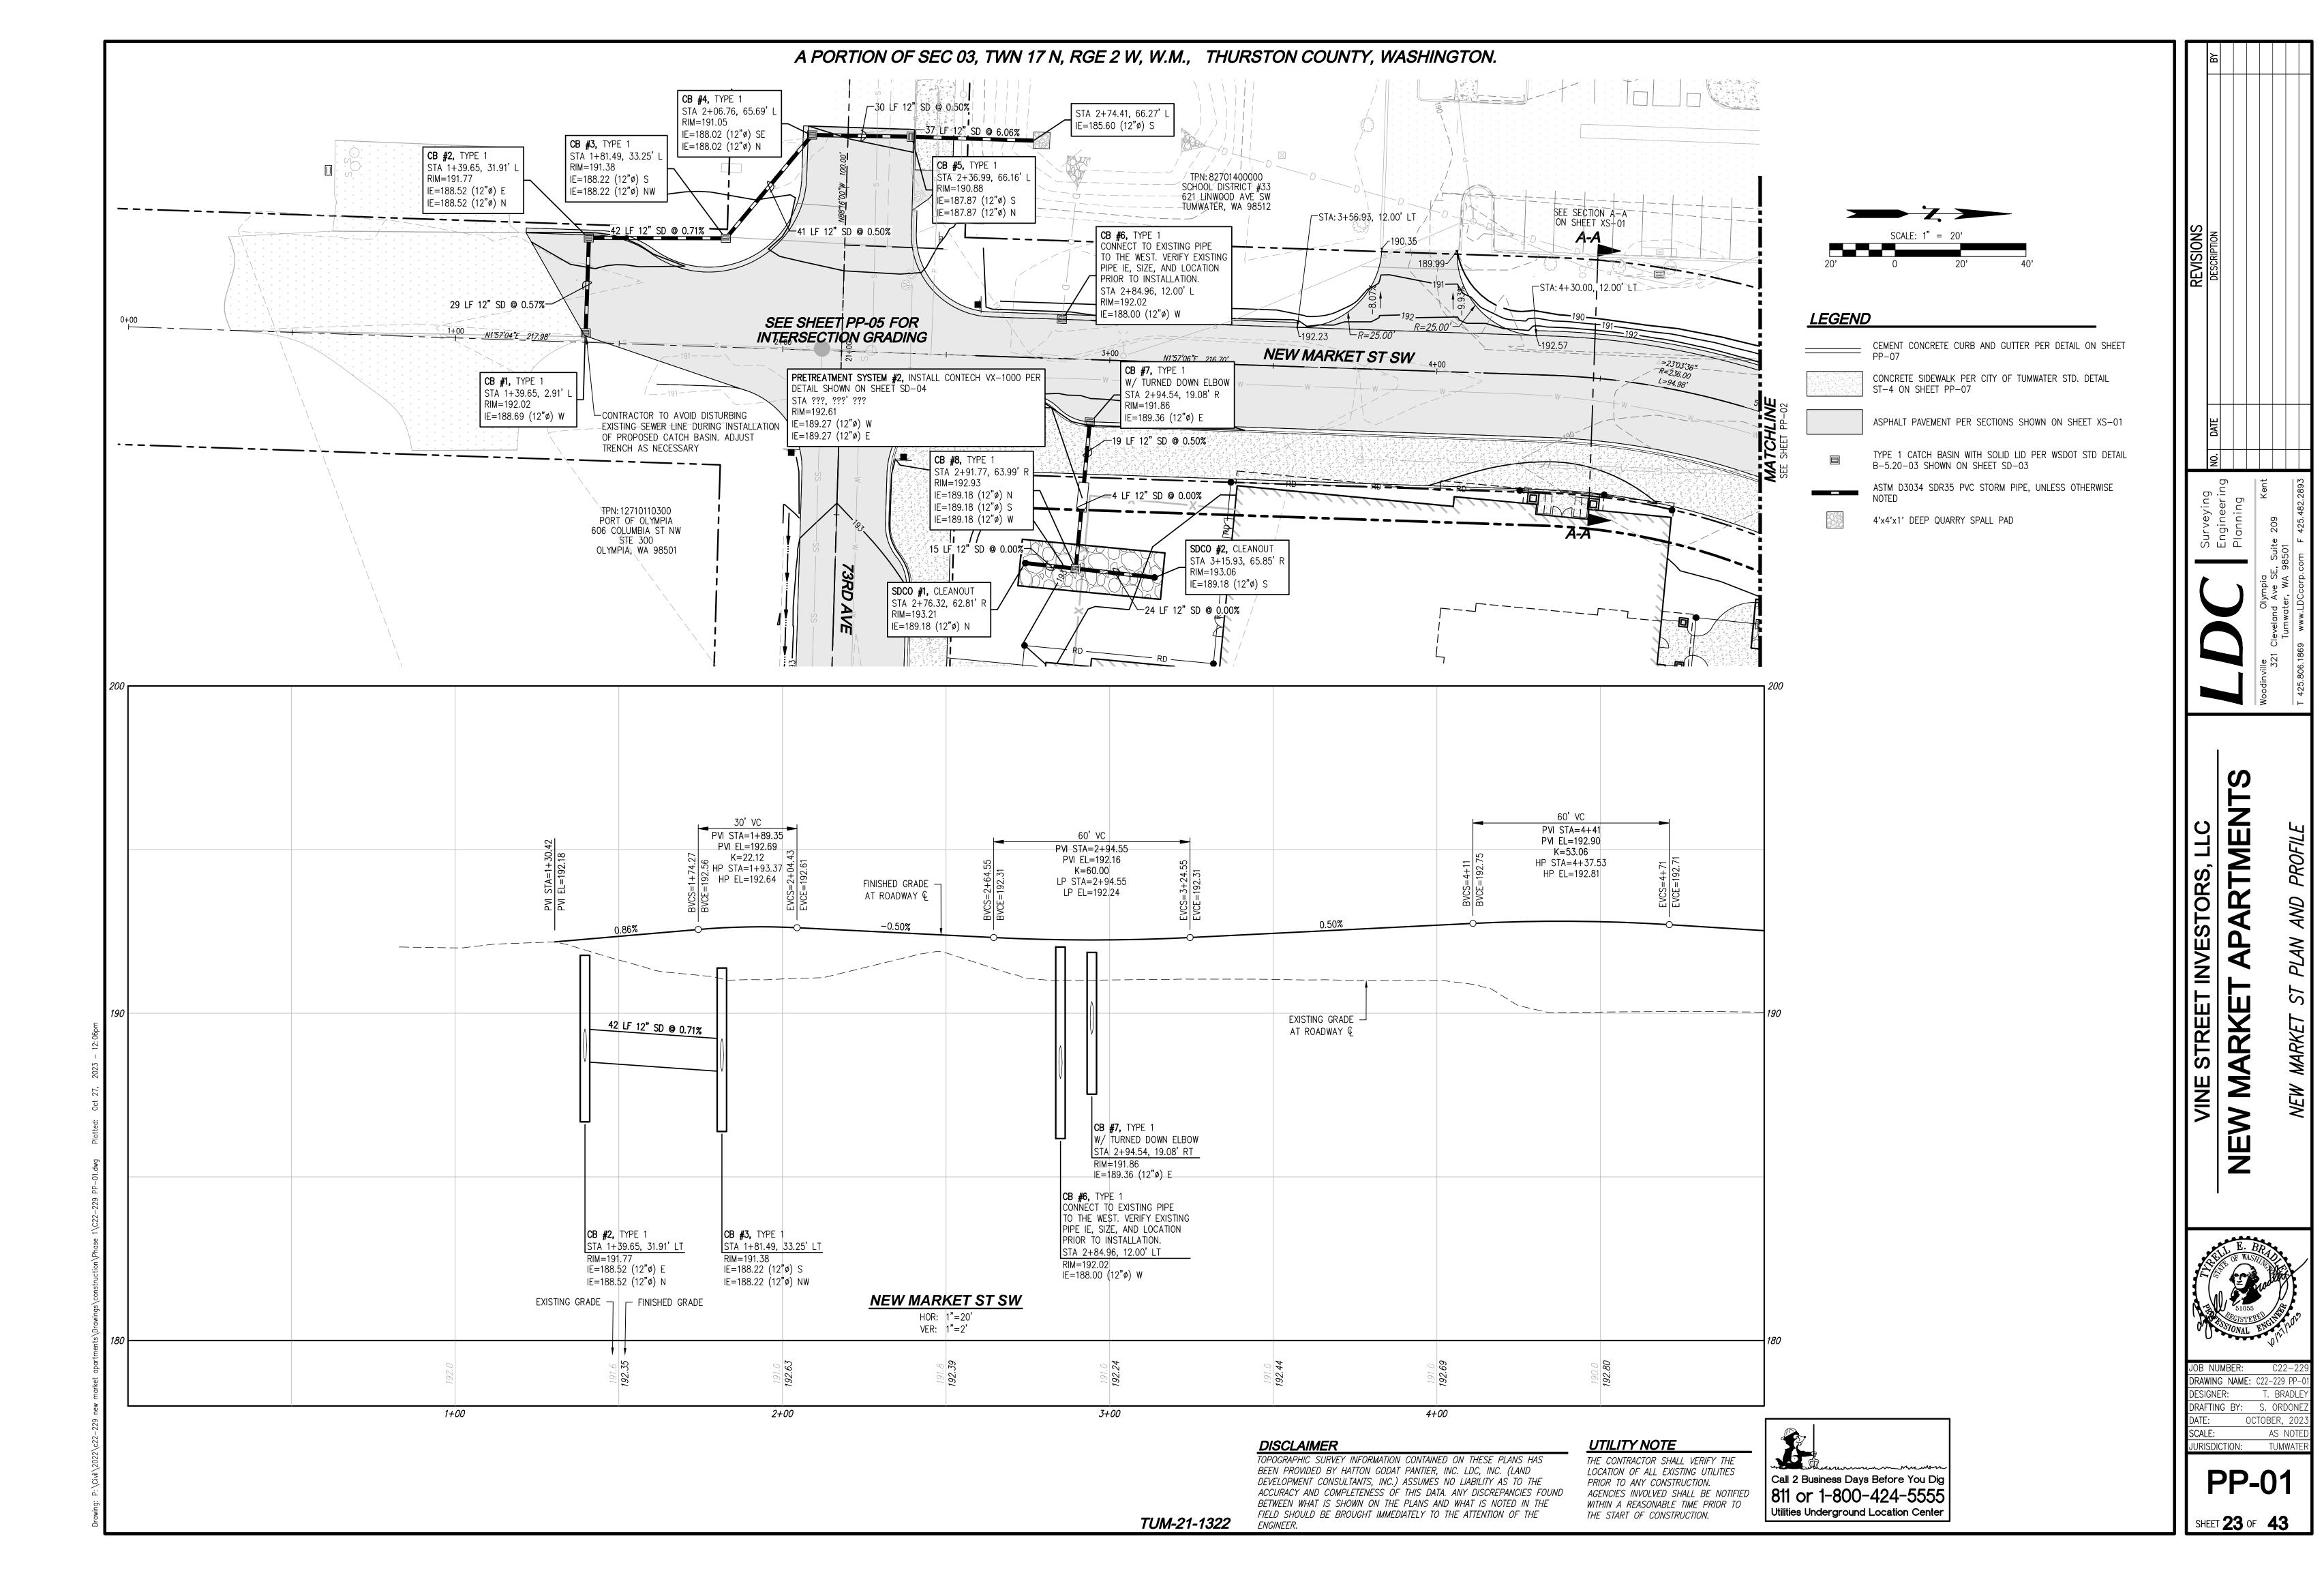

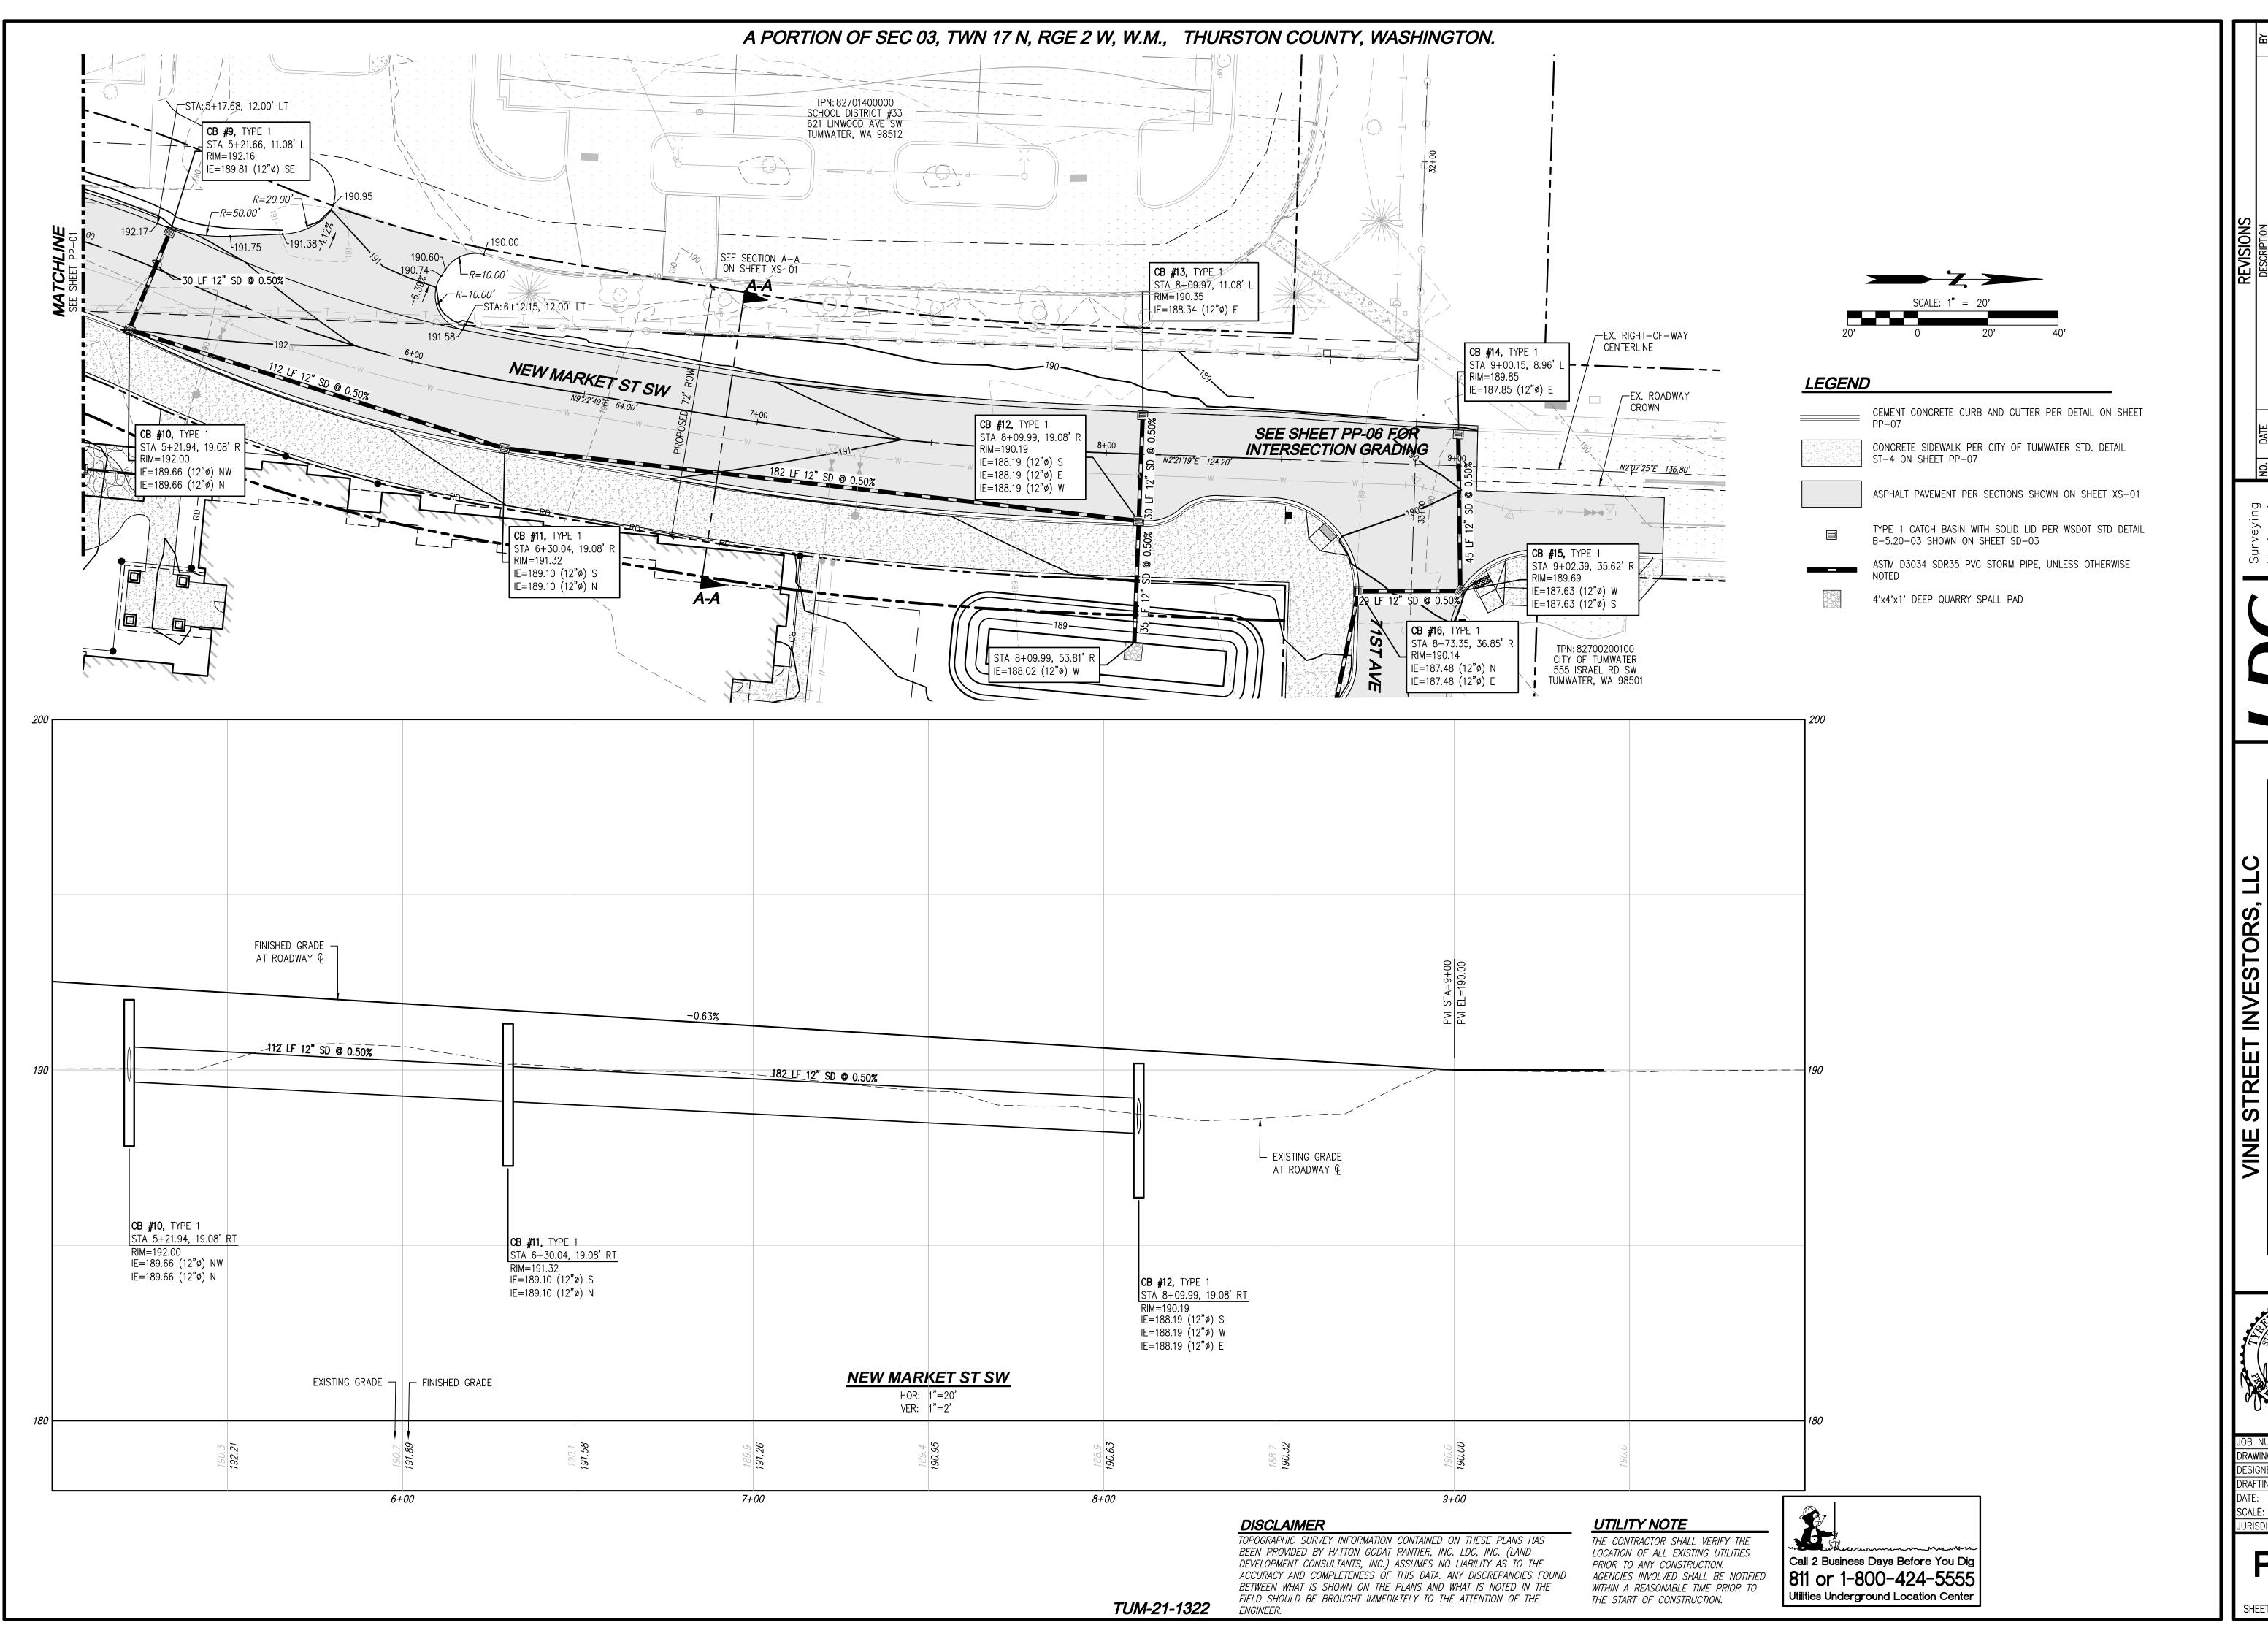

Engineerir
Planning
S21 Cleveland Ave SE, Suite 209
Tumwater, WA 98501

IENTS Woodinville

W MARKET APARTMENTS

E. BR SIONAL ENGINEERINGS

JOB NUMBER: C22-22

DRAWING NAME: C22-229 PP-C

DESIGNER: T. BRADLE

DRAFTING BY: S. ORDONE


DATE: OCTOBER, 202

SCALE: AS NOTE

JURISDICTION: TUMWATE

PP-02

SHEET **24** OF **43**

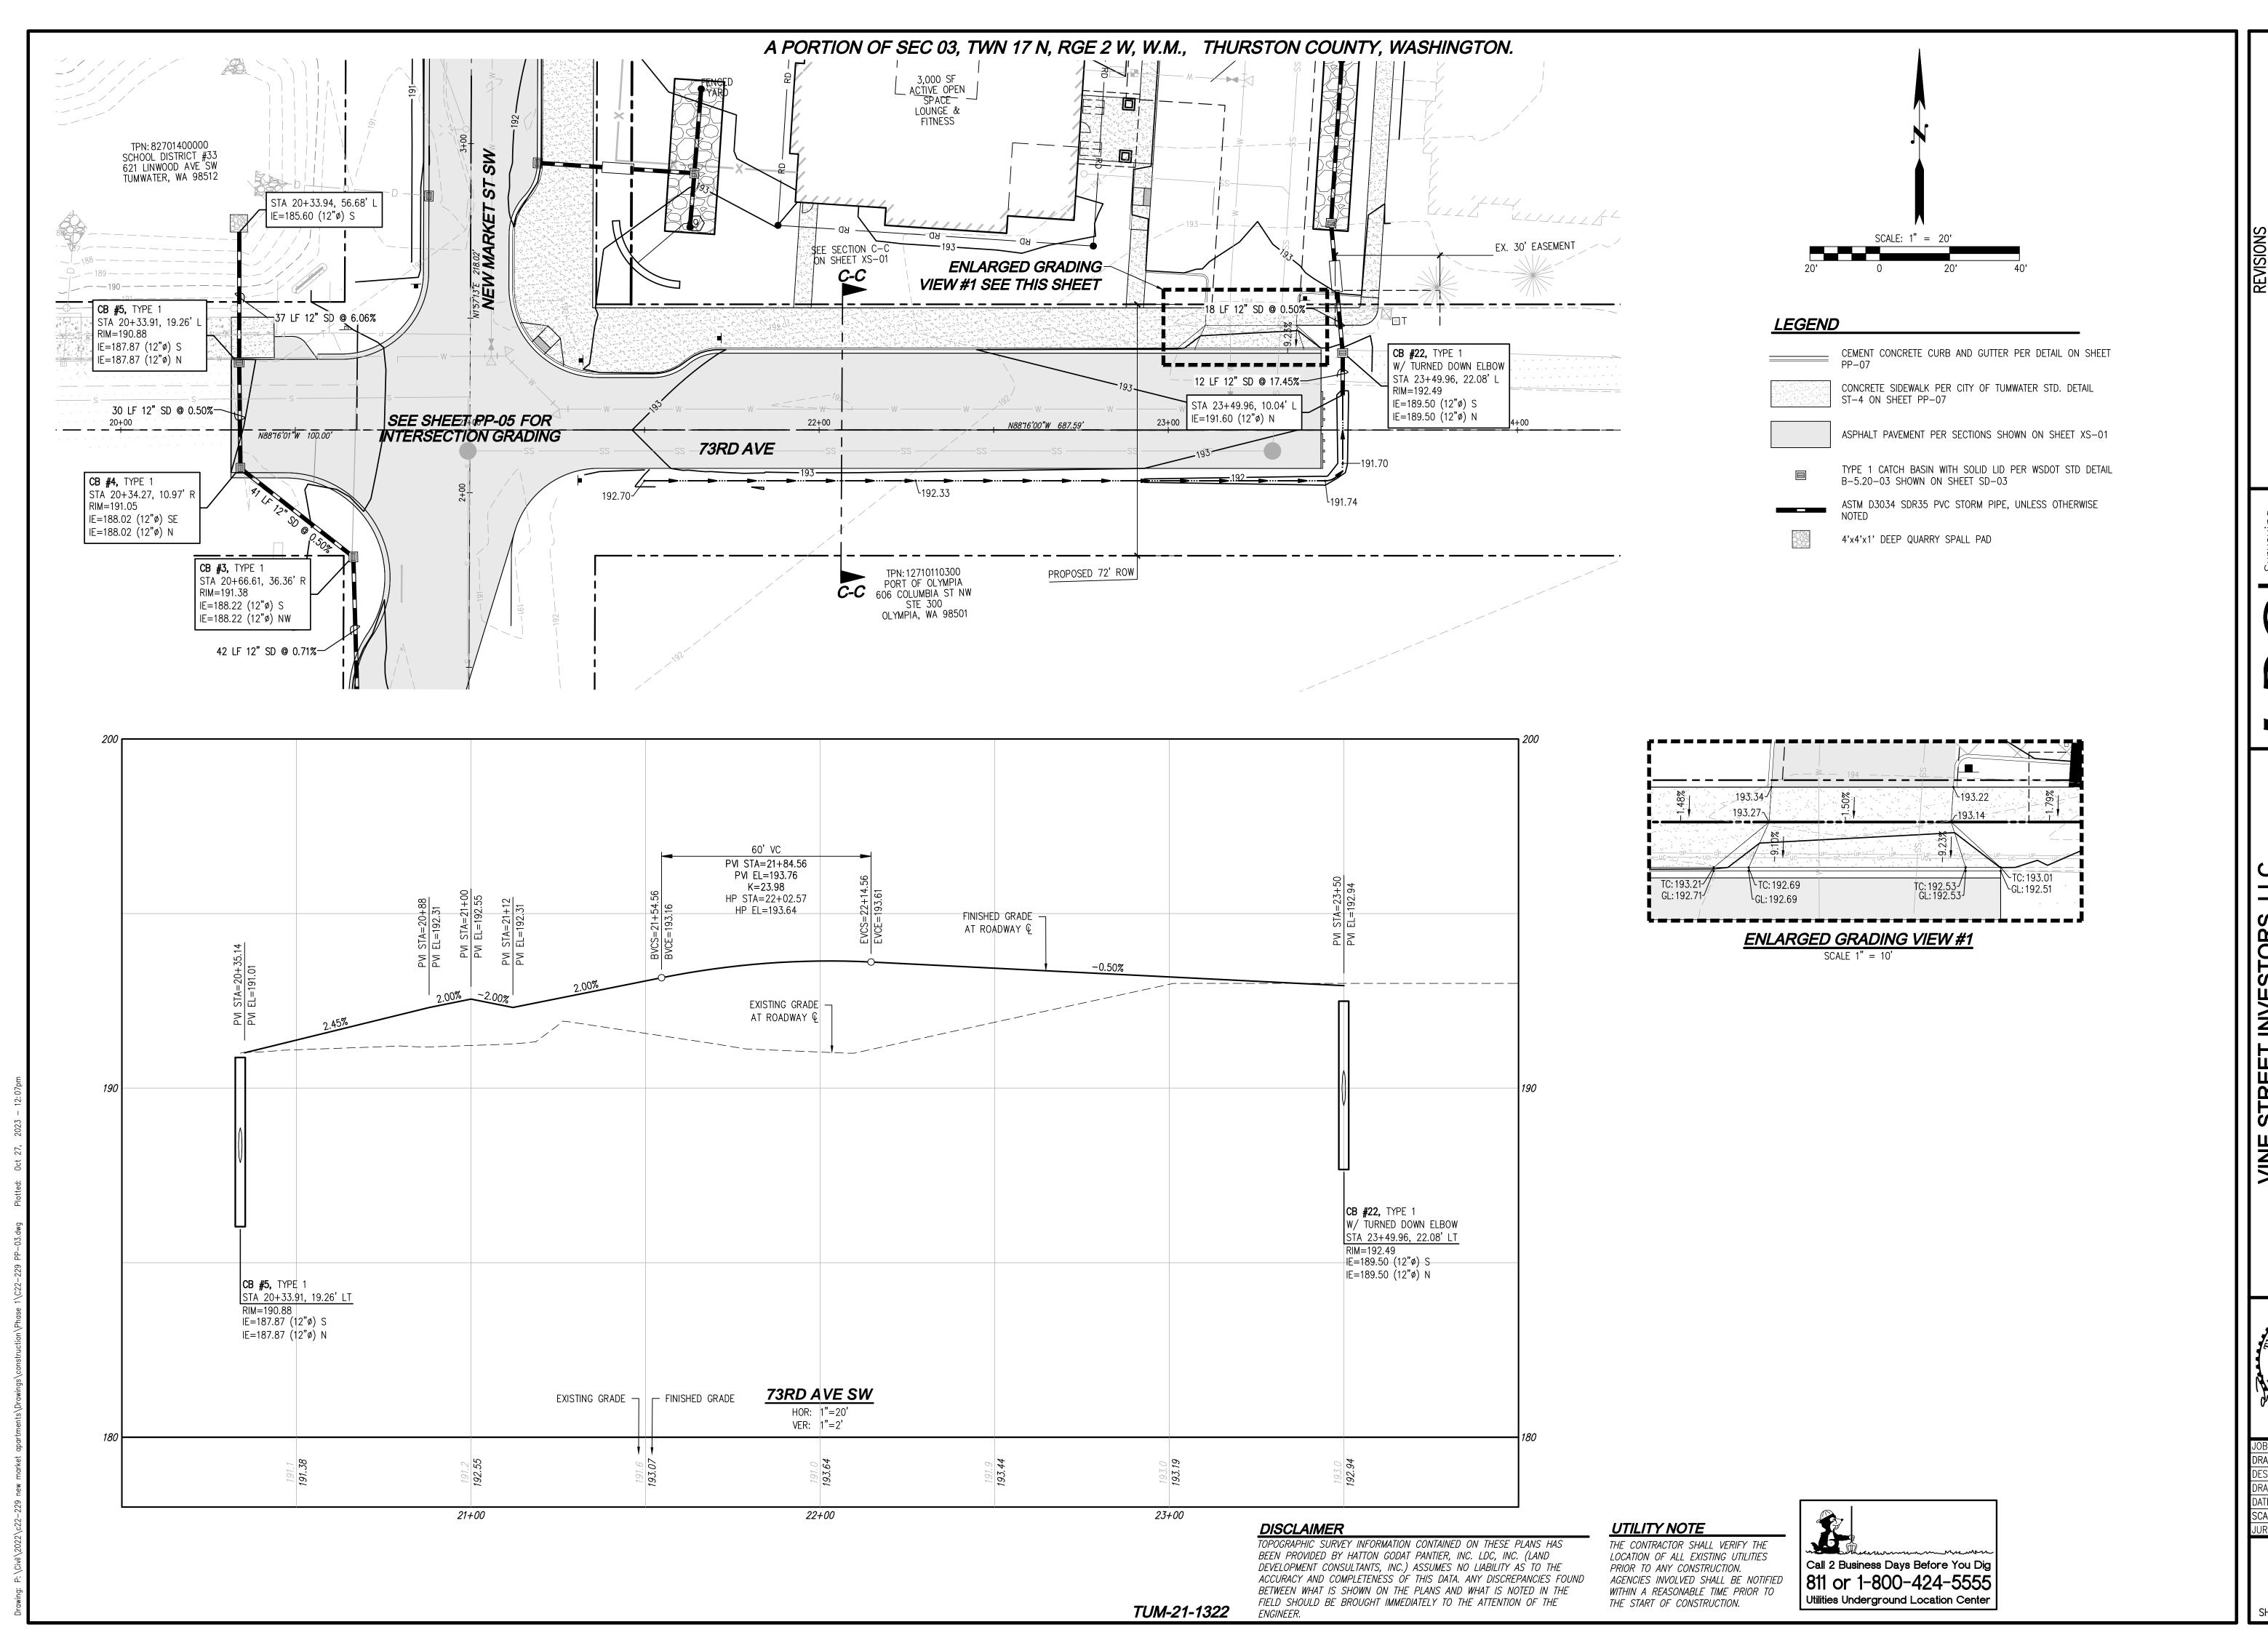

VINE STREET INVESTORS, LLC


NEW MARKET APARTMENTS

51.055
SIONAL ENGINEERINGS

	0/1
B NUMBER:	C22-229
AWING NAM	E: C22-229 PP-03
SIGNER:	T. BRADLEY
AFTING BY:	S. ORDONEZ
TE:	OCTOBER, 2023
ALE:	AS NOTED
RISDICTION:	TUMWATER

PP-03


SHEET **25** OF **43**

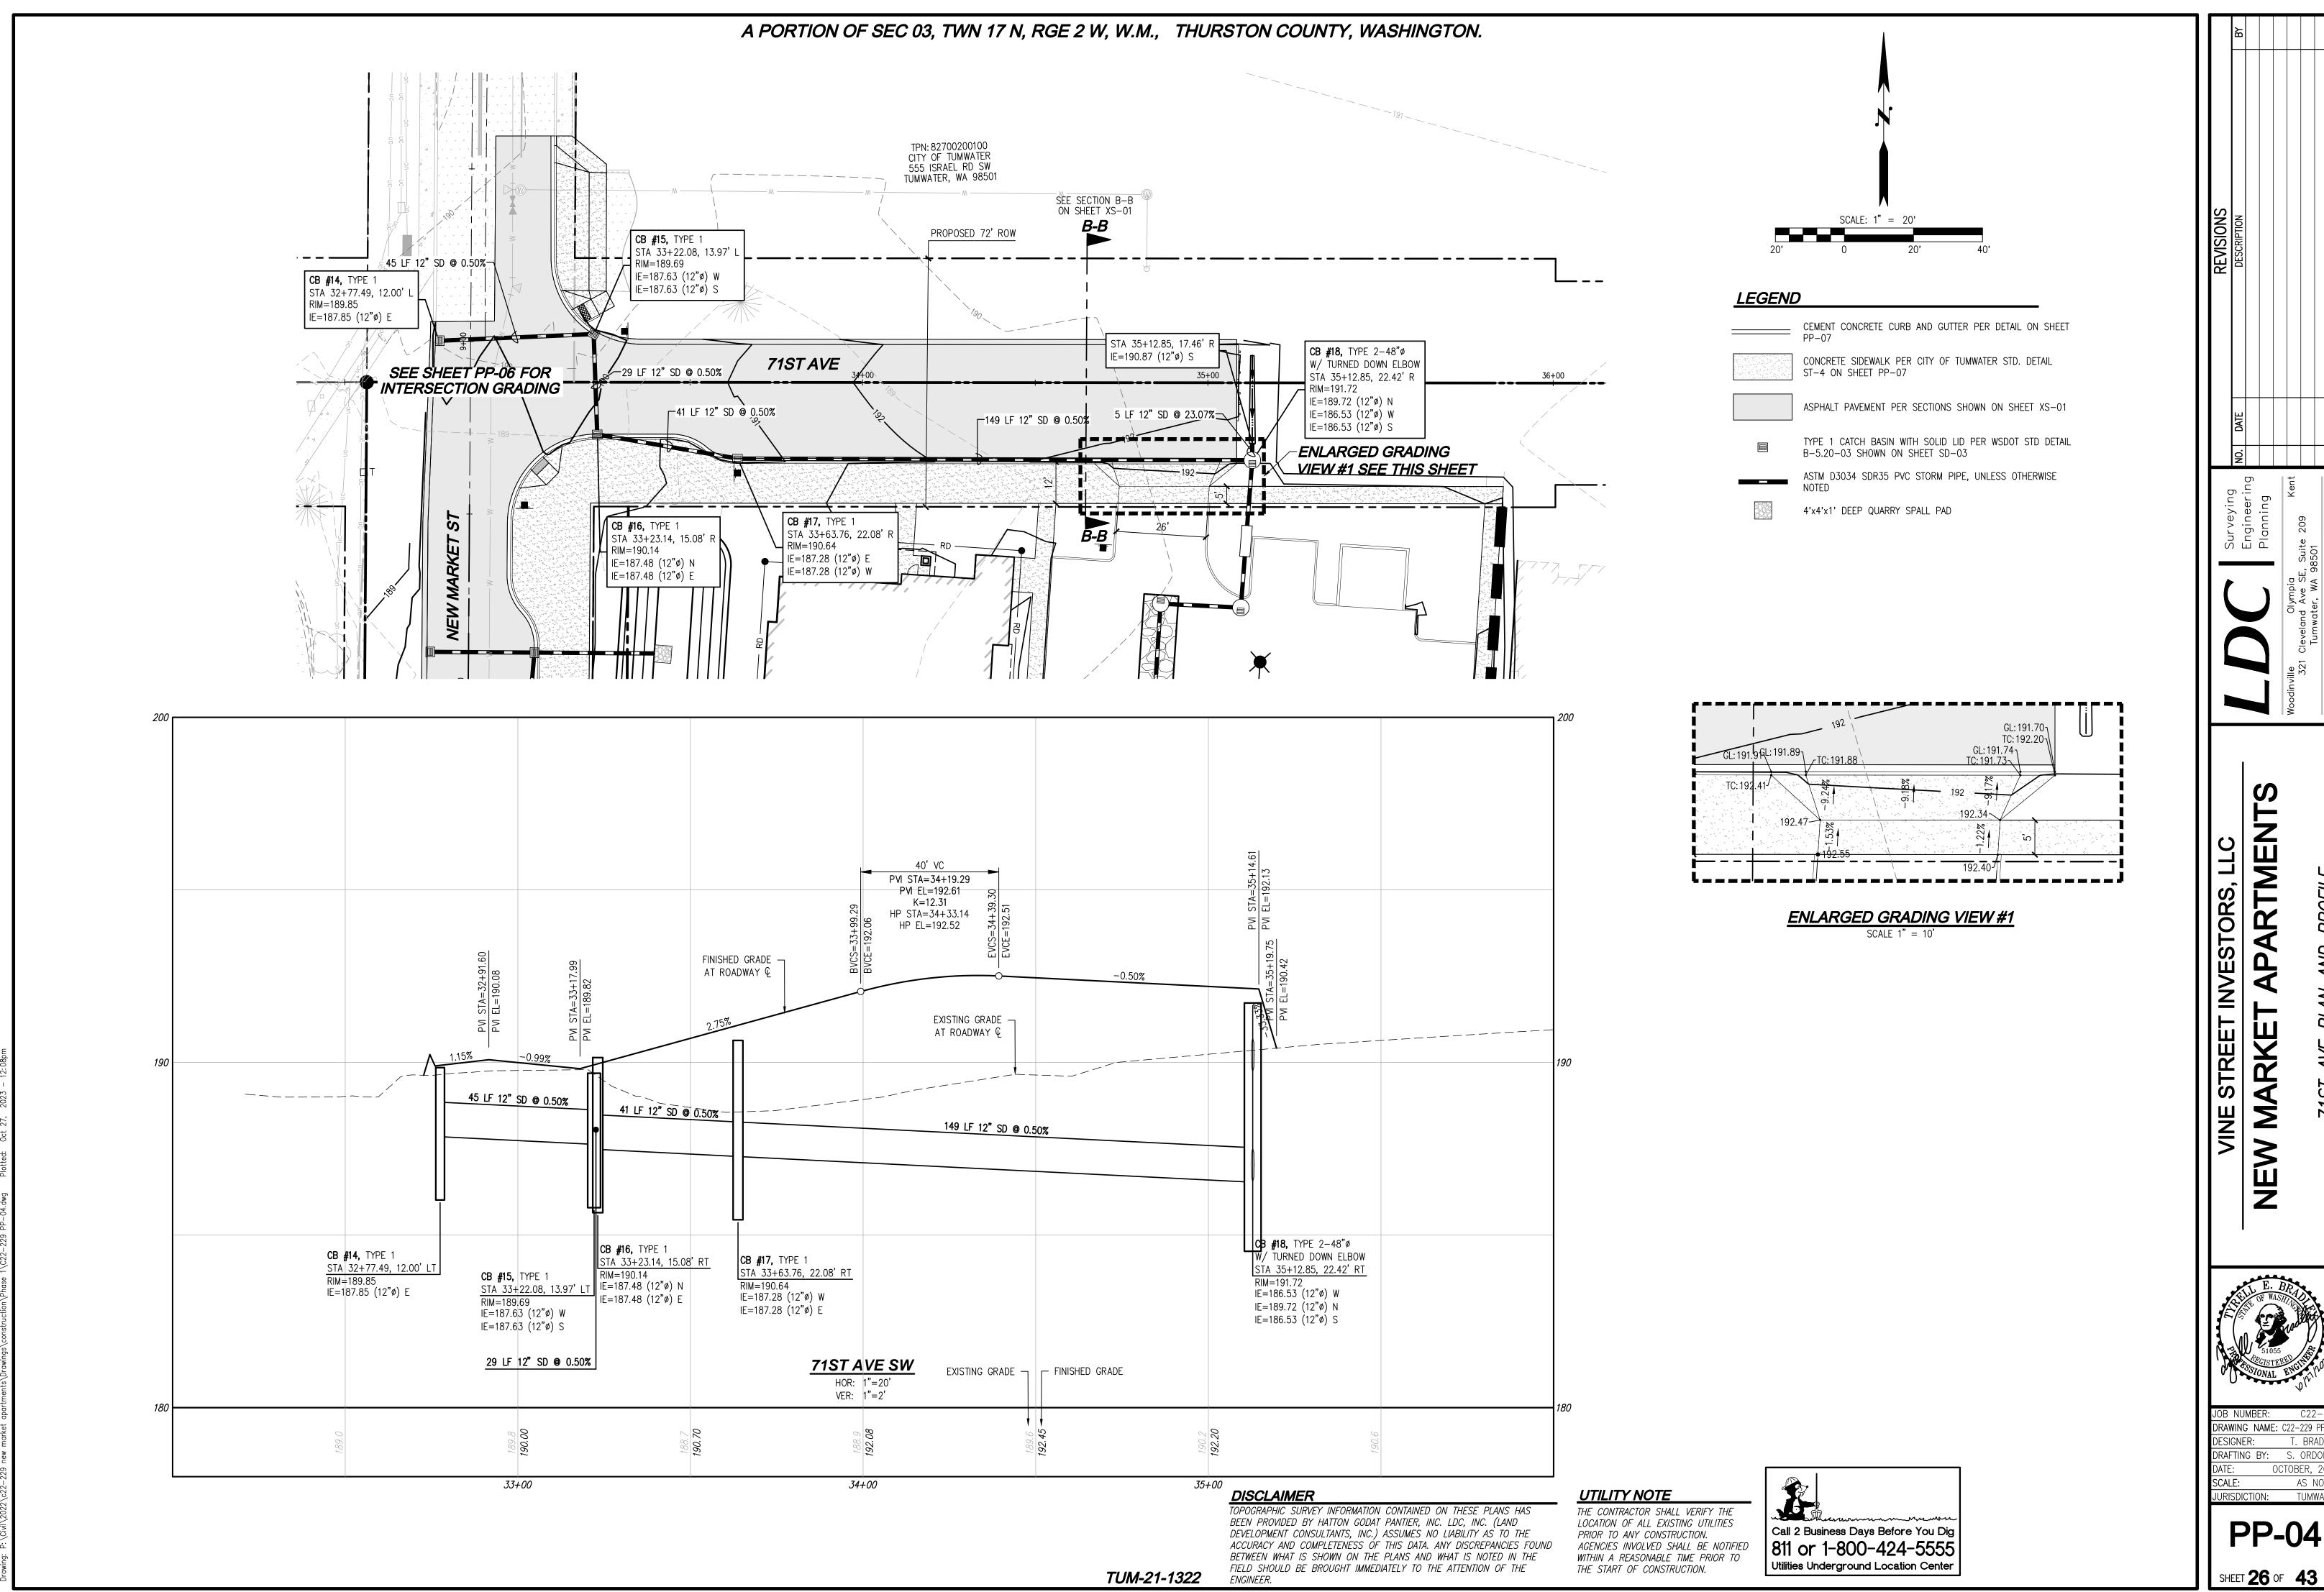

APARTMEN STREET INVESTORS,



DRAWING NAME: C22-229 PP-DESIGNER: DRAFTING BY: S. ORDON SCALE: as note J<u>URISDICTION:</u> T<u>UMWATE</u>

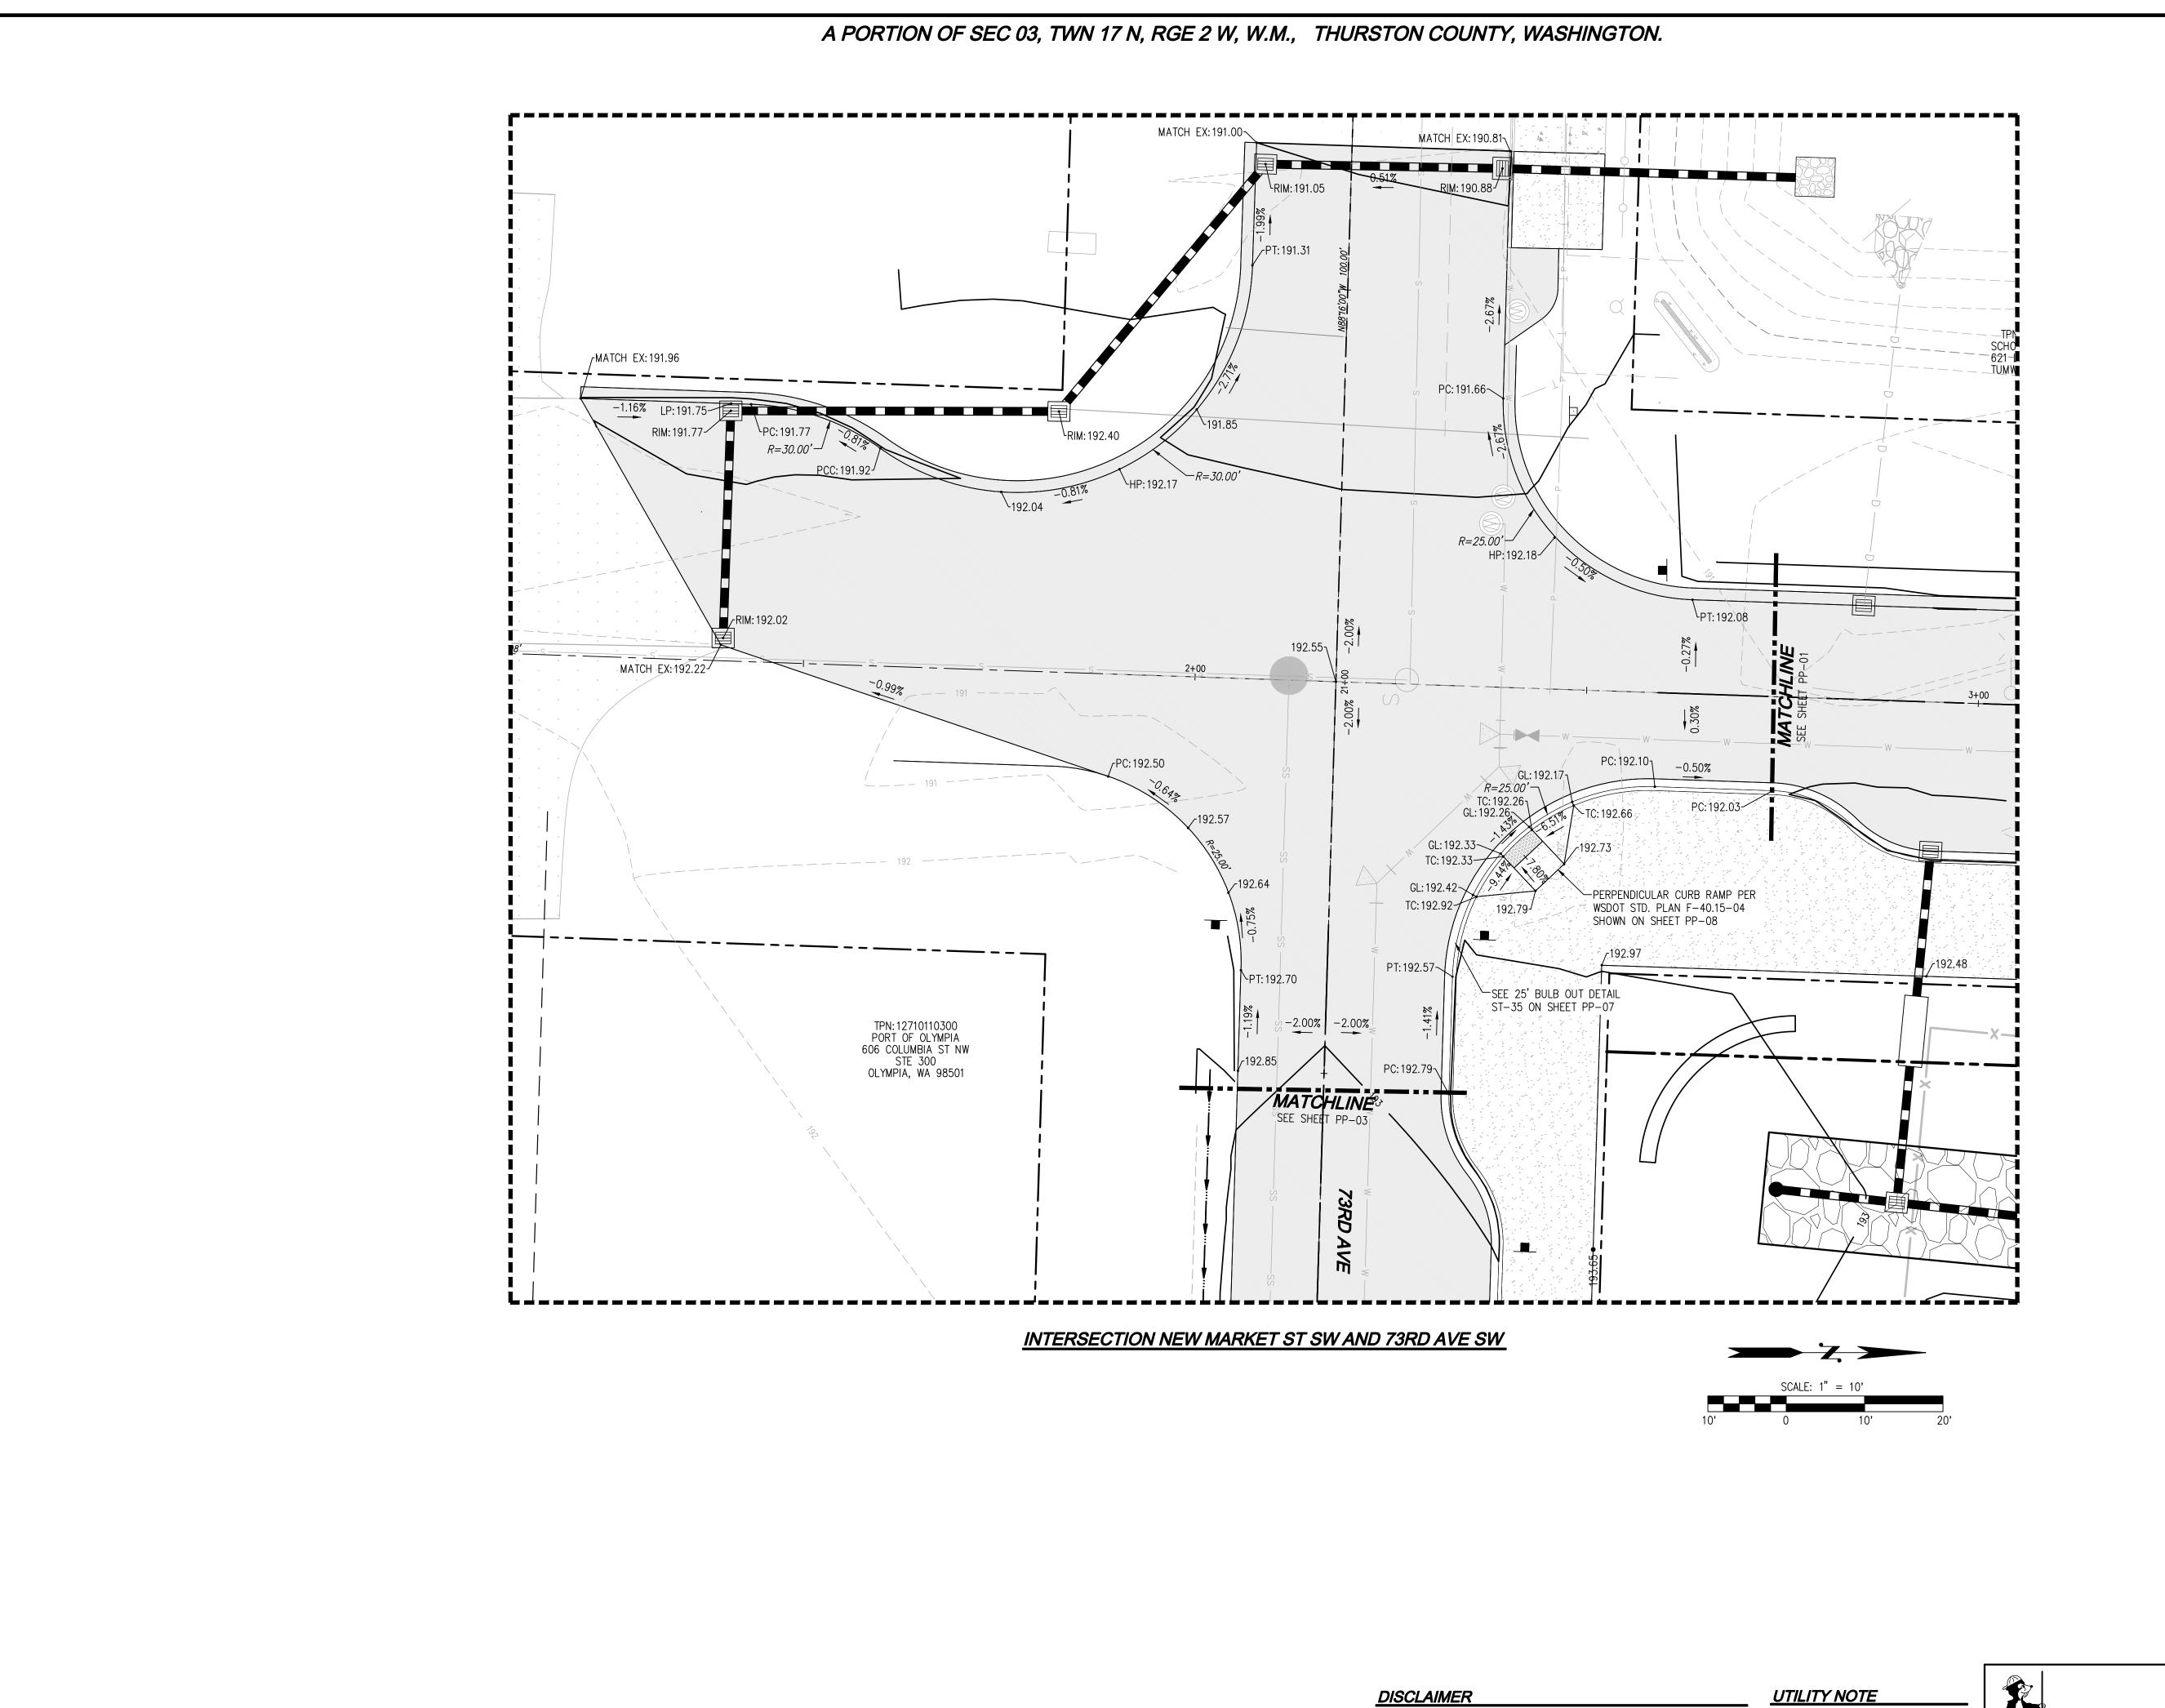

APARTMEN VINE STREET INVESTORS,

DRAWING NAME: C22-229 PP-DESIGNER: DRAFTING BY: S. ORDONE
DATE: OCTOBER, 202 SCALE: JURISDICTION: TUMWATER

PP-05

SHEET **27** OF **43**

TOPOGRAPHIC SURVEY INFORMATION CONTAINED ON THESE PLANS HAS BEEN PROVIDED BY HATTON GODAT PANTIER, INC. LDC, INC. (LAND DEVELOPMENT CONSULTANTS, INC.) ASSUMES NO LIABILITY AS TO THE ACCURACY AND COMPLETENESS OF THIS DATA. ANY DISCREPANCIES FOUND BETWEEN WHAT IS SHOWN ON THE PLANS AND WHAT IS NOTED IN THE FIELD SHOULD BE BROUGHT IMMEDIATELY TO THE ATTENTION OF THE ENGINEER.

THE CONTRACTOR SHALL VERIFY THE LOCATION OF ALL EXISTING UTILITIES PRIOR TO ANY CONSTRUCTION.
AGENCIES INVOLVED SHALL BE NOTIFIED WITHIN A REASONABLE TIME PRIOR TO THE START OF CONSTRUCTION.

Call 2 Business Days Before You Dig
811 or 1-800-424-5555
Utilities Underground Location Center

<u>DISCLAIMER</u>

TOPOGRAPHIC SURVEY INFORMATION CONTAINED ON THESE PLANS HAS BEEN PROVIDED BY HATTON GODAT PANTIER, INC. LDC, INC. (LAND DEVELOPMENT CONSULTANTS, INC.) ASSUMES NO LIABILITY AS TO THE ACCURACY AND COMPLETENESS OF THIS DATA. ANY DISCREPANCIES FOUND BETWEEN WHAT IS SHOWN ON THE PLANS AND WHAT IS NOTED IN THE FIELD SHOULD BE BROUGHT IMMEDIATELY TO THE ATTENTION OF THE ENGINEER.

UTILITY NOTE

THE CONTRACTOR SHALL VE

THE CONTRACTOR SHALL VERIFY THE LOCATION OF ALL EXISTING UTILITIES PRIOR TO ANY CONSTRUCTION.
AGENCIES INVOLVED SHALL BE NOTIFIED WITHIN A REASONABLE TIME PRIOR TO THE START OF CONSTRUCTION.



NO. DATE DESCRIPTION

Woodinville Olympia 321 Cleveland Ave SE, Suite 209 Tumwater, WA 98501
T 425.806.1869 www.LDCcorp.com F 425.482.289

VINE STREET INVESTORS, LLC

W MARKET APARTMENTS

E. BR STONAL ENGINEERS

JOB NUMBER: C22-22'
DRAWING NAME: C22-229 PP-0
DESIGNER: T. BRADLE'
DRAFTING BY: S. ORDONE:
DATE: OCTOBER, 202:
SCALE: AS NOTE!
JURISDICTION: TUMWATE!


PP-06

SHEET **28** OF **43**


TUM-21-1322

CITY OF TUMWATER GENERAL NOTES STREET CONSTRUCTION

- 1. ALL WORKMANSHIP AND MATERIALS SHALL BE IN ACCORDANCE WITH CITY OF TUMWATER STANDARDS AND THE MOST CURRENT COPY OF THE WSDOT/APWA STANDARD SPECIFICATIONS FOR ROAD, BRIDGE AND MUNICIPAL CONSTRUCTION. IN CASES OF CONFLICT, THE MOST STRINGENT STANDARD SHALL APPLY.
- 2. THE CONTRACTOR SHALL BE IN COMPLIANCE WITH ALL SAFETY STANDARDS AND REQUIREMENTS AS SET FORTH BY OSHA, WISHA AND THE WASHINGTON STATE DEPARTMENT OF LABOR AND INDUSTRIES
- 3. THE CONTRACTOR SHALL BE RESPONSIBLE FOR ALL TRAFFIC CONTROL IN ACCORDANCE WITH THE WSDOT/APWA STANDARD PLANS FOR ROAD, BRIDGE AND MUNICIPAL CONSTRUCTION (ALL APPLICABLE "K"PLANS) AND/OR THE MANUAL ON UNIFORM TRAFFIC CONTROL DEVICES (MUTCD). PRIOR TO DISRUPTION OF ANY TRAFFIC, A TRAFFIC CONTROL PLAN SHALL BE PREPARED AND SUBMITTED TO THE CITY FOR APPROVAL. NO WORK SHALL COMMENCE UNTIL ALL APPROVED TRAFFIC CONTROL IS IN PLACE.
- 4. ALL APPROVALS AND PERMITS REQUIRED BY THE CITY OF TUMWATER SHALL BE OBTAINED BY THE CONTRACTOR PRIOR TO THE START OF CONSTRUCTION.
- 5. IF CONSTRUCTION IS TO TAKE PLACE IN OTHER JURISDICTION'S RIGHT-OF-WAY (I.E., THE COUNTY, THE STATE, THE CITY OF OLYMPIA, OR OTHER ADJACENT MUNICIPALITIES), THE CONTRACTOR SHALL NOTIFY THE JURISDICTION AND OBTAIN ALL THE REQUIRED APPROVALS AND PERMITS.
- 6. A PRE-CONSTRUCTION MEETING SHALL BE HELD WITH THE CITY OF TUMWATER CONSTRUCTION INSPECTOR A MINIMUM 72 HOURS PRIOR TO THE START OF CONSTRUCTION.
- 7. HE CONTRACTOR SHALL BE FULLY RESPONSIBLE FOR THE LOCATION AND PROTECTION OF ALL EXISTING UTILITIES. THE CONTRACTOR SHALL VERIFY ALL UTILITY LOCATIONS PRIOR TO CONSTRUCTION BY CALLING THE UNDERGROUND LOCATE LINE AT 1-800-424-5555 OR 811 A MINIMUM OF 48 HOURS PRIOR TO ANY EXCAVATION.
- 8. IT SHALL BE THE RESPONSIBILITY OF THE CONTRACTOR TO HAVE A COPY OF AN APPROVED SET OF PLANS ON THE CONSTRUCTION SITE AT ALL TIMES.
- 9. ALL SURVEYING AND STAKING SHALL BE PERFORMED BY AN ENGINEERING FIRM OR SURVEYING FIRM CAPABLE OF PERFORMING SUCH WORK. THE SURVEYOR DIRECTING SUCH WORK SHALL BE LICENSED AS A PROFESSIONAL LAND SURVEYOR BY THE STATE OF WASHINGTON.
- 10. TEMPORARY EROSION CONTROL/WATER POLLUTION PREVENTION MEASURES SHALL BE REQUIRED. AT NO TIME WILL SILTS AND DEBRIS BE ALLOWED TO DRAIN INTO AN EXISTING OR NEWLY INSTALLED FACILITY.
- 11. COMPACTION OF SUBGRADE, ROCK, AND ASPHALT SHALL MEET WSDOT/APWA STANDARDS
- 12. FORM AND SUBGRADE INSPECTION BY THE CITY IS REQUIRED BEFORE POURING CONCRETE. TWENTY-FOUR HOURS NOTICE IS REQUIRED FOR FORM INSPECTION.
- 13. THE CONTRACTOR/DEVELOPER IS RESPONSIBLE FOR FURNISHING AND INSTALLING PUBLIC AND PRIVATE STREET NAME SIGNS, AND REGULATORY SIGNS AT THE CONTRACTOR'S /DEVELOPER'S EXPENSE.

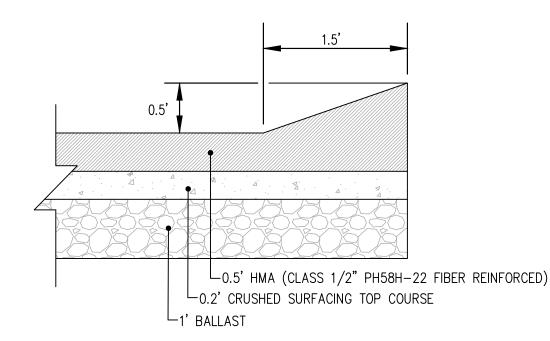

<u>ASPHALT - THICKENED EDGE</u>

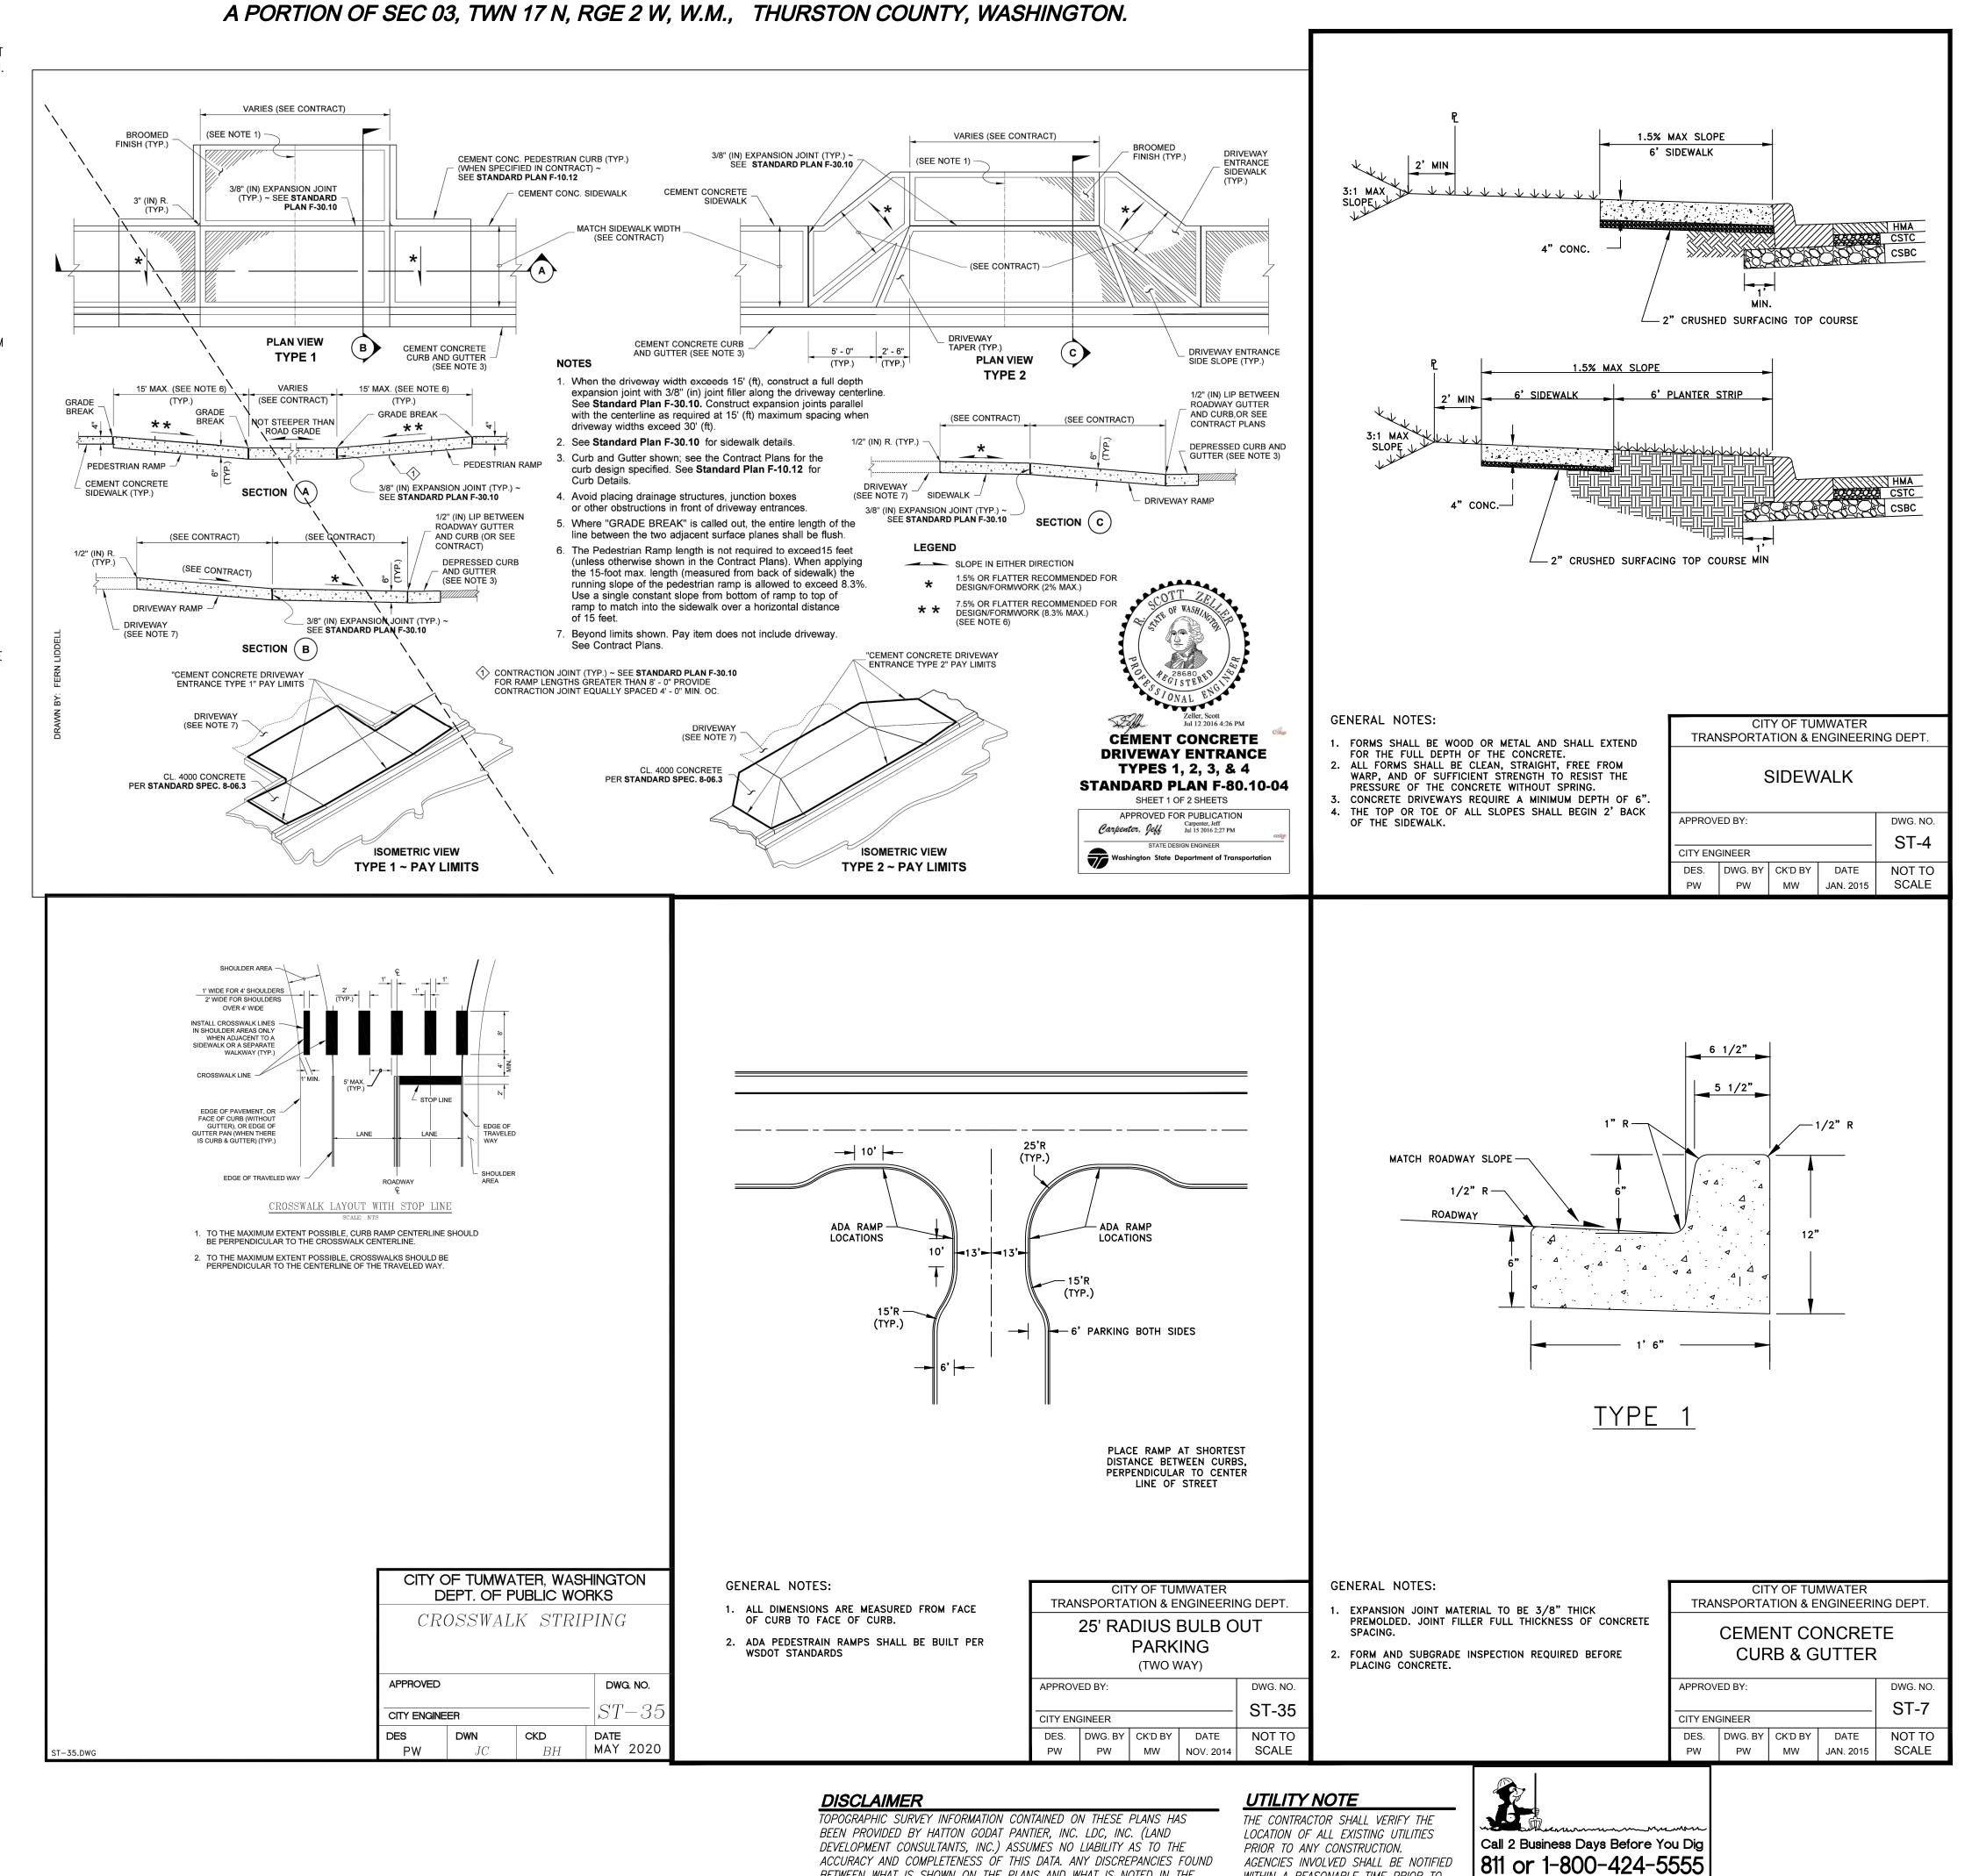

BETWEEN WHAT IS SHOWN ON THE PLANS AND WHAT IS NOTED IN THE

FIELD SHOULD BE BROUGHT IMMEDIATELY TO THE ATTENTION OF THE

TUM-21-1322

WITHIN A REASONABLE TIME PRIOR TO

THE START OF CONSTRUCTION.

Utilities Underground Location Center

ARKE JOB NUMBER:

ARTME

DRAWING NAME: C22-229 PP

S. ORDON OCTOBER,


AS NOTE

TUMWATE

DESIGNER:

DRAFTING BY:

JURISDICTION:

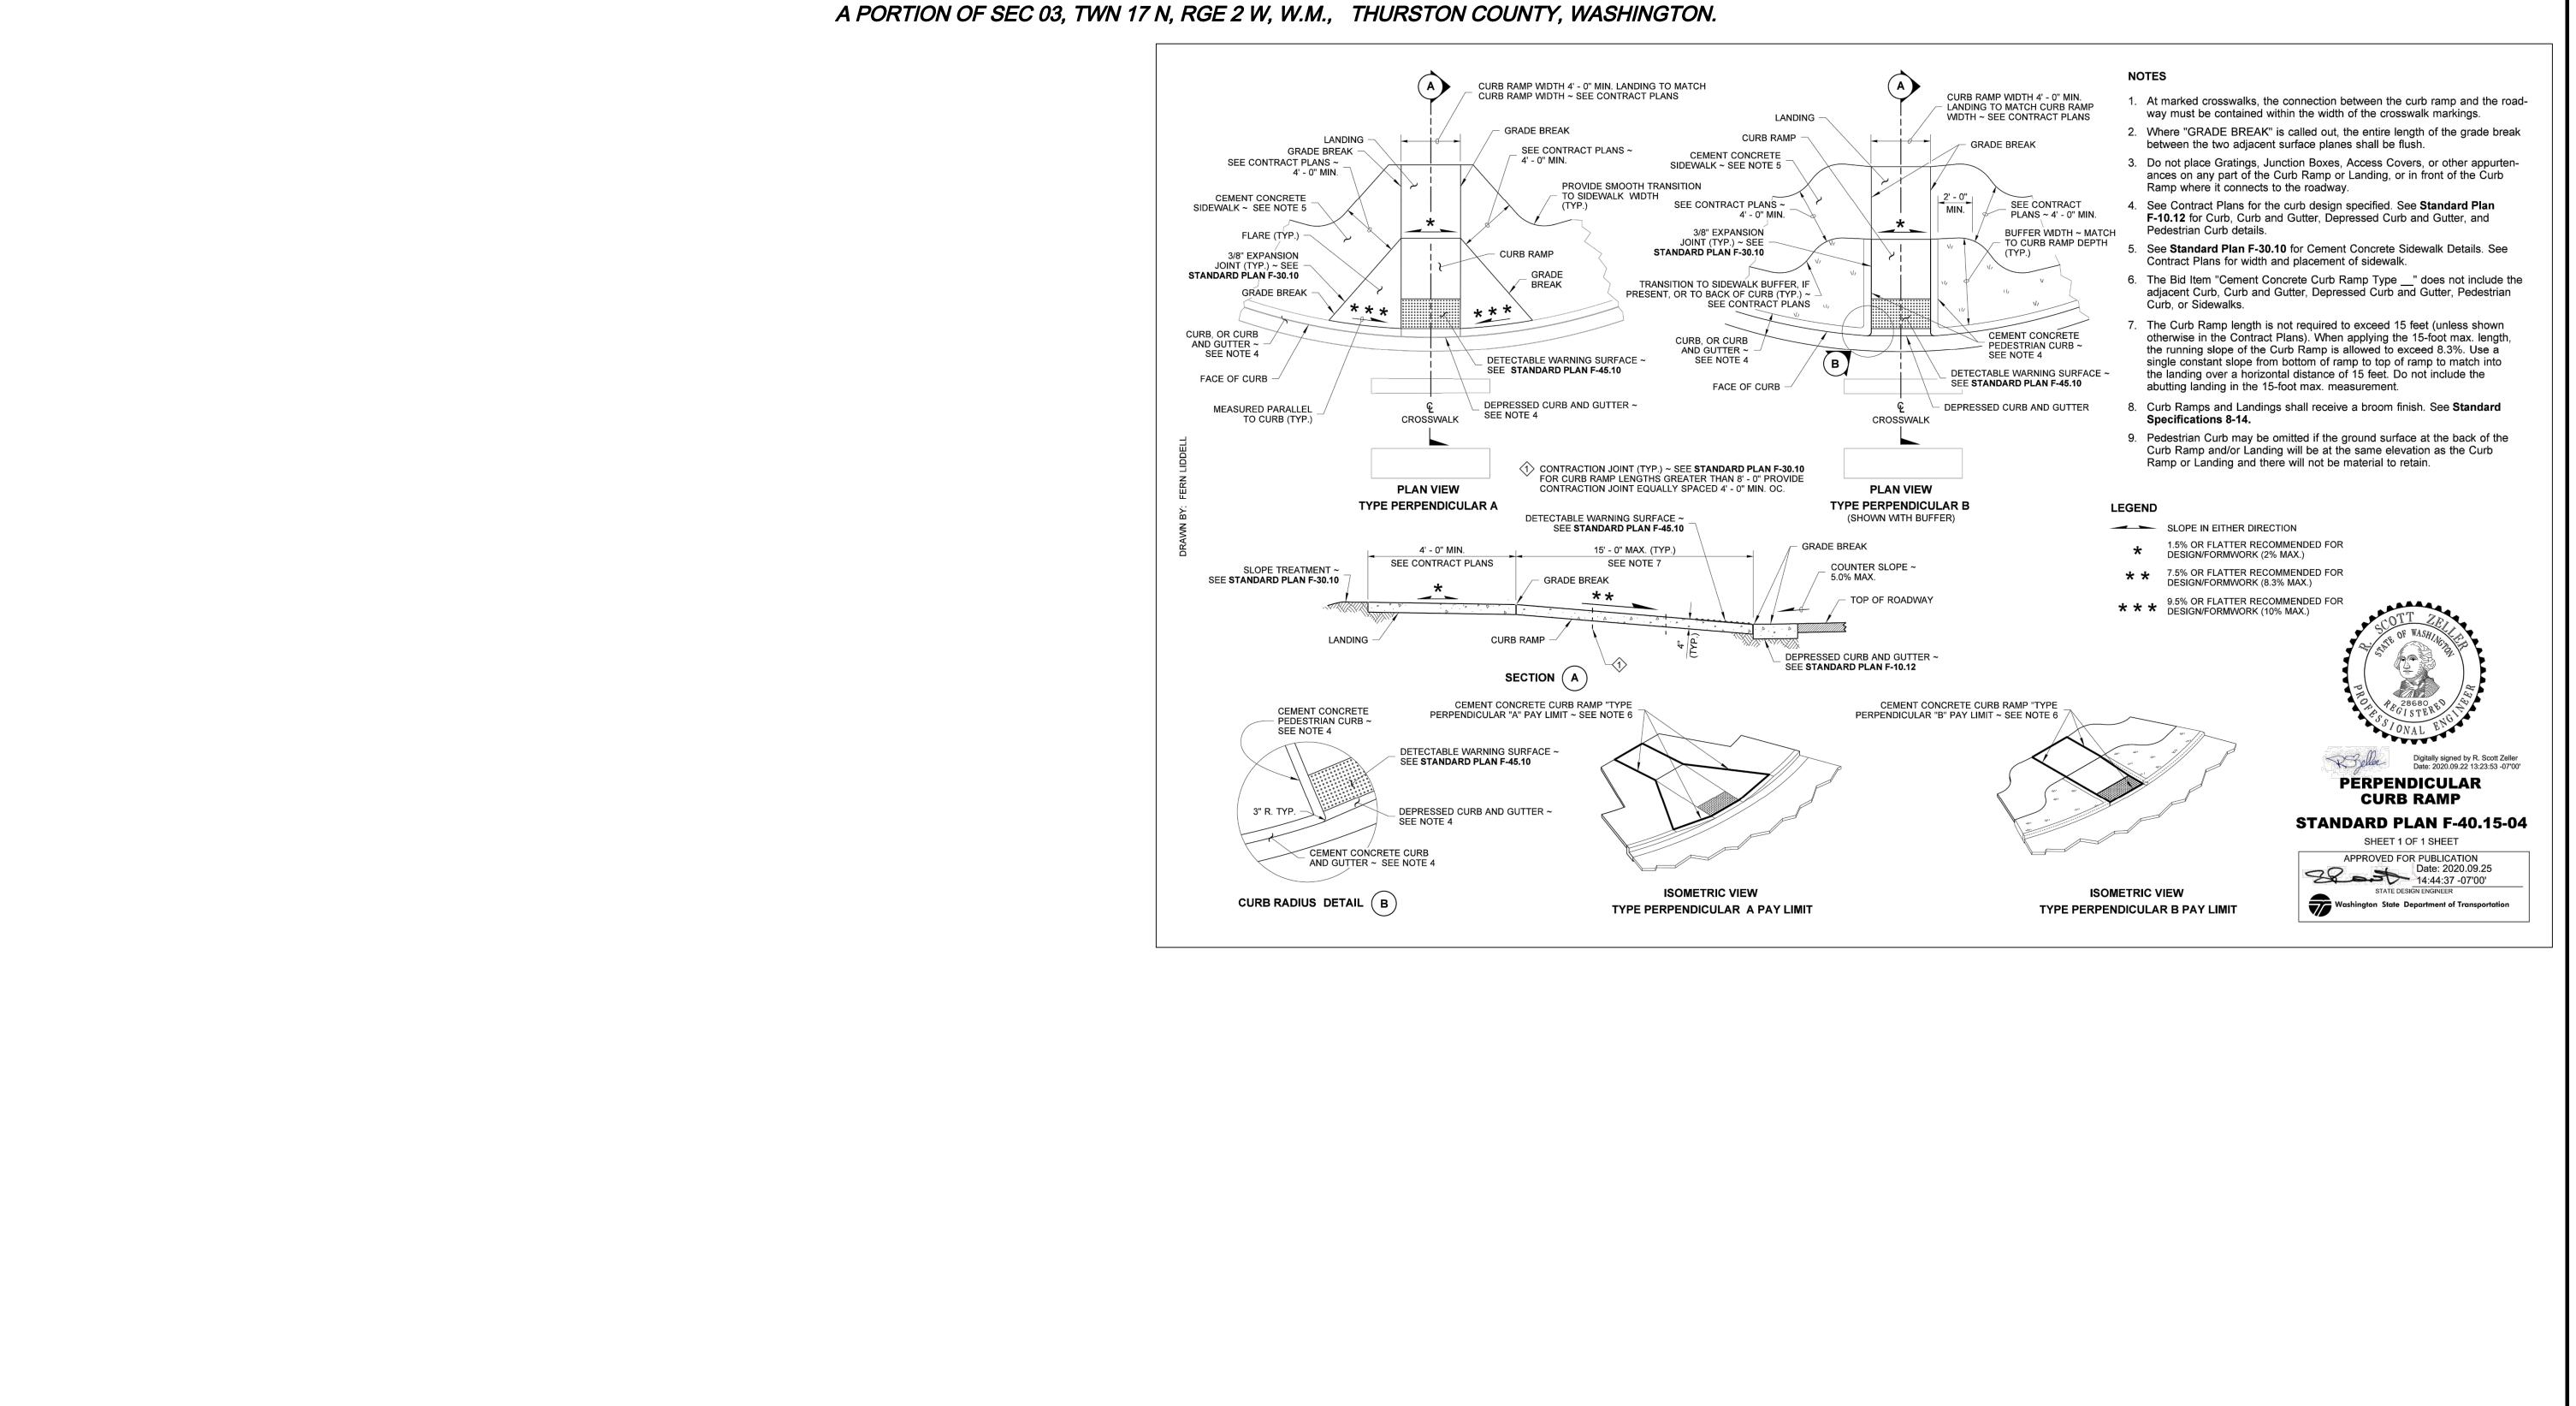

DISCLAIMER

TUM-21-1322

TOPOGRAPHIC SURVEY INFORMATION CONTAINED ON THESE PLANS HAS BEEN PROVIDED BY HATTON GODAT PANTIER, INC. LDC, INC. (LAND DEVELOPMENT CONSULTANTS, INC.) ASSUMES NO LIABILITY AS TO THE ACCURACY AND COMPLETENESS OF THIS DATA. ANY DISCREPANCIES FOUND BETWEEN WHAT IS SHOWN ON THE PLANS AND WHAT IS NOTED IN THE FIELD SHOULD BE BROUGHT IMMEDIATELY TO THE ATTENTION OF THE ENGINEER.

UTILITY NOTE

THE CONTRACTOR SHALL VERIFY THE LOCATION OF ALL EXISTING UTILITIES PRIOR TO ANY CONSTRUCTION.

AGENCIES INVOLVED SHALL BE NOTIFIED WITHIN A REASONABLE TIME PRIOR TO THE START OF CONSTRUCTION.

Call 81:

Utili



Call 2 Business Days Before You Dig
811 or 1-800-424-5555
Utilities Underground Location Center

REVISIONS
DATE
DATE
DESCRIPTION
BY

ia Kent Set Suite 209
A 98501
P.com F 425.482.2893

Woodinville Olympia 321 Cleveland Ave SE, Suite 209 Tumwater, WA 98501 T 425.806.1869 www.LDCcorp.com F 425.4

VINE STREET INVESTORS, LLC


W MARKET APARTMENTS


E. BR SIONAL ENGINEERING TO THE STREET OF T

JOB NUMBER: C22-229 PP-07
DESIGNER: T. BRADLEY
DRAFTING BY: S. ORDONEZ
DATE: OCTOBER, 2023
SCALE: AS NOTED
JURISDICTION: TUMWATER

PP-08

SHEET **30** OF **43**

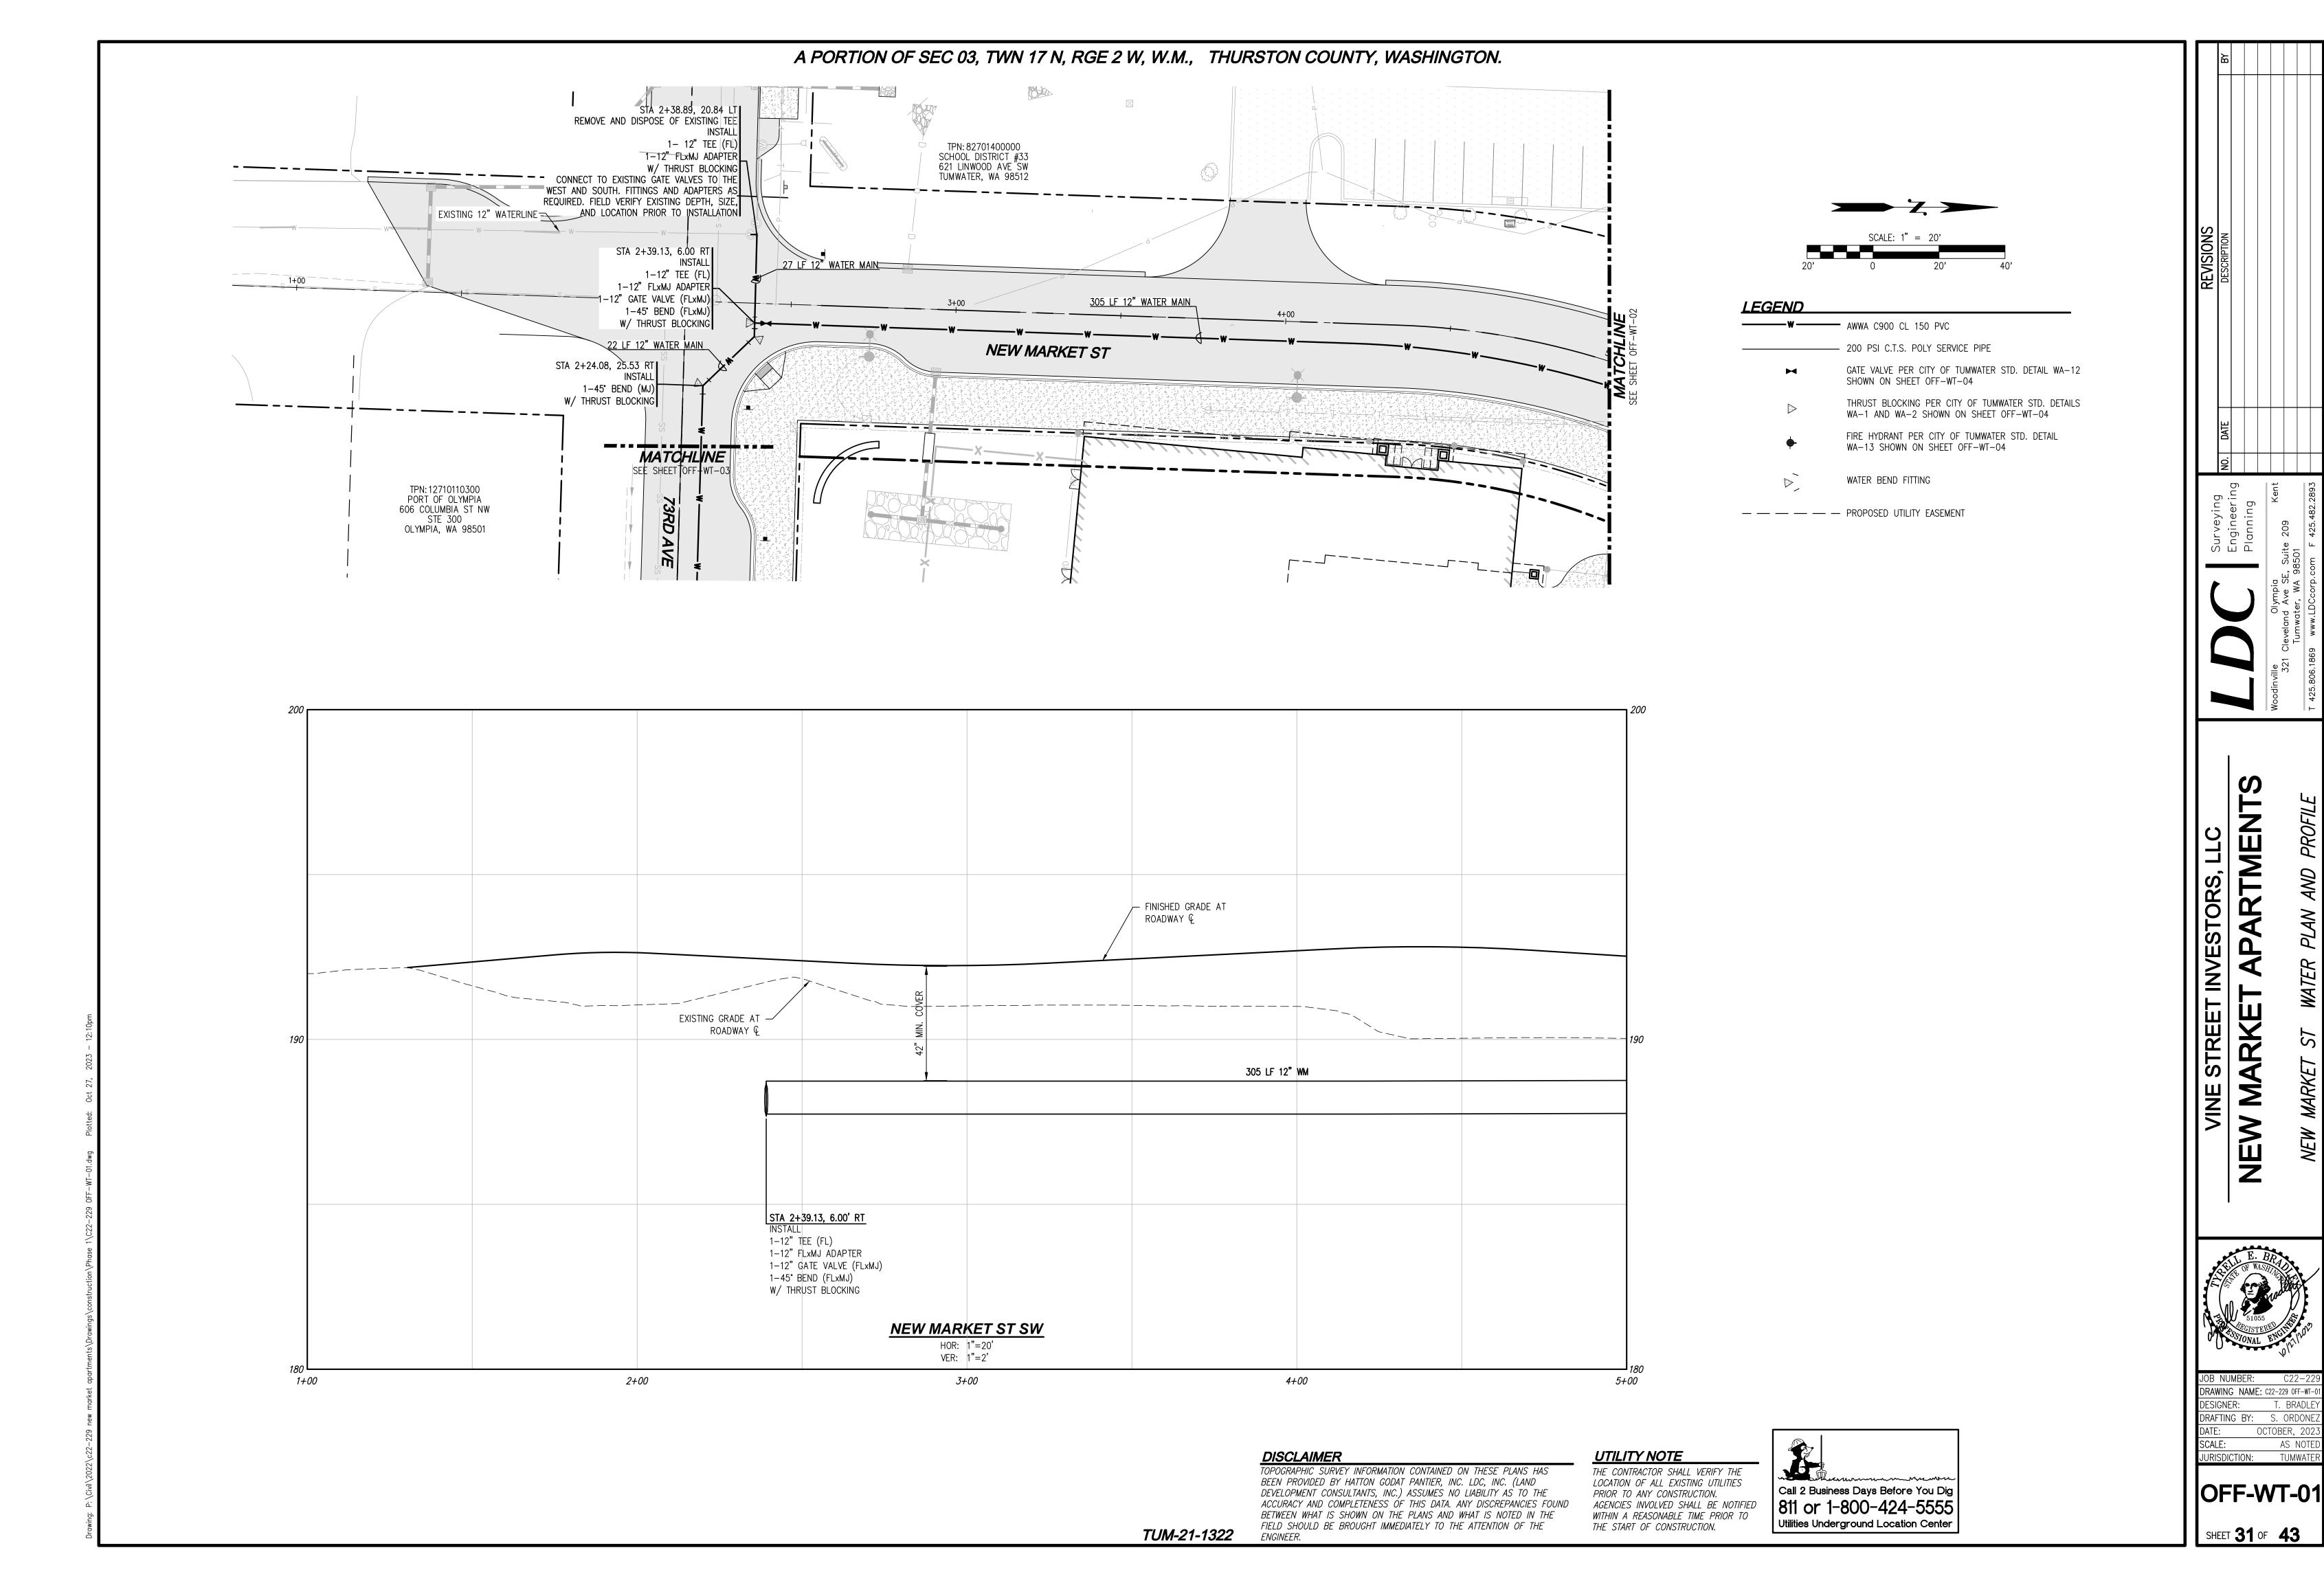

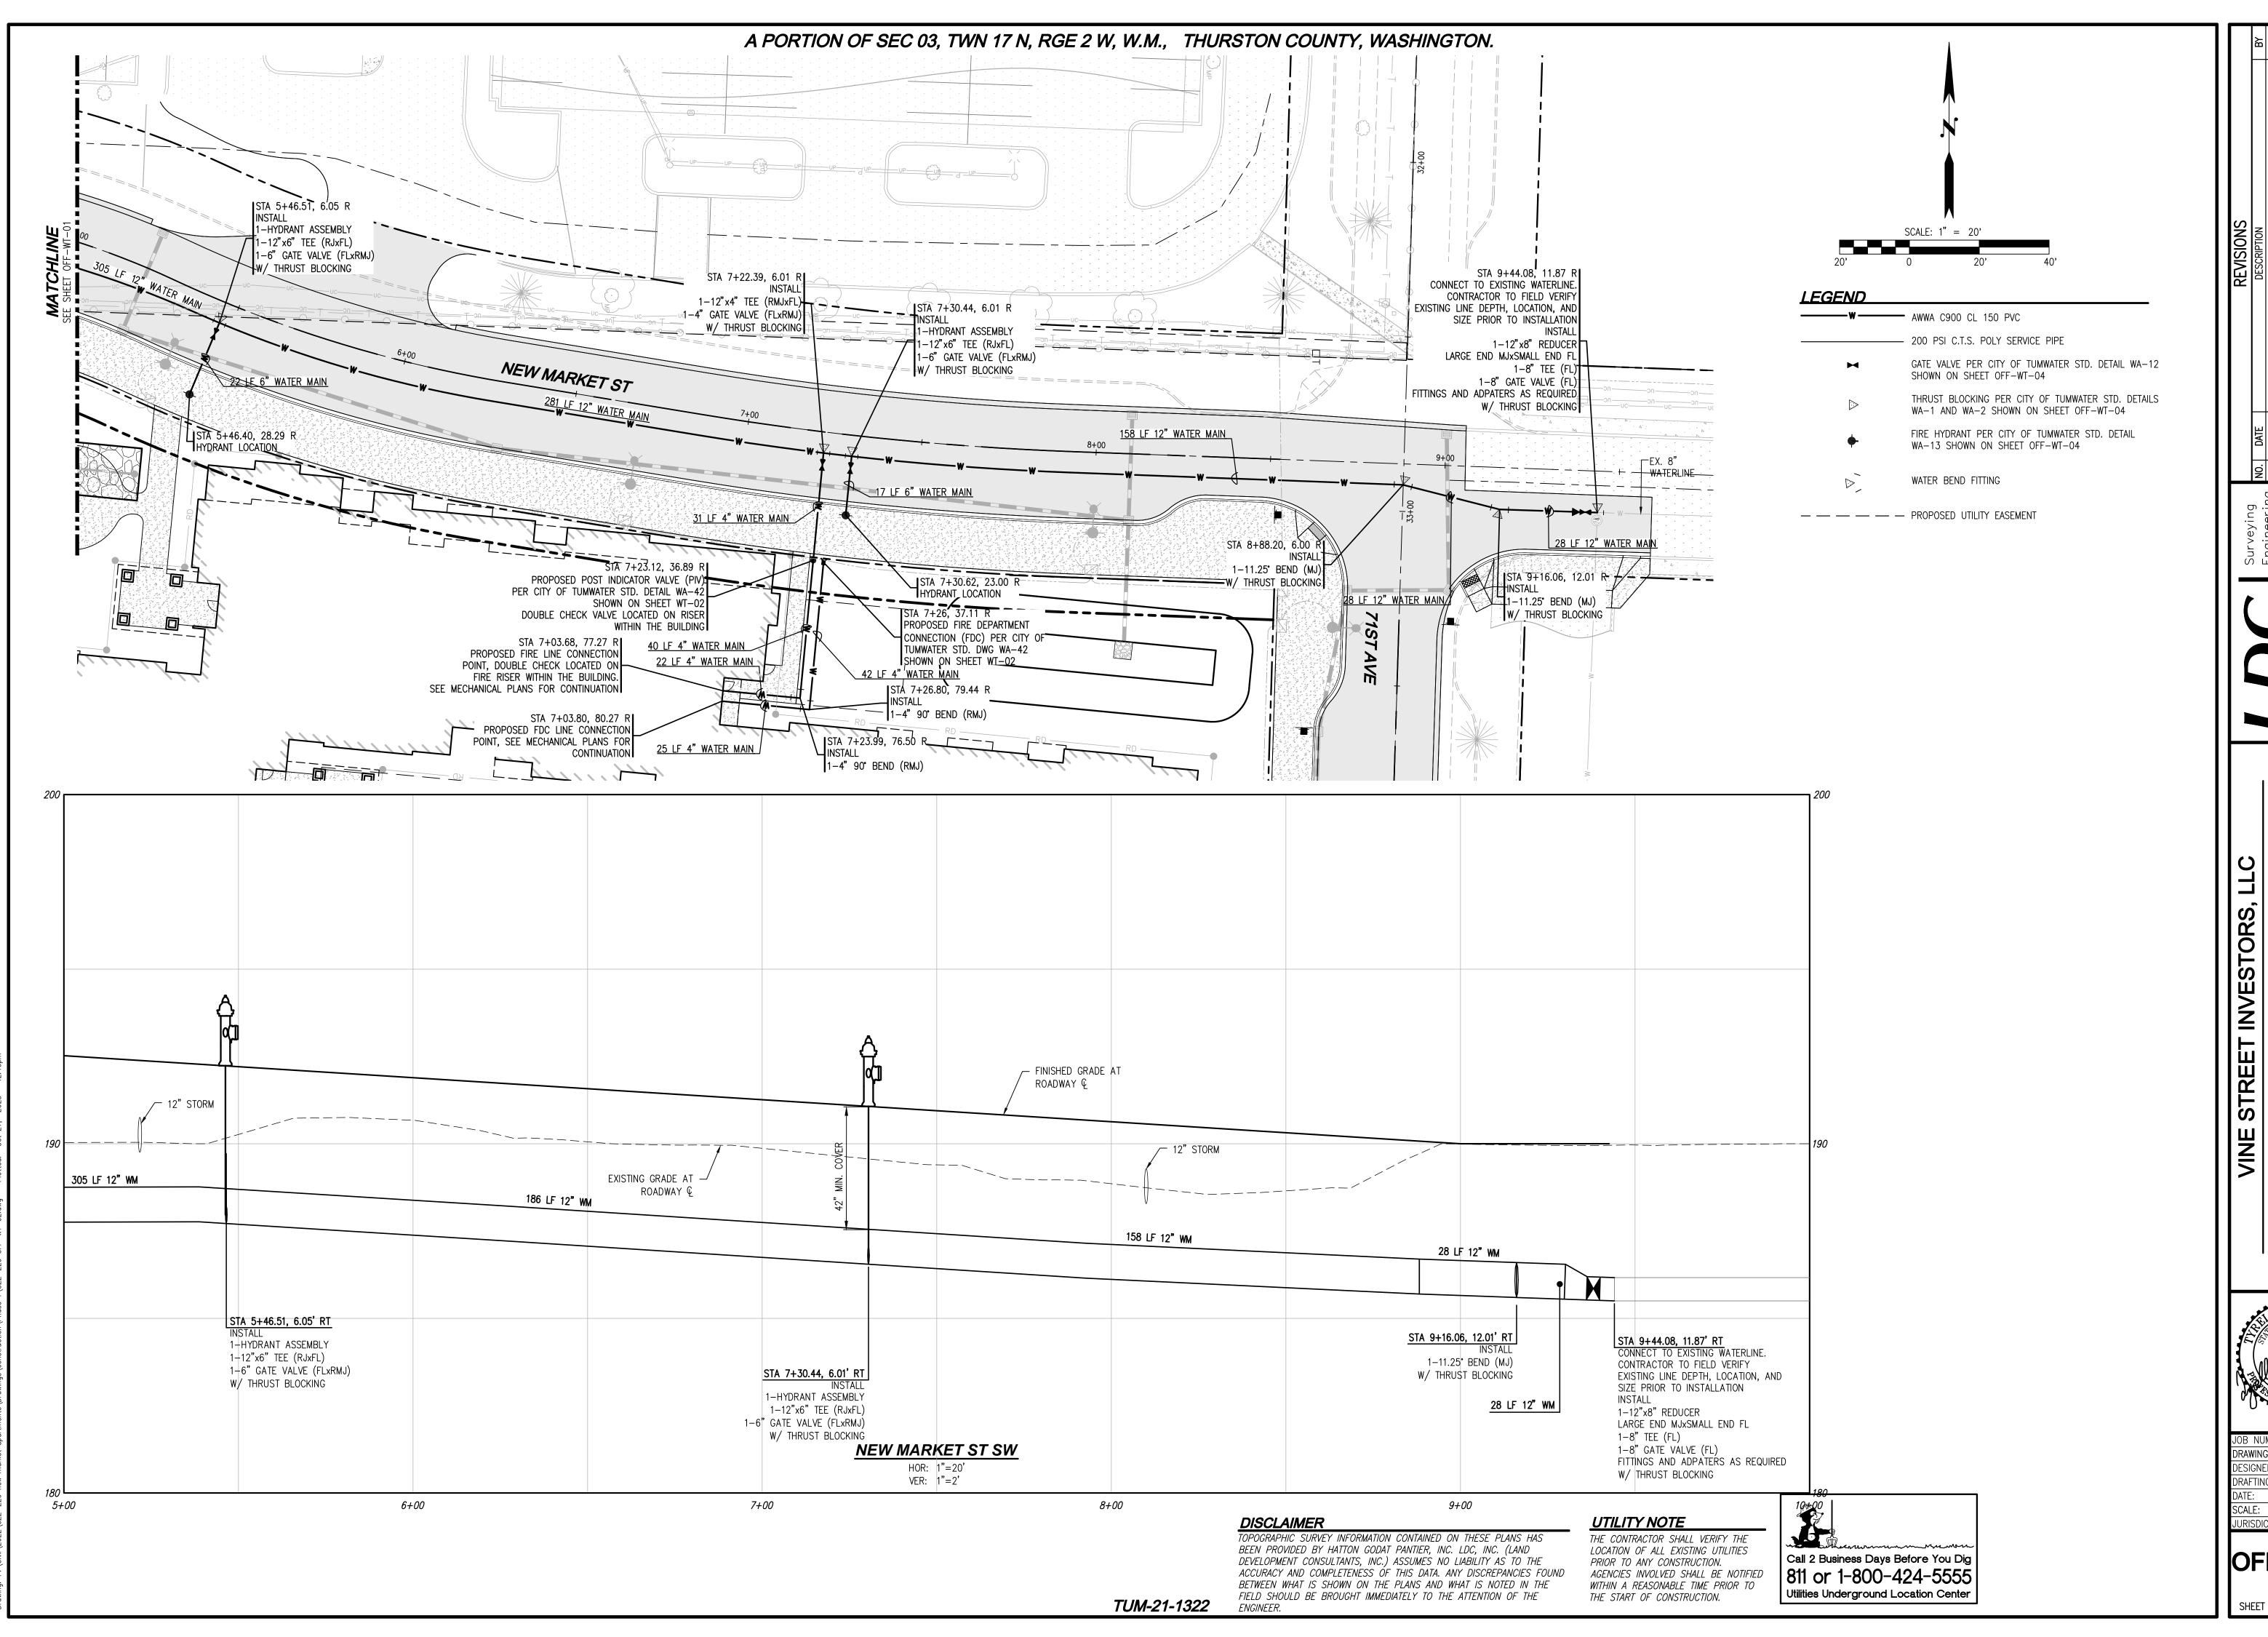

NO. DATE DESCRIPTION BY

Voodinville Olympia K 321 Cleveland Ave SE, Suite 209 Tumwater, WA 98501

MARKET APARTMENTS

MARKET APARTMENTS

VINE STREE


NEW MARKE



JOB NUMBER: C22-229
DRAWING NAME: C22-229 OFF-WT-02
DESIGNER: T. BRADLEY
DRAFTING BY: S. ORDONEZ
DATE: OCTOBER, 2023
SCALE: AS NOTED
JURISDICTION: TUMWATER

OFF-WT-02

SHEET **32** OF **43**

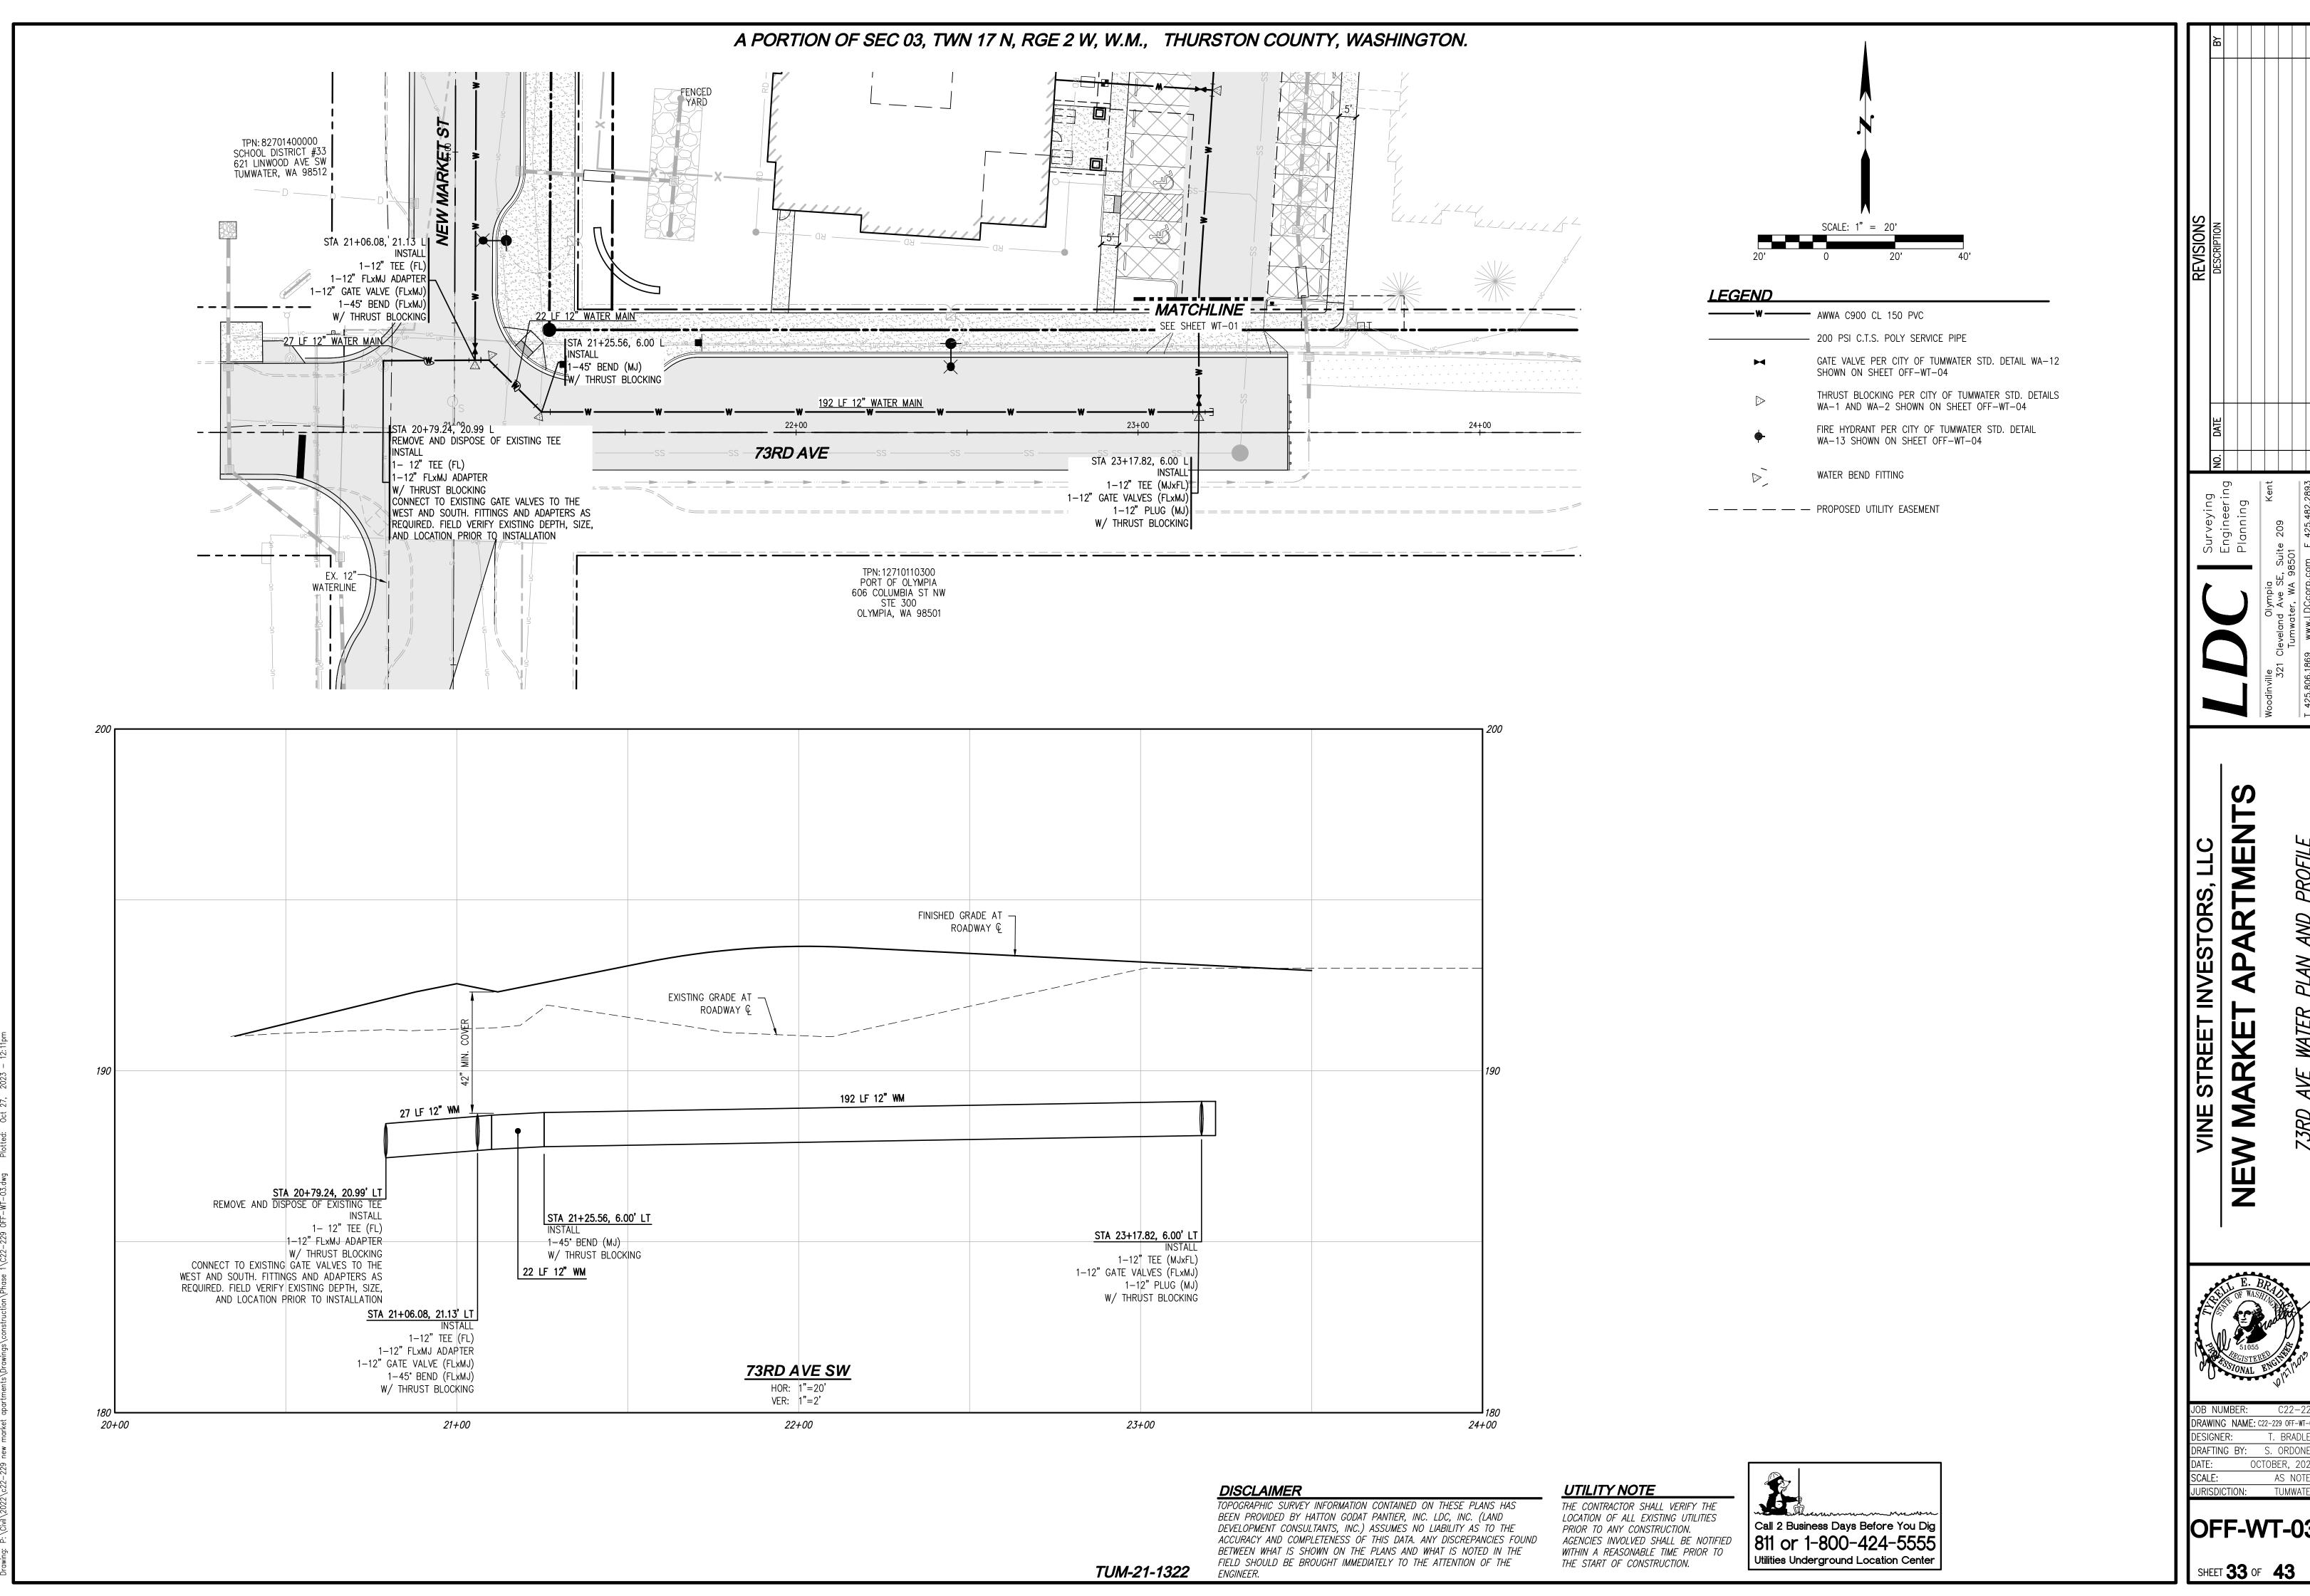

APARTMEN **MARKET**


DRAWING NAME: C22-229 OFF-WT-0 DESIGNER: DRAFTING BY: S. ORDONE


IOFF-WT-03

A PORTION OF SEC 03, TWN 17 N, RGE 2 W, W.M., THURSTON COUNTY, WASHINGTON.

APPROVED BY:

PW PW KMC JULY 2014 SCALE

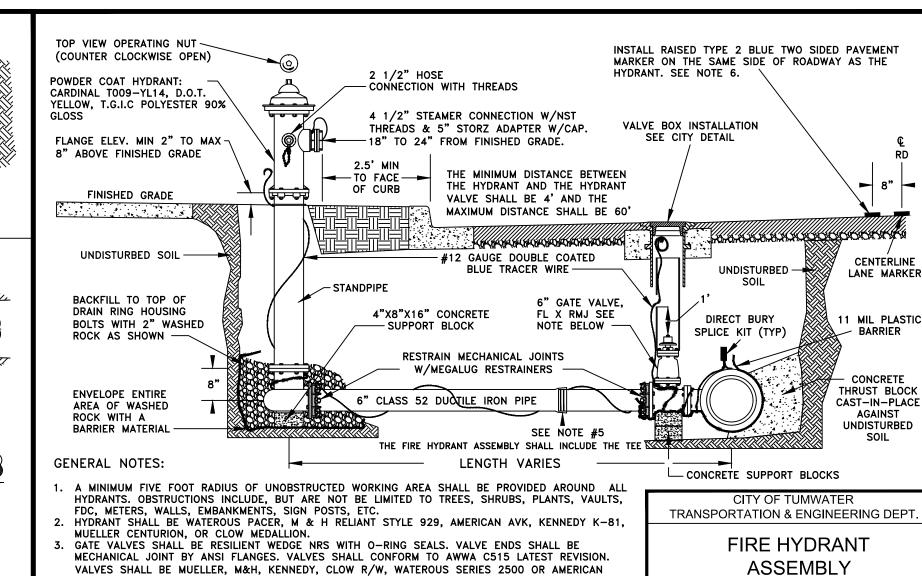

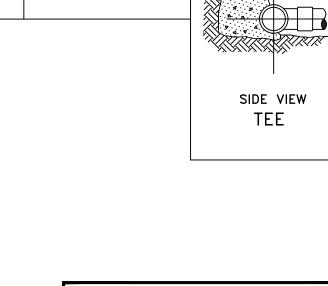

CROSS WITH

PLUGS

PLUG OR

CAP

TOP VIEW

REMOVE FACTORY CHAINS HOLDING CAPS.

RESTRAINED JOINTS SHALL BE REQUIRED.

. WHEN DISTANCE BETWEEN FIRE HYDRANT AND VALVE EXCEEDS MORE THAN 1 STICK OF PIPE

INSTALLATION OF A BLUE, TYPE 2, TWO WAY, REFLECTIVE HYDRANT MARKER SHALL BE THE

GENERAL NOTES:

1. CONCRETE THRUST BLOCKING TO BE POURED AGAINST UNDISTURBED EARTH.

2. PLASTIC BARRIER SHALL BE PLACED BETWEEN

ALL THRUST BLOCKS AND FITTIINGS.
3. ANCHOR REBAR SHALL BE 5/8" MINIMUM

TEE WITH

PLUG

45° - 90°


VERTICAL BEND


CROSS WITH

TRANSPORTATION & ENGINEERING DEPT.					
STANDARD BLOCKING DETAIL					
APPROVED BY:				DWG. NO.	
	WA-1				
CITY ENGINEER					
DES.	NOT TO				
PW	PW	KMC	JUNE 2014	SCALE	
			•		

CITY OF TUMWATER GENERAL NOTES- WATER

- A. ALL WORKMANSHIP AND MATERIALS WILL BE IN ACCORDANCE WITH CITY OF TUMWATER STANDARDS AND THE 1994 STATE OF WASHINGTON STANDARD SPECIFICATIONS FOR ROAD, BRIDGE AND MUNICIPAL CONSTRUCTION, LATEST EDITION.
- B. A PRECONSTRUCTION MEETING SHALL BE HELD WITH THE CITY PRIOR TO THE START OF CONSTRUCTION.
- C. WATER MAINS EQUAL TO OR LESS THAN TWELVE INCHES IN DIAMETER SHALL BE AWWA C900 CLASS 150, C905 CLASS 235, OR DUCTILE IRON CEMENT MORTAR LINED THICKNESS CLASS 50. ALL WATER MAINS LARGER THAN 12 INCHES IN DIAMETER SHALL BE AWWA C05, CLASS 235 CEMENT MORTAR—LINED THICKNESS CLASS 50 OR DUCTILE IRON.
- D. GATE VALVES SHALL BE RESILIENT WEDGE, NRS (NON RISING STEM) WITH O-RINGS. VALVE ENDS SHALL BE MECHANICAL JOINT OR ANSI FLANGES. VALVES SHALL CONFORM TO AWWA 509-80. VALVES SHALL BE MUELLER, M & H, KENNEDY, CLOW R/W OR WATEROUS SERIES 500. EXISTING VALVES SHALL BE OPERATED BY CITY EMPLOYEES ONLY.
- E. HYDRANTS SHALL BE THE DRY BARREL TYPE AND ONE OF THE FOLLOWING: WATEROUS, M & H, MUELER, OR CLOW. HYDRANTS SHALL BE BAGGED UNTIL SYSTEM IS APPROVED. ALL HYDRANTS SHALL BE EQUIPPED WITH STORZ ADAPTERS.
- F. ALL LINES SHALL BE CHLORINATED AND TESTED IN CONFORMANCE WITH THE ABOVE REFERENCED SPECIFICATION (SEE NOTE A ABOVE).
- G. ALL PIPE AND SERVICES SHALL BE INSTALLED WITH 14 GAUGE COATED COPPER WIRE, WRAPPED AROUND THE PIPE, BROUGHT UP AND TIED OFF AT TOP OF VALVE BOX.
- H. PROVIDE TRAFFIC CONTROL PLAN(S) AS REQUIRED IN ACCORDANCE WITH MUTCD.
- I. ALL WATER MAINS SHALL BE STAKED FOR GRADES AND ALIGNMENT BY AN ENGINEERING OR SURVEYING FIRM CAPABLE OF PERFORMING SUCH WORK.
- J. CALL UNDERGROUND LOCATE AT 1-800-424-5555 A MINIMUM OF 48 HOURS PRIOR TO ANY EXCAVATIONS.
- K. WHERE CONNECTIONS REQUIRE "FIELD VERIFICATION", CONNECTION POINTS WILL BE EXPOSED BY CONTRACTOR AND FITTINGS VERIFIED 48 HOURS PRIOR TO DISTRIBUTING SHUT-DOWN NOTICES.
- L. AT ANY CONNECTION TO AN EXISTING LINE WHERE A NEW VALVE IS NOT INSTALLED, THE EXISTING VALVE MUST BE PRESSURE TESTED TO CITY STANDARDS PRIOR TO CONNECTION. IF AN EXISTING VALVE FAILS TO PASS THE TEST, THE CONTRACTOR SHALL MAKE THE NECESSARY PROVISIONS TO TEST THE NEW LINE PRIOR TO CONNECTION TO THE EXISTING SYSTEM OR INSTALL A NEW VALVE.
- M. NO LOT LINE WATERMAINS ARE ALLOWED.

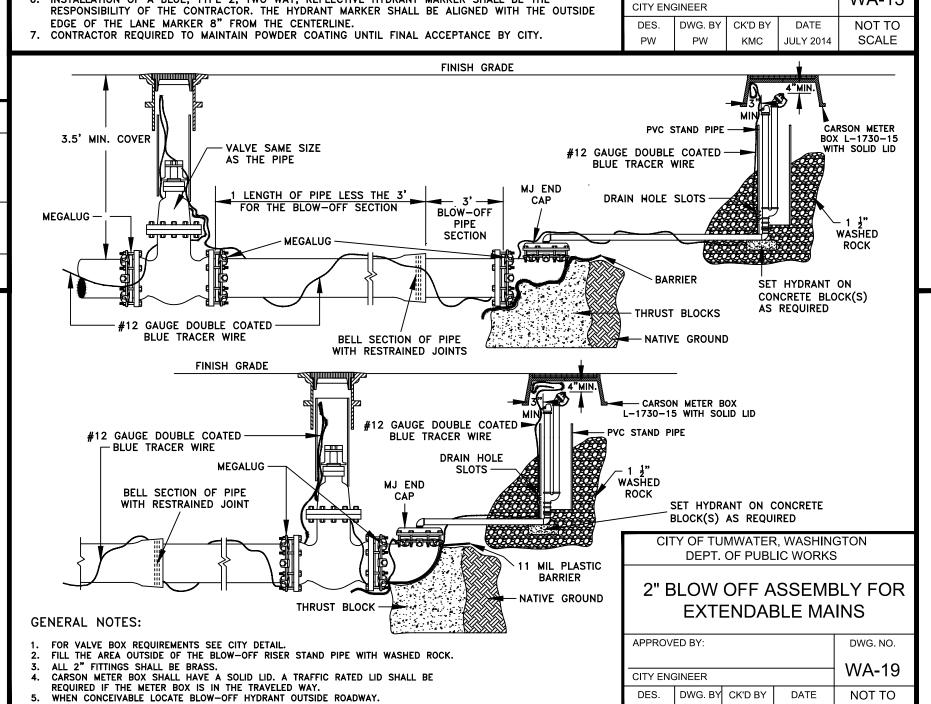

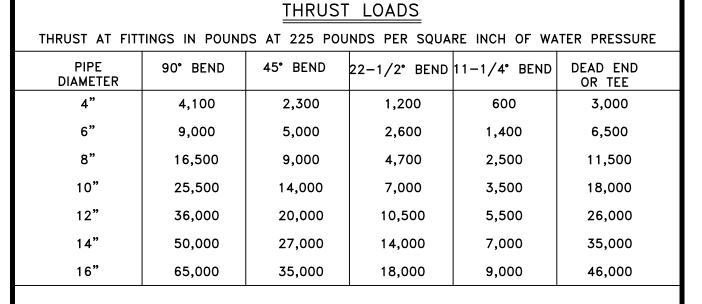

NOTES:

DWG. NO

- 1. BLOCKING SHALL BE COMMERCIAL CONCRETE POURED IN PLACE THRUST BLOCK
- WITH PLASTIC SHEETING OR SIMILAR MATERIAL TO ISOLATE THE FITTING.

 2. TO DETERMINE THE BEARING AREA OF THE THRUST BLOCK IN SQUARE FEET(S.F.)

 EXAMPLE: 12" 90° BEND IN SAND AND GRAVEL 36,000 LBS
- 3000 LB/S.F. = 12 S.F. OF AREA

 3. AREAS MUST BE ADJUSTED FOR OTHER PIPE SIZE, PRESSURES AND SOIL CONDITIONS.
- 4. BLOCKING SHALL BE ADEQUATE TO WITHSTAND FULL TEST PRESSURE AS WELL AS TO CONTINUOUSLY WITHSTAND OPERATING PRESSURE UNDER ALL CONDITIONS OF

SAFE SOIL B	EARING LOADS
FOR HORIZONTAL THRU OF COVER OVER THE	
SOIL	POUNDS PER SQUARE FOOT
MUCK, PEAT	0
SOFT CLAY	1,000
SAND	2,000
SAND & GRAVEL	3,000
SAND & GRAVEL CEMENTED WITH CLAY	4,000

10,000


HARD SHALE

CITY OF TUMWATER	
TRANSPORTATION & ENGINEERI	NG DEPT.
THRUST LOADS	
APPROVED BY:	DWG. NO.
CITY ENGINEER	WA-2

PW

DWG. BY CK'D BY DATE NOT TO

KMC JUNE 2014 SCALE

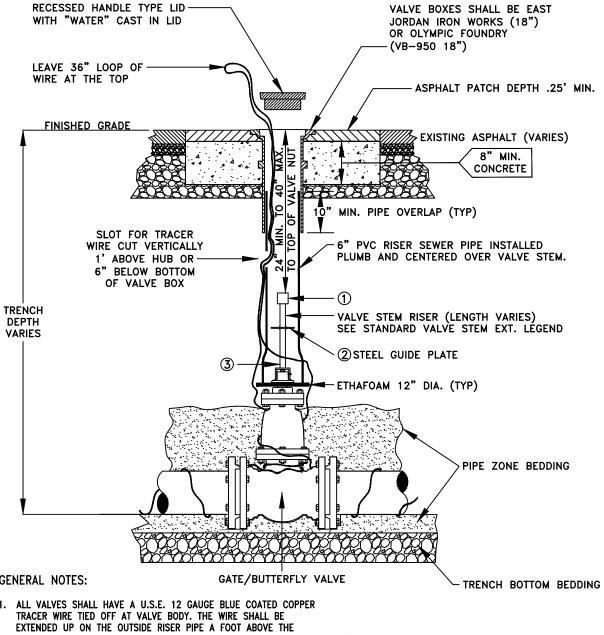

VALVE BOX COVER - EAST JORDAN

GENERAL NOTES: GATE	:/BUTTERFLY VALVE
. ALL VALVES SHALL HAVE A U.S.E. 12 GAUGE BLUE TRACER WIRE TIED OFF AT VALVE BODY. THE WIRE EXTENDED UP ON THE OUTSIDE RISER PIPE A FOOT	SHALL BE ABOVE THE
VALVE HUB BEFORE THE WIRE IS PUT INTO THE RIS SLOT CUT INTO THE RISER. LEAVE 36" OF WIRE AB VALVE BOX.	· · · · · · · · · · · · · · · · · ·
. ALL WELDS TO THE SHAFT SHALL BE FILLET WELD, ENTIRE PLATE PER #2 BELOW,	AROUND THE STANDA
ALVE STEM EXTENSION LEGEND	
1) VALVE OPERATING NUT OR 1-7/8" X 1- 7/8" X STEEL WELDED TO GUIDE PLATE. 2) 3/16" THICK X 5 1/5" DIA STEEL GUIDE PLATE W	
CHAFT	CITY ENGINEER

3 2"X2"X 3/16" SQUARE STRUCTURAL STEEL TUBING TO FIT

OPERATING NUT. LENGTH AS REQUIRED.

CITY OF TUMWATER TRANSPORTATION & ENGINEERING DEPT.

STANDARD VALVE BOX


DE APPROVED BY:

CITY ENGINEER

DES. DWG. BY CK'D BY DATE NOT TO PW PW KMC JUNE 2014 SCALE

SEE STANDARD VALVE BOX COVER AND


VALVE STEM DETAIL

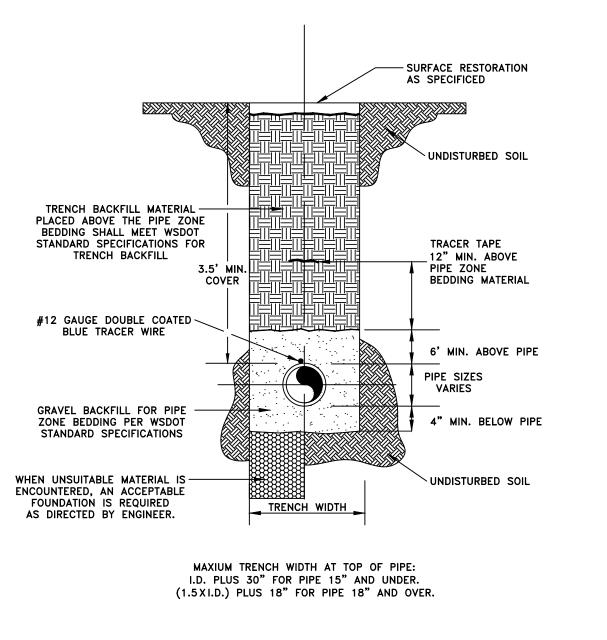

- I. COMPACTION: THE TESTING REQUIREMENTS SHALL BE PER THE CITY OF TUMWATER DEVELOPMENT GUIDELINES AND PUBLIC WORKS STANDARDS.
- ALL MATERIALS, WORKMANSHIP, AND INSTALLATION SHALL BE IN CONFORMANCE WITH THE WSDOT STANDARD SPECIFICATIONS FOR ROAD, BRIDGE AND MUNICIPAL CONSTRUCTION OR AS AMENDED BY CITY OF TUMWATER STANDARDS.

CITY OF TUMWATER TRANSPORTATION & ENGINEERING DEPT.					
WATER TRENCH DETAIL					
UNPAVED AREAS					
APPROVED BY: DWG. NO.					
CITY ENGINEER WA-5.2					
DES	DWG. BY	CK'D BY	DATE	NOT TO	

PW JC BH JAN. 2020 SCALE

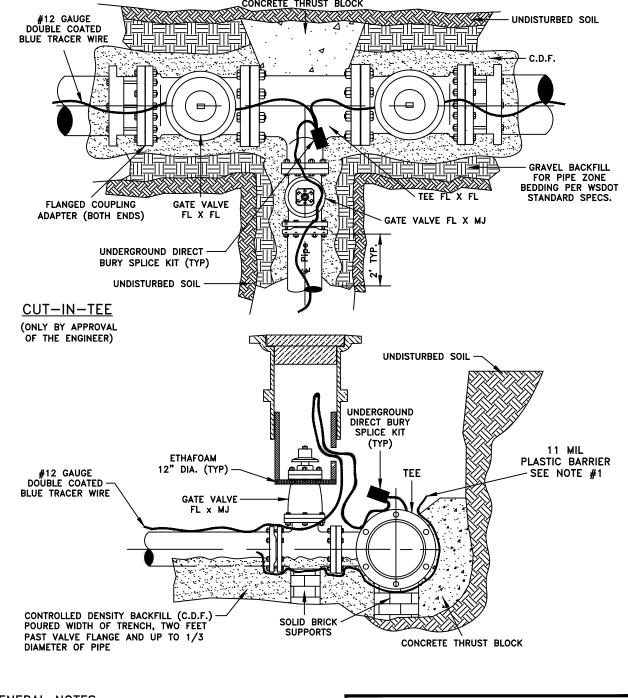

GI	ENERAL NOTES:
1.	11 MIL PLASTIC SHALL BE WRAPPED AROUND PIPE AND FITTINGS BEFORE THRUST BLOCK AND BACKFILL ARE POURED.
2.	CONTROLLED DENSITY BACKFILL IS A PLANT MIX CONSISTING OF 1750# SAND, 1750# PEA GRAVEL, 230# WATER, 141# CEMENT, 6 OUNCES WATER REDUCING

	1 CORED.
2.	CONTROLLED DENSITY BACKFILL IS A PLANT MIX
	CONSISTING OF 1750# SAND, 1750# PEA GRAVEL, 230#
	WATER, 141# CEMENT, 6 OUNCES WATER REDUCING
	AGENT PER 100# CEMENT.
3.	SUPPORT VALVE AND SLEEVE CONTINUOUSLY THROUGH
	INSTALLATION.
4.	MINIMUM 96 HOURS NOTICE SHALL BE GIVEN TO THE
	CITY BEFORE SCHEDULED CONNECTION TO THE EXISTING
	WATER LINE.

CITY OF TUMWATER
TRANSPORTATION & ENGINEERING DEPT
CUT-IN TEE

APPROVI	DWG. NO.			
CITY ENG	SINEER			WA-1
DES. PW	DWG. BY PW	CK'D BY KMC	DATE JUNE 2014	NOT TO SCALE

DISCLAIMER

GENERAL NOTES:

TOPOGRAPHIC SURVEY INFORMATION CONTAINED ON THESE PLANS HAS
BEEN PROVIDED BY HATTON GODAT PANTIER, INC. LDC, INC. (LAND
DEVELOPMENT CONSULTANTS, INC.) ASSUMES NO LIABILITY AS TO THE
ACCURACY AND COMPLETENESS OF THIS DATA. ANY DISCREPANCIES FOUND
BETWEEN WHAT IS SHOWN ON THE PLANS AND WHAT IS NOTED IN THE
FIELD SHOULD BE BROUGHT IMMEDIATELY TO THE ATTENTION OF THE

UTILITY NOTE

THE CONTRACTOR SHALL VERIFY THE LOCATION OF ALL EXISTING UTILITIES PRIOR TO ANY CONSTRUCTION.
AGENCIES INVOLVED SHALL BE NOTIFIED WITHIN A REASONABLE TIME PRIOR TO THE START OF CONSTRUCTION.




NO. DATE DESCRIPTION

Leading to the control of the


Woodinville Olympia 321 Cleveland Ave SE, Suite 209 Tumwater, WA 98501

NE STREET INVESTORS, LLC
MARKET APARTMENT

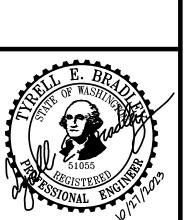

JOB NUMBER: C22-229
DRAWING NAME2-229 OFF-WT-04
DESIGNER: T. BRADLEY
DRAFTING BY: S. ORDONEZ
DATE: OCTOBER, 2023
SCALE: AS NOTED
JURISDICTION: TUMWATER

OFF-WT-04
SHEET **34** OF **43**

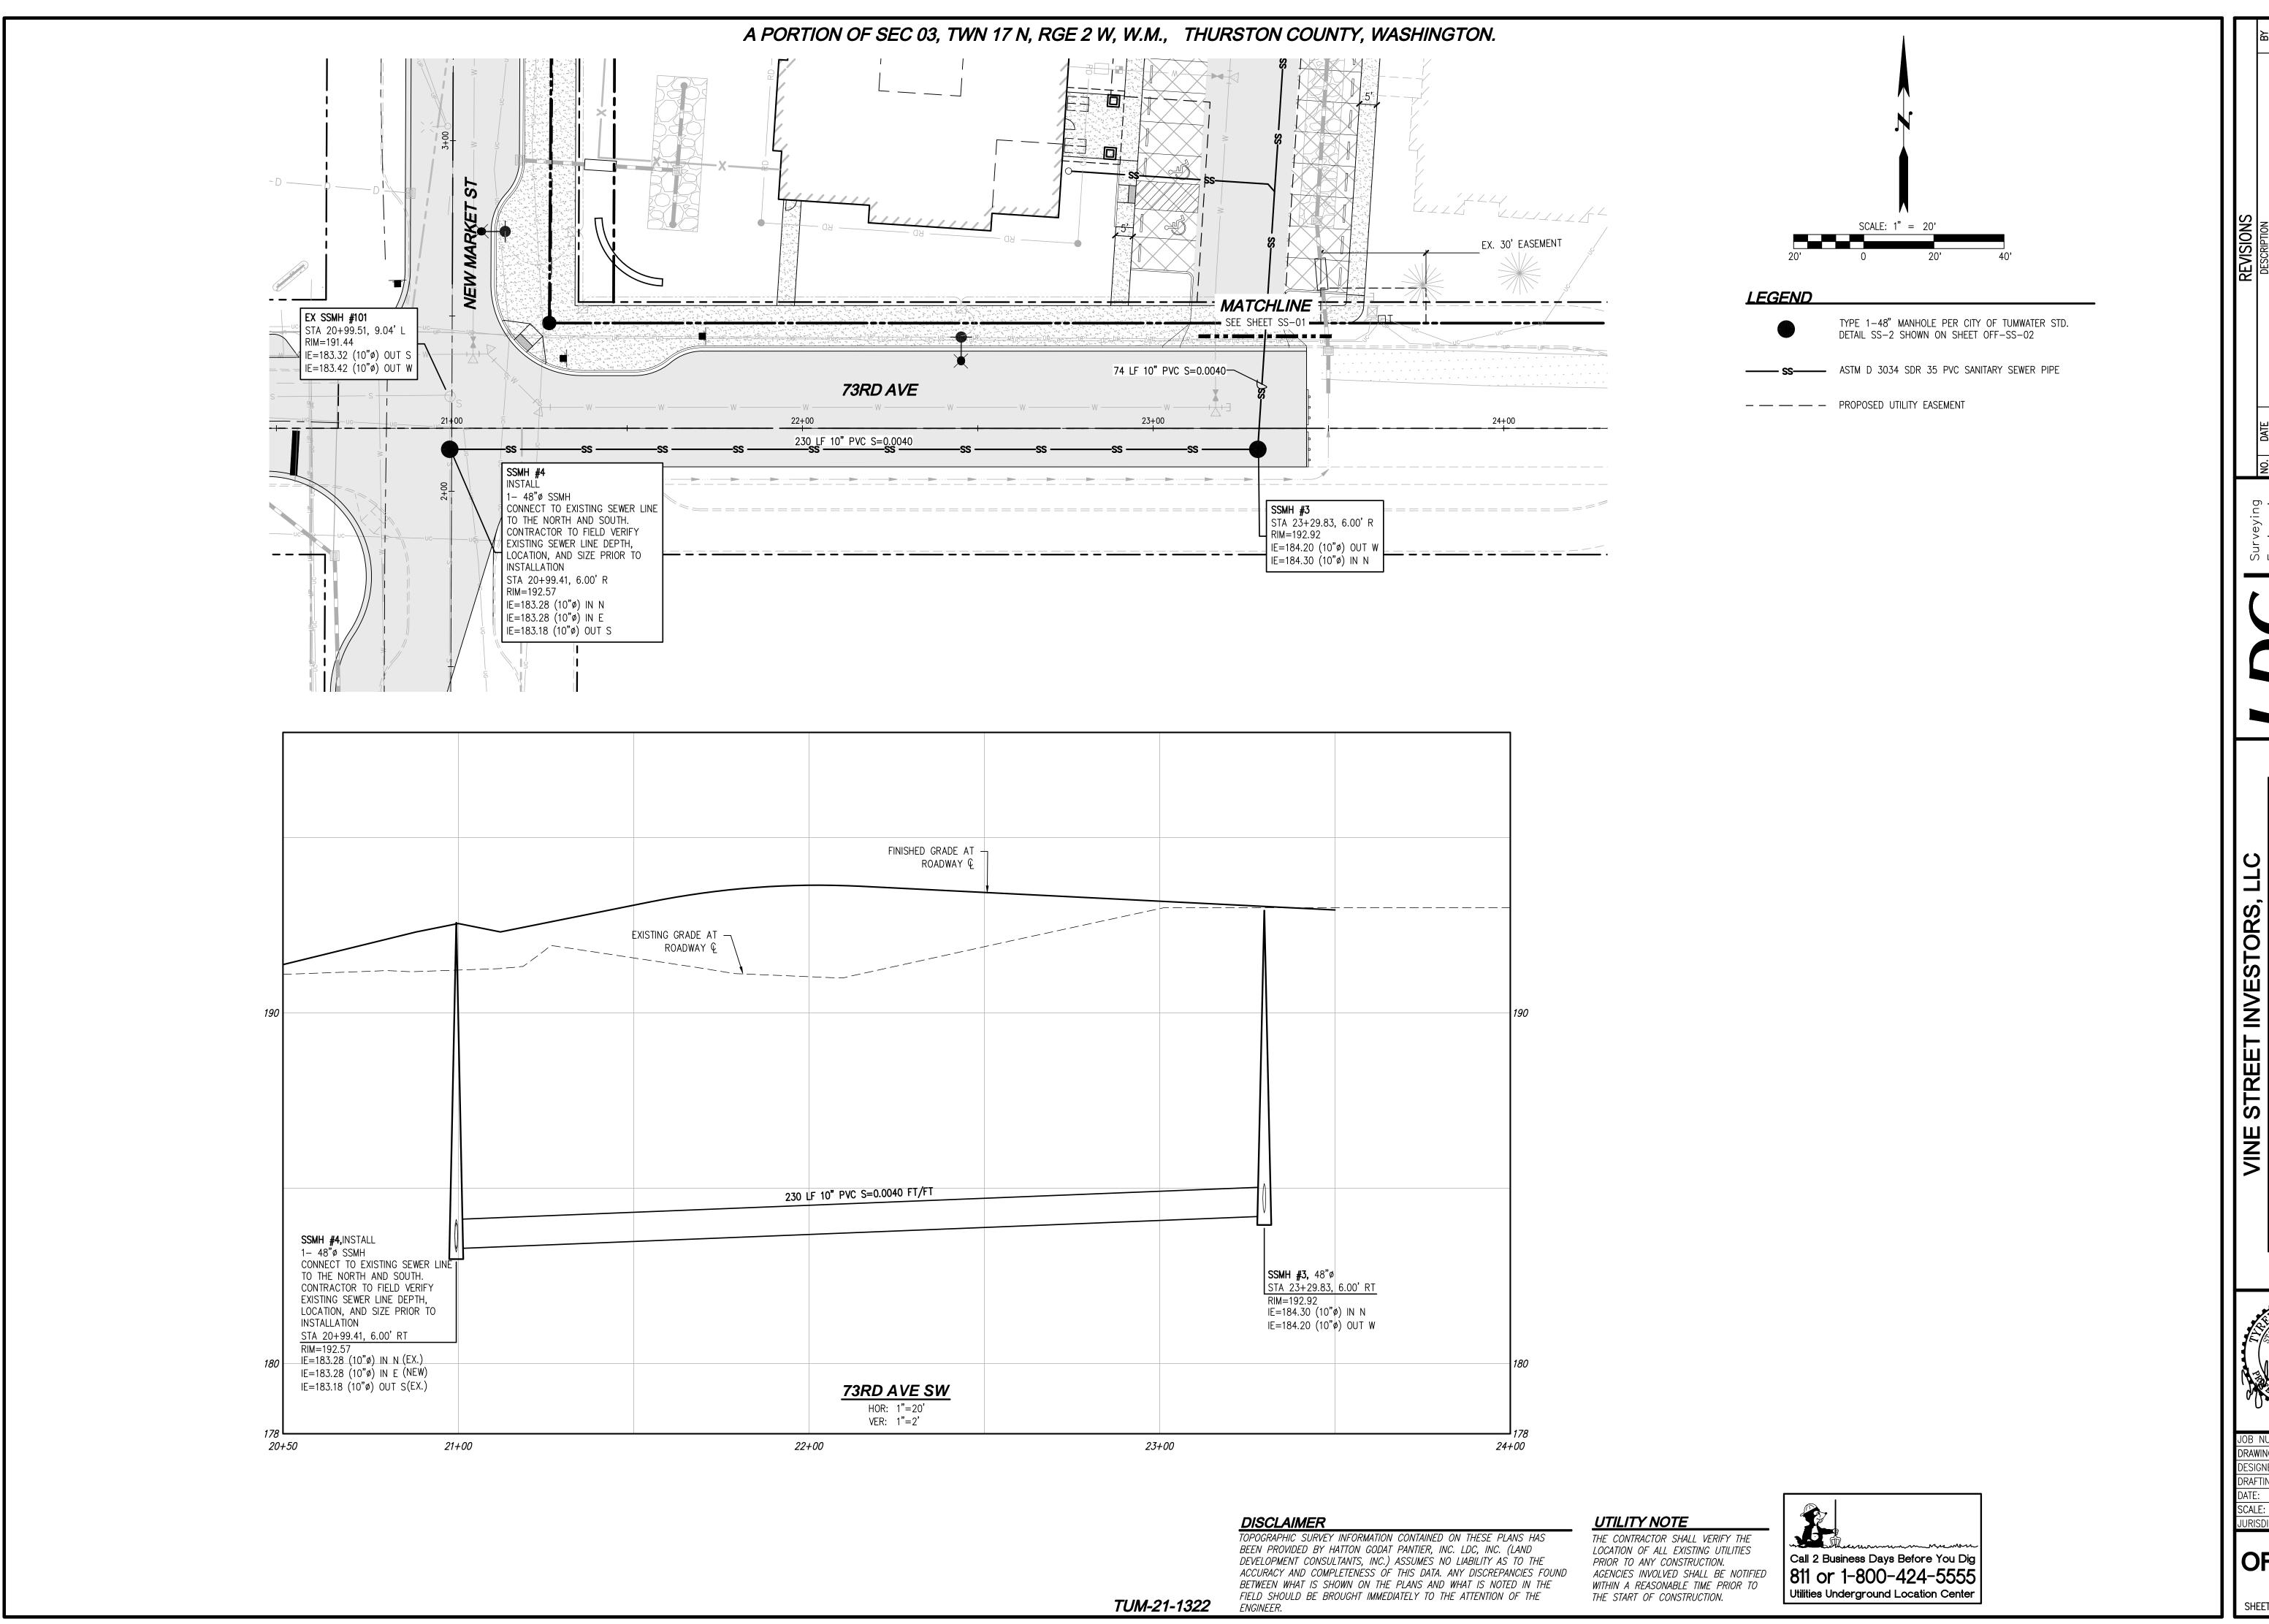

APARTMEN

MARKET




DRAWING NAME: C22-229 OFF-SS DESIGNER: DRAFTING BY: S. ORDONE SCALE: JURISDICTION: TUMWATER

OFF-SS-01

SHEET **35** OF **43**

CITY OF TUMWATER GENERAL NOTES SANITARY SEWER


- 1. ALL WORKMANSHIP AND MATERIALS WILL BE IN ACCORDANCE WITH CITY OF TUMWATER STANDARDS AND THE MOST CURRENT EDITION OF THE STATE OF WASHINGTON STANDARD SPECIFICATIONS FOR ROAD, BRIDGE AND MUNICIPAL CONSTRUCTION.
- 2. CITY OF TUMWATER DATUM SHALL BE USED FOR ALL VERTICAL CONTROL. A BENCHMARK LIST IS AVAILABLE FROM THE PUBLIC WORKS DEPARTMENT.
- 3. ALL APPROVALS AND PERMITS REQUIRED BY THE CITY OF TUMWATER SHALL BE OBTAINED BY THE CONTRACTOR PRIOR TO THE START OF CONSTRUCTION.
- 4. IF CONSTRUCTION IS TO TAKE PLACE IN THE COUNTY RIGHT-OF-WAY, THE CONTRACTOR SHALL NOTIFY THE COUNTY AND OBTAIN ALL THE REQUIRED APPROVALS AND PERMITS.
- 5. A PRECONSTRUCTION MEETING SHALL BE HELD WITH THE CITY OF TUMWATER CONSTRUCTION INSPECTOR PRIOR TO THE START OF CONSTRUCTION.
- 6. THE CITY OF TUMWATER CONSTRUCTION INSPECTOR SHALL BE NOTIFIED A MINIMUM OF 48 HOURS IN ADVANCE OF A TAP CONNECTION TO AN EXISTING MAIN.
- 7. THE CONTRACTOR SHALL BE FULLY RESPONSIBLE FOR THE LOCATION AND PROTECTION OF ALL EXISTING UTILITIES. THE CONTRACTOR SHALL VERIFY ALL UTILITY LOCATIONS PRIOR TO CONSTRUCTION BY CALLING THE UNDERGROUND LOCATE LINE AT 1-800-424-5555 A MINIMUM OF 48 HOURS PRIOR TO ANY EXCAVATION.
- 8. GRAVITY SEWER MAIN SHALL BE PVC, ASTM D 3034 SDR 35 OF ASTM F 789 WITH JOINTS AND RUBBER GASKETS CONFORMING TO ASTM D 3212 AND ASTM F 477.
- 9. PRECAST MANHOLES SHALL MEET THE REQUIREMENTS OF ASTM C 478. MANHOLES SHALL BE TYPE 1-48" MANHOLES OR LARGER UNLESS OTHERWISE SPECIFIED ON THE PLANS. JOINTS SHALL BE RUBBER GASKETED CONFORMING TO ASTM C 443 AND SHALL BE GROUTED FROM THE INSIDE. LIFT HOLES SHALL BE GROUTED FROM THE OUTSIDE OF THE MANHOLE.
- 10. SIDE SEWER SERVICES SHALL BE PVC, ASTM D 3034 SDR 35 WITH FLEXIBLE GASKETED JOINTS. SIDE SEWER CONNECTIONS SHALL BE MADE BY A TAP TO AN EXISTING MAIN OR A WYE BRANCH FROM A NEW MAIN.
- 11. ALL SEWER MAINS SHALL BE FIELD STAKED FOR GRADES AND ALIGNMENT BY A LICENSED ENGINEERING OR SURVEYING FIRM QUALIFIED TO PERFORM SUCH WORK.
- 12. BEDDING OF THE SEWER MAIN AND COMPACTION OF THE BACKFILL MATERIAL SHALL BE REQUIRED IN ACCORDANCE WITH THE ABOVE MENTIONED SPECIFICATION (SEE NOTE 1).
- 13. TEMPORARY STREET PATCHING SHALL BE ALLOWED FOR AS APPROVED BY THE CITY ENGINEER. TEMPORARY STREET PATCHING SHALL BE PROVIDED BY PLACEMENT AND COMPACTION OF ONE INCH MAXIMUM ASPHALT CONCRETE COLD MIX. CONTRACTOR SHALL BE RESPONSIBLE FOR MAINTENANCE AS REQUIRED.
- 14. EROSION CONTROL MEASURES SHALL BE TAKEN BY THE CONTRACTOR DURING CONSTRUCTION TO PREVENT INFILTRATION OF EXISTING AND PROPOSED STORM DRAINAGE FACILITIES AND ROADWAYS.
- 15. PROVIDE TRAFFIC CONTROL PLAN(S) IN ACCORDANCE WITH THE MANUAL ON UNIFORM TRAFFIC CONTROL DEVICES (MUTCD) AS
- 16. IT SHALL BE THE RESPONSIBILITY OF THE CONTRACTOR TO HAVE A COPY OF THESE APPROVED PLANS ON THE CONSTRUCTION SITE AT ALL TIMES.
- 17. ANY CHANGES TO THE DESIGN SHALL FIRST BE REVIEWED AND APPROVED BY THE PROJECT ENGINEER AND THE CITY OF TUMWATER.
- 18. ALL LINES SHALL BE CLEANED AND PRESSURE TESTED IN CONFORMANCE WITH THE ABOVE REFERENCED SPECIFICATIONS (SEE NOTE 1). A WATER TEST OF ALL MANHOLES IN ACCORDANCE WITH TUMWATER STANDARD IS ALSO REQUIRED. TESTING SHALL TAKE PLACE AFTER ALL UNDERGROUND UTILITIES ARE INSTALLED AND COMPACTION OF THE ROADWAY SUBGRADE IS COMPLETED.
- 19. PRIOR TO BACKFILL, ALL MAINS AND APPURTENANCES SHALL BE INSPECTED AND APPROVED BY THE CITY OF TUMWATER CONSTRUCTION INSPECTOR. APPROVAL SHALL NOT RELIEVE THE CONTRACTOR FOR CORRECTION OF ANY DEFICIENCIES AND/OR FAILURES AS DETERMINED BY SUBSEQUENT TESTING AND INSPECTIONS. IT SHALL BE THE CONTRACTOR'S RESPONSIBILITY TO NOTIFY THE CITY OF TUMWATER FOR THE REQUIRED INSPECTIONS.
- 20. ALL SANITARY SEWER MAINS SHALL BE PLACED IN PUBLIC RIGHT-OF-WAY OF IF IN EASEMENT AREAS, PROVIDE 12 FOOT WIDE PAVED (SIX INCH BALLAST, TWO INCH CRUSHED, TWO INCH ASPHALT) ACCESS TO ALL MANHOLES. NO LOT LINE SEWER MAINS
- 21. ALL MAINS WILL BE DEDICATED TO THE CITY FOR MAINTENANCE WITH APPROPRIATE BILLS OF SALE AND EASEMENTS.
- 22. CITY OWNERSHIP OF THE MAIN AND LATERAL WILL GO TO THE PROPERTY LINE OR EASEMENT IF A CLEANOUT EXISTS AT THIS POINT. IF NO CLEANOUT EXISTS, CITY RESPONSIBILITY ENDS AT THE LIMIT OF THE MAIN.

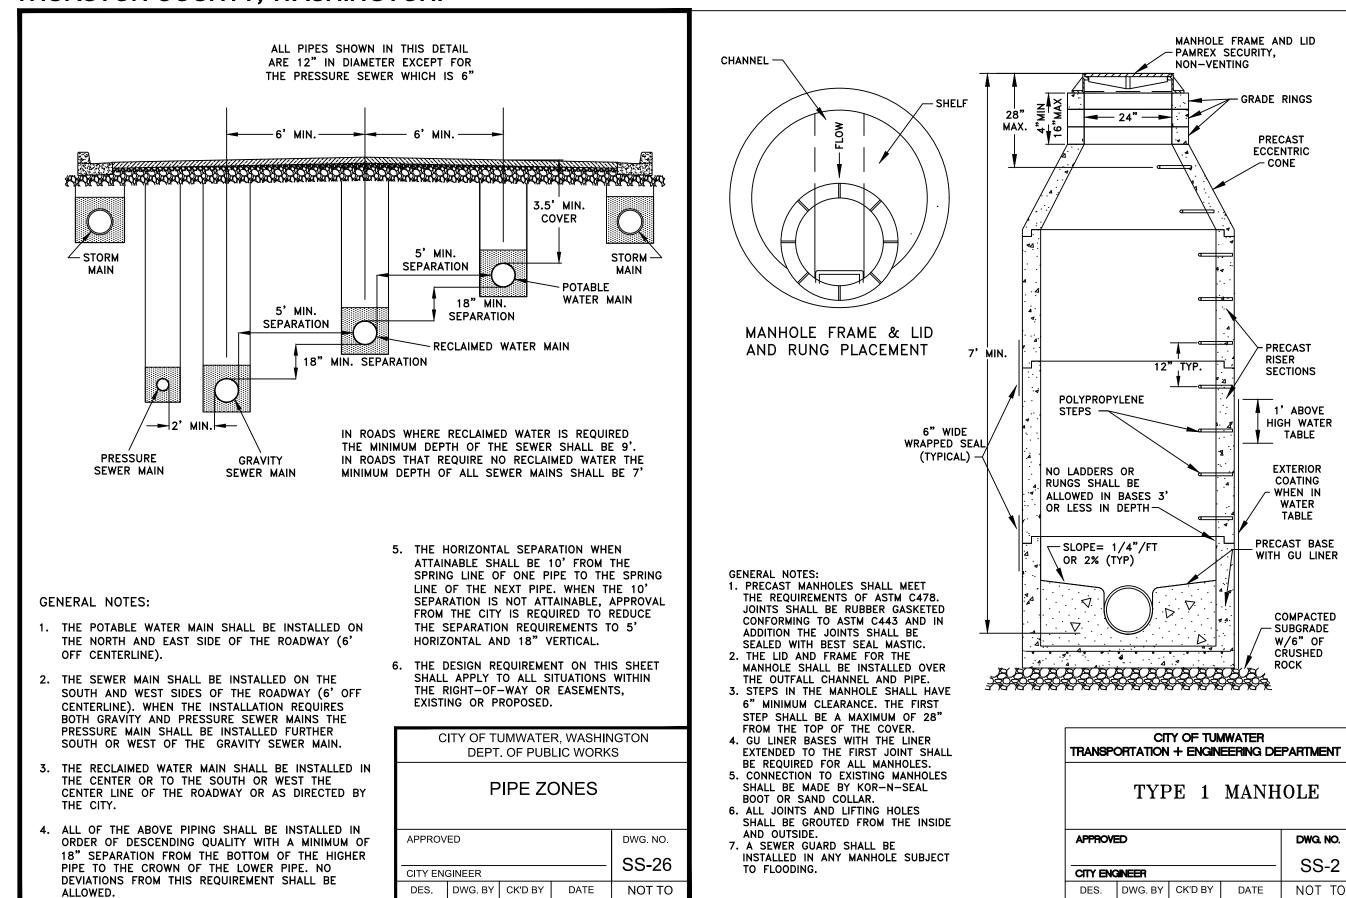

PW

KMC JAN. 2012

SCALE

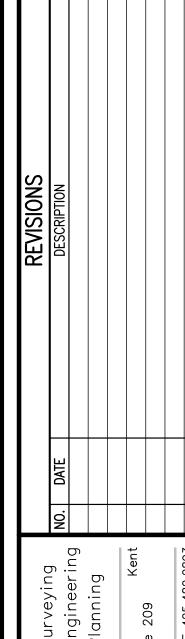

PRECAST ECCENTRIC

PRECAST

SECTIONS

1' ABOVE

HIGH WATER

TABLE

EXTERIOR

- WHEN IN

WATER

TABLE

PRECAST BASE

WITH GU LINER

SUBGRADE

DWG. NO.

SS-2


PW | MW | NOV. 2014 | SCALE

COATING

RISER

ARTME STREET INVESTORS,

VINE

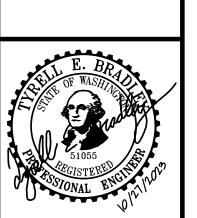

JOB NUMBER: |DRAWING NAMIE2-229 OFF-SS DESIGNER: DRAFTING BY: S. ORDONE SCALE: JURISDICTION: TUMWATE

IOFF-SS-02

SHEET **36** OF **43**


DISCLAIMER BEEN PROVIDED BY HATTON GODAT PANTIER. INC. LDC. INC. (LAND

TOPOGRAPHIC SURVEY INFORMATION CONTAINED ON THESE PLANS HAS DEVELOPMENT CONSULTANTS, INC.) ASSUMES NO LIABILITY AS TO THE ACCURACY AND COMPLETENESS OF THIS DATA. ANY DISCREPANCIES FOUND BETWEEN WHAT IS SHOWN ON THE PLANS AND WHAT IS NOTED IN THE FIELD SHOULD BE BROUGHT IMMEDIATELY TO THE ATTENTION OF THE THE START OF CONSTRUCTION.

UTILITY NOTE THE CONTRACTOR SHALL VERIFY THE LOCATION OF ALL EXISTING UTILITIES PRIOR TO ANY CONSTRUCTION. 811 or 1-800-424-5555 AGENCIES INVOLVED SHALL BE NOTIFIED WITHIN A REASONABLE TIME PRIOR TO

Call 2 Business Days Before You Dig

Utilities Underground Location Center

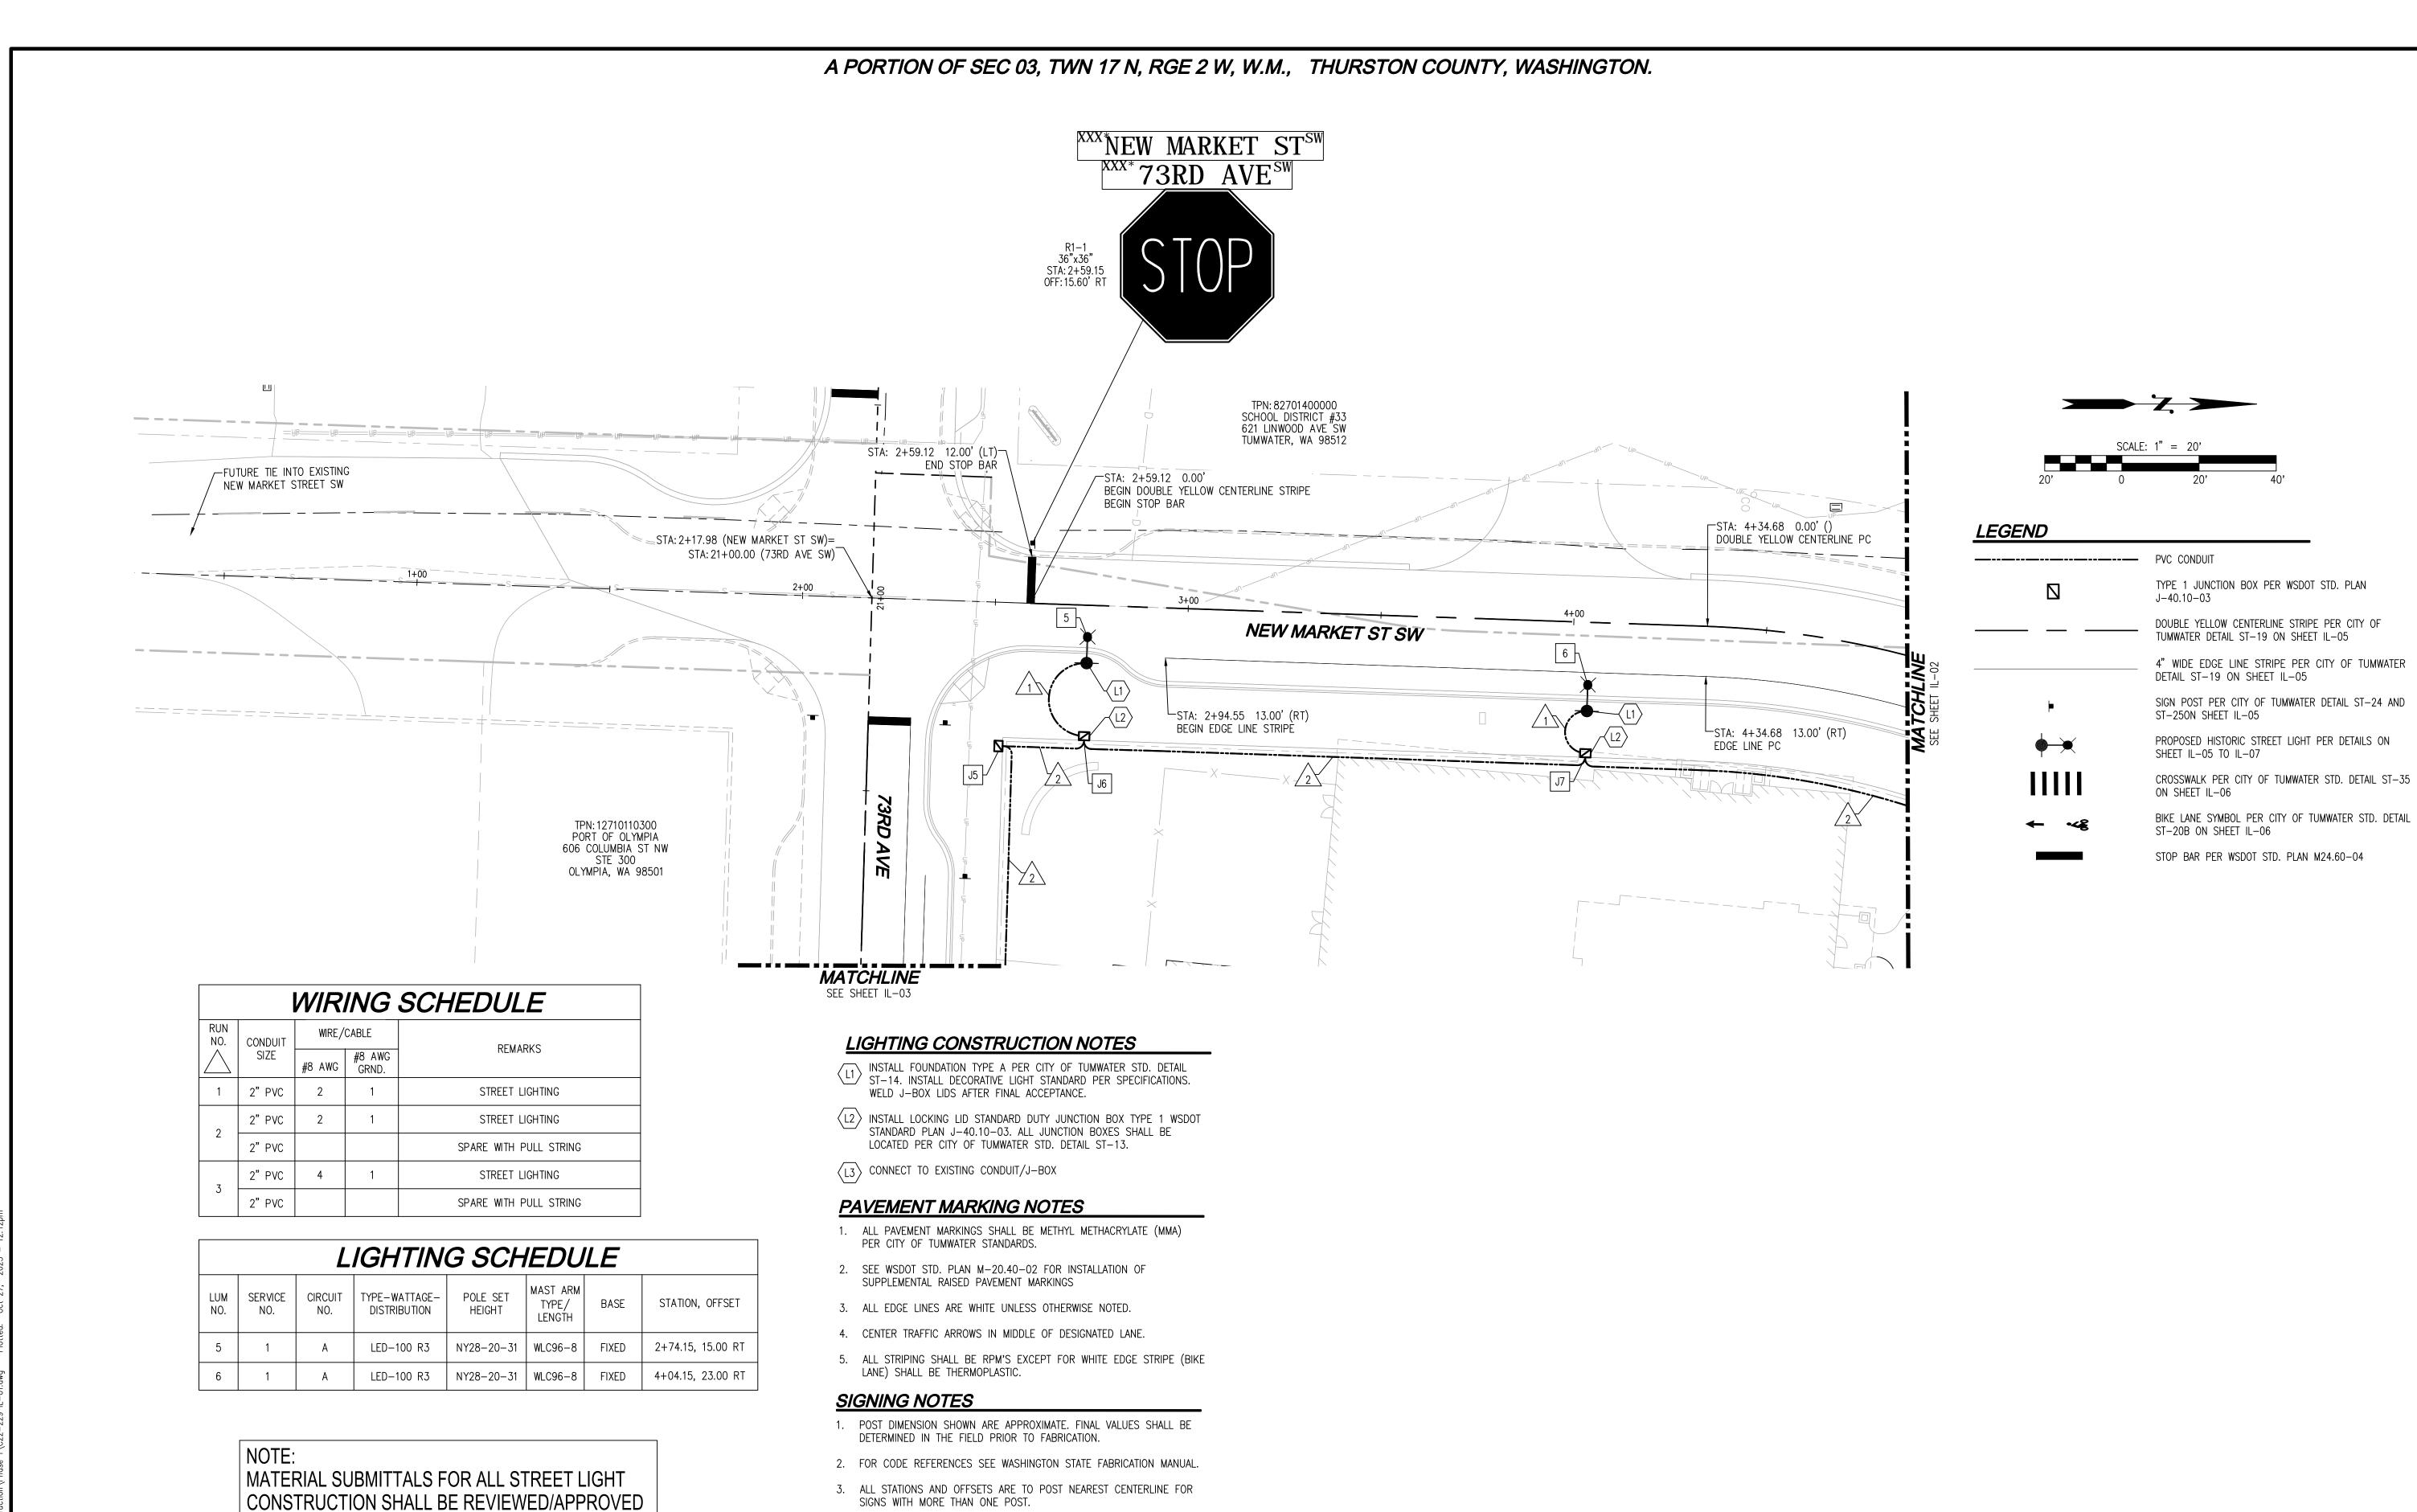

STREET INVESTORS,

T APARTMEN
ST ILLUMINATION,
AND SIGNING PLAN W MARKET ST NEW MARKET ST CHANNELIZATION AI VINE

JOB NUMBER: DRAWING NAME: C22-229 IL-DESIGNER: DRAFTING BY: S. ORDONE OCTOBER, 2 SCALE: AS NOTE JURISDICTION: TUMWATE

IL-01

SHEET **37** OF **43**

DISCLAIMER

TOPOGRAPHIC SURVEY INFORMATION CONTAINED ON THESE PLANS HAS BEEN PROVIDED BY HATTON GODAT PANTIER, INC. LDC, INC. (LAND DEVELOPMENT CONSULTANTS, INC.) ASSUMES NO LIABILITY AS TO THE ACCURACY AND COMPLETENESS OF THIS DATA. ANY DISCREPANCIES FOUND BETWEEN WHAT IS SHOWN ON THE PLANS AND WHAT IS NOTED IN THE FIELD SHOULD BE BROUGHT IMMEDIATELY TO THE ATTENTION OF THE

UTILITY NOTE

THE CONTRACTOR SHALL VERIFY THE LOCATION OF ALL EXISTING UTILITIES PRIOR TO ANY CONSTRUCTION. AGENCIES INVOLVED SHALL BE NOTIFIED WITHIN A REASONABLE TIME PRIOR TO THE START OF CONSTRUCTION.

TUM-21-1322

4. USE TYPE ST-4 SIGN SUPPORT, PER WSDOT STANDARD PLAN

G-24.40-04, FOR SIGNS WITH MORE THAN ONE POST.

6. ALL NEW SIGN SUPPORTS SHALL BE 2 INCH SQUARE STEEL 12

5. USE TYPE SB-3 STEEL SIGN SUPPORT, PER WSDOT STANDARD PLAN

G-24.50-03, FOR SIGNS WITH SINGLE POST.


GAUGE TELSPAR.

BY THE CITY PRIOR TO ORDERING ANY MATERIAL

INCLUDING POLES, LIGHTS, JUNCTION

BOXES, CONDUIT, ANCHORS, ETC.

Call 2 Business Days Before You Dig 811 or 1-800-424-5555 **Utilities Underground Location Center**

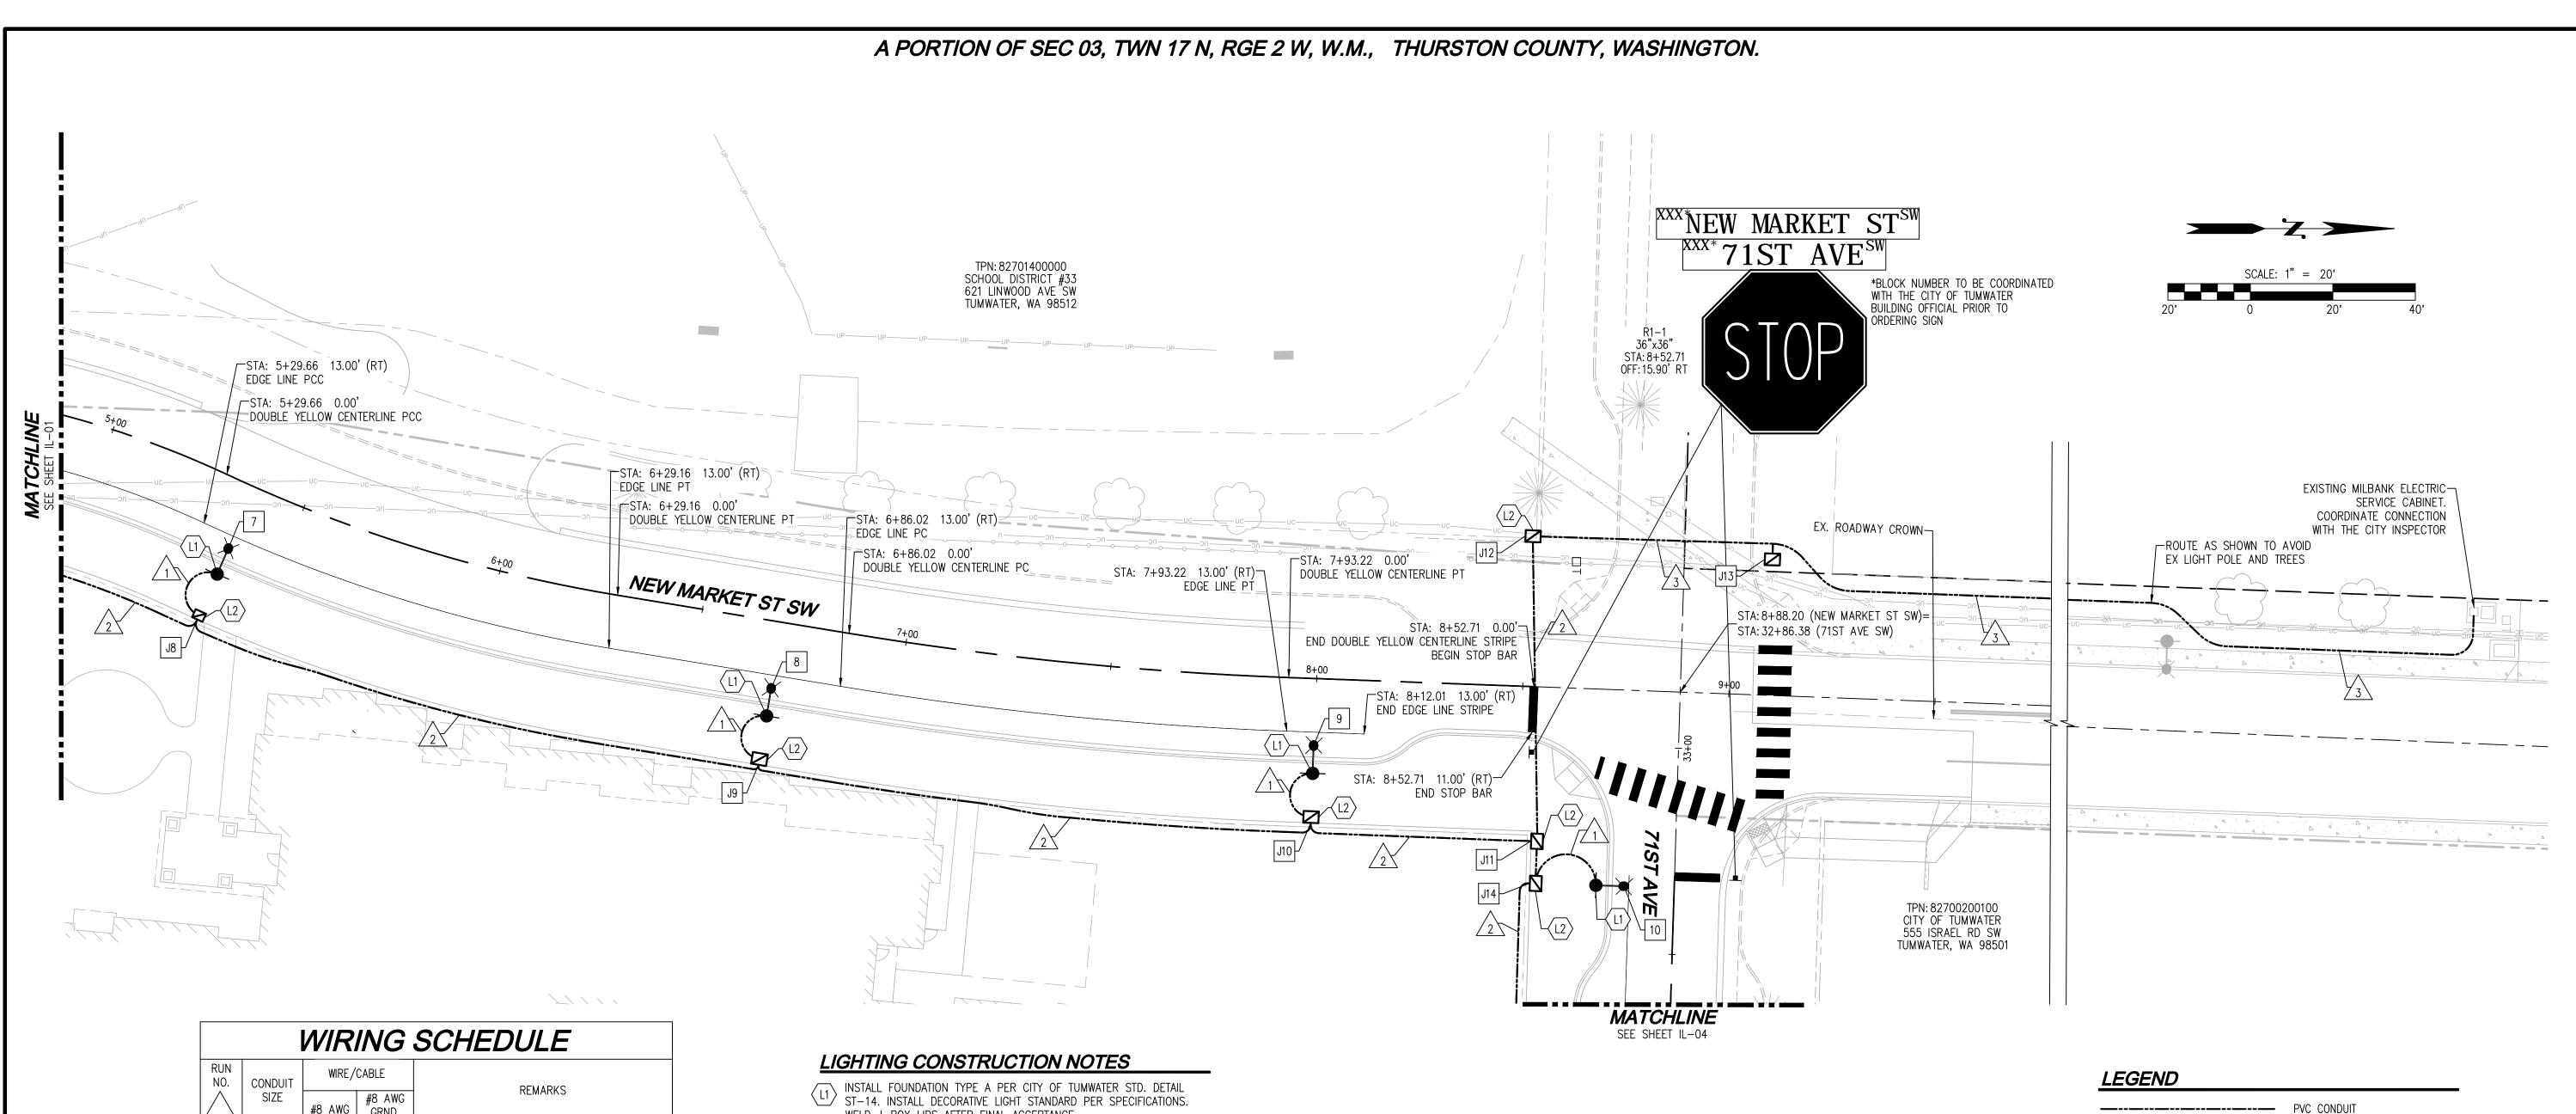

	WIRING SCHEDULE					
	RUN NO.	CONDUIT	WIRE/CABLE		REMARKS	
		SIZE	#8 AWG	#8 AWG GRND.	REMARKS	
	1	2" PVC	2	1	STREET LIGHTING	
	2	2" PVC	2	1	STREET LIGHTING	
	2	2" PVC			SPARE WITH PULL STRING	
	3	2" PVC	4	1	STREET LIGHTING	
	3	2" PVC			SPARE WITH PULL STRING	

LIGHTING SCHEDULE							
LUM NO.	SERVICE NO.	CIRCUIT NO.	TYPE-WATTAGE- DISTRIBUTION	POLE SET HEIGHT	MAST ARM TYPE/ LENGTH	BASE	STATION, OFFSET
7	1	Α	LED-100 R3	NY28-20-31	WLC96-8	FIXED	5+37.27, 23.00 RT
8	1	Α	LED-100 R3	NY28-20-31	WLC96-8	FIXED	6+69.53, 23.00 RT
9	1	Α	LED-100 R3	NY28-20-31	WLC96-8	FIXED	7+99.86, 23.00 RT
10	1	Α	LED-100 R3	NY28-20-31	WLC96-8	FIXED	8+69.57, 47.53 RT
11	2	А	LED-100 R3	NY28-20-31	WLC96-8	FIXED	34+63.88, 26.00 R ⁻

NOTE:

MATERIAL SUBMITTALS FOR ALL STREET LIGHT CONSTRUCTION SHALL BE REVIEWED/APPROVED BY THE CITY PRIOR TO ORDERING ANY MATERIAL INCLUDING POLES, LIGHTS, JUNCTION BOXES, CONDUIT, ANCHORS, ETC.

- INSTALL FOUNDATION TYPE A PER CITY OF TUMWATER STD. DETAIL ST-14. INSTALL DECORATIVE LIGHT STANDARD PER SPECIFICATIONS. WELD J-BOX LIDS AFTER FINAL ACCEPTANCE.
- (L2) INSTALL LOCKING LID STANDARD DUTY JUNCTION BOX TYPE 1 WSDOT STANDARD PLAN J-40.10-03. ALL JUNCTION BOXES SHALL BE LOCATED PER CITY OF TUMWATER STD. DETAIL ST-13.
- (L3) CONNECT TO EXISTING CONDUIT/J-BOX

PAVEMENT MARKING NOTES

- 1. ALL PAVEMENT MARKINGS SHALL BE METHYL METHACRYLATE (MMA) PER CITY OF TUMWATER STANDARDS.
- 2. SEE WSDOT STD. PLAN M-20.40-02 FOR INSTALLATION OF
- SUPPLEMENTAL RAISED PAVEMENT MARKINGS
- 3. ALL EDGE LINES ARE WHITE UNLESS OTHERWISE NOTED. 4. CENTER TRAFFIC ARROWS IN MIDDLE OF DESIGNATED LANE.
- 5. ALL STRIPING SHALL BE RPM'S EXCEPT FOR WHITE EDGE STRIPE (BIKE LANE) SHALL BE THERMOPLASTIC.

SIGNING NOTES

- 1. POST DIMENSION SHOWN ARE APPROXIMATE. FINAL VALUES SHALL BE DETERMINED IN THE FIELD PRIOR TO FABRICATION.
- 2. FOR CODE REFERENCES SEE WASHINGTON STATE FABRICATION MANUAL.
- 3. ALL STATIONS AND OFFSETS ARE TO POST NEAREST CENTERLINE FOR
- 4. USE TYPE ST-4 SIGN SUPPORT, PER WSDOT STANDARD PLAN G-24.50-03, FOR SIGNS WITH SINGLE POST.

SIGNS WITH MORE THAN ONE POST.

- 5. USE TYPE SB-3 STEEL SIGN SUPPORT, PER WSDOT STANDARD PLAN G-24.40-04, FOR SIGNS WITH MORE THAN ONE POST.
- 6. ALL NEW SIGN SUPPORTS SHALL BE 2 INCH SQUARE STEEL 12 GAUGE TELSPAR.

IIIIII

TYPE 1 JUNCTION BOX PER WSDOT STD. PLAN

DOUBLE YELLOW CENTERLINE STRIPE PER CITY OF TUMWATER DETAIL ST-19 ON SHEET IL-05


DETAIL ST-19 ON SHEET IL-05


SIGN POST PER CITY OF TUMWATER DETAIL ST-24 AND ST-250N SHEET IL-05

SHEET IL-05 TO IL-07 CROSSWALK PER CITY OF TUMWATER STD. DETAIL ST-35

BIKE LANE SYMBOL PER CITY OF TUMWATER STD. DETAIL ST-20B ON SHEET IL-06

STOP BAR PER WSDOT STD. PLAN M24.60-04

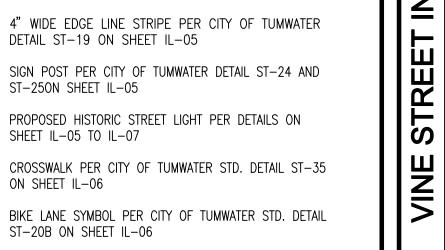

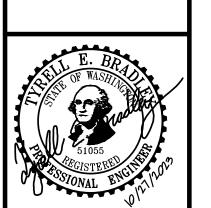

- APARTMEN
ST ILLUMINATION,
AND SIGNING PLAN

MARKE

JOB NUMBER:	C22-22
DRAWING NAM	E: C22-229 IL-C
DESIGNER:	T. BRADLE
DRAFTING BY:	S. ORDONE
DATE:	OCTOBER, 202
SCALE:	AS NOTE
JURISDICTION:	TUMWATE

SHEET **38** OF **43**


TUM-21-1322


DISCLAIMER TOPOGRAPHIC SURVEY INFORMATION CONTAINED ON THESE PLANS HAS BEEN PROVIDED BY HATTON GODAT PANTIER. INC. LDC. INC. (LAND DEVELOPMENT CONSULTANTS. INC.) ASSUMES NO LIABILITY AS TO THE ACCURACY AND COMPLETENESS OF THIS DATA. ANY DISCREPANCIES FOUND BETWEEN WHAT IS SHOWN ON THE PLANS AND WHAT IS NOTED IN THE FIELD SHOULD BE BROUGHT IMMEDIATELY TO THE ATTENTION OF THE

UTILITY NOTE

THE CONTRACTOR SHALL VERIFY THE LOCATION OF ALL EXISTING UTILITIES PRIOR TO ANY CONSTRUCTION. AGENCIES INVOLVED SHALL BE NOTIFIED WITHIN A REASONABLE TIME PRIOR TO THE START OF CONSTRUCTION.

Call 2 Business Days Before You Dig 811 or 1-800-424-5555 **Utilities Underground Location Center**

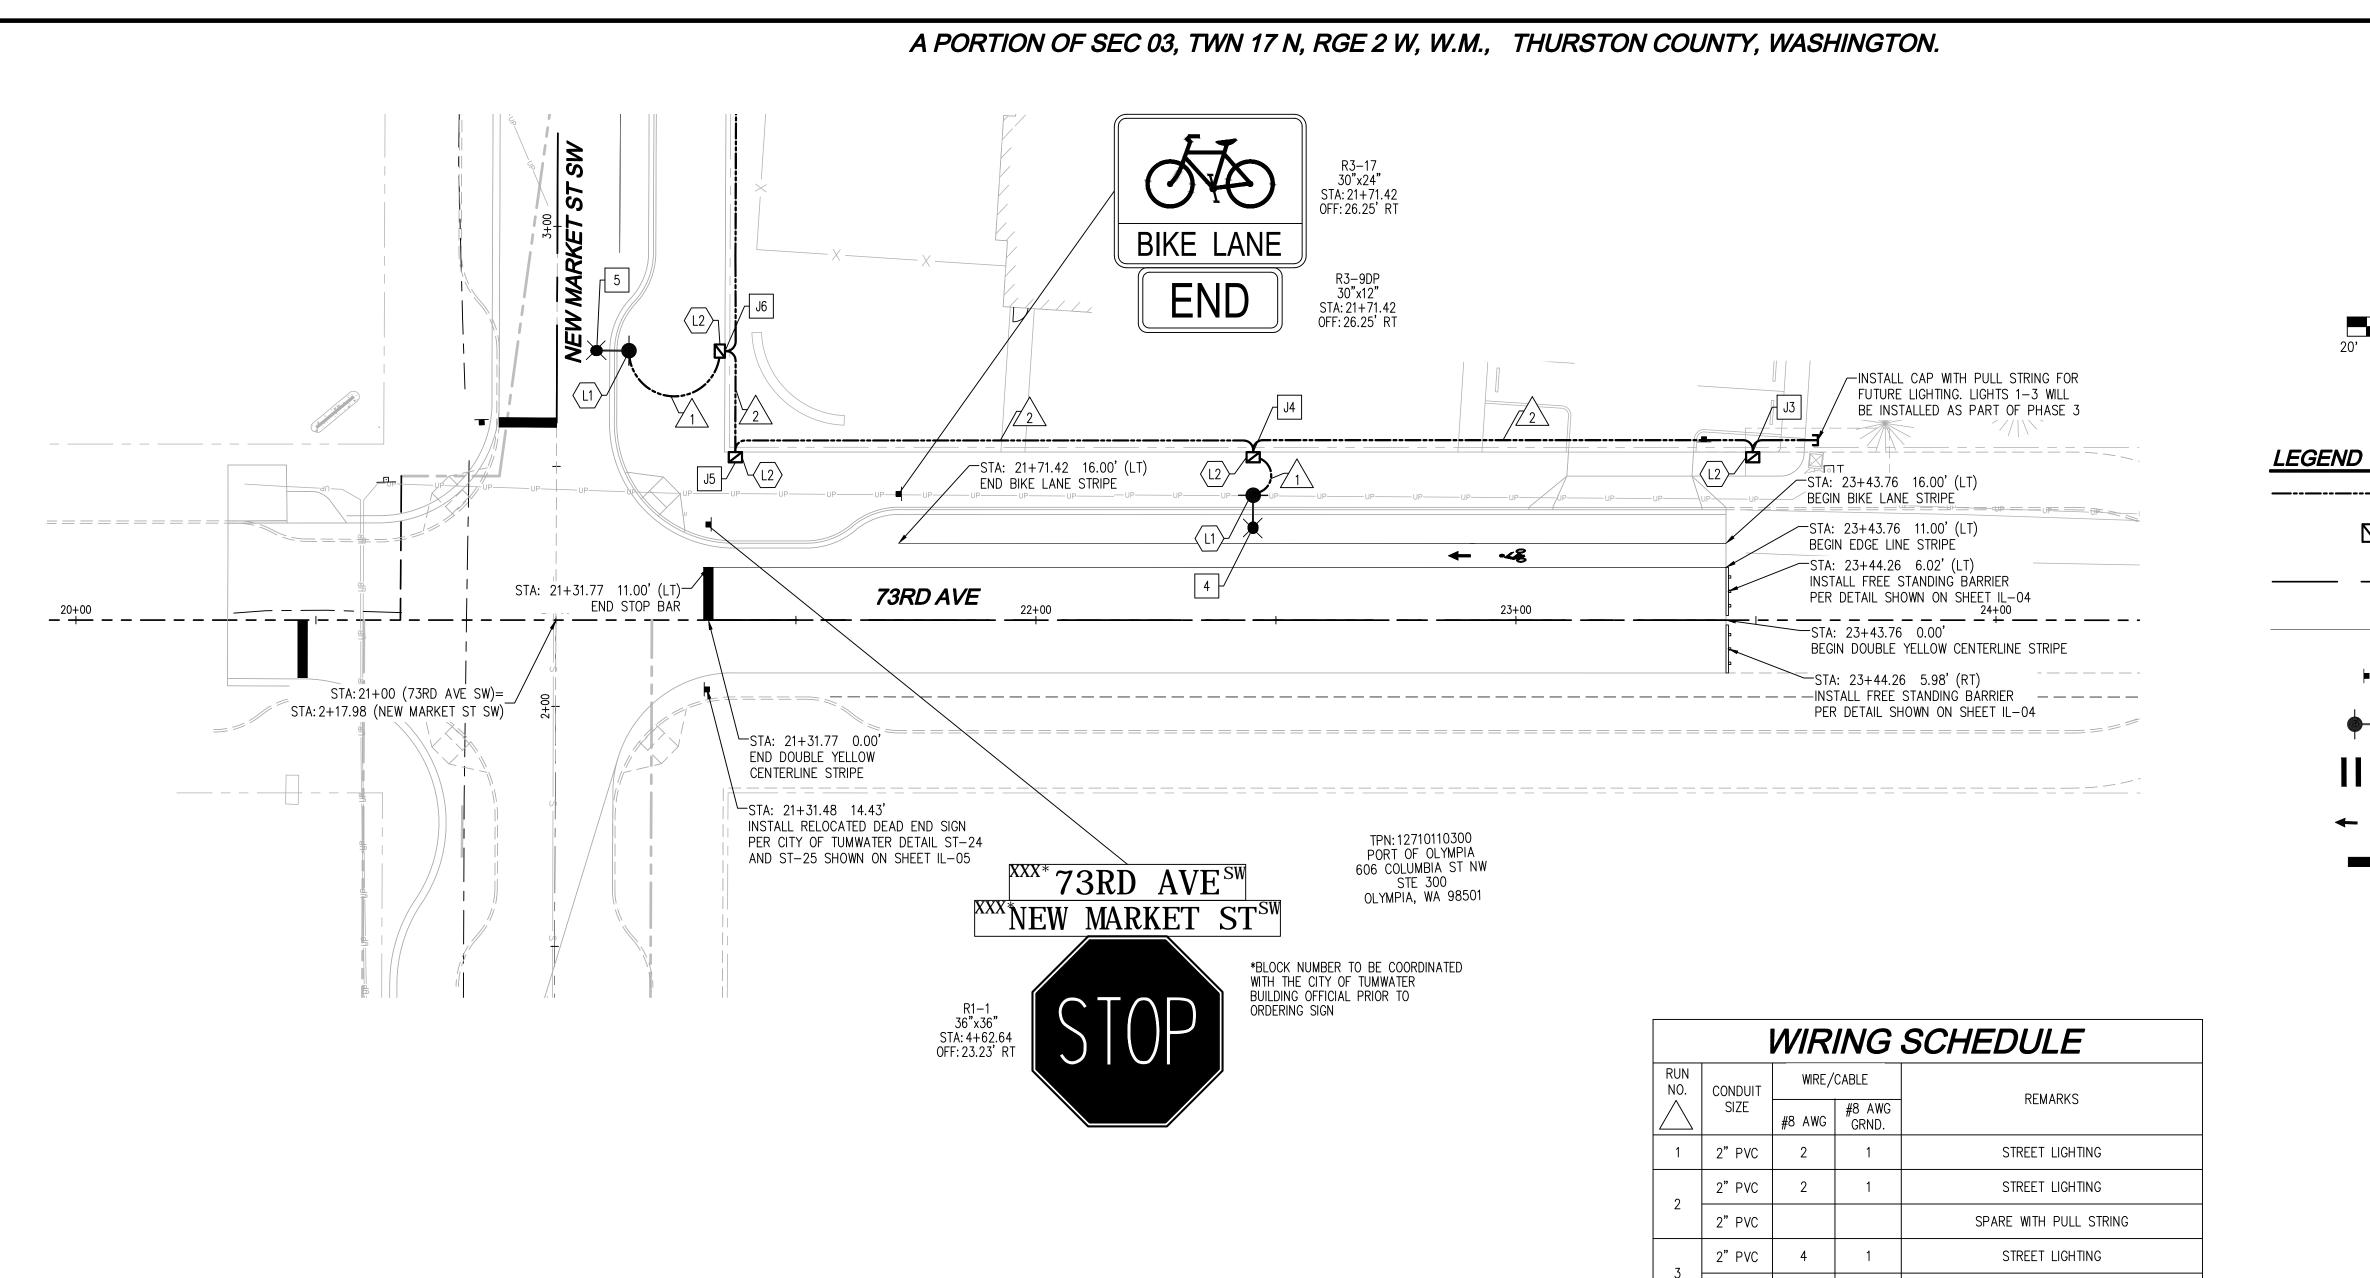

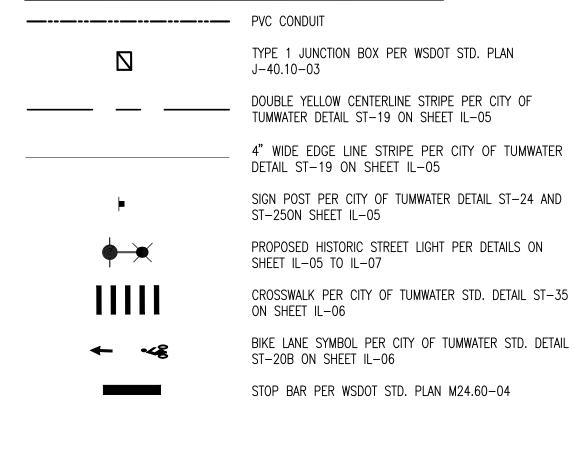

LIGHTING CONSTRUCTION NOTES

- INSTALL FOUNDATION TYPE A PER CITY OF TUMWATER STD. DETAIL INSTALL FOUNDATION TIPE A FEW OFF OF TOWNS.


 ST-14. INSTALL DECORATIVE LIGHT STANDARD PER SPECIFICATIONS. WELD J-BOX LIDS AFTER FINAL ACCEPTANCE.
- (L2) INSTALL LOCKING LID STANDARD DUTY JUNCTION BOX TYPE 1 WSDOT STANDARD PLAN J-40.10-03. ALL JUNCTION BOXES SHALL BE LOCATED PER CITY OF TUMWATER STD. DETAIL ST-13.
- $\langle L3 \rangle$ CONNECT TO EXISTING CONDUIT/J-BOX

PAVEMENT MARKING NOTES

- 1. ALL PAVEMENT MARKINGS SHALL BE METHYL METHACRYLATE (MMA) PER CITY OF TUMWATER STANDARDS.
- 2. SEE WSDOT STD. PLAN M-20.40-02 FOR INSTALLATION OF SUPPLEMENTAL RAISED PAVEMENT MARKINGS
- 3. ALL EDGE LINES ARE WHITE UNLESS OTHERWISE NOTED.
- 4. CENTER TRAFFIC ARROWS IN MIDDLE OF DESIGNATED LANE.
- 5. ALL STRIPING SHALL BE RPM'S EXCEPT FOR WHITE EDGE STRIPE (BIKE LANE) SHALL BE THERMOPLASTIC.

SIGNING NOTES

- 1. POST DIMENSION SHOWN ARE APPROXIMATE. FINAL VALUES SHALL BE DETERMINED IN THE FIELD PRIOR TO FABRICATION.
- 2. FOR CODE REFERENCES SEE WASHINGTON STATE FABRICATION MANUAL.
- 3. ALL STATIONS AND OFFSETS ARE TO POST NEAREST CENTERLINE FOR SIGNS WITH MORE THAN ONE POST.
- 4. USE TYPE ST-4 SIGN SUPPORT, PER WSDOT STANDARD PLAN G-24.50-03, FOR SIGNS WITH SINGLE POST.
- 5. USE TYPE SB-3 STEEL SIGN SUPPORT, PER WSDOT STANDARD PLAN G-24.40-04, FOR SIGNS WITH MORE THAN ONE POST.
- 6. ALL NEW SIGN SUPPORTS SHALL BE 2 INCH SQUARE STEEL 12 GAUGE TELSPAR.

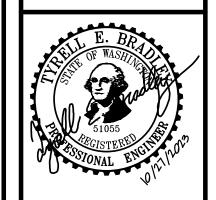

APARTMEN

MARKET

INVESTORS,

STREET

VINE

OB NUMBER:	C22-229
RAWING NAME	E: C22-229 IL-03
ESIGNER:	T. BRADLEY
RAFTING BY:	S. ORDONEZ
ATE:	OCTOBER, 2023
CALE:	AS NOTED
URISDICTION:	TUMWATER

IL-03

SHEET **39** OF **43**

DISCLAIMER TOPOGRAPHIC SURVEY INFORMATION CONTAINED ON THESE PLANS HAS BEEN PROVIDED BY HATTON GODAT PANTIER, INC. LDC, INC. (LAND DEVELOPMENT CONSULTANTS, INC.) ASSUMES NO LIABILITY AS TO THE ACCURACY AND COMPLETENESS OF THIS DATA. ANY DISCREPANCIES FOUND BETWEEN WHAT IS SHOWN ON THE PLANS AND WHAT IS NOTED IN THE FIELD SHOULD BE BROUGHT IMMEDIATELY TO THE ATTENTION OF THE

2"PVC

NO.

NOTE:

LUM SERVICE

NO.

NO.

CIRCUIT TYPE-WATTAGE-

DISTRIBUTION

LED-100 R3

LED-100 R3

UTILITY NOTE

SPARE WITH PULL STRING

BASE

TYPE/

LENGŤH

NY28-20-31 | WLC96-8 | FIXED

WLC96-8 FIXED

LIGHTING SCHEDULE

POLE SET

HEIGHT

NY28-20-31

MATERIAL SUBMITTALS FOR ALL STREET LIGHT

CONSTRUCTION SHALL BE REVIEWED/APPROVED

BY THE CITY PRIOR TO ORDERING ANY MATERIAL.

INCLUDING POLES, LIGHTS, JUNCTION

BOXES, CONDUIT, ANCHORS, ETC.

THE CONTRACTOR SHALL VERIFY THE LOCATION OF ALL EXISTING UTILITIES PRIOR TO ANY CONSTRUCTION. AGENCIES INVOLVED SHALL BE NOTIFIED WITHIN A REASONABLE TIME PRIOR TO THE START OF CONSTRUCTION.


STATION, OFFSET

22+45.25, 26.41 LT

2+74.15, 15.00 RT

Call 2 Business Days Before You Dig 811 or 1-800-424-5555 **Utilities Underground Location Center**

TUM-21-1322

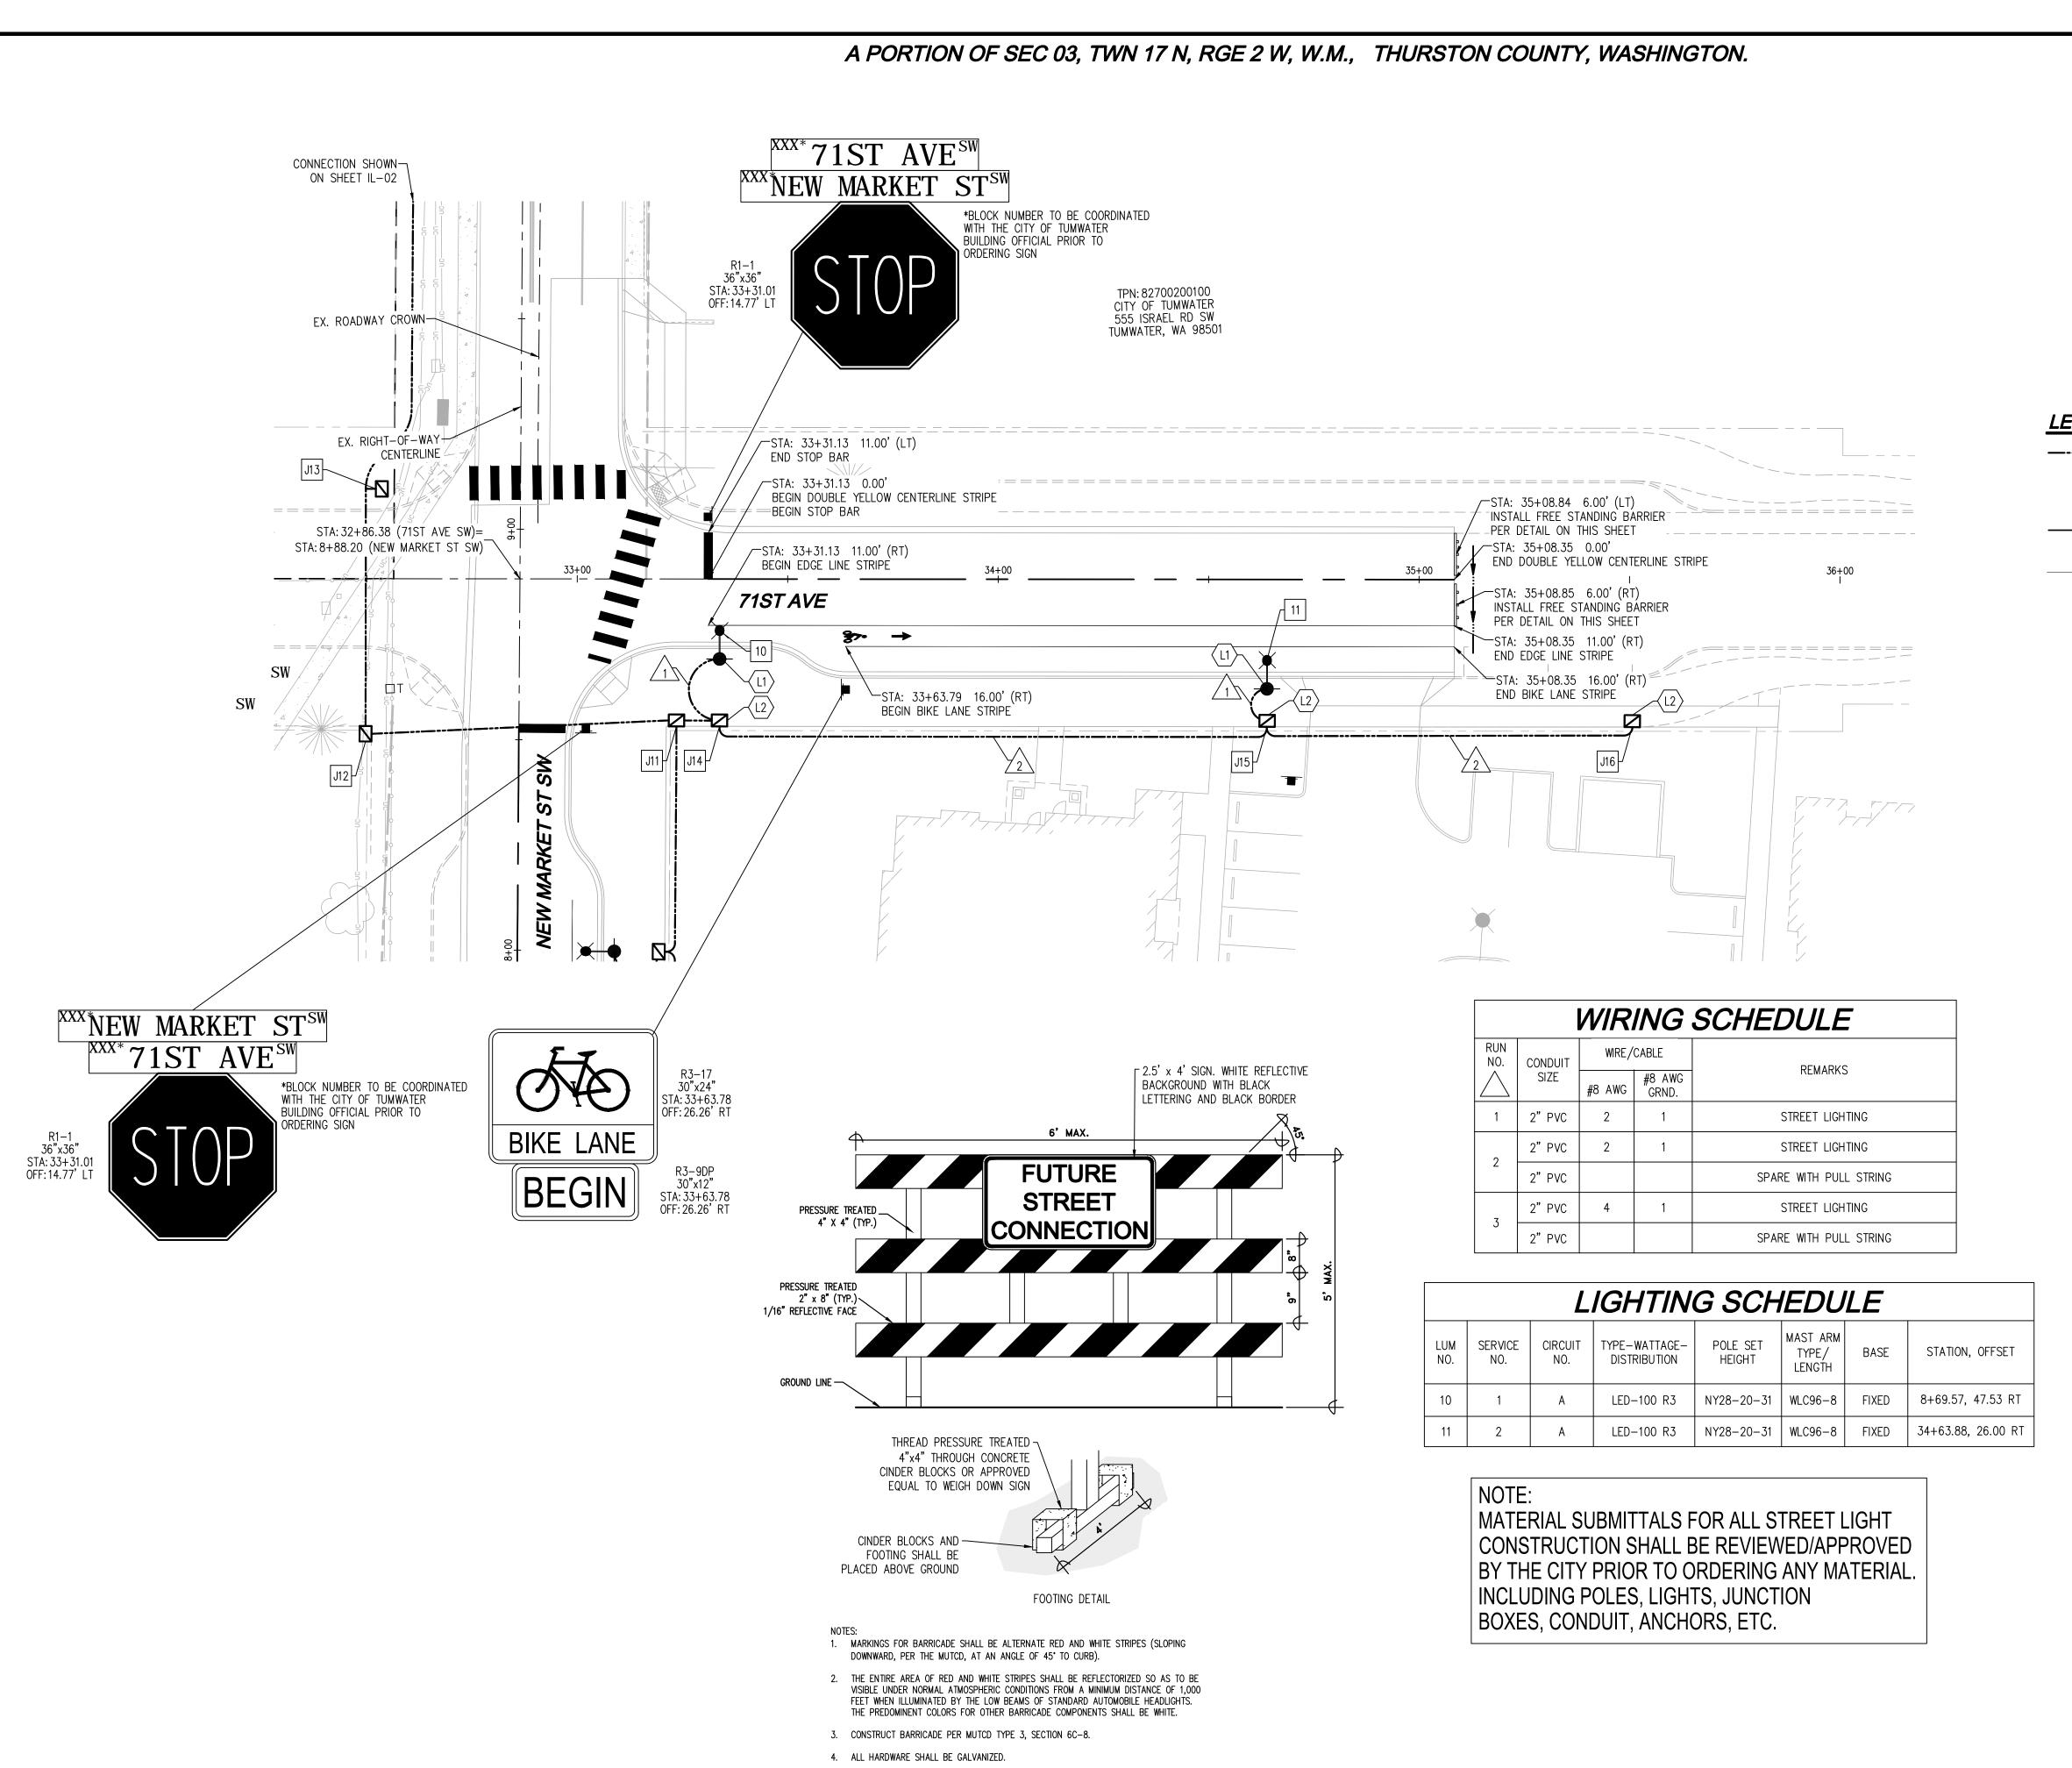

FREE STANDING BARRIER DETAIL

SCALE: 1" = 20'
20' 0 20' 40'

LEGEND

	PVC CONDUIT
	TYPE 1 JUNCTION BOX PER WSDOT STD. PLAN J-40.10-03
	DOUBLE YELLOW CENTERLINE STRIPE PER CITY OF TUMWATER DETAIL ST-19 ON SHEET IL-05
	4" WIDE EDGE LINE STRIPE PER CITY OF TUMWATER DETAIL ST-19 ON SHEET IL-05
+	SIGN POST PER CITY OF TUMWATER DETAIL ST-24 AND ST-250N SHEET IL-05
•	PROPOSED HISTORIC STREET LIGHT PER DETAILS ON SHEET IL-05 TO IL-07
ШШ	CROSSWALK PER CITY OF TUMWATER STD. DETAIL ST-35 ON SHEET IL-06
← •Æ	BIKE LANE SYMBOL PER CITY OF TUMWATER STD. DETAIL ST-20B ON SHEET IL-06

STOP BAR PER WSDOT STD. PLAN M24.60-04

LIGHTING CONSTRUCTION NOTES

- INSTALL FOUNDATION TYPE A PER CITY OF TUMWATER STD. DETAIL ST-14. INSTALL DECORATIVE LIGHT STANDARD PER SPECIFICATIONS WELD J-BOX LIDS AFTER FINAL ACCEPTANCE.
- L2 INSTALL LOCKING LID STANDARD DUTY JUNCTION BOX TYPE 1 WSDOT STANDARD PLAN J-40.10-03. ALL JUNCTION BOXES SHALL BE LOCATED PER CITY OF TUMWATER STD. DETAIL ST-13.
- (L3) CONNECT TO EXISTING CONDUIT/J-BOX

PAVEMENT MARKING NOTES

- 1. ALL PAVEMENT MARKINGS SHALL BE METHYL METHACRYLATE (MMA) PER CITY OF TUMWATER STANDARDS.
- 2. SEE WSDOT STD. PLAN M-20.40-02 FOR INSTALLATION OF SUPPLEMENTAL RAISED PAVEMENT MARKINGS
- 3. ALL EDGE LINES ARE WHITE UNLESS OTHERWISE NOTED.
- 4. CENTER TRAFFIC ARROWS IN MIDDLE OF DESIGNATED LANE.
- 5. ALL STRIPING SHALL BE RPM'S EXCEPT FOR WHITE EDGE STRIPE (BIKE LANE) SHALL BE THERMOPLASTIC.

SIGNING NOTES

- 1. POST DIMENSION SHOWN ARE APPROXIMATE. FINAL VALUES SHALL BE DETERMINED IN THE FIELD PRIOR TO FABRICATION.
- 2. FOR CODE REFERENCES SEE WASHINGTON STATE FABRICATION MANUAL.
- 3. ALL STATIONS AND OFFSETS ARE TO POST NEAREST CENTERLINE FOR SIGNS WITH MORE THAN ONE POST.
- 4. USE TYPE ST-4 SIGN SUPPORT, PER WSDOT STANDARD PLAN
- G-24.50-03, FOR SIGNS WITH SINGLE POST.

 5. USE TYPE SB-3 STEEL SIGN SUPPORT, PER WSDOT STANDARD PLAN
- G-24.40-04, FOR SIGNS WITH MORE THAN ONE POST.
- 6. ALL NEW SIGN SUPPORTS SHALL BE 2 INCH SQUARE STEEL 12 GAUGE TELSPAR.



JURISDICTION: TUMWATE

DRAWING NAME: C22-229 IL-

DRAFTING BY: S. ORDONE

T. BRADLE

AS NOTE

OCTOBER, 2

JOB NUMBER:

DESIGNER:

SCALE:

APARTMEN

Ì

INVESTORS,

SHEET **40** OF **43**

TUM-21-1322

DISCLAIMER
TOPOGRAPHIC SURVEY INFORMATION CONTAINED ON

TOPOGRAPHIC SURVEY INFORMATION CONTAINED ON THESE PLANS HAS BEEN PROVIDED BY HATTON GODAT PANTIER, INC. LDC, INC. (LAND DEVELOPMENT CONSULTANTS, INC.) ASSUMES NO LIABILITY AS TO THE ACCURACY AND COMPLETENESS OF THIS DATA. ANY DISCREPANCIES FOUND BETWEEN WHAT IS SHOWN ON THE PLANS AND WHAT IS NOTED IN THE FIELD SHOULD BE BROUGHT IMMEDIATELY TO THE ATTENTION OF THE

UTILITY NOTE

THE CONTRACTOR SHALL VERIFY THE LOCATION OF ALL EXISTING UTILITIES PRIOR TO ANY CONSTRUCTION.
AGENCIES INVOLVED SHALL BE NOTIFIED WITHIN A REASONABLE TIME PRIOR TO THE START OF CONSTRUCTION.



Utilities Underground Location Center

ALL LUMINAIRES SHALL BE LED.

#10-2 WIRE TRAY CABLE

FUSED CONNECTOR KIT

(MODEL SEC 1791-SF)


EQUIPMENT GROUND,


FROM SERVICE TO EACH POLE -

WITH 18" MIN SLACK

CITY OF TUMWATER GENERAL NOTES STREET LIGHT CONSTRUCTION

- 1. ALL WORKMANSHIP, MATERIALS AND TESTING SHALL BE IN ACCORDANCE WITH THE MOST CURRENT WASHINGTON STATE DEPARTMENT OF TRANSPORTATION/AMERICAN PUBLIC WORK ASSOCIATION STANDARD SPECIFICATIONS FOR ROAD, BRIDGE, AND MUNICIPAL CONSTRUCTION, NATIONAL ELECTRICAL CODE AND CITY OF TUMWATER DEVELOPMENT GUIDE MANUAL UNLESS OTHERWISE SPECIFIED BELOW. IN CASES OF CONFLICT, THE MOST STRINGENT GUIDELINE SHALL APPLY. WHEN THE MOST STRINGENT GUIDELINE IS NOT CLEAR, THE CITY ENGINEER WILL MAKE THE DETERMINATION. THE ELECTRICAL CONTRACTOR SHALL -24 BE FAMILIAR WITH ALL ABOVE-STATED PUBLICATIONS AND GUIDELINES AS THEY WILL BE STRICTLY ENFORCED BY THE CITY.
- 2. ALL SAFETY STANDARDS AND REQUIREMENTS SHALL BE COMPLIED WITH AS SET FORTH BY THE STATE OF WASHINGTON, DEPARTMENT OF LABOR AND INDUSTRIES.
- 3. THE CONTRACTOR SHALL BE RESPONSIBLE FOR ALL TRAFFIC CONTROL IN ACCORDANCE WITH THE MANUAL ON UNIFORM TRAFFIC CONTROL DEVICES. PRIOR TO DISRUPTION OF ANY TRAFFIC, TRAFFIC CONTROL PLANS SHALL BE PREPARED AND SUBMITTED TO THE CITY FOR APPROVAL. (SEE WSDOT STANDARD PLANS K2-K21.) NO WORK SHALL COMMENCE UNTIL ALL APPROVED TRAFFIC CONTROL IS IN PLACE.
- 4. A PRE-CONSTRUCTION MEETING SHALL BE HELD WITH THE CITY OF TUMWATER PRIOR TO THE START OF CONSTRUCTION. CONTACT THE DEVELOPMENT SERVICES DEPARTMENT TO SCHEDULE A MEETING.
- 5. ALL APPROVALS AND PERMITS REQUIRED BY THE CITY OF TUMWATER SHALL BE OBTAINED BY THE CONTRACTOR PRIOR TO THE START OF CONSTRUCTION.
- 6. IT SHALL BE THE RESPONSIBILITY OF THE CONTRACTOR TO HAVE A COPY OF AN APPROVED SET OF PLANS ON THE CONSTRUCTION SITE AT ALL TIMES.
- 7. ALL PROJECT STAKING SHALL BE PERFORMED BY QUALIFIED SURVEY PERSONNEL WORKING UNDER THE DIRECT SUPERVISION OF A PROFESSIONAL LAND SURVEYOR OR PROFESSIONAL CIVIL ENGINEER LICENSED BY THE STATE OF WASHINGTON. IN CASES WHERE THE WORK INCLUDES THE SETTING OR PERPETUATION OF STREET MONUMENTATION, THE SETTING OR REPLACEMENT OF LAND CORNERS, OR ANY OTHER WORK REQUIRING THE SERVICES OF A PROFESSIONAL LAND SURVEYOR AS DEFINED BY THE LAWS OF THE STATE OF WASHINGTON, SAID WORK SHALL BE DONE UNDER THE DIRECT SUPERVISION OF A PROFESSIONAL LAND SURVEYOR LICENSED IN THE STATE OF WASHINGTON.
- 8. TEMPORARY EROSION CONTROL/WATER POLLUTION MEASURES SHALL BE REQUIRED IN ACCORDANCE WITH SECTION 1-07.15 OF THE WSDOT/APWA STANDARD SPECIFICATIONS AND THE DRAINAGE DESIGN AND EROSION CONTROL MANUAL FOR THURSTON REGION WASHINGTON. AT NO TIME WILL SILTS AND DEBRIS BE ALLOWED TO DRAIN INTO A EXISTING OR NEWLY INSTALLED FACILITY.
- 9. IF CONSTRUCTION IS TO TAKE PLACE IN THE COUNTY RIGHT-OF-WAY, THE CONTRACTOR SHALL NOTIFY THE COUNTY AND OBTAIN ALL THE REQUIRED APPROVALS AND PERMITS.
- 10. THE CONTRACTOR SHALL BE FULLY RESPONSIBLE FOR THE LOCATION AND PROTECTION OF ALL EXISTING UTILITIES. THE CONTRACTOR SHALL VERIFY ALL UTILITY LOCATIONS PRIOR TO CONSTRUCTION BY CALLING THE UNDERGROUND LOCATE LINE AT 1-800-424-5555 A MINIMUM OF 48 HOURS PRIOR TO ANY EXCAVATION. THE CONTRACTOR WILL ALSO BE RESPONSIBLE FOR MAINTAINING ALL LOCATE MARKS ONCE THE UTILITIES HAVE BEEN LOCATED.
- 11.ELECTRICAL PERMITS AND INSPECTIONS ARE REQUIRED FOR ALL STREET LIGHTING INSTALLATIONS WITHIN THE CITY OF TUMWATER. THE CONTRACTOR IS RESPONSIBLE FOR OBTAINING SAID PERMITS PRIOR TO ANY TYPE OF ACTUAL CONSTRUCTION. THESE PERMITS ARE AVAILABLE FROM THE WASHINGTON STATE DEPARTMENT OF LABOR AND INDUSTRIES ELECTRICAL SAFETY DIVISION.
- 12. PRIOR TO INSTALLATION OF ANY MATERIALS, THE ELECTRICAL CONTRACTOR SHALL SUBMIT FOR APPROVAL BY THE CITY TWO COPIES OF MATERIAL CATALOG CUTS, SPECIFICATIONS, SHOP DRAWINGS AND/OR WIRING DIAGRAMS. ANY MATERIALS PURCHASED OR LABOR PERFORMED PRIOR TO SUCH APPROVAL SHALL BE AT THE CONTRACTOR'S RISK. MOUNTING HEIGHTS, ARM LENGTH, POWER SOURCE, LUMINAIRE TYPE AND BOLT PATTERNS SHALL FOLLOW CITY OF TUMWATER DEVELOPMENT GUIDE MANUAL SECTION 4.31. MODIFICATIONS OF ANY PORTION OF AN EXISTING LIGHTING SYSTEM WILL NOT BE ALLOWED WITHOUT PRIOR APPROVAL BY THE CITY.
- 13.A RATED SERVICE DISCONNECT SHALL BE PROVIDED FOR EVERY BRANCH CIRCUIT. LIGHT BRANCH CIRCUIT BREAKERS SHALL BE 40 AMP MINIMUM. THE LOCATION AND INSTALLATION OF THE DISCONNECT SHALL CONFORM TO THE NATIONAL ELECTRIC CODE (NEC) AND CITY OF TUMWATER STANDARDS. THE SERVICE DISCONNECT SHALL BE OF A TYPE EQUAL TO A "MYERS" MEUGL-M100C-UM OR A "UNICORN" CPIIIB-0111A SERVICE, 120/240 VAC, CALTRANS TYPE 3B OR CITY APPROVED EQUAL, WITH TWO LIGHTING RELAYS, ONE THREE POSITION TEST SWITCH (AUTO/OFF/MANUAL) AND ONE PHOTOCELL. THE PHOTOCELL SHALL FACE NORTH UNLESS OTHERWISE DIRECTED BY THE CITY. (SEE GUIDELINE DRAWING
- 14. SERVICE ENTRANCE CONDUCTORS SHALL BE A MINIMUM SIZE OF #2 COPPER. ALL LIGHTING
- WIRE SHALL BE STRANDED COPPER WITH A MINIMUM SIZE OF #8 WITH INSULATION SUITABLE FOR WET LOCATIONS. PHASING TAPE WILL NOT BE ALLOWED. ALL WIRE SHALL BE INSTALLED IN SCHEDULE 40 PVC CONDUIT WITH A MINIMUM DIAMETER OF 1-1/4 INCHES. ALL CONDUIT SHALL BE INSTALLED IN THE "UTILITY DITCH" OR AS OTHERWISE DIRECTED BY THE CITY. A BUSHING OR BELL END SHALL BE USED AT THE END OF EVERY CONDUIT. ALL SPLICES SHALL BE IN THE NEAREST JUNCTION BOX. WIRE NUTS WILL NOT BE ALLOWED. ALL SPLICES WILL BE MADE WITH TYPE C COPPER FITTINGS, CENTERED AND ENCASED IN A 3-M SCOTCHCAST EPOXY KIT. RATED AT 600 VOLTS. TYPE 82-A1. 82-B1 OR CITY APPROVED EQUAL. IF MORE THAN ONE CIRCUIT PASSES THROUGH A JUNCTION BOX EACH IS TO HAVE A PCV SLEEVE CLEARLY IDENTIFYING THE CIRCUIT. (WSDOT STANDARD SPECIFICATION 8-20.3).
- A 500 VOLT MEGGER TEST WILL BE PERFORMED BY THE CITY ON EACH CIRCUIT BETWEEN CONDUCTOR AND GROUND PRIOR TO ACCEPTANCE OF THE LIGHTING SYSTEM. THE INSULATION RESISTANCE SHALL NOT BE LESS THAN 6 MEGAOHMS TO GROUND 2,500 FEET AND OVER NOR LESS THAN 8 MEGAOHMS UNDER 2,500 FEET. A FUNCTIONAL TEST WILL BE PERFORMED BY THE CITY, IN WHICH IT IS DEMONSTRATED THAT EACH AND EVERY PART OF THE SYSTEM FUNCTIONS AS SPECIFIED OR INTENDED HEREIN. (WSDOT STANDARD SPECIFICATIONS 8-20.3(11)
- 15.EACH LUMINAIRE POLE SHALL HAVE AN IN-LINE, FUSED, WATER-TIGHT ELECTRICAL DISCONNECT LOCATED AT THE BASE OF THE POLE. ACCESS TO THESE FUSED DISCONNECTS 4-26 SHALL BE THROUGH THE HAND-HOLE ON THE POLE. THE HAND-HOLE SHALL BE FACING AWAY FROM ON-COMING TRAFFIC. LOAD SIDE OF IN-LINE FUSE TO LUMINAIRE HEAD SHALL BE CABLE AND POLE BRACKET WIRE, 2 CONDUCTOR, 19 STRAND COPPER #10 AND SHALL BE SUPPORTED AT THE END OF THE LUMINAIRE ARM BY AN APPROVED MEANS. FUSE SIZE, DISCONNECT INSTALLATION AND GROUNDING IN POLE SHALL CONFORM TO WSDOT STANDARDS.
- 16. CITY-APPROVED PULL BOXES OR JUNCTION BOXES SHALL BE INSTALLED PER WSDOT STANDARD PLAN J-11A IN ALL STREET LIGHTING INSTALLATIONS. JUNCTION BOXES SHALL BE INCORPORATED INTO THE BACK EDGE OF SIDEWALK OR AS DIRECTED BY CITY. WHERE NO SIDEWALKS EXISTS, JUNCTION BOXES SHALL HAVE A CONCRETE PAD PER TUMWATER DRAWING ST-22. NO CONDUIT RUN SHALL BE MORE THAN 200 FEET BETWEEN JUNCTION BOXES. A JUNCTION BOX SHALL BE LOCATED WITHIN 10 FEET OF EACH LUMINAIRE POLE AND AT EVERY ROAD CROSSING. NO CONDUIT SHALL BE
- INSTALLED IN THE ROADWAY EXCEPT AT DESIGNATED ROAD CROSSINGS. CONDUIT ENTERING THE JUNCTION BOX SHALL BE PERPENDICULAR TO THE SIDES OF THE BOX AND A MINIMUM OF 6 BUT NO MORE THAN 8 INCHES BELOW THE LID. BOXES SHALL BE CLEARLY AND INDELIBLY MARKED AS LIGHTING BOXES BY THE LEGEND "L.T." OR "LIGHTING". ALL J-BOXES SHALL BE SUPPORTED BY A MINIMUM 6 INCH CRUSHED GRAVEL PAD. A 3/8 INCH EXPANSION JOINT SHALL BE INSTALLED BETWEEN CONCRETE SIDEWALK AND JUNCTION BOX.
- 17. ALL LIGHTING POLES SHALL BE AS SPECIFIED IN SECTION 4.31 OF THE DEVELOPMENT GUIDE MANUAL. IN EXISTING DEVELOPED AREAS, THE CITY MAY REQUIRE THE USE OF OTHER POLES TO ESTABLISH UNIFORMITY WITHIN THE DEVELOPED AREA. AFTER INSTALLATION AND BEFORE ACCEPTANCE BY THE CITY, ALL POLES SHALL BE FREE OF DENTS AND MARKS. SONOTUBE SHALL BE REMOVED TO BELOW GROUND LEVEL. POLE BASES SHALL BE GROUTED AND ALL LUMINAIRE HEADS SHALL BE PLUMB AND LEVEL.
- 18. CEMENT CONCRETE BASES SHALL FOLLOW CITY OF TUMWATER DEVELOPMENT GUIDE MANUAL DRAWING ST-25 LUMINAIRE FOUNDATION DETAIL. CONDUIT SHALL EXTEND BETWEEN 3 AND 6 INCHES ABOVE THE CONCRETE BASE.
- 19. ANY MODIFICATION TO APPROVED LIGHTING PLANS SHALL BE REVIEWED AND APPROVED BY THE CITY PRIOR TO INSTALLATION. ANY APPROVED MODIFICATIONS SHALL BE SHOWN ON A MYLAR ASBUILT SUPPLIED TO THE CITY AFTER THE LIGHTING INSTALLATION IS COMPLETED AND BEFORE FINAL ACCEPTANCE. IT SHALL BE THE RESPONSIBILITY OF THE ELECTRICAL CONTRACTOR TO ENSURE THESE ASBUILTS ARE PROVIDED TO THE CITY.

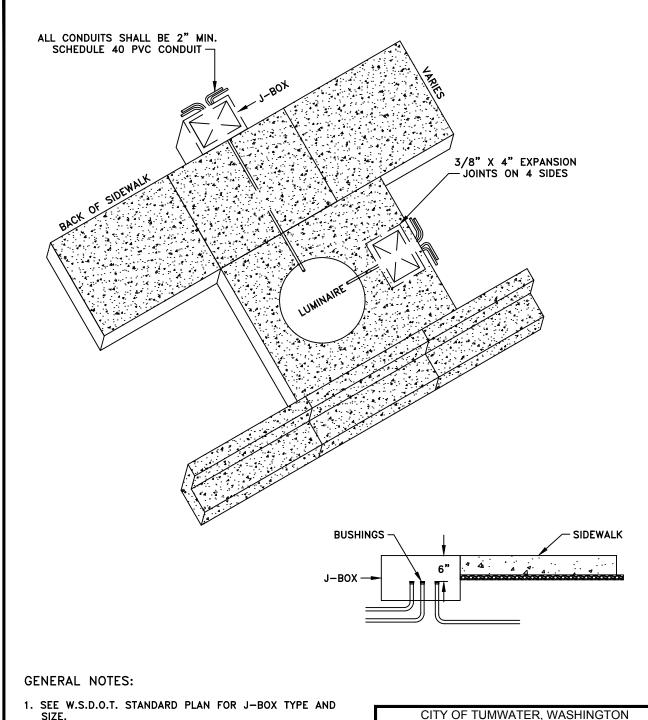

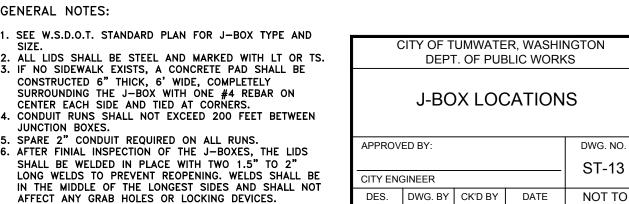

BELL END

– 14" x∥14" \$QUARE

POLE BASE TOP SECTION

POLE CENTERED IN

PLANTER STRIP

SQUARE OR ROUND

THE FOUNDATION IS DESIGNED FOR 2000 PSF AVERAGE

2. BOLT PATTERN PER MANUFACTURER'S SPECIFICATIONS.

3. FOR DETAILS NOT SHOWN, USE MANUFACTURER'S

SOIL LATERAL BEARING PRESSURE.

4. FOUNDATION HOLES SHALL BE AUGERED.

NO MORE THAN -2 THREADS

LEVELING NUTS -


LEVELING NUTS -

OF POLE BASE SHALL

GENERAL NOTES:

BE 3" ABOVE

TOP OF CURB-

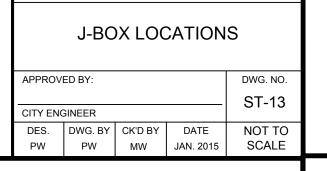

✓ HOLLOW

← 6" CSTC

CONDUIT TO POLE BASE

APPROVED BY:

ITY FNGINFER

PW

-8-#7 VERTICAL REBARS

CENTERS

2" CLEARANCE

HORIZONTAL REBARS 1' ON

EVËNLY SPACED AND 6-#4

SHRINKLESS GROUT

-3/8" WEEP HOLE

- SIDEWALK

- 2" CONDUITS AT A

MINIMUM OF 2-2"


CONDUITS PER

CITY OF TUMWATER, WASHINGTON

DEPT. OF PUBLIC WORKS

LUMINAIRE FOUNDATION

DES. DWG. BY CK'D BY DATE

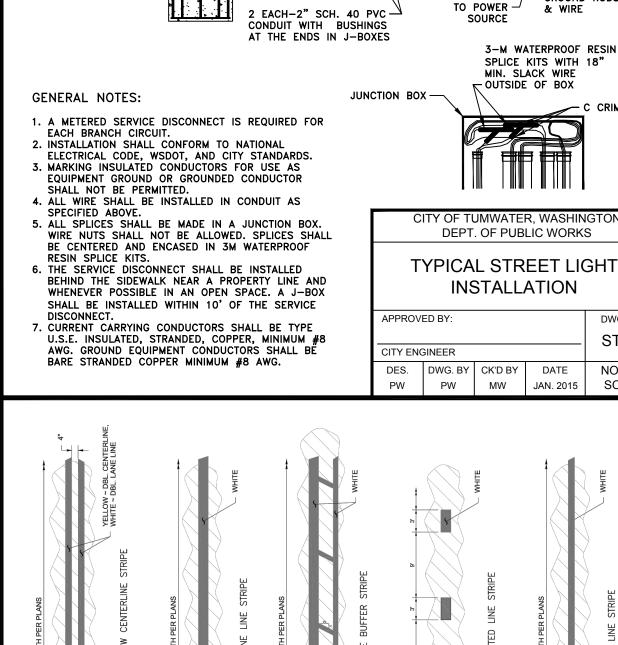

ADDITIONAL NOTES:

BY THE CITY ENGINEER.

- JUNCTION BOX -

HOLE

1. MILBANK CABINET SHALL BE ORIENTED AS DIRECTED

3. THE CONDUIT AND WIRING FOR THE POWER SOURCE

COLLECTORS THERE SHALL BE 1 CIRCUIT FOR THE

5. MILBANK PHOTO CELL SHALL BE UNOBSTRUCTED.


RIGHT AND 1 CIRCUIT FOR THE LEFT SIDE OF THE

CABINE

SHALL MEET PUGET SOUND ENERGY REQUIREMENTS.


2. NO MORE THAN 3 CIRCUITS PER CONDUIT

4. ON ARTERIALS, BOULEVARDS AND MAJOR

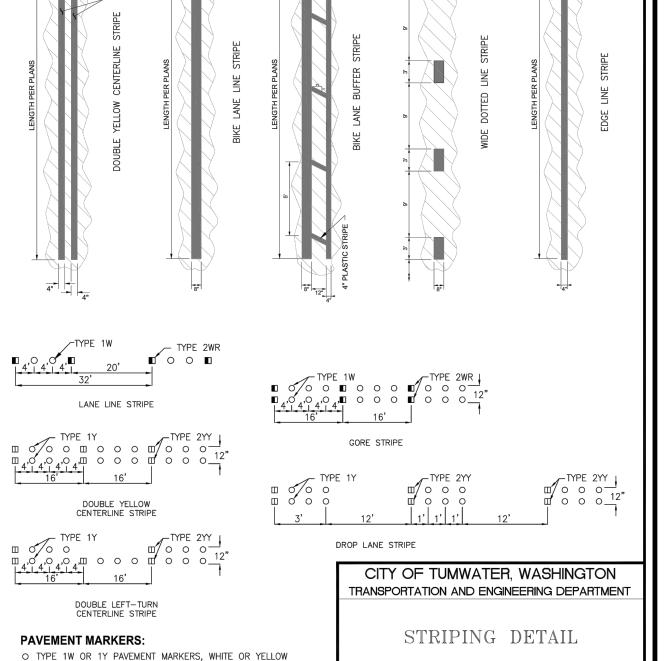

APPROVED

ENGINEERING SERVICES MANAGER

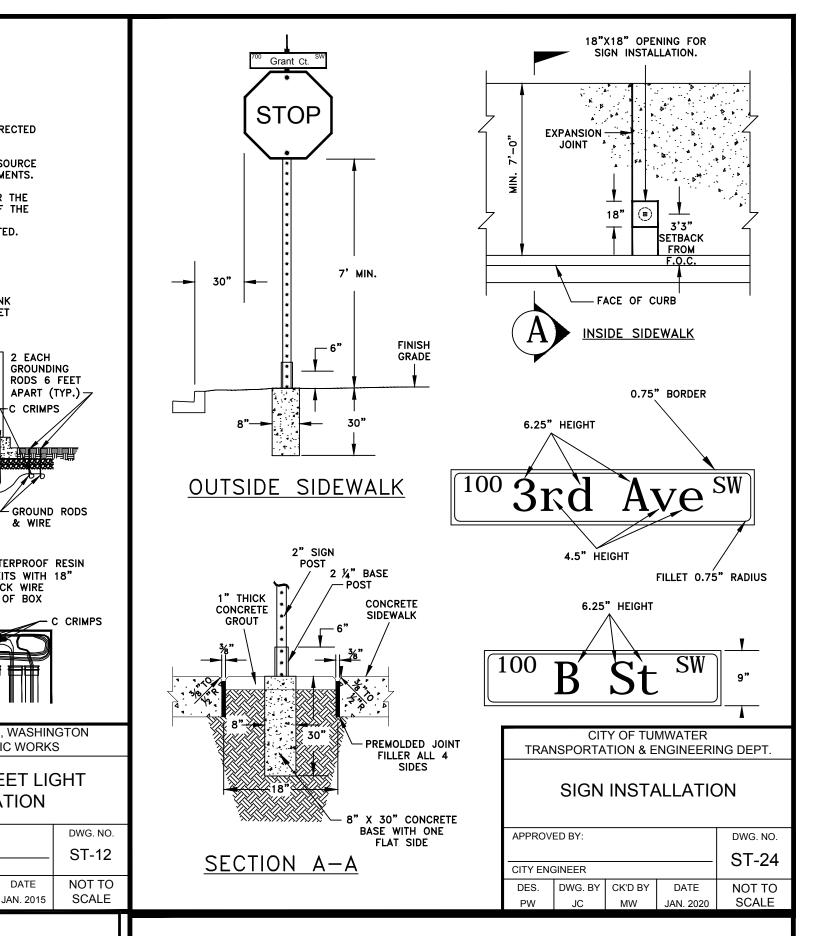



- ALL SIGNS SHALL MEET REQUIREMENTS OF THE MUTCD, LATEST EDITION.
- ALL STREET NAME SIGNS SHALL BE 9" TALL AND HAVE EXTRUDED BLADE EDGES ALL SIGN SHEETING, WITH THE EXCEPTION OF CROSSWALK SIGNS, SHALL BE 3M HIGH INTENSITY PRISMATIC SHEETING WITH THE FOLLOWING SERIES NUMBER: WHITE-3930, YELLOW-3931, RED-3932, ORANGE-3934. BLUE-3935. GREEN-3937 OR BROWN-3939 IF A REVERSE LAY PROCESS IS USED, 3M ELECTROCUT FILM SHALL BE USED WITH THE FOLLOWING SERIES NUMBER: YELLOW-1171, RED-1172, ORANGE-1174, BLUE-1175, GREEN-1177, BLACK-1178 OR BROWN-1179. A 0.75" BORDER IN WHITE-3930 SHOULD BE PROVIDED PER DETAIL ST-24. CROSSWALK SIGNS SHALL BE 3M DIAMOND GRADE DG3 SHEETING SERIES 4083 FLUORESCENT
- ALL SIGNS, WITH THE EXCEPTION OF STREET NAME, SHALL BE COVERED WITH 3M GRAFFITI FILM
- ALL PUBLIC STREET NAME SIGNS WILL HAVE A GREEN BACKGROUND.
- ALL PRIVATE STREET NAME SIGNS WILL HAVE BLUE BACKGROUND. PUBLIC STREET NAME SIGN SHALL BE ON TOP AND PRIVATE ON THE BOTTOM.
- ALL STREET NAME SIGNS SHALL INCLUDE 3.5" TALL BLOCK NUMBERS IN THE UPPER LEFT HAND CORNER (AVAILABLE FROM THE BUILDING OFFICIAL IN THE COMMUNITY DEVELOPMENT DEPARTMENT), S.E. OR S.W. DIRECTION IN THE UPPER RIGHT HAND CORNER AND SUFFIX SUCH AS "St OR "Rd" USING THE UNITED STATES POSTAL SERVICE STANDARD SUFFIX ARREVIATION
- STREET NAME SIGNS SHALL BE MOUNTED TO THE POST USING A 12" LONG, EXTRUDED BLADE SIGN CROSS AND/OR A 12" LONG, SQUARE TOP, EXTRUDED BLADE SIGN BRACKET.
- ALL SIGNS SHALL BE MOUNTED TO 2" TELESPAR SIGN SUPPORTS WITH HOT-DIPPED GALVANIZED FINISH, PRE-PUNCHED POSTS, LONG ENOUGH TO ACCOMMODATE 2' INTO THE BASE AND STILL ACHIEVE A MINIMUM SIGN HEIGHT OF 7'.
- BASE POST SHALL BE 36" LONG AND PRECAST IN AN 8" DIAMETER, 30" LONG, CONCRETE BASE, ONE SIDE FLAT TO PREVENT SIGN ROTATION IN GROUND ONCE INSTALLED. POST WILL NEED TO SLIDE IN THE ENTIRE LENGTH OF THE BASE POST FOR SIGN HEIGHT ADJUSTMENT. ANY SIGN BASE INSTALLED UNDER CONCRETE SHALL UTILIZE A "HOA" (HEAVY DUTY ANCHOR) BASE SLEEVE OF 7 GAUGE SOLID WALL. TWO-HOLE ANCHOR FOR THE TELESPAR POSTS.
- FASTENERS FOR SIGN TO POST WILL BE 3/8" ALUMINUM DRIVE RIVETS WITH NYLON BACK SPACER. FASTENERS FOR POST TO BASE WILL BE 3/8" DRIVE RIVETS ONLY. NO BOLTS, NUTS, SCREWS OR
- MATERIALS MAY BE ACQUIRED AT, BUT ARE NOT LIMITED TO
- ZUMAR INDUSTRIES, 12015 STEELE ST. S, TACOMA, WA 98445. 1-800-426-7967 TRAFFIC SAFETY SUPPLY CO., 2324 SE UMATILLA ST., PORTLAND, OR 97202. 1-800-547-8518 PACIFIC COAST PRECAST, 4928 SHINCKE RD. NE OLYMPIA, WA. 98506. 360-352-0142
- TREES AND LANDSCAPING SHALL BE PLANTED AT LEAST 30' AWAY FROM SIGNS TO GIVE ADEQUATE ADVANCED SIGN VISIBILITY.

ANY QUESTIONS SHOULD BE DIRECTED TO THE CITY OF TUMWATER SIGN SHOP @ 360-754-4150

TRANSPORTATION & ENGINEERING DEPT.							
SIGN INSTALLATION NOTES							
APPROV	DWG. NO.						
	CITY ENGINEER						
CITY ENG							
DES.	DWG. BY	CK'D BY	DATE	NOT TO			
PW	JC	MW	JAN. 2020	SCALE			

CITY OF TUMWATER

DISCLAIMER

■ TYPE 2WR REFLECTIVE PAVEMENT MARKER, WHITE AND RED

□ TYPE 2YY REFLECTIVE PAVEMENT MARKER, YELLOW AND YELLOW

□ TYPE 2W REFLECTIVE PAVEMENT MARKER, WHITE-ONE SIDE ONLY

TOPOGRAPHIC SURVEY INFORMATION CONTAINED ON THESE PLANS HAS BEEN PROVIDED BY HATTON GODAT PANTIER. INC. LDC. INC. (LAND DEVELOPMENT CONSULTANTS, INC.) ASSUMES NO LIABILITY AS TO THE ACCURACY AND COMPLETENESS OF THIS DATA. ANY DISCREPANCIES FOUND BETWEEN WHAT IS SHOWN ON THE PLANS AND WHAT IS NOTED IN THE FIELD SHOULD BE BROUGHT IMMEDIATELY TO THE ATTENTION OF THE

UTILITY NOTE

DWG. NO.

AUG 2020

DATE


BH

THE CONTRACTOR SHALL VERIFY THE LOCATION OF ALL EXISTING UTILITIES PRIOR TO ANY CONSTRUCTION. AGENCIES INVOLVED SHALL BE NOTIFIED WITHIN A REASONABLE TIME PRIOR TO THE START OF CONSTRUCTION.



RTME ORS

ΙШ 4 ARKE $\sum_{i=1}^{n}$

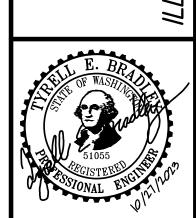


JOB NUMBER: DRAWING NAME: C22-229 IL DESIGNER: T. BRADL DRAFTING BY: S. ORDONE OCTOBER, 2 ISCALE: AS NOT JURISDICTION: TUMWATE

DWG. NO

ST-14

NOT TO

MW JAN. 2015 SCALE

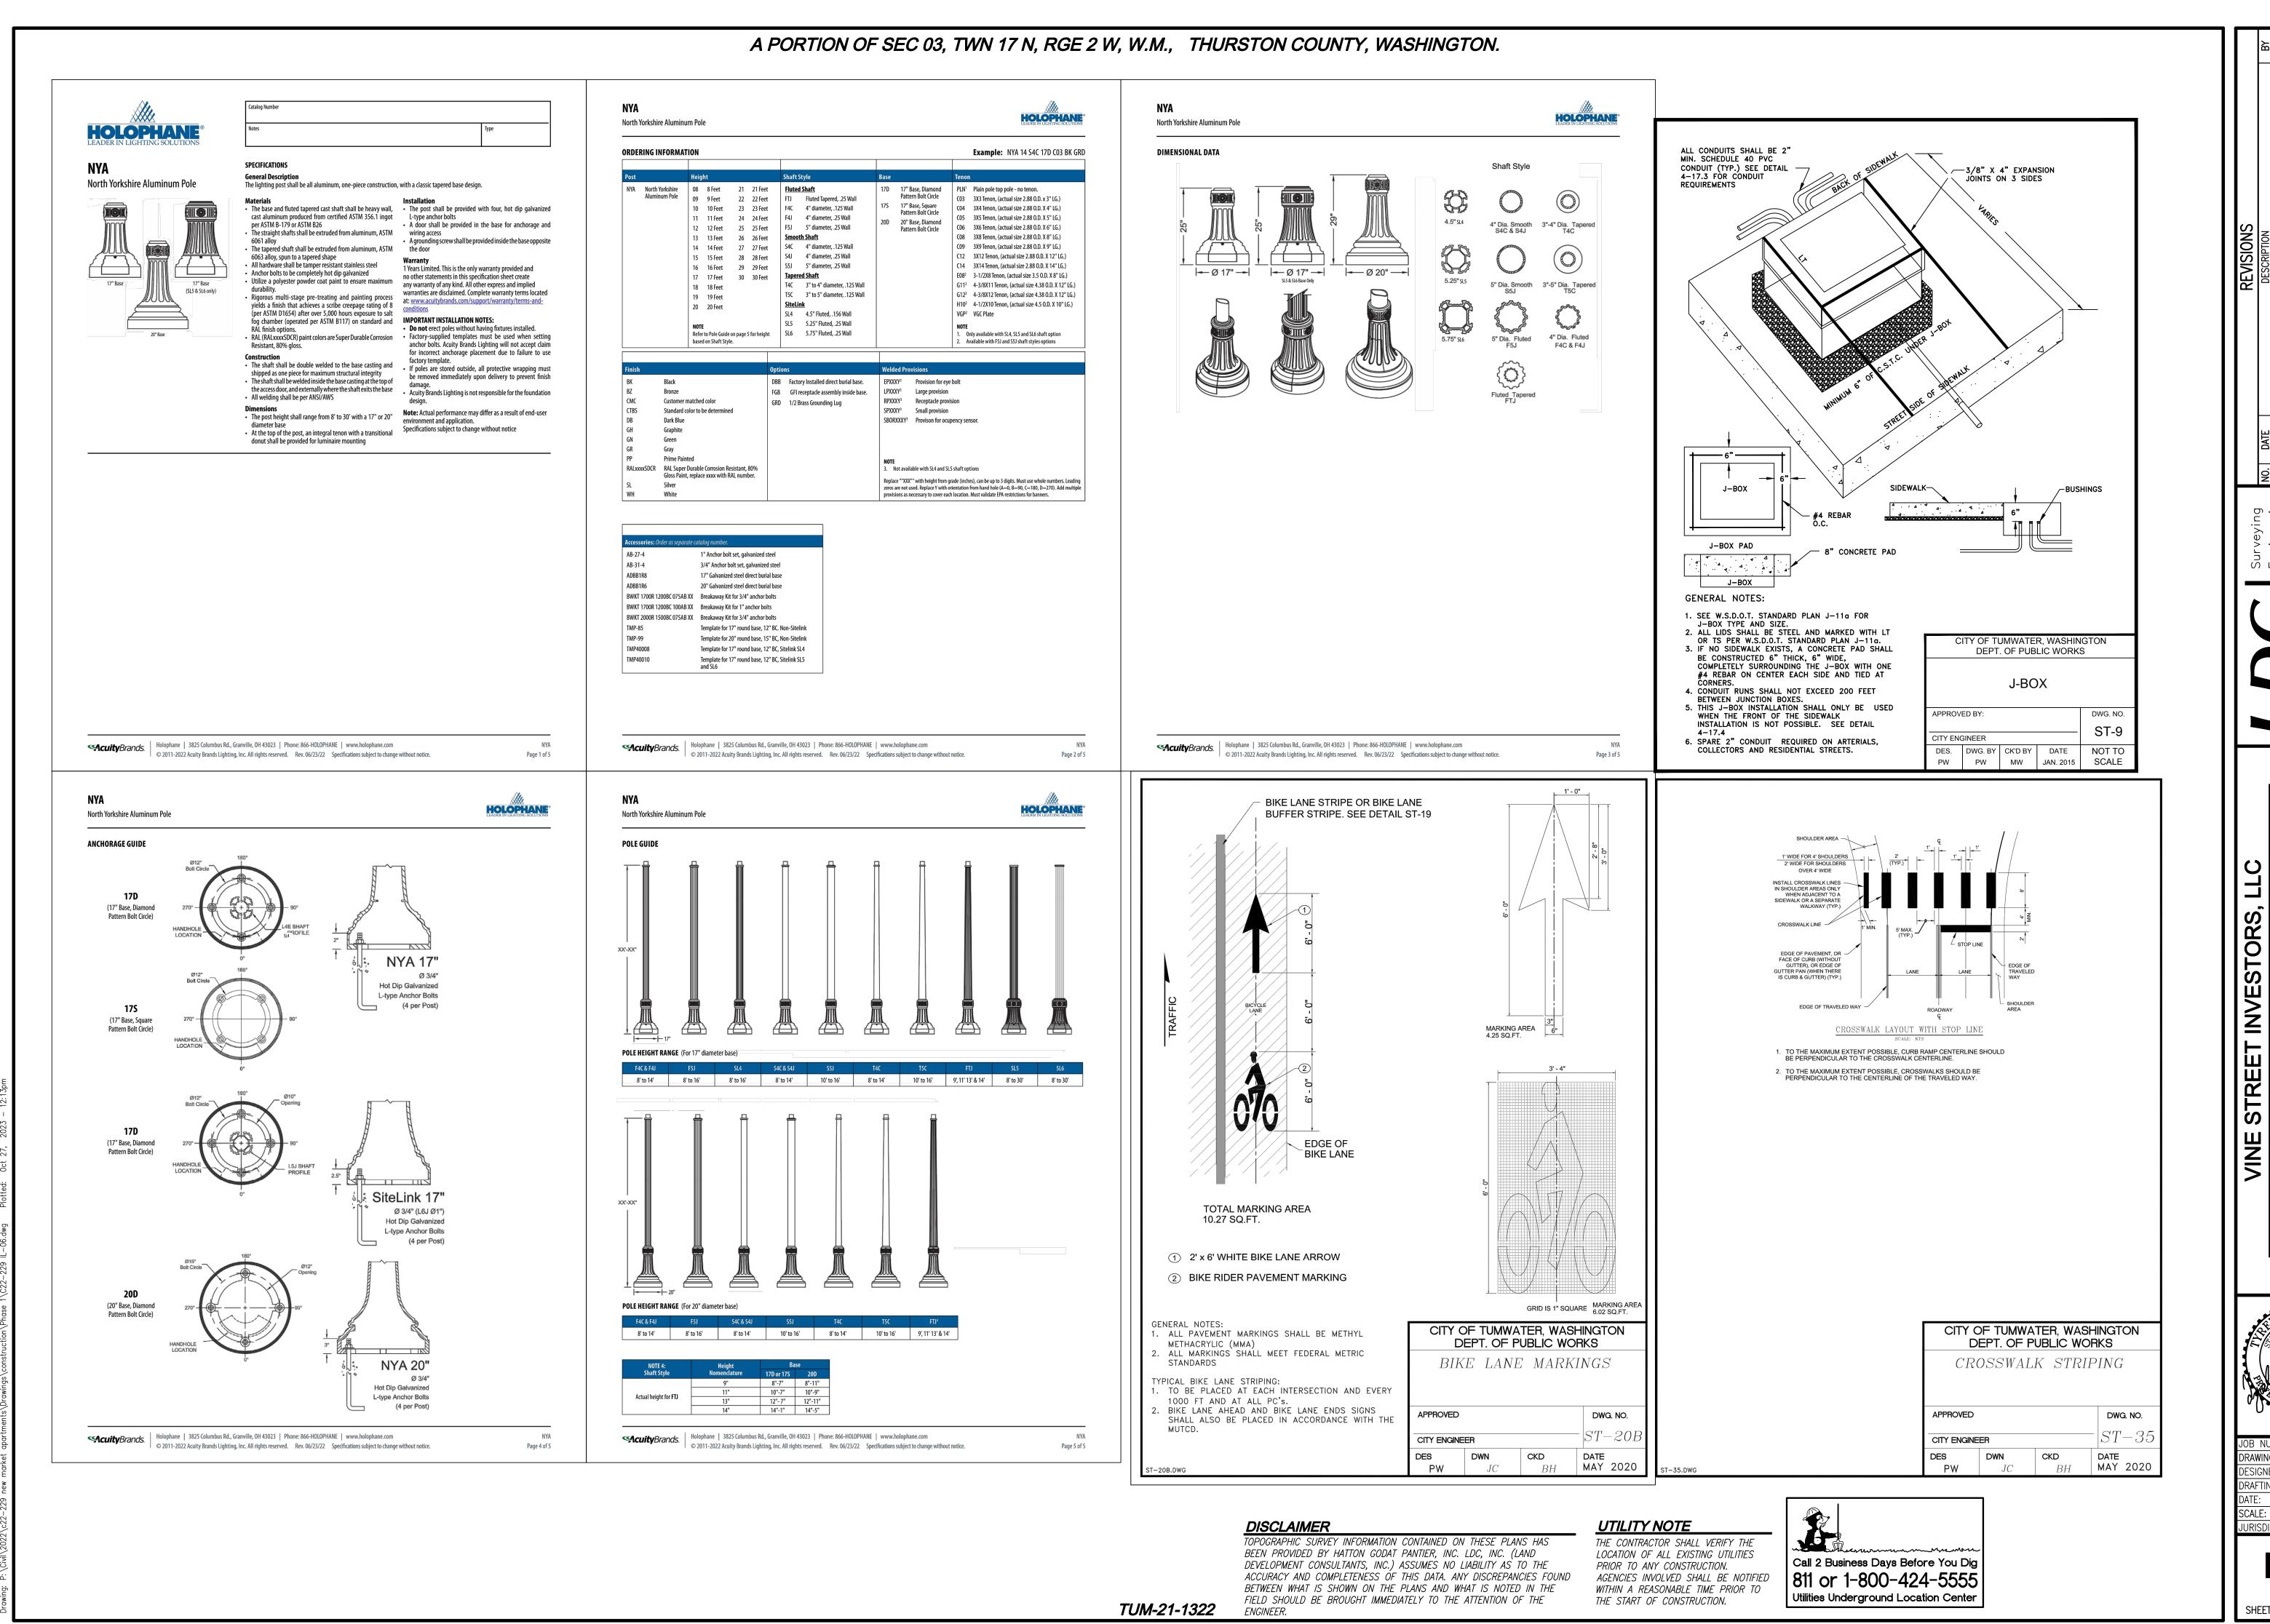


JOB NUMBER: C22-229 IL-C
DESIGNER: T. BRADLE
DRAFTING BY: S. ORDONE
DATE: OCTOBER, 202
SCALE: AS NOTE
JURISDICTION: TUMWATE

APARTMEN

MARKET

A PORTION OF SEC 03, TWN 17 N, RGE 2 W, W.M., THURSTON COUNTY, WASHINGTON.

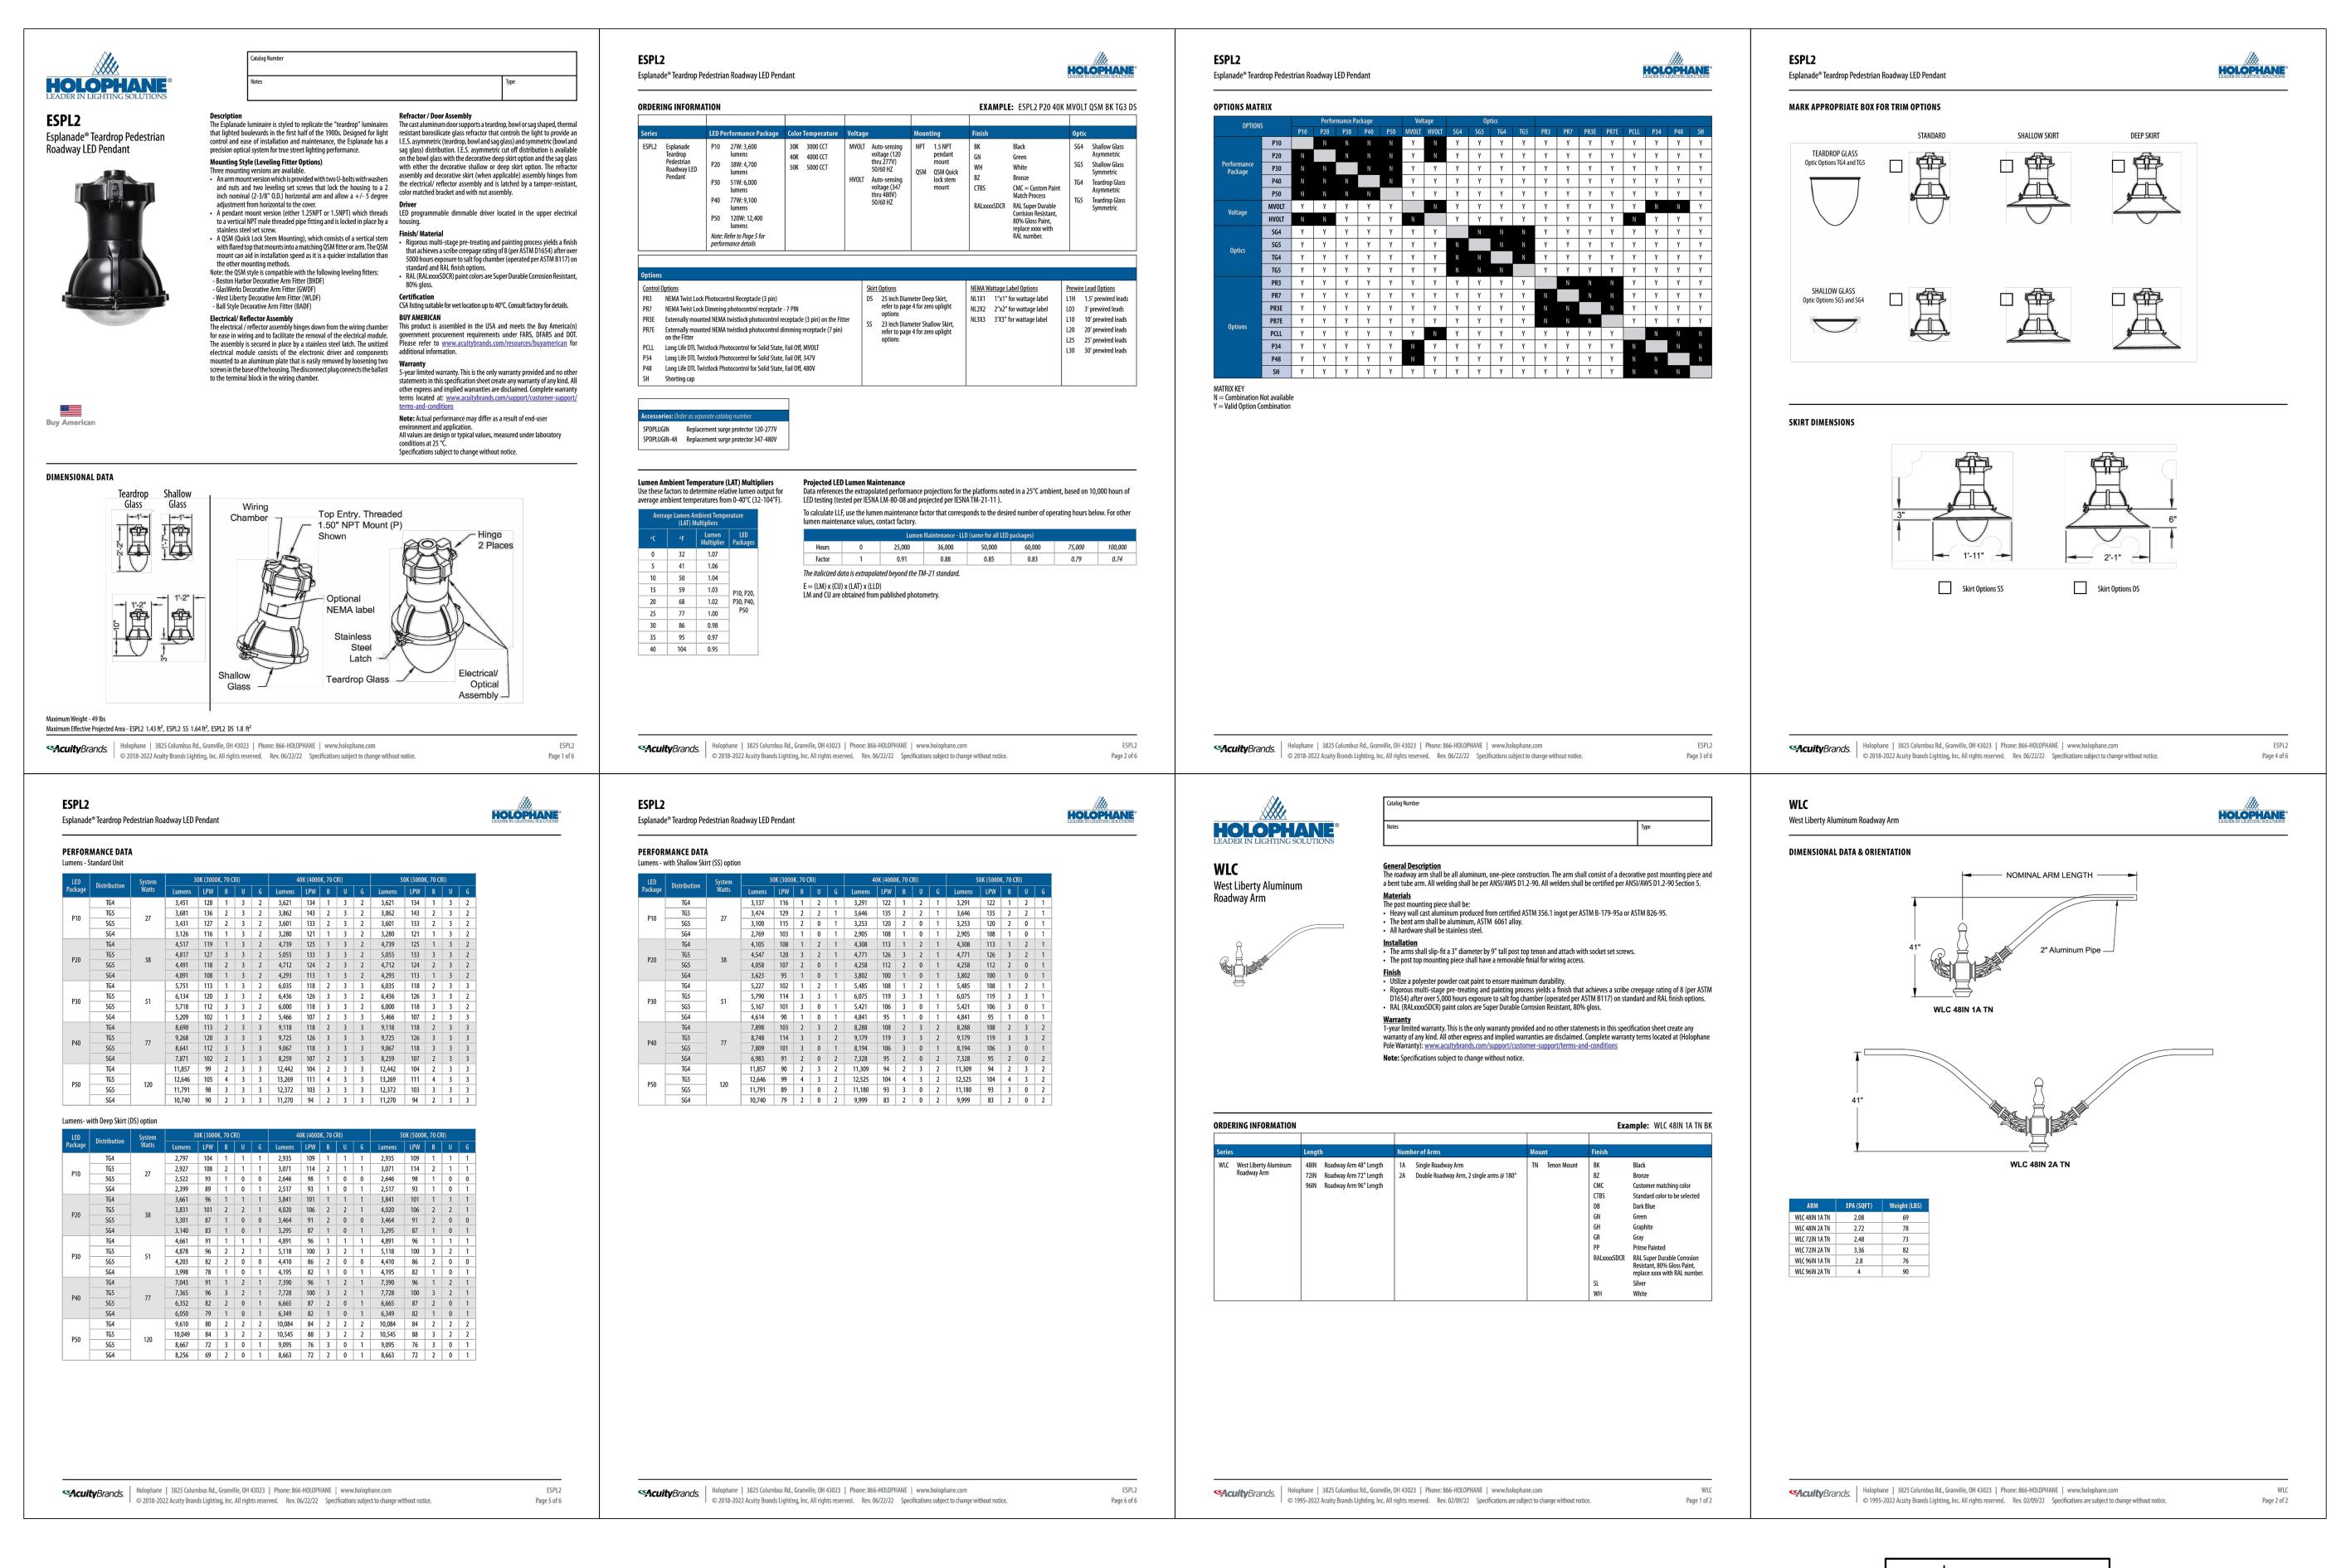

TUM-21-1322

DISCLAIMER

TOPOGRAPHIC SURVEY INFORMATION CONTAINED ON THESE PLANS HAS
BEEN PROVIDED BY HATTON GODAT PANTIER, INC. LDC, INC. (LAND
DEVELOPMENT CONSULTANTS, INC.) ASSUMES NO LIABILITY AS TO THE
ACCURACY AND COMPLETENESS OF THIS DATA. ANY DISCREPANCIES FOUND
BETWEEN WHAT IS SHOWN ON THE PLANS AND WHAT IS NOTED IN THE
FIELD SHOULD BE BROUGHT IMMEDIATELY TO THE ATTENTION OF THE
THE START OF

THE CONTRACTOR SHALL VERIFY THE LOCATION OF ALL EXISTING UTILITIES PRIOR TO ANY CONSTRUCTION.

AGENCIES INVOLVED SHALL BE NOTIFIED WITHIN A REASONABLE TIME PRIOR TO THE START OF CONSTRUCTION.

Call 2 Busing the prior of the prior of the start of construction.

Call 2 Business Days Before You Dig 811 or 1-800-424-5555 Utilities Underground Location Center REVISIONS

DESCRIPTION

Engineering
Planning
Kent
Suite 209
501
n F 425.482.2893

Woodinville Olympia 321 Cleveland Ave SE, Suite 209 Tumwater, WA 98501
T 425.806.1869 www.LDCcorp.com F 425.

APARTMENTS

VINE STREET INVESTORS, LL W MARKET APARTME

E. BR.

SIOSS

SIONAL ENGINEERING

SIONAL ENGI

JOB NUMBER: C22-22
DRAWING NAME: C22-229 IL-C
DESIGNER: T. BRADLE
DRAFTING BY: S. ORDONE
DATE: OCTOBER, 202
SCALE: AS NOTE
JURISDICTION: TUMWATE

IL-07

SHEET **43** OF **43**