






NOTE

THE EXISTENCE AND LOCATION OF ANY UNDERGROUND UTILITY PIPE, CONDUIT, OR STRUCTURES SHOWN ON THESE PLANS ARE OBTAINED BY A SEARCH OF THE AVAILABLE RECORDS. THE CONTRACTOR IS REQUIRED TO TAKE DUE PRECAUTIONARY MEASURES TO PROTECT THE UTILITY LINES SHOWN ON THESE DRAWINGS. THE CONTRACTOR FURTHER ASSUMES ALL LIABILITY AND RESPONSIBILITY FOR THE UTILITY PIPES, CONDUITS, AND OTHER STRUCTURES SHOWN OR NOT SHOWN ON THESE DRAWINGS.

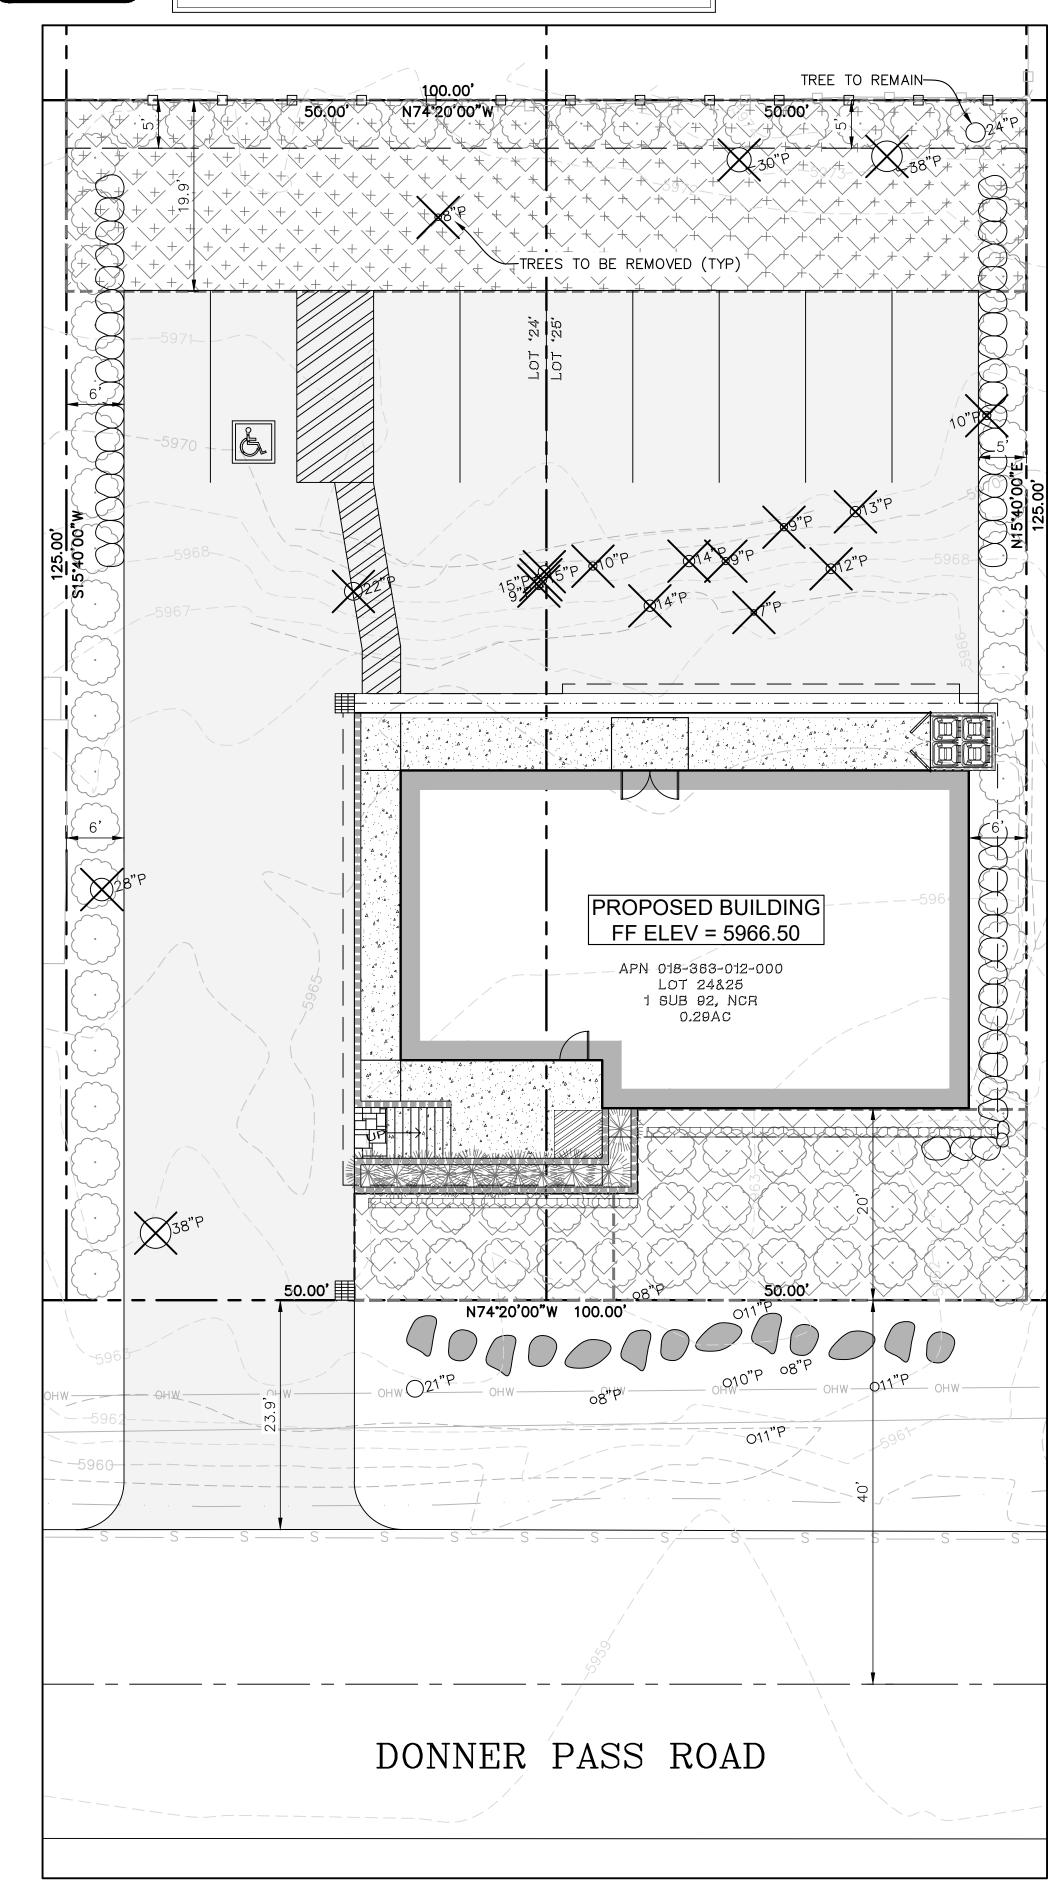

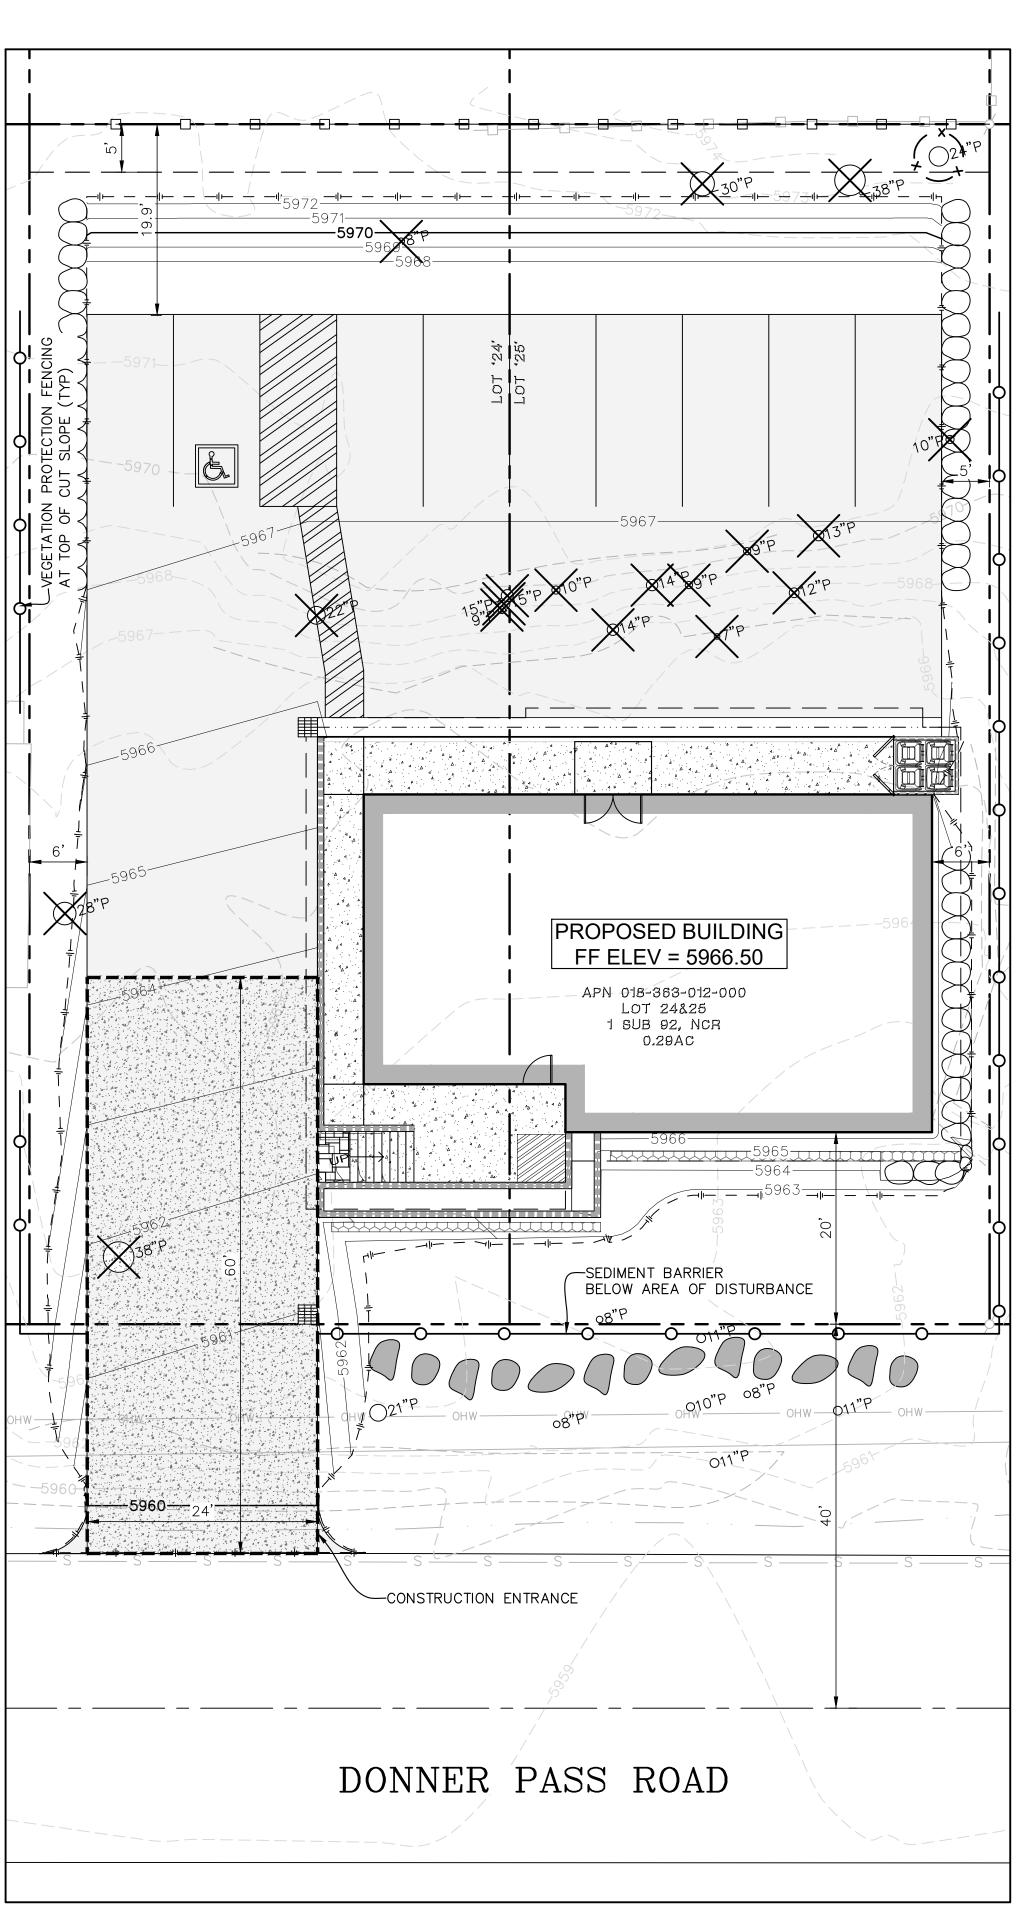



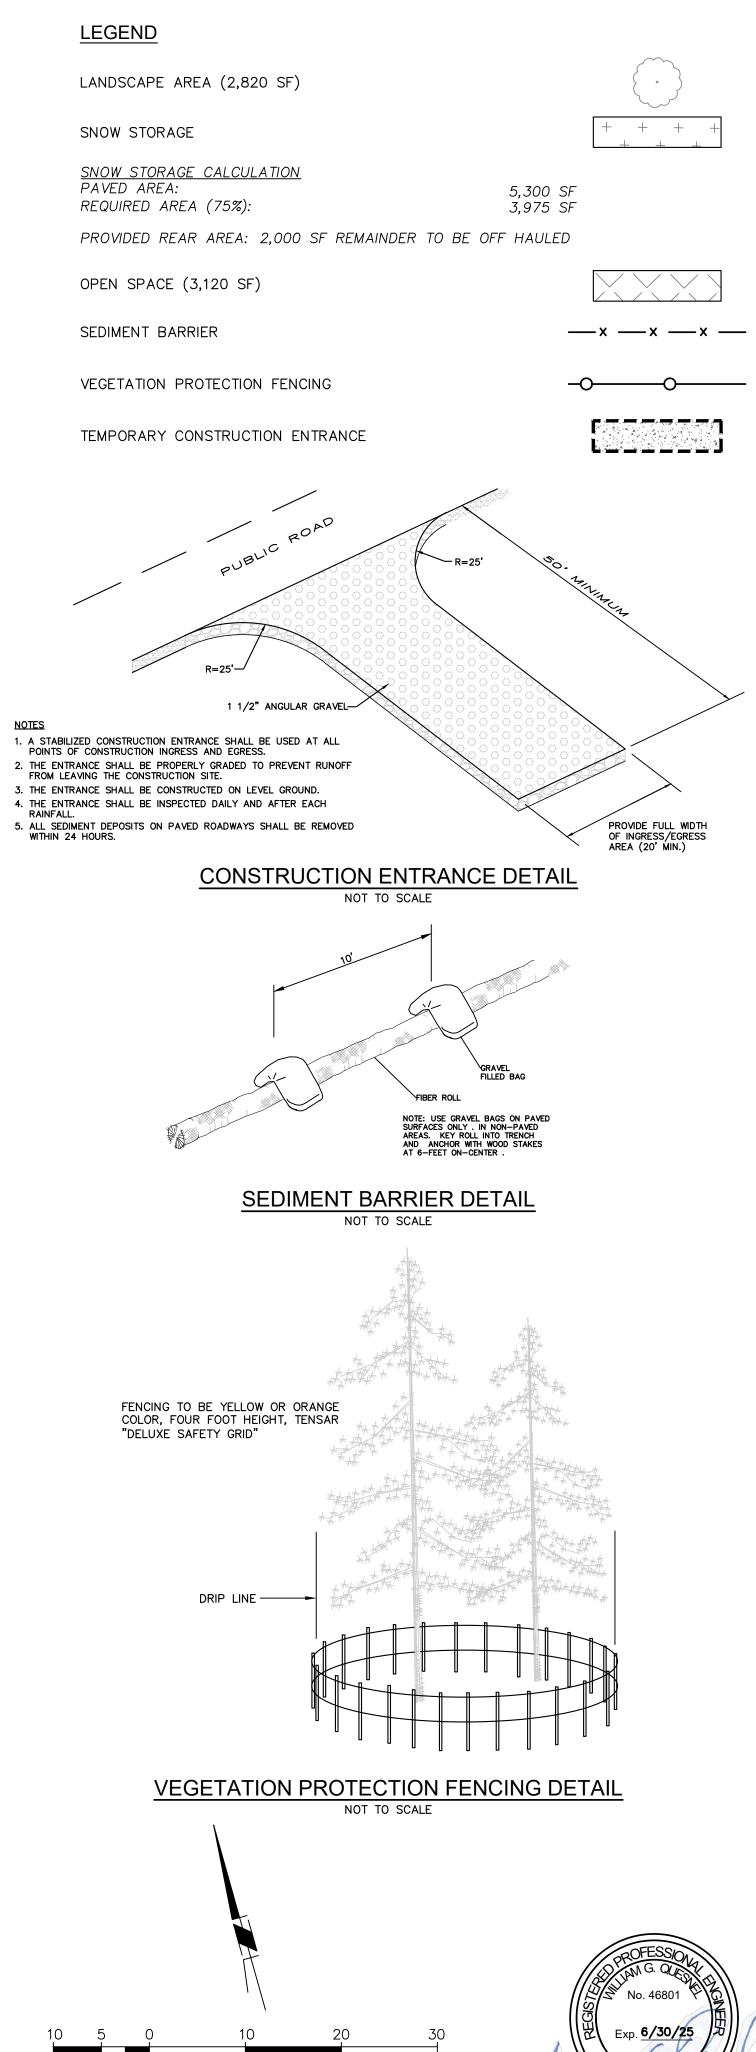

ACUMEN ENGINEERING C O M P A N Y

> TRUCKELL READ DOOR 18 DONNER PASS ROAD RUCKEE, CALIFORNIA APN 018-363-012

CLIENT NAME:
TRUCKEE OVERHEAD DOOR
C/O SCOTT KESSLER
13380 DONNER PASS ROAD

TRUCKEE, CA 96161

FILE:
TRUCKEE OVERHEAD DOOR - PRELIM SITE PLAN.dv
SCALE:
AS SHOWN ON PLAN

FEB 5, 2024

REVISIONS:


AREA
DESIGNATION
& BMP PLAN

SHEET:

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AREA DESIGNATION PLAN


SCALE: 1" = 10'

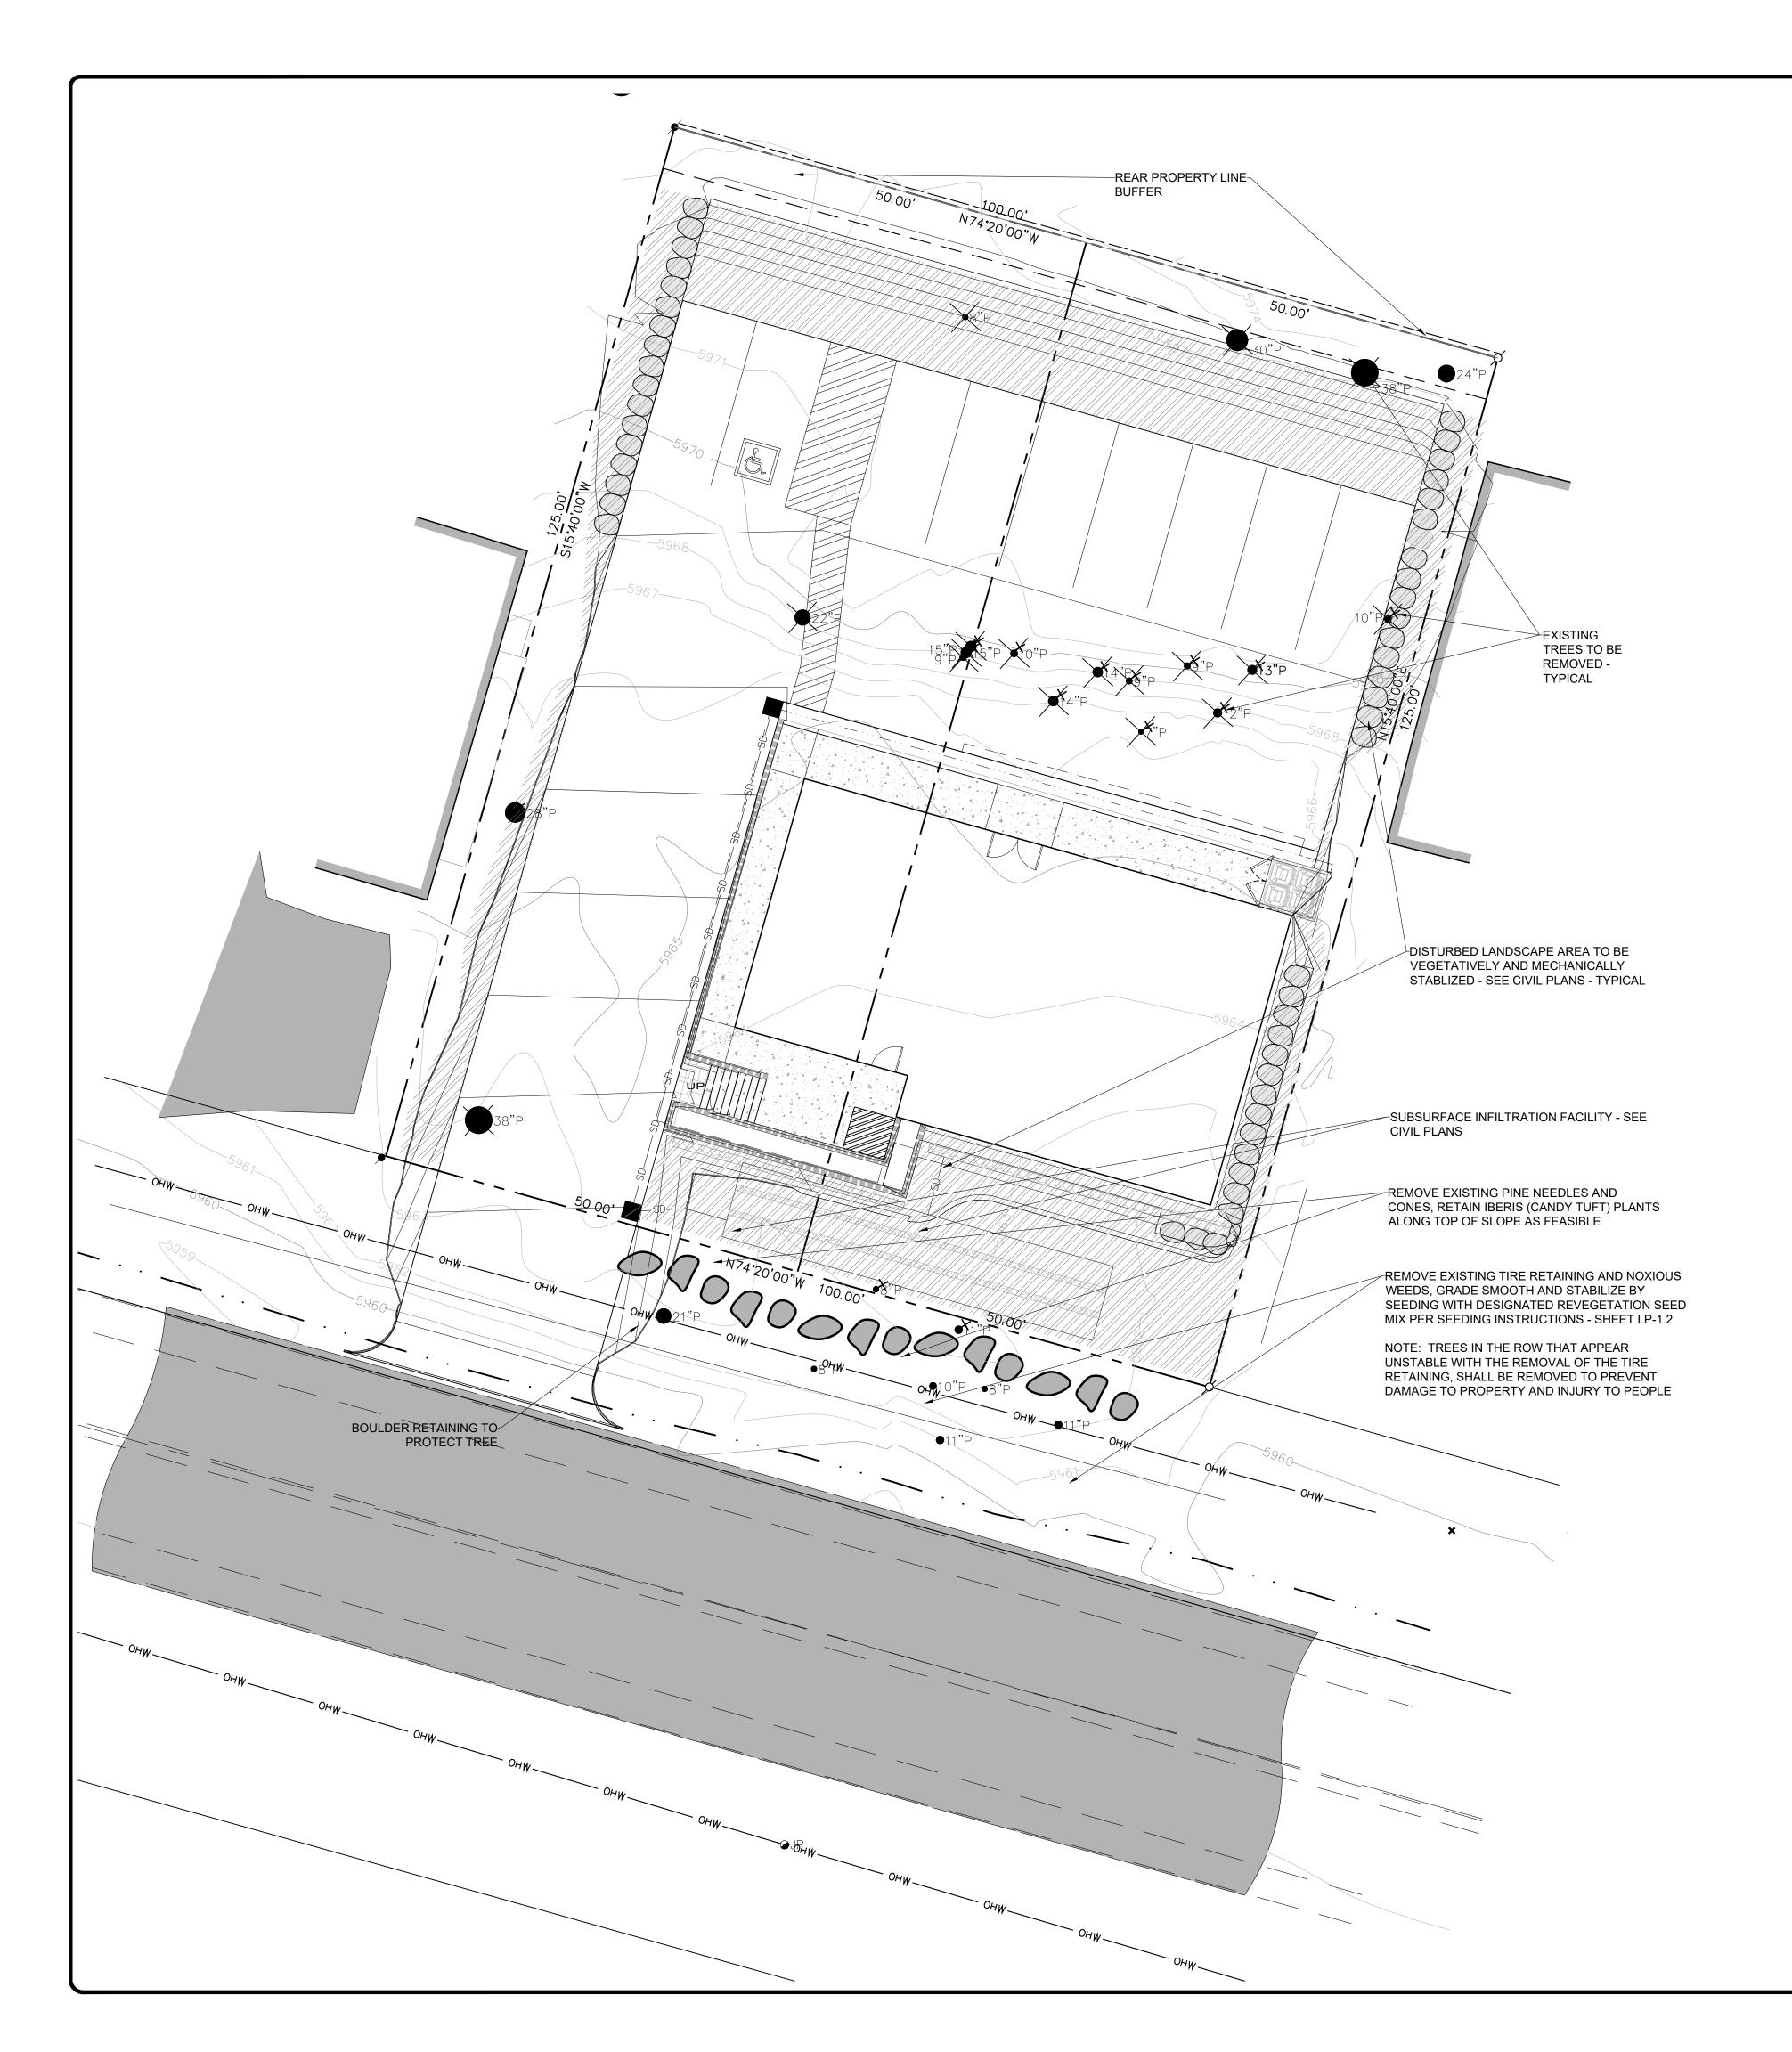

PRELIMINARY GENERAL NOTES:

- 1. TREE, SHRUB AND GROUNDCOVER PLANTERS TO BE DRIP IRRIGATED WITH WATER CONSERVING METHODS. AREAS TO BE VEGETATED WITH SEED MIXES OR GROUND COVERS ARE INTENDED TO BE SPRAY IRRIGATED WITH LOW FLOW, LOW TRAJECTORY DRIP MICRO SPRAYS. SUCH SEEDED AREAS SHALL BE OVER-SEEDED THE FOLLOWING SPRING WHERE THIN OR BARE AREAS APPEAR. NO TURF IS TO BE INSTALLED AT THIS PROJECT LOCATION.
- 2. ALL IRRIGATION TO BE CONTROLLED WITH A SMART CONTROLLER, RAIN/ WEATHER DELAY AND FLOW SENSOR. ALL IRRIGATION TO BE HIGHLY WATER EFFICIENT DRIP IRRIGATION AND COMPLY WITH ALL TRUCKEE IRRIGATION STANDARDS.
- 3. WATER METER AND POINT OF CONNECTION FOR IRRIGATION TO BE LOCATED NEAR EXISTING WATER METER, SEE CIVIL SHEETS.
- 4. ALL SEED AND PLANTING AREAS SHALL BE AMENDED WITH AN APPROVED COMPOST FULL CIRCLE BRAND "BOOST"* OR EQUAL AT A RATE OF 4" PER 1000 SQUARE FEET TILLED INTO THE TOP 6" OF SOIL FINISH GRADE
- 5. IN ACCORDANCE WITH THE TOWN OF TRUCKEE DEVELOPMENT CODE, SECTION 18.40, THE FOLLOWING SHALL OCCUR:
- 5.1. REGULAR MAINTENANCE PRUNING FERTILIZING, WEED, DEBRIS AND TRASH REMOVAL, REMOVE AND REPLACE ANY DEAD OR DIEING PLANT MATERIAL, REPARATION OF IRRIGATION SYSTEM AS NEEDED.
- 5.2. REPORT PRIOR TO THE TWO YEAR ANNIVERSARY OF COMPLETION OF PROJECT A REPORT SHALL BE "PREPARED BY THE PROJECT LANDSCAPE CONTRACTOR OR LANDSCAPE ARCHITECT WHICH DOCUMENTS THE CONDITION OF THE LANDSCAPING, AND PROVIDES RECOMMENDATIONS AS TO WHETHER ANY LANDSCAPING SHOULD BE REPAIRED REPLACED OR INSTALLED. THE RECOMMENDATIONS OF THE REPORT SHALL BECOME A PART OF AND INCORPORATED INTO THE FINAL LANDSCAPE PLAN, AND THE LANDSCAPING SHALL BE REPAIRED, REPLACED AND INSTALLED WITHIN SIX MONTHS OF THE DATE OF APPROVAL OF THE REPORT BY THE (COMMUNITY DEVELOPMENT) DIRECTOR."
- 6. SEE CIVIL PLANS FOR GRADING AND DRAINAGE, BMP, TREE PRESERVATION, STRUCTURAL ELEVATIONS, UTILITIES.
- 7. A SOIL STUDY SHALL BE MADE AVAILABLE PRIOR TO DEVELOPMENT OF CONSTRUCTION DRAWINGS
- 8. THESE PRELIMINARY LANDSCAPE DRAWINGS ARE NOT INTENDED FOR CONSTRUCTION
- 9. LOCATIONS OF EXISTING SITE FEATURES ARE BASED ON ARCHITECT'S/ENGINEER'S SITE PLAN. LANDSCAPE CONTRACTOR TO VERIFY AND NOTIFY LANDSCAPE ARCHITECT OF DISCREPANCIES WHICH AFFECT PRELIMINARY DESIGN OUTCOME.

PRELIMINARY:
NOTFORUCTION
CONSTRUCTION

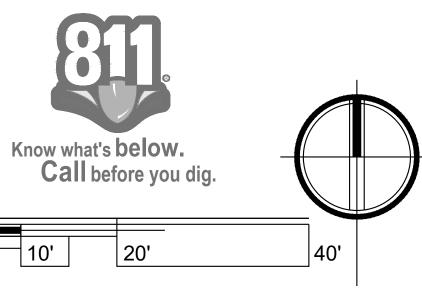

Project: TRUCKEE OVERHEAD DOOR

Site: 13418 DONNER PASS ROAD TRUCKEE, CA APN 018-363-012 NEVADA COUNTY

Engineer:
BILL QUESNEL
ACUMEN ENGINEERING
BOX 3497
TRUCKEE, CA 96161
530.550.8068
PLANNER:
Gavin Ball,

PLANNER: Gavin Ball, Consulting Landuse Planner P.O. Box 313 Truckee, CA 96160 530.582.4244

Litchfield DESIGN + CONSULTING


Robie W. Litchfield, RLA, ASLA

101 Empty Saddle Trail. Suite 24

I01 Empty Saddle Trail, Suite 242 Hailey, ID 83333 robie@Litchfield-DC.com 208.450.1110

> California License #4197 Nevada License #429 Idaho License #LA16881

PRELIMINARY LANDSCAPE SITE PLAN

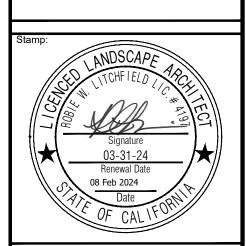

Drav	wn By:	RW	′L			_
Che	cked B	y: RV	٧L			
Drav	wing Da	ate:	8	Feb	202	4
Re	visions:					
Rev.	Date	Rema	arks			

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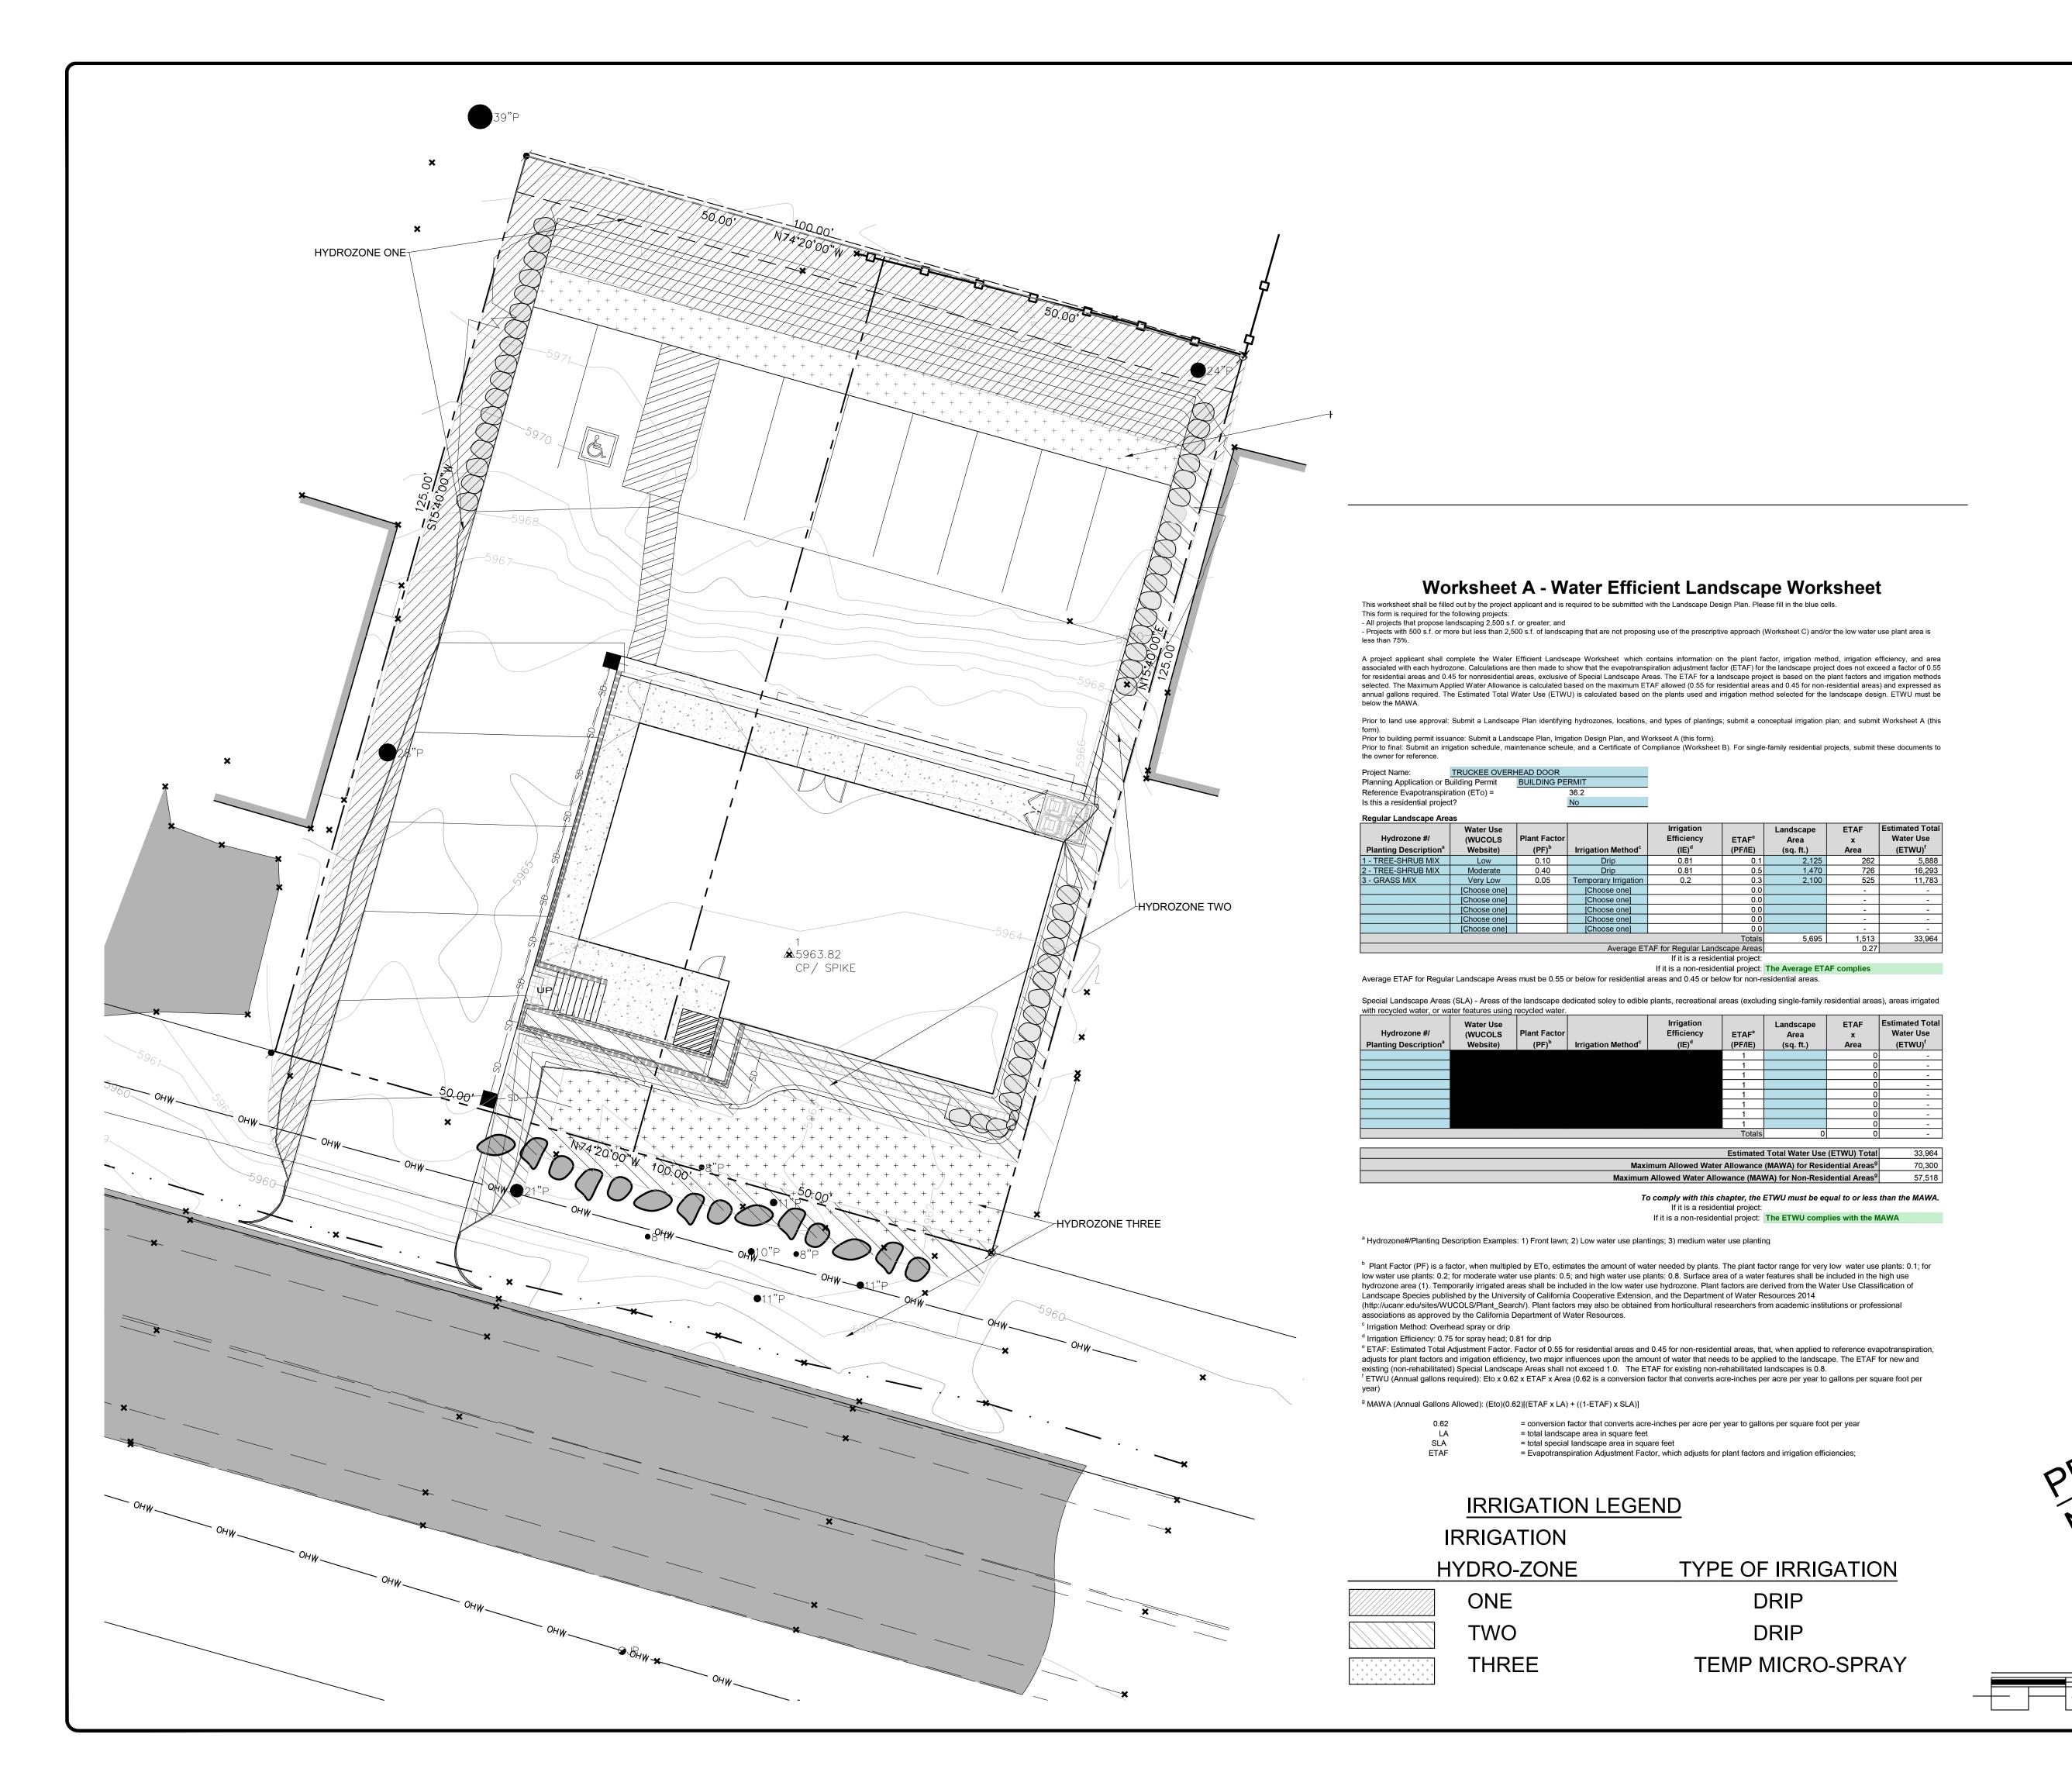
PRELIM. LANDSCAPE

SITE PLAN

Scale: 1" = 10'

Sheet No:

LP-1.0



Project: TRUCKEE OVERHEAD DOOR

13418 DONNER PASS ROAD TRUCKEE, CA APN 018-363-012 NEVADA COUNTY

Engineer: BILL QUESNEL ACUMEN ENGINEERING BOX 3497 TRUCKEE, CA 96161


530.550.8068 PLANNER: Gavin Ball,

Consulting Landuse Planner P.O. Box 313 Truckee, CA 96160 530.582.4244

DESIGN + CONSULTING Robie W. Litchfield, RLA, ASLA

101 Empty Saddle Trail, Suite 242 Hailey, ID 83333 robie@Litchfield-DC.com 208.450.1110

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Drawn By: RWL Checked By: RWL Drawing Date: 8 Feb 2024

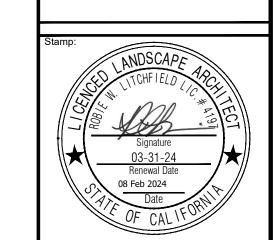
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PRELIM. LANDSCAPE IRRIGATION PLAN

Scale : 1" = 10'



	TRUCKEE OVERHEAD DOOR PRELIMINARY PLAN PLANT INVENTORY															
TREES									9	SHRUBS		REVEG MIX				
AREA	MEASURE	TREES REQUIRED PER TOT DEVELOPMENT CODE	TREES EXISTING TO REMAIN	TREES EXISTING TO REMOVE	TREES EXPECTED	TREE SIZE MIX	SIZES	PROVIDED	SHRUBS EXPECTED	SHRUBS PRO- POSED	GROUND COVERS & PERENNIALS PROPOSED	SIZES	PROVIDED	SQUARE FEET	COMMENTS	
Disturbed	2021 SF	1T/4SH PER 100 SF = 20 T/80 SH * Reduction applied to	0	3	15	3	24" Box	3	60	36		#5	36	0	HIS AREA IS CALCULATED USING AREAS TO BE	
Area		Street Buffer = 15 T / 60 SH				12	#15	13			18	#1	24		AND PAVED AREAS	
REAR PROPERTY		1T/4SH PER 20 LF =				2	24" Box	2		14		#5	14		THIS INCLUDES THREE MATURE TREES AT TOI OF PROPERTY. ASSUME CREDIT FOR TREES	
LINE RESIDENTIAL BUFFER	100 LF	5T/20 SH *	1	2	5	2	#15	2	20		6	#1	6	495	RETAINED UNDER DC CHAPTER 18.4.040, SECTION A PARAGRAPH 3.	
STREET	100 LF	1T/4SH PER 20 LF =	_			0	24" Box	0	20	14		#5	14	858	CREDIT FOR RETENTION OF EXISTING TREES IS	
BUFFER	100 LF	5 T/20 SH *	5	3	0	0	#15	0	20		6	#1	6	858	TAKEN PER DC CHAPTER 18.4.040, SECTION A PARAGRAPH 3.	
INTERIOR		2T / 5 SH /5 STALLS =				1	24" BOX	1		8		#5	4		TREES AND SHRUBS FOR THIS PURPOSE HAVE BEEN APPLIED TO THE DISTURBED AREAS ALONG	
PARKING	9 SPACES	4T / 9 SH	0	11	4	3	#15	1	9		3	#1	3	747	THE PROPERTY SIDE LINES PER DC CHAPTER 18.40.040.B.4 TO AVOID OVER CROWDING OF PLANT MATERIAL	
SUB-TOTALS		0	6	19	24		0	22	109	72	30	0	107	2100		

REVEG SEED MIX

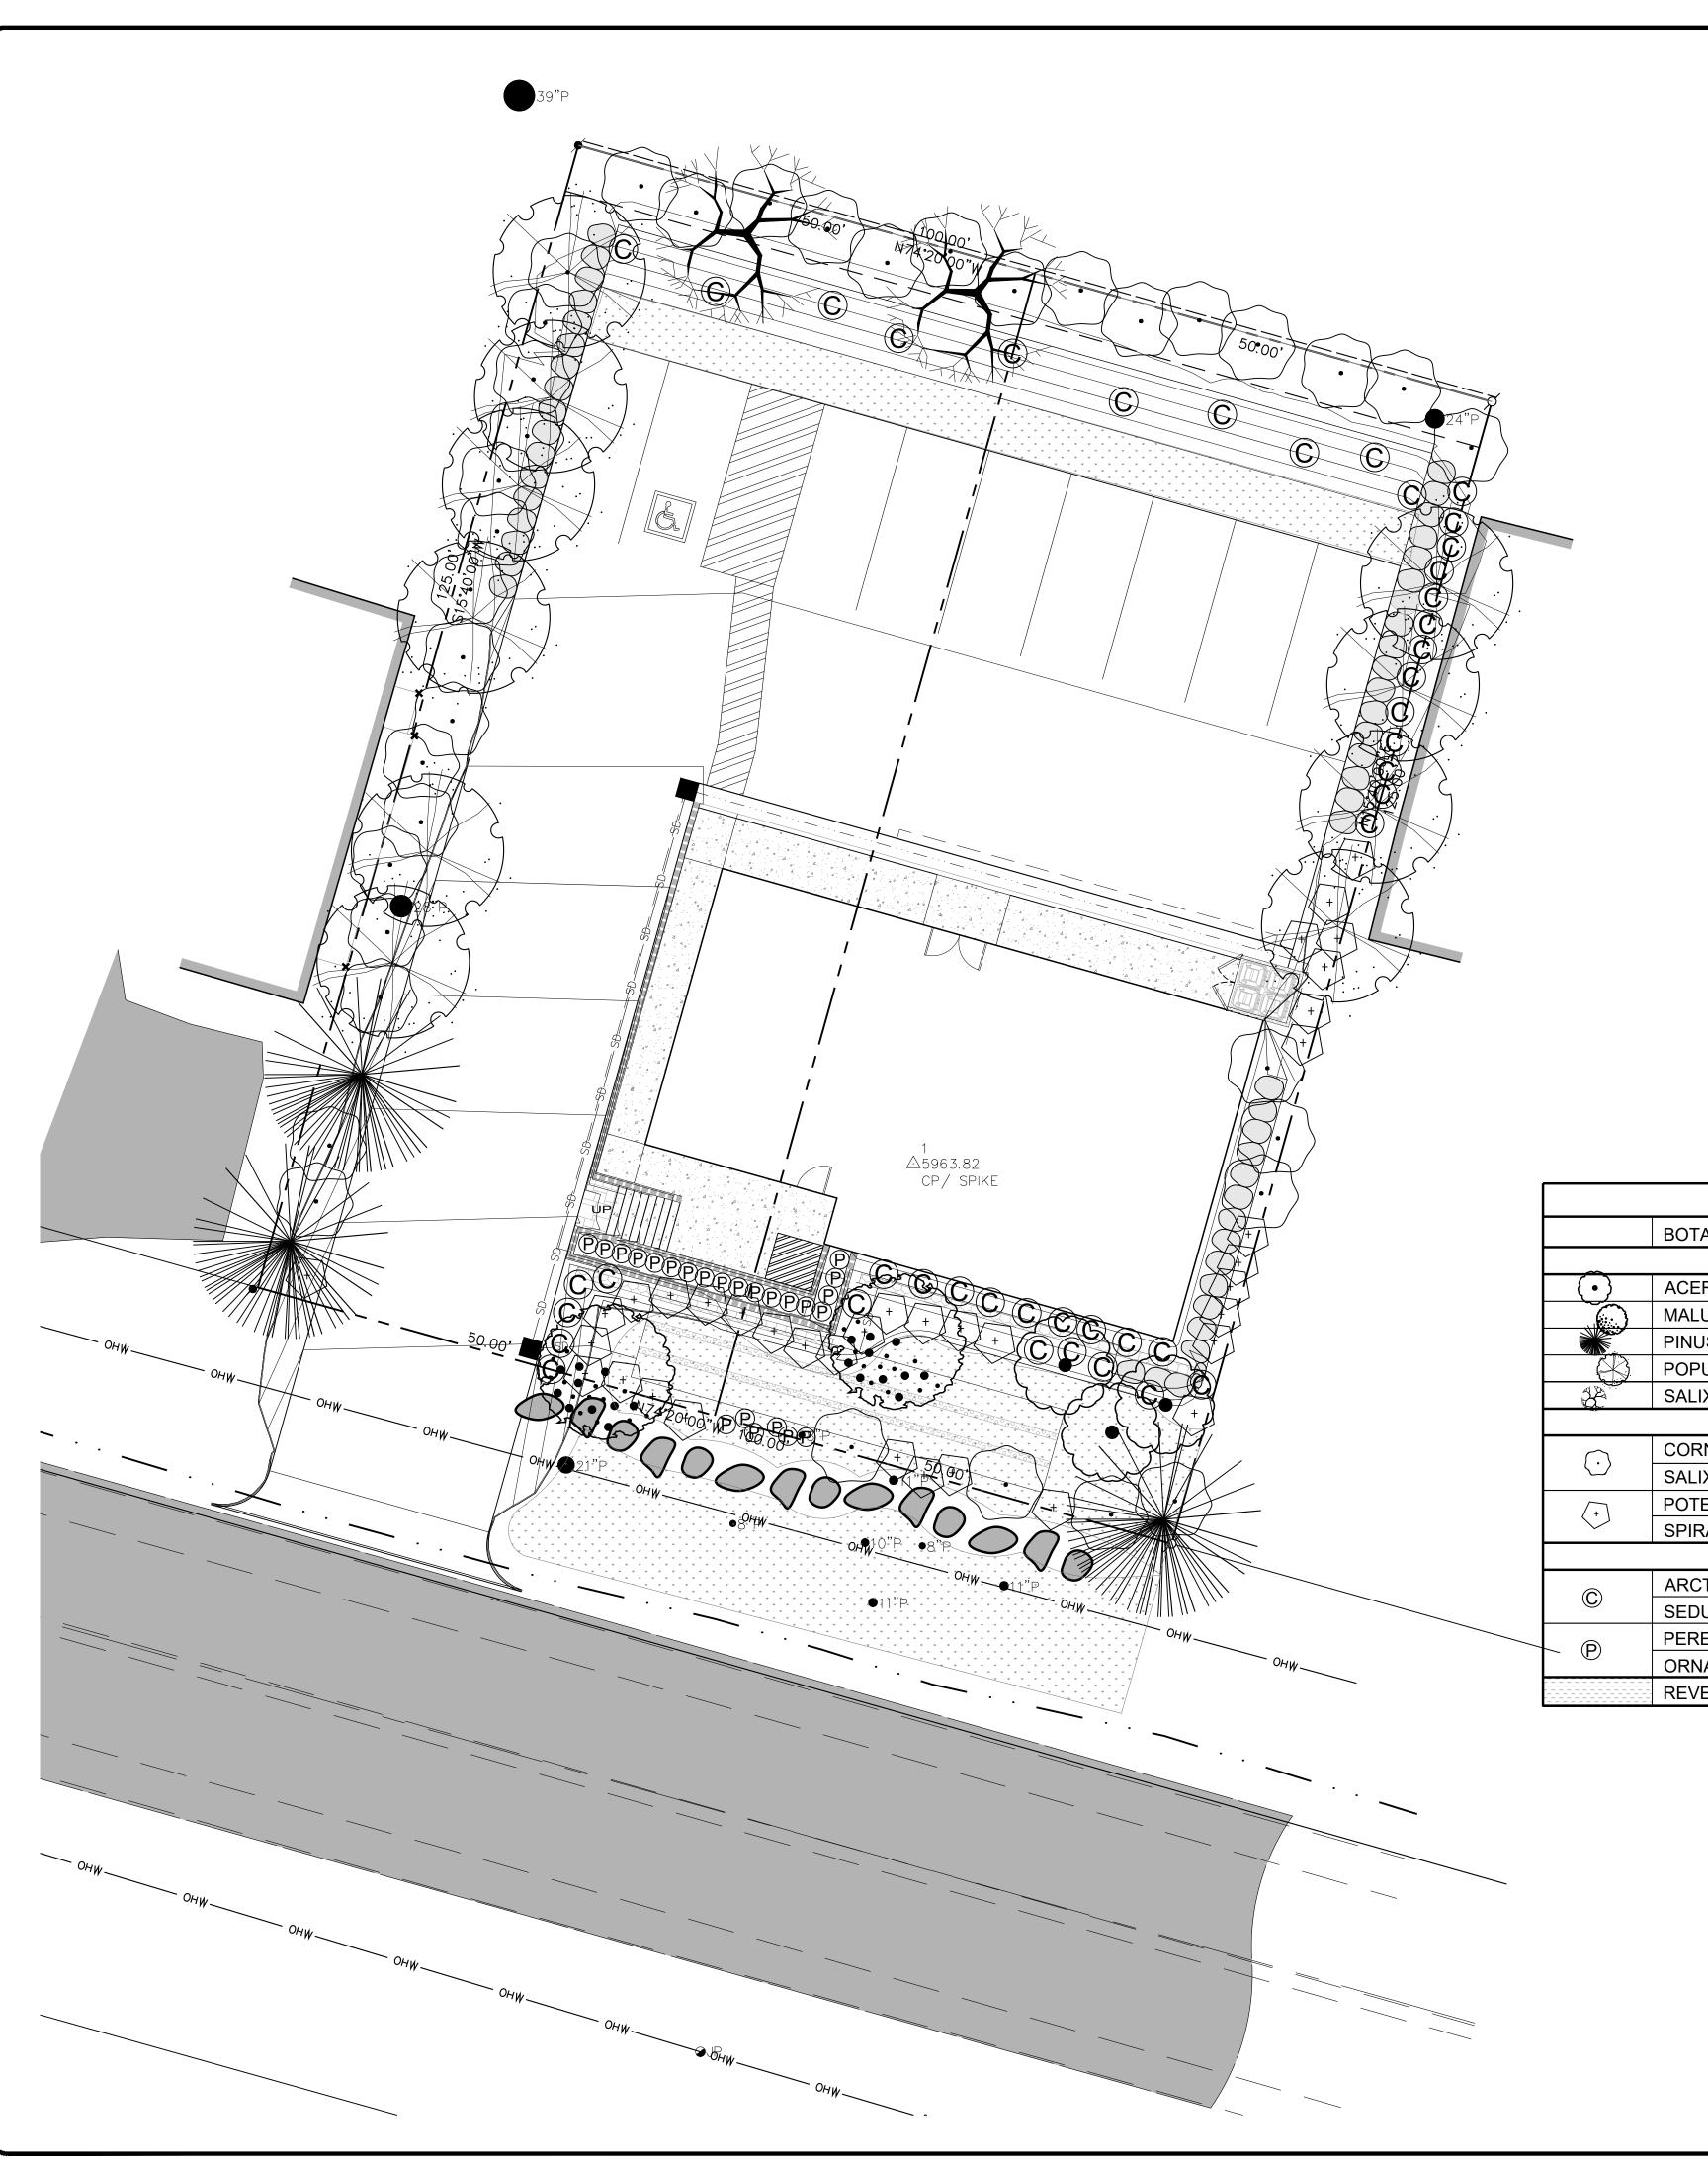BROME MOUNTAIN BROMAR

WILDRYE BLUE ELKTON

SQUIRREL TAIL GRASS

BLUEGRASS BIG SHERMAN

SEED MIX WEIGHT TOTALS

WHEATGRASS SLENDER REVENU

APPROX TOTAL AREA = 3000 SF/0.07 ACRES

SPECIES

			*	Ψ Ψ Ψ Ψ Ψ Ψ Ψ				
		PL <i>F</i>	ANT L	IST AND	LEGEND			
	BOTANICAL NAME	COMMON NAME QTY SIZE LOCATION COMMENTS					NATIVE/ADAPT	. WATER USE
				TREES				
(•)	ACER GINNALA	AMUR MAPLE	3	#15	AS SHOWN	ORN. MULTI-STEM	ADAPTIVE	MODERATE
	MALUS SPECIES	CRABAPPLE	2	#15	AS SHOWN	ORNAMENTAL	ADAPTIVE	LOW
	PINUS JEFFREYI	JEFFREY PINE	3/2	#15 / 24	AS SHOWN	60' TALL	NATIVE	LOW
	POPULUS TREMULOIDES	QUAKING ASPEN	8/2	#15 / 24"	AS SHOWN	30' TALL	NATIVE	MODERATE
	SALIX SCOULERIANA	SCOULER'S WILLOW	1/1	#15 / 24"	AS SHOWN	MULTI-STEM - 25'	NATIVE	MODERATE
**************************************				SHRUBS				
\bigcap	CORNUS SERICEA	REDTWIG DOGWOOD	37	#5	AS SHOWN	NATIVE 8' T/W	NATIVE	MODERATE
$\langle \cdot \rangle$	SALIX LEMMONII	LEMMON'S WILLOW		#5	AS SHOWN	NATIVE 8-10' T/W	NATIVE	MODERATE
(+)	POTENTILLA FRUITICOSA	SHRUB CINQUEFOIL	36	#5	AS SHOWN	NATIVE CULTIVAR	NATIVE	LOW
	SPIRAEA DENSIFLORA	MOUNTAIN SPIREA		#5	AS SHOWN	NATIVE 3' T/W	NATIVE	LOW
		GROUND COVE	ERS, PE	ERENNIALS	S AND GRASSE	ES		
<u> </u>	ARCTOSTAPHYLOS UVA URSI	BEAR BERRY MANZANITA	43	#1	48" O.C.	ORN. 3' DIA, YLO FL.	ADAPTIVE	LOW
©	SEDUM SPECIES	STONE CROP		#1	24" O.C.	ORN. 3' DIA, PINK FL.	ADAPTIVE	LOW
~ (P)	PERENNIAL PLANT	CATMINT, DAISY, PHLOX	24	#1	24" O.C.	ORNAMENTAL	ADAPTIVE	MODERATE
` (F)	ORNAMENTAL GRASS	FEATHER REED GRASS		#1	AS SHOWN	ORN. 4-5' TALL	ADAPTIVE	MODERATE
	REVEGETATION SEED MIX - NO	ON IRRIGATED MIX OF LOW PF	ROFILE	GRASSES	- 2100 SF		NATIVE	LOW



PLS LBS/ACRE

8.00

8.00 4.00

3.00

1.00

24.0

PLS LBS

.56

Project: TRUCKEE OVERHEAD DOOR

Site: 13418 DONNER PASS ROAD TRUCKEE, CA APN 018-363-012 NEVADA COUNTY

Engineer: BILL QUESNEL ACUMEN ENGINEERING BOX 3497 TRUCKEE, CA 96161 530.550.8068


PLANNER: Gavin Ball, Consulting Landuse Planner P.O. Box 313 Truckee, CA 96160 530.582.4244

DESIGN + CONSULTING Robie W. Litchfield, RLA, ASLA

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Drawn By: RWL
Checked By: RWL
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PRELIM. LANDSCAPE PLANTING PLAN

Scale : 1" = 10'

SOIL IMPROVEMENT NOTES

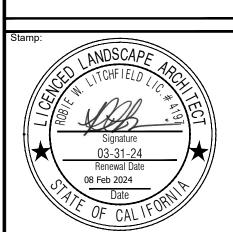THE SOIL ON THIS SLOPE IS NOT AN OPTIMAL GROWING MEDIUM FOR NEW LANDSCAPE PLANTING. TO IMPROVE THE ODDS OF SUCCESS, WE MAKE THE **FOLLOWING RECOMMENDATIONS:**

1. LANDSCAPE PLANTING AREAS

- 1.1 SPREAD 1.5" OF FULL CIRCLE BRAND 'BOOST' OR 12" OF 'KICK'
- 1.2 WORK INTO THE TOP 24" OF THE SOIL
- 1.3 WHEN PLANTING NURSERY STOCK DIG THE PLANTING HOLES AS DIRECTED IN THE NOTES 4 AND 5 OF THE PLANTING NOTES
- 1.4 MIX BACKFILL MATERIAL WITH 50% SITE SOIL AND 50% FULL CIRCLE BRAND 'KICK' GARDEN SOIL
- 1.5 IF SUITABLE SITE SOIL IS UNAVAILABLE, IMPORT CLEAN, SIFTED, LOCALLY SOURCED EXCAVATED MATERIAL - SUBMITTAL SAMPLE **REQUIRED**

2. MULCH

SPREAD 3" OF FULL CIRCLE BRAND 'PROTECT' MULCH OVER ENTIRE LANDSCAPE AREA MAINTAINING 3" CLEARANCE FROM PLANT CROWNS TO PROVIDE WATER RETENTION, IMPROVE SOIL STRUCTURE OVER TIME

FULL CIRCLE PRODUCTS ARE MADE FROM LOCALLY HARVESTED ORGANICS FROM THE LAKE TAHOE REGION WHICH PROTECTS FROM FOREIGN PATHOGENS. THEIR PRODUCTS ARE ALL ORGANIC AND CONTAIN A PROPRIETARY BLEND OF SOIL FORTIFYING INGREDIENTS, INCLUDING MACRO AND MICRO NUTRIENTS AND BENEFICIAL MICROBES. THAT FOSTER A HEALTHY GROWING MEDIUM. ADDITIONALLY THEY ARE INFLAMMABLE

TO MAINTAIN A HEALTHY GROWING ENVIRONMENT IN THE LONG TERM IT IS RECOMMENDED TO REAPPLY 'PROTECT' APPROXIMATELY EVERY THREE YEARS.

FULL CIRCLE PRODUCTS ARE AVAILABLE LOCALLY OR FROM THEIR PLANT IN MINDEN, NEVADA - FOR MORE INFORMATION GO TO http://fullcirclecompost.com/

PLANT DROUGHT TOLERANCE INVENTORY FOR 13418 Donner Pass Road - TRUCKEE OVERHEAD DOOR

It is important to note that the drought tolerances expressed below are based upon plants being well established in their situations. This typically take three to five years with a well planned weaning off period prior to removing irrigation all together. Additionally, fo some of the plants to thrive, not merely survive, supplemental water will be necessary. For optimal Defensible Space purposes, well

Plant Type	Common Name	Quantity Specified	Relative Drought Tolerance	Percentage of Total Plant Count of 165 Total Plants	Percentage of Native Plant Count of 90 total Native Plants	Comments
Turf	None	N/A	-	-	•	No Turf is specified for this project
Ornamental Deciduous Trees	Amur Maple	3	Moderate	2.00%	-	Especially Drought tolerant in shad locations
Ornamental Deciduous Trees	Crabapple	2	Very	1.00%	-	These plants will tolerate periods of drought, Flowering and fruiting ma be affected by prolonged drought
Native Deciduous Trees	Aspen and Scouler's Willow	12	Moderate	7.00%	13.00%	Though these plants are considere riparian in nature they are very tolerant of drought and make excellent defensible space planting
Ornamental Evergreen Trees	None	n/a	-	-	-	No Ornamental Evergreens are specified for this project
Native Evergreen Trees	Jeffrey Pine	5	Extremely	3.00%	6.00%	Prevalent native evergreen found throughout Truckee
Ornamental Shrubs	None		-	-	-	No Ornamental Shrubs are specific for this project
Native Shrubs	Redtwig Dogwood, Lemmon's Willow, Shrub Cinquefoil, Mountain Spirea	73	Moderate to Very	45.00%	81.00%	All the plants specified are readily found locally in the native and home/commercial landscapes
Ornamental Perennials	Catmint, Shasta Daisy, Garden Phlox, Feather Reed Grass	24	Very to Extremely	15.00%	0.00%	All these plants are extremely reliable in Truckee Landscapes
Native Perennials		N/A	-	0.00%	0.00%	No Native Perennial Plants are specified for this project
Ornamental Ground Cover	Bearberry Manzanita, Stone Crop	43	Very	27.00%	0.00%	Commercially available species that mimic natives not typically commercially available
Native Ground Cover	Low Profile Grass seed	N/A	Very	2100 square feet	0.00%	Seeding not counted toward total plant count
Totals		162		100.00%	100.00%	Native Plants comprise 52% of the total plant count in addition to the seed mix

PLANTING NOTES

PLANTING


- PLANTS SHALL BE THE VARIETY AND SIZE SPECIFIED ON THE PLAN AND BE HEALTHY. SHAPELY AND WELL ROOTED AND CONFORM TO AMERICAN NURSERYMAN'S STANDARDS TREES SHALL BE ABLE TO STAND STRAIGHT ON THEIR OWN WITHOUT SUPPORT. ANY CHANGES TO PLAN TO BE APPROVED BY LANDSCAPE ARCHITECT PRIOR TO INSTALLATION. LANDSCAPE ARCHITECT AND /OR OWNER RESERVES THE RIGHT OF REFUSAL SHOULD PLANT MATERIAL SIZE AND QUALITY BE DEEMED UNSATISFACTORY INSPECTION BY LANDSCAPE ARCHITECT IS MANDATORY PRIOR TO ACCEPTANCE OF ALL PLANT MATERIALS. MATERIAL SHALL BE REPLACED AT THE EXPENSE OF THE CONTRACTOR. MATERIALS SHALL BE COMPLETELY FREE OF TRUNK, BRANCH AND BARK WOUNDS. STRUCTURE OF PLANT MATERIAL SHALL BE APPROPRIATE TO NATURAL HABIT INSTALLING CONTRACTOR SHALL VERIFY PLANT QUANTITIES AND AREAS TO BE
- LANDSCAPED AND NOTIFY OWNER AND/OR LANDSCAPE ARCHITECT OF DISCREPANCIES. GRADING OF ENTIRE CONTRACT AREA SHALL BE SMOOTH AND EVEN AND SLOPE TO DRAIN. FINISH GRADES SHALL BE 1/2" BELOW ALL PAVED SURFACES. SLOPES, MOUNDS, AND SWALES SHALL HAVE NO ABRUPT CHANGE IN GRADIENT TO ASSURE A NATURAL AND PLEASING APPEARANCE
- 4. THE PLANTING HOLE SHALL BE DUG TWICE THE WIDTH AND TO THE SAME DEPTH OF THE CONTAINER OR ROOTBALL
- THE PLANTING HOLE SHALL BE TESTED FOR DRAINAGE. FILL WITH WATER AND ALLOW TO DRAIN. SHOULD DRAINAGE NOT OCCUR WITHIN A FEW HOURS THE HOLE SHOULD NOT BE USED AND AN ALTERNATIVE LOCATION FOR PLANT FOUND.
- ROOTBALL SHALL BE GENTLY REMOVED FROM CONTAINER AND ROOT INSPECTED PRIOR TO PLACEMENT IN THE HOLE. THE ROOT BALL SHALL BE TEASED BY PINCHING ROOTLETS LOOSE FROM WALL OF BALL TO ENCOURAGE ROOTS TO EXTEND OUTWARD. SHOULD PLANT BE ROOT BOUND THE BALL SHALL BE SCORED WITH A SHARP KNIFE VERTICALLY IN THIRDS DOWN THE ROOTBALL SIDES APPROXIMATELY 1/2 INCH DEEP AND TWO WAYS ACROSS THE BOTTOM, THE ROOTS SHALL THEN BE LOOSENED AND SPREAD TO ENCOURAGE OUTWARD GROWTH.
- PLANT SHALL BE BURIED TO STRUCTURAL ROOT DEPTH. EXCESS MATERIAL ON BALLED AND BURLAP TREES SHALL BE REMOVED. REMOVE BURLAP AND BASKETS FROM B&B TREES WITH CARE TO MAINTAIN INTEGRITY OF ROOT BALL.
- ALL TAGS SHALL BE REMOVED FROM PLANTS.
- FOLLOW SOIL IMPROVEMENT NOTES ON THIS SHEET FOR SOIL AMENDMENTS AND MULCHES. WHEN COMPOSTED HUMUS NOT AVAILABLE, AMENDMENT SHALL BE SUFFICIENTLY NITROLIZED TO PREVENT LOCK UP OF NUTRIENTS AND ROOT BURN CONTRACTOR TO PROVIDE SAMPLE SUBMITTAL TO LANDSCAPE ARCHITECT
- TOP SOIL SHALL BE FERTILE, FRIABLE AND FREE OF ROCKS LARGER THAN 1" DIAMETER, NOXIOUS WEED SEEDS OR EXTRANEOUS MATTER. TOP SOIL DELIVERED TO SITE SHALL HAVE ACIDITY RANGE OF PH 5.0 TO 7.0 AND SHALL CONTAIN NOT LESS THAN 15%
- BACKFILL MATERIAL SHALL MEET THE LEVEL OF TOP OF ROOTBALL. NEVER ALLOW NEW SOIL TO REACH PLANT STEM. BACKFILL SHALL BE PRESSED FIRMLY IN AROUND
- WHEN BACKFILLING IS COMPLETE, CONSTRUCT A WATER RETENTION BERM APPROXIMATELY THREE INCHES HIGH AND TWICE THE DIAMETER OF THE ROOT BALL SEE DETAIL
- 13. FILL BASIN INSIDE BERM WITH WATER AND ALLOW TO DRAIN. FILL ANY HOLES THAT APPEAR WITH ADDITIONAL BACKFILL MATERIAL. REPEAT UNTIL HOLES DO NOT APPEAR AND ALL SOIL AROUND ROOT BALL IS MOISTENED.
- ONE REDWOOD STAKE OF 1-1/2" BY 1-1/2" SHALL BE ISNTALLED FOR WINTER SUPPORT OF MULTI-STEMMED SHRUBS UNTIL ADEQUATE BRANCH STRENGTH IS ATTAINED, SEE DETAIL ONE LODGEPOLE STAKE OF TWO INCHES DIAMETER AND 8-10 FEET IN LENGTH SHALL BE INSTALLED AT THE WINDWARD SIDE OF ALL DECIDUOUS TREES. DOUBLE STAKING WILL BE REQUIRED IN WINDIER AND HEAVY SNOW LOAD AREAS. STAKE(S) SHALL BE INSERTED INTO GROUND AT EDGE OF ROOT BALL, NEVER INTO ROOTBALL. TREE GUYING METHOD

IS RECOMMENDED FOR LARGER CONIFEROUS TREES IN WINDIER LOCATIONS. SEE

- TWO TO THREE TREE TIES OF DURABLE CONSTRUCTION SHALL BE USED PER TREE. THE RUBBER OR MORE PLIABLE PORTION OF THE TIE SHALL BE LOOPED AROUND THE TRUNK AND WIRE OR OTHER MATERIAL LOOPED AROUND THE STAKE IN A FIGURE EIGHT CONFIGURATION. THE WIRES ARE THEN TWISTED TOGETHER. SHOULD SECURING THE TIE IN PLACE BE REQUIRED. NAIL OR STAPLE THE TIE TO THE STAKE ONLY. NEVER TO THE TREE. DO NOT TIE THE TRUNK TOO TIGHTLY AGAINST THE STAKE. ALLOW SOME ROOM TO MOVE IN BREEZE SO AS TO DEVELOP CALIPER STRENGTH IN TRUNK. THE TRUNK SHALL BE UPRIGHT AND STRAIGHT. SEE DETAIL
- IN THE FALL, AFTER LEAVES HAVE DROPPED, BRANCHES OF YOUNG TREES AND SHRUBS AND THOSE CLOSE TO SNOW REMOVAL/STORAGE AREAS SHALL BE BOUND IN AN UPWARD FASHION WITH VINYL TREE TAPE OR EQUAL TO MINIMIZE BREAKAGE FROM WEIGHT AND MOVEMENT OF SNOW, SEE DETAIL. THIS PROCEDURE SHOULD BE REPEATED EACH YEAR UNTIL TREES AND SHRUBS HAVE ATTAINED SUBSTANTIAL STRENGTH AND GIRTH. UNWRAP TREES AND SHRUBS IN SPRING, BEFORE NEW LEAVES APPEAR.
- ALL CHANGES TO PLANS TO BE APPROVED BY LANDSCAPE ARCHITECT UPON COMPLETION OF ALL PROJECT PHASES, INSTALLING CONTRACTOR SHALL NOTIFY LANDSCAPE ARCHITECT FOR INSPECTION AND FINAL APPROVAL.
- REGULAR MAINTENANCE PRUNING FERTILIZING, WEED, DEBRIS AND TRASH REMOVAL, REMOVE AND REPLACE ANY DEAD OR DYING PLANT MATERIAL, REPARATION OF IRRIGATION SYSTEM AS NEEDED. REPORT - PRIOR TO THE TWO YEAR ANNIVERSARY OF COMPLETION OF PROJECT A REPORT SHALL BE "PREPARED BY THE PROJECT LANDSCAPE CONTRACTOR OR LANDSCAPE ARCHITECT WHICH DOCUMENTS THE CONDITION OF THE LANDSCAPING, AND PROVIDES RECOMMENDATIONS AS TO WHETHER ANY LANDSCAPING SHOULD BE REPAIRED REPLACED OR INSTALLED. THE RECOMMENDATIONS OF THE REPORT SHALL BECOME A PART OF AND INCORPORATED INTO THE FINAL LANDSCAPE PLAN, AND THE LANDSCAPING SHALL BE REPAIRED, REPLACED AND INSTALLED WITHIN SIX MONTHS OF THE DATE OF APPROVAL OF THE REPORT."


DETAILS.

- SEEDING AREAS SHALL BE PREPARED BY TILLING SOIL TO A SIX INCH DEPTH REMOVING ROCK GREATER THAN FOUR INCHES IN DIAMETER FOR WILDFLOWER AND EROSION CONTROL AREAS AND TURF GRASS AREAS. SIX INCHES OF HUMUS OR COMPOST SHALL BE TILLED IN. FOR SEEDED AREAS EVENLY SPREAD TOPSOIL/MANUFACTURED SOIL ON TOP OF NATIVE SOIL.
- SEEDING/SOD AREA SHALL BE RAKED OR ROLLED TO A SMOOTH SURFACE FILLING HOLES AND REMOVING ROCK AS NECESSARY.
- SEED SHALL THEN BE BROADCAST AT THE RATE PRESCRIBED BY SEED COMPANY OR LANDSCAPE ARCHITECT.
- APPLY BIOSOL MIX GRANULAR FERTILIZER AT RATE RECOMMENDED. SEED SHALL THEN BE COVERED WITH A 1/8 TO 1/4" LAYER OF HUMUS OR EQUAL TO RETAIN MOISTURE AND PREVENT WIND AND BIRDS FROM CARRYING SEED AWAY.
- ADEQUATE MOISTURE SHALL BE MAINTAINED IN SEEDING AREA UNTIL SEEDLINGS REACH A HEIGHT OF TWO INCHES WHEN REGULAR WATERING MAY BEGIN. FREQUENCY AND DURATION OF INITIAL WATERING WILL VARY ACCORDING TO DAILY TEMPERATURES. SUN/SHADE PERIODS, WIND, SOIL, SLOPE AND ASPECT. CONTRACTOR TO ENSURE THAT APPROPRIATE SCHEDULE IS EMPLOYED FOR THIS AREA.

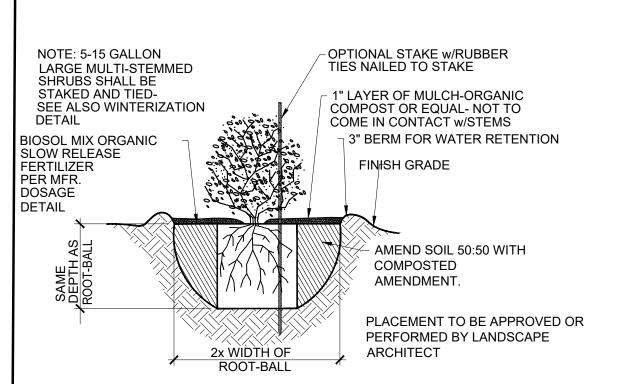

5) SHRUB PLANTING DETAIL

NOT TO SCALE

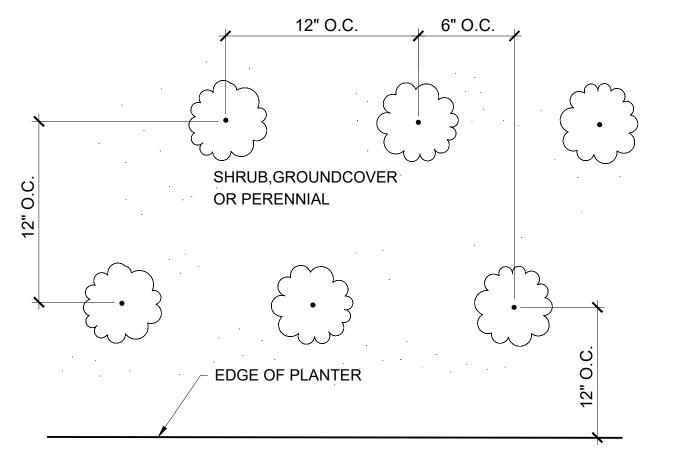


MASS PLANTING DETAIL

NOT TO SCALE

1. BOULDERS TO BE PLACED UNDER DIRECTION OF LANDSCAPE ARCHITECT

2 BURY BOULDERS 1/2-1/3 TO APPEAR 'NATURAL' WITH WEATHERED SIDE UP, UNWEATHERED SIDES BURIED AS POSSIBLE

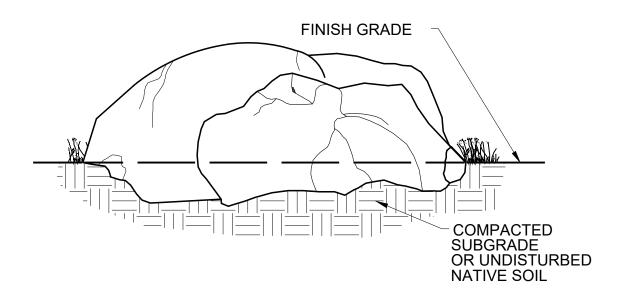

BOULDER PLACEMENT DETAIL

NOT TO SCALE

6. PREPARE BACKFILL MIX IN ACCORDANCE WITH SOIL TESTING LAB RECOMMENDATIONS **BOX TREE PLANTING DETAIL NOT TO SCALE** SPACE 3-**GUYLINES** PREVAILING WINDS **EQUIDISTANT** AROUND TREE 1/2" RUBBER HOSE WITH 10 GA. GALV. WIRE INSIDE, LEAVE 2" CLEAR BETWEEN TRUNK AND HOSE ON ALL SIDES. STAKE TO SECURE ROOT PLASTIC FLAGGING PLACE ON ALL CABLES LOCATE 6" TURN 6" WATERING BASIN, W/3" DEPTH BUCKLES ON EACH MULCH AS SPECIFIED ON PLANS CABLE KEEP MULCH 4" FROM TRUNK, SET

1. REMOVE ALL NURSERY STAKES, TIES & TAGS - TREES MUST STAND UPRIGHT TO BE ACCEPTABLE

2. REMOVE DAMAGED BRANCHES - DO NOT REMOVE CENTRAL LEADER OR ANY LOWER BRANCHES.

GRADE WATERING BASIN SUCH THAT WATER COLLECTS AT OUTER EDGE OF ROOT BALL, NOT AT TRUNK.

3. TOP OF ROOT BALL TO BE THE SAME AS EXIST. GRADE - NO NATIVE SOIL TO BE PLACED ON

-24 - 36" BOX TREE

OF ROOT BALL.

PLANT CONTAINER.

-CINCHTIES OR EQUAL

-REMOVE BOX MATERIAL.

OR OTHER MATERIALS.

-(2) 2" x 8' LODGEPOLE PINE STAKES -

COMPLETELY REMOVE ANY WIRE

SCARIFY EDGES OF PLANT HOLE - HOLE

DEPTH TO BE SAME AS DEPTH OF ORIGINAL

BACKFILL W/ PREPARED SOIL SCREENED

GREATER THAN ¹/₂" DIA. WATER SETTLE

ROOTBALL 1-2" ABOVE GRADE.

AMEND SOIL 50:50 WITH

COMPOSTED AMENDMENT.

LOOSEN SIDES OF

AWAY FROM ROOT

PLANTING HOLE,

SLOPE ~45 DEG

FREE OF ROCKS, CLODS & DEBRIS

STAKE INTO UNDISTURBED SOIL OUTSIDE

CONIFER PLANTING DETAIL

STAKES TO REMAIN ONLY UNTIL

TREE HAS GROWN SUFFICIENT

HEAVY SNOW LOAD AREAS

ROOTS TO SUPPORT ITSELF, OR IN

4" DEEP WATERING BASIN FILL

EDGES OF PLANTING HOLE

TO BE SLOPED AWAY FROM

ROOT BALL AT ~45 DEG.

DUCKBILL

ANCHORS SIZE

AS NECESSARY

UN-DISTURBED SOIL

5. THOROUGHLY WATER IMMEDIATELY AFTER PLANTING


W/ 4" GROUND FIR BARK. KEEP

BARK 4" AWAY FROM TRUNK.

NOT TO SCALE - 2"Ø x10' TREATED LODGEPOLE STAKE TREES IN HIGH WIND OR HEAVY RUBBER TREE TIE W/ SNOW LOAD AREAS MAY FIGURE 8 LOOP NAILED IN REQUIRE 2 STAKES. STAKE(S) TO PLACE TO STAKE REMAIN ONLY UNTIL TREE HAS 1" ORGANIC COMPOST **GROWN SUFFICIENT ROOTS TO** MULCH OR EQUAL - NOT SUPPORT ITSELF, OR IN HEAVY TO TOUCH TRUNK SNOW LOAD AREAS 3" BERM FOR AMEND SOIL 50:50 WITH WATER RETENTION COMPOSTED AMENDMENT. EDGES **FINISH GRADE** OF HOLE TO BE SCARIFIED AND AT ~45 DEG SLOPE AWAY FROM ROOT PLACEMENT TO BE APPROVED BY LANDSCAPE **ARCHITECT** 2x WIDTH OF ROOT

TREE PLANTING DETAIL

NOT TO SCALE

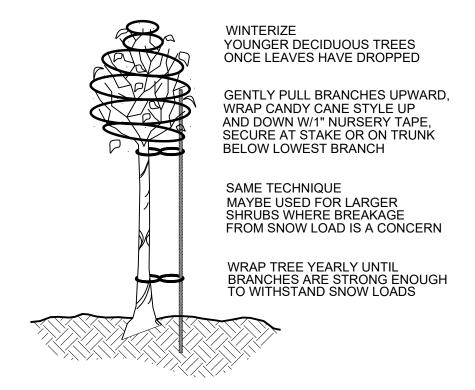

PRELIMINARY:
PROTFORUCTION
NOTRUCTION
NOTRUCTION TREE & SHRUB WINTERIZATION DETAIL

NOT TO SCALE

TRUCKEE OVERHEAD **DOOR**

13418 DONNER PASS ROAD TRUCKEE, CA APN 018-363-012 NEVADA COUNTY

Engineer: BILL QUESNEL **ACUMEN ENGINEERING** BOX 3497 TRUCKEE, CA 96161 530.550.8068


PLANNER: Gavin Ball. Consulting Landuse Planner P.O. Box 313 Truckee, CA 96160 530.582.4244

DESIGN + CONSULTING Robie W. Litchfield, RLA, ASLA 101 Empty Saddle Trail, Suite 242

> robie@Litchfield-DC.com 208.450.1110 California License #4197 Nevada License #429

Hailey, ID 83333

Idaho License #LA16881

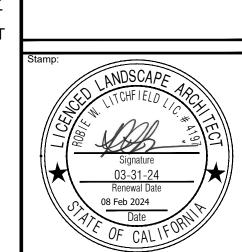


Drawn By: RWL Checked By: RWL Drawing Date: 8 Feb 2024 The use of these plans and specifications is restricted to the original site for which they were prepared and publication thereof is expressly


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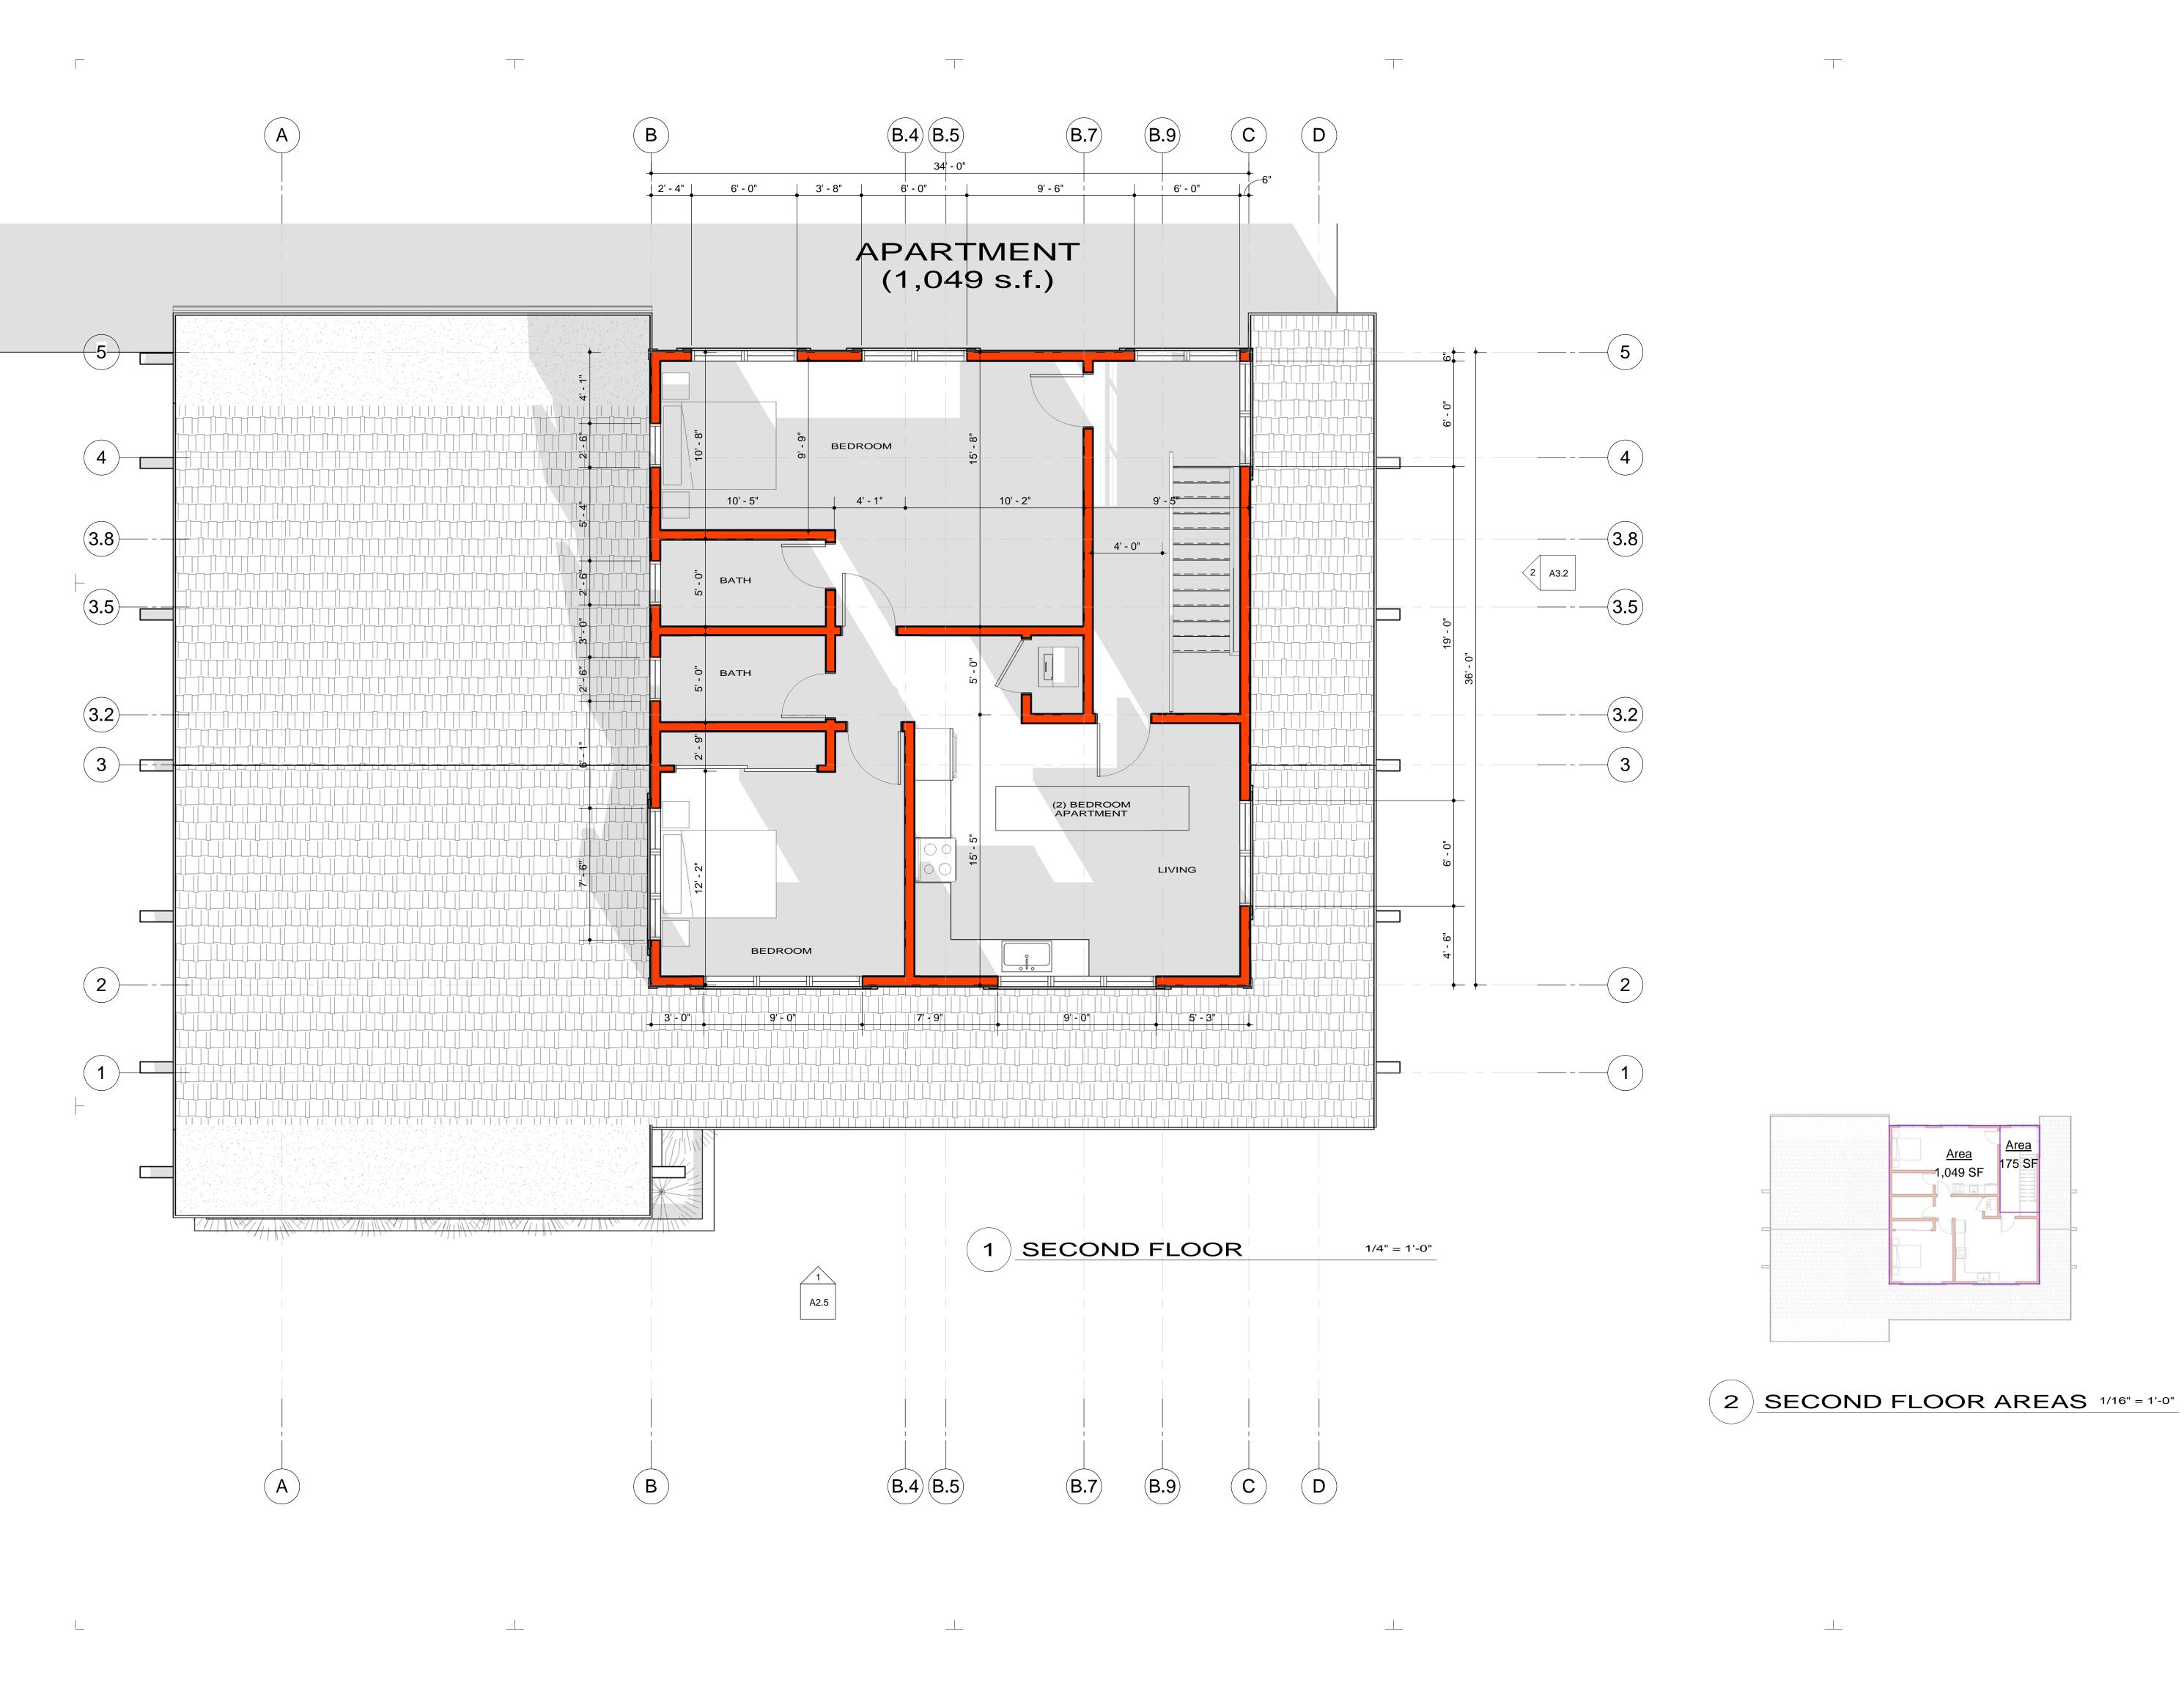
PLANTING NOTES AND DETAILS


Scale: NONE

FOUR OF 4



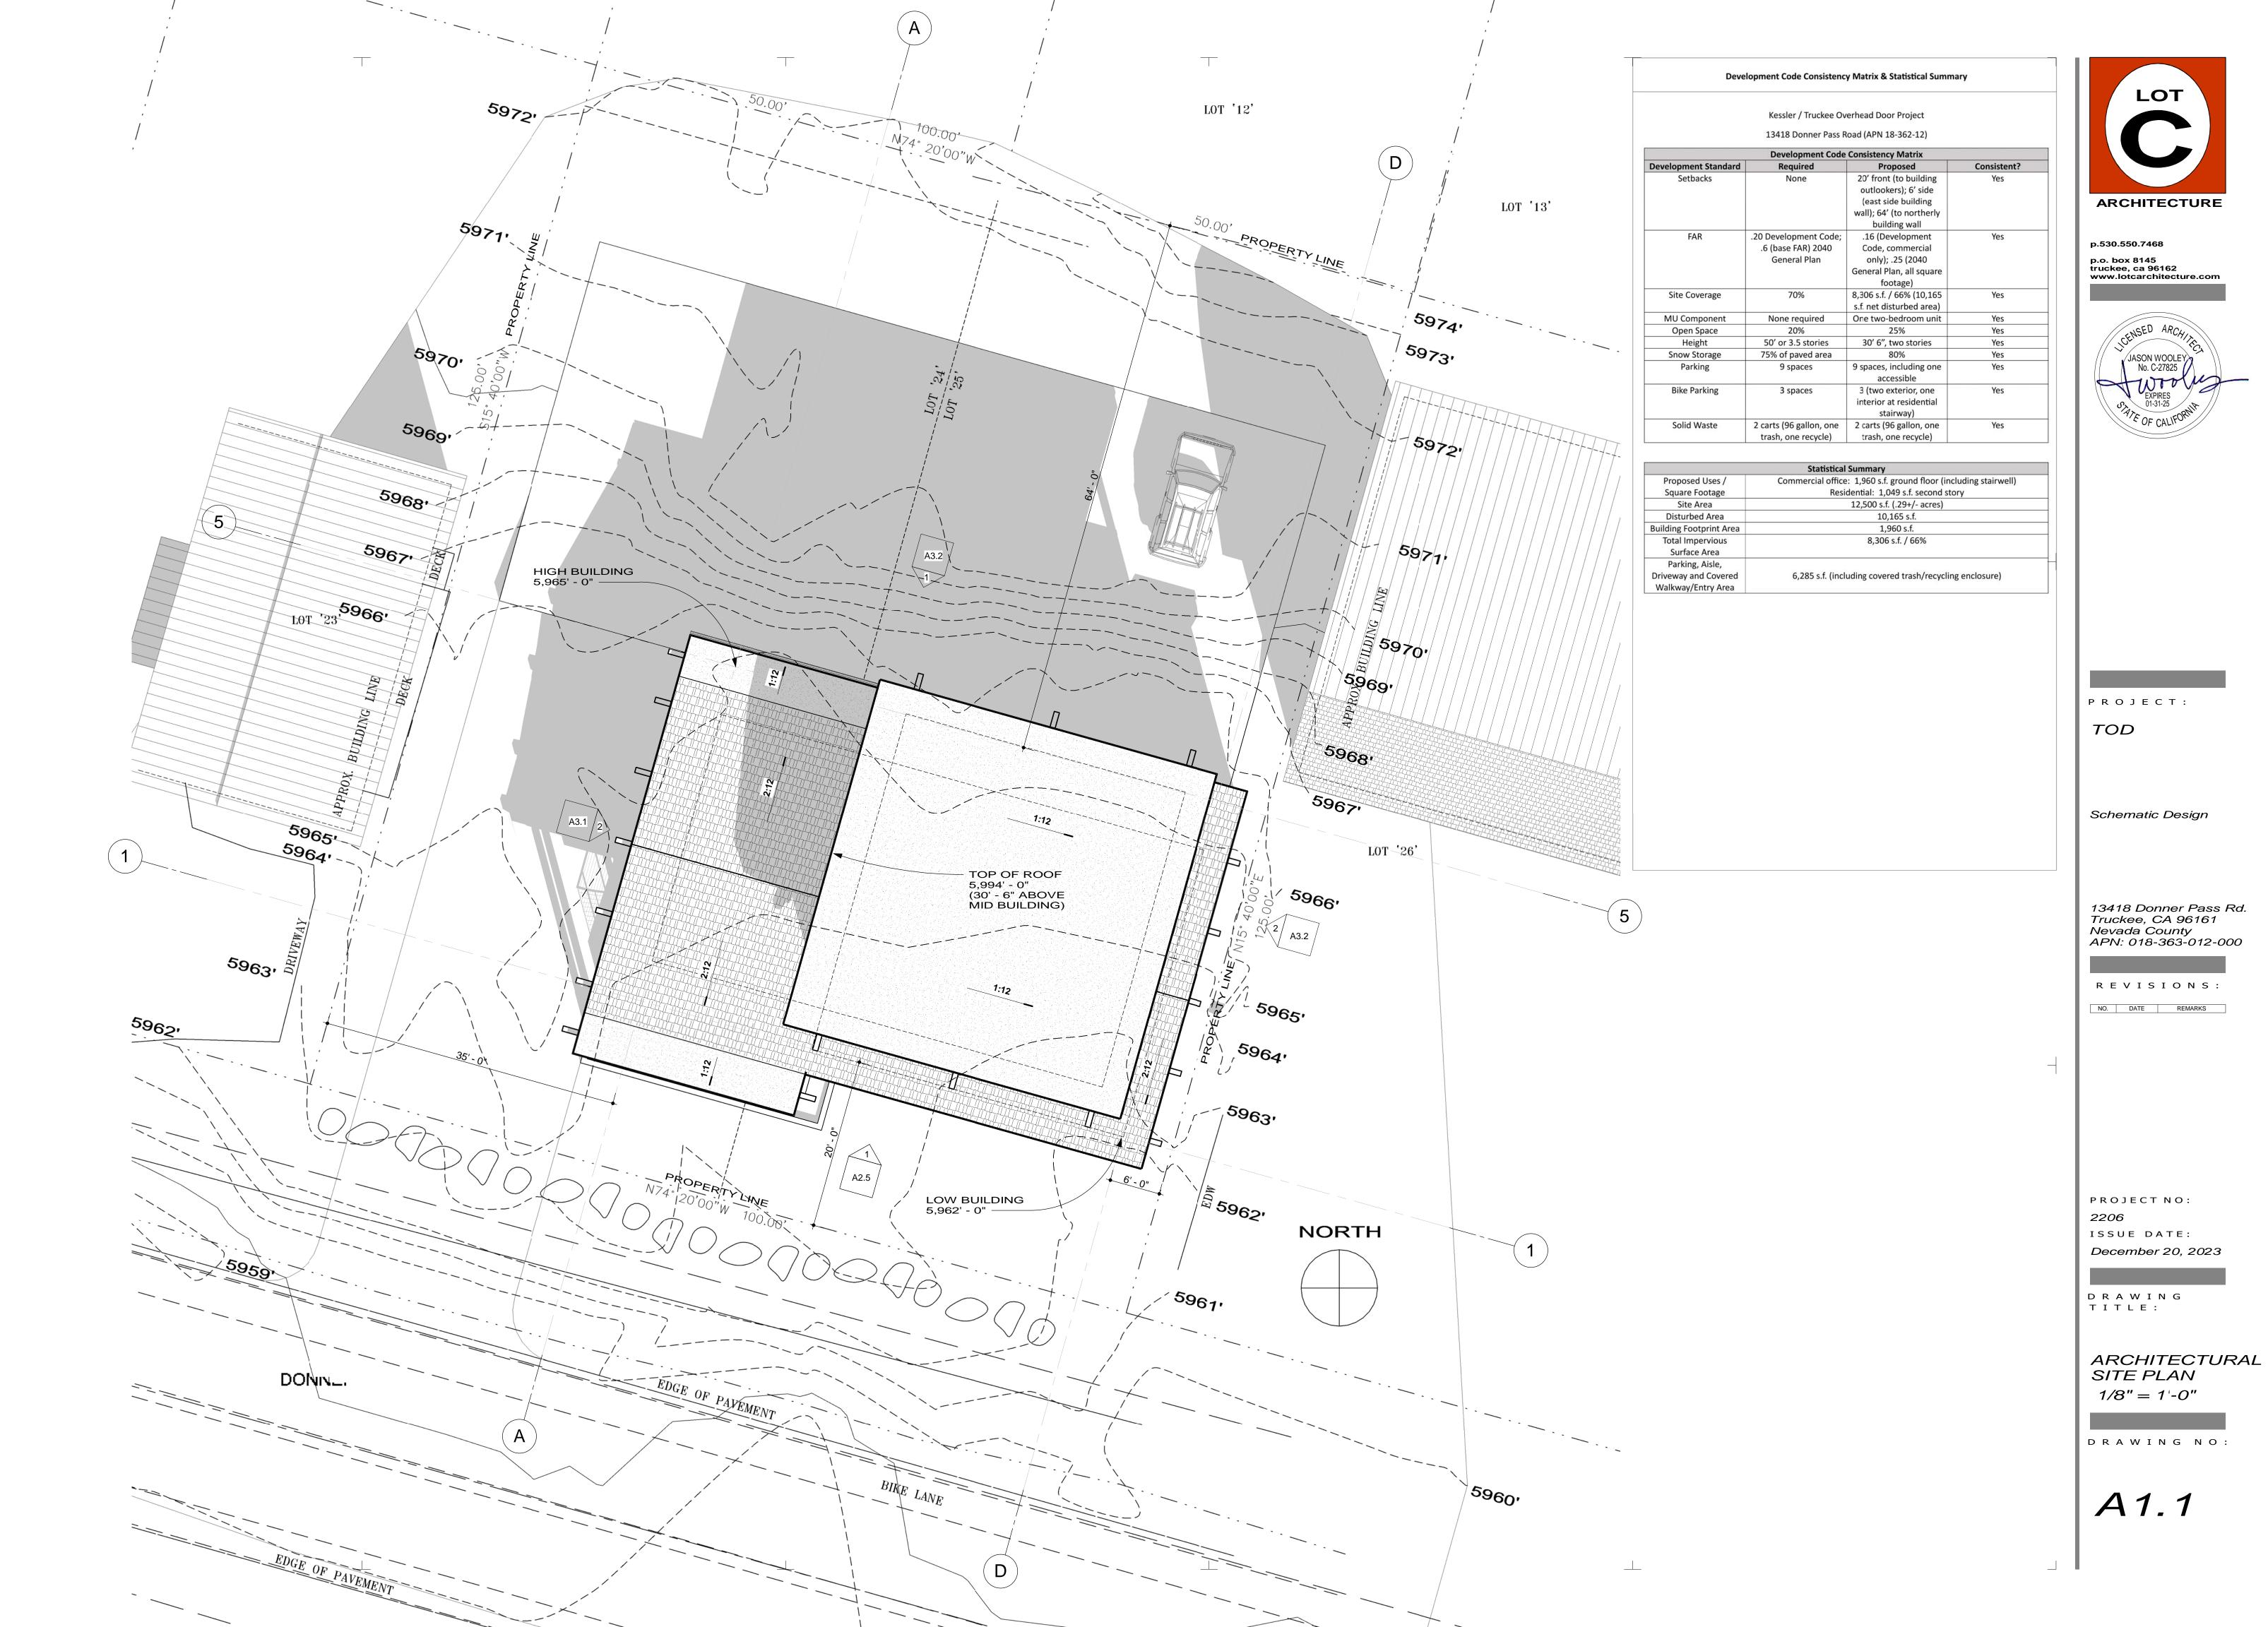

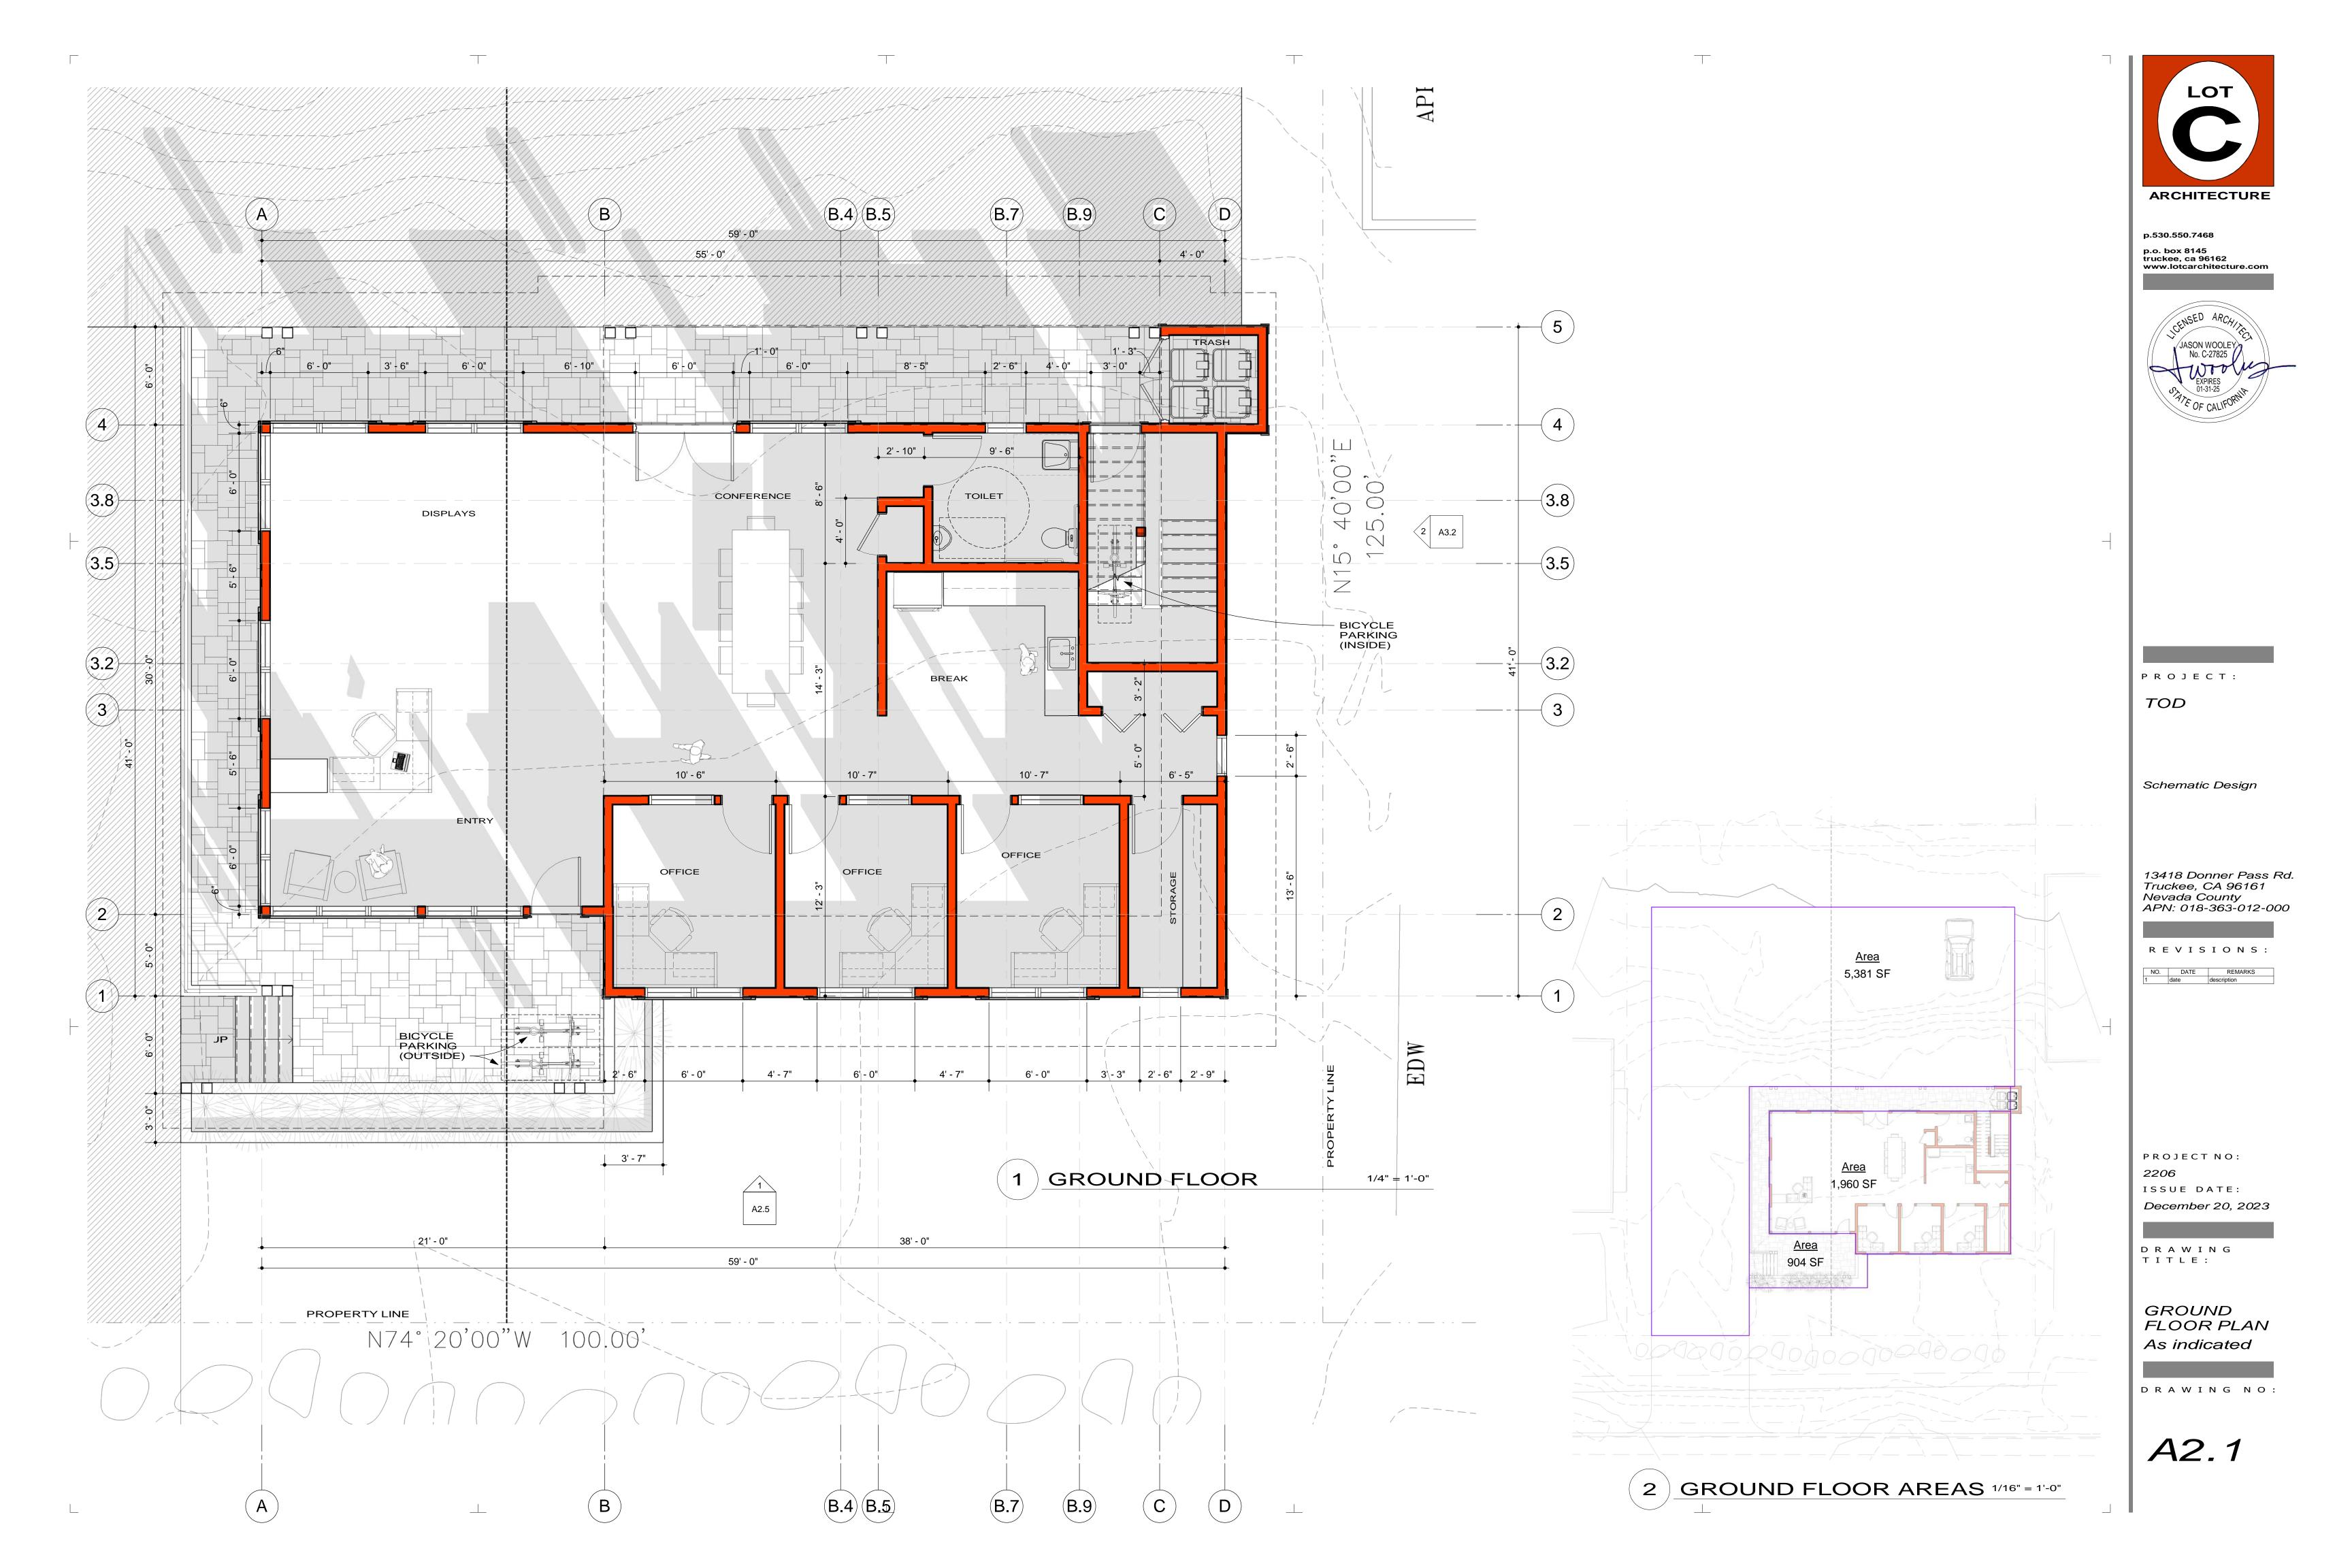

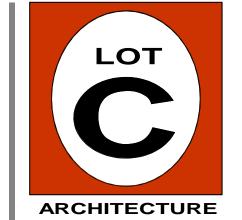



PROJECT:

Schematic Design

13418 Donner Pass Rd. Truckee, CA 96161 Nevada County APN: 018-363-012-000

R E V I S I O N S :

PROJECT NO:

2206
ISSUE DATE:


December 20, 2023


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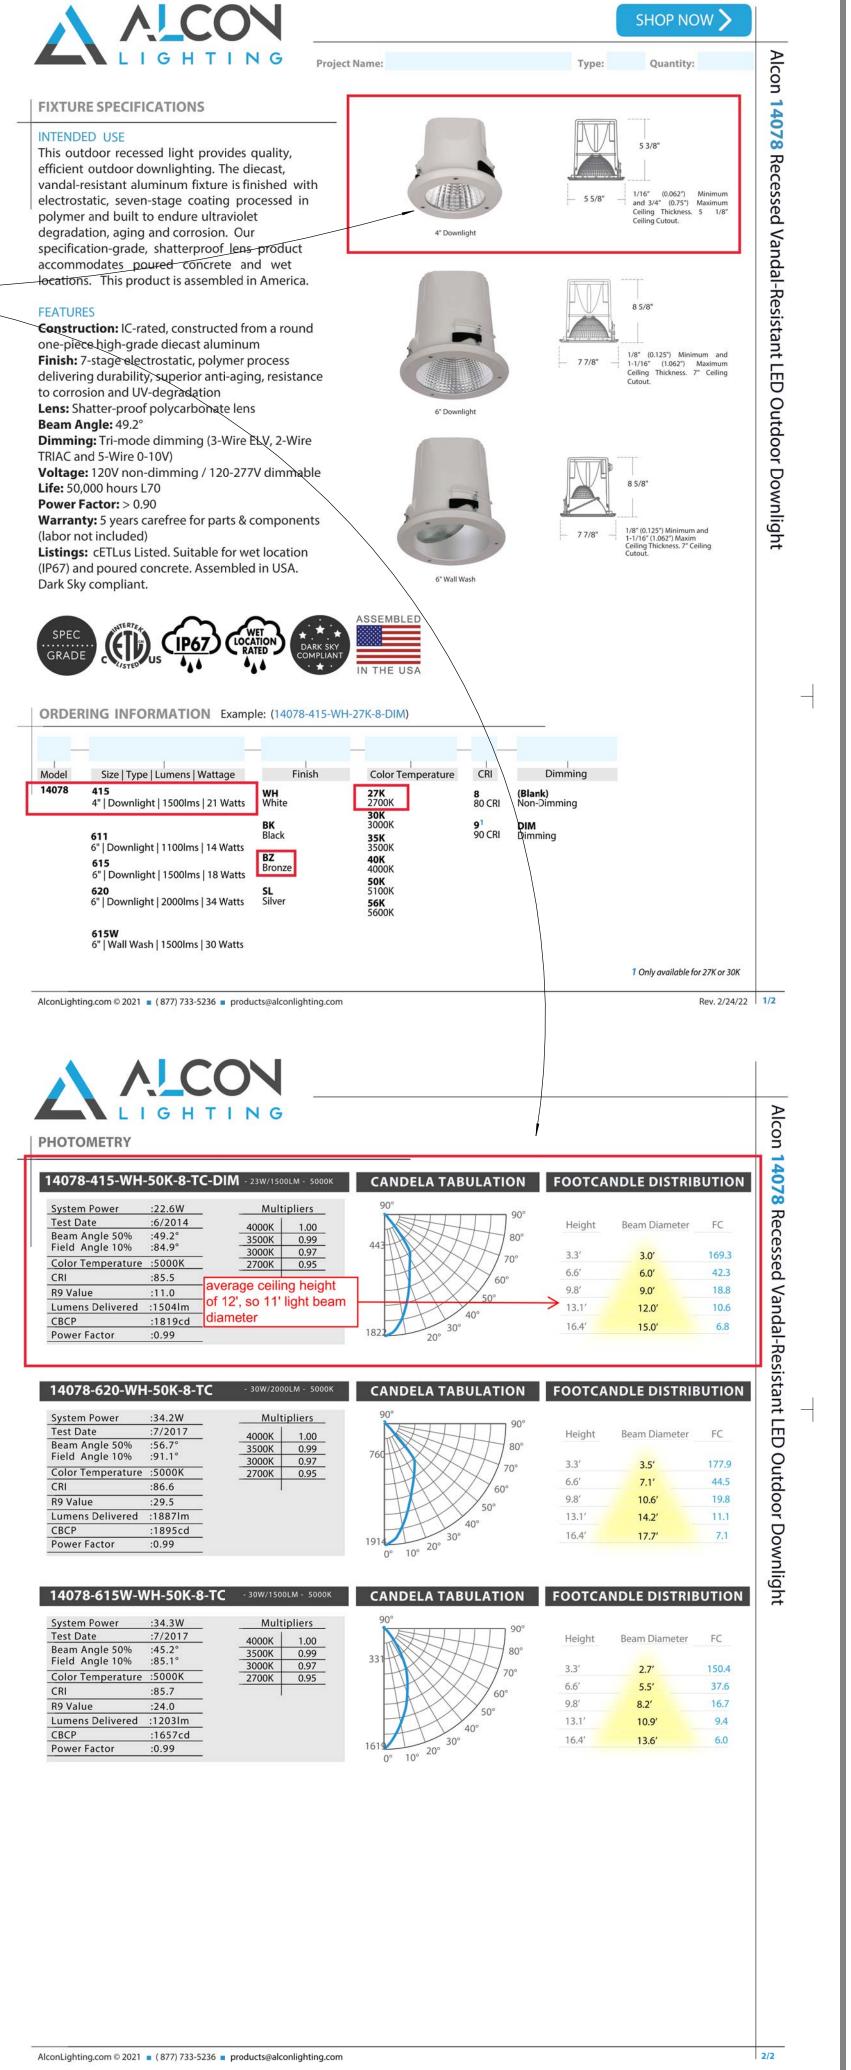
SECOND FLOOR PLAN As indicated


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A2.2





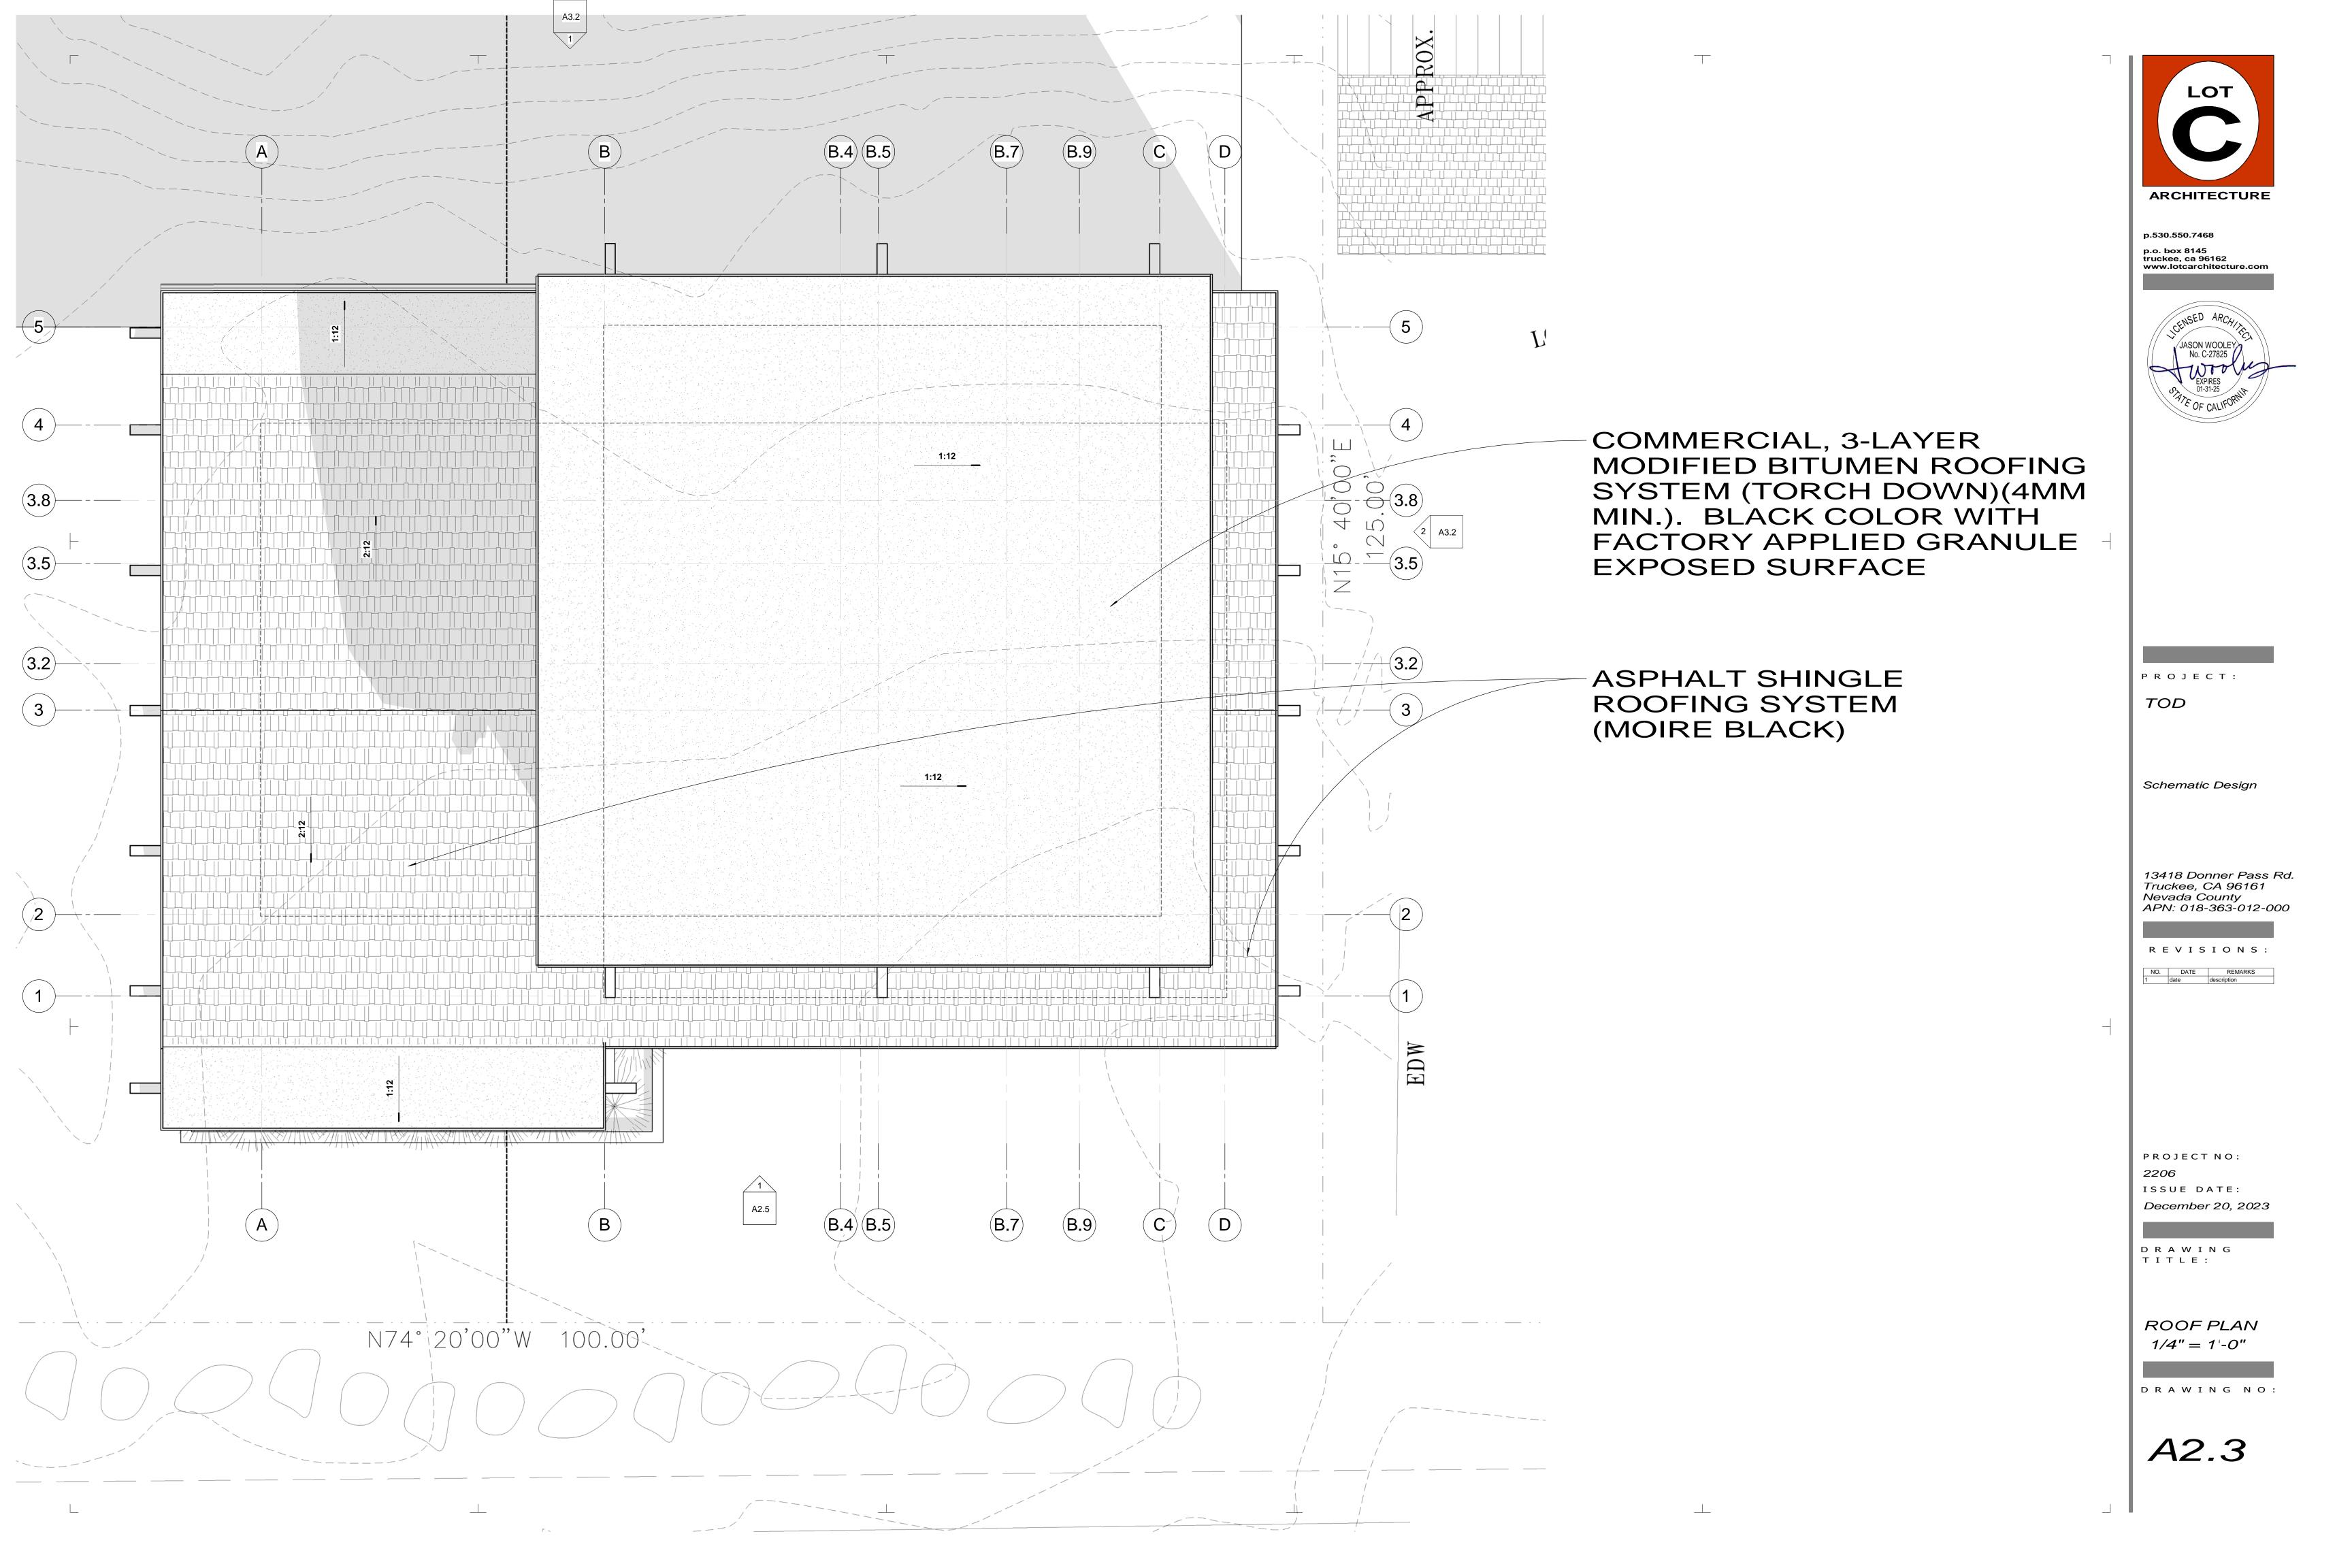

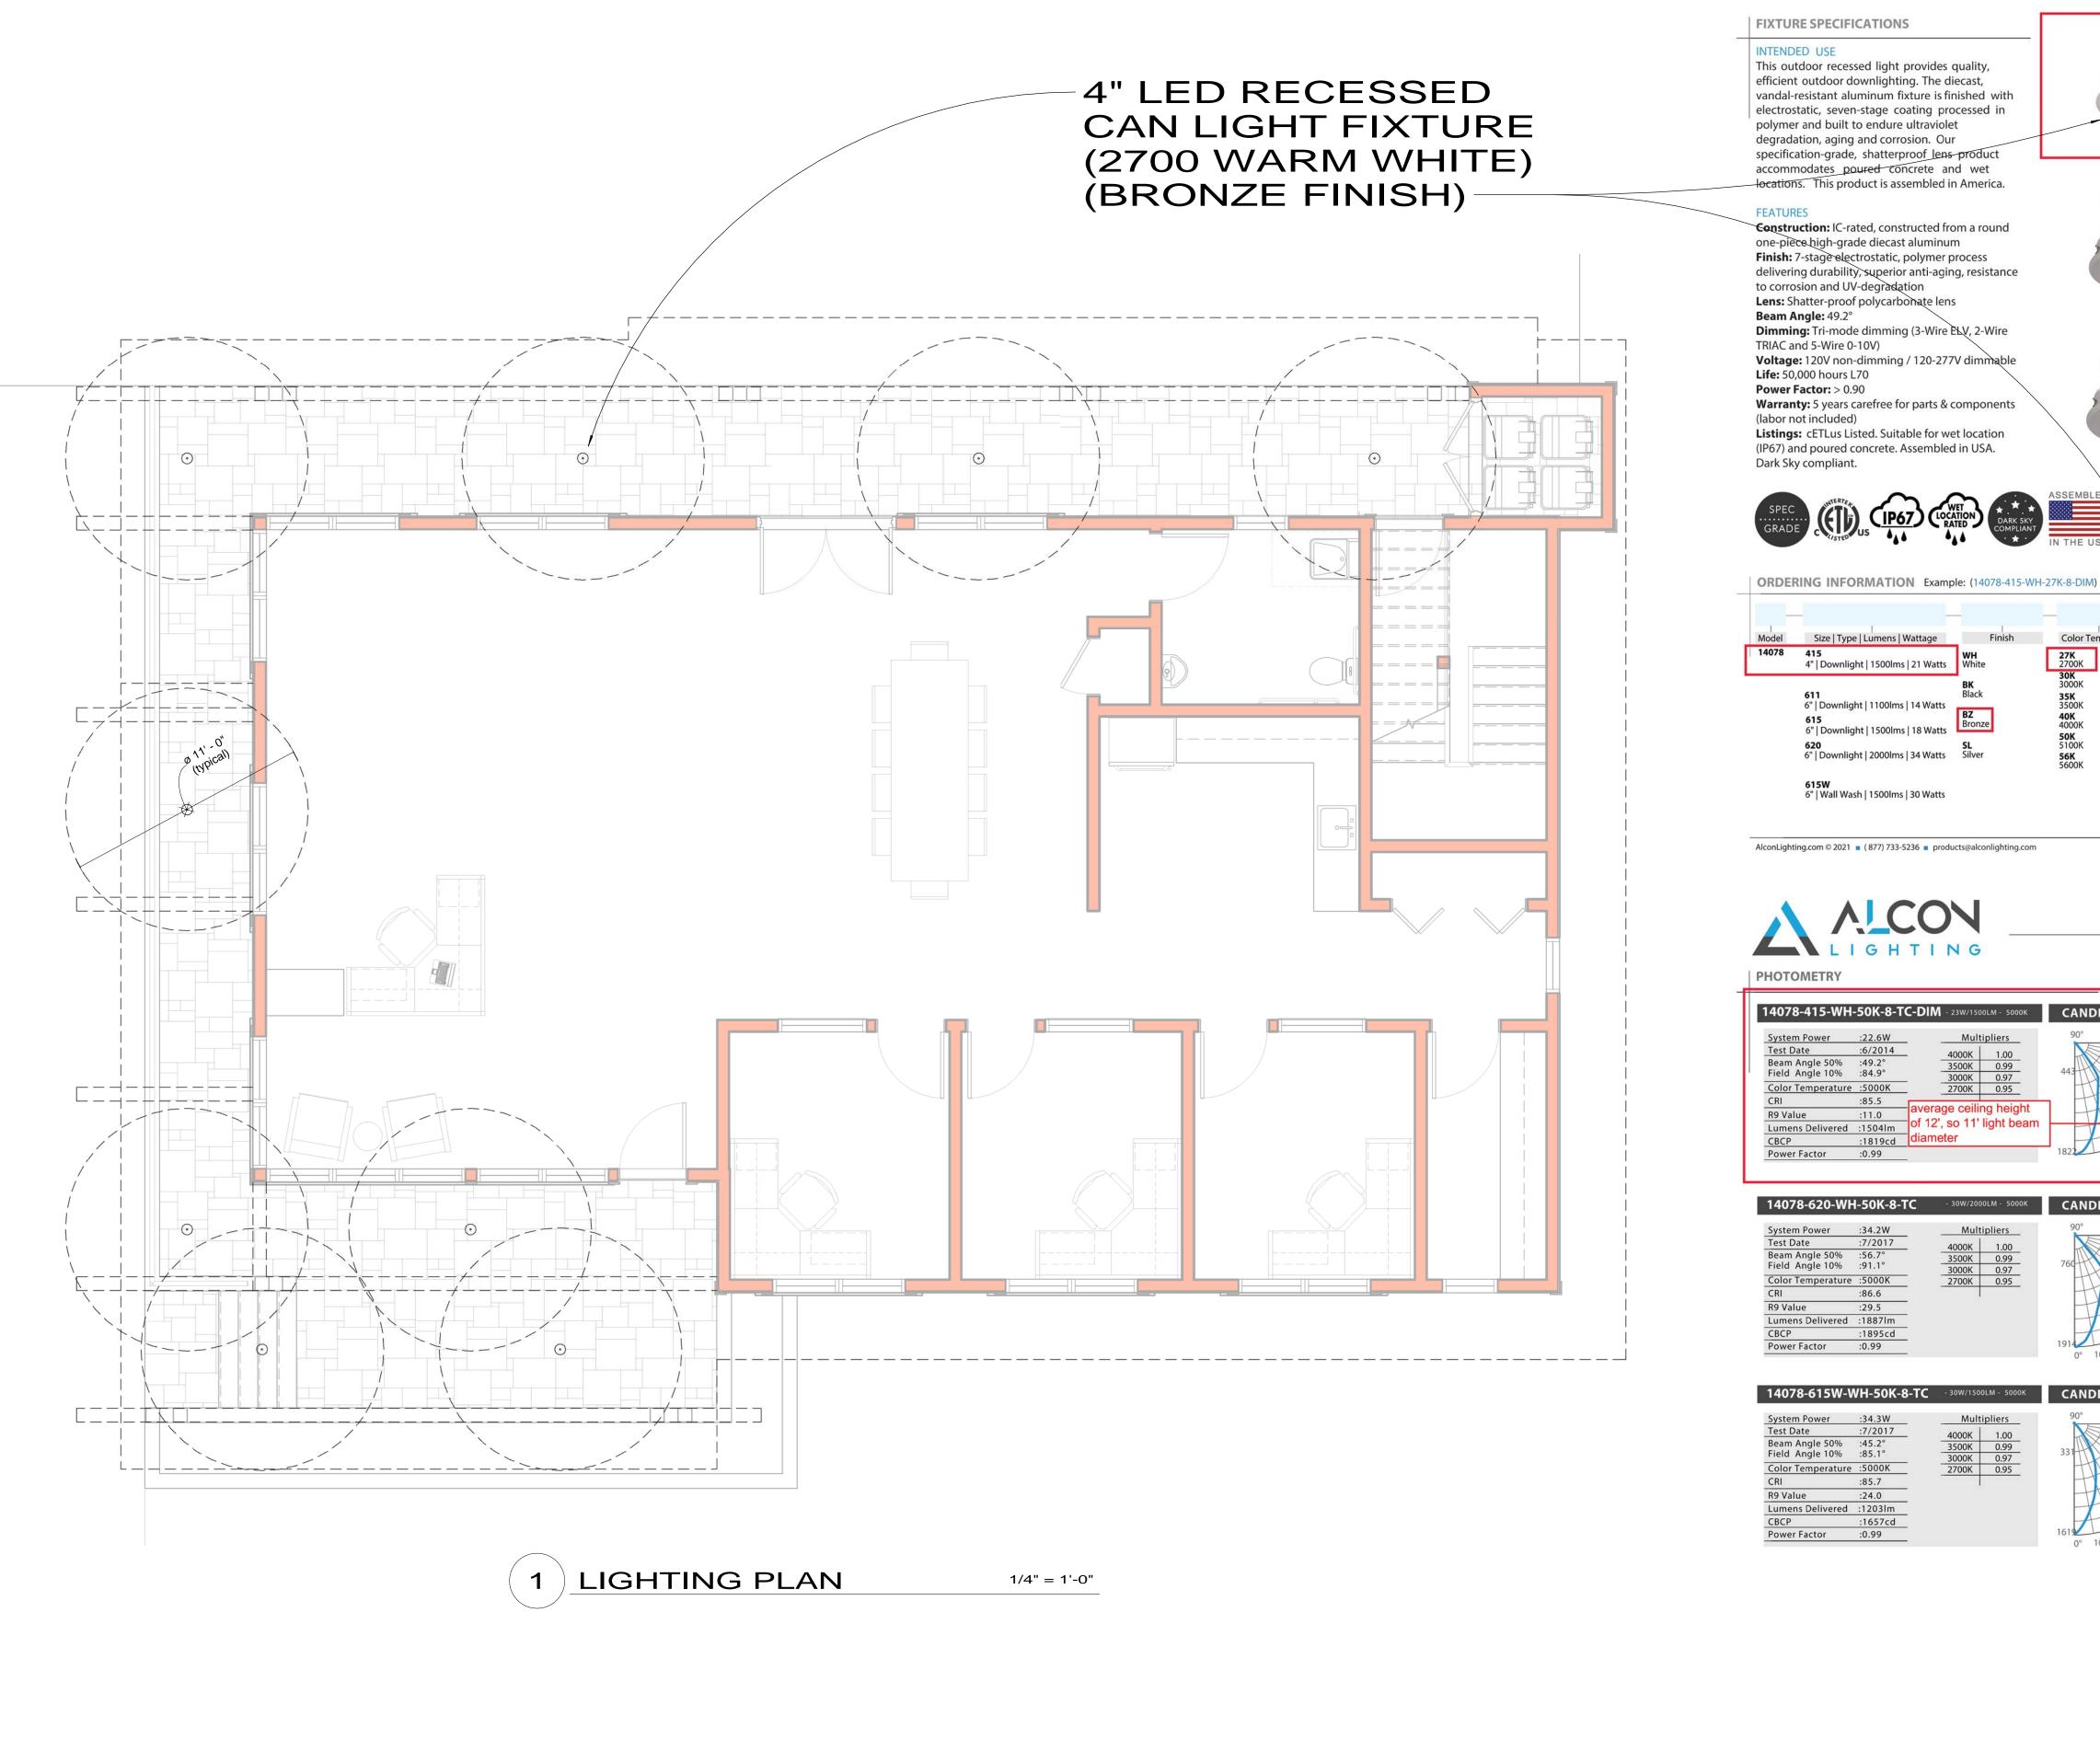

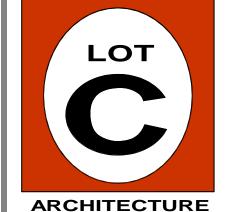

PROJECT:

Schematic Design

13418 Donner Pass Rd. Truckee, CA 96161 Nevada County APN: 018-363-012-000

R E V I S I O N S :

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2206

ISSUE DATE:

December 20, 2023


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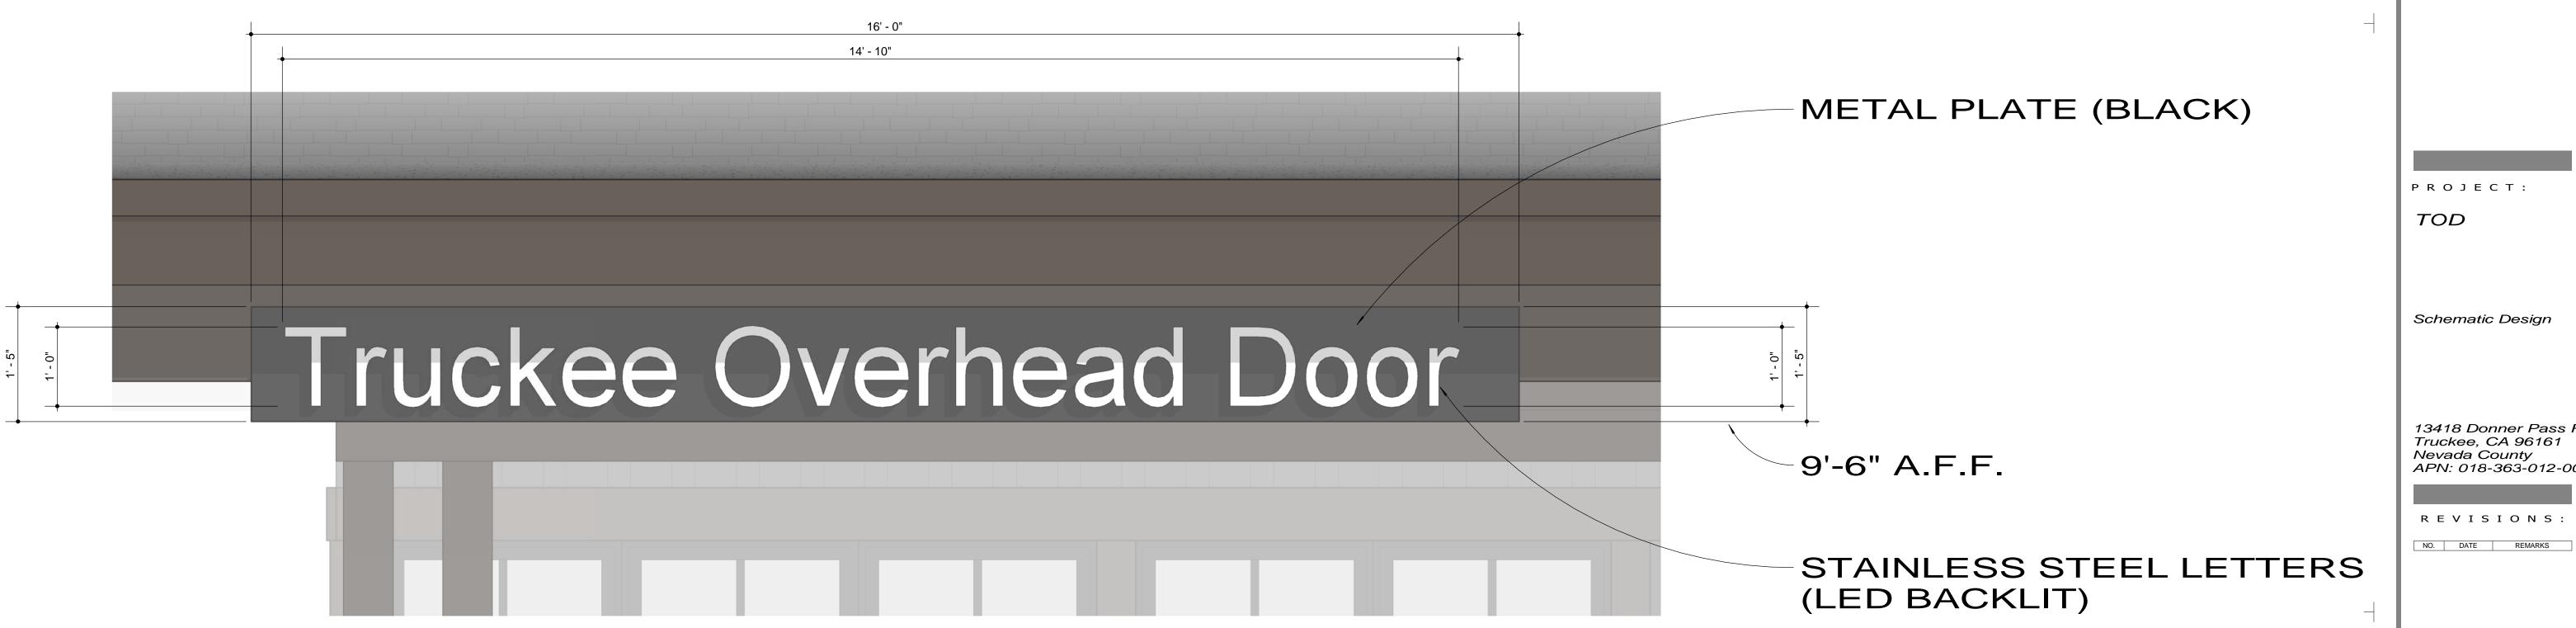
EXTERIOR LIGHTING PLAN 1/4" = 1'-0"

DRAWING NO:

A2.4





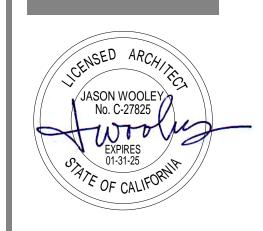

PROJECT:

Schematic Design

13418 Donner Pass Rd. Truckee, CA 96161 Nevada County APN: 018-363-012-000

REVISIONS:

PROJECT NO: 2206 ISSUE DATE:


December 20, 2023


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SIGNAGE 1'' = 1' - O''

DRAWING NO:


A2.5



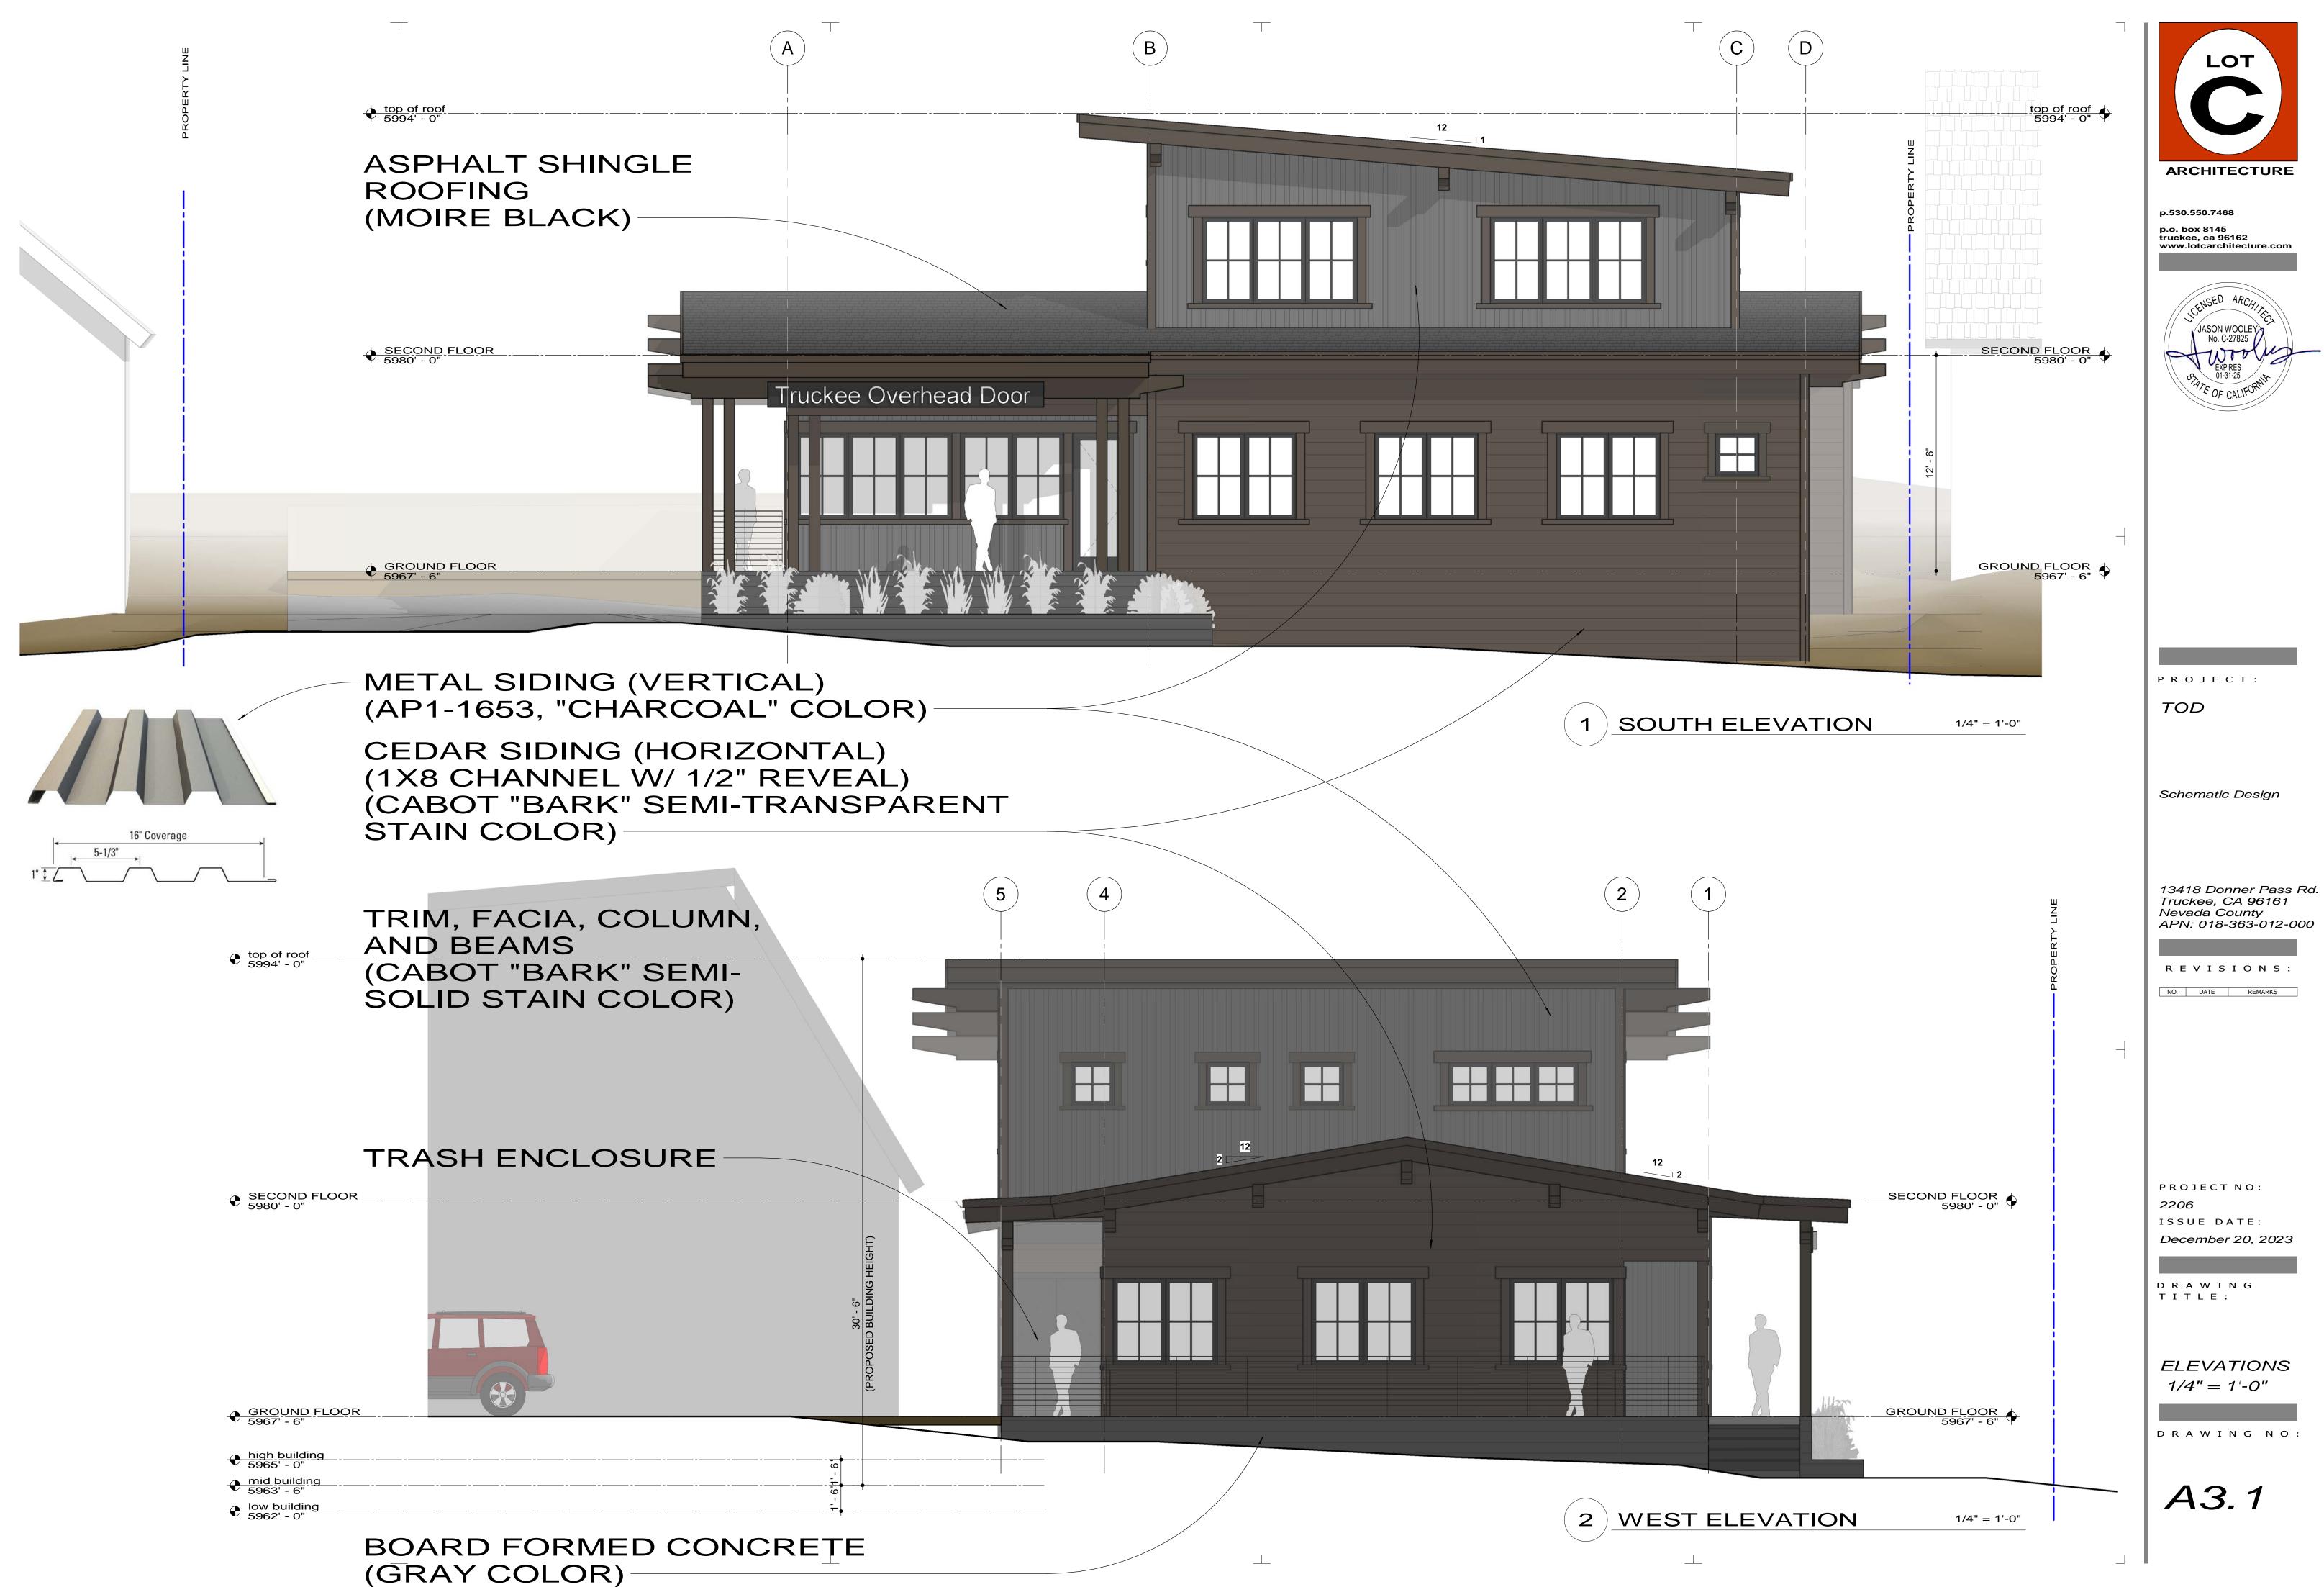

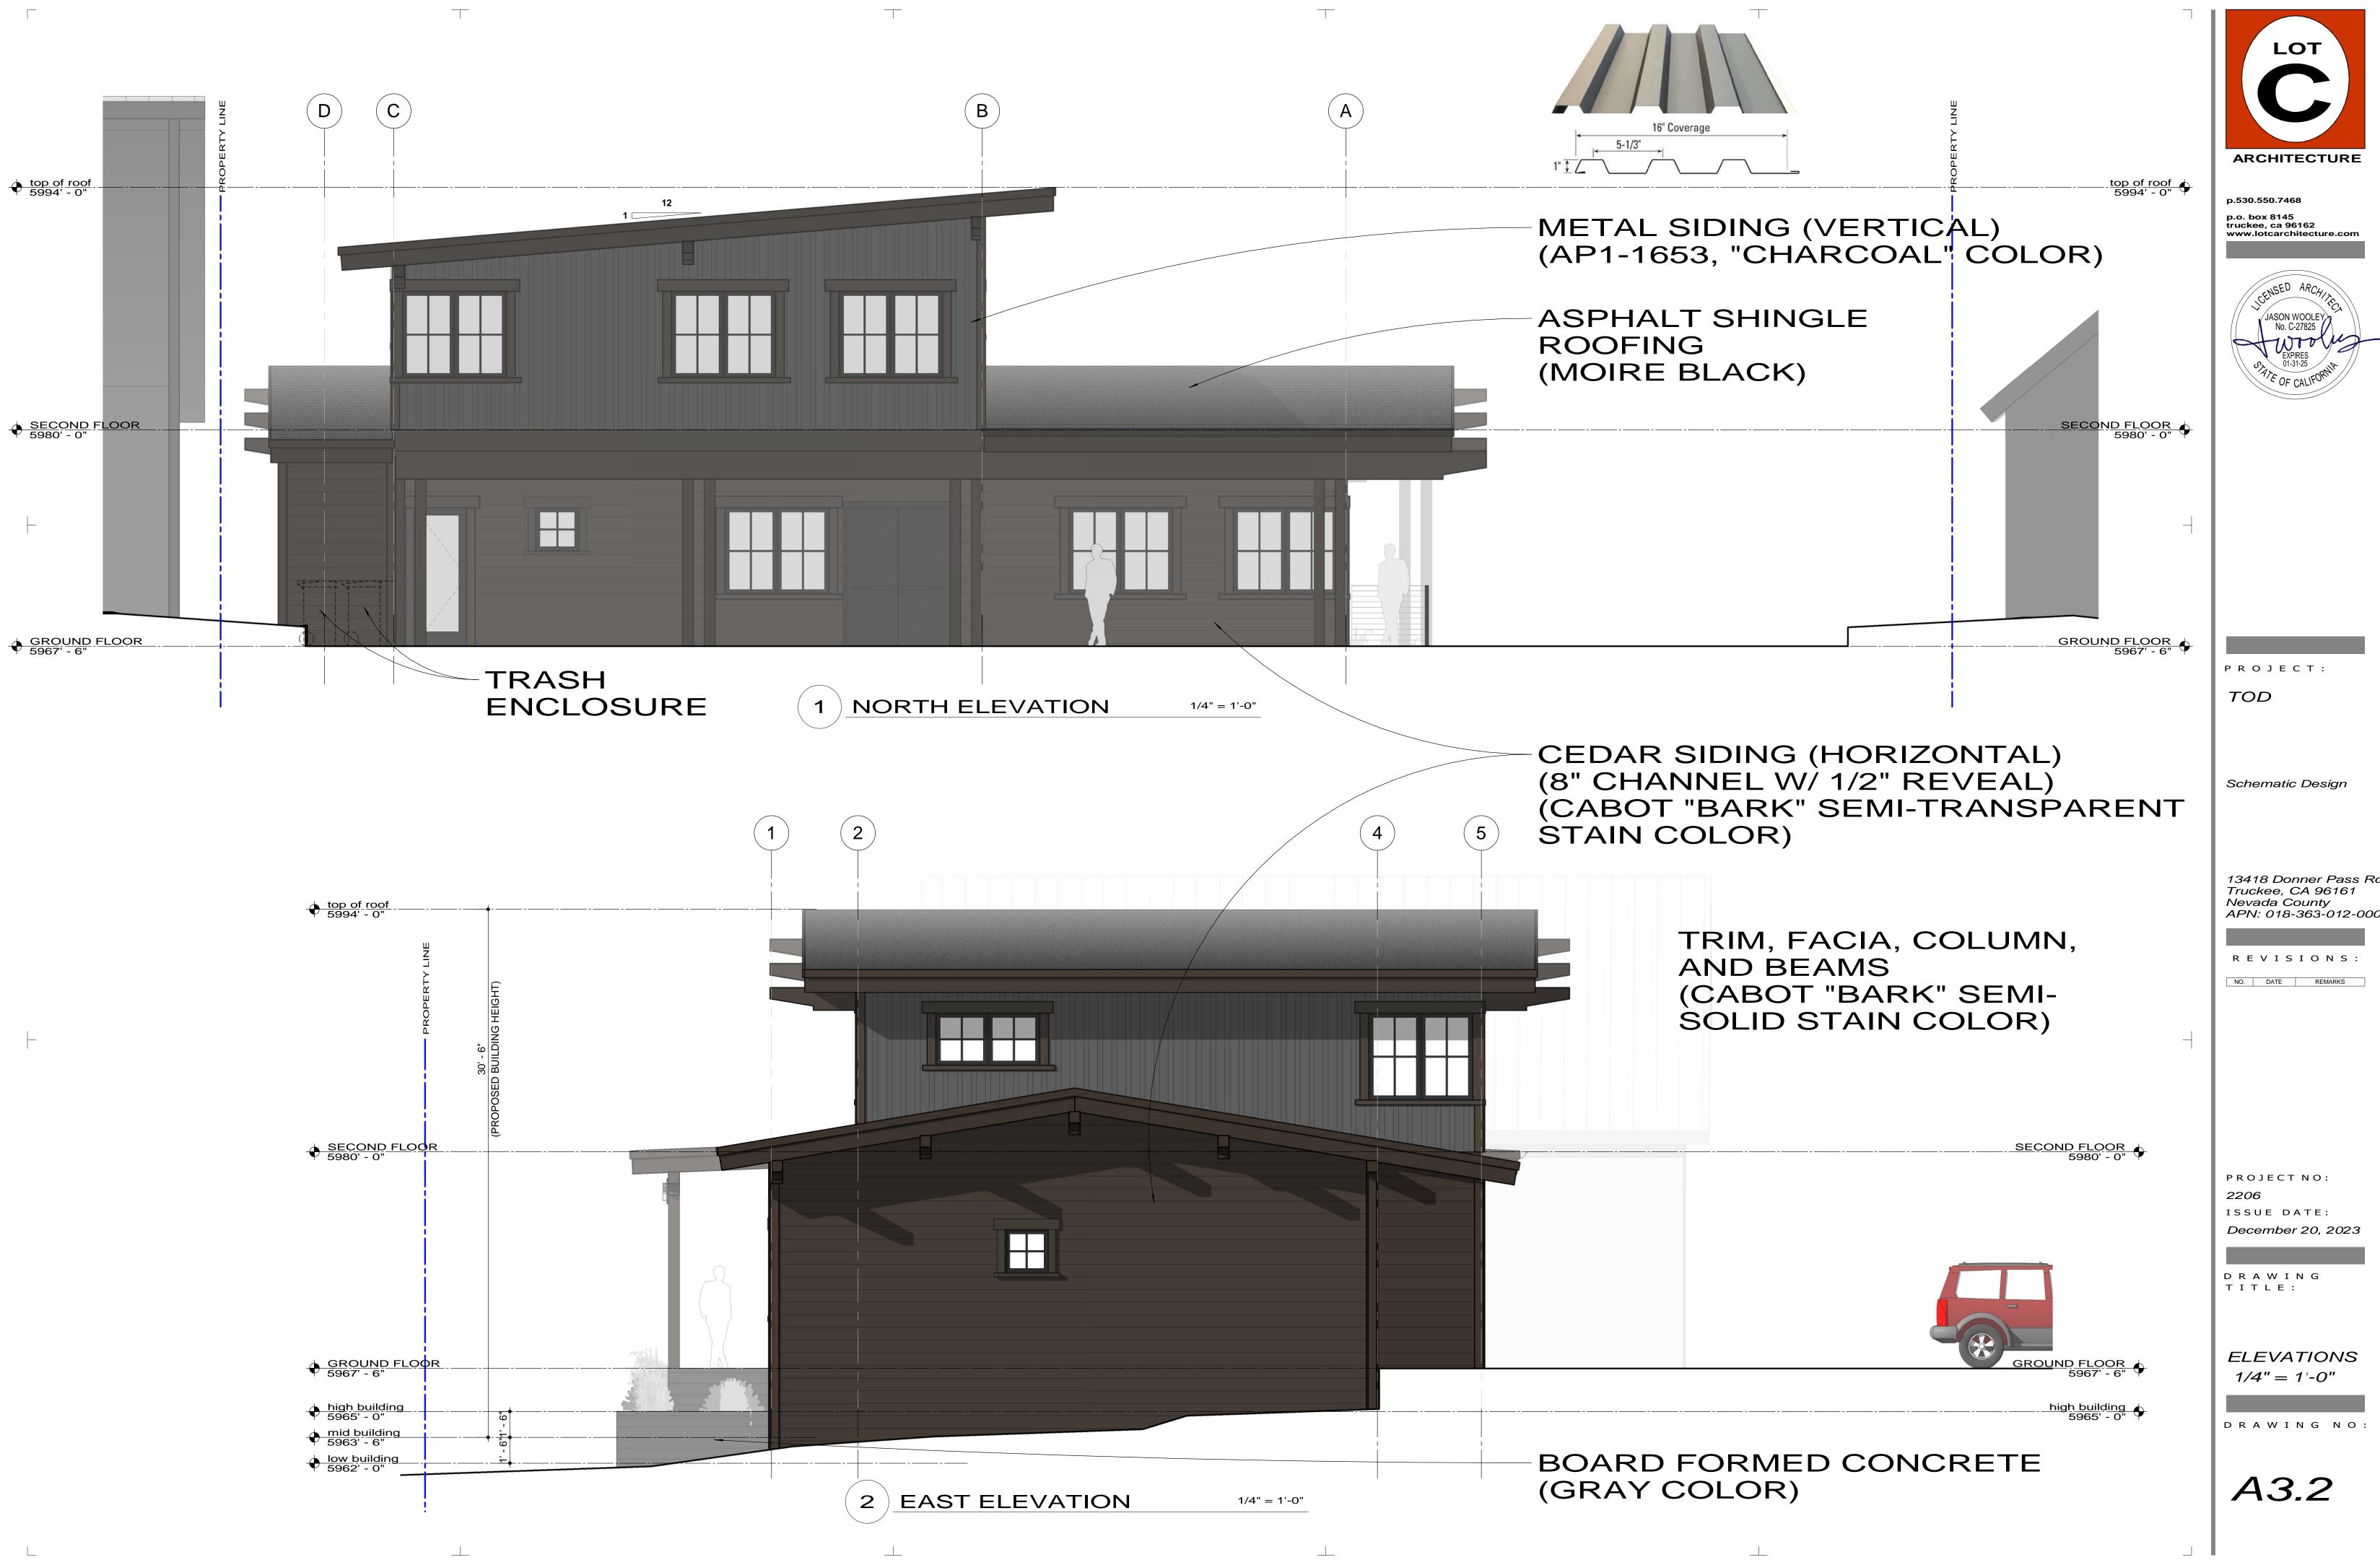

13418 Donner Pass Rd. Truckee, CA 96161 Nevada County APN: 018-363-012-000

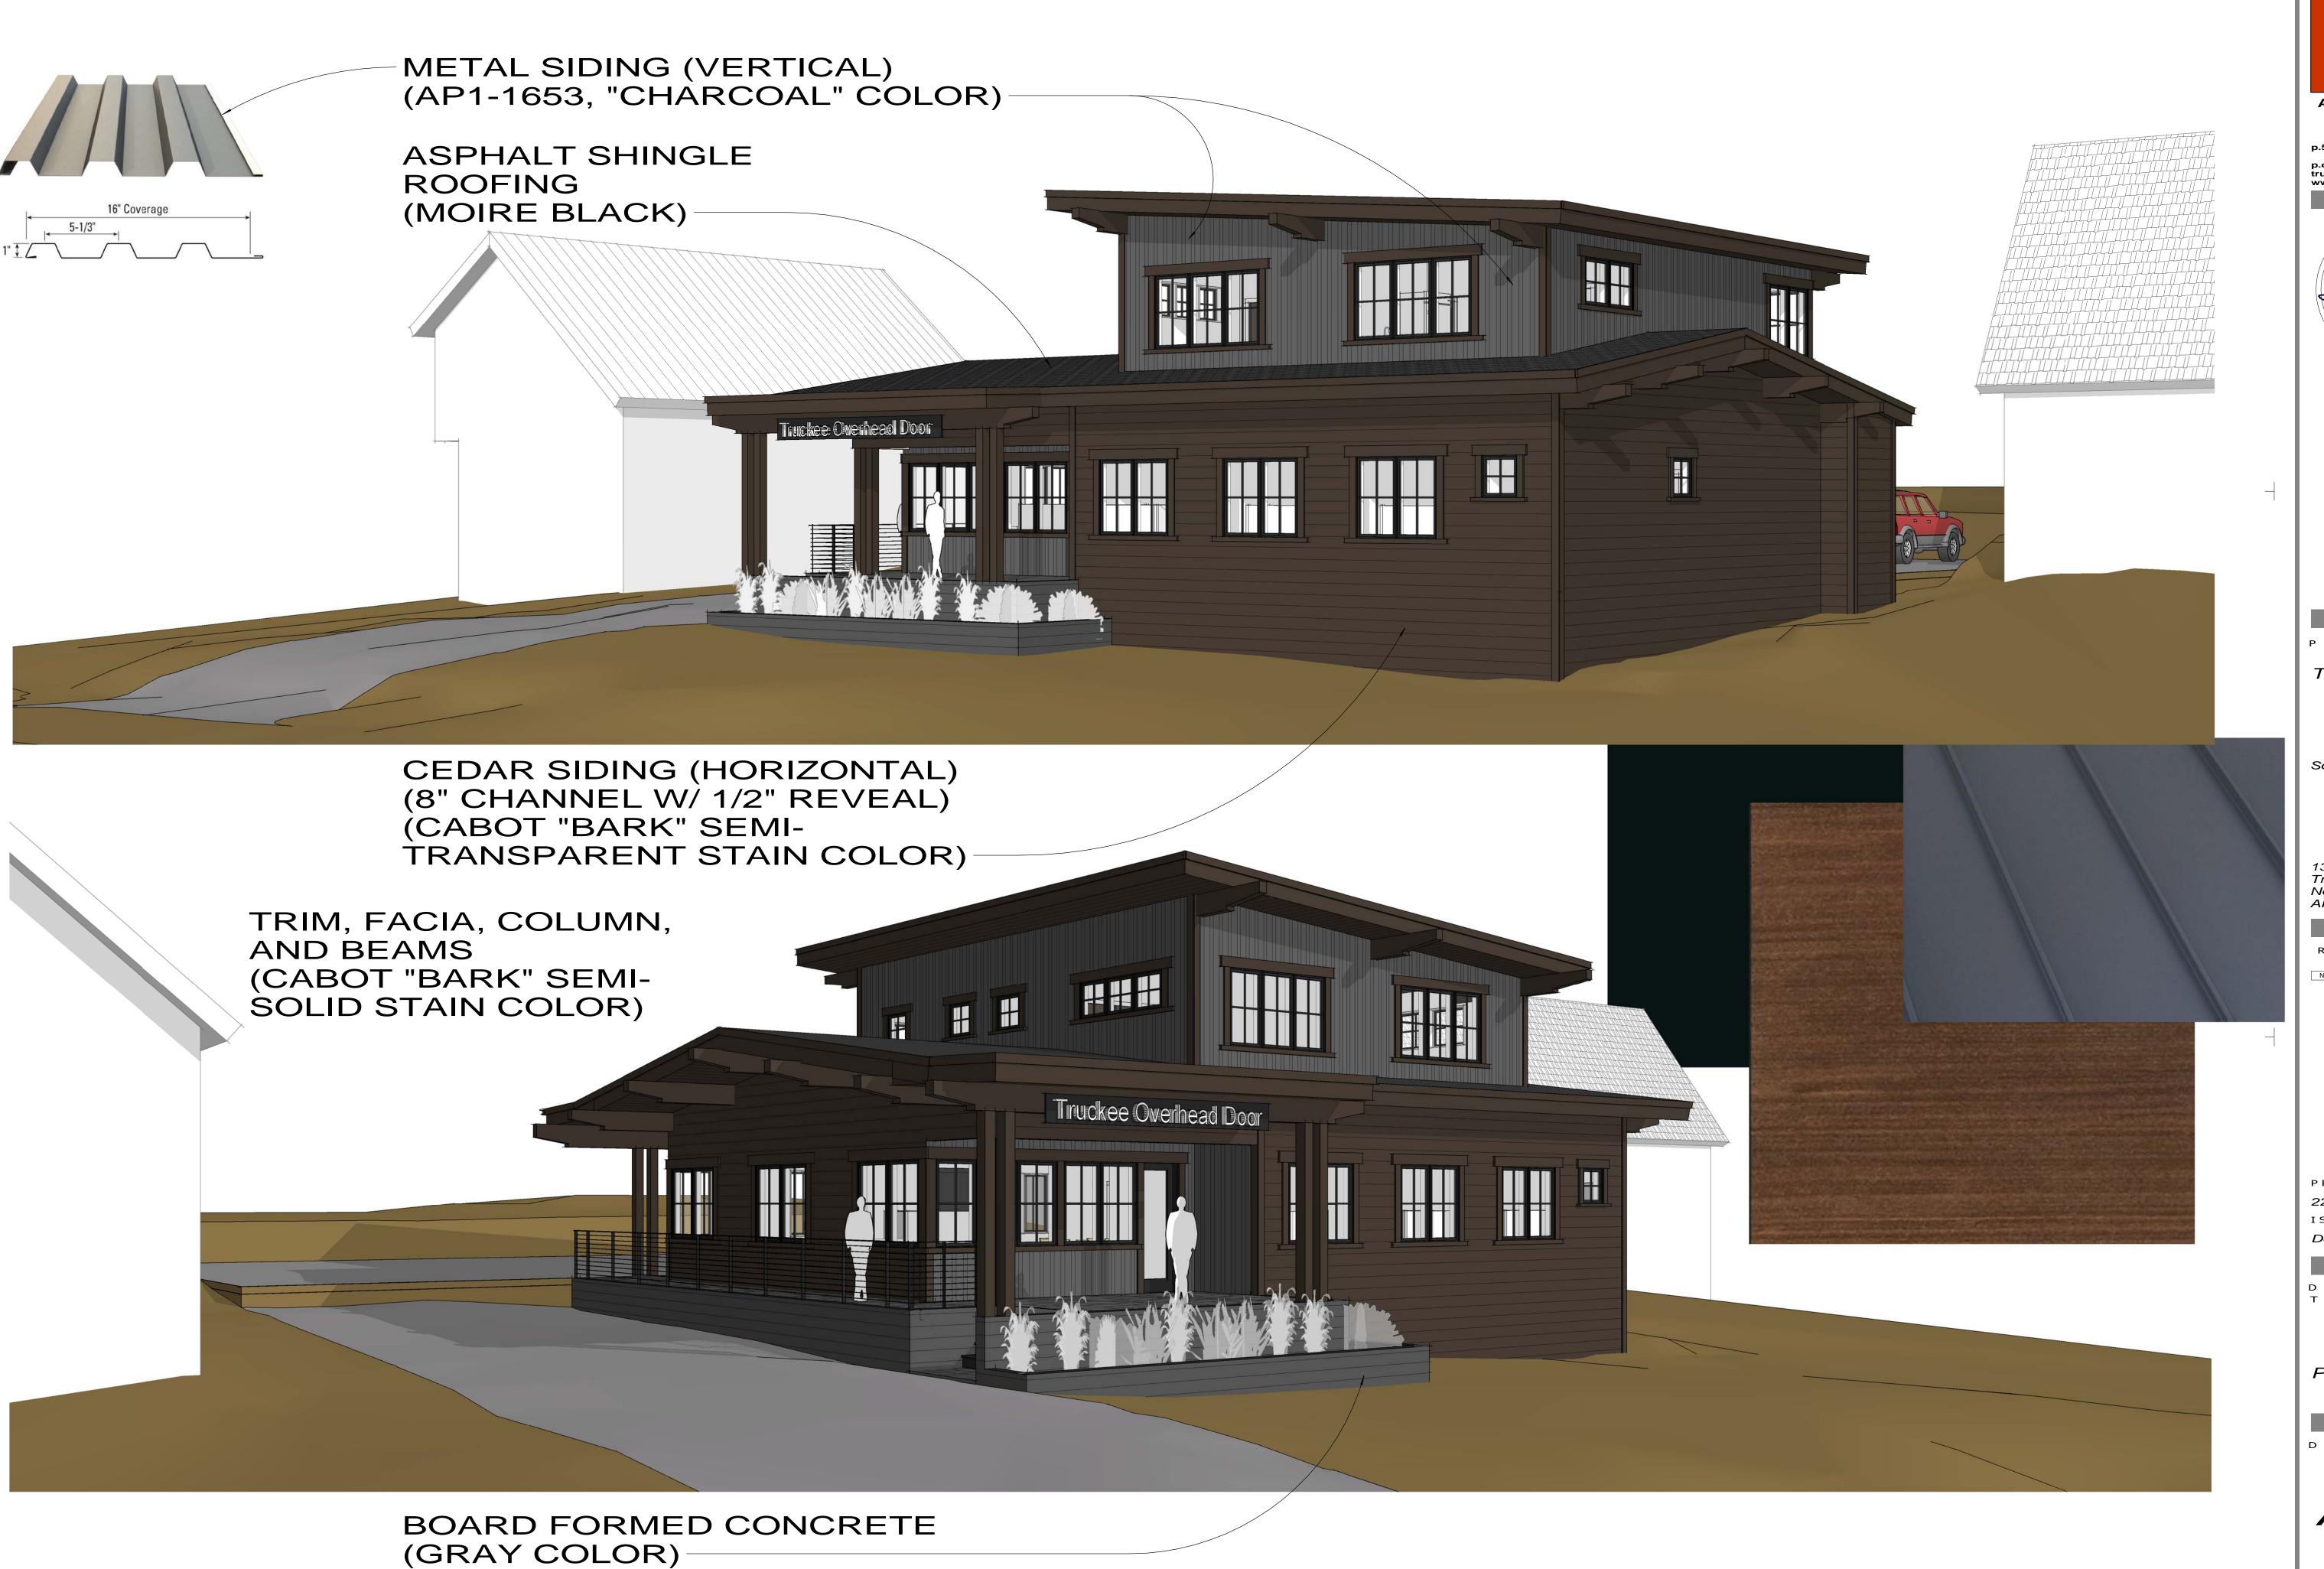





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R E V I S I O N S :

PROJECT NO:

2206

ISSUE DATE:


December 20, 2023

DRAWING TITLE:

PERSPECTIVES

DRAWING NO

A3.3

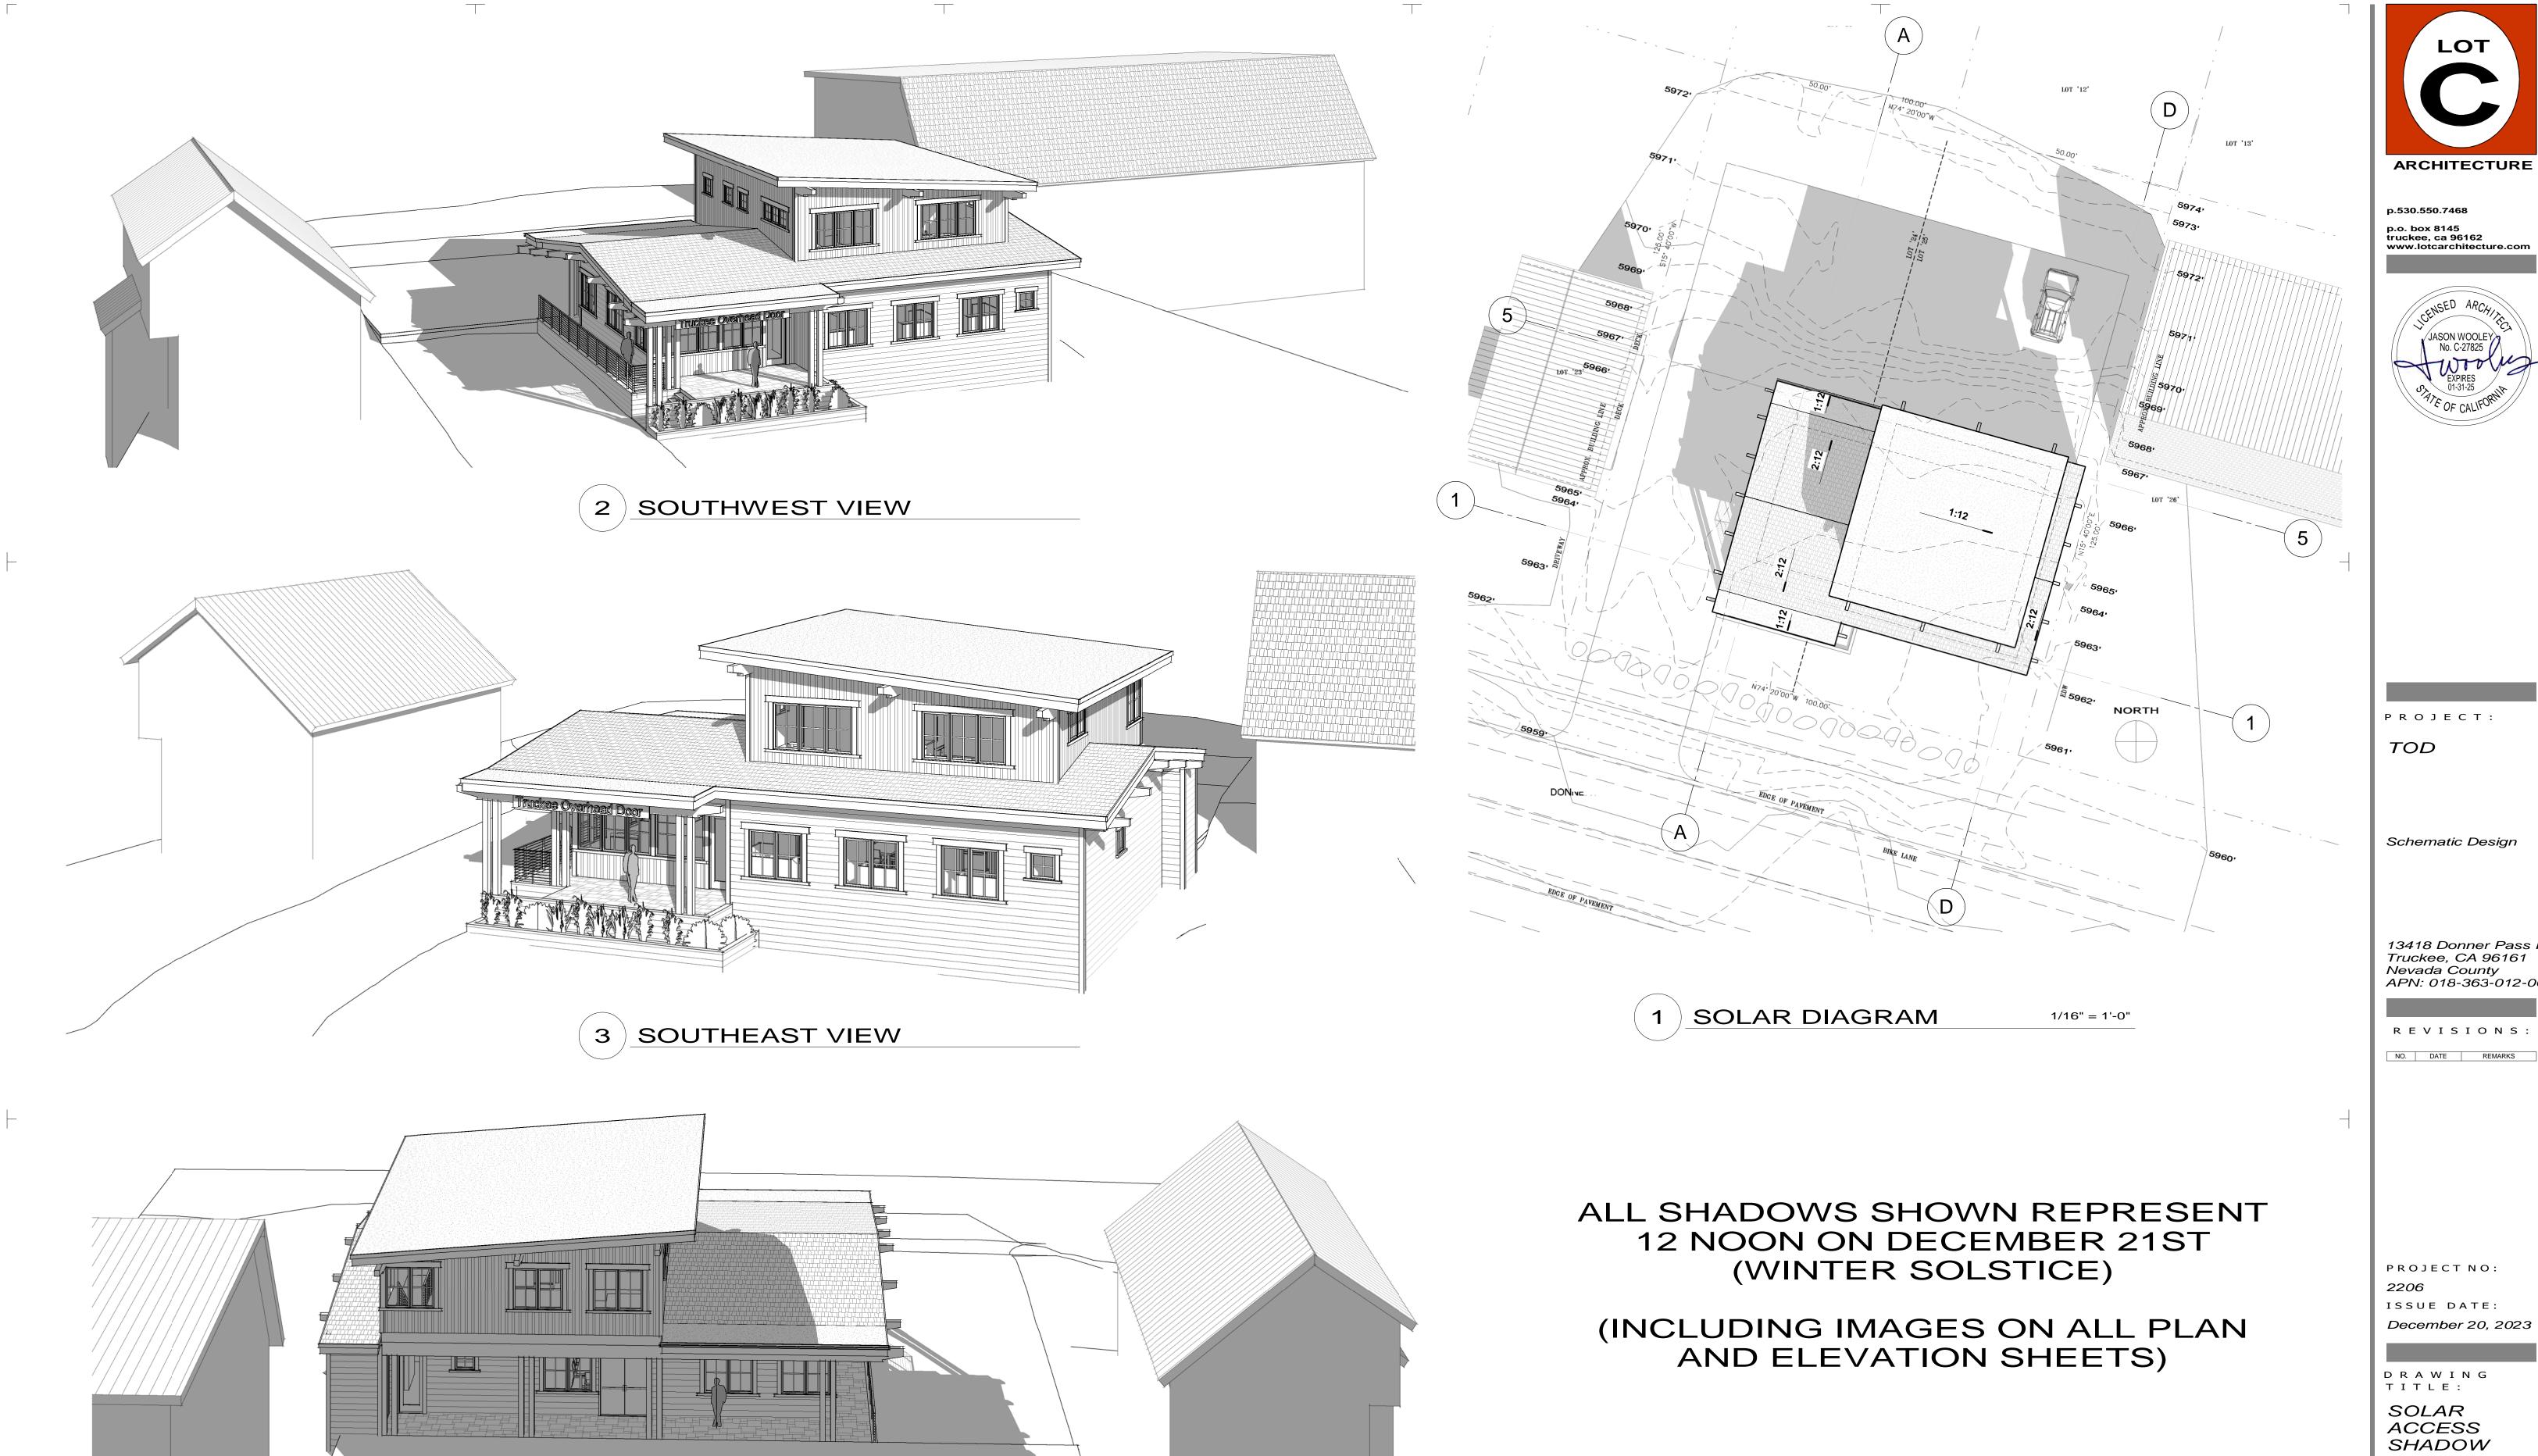

4 NORTH VIEW

ARCHITECTURE

p.530.550.7468 p.o. box 8145 truckee, ca 96162 www.lotcarchitecture.com

PROJECT:

Schematic Design

13418 Donner Pass Rd. Truckee, CA 96161 Nevada County APN: 018-363-012-000

PROJECT NO:

ISSUE DATE: December 20, 2023

DRAWING TITLE: SOLAR ACCESS SHADOW DIAGRAM 1/16" = 1'-0"

A3.4