1.	THE CONTRACT DOCUMENTS ARE COMPLIMENTARY, AND WHAT IS REQUIRED BY ONE, ARCHITECTURAL, CIVIL, STRUCTURAL, MECHANICAL, PLUMBING, OR ELECTRICAL DRAWINGS OR SPECIFICATIONS, ADDENDUM, BULLETINS, OR OTHER DOCUMENT, SHALL BE AS BINDING AS IF REQUIRED BY ALL. CONTRACTOR SHALL USE ONLY COMPLETE SETS OF CONTRACT DOCUMENTS FOR EACH AND EVERY ITEM OF WORK.
2.	CONTRACTOR AGREES THAT, IN ACCORDANCE WITH GENERALLY ACCEPTED CONSTRUCTION PRACTICES, CONTRACTOR SHAI BE REQUIRED TO ASSUME SOLE AND COMPLETE RESPONSIBILITY FOR JOB SITE CONDITIONS DURING THE COURSE OF CONSTRUCTION OF THE PROJECT, INCLUDING SAFETY OF ALL PERSONS AND PROPERTY, THAT THIS REQUIREMENT SHALL BE MADE TO APPLY CONTINUOUSLY AND NOT BE LIMITED TO NORMAL WORKING HOURS. CONTRACTOR FURTHER AGREES TO DEFEND, INDEMNIFY, AND HOLD DESIGN PROFESSIONAL HARMLESS FROM ANY AND ALL LIABILITY, REAL OR ALLEGED, IN CONNECTION WITH THE PERFORMANCE OF WORK ON THIS PROJECT.
3.	ALL WORK SHALL COMPLY WITH ALL APPLICABLE CODE, ORDINANCE, A.D.A., T.A.S AND REGULATIONS OF ALL GOVERNING BODIES.
4.	ALL WORK SHALL BE DONE IN ACCORDANCE WITH THE APPLICABLE CODES, ORDINANCES AND STANDARD SPECIFICATIONS OF ALL AGENCIES THAT HAVE THE RESPONSIBILITY OF REVIEWING PLANS AND SPECIFICATIONS FOR CONSTRUCTION OF ALL ITEMS PER THESE PLANS AND SPECIFICATIONS IN THIS LOCALITY.
5.	THE CONTRACTOR SHALL OBTAIN ALL THE NECESSARY PERMITS AS REQUIRED FOR CONSTRUCTION OF THIS PROJECT. OWNER WILL PAY FOR BUILDING PERMIT.
6.	WHEN ANY EXISTING UTILITY REQUIRES ADJUSTMENT OR RELOCATION, THE CONTRACTOR SHALL NOTIFY THE PROPER UTILIT AND COORDINATE HIS WORK ACCORDINGLY. THERE SHALL BE NO CLAIM MADE BY THE CONTRACTOR AND ANY COSTS
7.	CAUSED BY DELAYS IN CONSTRUCTION TO THE ADJUSTMENT OR RELOCATION OF UTILITIES. ALL TRAFFIC CONTROLS ON THIS PROJECT SHALL ADHERE TO THE LATEST EDITION OF THE MANUAL ON UNIFORM TRAFFIC
8.	CONTROL DEVICES (MUTCD). THE OWNER SHALL NOT BE LIABLE FOR ANY CLAIMS RESULTING FROM ACCIDENTS OR DAMAGES CAUSED BY THE
9.	CONTRACTOR'S FAILURE TO COMPLY WITH TRAFFIC AND PUBLIC SAFETY REGULATIONS DURING THE CONSTRUCTION PERIOD THE CONTRACTOR SHALL CONFINE HIS ACTIVITIES TO THE PROJECT SITE UNDER DEVELOPMENT OR THE EXISTING RIGHT-OF- WAYS, CONSTRUCTION AND REPRANENT EASEMENTS, AND SHALL NOT TRESPASS LIPON OTHER PRIVATE PROPERTY WITHOUT
10	WAYS, CONSTRUCTION AND PERMANENT EASEMENTS, AND SHALL NOT TRESPASS UPON OTHER PRIVATE PROPERTY WITHOU THE CONSENT OF THE OWNER OF THE OTHER PROPERTY.
10.	THE CONTRACTOR SHALL DISPOSE OF ALL SURPLUS EXCAVATION PROPERLY AND PROVIDE ALL SUITABLE FILL MATERIAL AS APPROVED BY THE SOILS ENGINEER, AND THE COST SHALL BE INCLUDED IN THE PRICE BID FOR THE RELATED ITEMS.
11.	EROSION AND SEDIMENT CONTROL SHALL BE PROVIDED IN ACCORDANCE WITH LOCAL AND/OR STATE REQUIREMENTS. PROTECTIVE MEASURES SHALL BE TAKEN BY THE CONTRACTOR TO PROTECT ADJACENT PROPERTY AT ALL TIMES DURING CONSTRUCTION. PROTECTIVE MEASURES SHALL BE TAKEN BY THE CONTRACTOR SO AS NOT TO CAUSE ANY MUD, SILT, OR DEBRIS ONTO PUBLIC OR ADJACENT PROPERTY. ANY MUD OR DEBRIS ON PUBLIC PROPERTY SHALL BE REMOVED IMMEDIATELY.
12.	ALL WORK SHALL BE GUARANTEED BY THE CONTRACTOR TO BE FREE FROM DEFECTS IN WORKMANSHIP AND MATERIALS AND IN CONFORMANCE WITH THE APPROVED PLANS AND SPECIFICATIONS, AND THAT THE CONTRACTOR SHALL REPLACE OR REPAIR ANY WORK OR MATERIAL FOUND TO BE DEFECTIVE.
13.	CONTRACTOR SHALL VERIFY THAT THE PLANS AND SPECIFICATIONS THAT HE IS USING ARE THE VERY LATEST PLANS AND SPECIFICATIONS.
14.	SHOULD THE CONTRACTOR ENCOUNTER CONFLICTS BETWEEN THESE PLANS AND SPECIFICATIONS, EITHER AMONG THEMSELVES OR WITH THE REQUIREMENTS OF ANY AND ALL REVIEWING AND PERMIT ISSUING AGENCIES, HE SHALL SEEK CLARIFICATION IN WRITING FROM THE ARCHITECT BEFORE COMMENCEMENT OF CONSTRUCTION. FAILURE TO DO SO SHALL BE AT SOLE EXPENSE TO THE CONTRACTOR.
15.	THE CONTRACTOR IS REQUIRED TO TAKE DUE PRECAUTIONARY MEASURES TO PROTECT THE UTILITIES OR STRUCTURE AT THE SITE. IT SHALL BE THE CONTRACTOR'S RESPONSIBILITY TO NOTIFY THE OWNER OF UTILITIES OR STRUCTURES CONCERNED BEFORE STARTING WORK. THE CONTRACTOR SHALL NOTIFY THE PROPER UTILITY IMMEDIATELY UPON BREAK O DAMAGE TO ANY UTILITY LINE OR APPURTENANCE, OR THE INTERRUPTION OF THEIR SERVICE. HE SHALL NOTIFY THE PROPEF UTILITY INVOLVED, IF EXISTING UTILITY CONSTRUCTION CONFLICTS WITH REQUIREMENTS, THE CONTRACTOR SHALL NOTIFY THE ENGINEER SO THAT THE CONFLICT MAY BE RESOLVED.
16.	INSTALL ALL MANUFACTURED ITEMS, MATERIALS, AND EQUIPMENT IN STRICT ACCORDANCE WITH MANUFACTURER'S WRITTEN INSTRUCTIONS EXCEPT THAT THE SPECIFICATIONS, WHERE MORE STRINGENT, SHALL GOVERN.
17.	THE CONTRACTOR SHALL BE RESPONSIBLE FOR PROVIDING ALL TAPS, EXTENSIONS, WATER AND ELECTRICITY FOR ALL PROJECT FUNCTIONS, OFFICE, STORAGE, ETC.
18.	THE CONTRACTOR SHALL BE RESPONSIBLE FOR PROVIDING HIS OWN TELEPHONE, FAX MACHINE, TOILET, VALVES, OR OTHER DEVICES NECESSARY TO RUN POWER TOOLS AND EQUIPMENT. SUCH MODIFICATIONS TO EXISTING UTILITIES SHALL BE REMOVED AT COMPLETION OF THE PROJECT.
19.	CONTRACTOR SHALL SUBMIT SHOP DRAWINGS TO THE ARCHITECT IN A TIMELY MANNER THAT WILL ALLOW NOT LESS THAN TEN DAYS FOR REVIEW. THE GENERAL CONTRACTOR SHALL SUBMIT CORRECT NUMBER REQUIRED, BUT NOT LESS THAN FOUR COPIES.
20.	THE GENERAL CONTRACTOR SHALL PROVIDE STREET NUMBERING ON THE BUILDING IN COMPLIANCE WITH LOCAL AUTHORITY
21.	ALL PENETRATIONS THRU WALLS SHALL BE SEALED AIR/WATER TIGHT AND CAULKED WITH TWO PART SEALANT EACH SIDE.
22.	THE GENERAL CONTRACTOR SHALL PROVIDE ONE COPY OF AS-BUILT DRAWINGS TO THE OWNER AT THE COMPLETION OF THI PROJECT. AS-BUILT DRAWINGS SHALL BE KEPT ON THE JOB AT ALL TIMES AND UPDATED THROUGHOUT THE CONSTRUCTION PHASE.
23.	UNLESS NOTED OTHERWISE, SITE PLAN DIMENSIONS, ARE TO FACE OF CURB. FLOOR PLAN DIMENSIONS ARE TO FACE OF STUDS, FRAMING, MASONRY, CONCRETE WALL PANELS, OR FOUNDATION WALLS.
24.	SPECIAL INSPECTIONS NOTE: AT THE COMPLETION OF CONSTRUCTION, A FINAL REPORT OF REQUIRED SPECIAL INSPECTIONS PREPARED BY THE REGISTERED DESIGN PROFESSION IN RESPONSIBLE CHARGE THAT CONFIRMS THAT THE LISTED REQUIRED SPECIAL INSPECTIONS HAVE BEEN CONDUCTED AND COMPLETED WILL BE SUBMITTED TO THE BUILDING OFFICIAL, VIA THE OWNER. IT IS OUR UNDERSTANDING THAT A CERTIFICATE OF OCCUPANCY WILL NOT BE ISSUED BY THE CITY OF SAN ANTONIO UNTIL THIS FINAL REPORT IS RECEIVED. REFER TO DOCUMENT LABELED "DETERMINATION OF REQUIRED SPECIAL INSPECTIONS" AS WELL AS STRUCTURAL SHEET OR REQUIRED INSPECTIONS. IT IS THE CONTRACTOR'S RESPONSIBILITY TO PROVIDE DOCUMENTATION THAT ALL REQUIRED INSPECTIONS HAVE BEEN CONDUCTED AND ALL REPORTED NON-COMPLYINGITEMS HAVE BEEN RESOLVED.
25.	GOVERNING CODE AND FIRE DEPARTMENT, FIELD INSPECTORS SHALL DICTATE SIZE, TYPE, QUANTITY AND LOCATIONS OF BOTH TEMPORARY AND PERMANENT PORTABLE FIRE EXTINGUISHERS.
26.	ALL EXPOSED ELECTRICAL EQUIPMENT, CONDUITS, PLUMBING LINES, ETC. SHALL BE PAINTED W/ MIN (2) COATS OF PAINT TO MATCH ADJACENT SURFACES.
27.	KNOX BOX-LOCATE PER LOCAL FIRE DEPARTMENT REQUIREMENTS.

# **CODE INFORMATION**

BMY WEALTH MANAGMENT

CLIENT.

#### RCHITECTURAL, CIVIL, STRUCTURAL, BULLETINS, OR OTHER DOCUMENT, ETE SETS OF CONTRACT DOCUMENTS

PROJECT ADDRESS	FM 988 & PECAN HILL DR. STEPHENVILLE , TX 76401
APPLICABLE CODES	
BUILDING CODE	2015 IBC
FIRE CODE	2015 IFC
MECHANICAL CODE	2015 IMC
PLUMBING CODE	2015 IPC
ELECTRICAL CODE	2014 NEC
ENERGY CODE	2018 IECC
CODE ANALYSIS	
SINGLE STORY STUD FRAMED STRUCTURE. NON (OFFICE) OCCUPANCY.	I SPRINKLED W/ B
PROPOSED ZONING	PD
TYPE OF CONSTRUCTION	V-B
NUMBER OF STORIES	1
ALLOWABLE HEIGHT (S)	
OCCUPANCY GROUP	B (OFFICE)
ALLOWABLE BUILDING AREA (NON-SPRINKLED)	
GROSS BUILDING SQUARE FOOTAGE	
GROSS FLOOR AREA	6,800 SQFT
EXIT CALCULATIONS	
PER IBC TABLE	
CORRIDOR WIDTH REQUIRED 1005.3.2, 1020.2	
EXIT WIDTH REQUIRED 1010.1	
MINIMUM NUMBER OF EXITS (BUSINESS)	2
MAXIMUM COMMON PATH TRAVEL DISTANCE (1006.2.1)	
MAXIMUM EXIT ACCESS TRAVEL DISTANCE	

NO FIRE RATED INTERIOR PARTITIONS REQD.

# **PROJECT DESCRIPTION**

NEW CONSTRUCTION OF A SINGLE STORY OFFICE BUILDING THE BUILDING WILL NOT BE SPRINKLED.

# SHEET LIST

		SHEET LIST	
Sheet Discipline	Sheet Number	Sheet Name	Sheet Issue Date
00 GEN	G000	COVER SHEET	01/07/2022
01 CIVIL	EXH	ZONING EXHIBIT - SITE PLAN	01/07/22
02 ARCH	A001	DRAWING INFORMATION	01/07/2022
02 ARCH	A010	LIFE SAFETY PLAN	01/07/2022
02 ARCH	A100	SITE PLAN	01/07/2022
02 ARCH	A110	FLOOR PLAN	01/07/2022
02 ARCH	A115	REFLECTED CEILING PLAN	01/07/2022
02 ARCH	A120	ROOF PLAN	01/07/2022
02 ARCH	A200	ELEVATIONS	01/07/2022
02 ARCH	A300	BUILDING SECTIONS	01/07/2022
02 ARCH	A900	3D VIEWS	01/07/2022







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Design Team

Consultant Address Address Phone Fax e-mail

Consultant Address Address Phone Fax e-mail

CLIENT

NAME: Justin Haschke ADDRESS: FM 988 NW & Pecan Hill Dr.

PROJECT

# Stephenville Office

PROJECT KEY



ARCHITECT STAMP

## NOT FOR CONSTRUCTION

#### FOR PD REGULATORY APPROVAL ONLY

REVISIONS	ONS		
No.	Description	Date	


SHEET TITLE

# COVER SHEET

DWG INFO





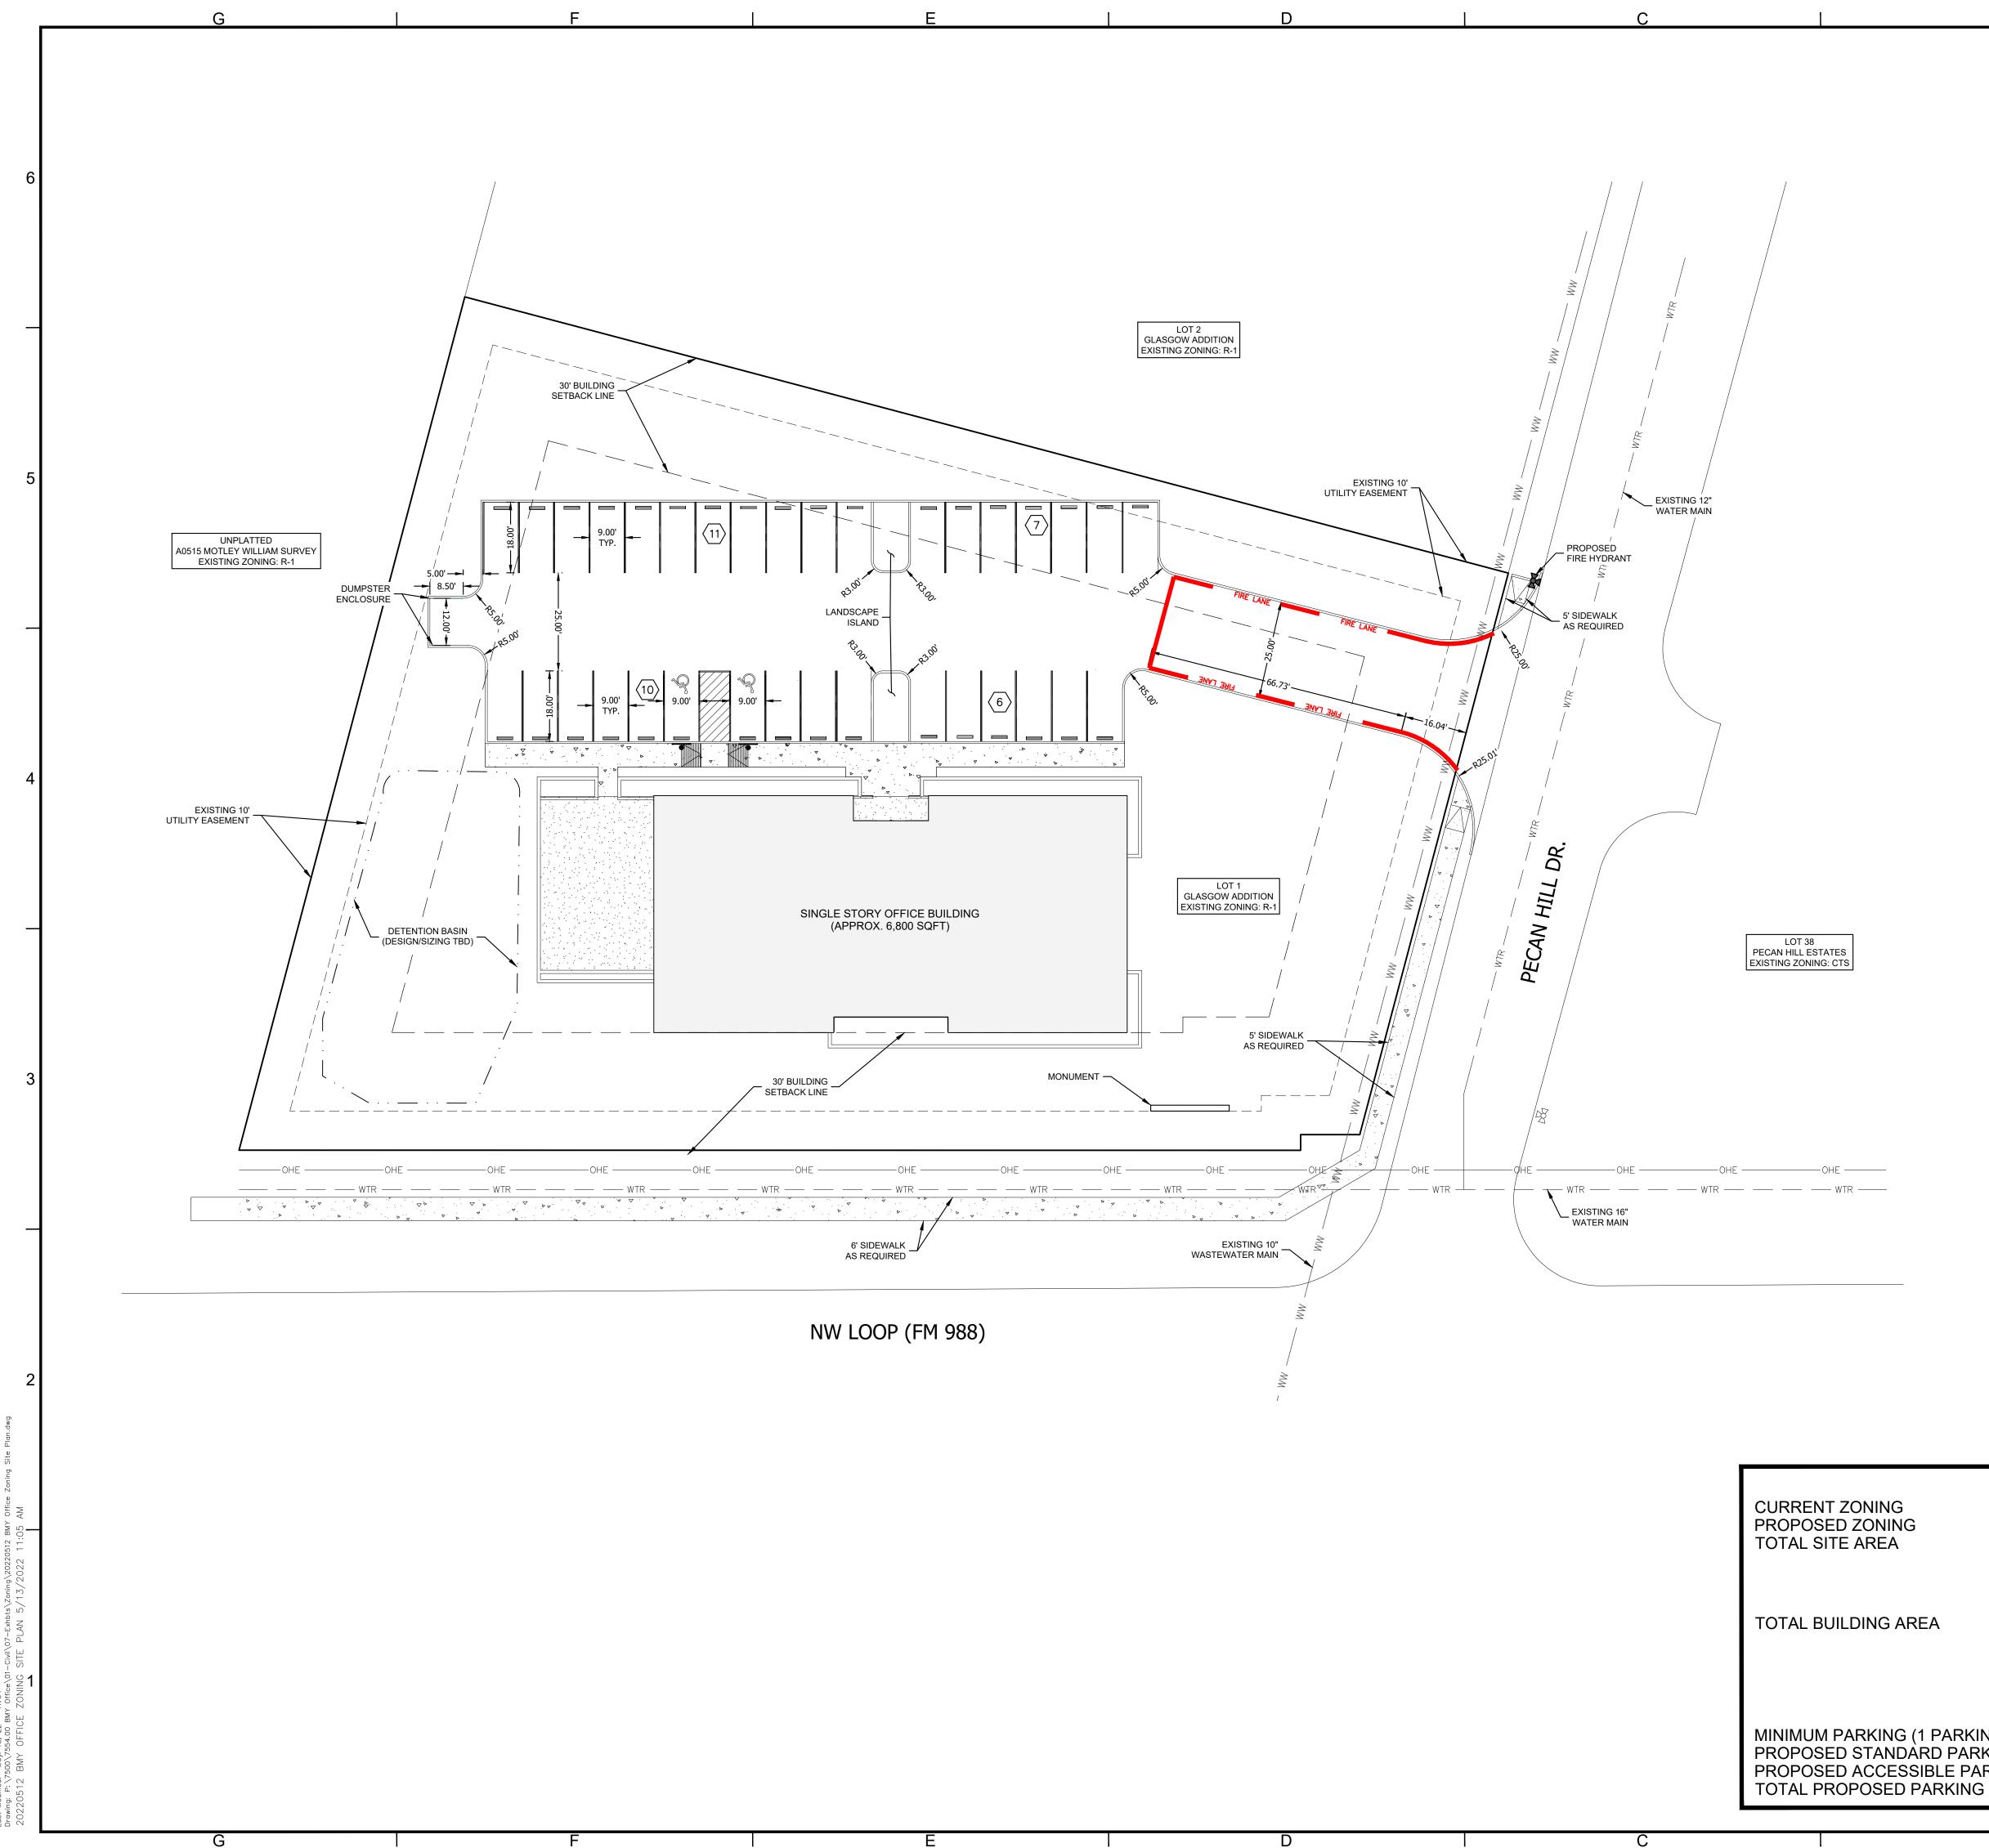

MINIMUM PARKING (1 PARKING PROPOSED STANDARD PARKI PROPOSED ACCESSIBLE PARK

	А	
0 LE	10' 20' 40' 10' 20' 40' GEND	uthorized for uction prior to l city approval
	BOUNDARY / RIGHT OF WAY EASEMENT	DT A ISTR RMA
	BUILDING SETBACK LINE EXISTING WASTEWATER LINE	O Z Z
WW	EXISTING WASTEWATER LINE	
	EXISTING OVERHEAD ELECTRIC LINE	Ŭ
	PROPOSED SIDEWALK	
FIRE LANE	PROPOSED FIRE LANE	085 0
<b>#</b>	PARKING COUNT	. F -15
<b>X</b>	PROPOSED FIRE HYDRANT	
		WGInc.com

		OFFICE PECAN HILL DR. & FM 988 IVILLE, ERATH COUNTY, TEXAS 76401	ZONING EXHIBIT - SITE PLAN
SITE DATA TABLE	R-1	PECA STEPHENVILLE,	ZOI
	PD 51,820 SF / 1.18 AC	ST	
BUILDING DATA	6,800 SF		TITLE:
PROVIDED PARKING		PROJECT:	SHEET TII
PROVIDED PARNING		SHEET	
G STALL PER EVERY 200 SQ FT) NG STALL	34 32	EX⊦	
KING STALL	02 34	OF	-
		PLAT NO.	

Α

# SHEET NUMBERING

## A401

EACH SHEET OF DRAWINGS IS NUMBERED IN THE LOWER RIGHT HAND CORNER. SHEETS ARE NUMBERED FIRST BY SECTION LETTER THEN BY SHEET NUMBER WITHIN THE SECTION. FOR EXAMPLE, SHEET A401 REPRESENTS SHEET 401 WITHIN THE ARCHITECTURAL SECTION.

# DRAWINGS

DRAWINGS ARE ORGANIZED ACCORDING TO A "SECTION FORMAT". WITH EACH SECTION DESCRIBING A GENERAL ASPECT OF THE CONSTRUCTION. THE FOLLOWING LISTING ILLUSTRATES A TYPICAL SEQUENCE OF DRAWINGS DEVELOPED FOR A LOGICAL SECTION OF WORK.

GENERAL PROJECT INFORMATION & DRAWINGS
CIVIL DRAWINGS
ARCHITECTURAL DRAWINGS
STRUCTURAL DRAWINGS
MECHANICAL DRAWINGS
ELECTRICAL DRAWINGS
PLUMBING DRAWINGS
LANDSCAPE DRAWINGS

# **GENERAL NOTES**

THIS PROJECT COMPLIES WITH THE 20D9 INTERNATIONAL CODE SERIES, AS ADOPTED BY , AND WITH THE CODE ORDINANCES OF

MATERIALS SHALL BE NEW, EXCEPT AS NOTED OTHERI\1SE, AND SHALL CONFORM TO THE LATEST STANDARDS OF THE AMERICAN SOCIETY FOR TESTING MATERIALS, THE AMERICAN INSTITUTE FOR STEEL CONSTRUCTION, THE AMERICAN CONCRETE INSTITUTE, AND LOCAL APPLICABLE BUILDING CODES, AND HANDLED IN ACCORDANCE I\1TH MANUFACTURER'S SPECIFICATIONS

ALL WORK SHALL BE PERFORMED TO THE HIGHEST STANDARD FOR FIRST QUALITY CONSTURUCTION BY MECHANICS AND ARTISANS SKILLED IN THEIR RESPECTIVE TRADES

ALL TRADES SHALL PROTECT THEIR OWN WORK TO PREVENT DAMAGE BY OTHERS DURING THE COURSE OF CONSTRUCTION

THE GENERAL CONTRACTOR SHALL EXAMINE THE CONTIRACT DOCUMENTS AND BE FAMILIAR WITH ALL OF THE MATERIAL CONTAINED HEREIN AND SHALL MAKE ANY AND ALL INFORMATION CONTAINED HEREIN AVAILABLE TO ANY AND ALL OF THE GENERAL CONTIRACTOR'S SUBCONTACTORS AND MATERIAL SUPPLIERS, AND TO MAKE CERTAIN THEY ARE FAMILIAR WITH THE APPLICABLE INFORMATION HEREIN

ALL BIDS SUBMITTED AND ACCEPTED UNDER THIS CONTRACT SHALL INCLUDE ALL MATERIAL AND LABOR NECESSARY TO COMPLETE THE PROJECT IN ACCORDANCE WITH THE DOCUMENTS

REASONABLE PROFESSIONAL CARE AND DILLEGENCE IS ASSUMED IN THE PREPARATION OF THESE DOCUMENTS. SHOULD ERRORS AND/OR OMISSIONS OCCUR, ALL WORK ON THE AFFECTED AREA OF THE PROJECT WILL STOP AT ONCE, AND SAID ERRORS AND/OR OMISSIONS SHALL BE REFERRED TO THE DESIGNER FOR RESOLUTION. WORK ON THE AFFECTED AREA OF THE PROJECT SHALL RESUME ONLY UPON WRITTEN APPROVAL BY THE DESIGNER

PROPERTY DIMENSIONS, BEARINGS, SETBACKS, EASEMENTS AND UTILITIES ARE SUPPLIED TO THE DESIGNER BY OTHERS AND ASSUMED ACCURATE. THE DESIGNER SHALL MAKE EVERY EFFORT TO INSURE THE ACCURACY OF THE WORK PROVIDED BY OTHERS, BUT CANNOT GUARANTEE OR BE RESPONSIBLE FOR WORK PROV, DED BY OTHERS

NO SUBSTITUTION, DEV1ATION, OR CHANGE FROM THE CONTRACT DOCUMENTS SHALL BE ACCEPTED WITHOUT PRIOR WRITTEN APPROVAL BY THE DESIGNER

DRAWINGS ARE NOT TO BE SCALED. IF NOTED DIMENSIONS DO NOT ADEQUATELY DESCRIBE AN AREA, REFER AT ONCE TO THE DESIGNER

FIELD VERIFY ALL CABINETS, MIRRORS, WINDOWS, DOORS, ETC. PRIOR TO FABRICATION AND/OR INSTALLATION

FINAL LOCATIONS OF ALL SWITCHES, OUTLETS, GRILLES, ETC. SHALL BE DETERMINED AT THE SITE IN CONSULTATION WITH THE OWNER. ALL SUBCONTRACTORS SHALL VERIFY THAT ALL MECHANICAL, PLUMBING, AND ELECTIRICAL ITEMS CAN BE INSTALLED IN THE SPACE ALLOCATED

TEMPORARY FACILITIES FOR THE PROTECTION OF MATERIALS AND EQUIPMENT SHALL CONFORM TO LOCAL REGULATIONS AND SHALL BE THE RESPONSIBILITY OF THE GENERAL CONTRACTOR

# **SYMBOLS**

DOCUMENTS

FLOOR LEVEL LINE

MATCHLINE (SHADED PORTION)

**COLUMN GRIDS** 

**ROOM TAG** 

**REVISION TAG** 

WINDOW TAG

DOOR TAG

NORTH ARROW

**BUILDING SECTION** 

DRAWING.

WALL SECTION TAG

SEE ABOVE FOR EXPLANATION

**ELEVATION TAG** 

THE ARROW POINTS IN THE DIRECTION OF THE VIEW FOR THE ELEVATION. THE NUMBER IS A REFERENCE TO THE ELEVATION DRAWING. IN THIS EXAMPLE, DRAWING 2 ON SHEET A300

DETAIL KEY


THIS SYMBOL IS A KEY TO A DETAIL DRAWN OF THE AREA WITHIN THE DASHED LINES. THE NUMBER IS A REFERENCE TO THE DETAIL DRAWING. FOR EXAMPLE, DRAWING 1/A101 REPRESENTS DRAWING 1 ON SHEET A101

- WALL TYPE PARTITION TYPE TAG

# INDEX

ARCH	ITECTURAL
	COVER SHEE
A001	DRAWING INF
A100	SITE PLAN AN



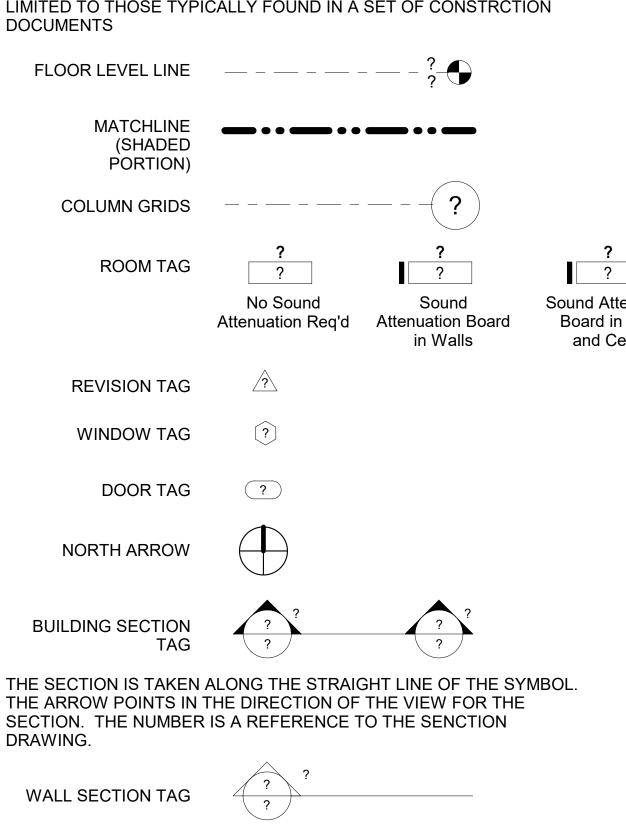

A300





APPROX. SIZE **OF STRUCTURAL** ELEMENT

?

Board in Walls and Ceiling

Sound Attenuation

**ABBREVIATIONS** 

ADD. ADH. ADJ. ADJT. AGG. ALT. ALUM.	ABOVE FINISHED FLOOR ADDITION ADHESIVE ADJACENT ADJUSTABLE	FIXT. FLG. FLUOR. FLR. FND.	FIGURE FINISH(ED) FIXTURE FLASHING FLUORESCENT FLOOR(ING) FOUNDATION FIREPROOF FRAME(D), (ING)
APPROX ARCH. AVG.	APPROXIMATE ARCHITECT(URAL) AVERAGE BOTH SIDES	GD.	GENERAL CONTRA GAUGE GALVANIZED GRADE, GRADING GLASS, GLAZING
BD. BEL. BET. BLKG.	BOARD BELOW BETWEEN BLOCKING	GWB. GYP. GYP.PL.	GYPSUM WALLBO GYPSUM GYPSUM PLASTEF
C.O. C.W. CTL.JT. CAB. CEM. CER. CHAM. CIR.	BOTTOM CONCRETE MASONRY UNIT CLEAN OUT COLD WATER CONTROL JOINT CABINET CEMENT CERAMIC CHAMFER CIRCLE	H.C. H.M. H.V.A.C. H.W. HDR. HDW. HORIZ. HR. HT.	HOSE BIB HOLLOW CORE HOLLOW METAL HEAT/VENT/AIR CO HOT WATER HEADER HARDWARE HORIZONTAL HOUR HEIGHT HEATING HARDWOOD
CLG. CLO. CLR. CNTR. COL.	CAULK(ING) CEILING CLOSET CLEAR(ANCE) COUNTER COLUMN COMPRESS(ED), (ION), (IBLE)	I.D. IN. INCL. INS. INT.	INSIDE DIAMETER INCH INCLUDE(D), (ING) INSULATE(D), (ING INTERIOR
COMPO.	COMPOSITION (COMPOSITE) CONCRETE	JT.	JOINT
CONN. CONST. CORR. CPT. CSMT. CTR.	CONNECTION CONSTRUCTION CORRUGATED CARPET (ED) CASEMENT CENTER	L.H. LAM. LAV. LT. LTL.	LENGTH LEFT HAND LAMINATE LAVATORY LIGHT LINTEL LOUVER
DBL. DEM. DIAG. DIA. DIM. DIV. DN. DR. DR. DS. DTL. DW. DWG.	DOUBLE HUNG DOUBLE DEMOLISH, DEMOLITION DIAGONAL DIAMETER DIMENSION DIVISION DOWN DOOR DOOR DOWNSPOUT	MBR. MECH. MED. MFR. MIN. MIN.	MAXIMUM MEMBER MECHANICAL MEDIUM MANUFACTURER MINIMUM MIRROR MISCELLANEOUS MOLDING, MOULD MONTH MOVABLE MOUNT(ED), (ING) METAL MULLION
EQ.	ELECTRICAL PANELBOARD ELEVATION EQUIVALENT EQUIPMENT	N.I.C. N.T.S. NO. NOM.	NOT IN CONTRACT NOT TO SCALE NUMBER NOMINAL
F.B.O. F.D. F.E. F.F.E. F.O.F.	FIRE ALARM FURNISHED BY OTHERS FLOOR DRAIN FIRE EXTINGUISHER FINISH FLOOR ELEVATION FACE OF FINISH FACE OF STUD	o.d. oh. opng. opp.	ON CENTER OUTSIDE DIAMETE OVERHEAD OPENING OPPOSITE OPPOSITE HAND
F.R. FAS.	FIRE RATED FASTEN(ER) FIBERGLASS	P.LAM.	PROPERTY LINE PLASTIC LAMINAT PERFORATE(D)

ELECTRICAL

ELECTRICAL

ORMATION ND SCHEDULE A110 FLOOR PLANS AND SCHEDULE

D) G ICENT IG)	PERP. PK. PL.	PERIMETER PERPENDICULAR PARKING PLATE PLASTER
TIÓN OF ), (ING) . CONTRACTOR ZED	PNT. PT. PTN. PV. PVC.	
	R.D. R.H. R.O.W. RAD. RFG. RFL. REF. REFR. REFR. RES. RET.	RETURN AIR ROOF DRAIN RIGHT HAND ROUGH OPENING RIGHT OF WAY RADIUS ROOFING REFLECT(ED), (IVE), (OR) REFERENCE REFRIGERATOR REMOVE RESILIENT RETURN RETURN REVISION
AMETER (D), (ING) E(D), (ING) R ID E Y	S.D. SCHED. SEC. SH. SHTH. SHT. SIM. SNT. SP. SPK. SPEC. SQ. S.S. STL. STR. STD. STOR. SUSP.	SOLID CORE WOOD STORM DRAIN SCHEDULE(D) SECTION SHELF(VES), (VING) SHEATHING SHEET SIMILAR SEALANT SOUNDPROOF SPEAKER SPECIFICATION(S) SQUARE STAINLESS STEEL STEEL STRUCTURAL STANDARD STORAGE SUSPENDED SYSTEM
CTURER ANEOUS , MOULDING <u>=</u> D), (ING)	T.P.D. T.O.STL TEL. TEMP. THK. THR.	TREAD TOP OF STRUCTURE TOILET PAPER DISPENSER TOP OF STEEL TELEPHONE TEMPERATURE THICK(NESS) THRESHOLD TYPICAL
ONTRACT CALE	VERT. VIN. VNR.	VAPOR BARRIER VERTICAL VINYL VENEER VOLUME
ER DIAMETER AD E E HAND TY LINE LAMINATE ATE(D)	W.C. W.H. W.I. W.M. W.S. WD. WDW. WP.	WIDTH, WIDE WATER CLOSET WATER HEATER WROUGHT IRON WIRE MESH WEATHERSTRIPPING WOOD WINDOW WATERPROOFING WEIGHT

OTHER



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e-mail

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NAME: Justin Haschke ADDRESS: FM 988 NW & Pecan Hill Dr.

PROJECT KEY

ARCHITECT STAMP

# Stephenville Office



#### NOT FOR CONSTRUCTION

#### FOR PD REGULATORY APPROVAL ONLY


No.	Description	Date

SHEET TITLE

# DRAWING **INFORMATION**





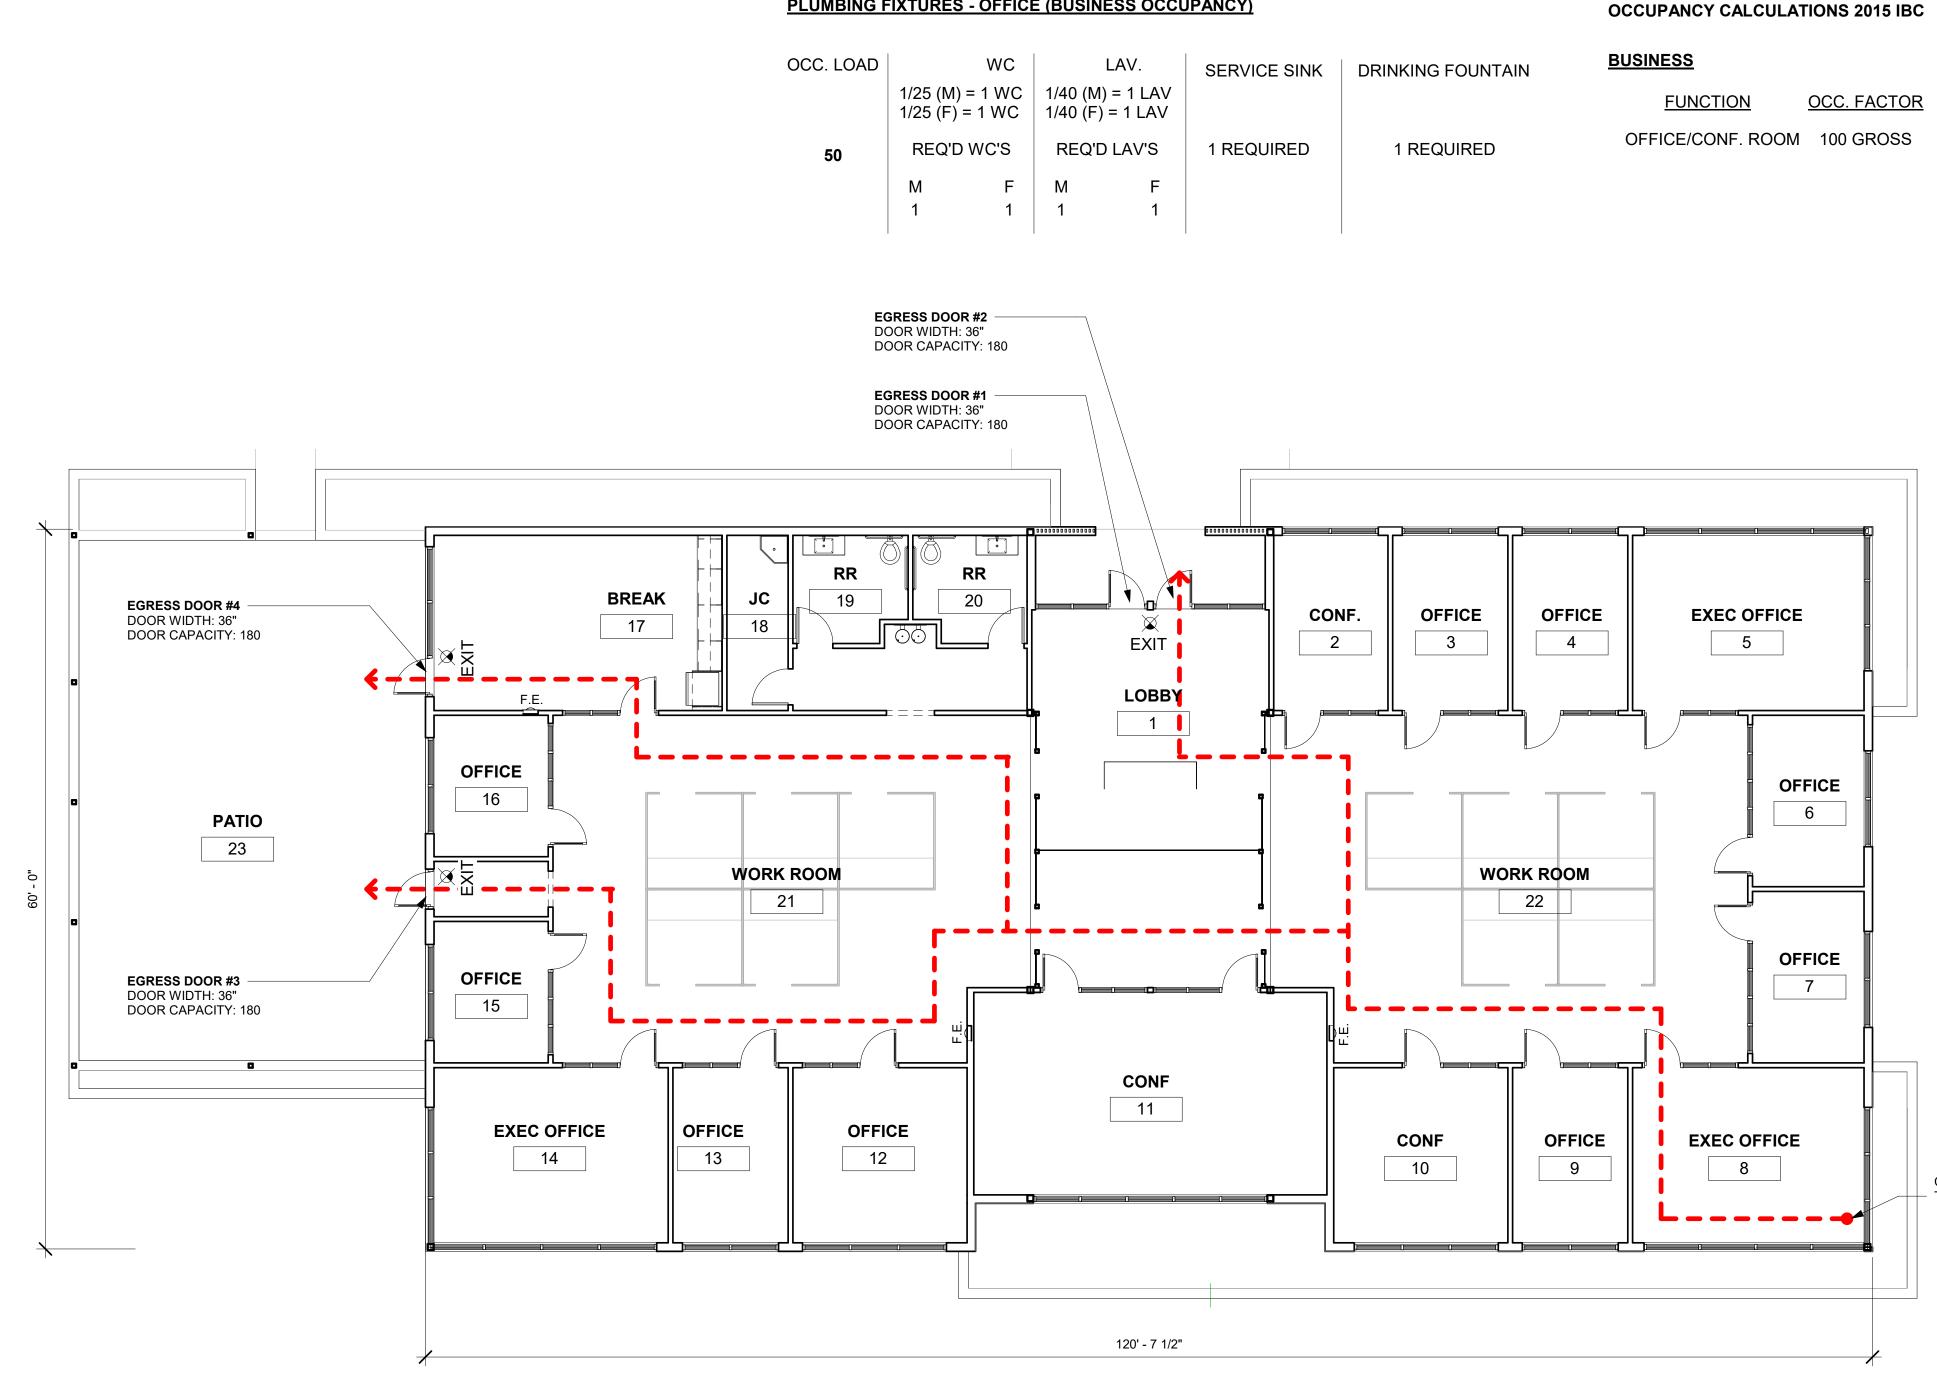

1 <u>LEVEL 1 - LIFE SAFETY</u> 1/8" = 1'-0"

#### PLUMBING FIXTURE CALCULATIONS 2015 IBC (TABLE 2902.1.1)

# PLUMBING FIXTURES - OFFICE (BUSINESS OCCUPANCY)



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CLIENT

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PROJECT

# Stephenville Office

PROJECT KEY



ARCHITECT STAMP

## NOT FOR CONSTRUCTION

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REVISIONS		
No.	Description	Date

SHEET TITLE



PROJECT: 2004 ISSUE DATE: 05/13/2022 DRAWN BY: SS CHECKED BY: SS





(TABLE 1004.5)

#### <u>AREA (S.F.)</u>


#### · · · · ·

6,800

68 (PROPOSED 50 MAX)

OCC. LOAD

CPTD: 65' - TD: 109'

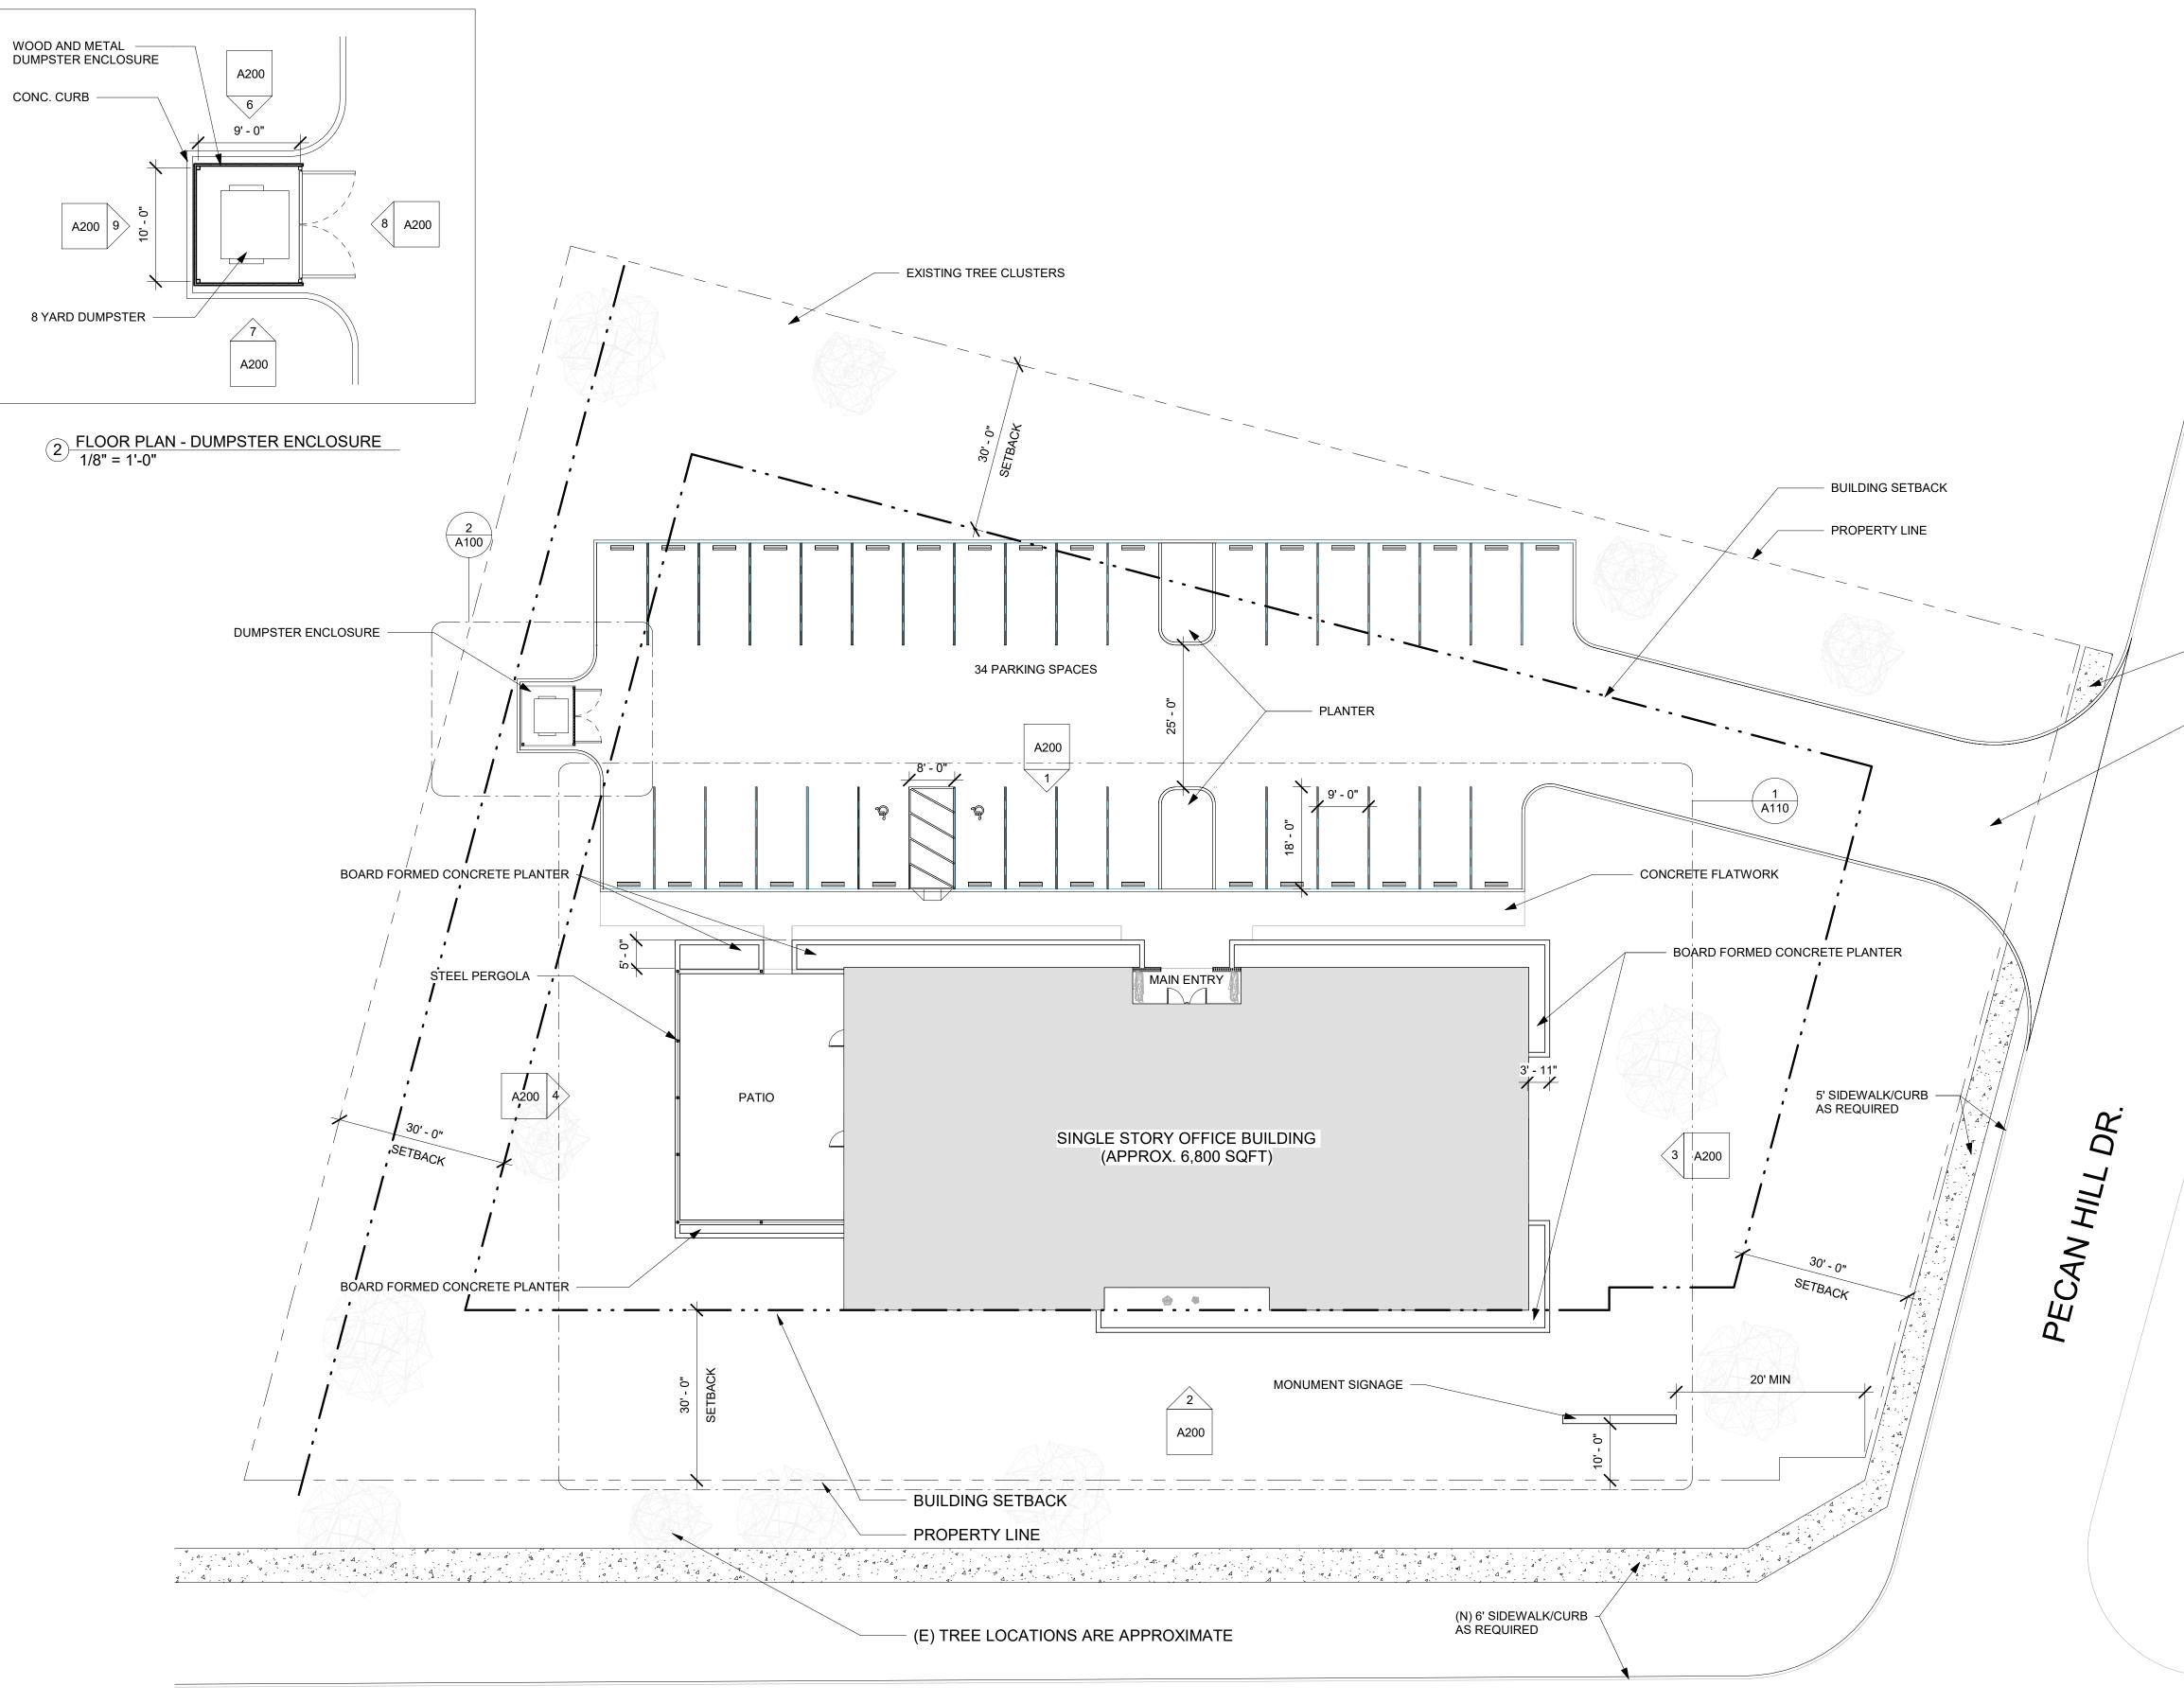

# NW LOOP (FM 988)



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PROJECT

# Stephenville Office





ARCHITECT STAMP

## NOT FOR CONSTRUCTION

# FOR PD REGULATORY APPROVAL ONLY

REVISIONS		
No.	Description	Date

SHEET TITLE

SITE PLAN

DWG INFO

**PROJECT:** 2004 **ISSUE DATE:** 05/13/2022 DRAWN BY: SS CHECKED BY: SS






(N) 5' SIDEWALK/CURB AS REQUIRED


## - ALIGN (N) CURB CUT WITH (E) CURB CUT ON OPPOSITE SIDE OF STREET.

(E) CURB CUT

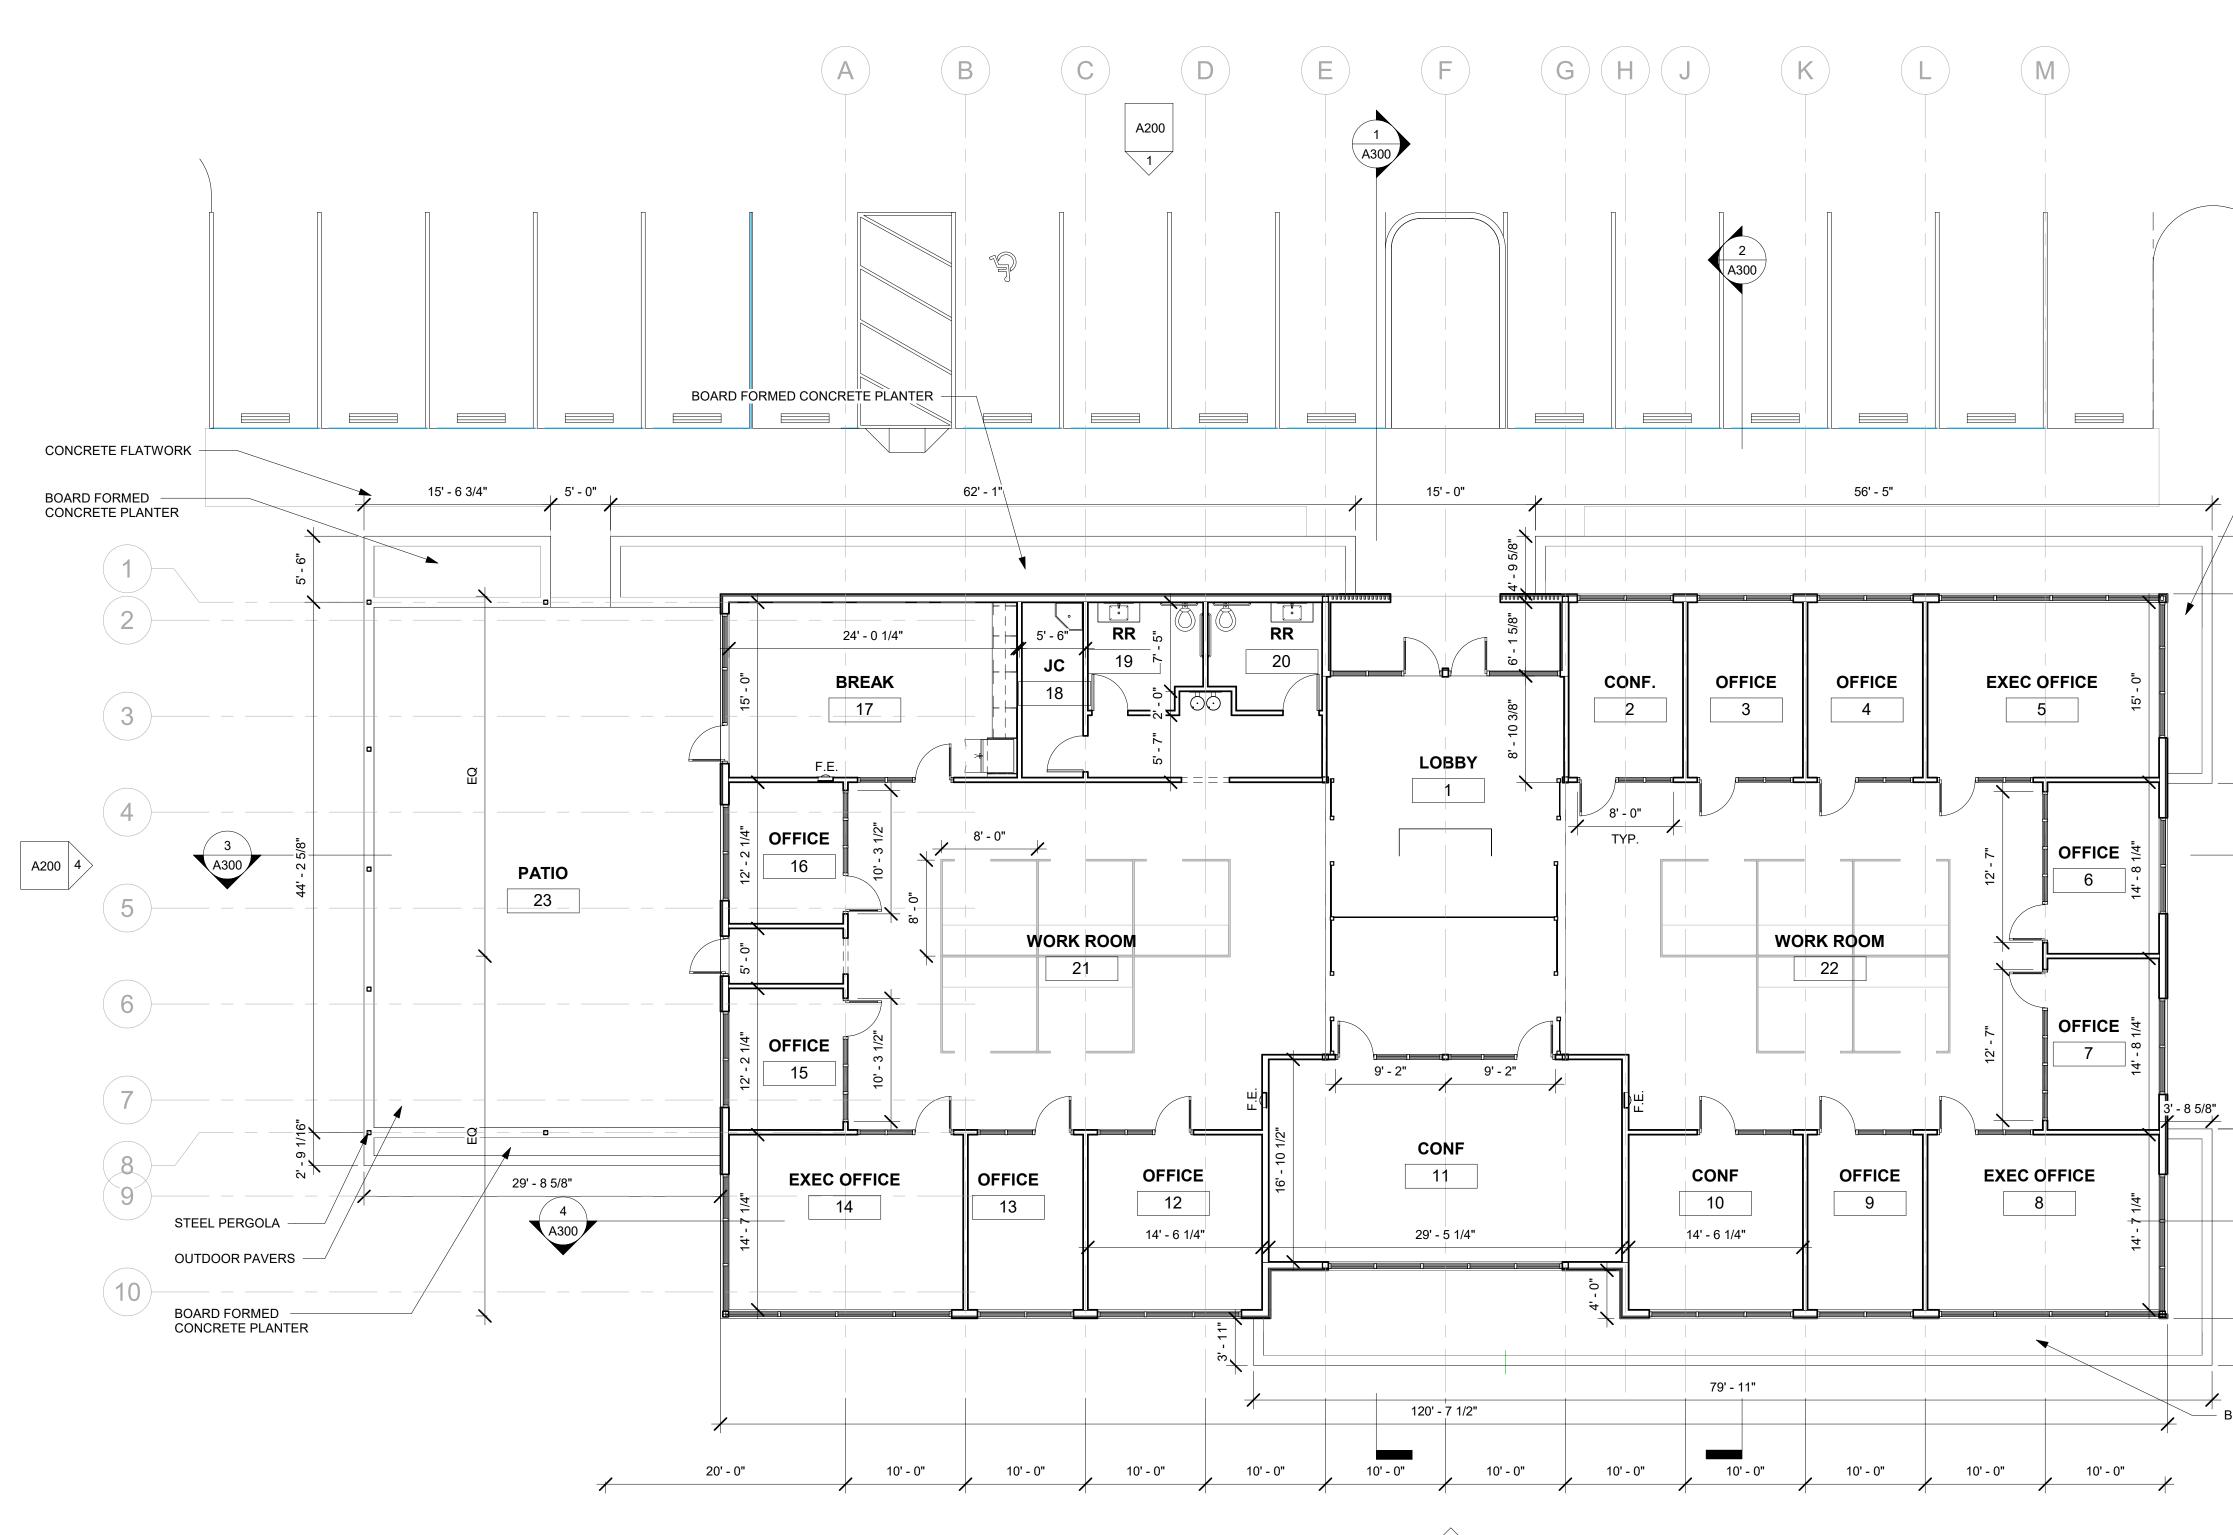

2 A200

> 1 <u>LEVEL 1</u> 1/8" = 1'-0"

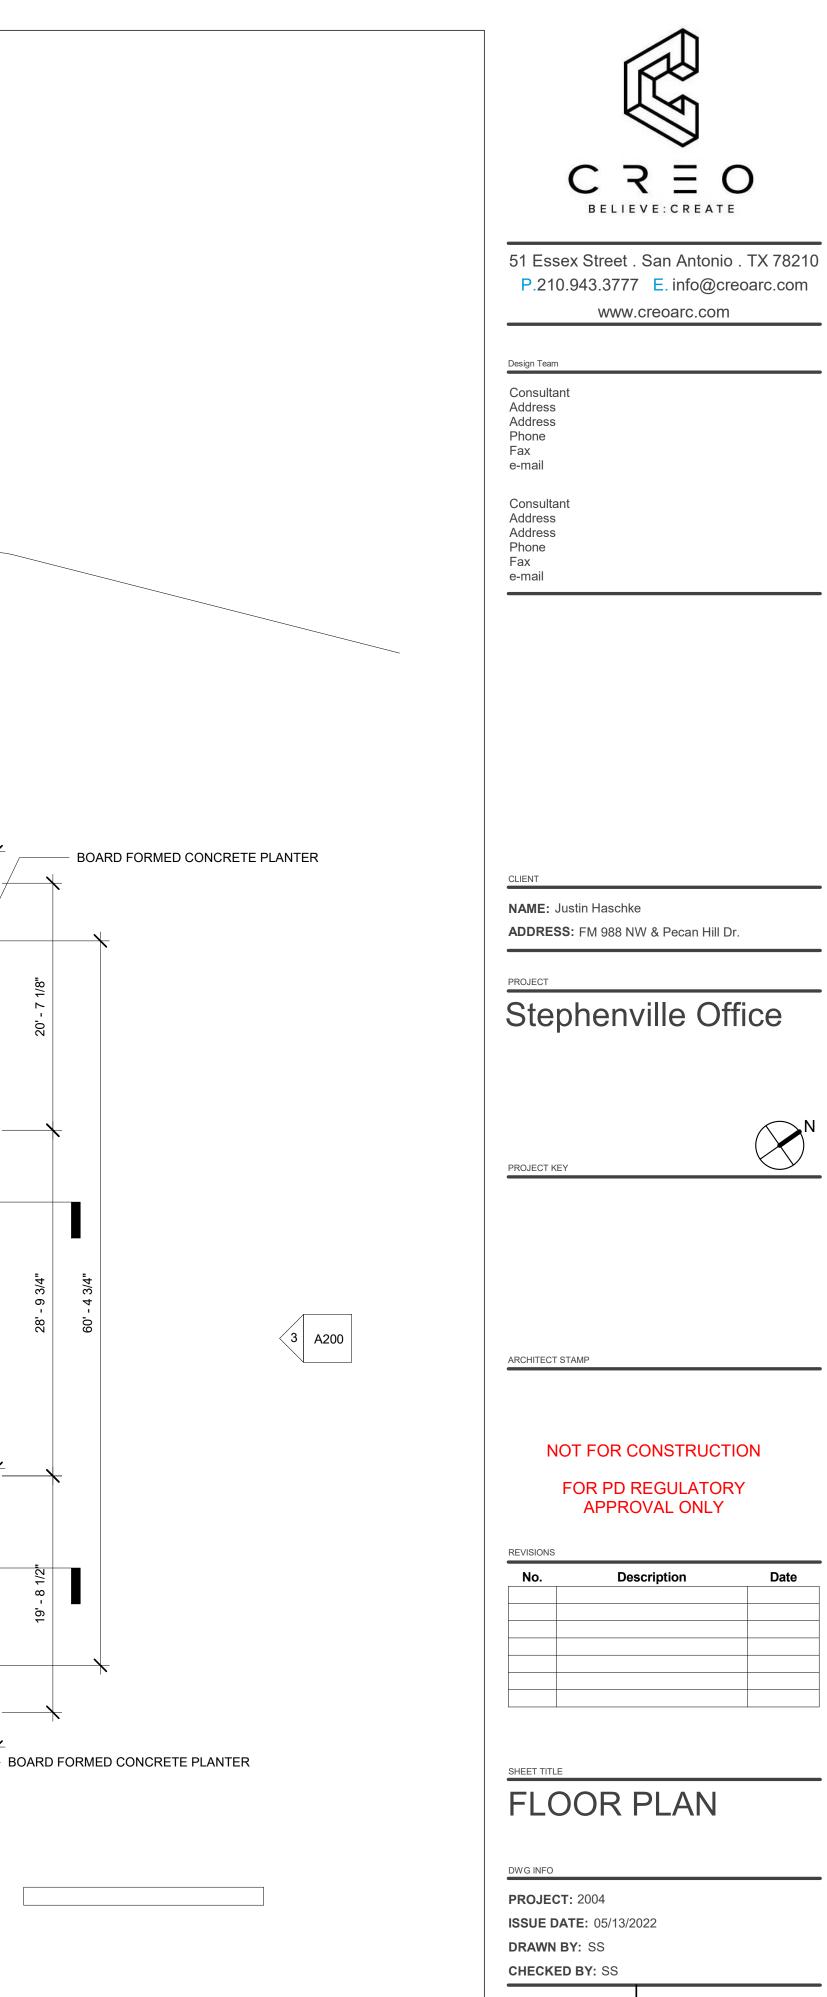

SHEET

A110





NOTES: 1. GENERAL CONTRACTOR TO USE PROVIDED FINISH AND LIGHT FIXTURE INFORMATION AS BASIS OF DESIGN AND PRESENT ALTERNATIVE MANUFACTURER'S TO OWNER AS REQ'D.

2. SWITCH LOCATIONS TO BE VERIFIED WITH OWNER/ARCHITECT PRIOR TO INSTALLATION.

REFLECTED CEILING PLAN LEGEND			
	GYP. BOARD WOOD SLATS - STAINED		
ø	RECESSED LED LIGHT 4' RECTANGULAR SURFACE MOUNTED LIGHT		
() ()	SUSPENDED LIGHT FIXTURE		
	60"X36" SKYLIGHT		
Ø	EXTERIOR DOWN LIGHT		



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CLIENT

NAME: Justin Haschke ADDRESS: FM 988 NW & Pecan Hill Dr.

# Stephenville Office

PROJECT



NOT FOR CONSTRUCTION

FOR PD REGULATORY APPROVAL ONLY

Description



PROJECT KEY \_

ARCHITECT STAMP

REVISIONS

No.

SHEET TITLE



Date


SKYLIGHT

- SUSPENDED LIGHT FIXTURE - EXPOSED TRUSSES

- GYP. CEILING



- RECESSED LED LIGHT

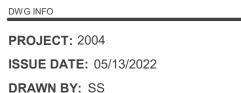


REFLECTED

CEILING PLAN

DRAWN BY: SS CHECKED BY: SS

SHEET




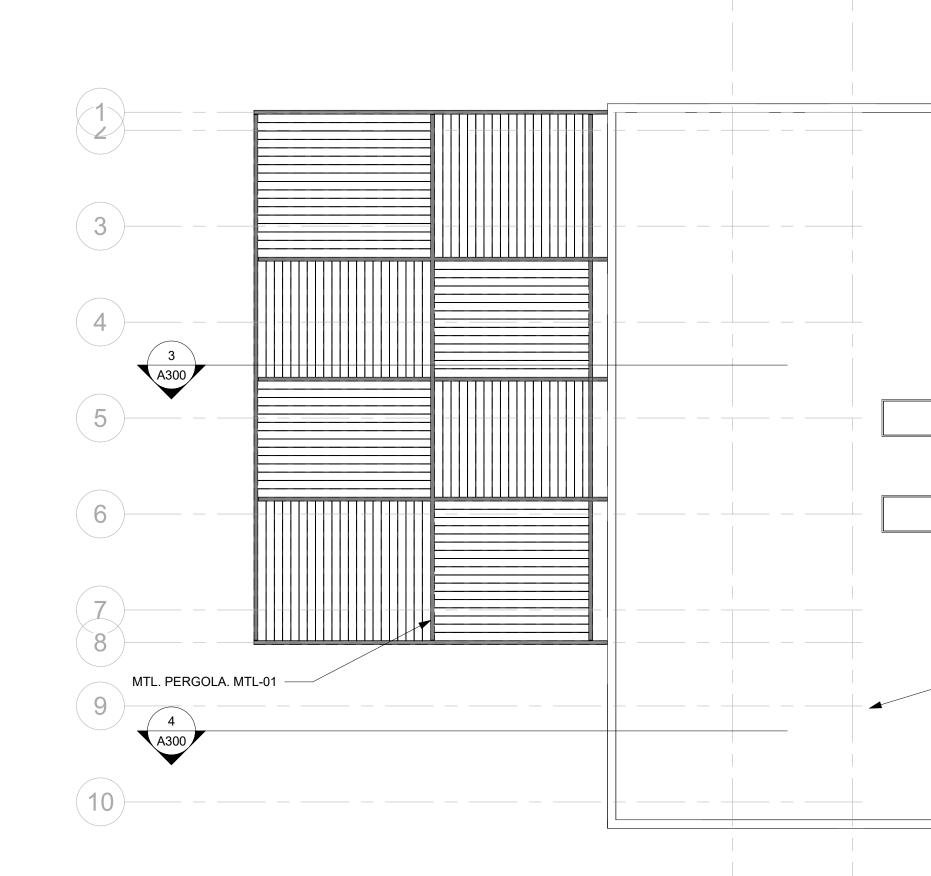

B

A



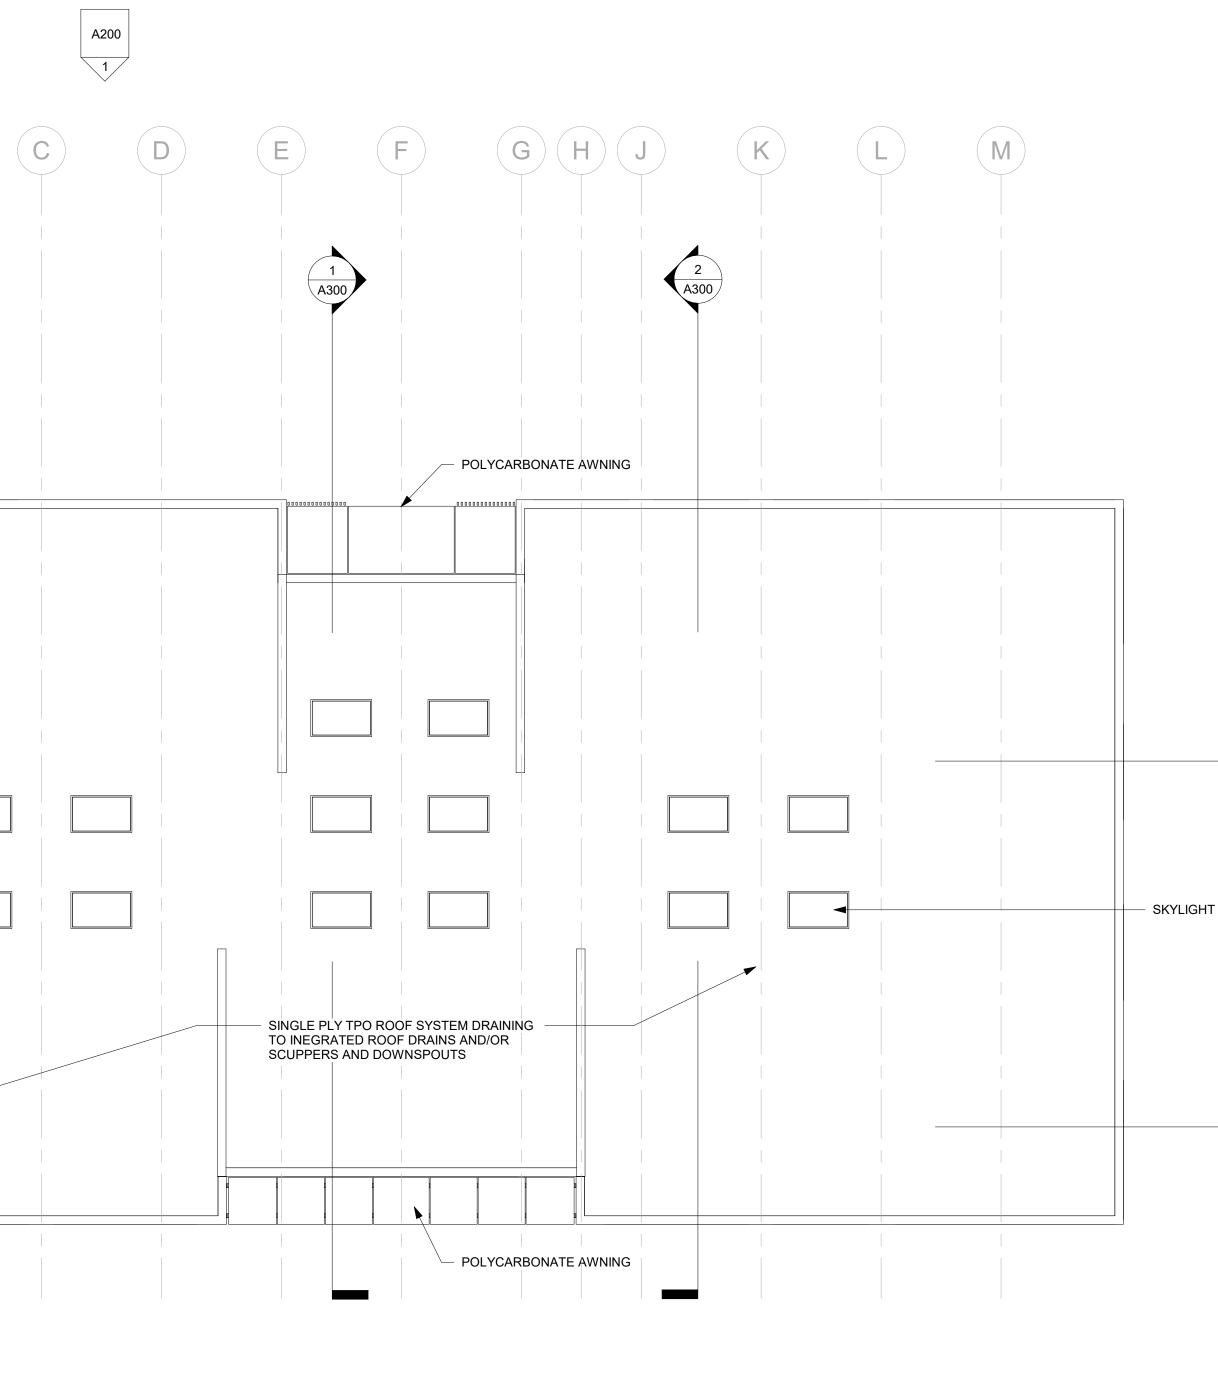

1 ROOF PLAN 1/8" = 1'-0"

1/8" =

2

A200



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#### Design Team

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CLIENT

**NAME:** Justin Haschke **ADDRESS:** FM 988 NW & Pecan Hill Dr.

PROJECT

# Stephenville Office

PROJECT KEY



ARCHITECT STAMP

3 A200

## NOT FOR CONSTRUCTION

#### FOR PD REGULATORY APPROVAL ONLY

# No. Description Date Image: Strategy of the strategy of


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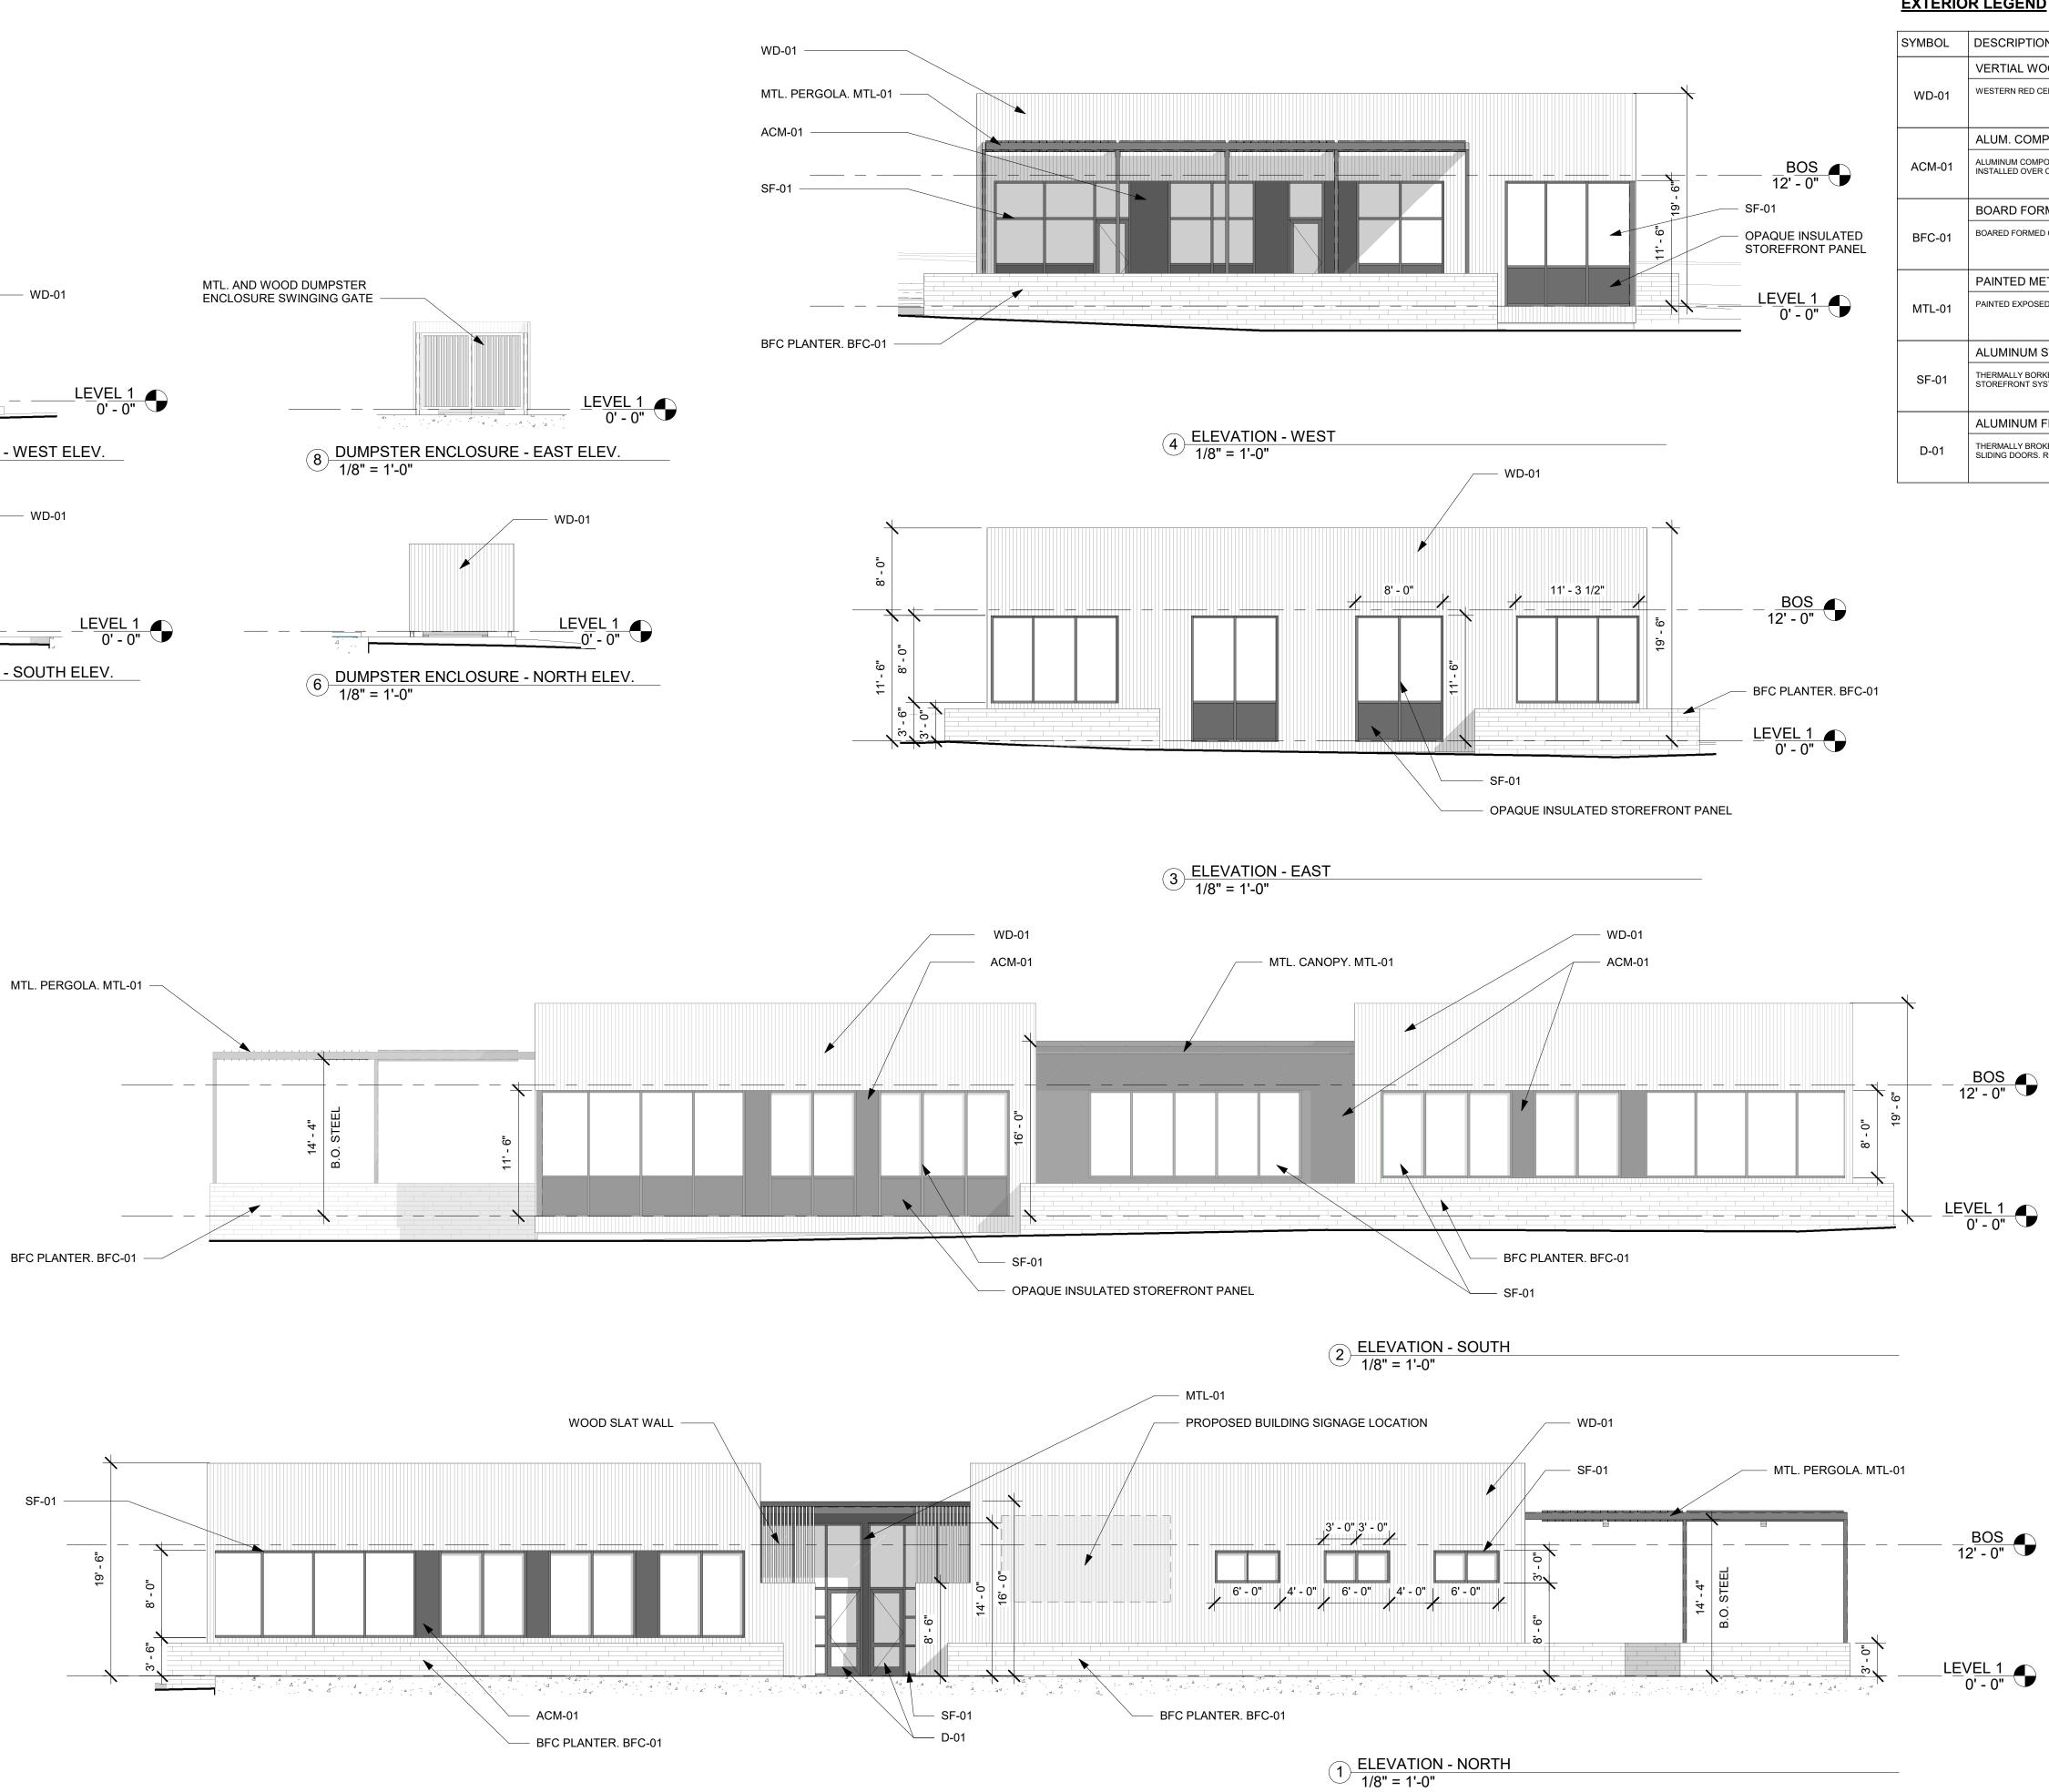
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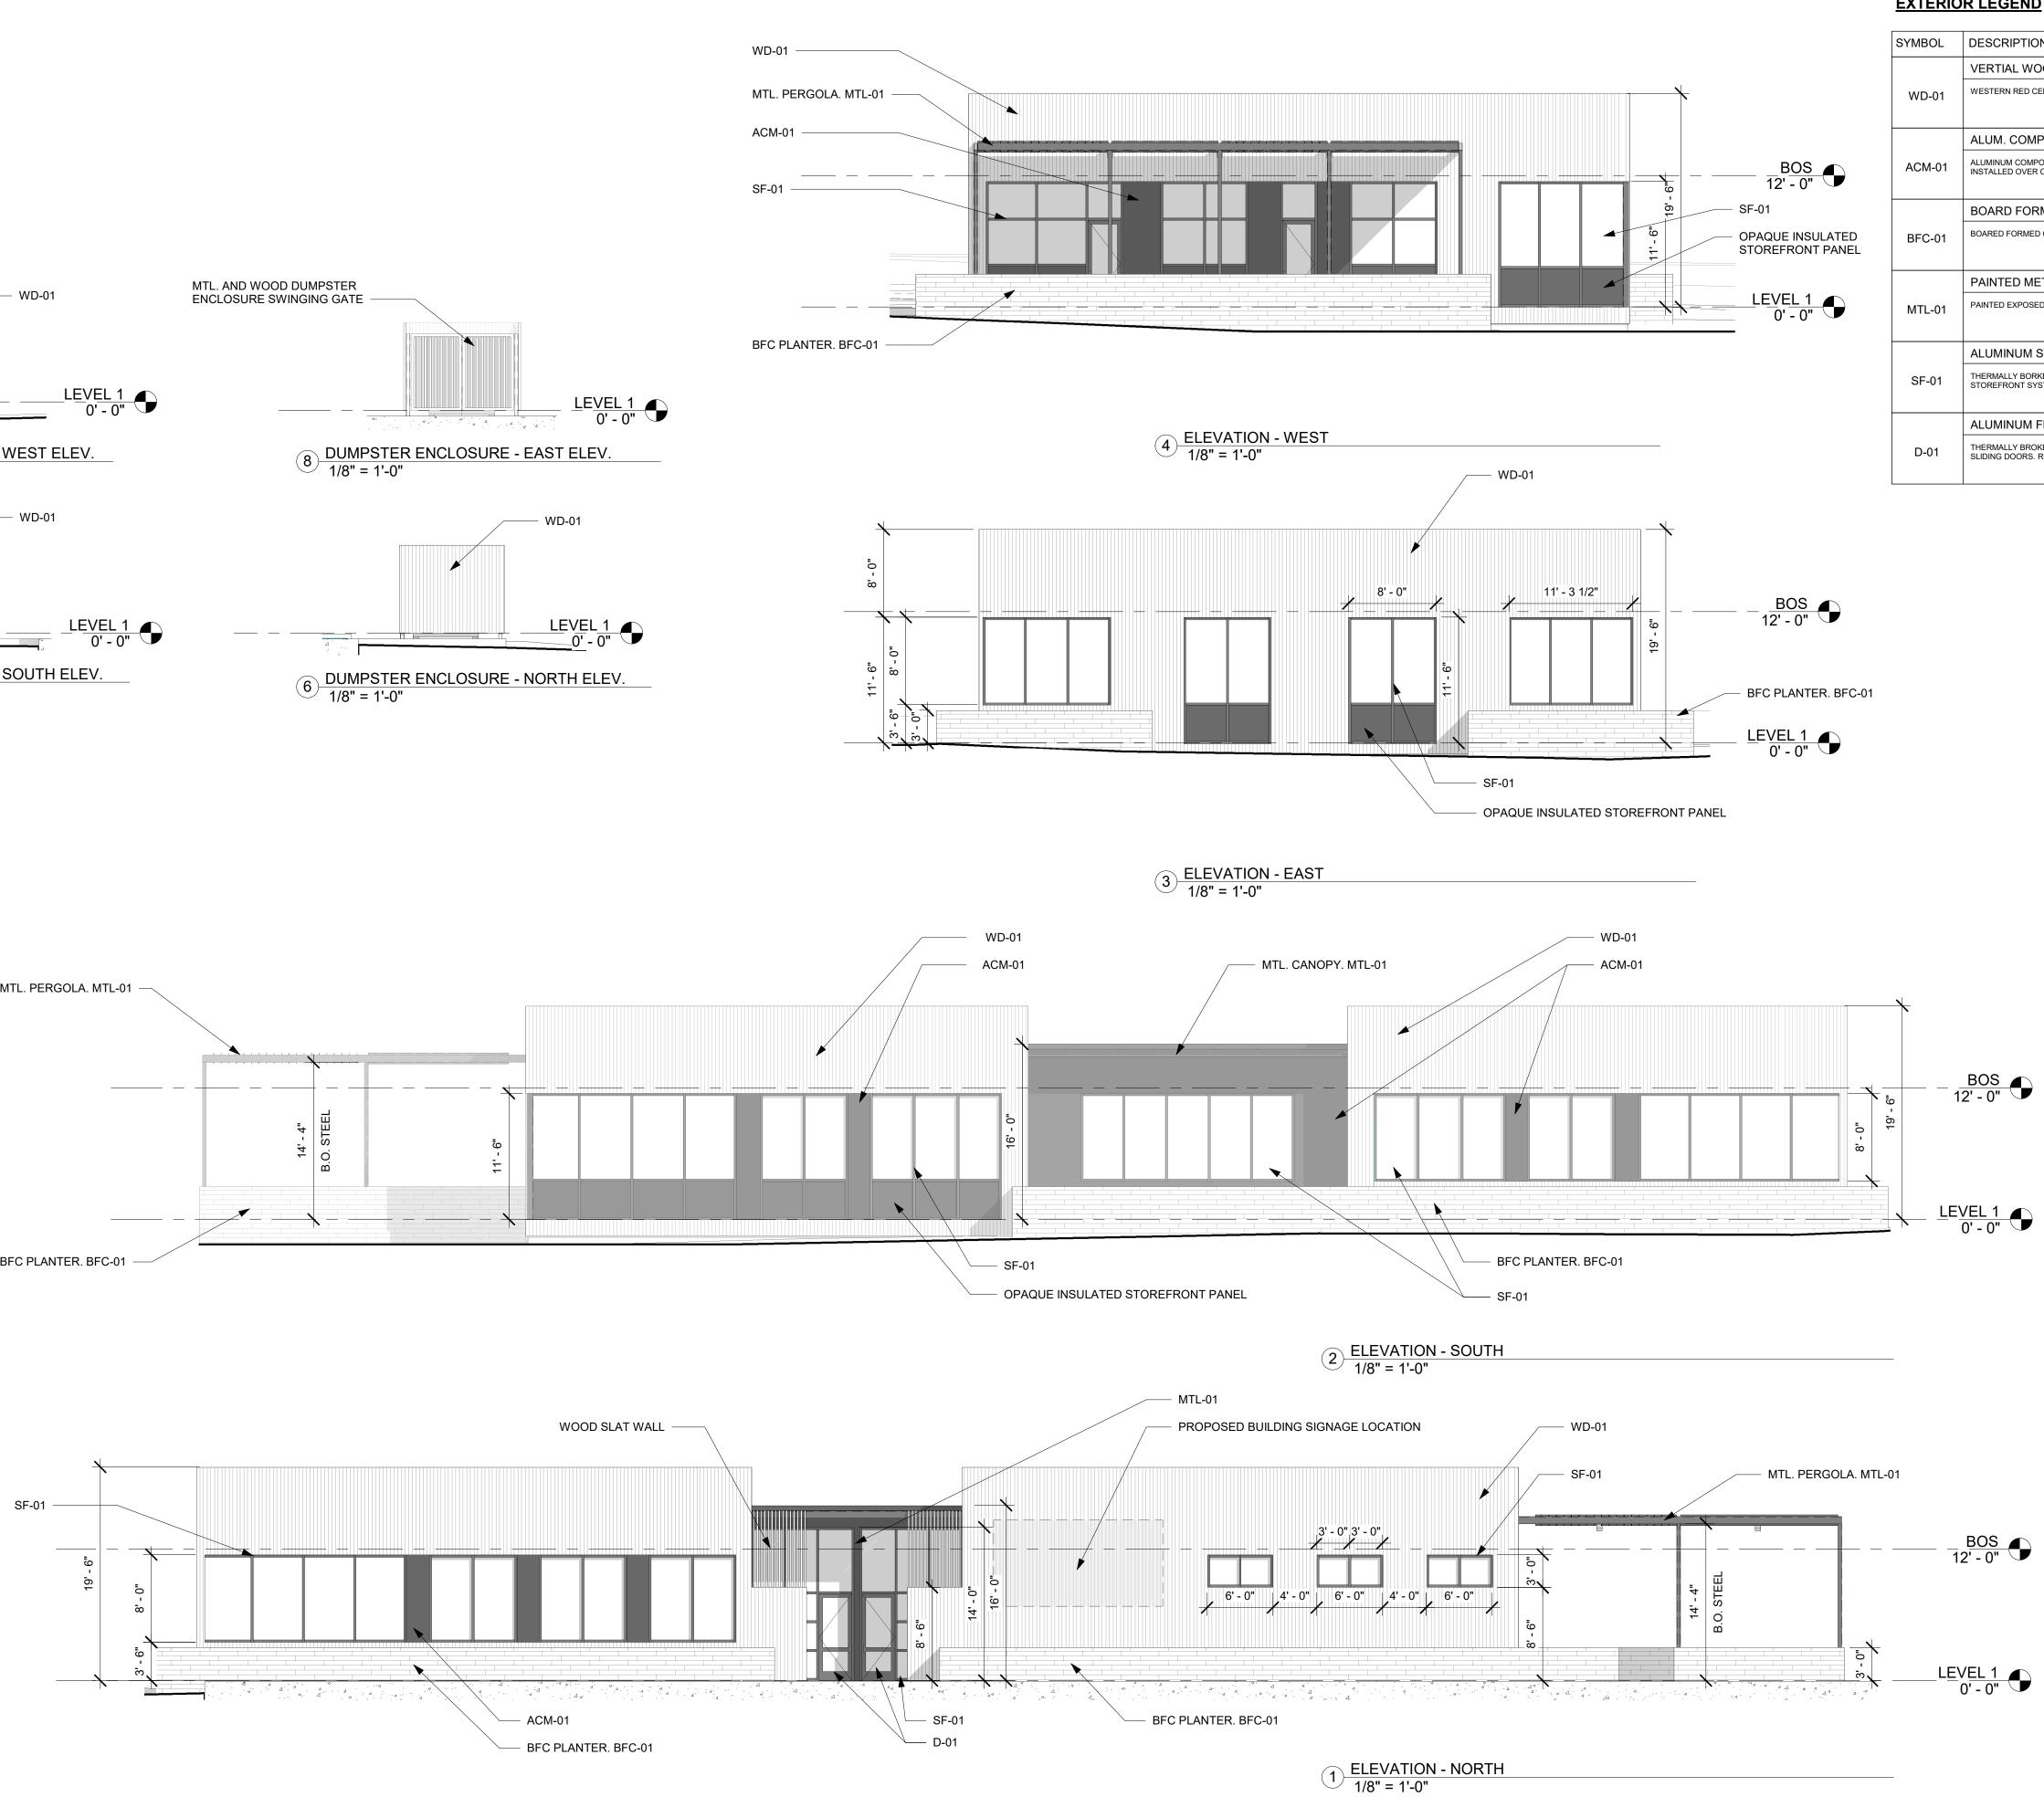
DWG INFO









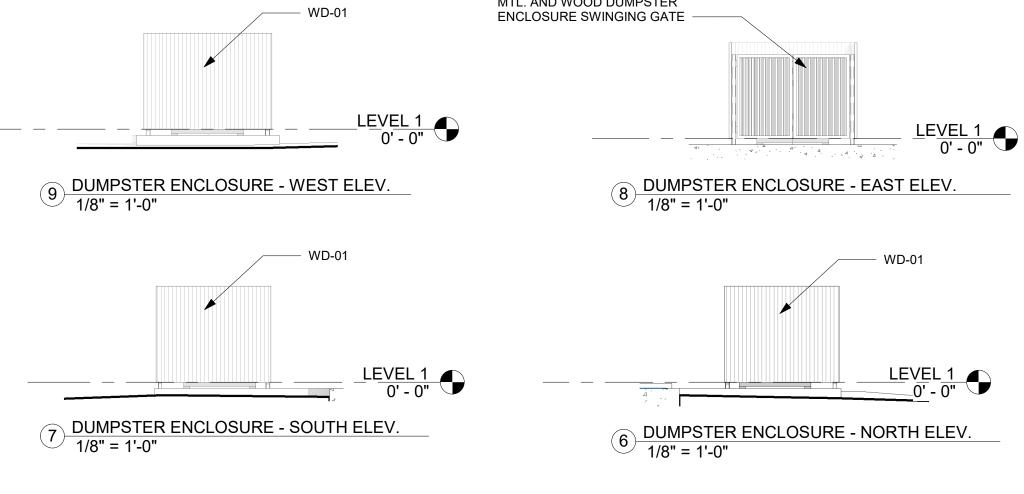

#### EXTERIOR LEGEND

SYMBOL	DESCRIPTION	
	VERTIAL WOOD RAINSCREEN FACADE	
WD-01	WESTERN RED CEDAR RAINSCREEN FACADE	
	ALUM. COMPOSITE METAL PANEL	
ACM-01	ALUMINUM COMPOSITE METAL PANEL SYSTEM INSTALLED OVER C.I.	
	BOARD FORMED CONCRETE	
BFC-01	BOARED FORMED CONCRETE WALL / PLANTER	
	PAINTED METAL	
MTL-01	PAINTED EXPOSED METAL.	
	ALUMINUM STOREFRONT	
SF-01	THERMALLY BORKEN ANNODIZED ALUMINUM STOREFRONT SYSTEM	
	ALUMINUM FRAMED DOORS	
D-01	THERMALLY BROKEN ANNODIZED ALUMINUM FRAMED SLIDING DOORS. REFER TO DOOR SCHEDULES	



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EVISIONS			
No.	Description	Date	


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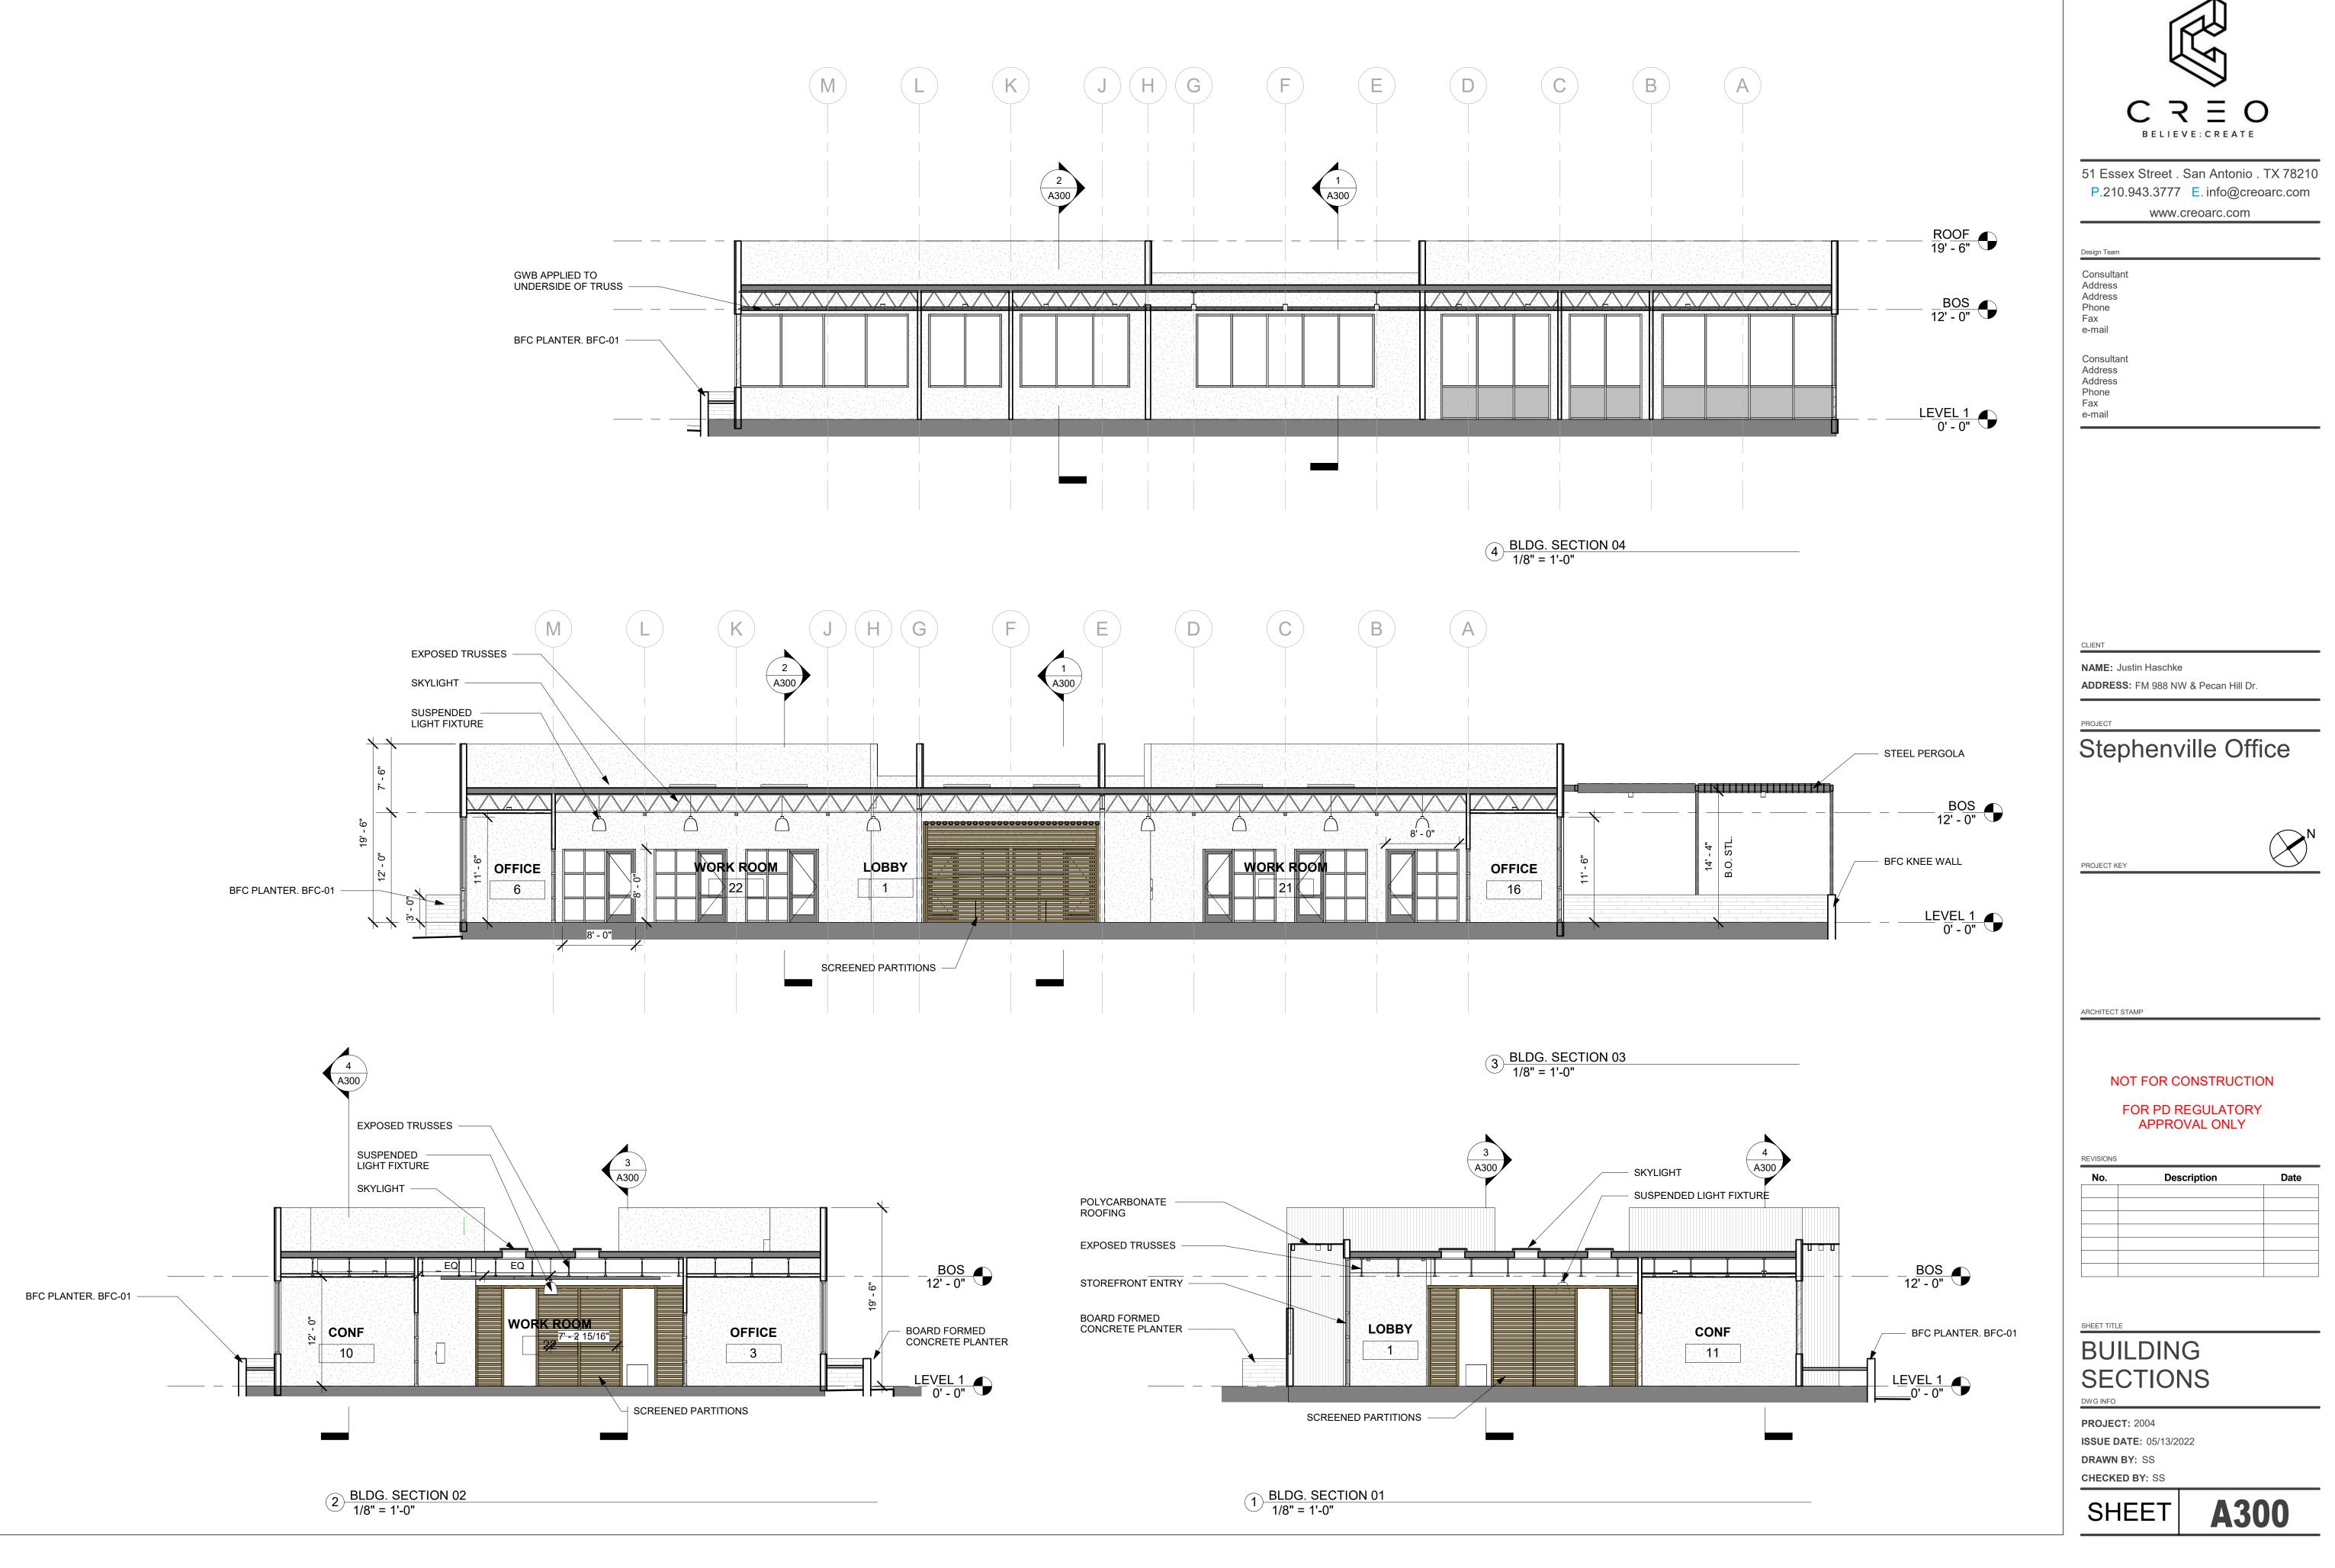
# ELEVATIONS


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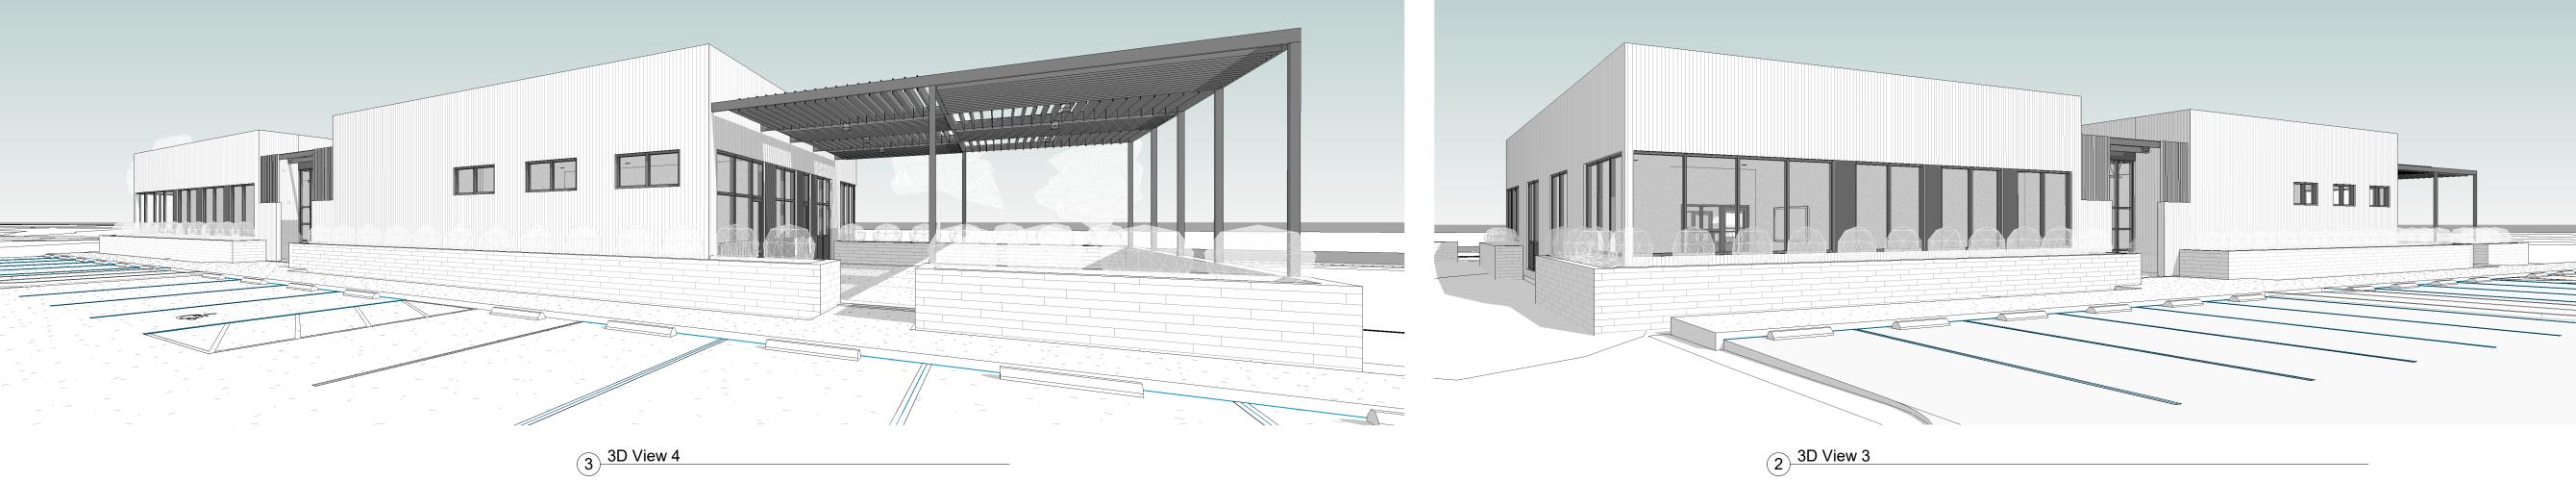









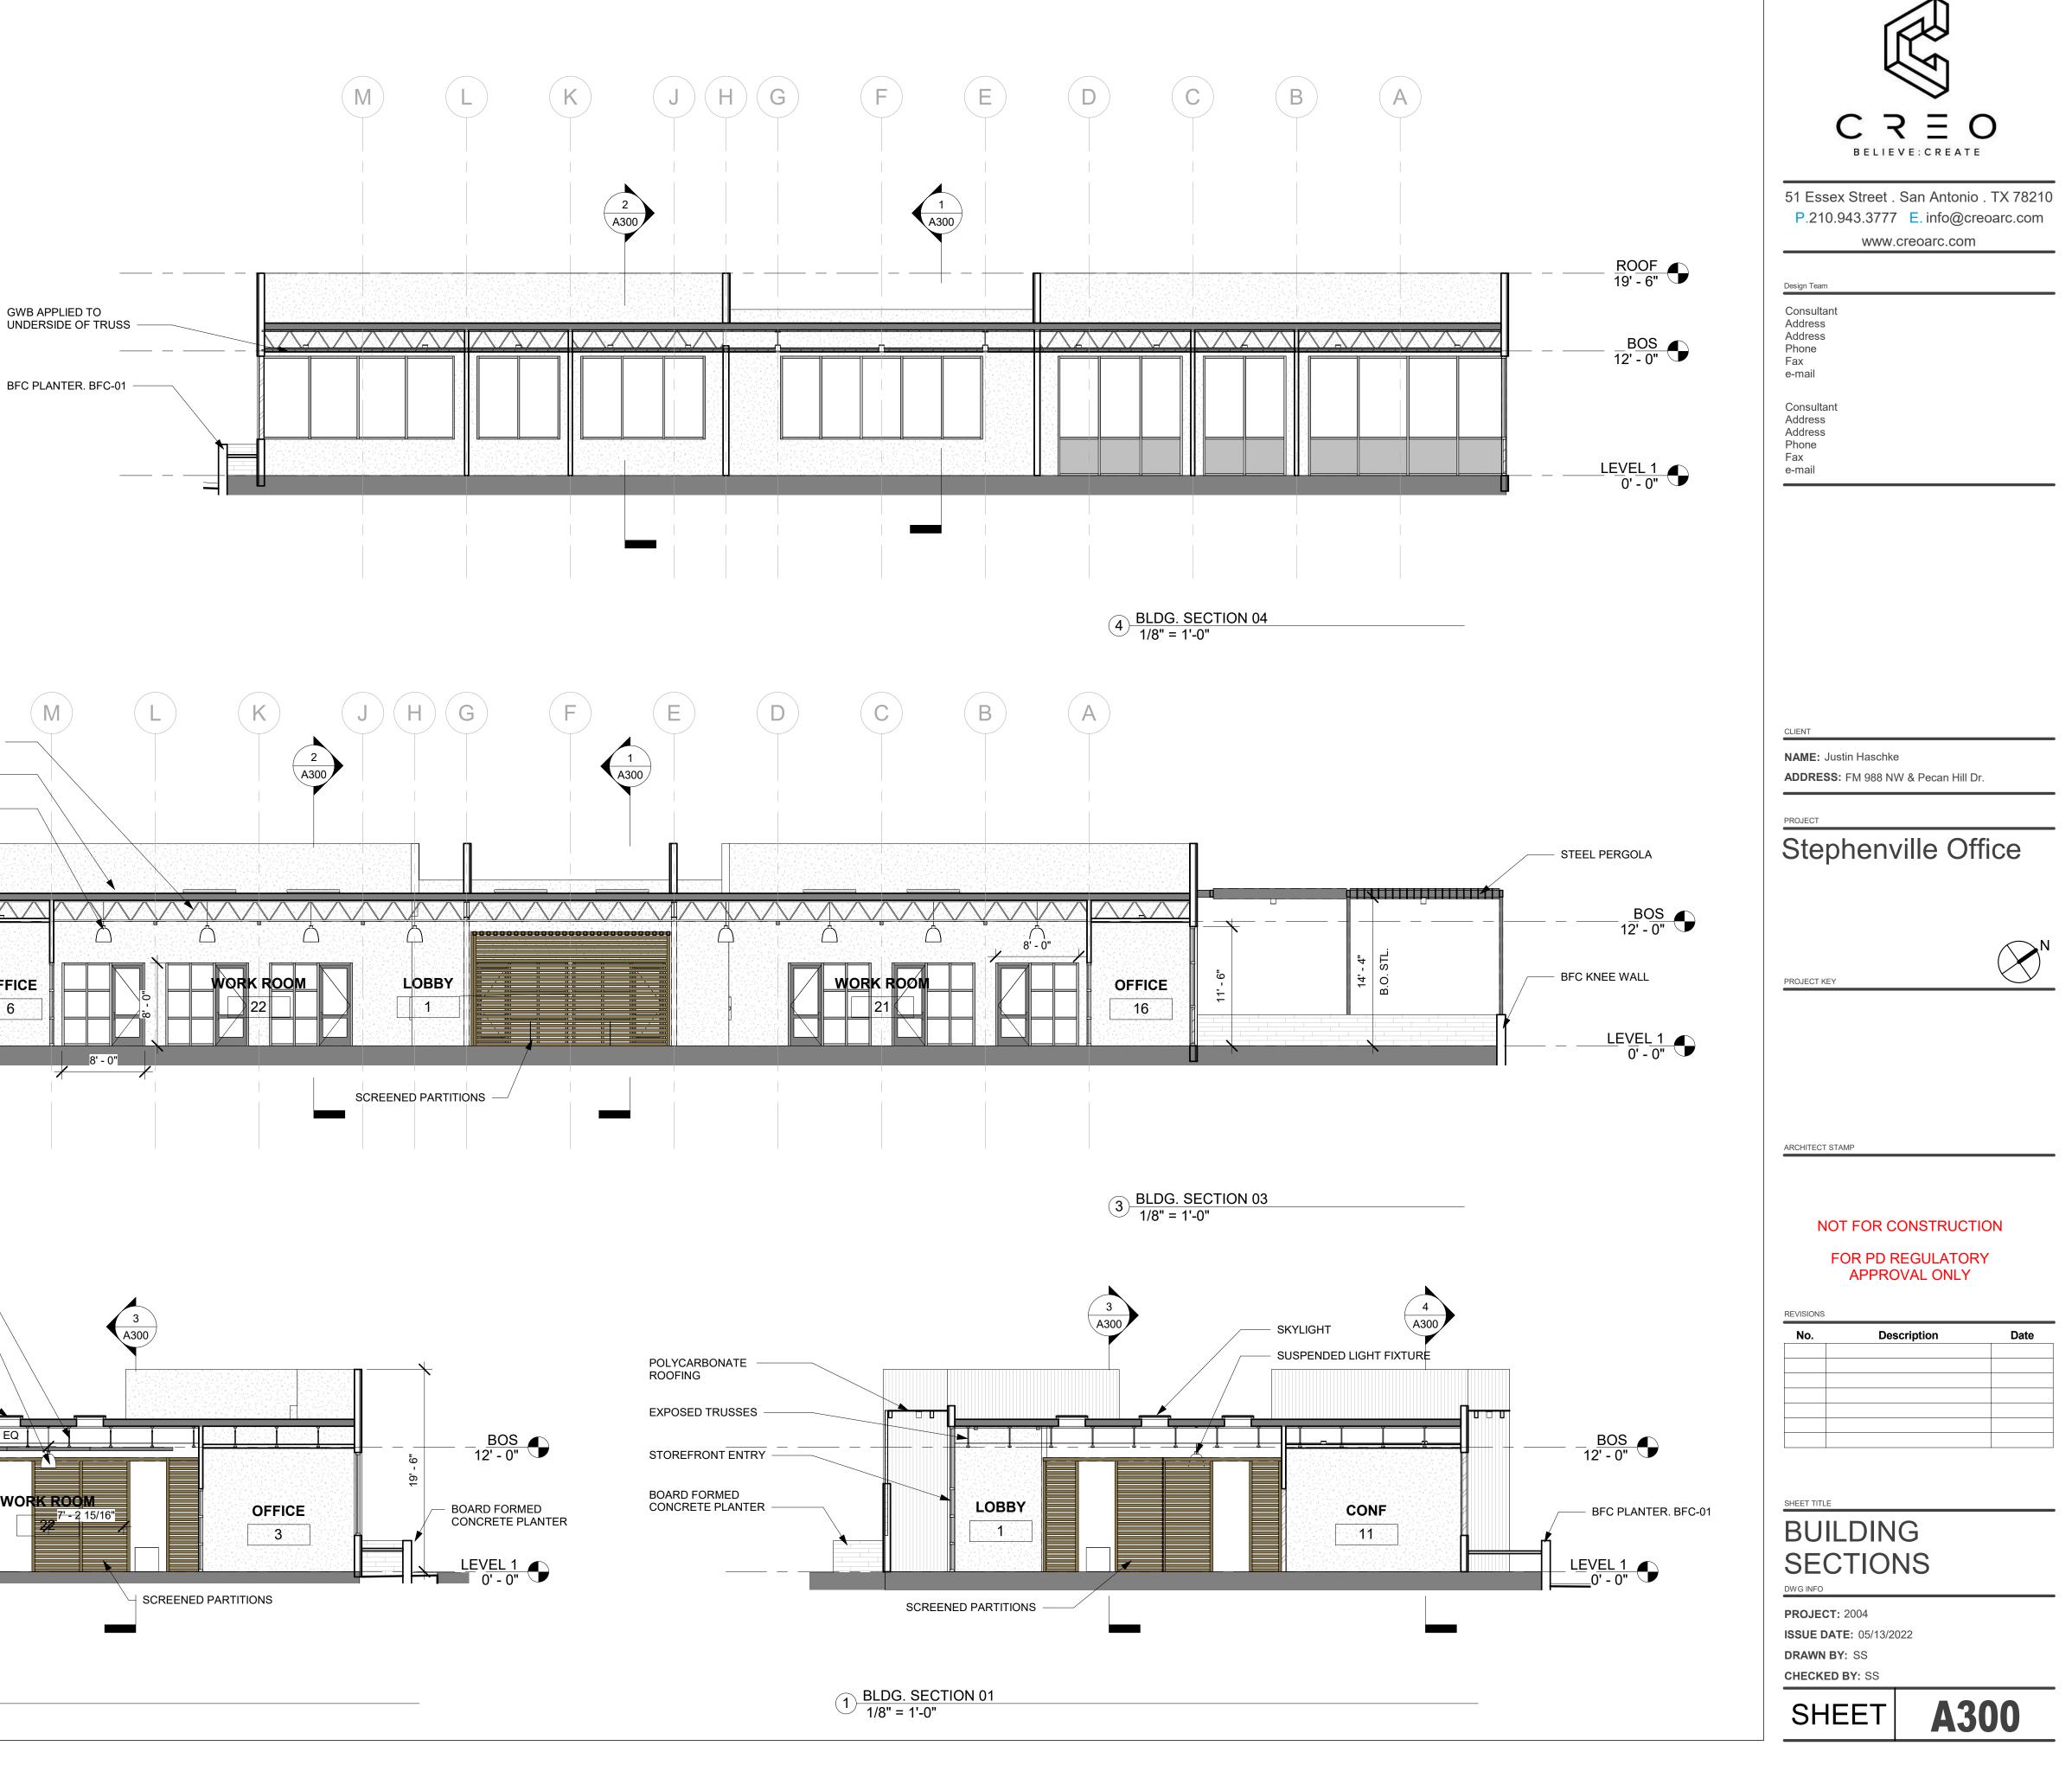

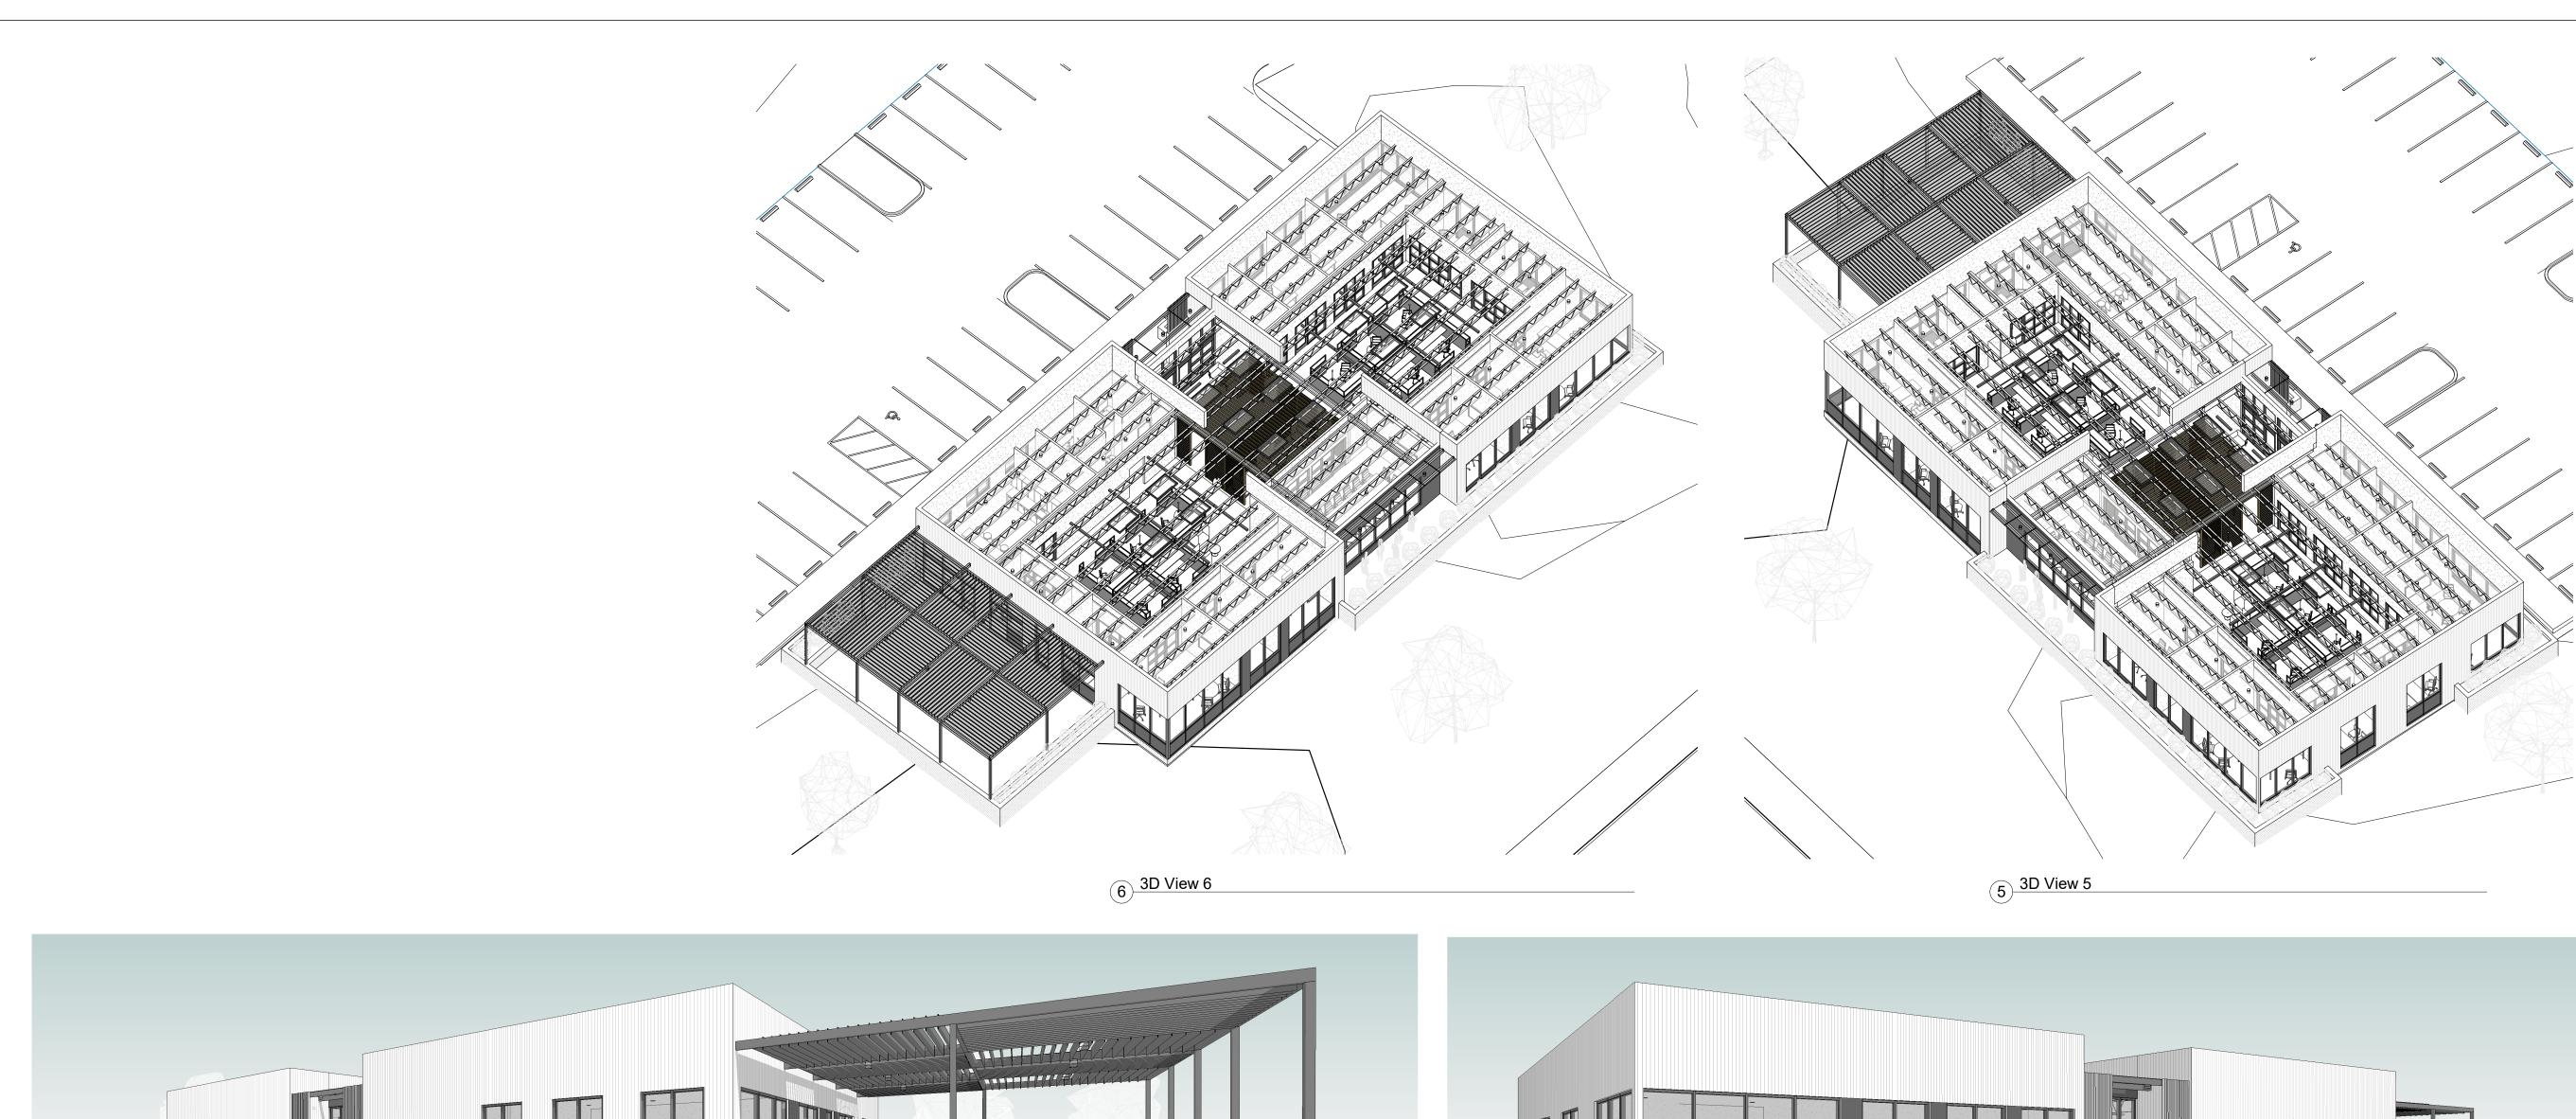



1 3D View 2

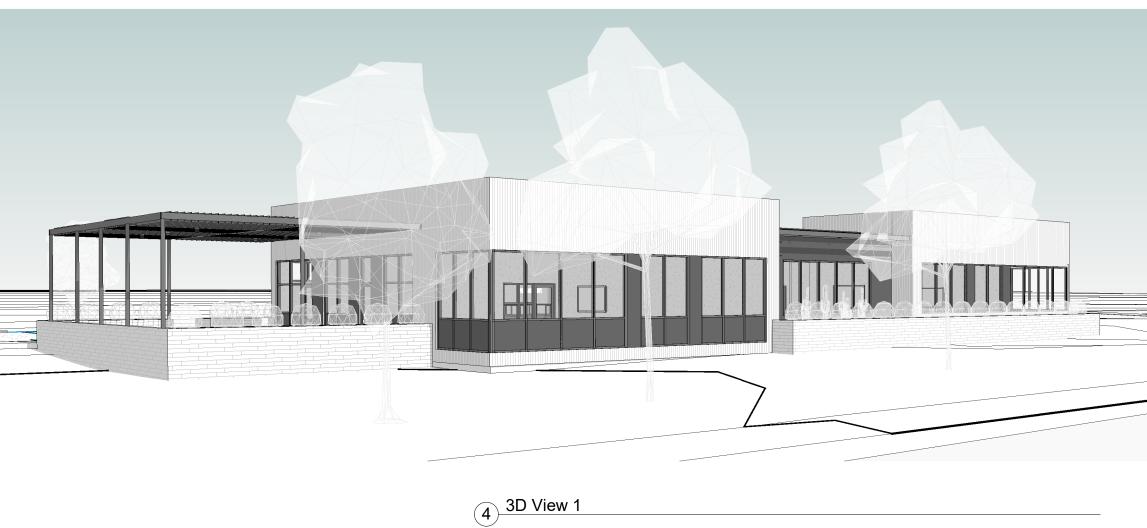



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# REVISIONS

No.	Description	Date

SHEET TITLE

# 3D VIEWS

DWG INFO



