

CITY OF ST. HELENS PLANNING DEPARTMENT

MEMORANDUM

TO: Planning Commission acting as the Historic Landmarks Commission

FROM: Jennifer Dimsho, AICP, Associate Planner
RE: Architectural Review at 230 Strand Street

DATE: December 5, 2023

We received Building Permit No. 749-23-000432-STR and Site Development Review (Minor) for a new elevator and related exterior site improvements to 230 Strand Street, which is the Courthouse Annex building.

Per SHMC 17.132.172 (7), permanent exterior architectural changes to buildings must comply with the *Riverfront District Architectural Guidelines*. The Historic Landmarks Commission shall make a recommendation to the approval authority as to whether the Commission believes the proposal complies. Please review your copy of the Guidelines when looking at this proposal and be prepared to discuss. The Guidelines can also be found on the City website on the City's website:

https://www.sthelensoregon.gov/planning/page/riverfront-district-architectural-design-guidelines

Generally, the Courthouse annex is not compatible with the bulk of the buildings in the Riverfront District and considered a non-contributing structure to the historic district. In addition, the area of work for the elevator and related site improvements is tucked within the alley between the historic Courthouse and the annex building.



Existing alley where elevator and related site improvements are proposed

Staff identified a relevant Guidelines: the building façade/entry, lighting, material & building colors, roofs, and windows. The Commission may identify other relevant Guidelines during discussion.

Building Façade/Entry: The existing courthouse annex main entry is not proposed to be altered. However, there is a new west-facing aluminum door to the vestibule elevator entrance which will service the historic courthouse and the annex building proposed. What is currently a vehicular accessible alley will become an accessible walkway with a ramp and handrails. In the right-of-way, they are proposing a new parallel ADA parking space and modifications to the sidewalk ramps.

Given that the elevator work focuses on making the historic courthouse more accessible without impacting the exterior of the historic courthouse, staff feels adding a new building entry is warranted. For new doors, the Guidelines support using traditional building materials of a similar texture, pattern, and scale as those found in the Riverfront District. Does the Commission support the use of an aluminum door system for the new west facing entry, given that the Courthouse annex is not compatible with most of the buildings in the Riverfront District (not traditional construction) and that the new entry is not very visible because of its location?

Lighting: The applicant is proposing to relocate and repurpose the existing light fixture. This light fixture is currently mounted on the annex building (pictured right). It is unclear where this light fixture is proposed to be relocated as it is identified in the same location on both the existing and proposed site plan. The Commission could consider a condition of approval to ensure the light is relocated on the courthouse annex building (not the historic courthouse building) since it is unclear where it will be installed.




Material & Building Colors: During rehabilitation of buildings, the Guidelines support replacement of materials with similar material types to maintain the original appearance of the structure. With the new elevator shaft, there is a significant portion of the elevation's siding which will be renovated. The applicant notes that the wood siding is to match existing siding in style, texture, and color. Staff feels this complies. Does the Commission agree?

Roof: The Guidelines require minimizing the visual impact of mechanical systems and equipment by locating these as far away from the façade as possible. It appears that there are no mechanical components for the elevator which are visible on the roof. The Site Development Review (minor) review will require screening of any mechanical units that would be visible, even if they are not shown on preliminary plans.

Windows: The new elevator vestibule includes a floor-to-ceiling aluminum window system on the south elevation, likely for safety reasons. The Guidelines support maximizing window-to-wall ratio of ground-floor facades in new construction and/or additions. Staff feels a floor-to-ceiling aluminum window system for on the south face of the vestibule complies. Does the Commission agree?

PROJECT #: 23-009 DATE: 13-OCT-2023 DRAWN BY: CG CHECK BY: NDC OVERALL SITE PLAN SSUED FOR: Α 100

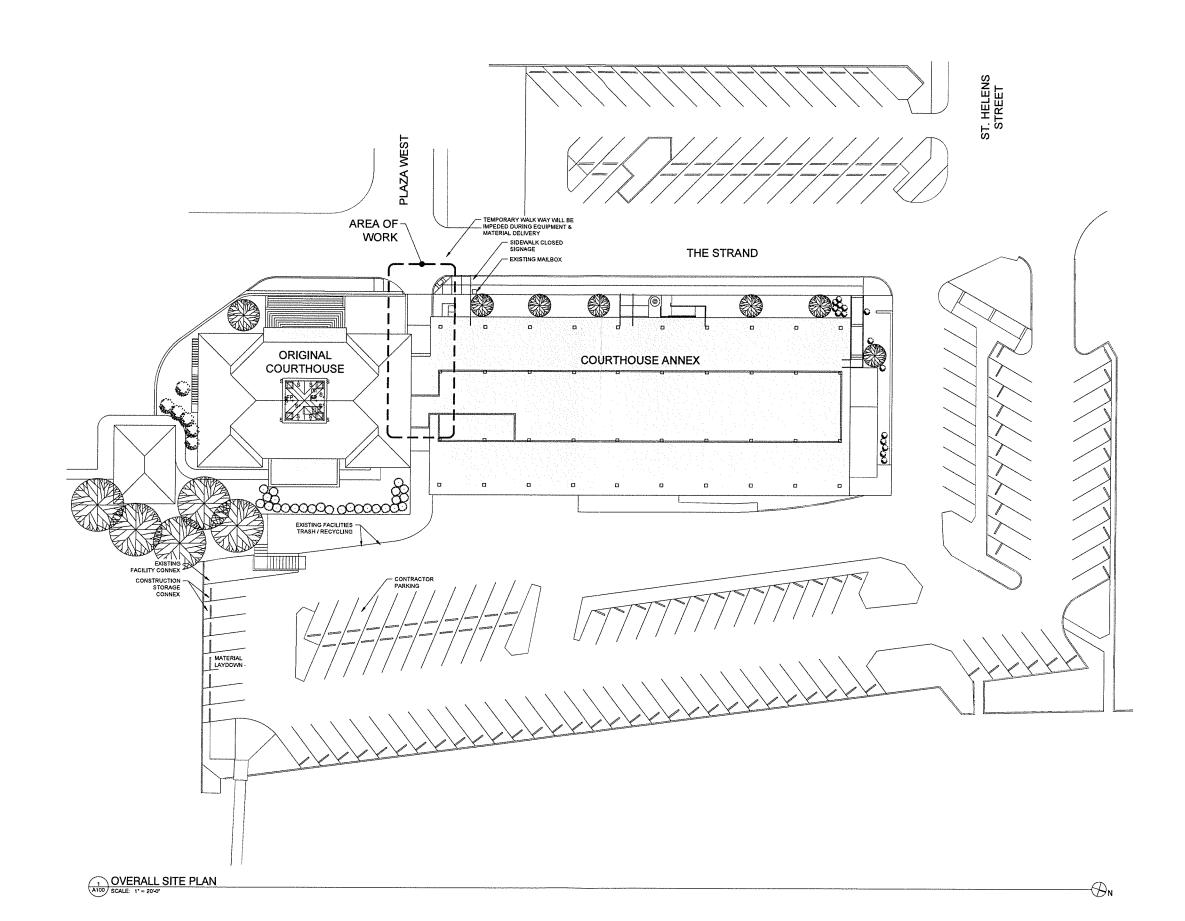

NOT FOR CONSTRUCTION

Ш

 \overline{S}

COLUMBIA COUNTY DESIGN-BUILD IMPROVEMENTS COLUMBIA COUNTY COURTHOUS

TREMOVE EXISTING CONCRETE PAVING AND SUB-BASE. PROTECT UNDERGROUND UTILITIES, IRRIGATION SYSTEM, OIL TANK A ALL OTHER KNOWN OR UNKNOWN ELEMENTS.

(4) REMOVE ABANDONED IN-GROUND VALVE BOX. (5) REMOVE EXISTING CONCRETE SIDEWALK & ASPHLAT PAVING, REFER TO ENLARGE PLANS FOR MORE INFORMATION.

2 REMOVE EXISTING DECORATIVE ROCK

KEY NOTES

3 REMOVE VENT PIPE.

(5) VERIFY EXTERIOR CONDUIT & JUNCTION BOX, REMOVE IF ABANDONED.

7 NEW CONCRETE PAVING, PER ASSEMBLY DETAIL. NEW ADA RAMP & RAILING, REFER TO ENLARGED PLANS FOR MORE INFORMATION.

8 NEW ADA PARKING, REFER TO ENLARGED PLANS FOR INFORMATION.

9 NEW DECORATIVE ROCK. IF EXISTING ROCK IS REUSED, CLEAN ROCK PRIOR TO RE-USE.

(10) EXCAVATE AS NEEDED FOR NEW ADA RAMP, ELEVATOR PIT, & FOUNDATIONS, REFER TO STRUCTURAL DRAWINGS FOR MORE INFORM

11) RELOCATE OIL TANK VENT PIPE.

(12) RELOCATE SECURITY CAMERAS, PER OWNER'S DIRECTION.

(13) RELOCATE FIRE ALARM.

14 RELOCATE WALL MOUNTED LIGHTS.

GENERAL NOTES

CONTRACTOR IS TO BE FAMILIAR WITH AND FIELD VERIFY SCOPE OF WORK (SHOWN & UNSHOWN) PRIOR TO THE COMMENCEMENT OF DEMOLITION, REPORT ANY DISCREPANCIES TO ARCHITECT.

2. CONTRACTOR IS RESPONSIBLE FOR DISCONNECTING ELECTRICAL, GAS, OR ANY OTHER 'LIVE' UTILITY SERVICES PRIOR TO COMMENCEMENT OF DEMOLITION

NOTIFY ARCHITECT OF UNFORSEEN ROT, DE-LAMINATION OR OTHER DEFECTS IN STRUCTURAL MEMBER THAT REMAIN AFTER DEMOLITION.

CONTRACTOR IS RESPONSIBLE FOR WASTE REMOVAL AND MATERIAL RECYCLING, AS DIRECTED BY THE OWNER. SITE IS TO BE CLEARED OF WASTE DEBRIS DAILY.


5. PROCEDURES FOR DEMOLITION SHALL BE CONDUCTED IN A MANNER SAFE FOR PROJECT PERSONNEL AND THE PUBLIC ATLANGE. PROTECT OR CLOSE ALL BUILDING ENTRANCES AND PUBLIC WALKWAYS ADJACENT TO PROJECT STEE CORDINATE WITH OWNER PRIOR TO IMPLEMENTING SAFETY MEASURES.


6. CONTRACTOR SHALL BE RESPONSIBLE REPAIRING DAMAGE TO OWNER'S PROPERTY AND NEIGHBORING PROPERTIES AS A RESULT OF THIS WORK, INCLUDIN CITY UTILITIES / INFRASTRUCTURE.


COORDINATE AND COMPLY WITH OWNER AND AHJ RESTRICTIONS INVOLVING PERMITS, WORKING HOURS, NOISE, ODORS, MATERIAL STAGING, AND PARKING.

EXISTING BUILDING MAY CONTAIN HAZARDOUS
MATERIALS, IF DISCOVERED, COORDINATE SCOPE OF
REMOVAL WITH OWNER AND FOLLOWALL CITY, STATE,
AND FEDERAL REGULATIONS.

 \bigcirc N,

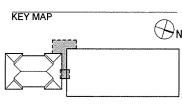

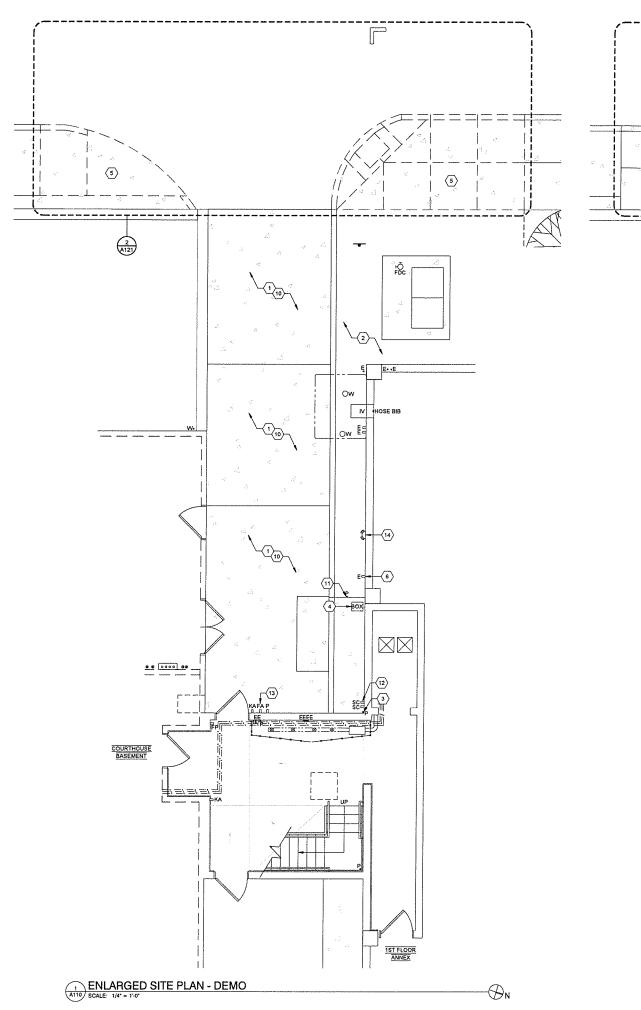

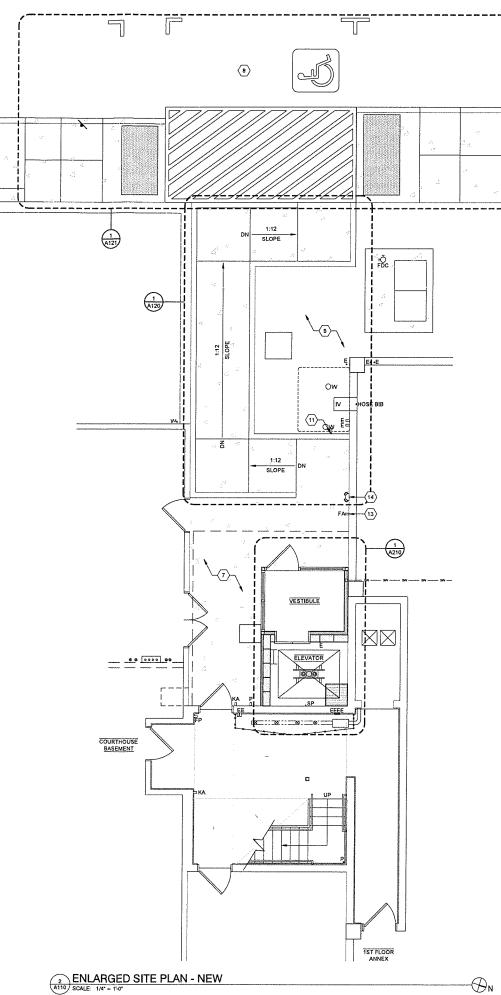

PROJECT #: 23-009

DATE: 13-OCT-2023 DRAWN BY: CG CHECK BY: NDC

ENLARGED SITE PLAN -DEMO & NEW

1) RE-ROUTE EXISTING ELECTRICAL CONDUIT.

REMOVE PART OF PARAPET STRUCTURE & FINISHES FOR NEW ELEVATOR SHAFT.

SECURITY CAMERA FLOOD LIGHT

FIRE ALARM SECURITY LOCK

ELECTRICAL EQUIPMENT ON WALL

5 RELOCATE SECURITY CAMERAS. (6) RELOCATE WALL MOUNTED LIGHTING FIXTURE.

(7) RELOCATE FIRE ALARM.

LEGEND

0<u>ę</u>20

•

KEY NOTES

B RELOCATE VENT PIPE. 9 REMOVE VENT PIPE.

GENERAL NOTES

CONTRACTOR IS TO BE FAMILIAR WITH AND FIELD VERIFY SCOPE OF WORK (SHOWN) & UNSHOWN) PRIOR TO THE COMMENCEMENT OF DEMOLITION. REPORT ANY DISCREPANCIES TO ARCHITECT.

CONTRACTOR IS RESPONSIBLE FOR DISCONNECTING ELECTRICAL, GAS, OR ANY OTHER 'LIVE' UTILITY SERVICES PRIOR TO COMMENCEMENT OF DEMOLITION.

NOTIFY ARCHITECT OF UNFORSEEN ROT, DE-LAMINATION, OR OTHER DEFECTS IN STRUCTURAL MEMBER THAT REMAIN AFTER DEMOLITION.

CONTRACTOR IS RESPONSIBLE FOR WASTE REMOVAL AND MATERIAL RECYCLING, AS DIRECTED BY THE OWNER. SITE IS TO BE CLEARED OF WASTE DEBRIS DAILY.

5. PROCEDURES FOR DEMOLITION SHALL BE CONDUCTED IN A MANNER SAFE FOR PROJECT PERSONNEL AND THE PUBLIG AT-LARGE. PROTECT OR CLOSE ALL BUILDING ENTRANCES AND PUBLIC WALKWAYS ADJACENT TO PROJECT SITE, COORDINATE WITH DOWNER PRIOR TO IMPLEMENTING SAFETY MEASURES.

6. CONTRACTOR SHALL BE RESPONSIBLE REPAIRING DAMAGE TO OWNER'S PROPERTY AND NEIGHBORING PROPERTIES AS A RESULT OF THIS WORK, INCLUDING CITY UTILITIES / INFRASTRUCTURE.

COORDINATE AND COMPLY WITH OWNER AND AHJ RESTRICTIONS INVOLVING PERMITS, WORKING HOURS, NOISE, ODORS, MATERIAL STAGING, AND PARKING.

EXISTING BUILDING MAY CONTAIN HAZARDOUS
MATERIALS. IF DISCOVERED, COORDINATE SCOPE OF
REMOVAL WITH OWMER AND FOLLOW ALL CITY, STATE,
AND FEDERAL REGULATIONS.

KEY MAP



1 ANNEX UPPER ROOF ANNEX LOWER ROOF 2 **♦** 2ND LEVEL 24'-0" (3)-**5**~ (e)— ♦1ST LEVEL 5 9 BASEMENT _____

2 EXISTING ELEVATOR - SOUTH ELEVATION DEMO

EXISTING ELEVATOR - WEST ELEVATION

SCALE 1/4" = 1'-0"

 $\langle 4 \rangle$

7

ANNEX UPPER ROOF

ANNEX LOWER ROOF

♦2ND LEVEL

♦ IST LEVEL

♦BASEMENT

PROJECT #: 23-009 DATE: 13-OCT-2023 DRAWN BY: CG CHECK BY: NDC

EXISTING EXTERIOR **ELEVATIONS**

SUED 300

KEY NOTES

LEGEND

৫৯৯

0

O

WOOD SIDING TO MATCH EXISTING SIDING IN STYLE, TEXTURE, & COLOR.

SECURITY LOCK

SECURITY CAMERA

ELECTRICAL EQUIPMENT ON WALL

FLOOD LIGHT

FIRE ALARM

PRE-FINISHED SHEET METAL COPING CAP TO MATCH EXISTING.

PRE-FINISHED SHEET METAL COLLECTION BOX & DOWNLEADER, COLOR TO COPING CAP.

PRE-FINISHED SHEET METAL FASCIA. COLOR TO MATCH COPING CAP.

 ${\Large \Large \left\langle \ensuremath{\mathbf{5}} \right\rangle}$ aluminum storefront system,

6 ACCESS LADDER.

7 RELOCATED WALL MOUNTED LIGHTING FIXTURE.

8 RELOCATED FIRE ALARM.

9 RELOCATED VENT PIPE.

GENERAL NOTES

CONTRACTOR IS TO BE FAMILIAR WITH AND FIELD VERIFY SCOPE OF WORK (SHOWN & UNSHOWN) PRIOR TO THE COMMENCEMENT OF DEMOLITION, REPORT ANY DISCREPANCIES TO ARCHITECT.

2. CONTRACTOR IS RESPONSIBLE FOR DISCONNECTING ELECTRICAL, GAS, OR ANY OTHER 'LIVE' UTILITY SERVICES PRIOR TO COMMENCEMENT OF DEMOLITION.

NOTIFY ARCHITECT OF UNFORSEEN ROT, DE-LAMINATION, OR OTHER DEFECTS IN STRUCTURAL MEMBER THAT REMAIN AFTER DEMOLITION.

4. CONTRACTOR IS RESPONSIBLE FOR WASTE REMOVAL AND MATERIAL RECYCLING, AS DIRECTED BY THE OWNER. SITE IS TO BE CLEARED OF WASTE DEBRIS DAILY.


5. PROCEDURES FOR DEMOLITION SHALL BE CONDUCTED IN A MANNER SAFE FOR PROJECT PERSONNEL AND THE PUBLIC AT-LARGE. PROTECT OR CLOSE ALL BUILDING ENTRANCES AND PUBLIC WALKWAYS ADJACENT TO PROJECT SITE COORDINATE WITH OWNER PRIOR TO IMPLEMENTING SAFETY MEASURES.


6. CONTRACTOR SHALL BE RESPONSIBLE REPAIRING DAMAGE TO OWNER'S PROPERTY AND NEIGHBORING PROPERTIES AS A RESULT OF THIS WORK, INCLUDING CITY UTILITIES / INFRASTRUCTURE.

COORDINATE AND COMPLY WITH OWNER AND AHJ RESTRICTIONS INVOLVING PERMITS, WORKING HOURS, NOISE, ODORS, MATERIAL STAGING, AND PARKING.

EXISTING BUILDING MAY CONTAIN HAZARDOUS
MATERIALS. IF DISCOVERED, COORDINATE SCOPE OF
REMOVAL WITH OWNER AND FOLLOWALL CITY. STATE,
AND FEDERAL REGULATIONS.

KEY MAP

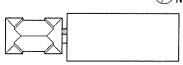

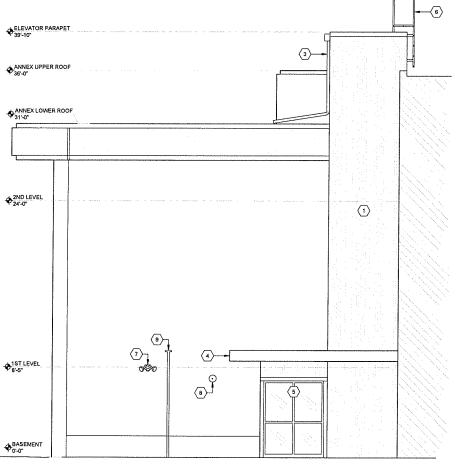

NEW ADA RAMP & RAILING OMITTED FOR CLARITY

NEW ELEVATOR - SOUTH ELEVATION

SCALE: 1/4" = 1/0"

NEW ELEVATOR - WEST ELEVATION

A310 SCALE 1/4" = 11-0"

ELEVATOR PARAPET

ANNEX UPPER ROOF

ANNEX LOWER ROOF

♦2ND LEVEL 24'-0"

♦1ST LEVEL

BASEMENT

1

NEW ADA RAMP & RAILING OMITTED FOR CLARITY

PROJECT #: 23-009 DATE: 13-OCT-2023 DRAWN BY: CG CHECK BY: NDC

NEW **EXTERIOR ELEVATIONS**



NOT FOR CONSTRUCTION

- 4" CONCRETE SLAB

1:12 SLOPE

1:12 SLOPE

ENLARGED RAMP PLAN
SCALE: 1/4" = 1'40"

PAVING ASSEMBLY
SCALE: 3/4* = 1*0*

3 A120

COLUMBIA COUNTY
DESIGN-BUILD IMPROVEMENTS
COLUMBIA COUNTY COURTHOUSE

PROJECT#: 23-009 DATE: 13-0CT-2023 DRAWN BY: CG CHECK BY: NDC

Α


RAMP PLAN, SECTION & NO PLAN, SE


SZ RED FOR 12

KEY MAP

~ (N) 1 ¼* STD STEEL PIPE HANDRAIL COURTHOUSE 1'-0" (N) CONTINUOUS -CONCRETE CURB BETWEEN RAMPS T.O. FLOOR 0'-0" ♦ T.O. FLOOR 4'-6" SITE RAMP

SCALE: 1/2" = 1'0"

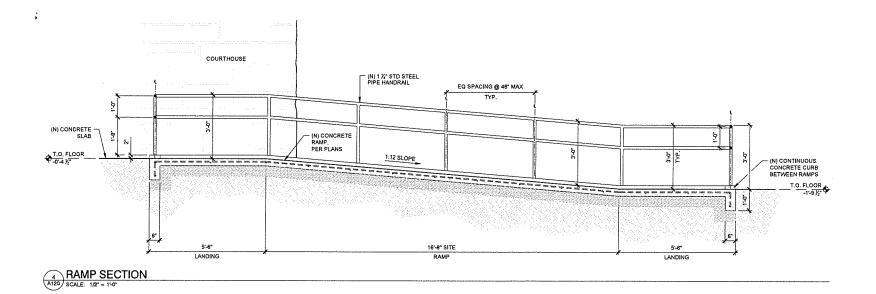

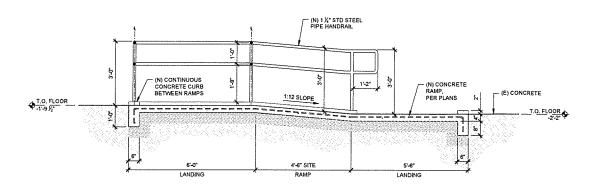

RAMP SECTION

SCALE: 1/2" = 1'-0"



OF OREG

SOLARC

COLUMBIA COUNTY
DESIGN-BUILD IMPROVEMENTS
COLUMBIA COUNTY COURTHOUSE

PROJECT #: 23-009


REFUSE /

CHECK BY: NDC

DATE: 13-OCT-2023 DRAWN BY: CG


∴⊑CYCLING I— ENCLOSURE ↓ III III SUEDI



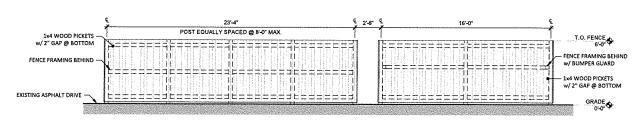


EXTERIOR ELEVATION

A140 SCALE: 1/4' = 1'-0'

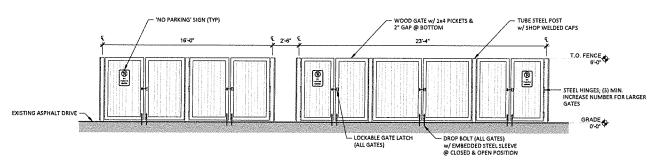

SCALE: 1/4" = 1'0"

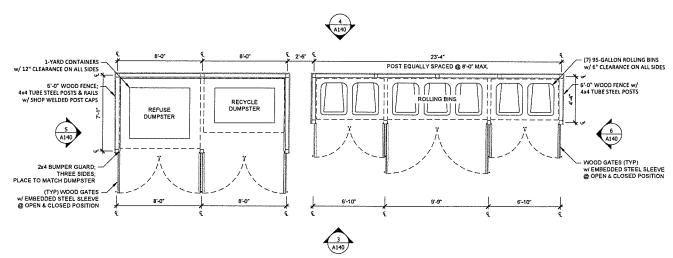

ENLARGED PLAN
SCALE: 1/4" = 1".0"

2x4 P.T. BUMPER GUARD (WHERE REQUIRED) FASTEN w/ SELF-TAPPING STAINLESS STEEL SCREWS @ 12" O.C. 4x4 TUBE STEEL RAIL; GALVANIZED; CENTERED ON POST, UNLESS FOR BUMPER GUARD THEN PLACE TO PREVENT DUMPSTER FROM HITTING FRAME 4x4 TUBE STEEL RAIL; GALVANIZED EXISTING ASPHALT; COLD PATCH AS NEEDED

1x4 WOOD PICKET -- 124 WOOD PICKET;
PAINT, STAIN, OR SEAL
FOR WEATHER PROTECTION;
FASTEN w/ SELF-TAPPING
STAINLESS STEEL SCREWS
(2) PER PICKET

STRAND STREET

4x4 TUBE STEEL RAIL; --GALVANIZED

4x4 TUBE STEEL POST; GALVANIZED

7 TYPICAL POST SECTION

