


PLAN

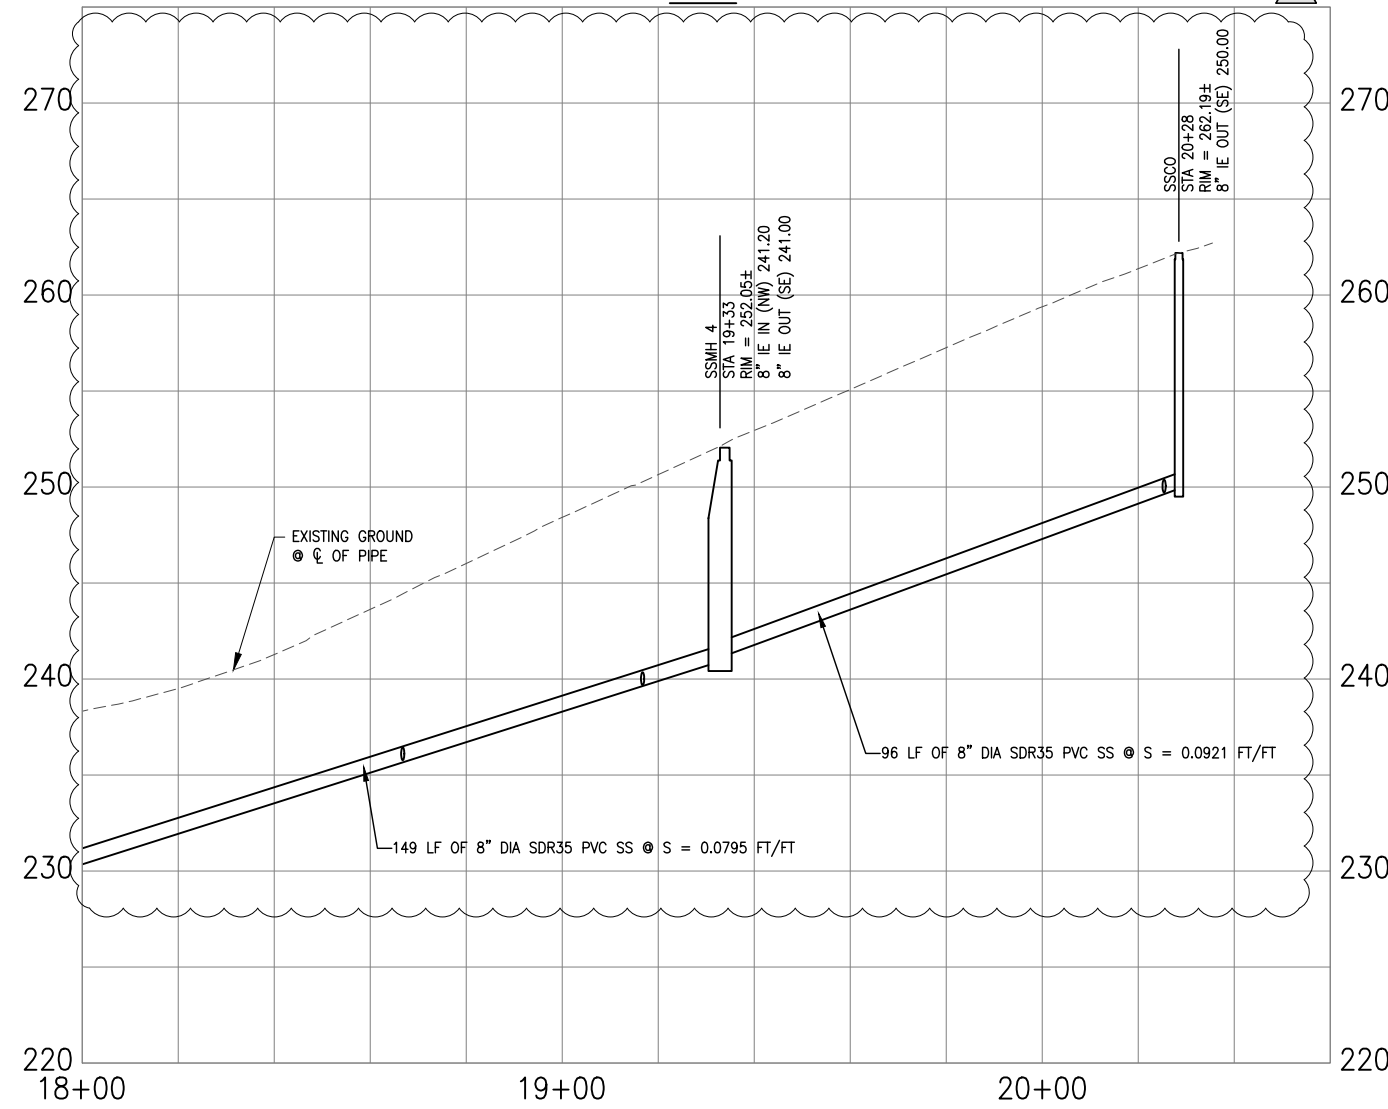

PROFILE

SCALE: 1" = 20' HORIZ
1" = 5' VERT

EROSION CONTROL LEGEND

IP INLET PROTECTION PER DETAIL, SHEET C3

GENERAL NOTES:



1. CONSTRUCT TRENCH PER DETAIL, SHEET D3.
2. POT HOLE EXISTING UTILITY CROSSINGS PRIOR TO CONSTRUCTION OF PROPOSED SEWER MAIN AND LATERALS. REPORT UTILITY HORIZONTAL AND VERTICAL DATA TO ENGINEER A MINIMUM OF 5 DAYS IN ADVANCE OF SEWER CONSTRUCTION AT THAT LOCATION.
3. RESTORE SURFACES DISTURBED BY EXCAVATION WORK PER DETAIL SHEET D3. ANTICIPATED TRENCHING LIMITS ARE AS HATCHED. CONTRACTOR SHALL RESTORE ALL SURFACES, STRUCTURES, OR LANDSCAPING OUTSIDE OF THESE LIMITS AT NO ADDITIONAL COST TO THE CITY.
4. DESIGN FOR SEWER MAIN FROM APPROXIMATELY STATION 19+00 TO END BASED ON GIS AND FIELD SURVEY. CONTRACTOR SHALL CONFIRM NO UTILITY CONFLICTS DURING CONSTRUCTION.

SANITARY SEWER KEY NOTES

1. INSTALL NEW 48" DIAMETER CONCRETE SANITARY SEWER MANHOLE PER DETAIL, SHEET D1.
2. INSTALL PVC SANITARY SEWER MAIN OF LENGTH AND DIAMETER NOTED.
3. CONSTRUCT NEW 6" DIAMETER PVC SANITARY LATERAL AND CLEANOUT PER DETAILS, SHEET D2. SEE TABLE BELOW FOR LATERAL DATA. STAMP "S" ON THE CURB AT THE LOCATION OF THE SERVICE LATERAL.
5. INSTALL MAINLINE SEWER CLEANOUT PER DETAIL, SHEET D2.
6. PROTECT EXISTING MONUMENT.
8. RESET AND RECORD EXISTING MONUMENT.

SEWER LATERAL TABLE

#	STATION	SIDE	LENGTH	ADDRESS SERVED
5	18+67	NEAR	11'	361
6	19+17	FAR	27'	370
7	20+25	NEAR	11'	371

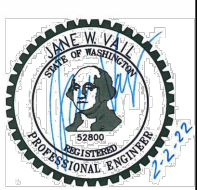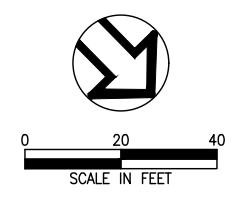

DATE	2/2/22
BY	JV
REVISION	ADDENDUM NO. 1
NO.	CHANGE ORDER NO. 1
DESIGNED BY	JW
DRAWN BY	AP/CK/AH
REVISION	DB
SCALE	ONE INCH AT FULL SCALE. IF NOT ONE INCH ADJUST SCALE ACCORDINGLY.

SEWER PLAN & PROFILE STA 18+00 TO END

wallis engineering
Vancouver, WA 98601
360.695.7041

PROJECT NO: 1477A
DATE: 01/2022

CITY OF STEVENSON
MAIN D EXTENSION

DRAWING NO:
C6
6 OF 9

P:\1477A WWP and Collection Sys Imp\500 DWG\501 Plan Sheets\502.6 Main D Extension\Y PLAN & PROFILE.dwg, 4/11/2022 4:15:44 PM, Aurora Hendrix