

APPROVAL SIGNATURE BLOCK

The following parties have reviewed these documents:

Site Aquisition Specialist:	Approved:	Date:	
APPROVED By Roshaughnessy at 9:51 am, Dec 16, 2020	Rejected:		
RF Engineer:		Date:	
APPROVED	Approved:	Date.	
By Shawn Kohout at 10:27 am, Dec 21, 2020	Rejected:		
Construction Manager:	Approved:	Date:	
APPROVED By Trevor Duevel at 3:54 pm, Dec 18, 2020	Rejected:		
Operations:	Approved:	Date:	
APPROVED By Shaun Burgess at 1:19 pm, Dec 18, 2020	Rejected:		
Project Manager:	Approved:	Date:	
APPROVED By Jeannette Davis at 10:44 am, Dec 21, 2020	Rejected:		

DRAWINGS ARE NO LONGER TO BE "APPROVED WITH COMMENTS" - IF YOU HAVE ANY REDLINES TO THESE DRAWINGS THEN YOU MUST SELECT REJECTED



SITE NAME: SPRMN-MS14XC851

SITE NUMBER: A100091A

SITE ADDRESS: 8249 ARTHUR ST NE

SPRING LAKE PARK, MN 55432

SITE TYPE: WATER TOWER

T - Mobile

8000 WEST 78TH STE 400 EDINA, MN 55439



1100 E. WOODFIELD ROAD, SUITE 500 SCHAUMBURG, ILLINOIS 60173 TEL: 847-908-8400 www.FullertonEngineering.com

	PROJECT INFORMATION	SCOPE OF WORK	APPLICABLE BUILDING CODES AND STANDARDS	1
OUTE NAME				REV DATE DESCRIPTION B
SITE NAME:	SPRMN-MS14XC851	THE SCOPE OF WORK CONSISTS OF: EXISTING EQUIPMENT TO BE REMOVED	ALL WORK AND MATERIALS SHALL BE PERFORMED AND INSTALLED IN ACCORDANCE WITH THE CURRENT EDITIONS OF THE FOLLOWING CODES AS ADOPTED BY THE LOCAL GOVERNING	A 12/01/20 90% REVIEW M
SITE NUMBER:	A100091A	(6) ANTENNAS (6) RRUS	AUTHORITIES.	0 05/25/21 FINAL RO
SITE ADDRESS:	8249 ARTHUR ST NE	(1) PPC	BUILDING CODE: 2020 MINNESOTA BUILDING CODE	
	SPRING LAKE PARK, MN 55432	(9) ANTENNA MOUNTS NEW EQUIPMENT TO BE INSTALLED	(2018 INTERNATIONAL BUILDING CODE)	
SITE TYPE:	WATER TOWER	(1) SITE SUPPORT CABINET AND (1) NEW BATTERY CABINET	ELECTRICAL CODE: 2017 NATIONAL ELECTRICAL CODE	
JURISDICTION:	CITY OF SPRING LAKE PARK	NÉW EQUIPMENT INSIDE NEW SITE SUPPORT CABINET (1) PPC		
APPLICANT:	T-MOBILE	(2) RAYCAPS, (2) BREAKOUT BOXES (6) ANTENNAS, (6) RRUS		
ADDRESS:	8000 WEST 78TH, STE 400 EDINA, MN 55439	(0) AIVIENNAS, (6) RROS (2) HYBRID TRUNK CABLES		
	EDINA, MIN 33439	(9) ANTENNA MOUNTS • CONTRACTOR SHALL FURNISH ALL MATERIAL WITH THE EXCEPTION OF T-MOBILE	FACILITY IS UNMANNED AND NOT FOR HUMAN HABITATION.	
SITE COORDINATES:	FROM RFDS	SUPPLIED MATERIAL. • ALL MATERIAL SHALL BE INSTALLED BY THE CONTRACTOR, UNLESS STATED OTHERWISE.	ADA ACCESS REQUIREMENTS ARE NOT REQUIRED. THIS FACILITY DOES NOT REQUIRE POTABLE WATER AND WILL NOT PRODUCE ANY SEWAGE.	
LATITUDE:	45.11757*		THIS FACILITY DOES NOT REQUIRE POTABLE WATER AND WILL NOT PRODUCE ANT SEWAGE	4
<u>LONGITUDE:</u> GROUND ELEV. (A.M.S	-93.2324* <u>S.L.):</u> 913'	SITE LOCATION MAP	DRAWING INDEX	
PROPERTY OWNER:	CITY OF SPRING LAKE PARK	Lumber Company V Q Aggressive Industries R	T-1 TITLE SHEET]
ADDRESS:	1301 81ST AVENUE		N-1 GENERAL NOTES	4
CONTACT:	SPRING LAKE PARK, MN 55432	And the second s	C-1 SITE PLAN C-2 EQUIPMENT PLAN	4
PHONE: EMAIL:		The American Eagle	C-3 SITE ELEVATION	1
LWAIL.		Tall Anti-Care Anti-Care	C-4 ANTENNA LAYOUT	SITE NAME
		(Substance Church Of Substance Church Of Subst	C-4A ANTENNAS, COLOR CODING AND RFDS]
		Bouldar Chark Bouldar Chark Stone Products SITE O ac Crest	C-5 EQUIPMENT DETAILS	SPRMN-MS14XC851
		Signature Mechanical Signature Acceptance Signature Mechanical	C-5A EQUIPMENT DETAILS E-1 UTILITY PLAN AND DETAILS	- 31 KWIN-WIS 1476051
		Wister Octors Water Treatment Company Surser Dental Technologies Technologies	E-2 ELECTRICAL DETAILS	-
		Agen Mile Technologies Little Bes's child Care Center One	E-3 ONE-LINE DIAGRAM AND PANEL SCHEDULE	SITE NUMBER:
<u>NOTE:</u> DRAWING	SCALES ARE FOR 11"x17" SHEETS UNLESS OTHERWISE NOTED	All American Door Co Sation Classic Q (37)	G-1 GROUNDING DIAGRAM]
	PROJECT CONSULTANTS	Elig Hat Outdoors Q Reflection Orbail Q To See April 1997	G-2 GROUNDING DETAILS	A1O0091A
PROJECT MANAGER:	T-MOBILE	Action Healing & Air Conditioning, Inc. Action Healing & Air Conditioning, Inc. Action Healing & Air Conditioning Inc. Acti	S-1 STRUCTURAL NOTES	4
ADDRESS:	8000 WEST 78TH, STE 400	Telico Department Park Construction Q Similar 1 ME Simila	S-2 STRUCTURAL DETAILS S-3 STRUCTURAL DETAILS	SITE ADDRESS
CONTACT:	EDINA, MN 55439 TREVOR DUEVEL	BIST AVE NE BIST AVE NE BIST AVE NE BIST AVE NE	3-5 STRUCTURAL DETAILS	1
PHONE: EMAIL:	(320) 281-0162	region of distances		8249 ARTHUR ST NE SPRING LAKE PARK, MN 55432
	trevor.duevel@sprint.com	NO SCALE		1
ENGINEER: ADDRESS:	FULLERTON ENGINEERING CONSULTANTS, P.C. 1100 E. WOODFIELD ROAD, SUITE 500	DIRECTIONS		SHEET NAME
CONTACT:	SCHAUMBURG, ILLINOIS 60173 CHUCK BECK, SR. PROJECT MANAGER	SCAN QR CODE FOR LINK		1
PHONE: EMAIL:	(847) 908-8400 cbeck@fullertonengineering.com	TO SITE LOCATION MAP		TITLE SHEET
LIVIAIL,	cbeck@ruller.conerigineering.com	LI TOUR TOUR TOUR TOUR TOUR TOUR TOUR TOUR		
				SHEET NUMBER
			Know what's below.	
			Know what's Delow. Call before you dig.	T-1
1		LEDUC SHANKS.	, ,	• •

- THE CONTRACTOR SHALL BE RESPONSIBLE FOR FOLLOWING ALL LAWS, REGULATIONS, AND RULES SET FORTH BY FEDERAL, STATE, AND LOCAL AUTHORITIES WITH JURISDICTION OVER THE PROJECT. THIS RESPONSIBILITY IS IN EFFECT REGARDLESS OF WHETHER THE LAW, ORDINANCE. REGULATION. OR RULE IS MENTIONED IN THESE SPECIFICATIONS. ALL WORK SHALL BE COMPLETED AS INDICATED ON THE DRAWINGS, PROJECT SPECIFICATIONS, AND THE CONSTRUCTION CONTRACT DOCUMENTS. THE CONTRACTOR SHALL FOLLOW ALL APPLICABLE RULES AND REGULATIONS OF THE THE FEDERAL OCCUPATIONAL SAFETY AND HEALTH ACT.
- OCCUPATIONAL SAFETY AND HEALTH ADMINISTRATION (OSHA) AND STATE LAW AS DEFINED IN
- THE CONTRACTOR SHALL BE RESPONSIBLE FOR INITIATING, MAINTAINING, AND SUPERVISING ALL SAFETY PRECAUTIONS AND PROGRAMS IN CONNECTION WITH THE WORK.
- THE CONTRACTOR SHALL HAVE AND MAINTAIN A VALID CONTRACTOR'S LICENSE FOR THE LOCATION IN WHICH THE WORK IS TO BE PERFORMED. FOR JURISDICTIONS THAT LICENSE INDIVIDUAL TRADES, THE TRADESMAN OR SUBCONTRACTOR PERFORMING THOSE TRADES
- THE CONTRACTOR SHALL PROVIDE THE NECESSARY CERTIFICATIONS OF ALL WORKERS ON THE TOWER TO THE OWNER OR THE PROJECT MANAGER UPON REQUEST.
- THE CONTRACTOR SHALL BE EXPERIENCED IN THE PERFORMANCE OF WORK SIMILAR TO THAT DESCRIBED HEREIN. BY ACCEPTANCE OF THIS ASSIGNMENT, THE CONTRACTOR IS ATTESTING THAT HE DOES HAVE SUFFICIENT EXPERIENCE AND ABILITY AND THAT HE IS KNOWLEDGEABLE OF THE WORK TO BE PERFORMED.
- PRIOR TO THE SUBMISSION OF THE BID, THE CONTRACTOR SHALL VISIT THE JOB SITE, VERIFY ALL DIMENSIONS, POTENTIAL SAFETY HAZARDS, AND BECOME FAMILIAR WITH THE FIELD CONDITIONS. ANY DISCREPANCIES SHALL BE BROUGHT TO THE ATTENTION OF THE PROJECT MANAGER AND STRUCTURAL ENGINEERING.
- 9. DO NOT SCALE DRAWINGS. USE DIMENSIONS.
- THE CONTRACTOR SHALL INSTALL ALL EQUIPMENT AND MATERIALS IN ACCORDANCE WITH MANUFACTURER RECOMMENDATIONS UNLESS SPECIFICALLY OTHERWISE NOTED.
- 11. ALL MATERIALS SHALL BE NEW AND OF GOOD QUALITY, FREE FROM FAULTS AND DEFECTS AND IN CONFORMANCE WITH THE DRAWINGS. ANY AND ALL SUBSTITUTIONS SHALL BE SUBMITTED FOR REVIEW AND APPROVAL BY THE PROJECT MANAGER AND THE ENGINEER OF RECORD PRIOR TO PROCUREMENT.
- ALL MEANS AND METHODS OF CONSTRUCTION DEALING WITH TOWER CONSTRUCTION AND SAFETY, STEEL ERECTION, EXCAVATIONS, SCAFFOLDING, FORMWORK, AND WORK IN CONFINED SPACES ARE THE SOLE RESPONSIBILITY OF THE CONTRACTOR.
- 13. THE CONTRACTOR SHALL PROVIDE SUFFICIENT TEMPORARY BRACING AND/OR SHORING OF ALL STRUCTURAL AND NON-STRUCTURAL ELEMENTS DURING CONSTRUCTION UNTIL ALL STRUCTURAL ELEMENTS HAVE BEEN PROPERLY INSTALLED.
- THE CONTRACTOR SHALL COORDINATE WITH THE PROJECT MANAGER IF ANY WIRELESS CARRIER DOWNTIME WILL BE REQUIRED FOR THE PROJECT. DO NOT PERFORM ANY WORK ON THE TOWER UNTIL ALL NECESSARY DOWNTIME HAS BEEN APPROVED.
- WORK IS TO BE CONTAINED TO THE SITE COMPOUND AREA ONLY. ANY OUTSIDE OR ADJACENT PROPERTY NEEDED FOR ACCESS OR TO COMPLETE THE WORK SHALL BE COORDINATED WITH THE PROJECT MANAGER PRIOR TO CONSTRUCTION.
- 16. THE CONTRACTOR SHALL COORDINATE SITE ACCESS AND SECURITY WITH THE PROPERTY OWNER AND THE PROJECT MANAGER PRIOR TO CONSTRUCTION.
- THE CONTRACTOR SHALL MAKE NECESSARY PROVISIONS TO PROTECT EXISTING SITE CONDITIONS AND UPON COMPLETION OF WORK REPAIR BACK TO ORIGINAL CONDITIONS ANY DAMAGE THAT OCCURRED DURING CONSTRUCTION.
- 18. THE CONTRACTOR SHALL KEEP THE CONSTRUCTION SITE CLEAN, HAZARD FREE, AND DISPOSE OF ALL DIRT, DEBRIS, RUBBISH AND REMOVE EQUIPMENT NOT SPECIFIED AS REMAINING ON THE PROPERTY. LEAVE PREMISES IN CLEAN CONDITION, SUBJECT TO APPROVAL BY THE PROPERTY OWNER AND THE PROJECT MANAGER.
- THE CONTRACTOR SHALL PROVIDE ON-SITE TRASH RECEPTACLES FOR COLLECTION OF 19. NON-TOXIC DEBRIS. ALL TRASH SHALL BE COLLECTED ON A DAILY BASIS.
- 20. ALL TOXIC AND ENVIRONMENTALLY HAZARDOUS SUBSTANCES SHALL BE USED AND DISPOSED OF IN ACCORDANCE WITH MANUFACTURER'S SPECIFICATIONS. UNDER NO CIRCUMSTANCES SHALL RINSING OR DUMPING OF THESE SUBSTANCES OCCUR ON-SITE.
- 21. UNLESS NOTED OTHERWISE, THE CONTRACTOR SHALL BE RESPONSIBLE FOR OBTAINING AND PAYING FOR ALL PERMITS NECESSARY FOR CONSTRUCTION.
- 22. INCORRECTLY FABRICATED, DAMAGED, OR OTHERWISE MISFITTING OR NONCONFORMING MATERIALS SHALL BE REPORTED TO THE PROJECT MANAGER AND ENGINEER, AND SHALL REQUIRE APPROVAL PRIOR TO PERFORMING ANY REMEDIAL OR CORRECTIVE ACTION.
- THE PROJECT MANAGER MAY RETAIN THE SERVICES OF A TESTING LABORATORY TO PERFORM QUALITY ASSURANCE TESTING ON VARIOUS PORTIONS OF THE CONTRACTOR'S WORK. WHEN REQUESTED, THE CONTRACTOR SHALL INFORM THE TESTING LABORATORY AND ASSIST THEM IN COMPLETING THE TESTS

NOT USED

24. THE CONTRACTOR SHALL MAINTAIN AND SUPPLY THE PROJECT MANAGER WITH AS-BUILT PLANS UPON COMPLETION OF THE PROJECT.


GENERAL NOTES

		ABBREVIATIONS	SYME	BOLS	
	AFF AFG AGL	ABOVE FINISHED FLOOR ABOVE FINISHED GRADE ABOVE GROUND LEVEL	#	REVISION	T - Mobile
	AMSL APPROX ATS AWG	ABOVE MEAN SEA LEVEL APPROXIMATE AUTOMATIC TRANSFER SWITCH AMERICAN WIRE GAUGE	⊕	WORK POINT UTILITY POLE	2 2/20/210
	BLDG BBU & CLR	BUILDING BASE BAND UNIT CENTERLINE CLEAR		BRICK	8000 WEST 78TH STE 400 EDINA, MN 55439
	COL CONC CND	COLUMN CONCRETE CONDUIT CENTRALIZED RAN		COMPRESSED STONE CONCRETE	
	CRAN C-RAN DWG FT	CLOUD RAN DRAWING FOOT(FEET)		EARTH GRAVEL	
	EGB ELEC EMT	EQUIPMENT GROUND BAR ELECTRICAL ELECTRICAL METALLIC TUBING		MASONRY STEEL	FULLERTON ENGINEERING DESIGN
	ELEV EQUIP (E) EXT	ELEVATION EQUIPMENT EXISTING EXTERIOR		CENTERLINE PROPERTY LINE LEASE LINE	I 100 E. WOODFIELD ROAD, SUITE 500 SCHAUMBURG, ILLINOIS 60173 TEL: 847-908-8400 www.FullertonEngineering.com
	FND F GA GALV	FOUNDATION FIBER GAUGE GALVANIZED		EASEMENT LINE FENCE CHAINLINK	www.i uner toricingneer ing com
	GPS GND GSM	GLOBAL POSITIONING SYSTEM GROUND GLOBAL SYSTEM FOR MOBILE		WOOD WROUGHT IRON ELECTRIC	REV DATE DESCRIPTION BY A 12/01/20 90% REVIEW MK
	LTE MAX MFR	COMMUNICATION LONG TERM EVOLUTION MAXIMUM MANUFACTURER		OVERHEAD UNDERGROUND FIBER	0 05/25/21 FINAL RO
	MGB MIN MIMO N.T.S.	MASTER GROUND BAR MINIMUM MULTIPLE IN MULTIPLE OUT NOT TO SCALE	UF UF UF UF UF UF UT	OVERHEAD UNDERGROUND TELEPHONE	
	O.C. PPC PL	ON CENTER POWER PROTECTION CABINET PROPERTY LINE	UTUT	OVERHEAD UNDERGROUND DCPOWER	
	RAN RBS RRH RGS	RADIO ACCESS NETWORK RADIO BASED STATION REMOTE RADIO HEAD RIGID GALVANIZED STEEL	LAA LA	SECTION REFERENCE	
	IN INT LB(S), #	INCH(ES) INTERIOR POUND(S) SOUARE FOOT			
	SF STL TYP UNO	STEEL TYPICAL UNLESS NOTED OTHERWISE			
	UMTS VIF W/	UNIVERSAL MOBILE TELE—COMMUNICATION SYSTEM VERIFY IN FIELD WITH			
	XFMR	TRANSFORMER			SITE NAME
					SPRMN-MS14XC851
					SITE NUMBER:
					A1O0091A
					SITE ADDRESS
					8249 ARTHUR ST NE SPRING LAKE PARK, MN 55432
					SHEET NAME
					GENERAL NOTES
					SHEET NUMBER
T	+		<u> </u>	1_	N-1

3

PROJECT# 2020.0215.0014

2 LEGEND

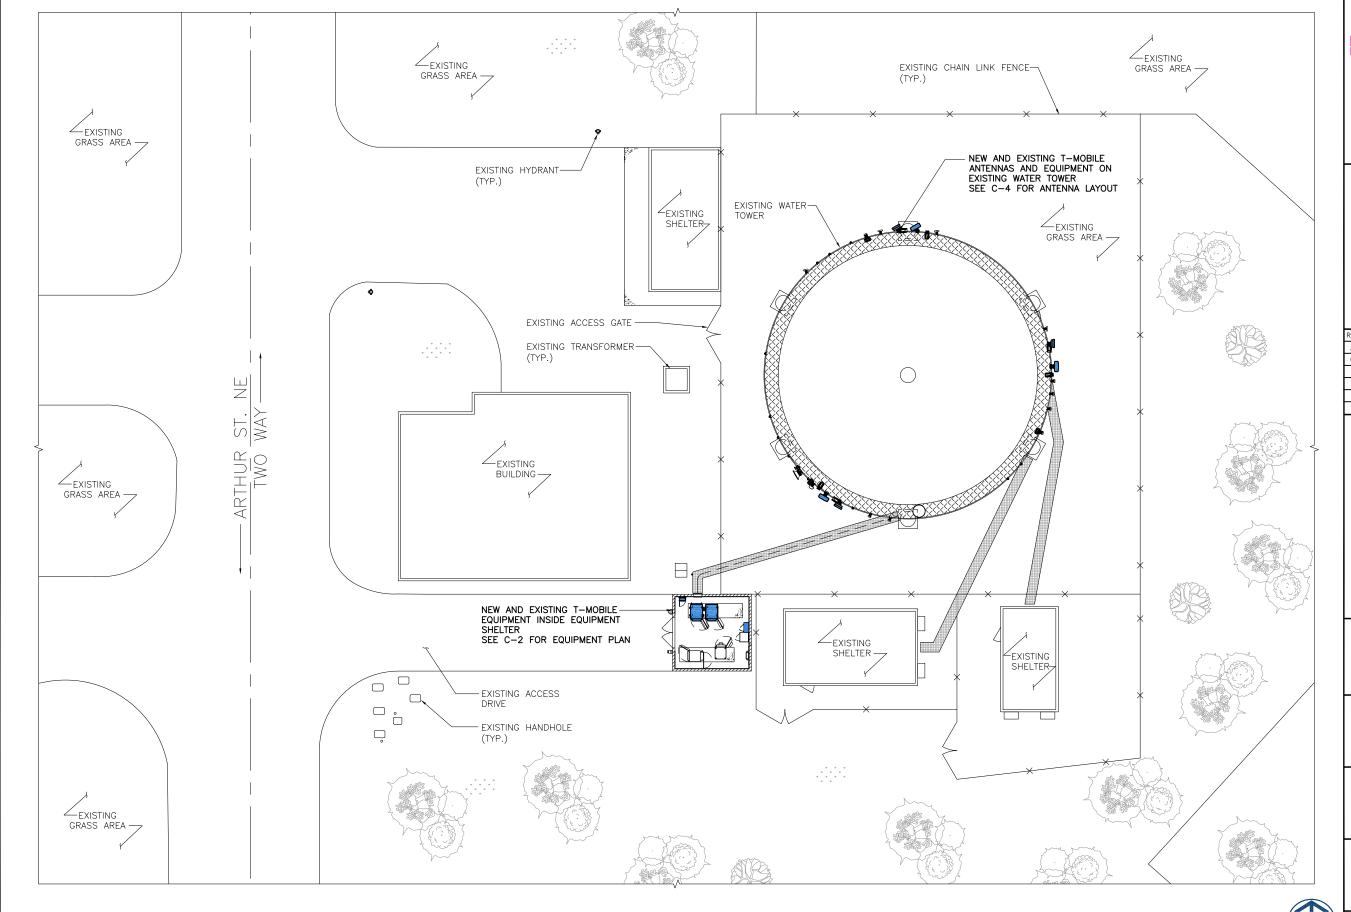

SITE PLAN



8000 WEST 78TH STE 400 EDINA, MN 55439

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REV	DATE	DESCRIPTION	BY
Α	12/01/20	90% REVIEW	MK
0	05/25/21	FINAL	RO
		·	

I hereby certify that this plan, specification, or report was prepared by me or under my direct supervision and that I am a duly Licensed Professional Engineer under the laws of the State of Minnesota

Daniel W Smith

License # 52398

SITE NAME

SPRMN-MS14XC851

SITE NUMBER:

A100091A

SITE ADDRESS

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SHEET NAME

SITE PLAN

SHEET NUMBER

NOTE:

CONTRACTOR SHALL REMOVE ALL UNUSED CABLES



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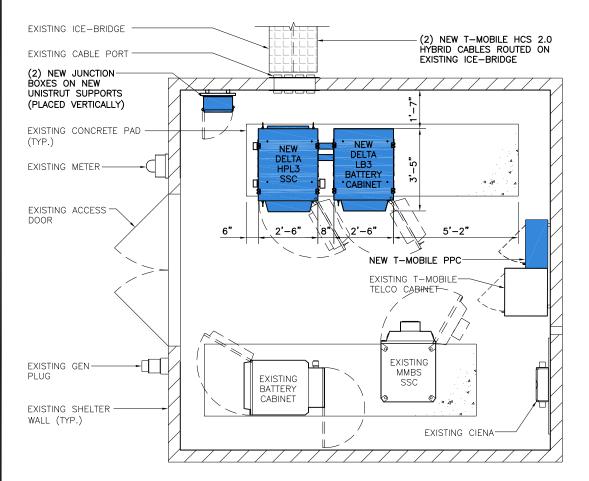
SITE ADDRESS

8249 ARTHUR ST NE SPRING LAKE PARK, MN 55432

SHEET NAME

EQUIPMENT PLAN

SHEET NUMBER





FINAL EQUIPMENT LAYOUT

SCALE: 1/4" = 1'-0"

SCALE: 1/4" = 1'-0"

EXISTING ICE-BRIDGE

EXISTING CABLE PORT

EXISTING CONCRETE PAD

EXISTING T-MOBILE PPC TO BE REMOVED

EXISTING T-MOBILE-TELCO CABINET

EXISTING MMBS -SITE SUPPORT CABINET

15'-5"

EXISTING T-MOBILE EQUIPMENT SHELTER

EXISTING CIENA-

EXISTING SHELTER

EXISTING METER-

EXISTING ACCESS

EXISTING GEN-

EXISTING T-MOBILE

EXISTING EQUIPMENT LAYOUT

BATTERY CABINET

PLUG

WALL (TYP.)

(TYP.)

DOOR

NOTES:

- 1. CALCULATIONS FOR THE STRUCTURE AND ANTENNA MOUNTS WERE PREPARED BY FULLERTON AND THOSE CALCULATIONS CERTIFY THE CAPACITY OF THE STRUCTURE TO SUPPORT THE NEW EQUIPMENT
- 2. CABLES NOT SHOWN FOR CLARITY
- 3. CONTRACTOR SHALL REMOVE ALL UNUSED CABLES



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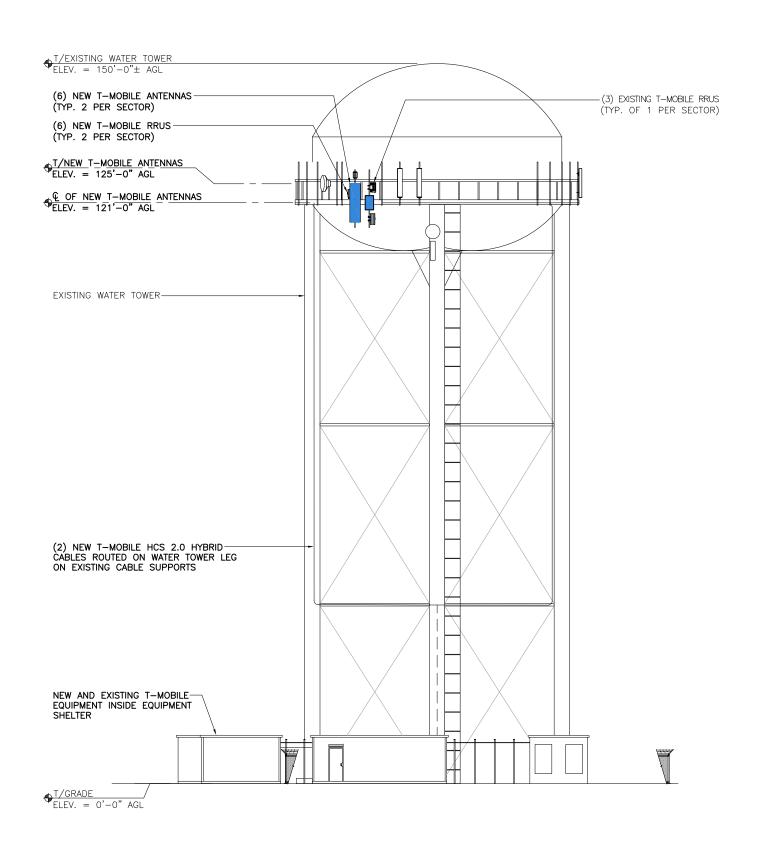
8249 ARTHUR ST NE SPRING LAKE PARK, MN 55432


SHEET NAME

SITE ELEVATION

SHEET NUMBER

C-3



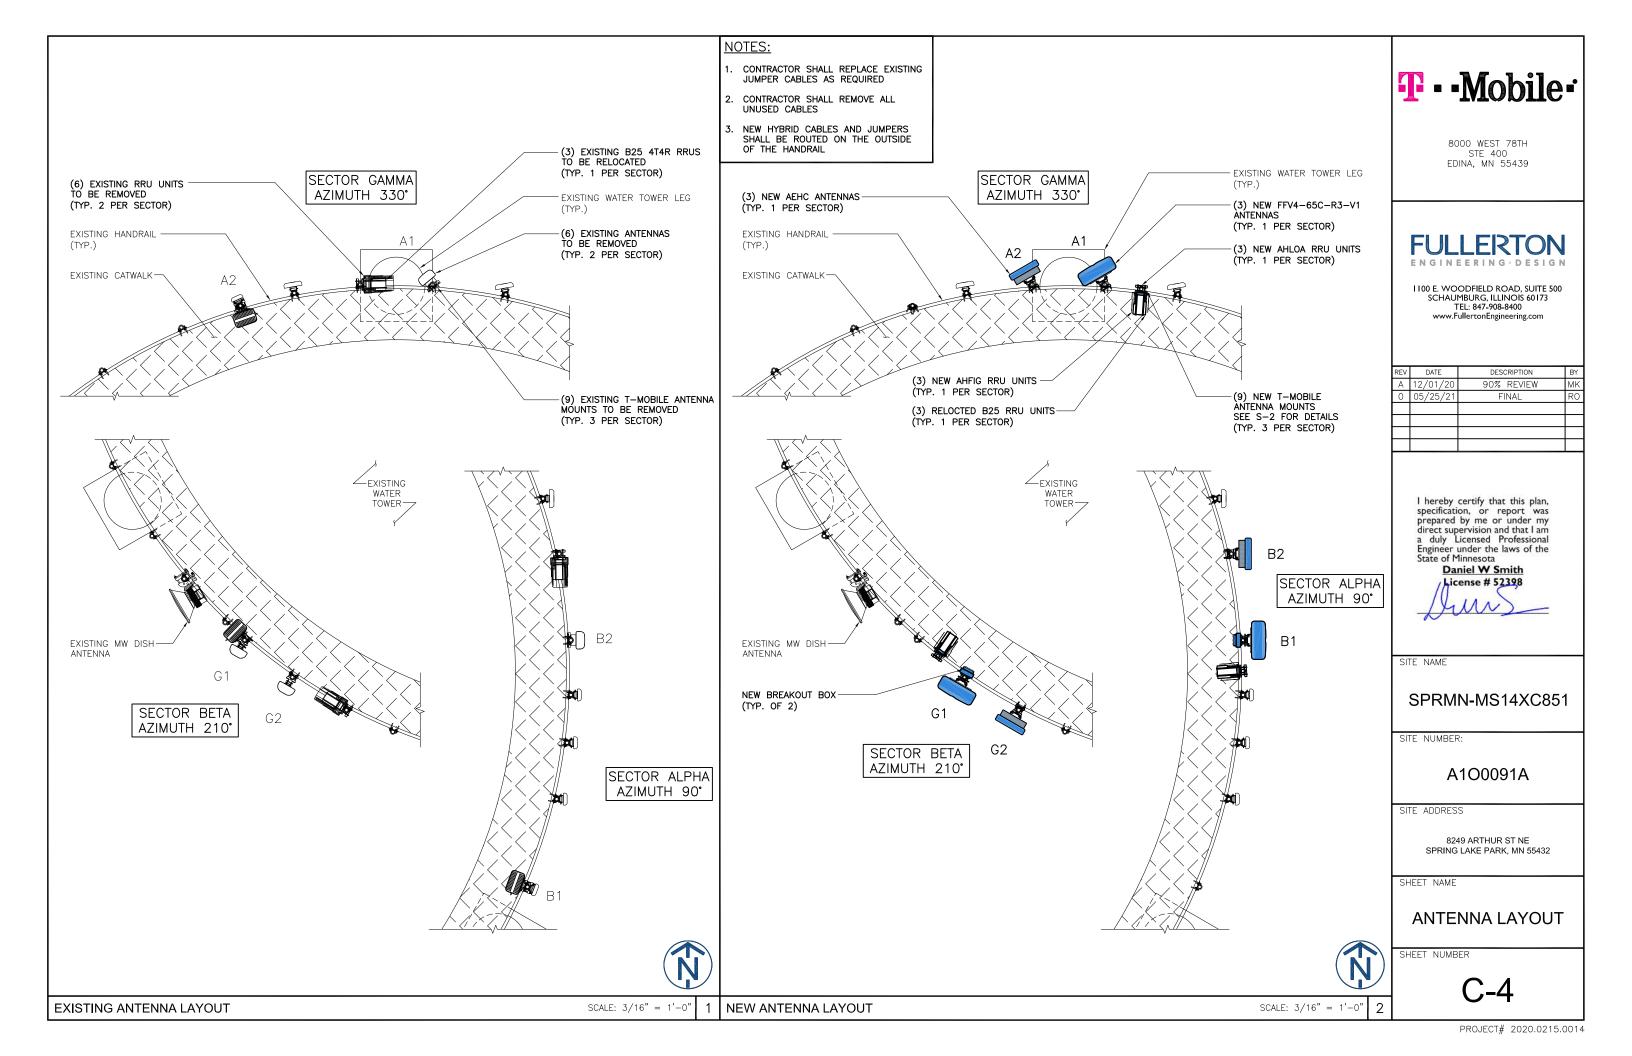

ANTENNA SCHEDULE						
SECTOR	ALPHA		BETA		GAMMA	
ANTENNA POSITION	A-1	A-2	B-1	B-2	G-1	G-2
ANTENNA TYPE	L700/L600/N600/L1900/ C1900/L2100/G1900	L2500/N2500	L700/L600/N600/L1900/ C1900/L2100/G1900	L2500/N2500	L700/L600/N600/L1900/ C1900/L2100/G1900	L2500/N2500
AZIMUTH	90.	90.	210°	210°	330°	330°
RAD CENTER (AGL)	121'	121'	121'	121'	121'	121'
MODEL	COMMSCOPE - FFV4-65C-R3-VI	NOKIA – AEHC BAND 41	COMMSCOPE - FFV4-65C-R3-VI	NOKIA – AEHC BAND 41	COMMSCOPE - FFV4-65C-R3-VI	NOKIA – AEHC BAND 41
SHARED LENGTH			200' SHARED H	HYBRID CABLE		
JUMPER LENGTH	±15'-0"	±15'-0"	±15'-0"	±15'-0"	±15'-0"	±15'-0"


ANTENNA TABLE

Coax Color Coding

- □ Antennas will be labeled (back of antenna view) Right to left 1 - X ports
- □ Coax/Jumper lines will be identified by sector color and by number of bands around the coax/jumper

Sector A	Red
Sector B	Green
Sector C	Blue
Sector D	Yellow Yellow
Sector E	White
Sector F	Purple
LMU	Brown + Sector Color Bands
	(1,2)
Fiber ID	Gray
Unused Coax	Pink
Microwave	Orange
PWE T-1's + GPS	ID w/Label Maker
Downlink cable	

Front of the Antenna

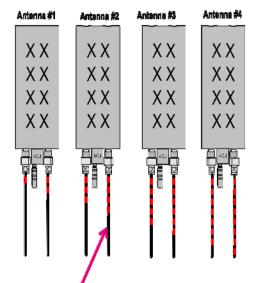


Example – Coax with four bands of RED tape will represent <u>Alpha sector</u> and <u>the 4th port of antenna</u>.

Configuration 56792EC_SR_no B26 (water tower)

* For 5G and LTE Airscale BB dimensioning refer to Fiber Port matrices.

(Alpha, Beta & Gamma)

(*Only Alpha sector is shown in the drawing)

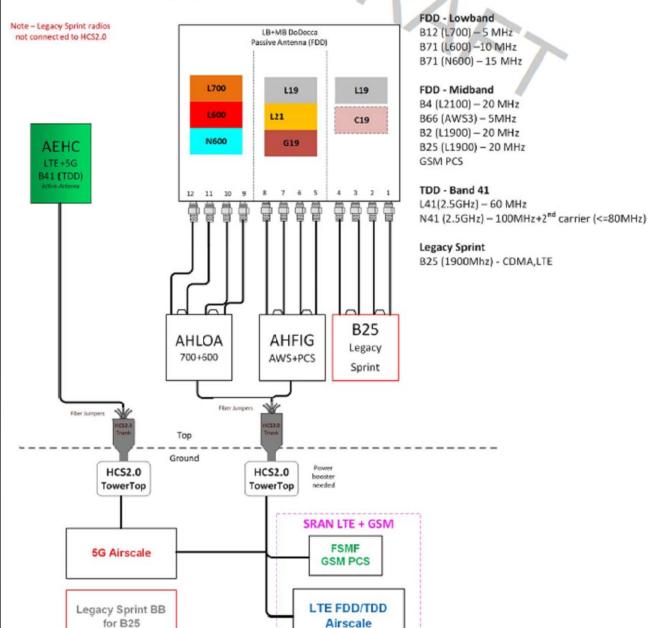

T - • Mobile •

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SHEET NAME


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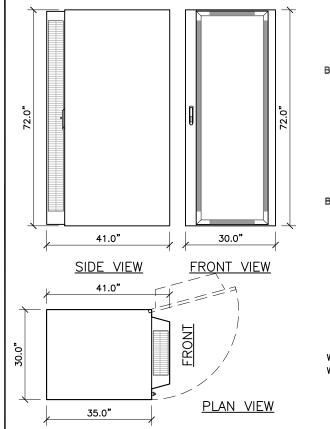
ANTENNA DETAILS, COLOR CODING AND RFDS


SHEET NUMBER

C-4A

NEW COLOR CODING 2 RFDS



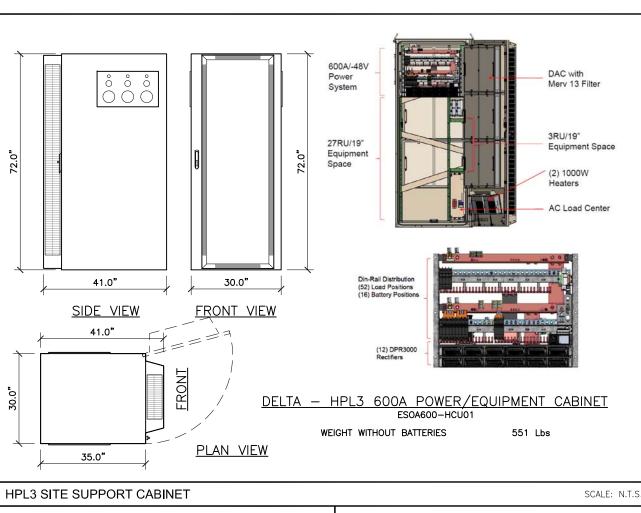

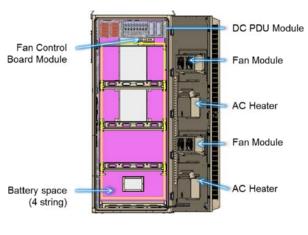

DELTA - LB3 BATTERY CABINET ESOF015-ECV04

WEIGHT WITHOUT BATTERIES WEIGHT WITH BATTERIES

14.0"

PLAN VIEW

TOTAL WEIGHT

540 Lbs 2652 Lbs

14.0"

FRONT VIEW

21.9 Lbs

SCALE: N.T.S.

6

DATE

T - - **M**obile -

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DESCRIPTION 90% REVIEW

FINAL

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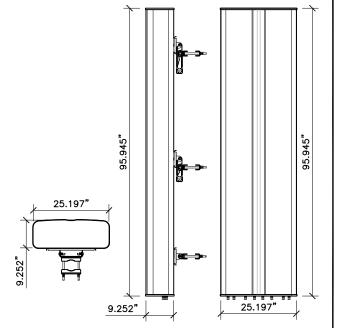
SPRING LAKE PARK, MN 55432

SHEET NAME

EQUIPMENT DETAILS


SHEET NUMBER

HPL3 BATTERY CABINET SCALE: N.T.S. 2




PLAN VIEW SIDE VIEW FRONT VIEW COMMSCOPE - FFV4-65C-R3-V1 12-PORT SECTOR ANTENNA

FREQUENCY RANGE 4 x 617-806 MHz 8 x 1695-2360 MHz 131.8 Lbs ANTENNA **BRACKET** TOTAL WEIGHT

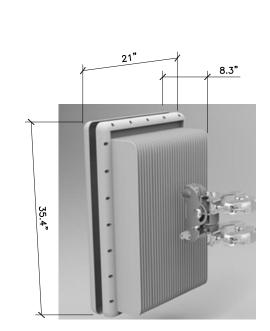

NOKIA - AEHC BAND 41 M-MIMO

WEIGHT 108 Lbs

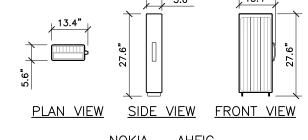


NOKIA - AHFIG

TOTAL WEIGHT 79.4 Lbs

4x30W on each band (full band IBW), total 240W

- 4TX/4RX (4x2 MIMO)
- Based on Airscale Platform
- Ground or tower-top installation
- Typical power consumption 664W
- 4.3-10+RF Connectors
- 2 x 9.8 Gbps CPRISFPs
- Approximately 25L and 73lbs
- W 12.1"x H 22" x 6.5"

NOKIA AHLOA Wideband 4T4R Band 12&71

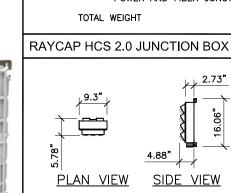



4.88" 9.3" PLAN VIEW SIDE VIEW FRONT VIEW ALLIANCE CORP HYBRID CABLE HI-CAP BREAKOUT BOX

TOTAL WEIGHT 3.59 Lbs

SIDE VIEW

RAYCAP - RTMDC-5634-PF

POWER AND FIBER JUNCTION BOX

SCALE: N.T.S.


COMMSCOPE FFV4-65C-R3-V1 DETAIL SCALE: N.T.S 3 NOKIA AEHC DETAIL


SCALE: N.T.S.

RRU DETAILS

SCALE: N.T.S


BREAKOUT BOX 5

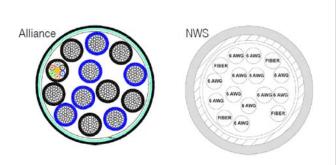

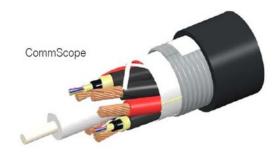

CHARACTERISTICS	ALLIANCE	COMMSCOPE	NWS
OUTER DIAM	1.46"	1.55"	1.48"
WEIGHT	1.61 LB/FT	1.71 LB/FT	1.61 LB/FT
MIN. BEND RAD	14.6"	18.6"	21.5"
DC CONDUCTORS	12x6 AWG	12x6 AWG	12x6 AWG
ARMOR	CORRUGATED CU	CORRUGATED AL	CU TAPE, PVC
CONDUCTOR TERM.	NONE	NONE	NONE
SINGLE-MODE FIBERS	48	48	48
FIBER TERMINATION	LC PAIR	LC PAIR	LC PAIR

HYBRID HCS 2.0 CABLE DETAIL

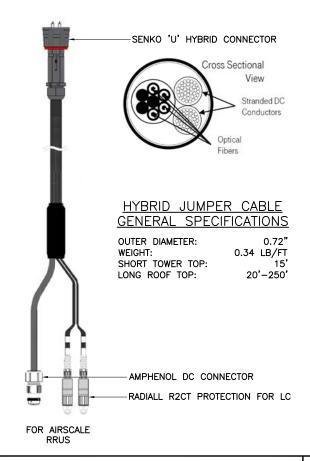



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4 SCALE: N.T.S.

1'-1 3/4"

FRONT

SAMSUNG

RRU 1900

9"

SCALE: N.T.S

DIMENSIONS (WxDxH): WEIGHT: MODEL:

-POWFR

OPTIC CABLE

□ CABLES

SIDE

PLAN

HYBRID JUMPER CABLE DETIAL

1'-1 3/4" x 9" x 1'-11 3/4" 62.83 LBS RRH-P4

SCALE: N.T.S.

SCALE: N.T.S

LOOSE TUBE (24F)

COPPER CONDUCTOR

OUTER SHEATH

WRAPING

RIP CORD

CONDUCTOR INSULATION

ALUMINUM CORRUGATION

SCALE: N.T.S

NOT USED

SCALE: N.T.S.

THIRD RING

3 NOT USED

NOTES:

HYBRID CABLE WILL BE MARKED IN A SIMILAR MANNER AS COAX CABLE DESCRIBED IN NOTES 2-9. THE MANN TRUNK OF THE HYBRID CABLE WILL NOT BE MARKED WITH THE FREQUENCY CODE AS THE HYBRID CABLE CAN CONTAIN ALL FREQUENCIES. THE MAIN TRUNK OF THE HYBRID CABLE WILL BE MARKED TO INDICATE THE SECTOR IT SERVES. THE INDIVIDUAL POWER PAIRS AND FIBER CABLE PAIRS WILL BE LABELED WITH DISTINCT COLOR BAND SECTIONS: THE CABLE ID BANDS (DETERMINED BY TERMINATINE CABLE ID BANDS (DETERMINED BY TERMINATINE RADIO). THE FREQUENCY/FADIO ID BANDS (ALSO

RADIO), THE FREQUENCY/RADIO ID BANDS (ALSO DETERMINED BY TERMINATING RADIO) AND FIBER/DC COUNT BANDS (SEE FIGURES 20-3,

FIBER/DC COUNT BANDS (SEE FIGURES 20-3, 20-4 AND 20-5). TO ACCOMMODATE THE INCREASED NUMBER OF COLOR BANDS, BAND WIDTH AND SPACING CAN BE PROPORTIONALLY REDUCED FROM THE STANDARDS DESCRIBED IN NOTE 2-9 AS SHOWN IN FIGURE 20-3. ALL CABLES SHALL BE MARKED AT THE TOP AND BOTTOM WITH COLORED TAPE, OR COLORED HEAT SHRINK TUBING COLORED TAPE (OR TOLORED TAPE (OR TOLO

STABILIZED TAPE OR HEAT SHRINK ARE.
PREFERRED.
THE FIRST COLOR BAND SHALL BE 2 IN FROM
THE WEATHERPROOFING AT THE END OF THE
CABLE, AND THERE SHALL BE 1 IN SPACES
BETWEEN EACH COLOR BAND FOR FEEDERS AND
1/2 IN SPACES FOR JUMPERS.
THE CABLE COLOR CODE SHALL BE APPLIED IN
ACCOMPANIES TO TABLE 20 5. TABLE 20 IN

THE CABLE COLOR CODE SHALL BE APPLIED IN ACCORDANCE TO TABLE 20-5. (TABLE 20-5 ONLY SHOWS 3 SECTORS, BUT ADDITIONAL SECTORS ARE EASILY SUPPORTED BY ADDING THE APPROPRIATE NUMBER OF COLORED BANDS TO THE CABLE COLOR CODE.)
AFTER THE CABLE COLOR CODE IS APPLIED, THE FREQUENCY BAND/RADIO COLOR CODE, TABLE 20-6, MUST BE APPLIED FOR THE SPECIFIC FREQUENCY BAND/RADIO IN USE ON A GIVEN LINE

FREQUENCY BAND/RADIO IN USE ON A GIVEN LINE.

7. A 2 IN GAP SHALL SEPARATE THE CABLE COLOR CODE FROM THE FREQUENCY COLOR CODE. THIS GAP SHALL BE 1 IN ON JUMPERS.

8. THE 2" COLOR BANDS FOR THE FREQUENCY/RADIO CODE SHALL BE PLACED NEXT TO EACH OTHER WITH NO SPACES. THE COLOR BANDS SHALL BE 1 IN FOR JUMPERS.

9. WRAP COLORED TAPE A MINIMUM OF 3 TIMES AROUND THE CABLE AND KEEP THE TAPE IN THE SAME AREA AS MUCH AS POSSIBILE. THIS WILL ALLOW REMOVAL OF TAPE THAT FADES OR DISCOLORS DUE TO WEATHER.

Engineer under the laws of the State of Minnesota **Daniel W Smith** License # 52398

SITE NAME

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SITE NUMBER:

A100091A

SITE ADDRESS

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SHEET NAME

EQUIPMENT DETAILS

SHEET NUMBER

SCALE: N.T.S.

SECOND SECTOR CABLE FIRST RING

RING THIRD RING
NO TAPE NO TAPE 1 ALPHA NO TAPE NO TAPE NO TAPE NO TAPE 1 WHITE NO TAPE NO TAPE NO TAPE NO TAPE GREY NO TAPE NO TAPE NO TAPE NO TAPE 2 BETA NO TAPE NO TAPE WHITE WHITE NO TAPE NO TAPE NO TAPE GREY GREY NO TAPE NO TAPE 3 GAMMA BLUE GREY GREY GREY PURPLE PURPLE

FREQUENCY	INDICATOR (1ST RING)	ID (SECOND RING)
800-1	YEL	GRN
800-1	YEL	ORG
1900-1	YEL	RED
1900-2	YEL	BRN
1900-3	YEL	BLU
1900-4	YEL	GREY
2500-1	YEL	WHT
2500-2	YEL	PPL

TABLE 20-7 HYBRID FIBER/DC

OUENCY	LC RN
(151 RING) (SECOND RING) HYBRID COL 800-1 YEL GRN 1 GF	R۱
900 1 VEI OPC 2 PI	
000-1 IEL UKG 2 BI	LU
1900-1 YEL RED 3 BF	R١
1900-2 YEL BRN 4 W	н
1900-3 YEL BLU 5 RE	ED
1900-4 YEL GREY 6 GR	₹E
2500-1 YEL WHT 7 PF	PL
2500-2 YEL PPL 8 OF	RG

INFORMATION TAKEN FROM SPRINT'S TECHNICAL
SPECIFICATIONS "ANTENNA TRANSMISSION LINE ACCEPTANCE
STANDARDS, TS-0200, ISSUE 6, SEPTEMBER 2015,
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EXISTING CABLE DETAIL

AUXILIARY HYBRID CABLE

20 x CABLE DIAMETER (DURING OPERATION) 25 x CABLE DIAMETER (DURING INSTALLATION)

CABLE BENDING RADIUS

1.2 LB PER FT CABLE WEIGHT

EXISTING RRU 1900

BREAKOUT


CYLINDER

6 EXISTING COLOR CODING

- THE CONTRACTOR SHALL PERFORM WORK IN ACCORDANCE WITH ALL GOVERNING STATE, COUNTY AND LOCAL CODES AND OSHA
- THE ENTIRE ELECTRICAL INSTALLATION SHALL BE GROUNDED AS REQUIRED BY ALL APPLICABLE CODES.
- THE CONTRACTOR SHALL PROVIDE ALL LABOR, MATERIALS, INSURANCE, EQUIPMENT, INSTALLATION, CONSTRUCTION TOOLS AND TRANSPORTATION FOR A COMPLETE AND PROPERLY OPERATIVE SYSTEM ENERGIZED THROUGHOUT AND AS INDICATED ON
- THE CONTRACTOR SHALL OBTAIN ALL PERMITS, PAY PERMIT AND INSPECTION FEES, AND BE RESPONSIBLE FOR SCHEDULING INSPECTIONS WITH THE AUTHORITY HAVING JURISDICTION.
- MATERIALS SHALL BE MANUFACTURED IN ACCORDANCE WITH APPLICABLE STANDARDS ESTABLISHED BY ANSI, IEEE, NEMA AND
- ALL MATERIALS SHALL BE U.L. LISTED.
- ALL MATERIALS AND EQUIPMENT SHALL BE NEW AND IN PERFECT CONDITION WHEN INSTALLED AND SHALL BE OF THE BEST GRADE AND OF THE SAME MANUFACTURER THROUGHOUT FOR EACH CLASS OR GROUP OF EQUIPMENT.
- MATERIALS SHALL MEET WITH APPROVAL OF THE AUTHORITY HAVING JURISDICTION.
- THE CONTRACTOR SHALL PERFORM ALL VERIFICATION OBSERVATIONS TEST, AND EXAMINATION WORK PRIOR TO THE ORDERING OF THE ELECTRICAL EQUIPMENT AND STARTING CONSTRUCTION. CONTRACTOR SHALL ISSUE A WRITTEN NOTICE OF ALL FINDINGS TO THE PROJECT MANAGER LISTING ALL MALFUNCTIONS, FAULTY EQUIPMENT AND DISCREPANCIES.
- THE CONTRACTOR SHALL COORDINATE WITH UTILITY COMPANY FOR 10. CONNECTION OF THE TEMPORARY AND PERMANENT POWER TO THE SITE. THE TEMPORARY POWER AND ALL HOOKUP COSTS TO BE PAID BY CONTRACTOR.
- UPON COMPLETION OF WORK, CONDUCT CONTINUITY, SHORT CIRCUIT, AND FALL OF POTENTIAL GROUND TESTS FOR APPROVAL. SUBMIT TEST REPORTS TO THE PROJECT MANAGER.
- 12. ALL BROCHURES, OPERATING MANUALS, CATALOGS, SHOP DRAWINGS, ETC. SHALL BE TURNED OVER TO THE PROJECT MANAGER AT JOB COMPLETION.
- 13. POST-INSTALLATION, ANY WORK, MATERIAL OR EQUIPMENT FOUND TO BE FAULTY SHALL BE CORRECTED AT ONCE, UPON WRITTEN NOTIFICATION, AT THE EXPENSE OF THE CONTRACTOR.
- PROVIDE THE PROJECT MANAGER WITH ONE SET OF COMPLETE ELECTRICAL "AS-INSTALLED" DRAWINGS AT THE COMPLETION OF THE JOB, SHOWING ACTUAL DIMENSIONS, ROUTINGS AND CIRCUITS.
- ALL ELECTRICAL EQUIPMENT SHALL BE LABELED WITH PERMANENT ENGRAVED PLASTIC LABELS NOTING USE FUNCTION.
- 16. EACH CONDUCTOR OF EVERY SYSTEM SHALL BE PERMANENTLY TAGGED IN EACH PANEL BOARD, PULL BOX, J-BOX, SWITCH BOX,
- ALL CONDUIT INSTALLED SHALL BE SURFACE MOUNTED OR DIRECT 17. BURIAL UNLESS OTHERWISE NOTED.
- 18. ALL CONDUIT SHALL HAVE A PULL WIRE OR ROPE.
- 19. ALL CONDUCTORS SHALL BE COPPER.
- ALL CIRCUIT BREAKERS, FUSES AND ELECTRICAL EQUIPMENT SHALL HAVE AN INTERRUPTING SHORT CIRCUIT CURRENT TO WHICH THEY 20. MAY BE SUBJECTED, AND A MINIMUM OF 10,000 A.I.C.
- PATCH, REPAIR AND PAINT ANY AREA THAT HAS BEEN DAMAGED IN THE COURSE OF THE ELECTRICAL WORK.
- 22. PENETRATIONS IN FIRE RATED WALLS SHALL BE FIRE STOPPED TO MATCH ORIGINAL RATING.
- 23. BX OR ROMEX CABLE IS NOT PERMITTED.

NOTES

- ALL ELECTRICAL/FIBER ENCLOSURES, JUNCTION BOXES, CONDUIT KNOCKOUTS, RACEWAYS, ETC. SHALL BE RODENT-PROOF.
- CLEAN PREMISES OF ALL DEBRIS RESULTING FROM WORK AND LEAVE WORK IN A COMPLETE AND UNDAMAGED CONDITION.

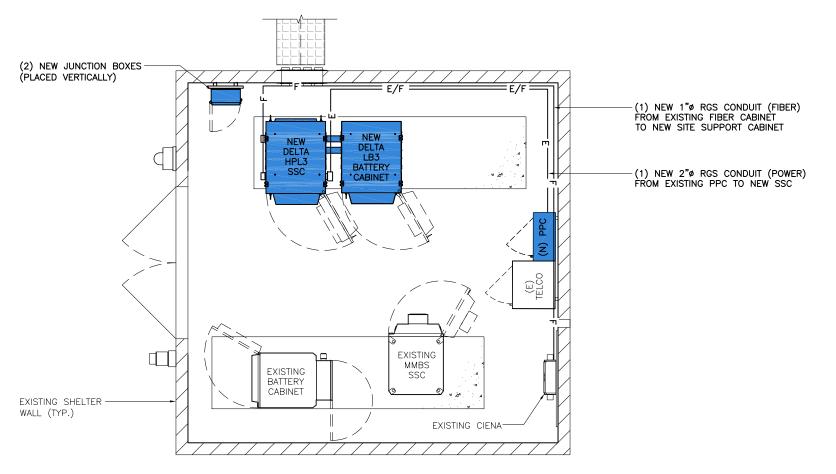




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UTILITY PLAN SCALE: 1/4" = 1'-0"

 $\frac{\text{NOTE:}}{\text{existing circuits to be reinstalled in New PPC,}}$ SEE 2/E-3 FOR NEW PANEL SCHEDULE



SPRMN-MS14XC851

SITE NUMBER:

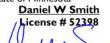SITE NAME

A100091A

SITE ADDRESS


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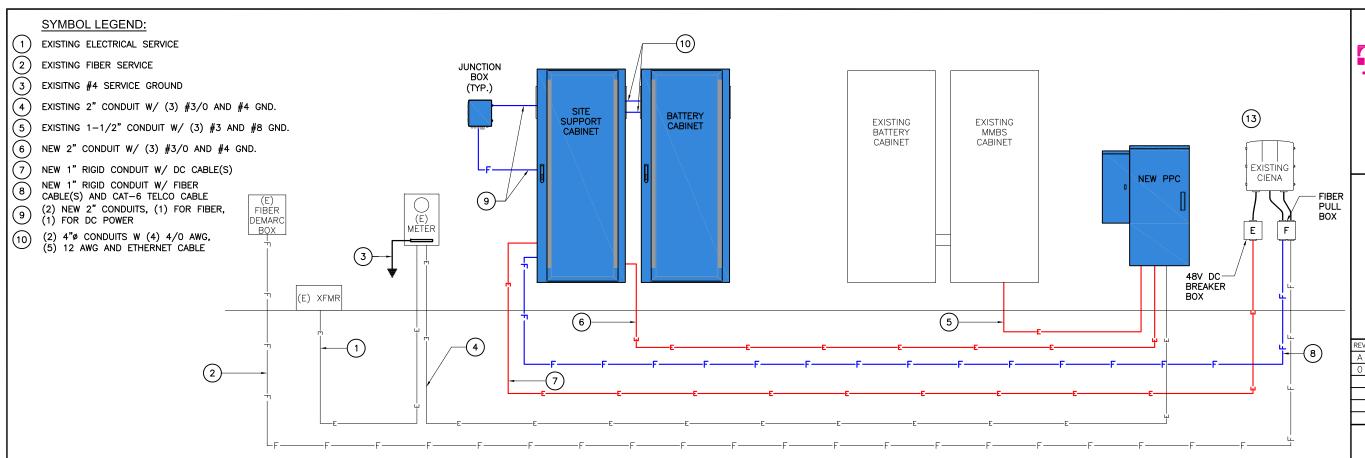
SHEET NAME

UTILITY PLAN AND DETAILS

SHEET NUMBER

5 SCALE: N.T.S. 3 NOT USED EXISTING PANEL NOT USED



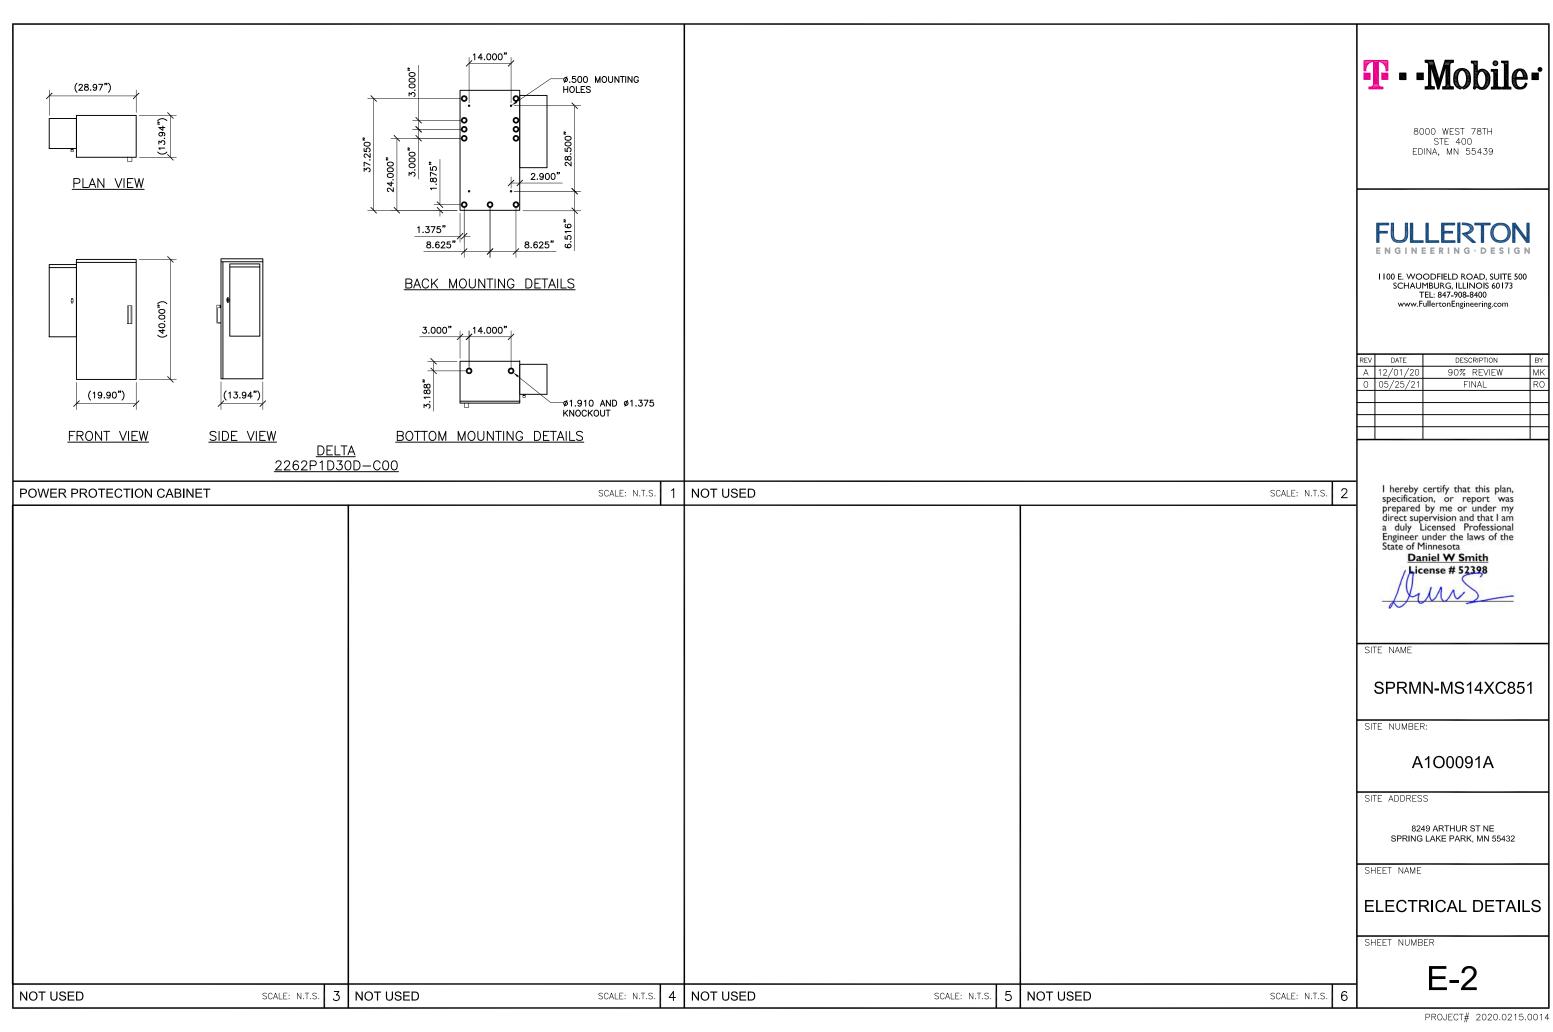

ONE LINE DIAGRAM

SCALE: N.T.S.

SITE: A100091A-MS14XC851 PANEL NAME: PPC 120/240 Vac PANEL STATUS: NEW **VOLTAGE: ENCLOSURE TYPE: NEMA 3R** PHASE: **3W** MOUNT: SURFACE WIRE: 200 AIC: 65kA **BUSS RATING:**

Total kVA 19.55
Total AMPS 81.46

	MAIN BREAKER:	200				PANEL PO	SITIONS:	24								_
скт	LOAD DESCRIPTION	BREAKER AMPS	BREAKER POLES	BREAKER STATUS	SERVICE LOAD	USAGE FACTOR	Phase A (VA) 81.5A		Phase B (VA) 81.5A	USAGE FACTOR	SERVICE LOAD	BREAKER STATUS	BREAKER POLES	BREAKER AMPS	LOAD DESCRIPTION	скт
1	MMBS DU	100	2	ON	5750	0	0		25	1	25	ON	2	60	SURGE ARESSTOR (1PH)	2
3					5750	0	25		0	1	25					4
5	HPL3	200	4	ON	4875	1	4875		0	0	200	ON	2	15	MMBS BU	6
7					4875	1	0		4875	0	200					8
9					4875	1	4875		0	0	250	ON	2	30	230 V OUTLET	10
11					4875	1	0		4875	0	250					12
13							0		0	0	500	ON	1	20	110 V OUTLETS	14
15							0		0							16
17							0		0							18
19							0		0							20
21				,			0		0			OFF	2	100	FUTURE	22
23							0		0							24

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Daniel W Smith

SITE NAME

SPRMN-MS14XC851

SITE NUMBER:

A100091A

SITE ADDRESS

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SHEET NAME

ONE-LINE DIAGRAM AND PANEL SCHEDULE

SHEET NUMBER

Ξ-3

PANEL SCHEDULE

GROUNDING NOTES:

- INSTALL 2 GROUND BARS AT THE BOTTOM OF THE TOWER (EVEN WITH SHORT ICE BRIDGE RUNS). ONE GROUND BAR AT THE TOWER, AND ON AT THE PLATFORM.
- 2. T-MOBILE IS ELIMINATING THE HOME RUN GROUND WIRE FROM THE TOP BUSS BAR TO THE BOTTOM BUSS BAR ON TOWER SITES. ROOFTOPS ARE STILL REQUIRED TO HAVE SECTORS GROUND AND #2 INSULATED GROUND WIRE. FROM SECTOR GROUNDS TO MAIN BUSS BARS AND BUILDING STEEL.
- 3. REMOVE INSULATORS (CHERRIES) FROM THE BUSS BARS AND GROUND TO TOWER, TOP AND BOTTOM ON TOWER SITES ONLY.
- 4. ALL EXPOSED GROUNDS TO BE DRESSED WITH SEAL
- 5. ALL ICE BRIDGE POST ARE TO BE GROUNDED WITH #2 SOLID AND DRESSED IN SEAL TIGHT.
- 6. (2) OF THE (4) PLATFORM POST NEED TO BE GROUNDED DIAGONALLY.
- BOTTOM BUSS BAR TO HAVE TWO #2 GROUND LEADS DRESSED IN WITH SEAL TIGHT.

GROUNDING LEGEND

EXOTHERMIC CONNECTION

MECHANICAL CONNECTION

INTERNAL EQUIPMENT GROUND BAR

EXTERNAL GROUND BAR


#2 AWG STRANDED INSULATED COPPER GROUND WIRE

#6 AWG STRANDED INSULATED COPPER GROUND WIRE

#2 SOLID TINNED, BARE COPPER GROUND WIRE 3 4 1/2" FLEXIBLE SEALTIGHT CONDUIT

W/SILICON SEALANT AT EACH END

TYPICAL ANTENNA SECTOR

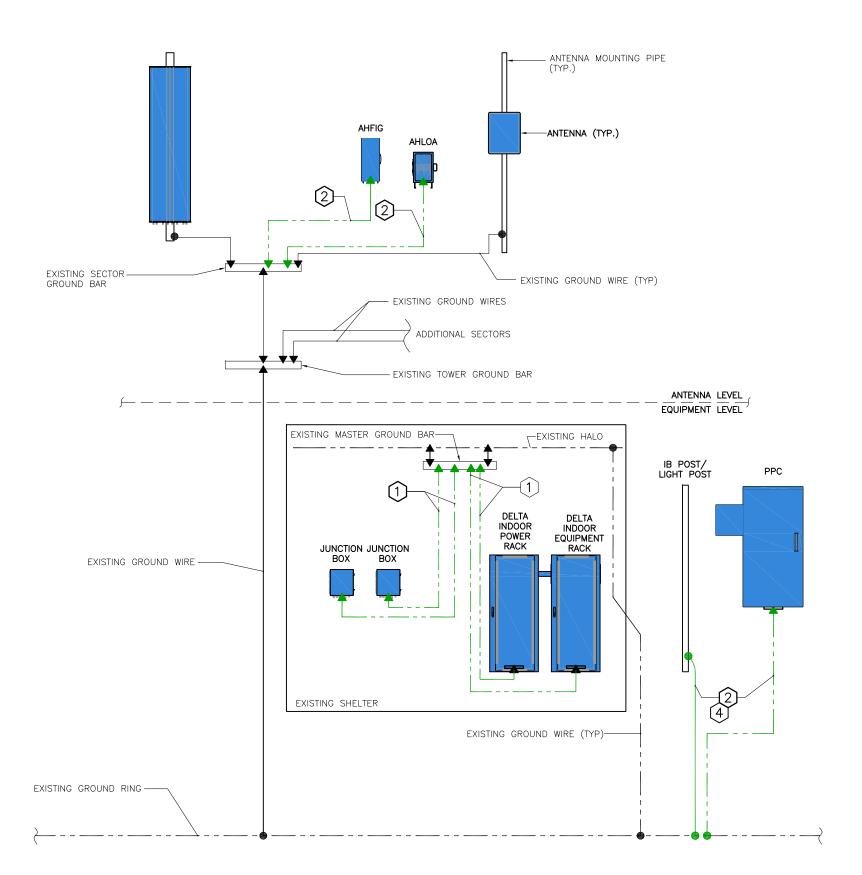



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Daniel W Smith License # 52398

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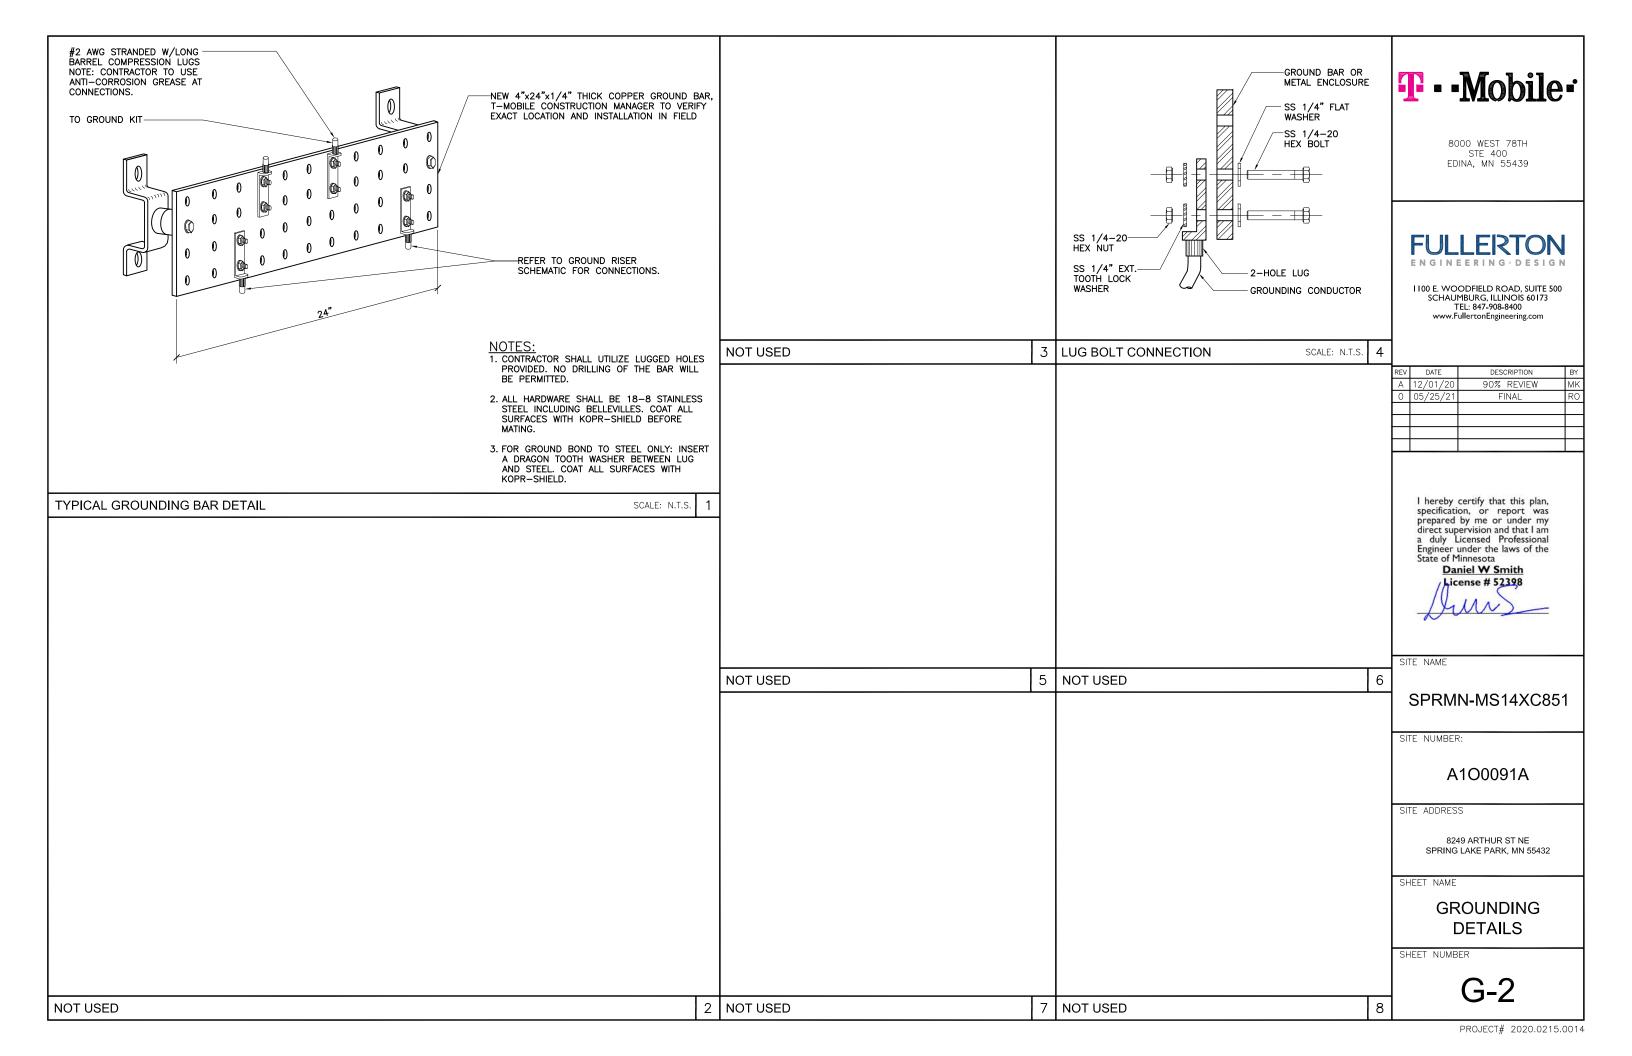
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SHEET NAME

GROUNDING DIAGRAM

SHEET NUMBER



STRUCTURAL NOTES:

APPLICABLE CODES:

1. DESIGN & CONSTRUCTION OF ALL WORK SHALL CONFORM TO

THE FOLLOWING CODES: 2020 MINNESOTA BUILDING CODE TIA-222-H

DESIGN LOADS:

WIND LOAD:

116 MPH BASIC DESIGN WIND SPEED PER TIA-222-H

SEISMIC LOAD:

SS = 0.048 SDS = 0.05 S1 = 0.028 SD1 = 0.015

SOIL SITE CLASS (ASSUMED) D SEISMIC DESIGN CATEGORY A

GENERAL NOTES:

- 1. THE CONTRACTOR SHALL BE RESPONSIBLE FOR FOLLOWING ALL LAWS, REGULATIONS, AND RULES SET FORTH BY FEDERAL, STATE, AND LOCAL AUTHORITIES WITH JURISDICTION OVER THE PROJECT. THIS RESPONSIBILITY IS IN EFFECT REGARDLESS OF WHETHER THE LAW, ORDINANCE, REGULATION OR RULE IS MENTIONED IN THESE SPECIFICATIONS.
- 2. ALL WORK SHALL BE COMPLETED AS INDICATED ON THE DRAWINGS, PROJECT SPECIFICATIONS, AND THE CONSTRUCTION CONTRACT DOCUMENTS.
- 3. THE CONTRACTOR SHALL HAVE AND MAINTAIN A VALID CONTRACTOR'S LICENSE FOR THE LOCATION IN WHICH THE WORK IS TO BE PERFORMED. FOR JURISDICTIONS THAT LICENSE INDIVIDUAL TRADES, THE TRADESMAN OR SUBCONTRACTOR PERFORMING THOSE TRADES SHALL BE LICENSED.
- 4. FOLLOW ALL APPLICABLE RULES AND REGULATIONS OF THE OCCUPATIONAL SAFETY AND HEALTH ADMINISTRATION (OSHA) AND STATE LAW AS DEFINED IN THE FEDERAL OCCUPATIONAL SAFETY AND HEALTH ACT.
- PRIOR TO THE SUBMISSION OF THE BID, THE CONTRACTOR SHALL VISIT THE JOB SITE, VERIFY ALL DIMENSIONS AND BECOME FAMILIAR WITH THE FIELD CONDITIONS. ANY DISCREPANCIES SHALL BE BROUGHT TO THE ATTENTION OF THE PROJECT MANAGER.
- 6. DRAWING PLANS SHALL NOT BE SCALED.
- 7. THE CONTRACTOR SHALL NOT PROCEED WITH ANY WORK NOT CLEARLY IDENTIFIED ON THE DRAWINGS WITHOUT THE PRIOR WRITTEN APPROVAL OF THE PROJECT MANAGER.
- 8. THE CONTRACTOR SHALL INSTALL ALL EQUIPMENT AND MATERIALS IN ACCORDANCE WITH MANUFACTURER RECOMMENDATIONS UNLESS SPECIFICALLY OTHERWISE NOTED.
- ALL MEANS AND METHODS OF CONSTRUCTION DEALING WITH TOWER CONSTRUCTION AND SAFETY, STEEL ERECTION, EXCAVATIONS, TRENCHING, SCAFFOLDING, FORMWORK, ELECTRICAL, AND WORK IN CONFINED SPACES ARE THE SOLE RESPONSIBILITY OF THE CONTRACTOR.
- 10. THE CONTRACTOR SHALL BE RESPONSIBLE FOR INITIATING, MAINTAINING, AND SUPERVISING ALL SAFETY PRECAUTIONS AND PROGRAMS IN CONNECTION WITH THE WORK
- 11. THE CONTRACTOR SHALL BE EXPERIENCED IN THE PERFORMANCE OF WORK SIMILAR TO THAT DESCRIBED HEREIN. BY ACCEPTANCE OF THIS ASSIGNMENT, THE CONTRACTOR IS ATTESTING THAT HE DOES HAVE SUFFICIENT EXPERIENCE AND ABILITY AND THAT HE IS KNOWLEDGEABLE OF THE WORK TO BE PERFORMED.
- 12. THE CONTRACTOR SHALL PROVIDE SUFFICIENT TEMPORARY BRACING AND/OR SHORING OF ALL STRUCTURAL AND NON-STRUCTURAL ELEMENTS DURING CONSTRUCTION UNTIL ALL STRUCTURAL ELEMENTS HAVE BEEN PROPERLY INSTALLED.
- 13. INCORRECTLY FABRICATED, DAMAGED, OR OTHERWISE MISFITTING OR NONCONFORMING MATERIALS SHALL BE REPORTED TO THE PROJECT MANAGER AND ENGINEER, AND SHALL REQUIRE APPROVAL PRIOR TO PERFORMING ANY REMEDIAL OR CORRECTIVE ACTION.

STRUCTURAL STEEL NOTES:

- STRUCTURAL STEEL MATERIALS CONFORM TO THE LATEST EDITION OF APPLICABLE STANDARDS AND TO ALL APPLICABLE CODES AND REQUIREMENTS OF LOCAL AUTHORITIES HAVING JURISDICTION, WHICHEVER IS MORE STRINGENT. ALL STRUCTURAL STEEL SHALL BE IN ACCORDANCE WITH THE LATEST APPLICABLE REQUIREMENTS OF AISC, ASTM, ACI, CRSI, AWS AND ALL OTHER APPLICABLE STANDARDS
- 2. ALL STEEL SHALL BE GALVANIZED IN ACCORDANCE WITH ASTM A123 UNLESS NOTED ON THE CONSTRUCTION DRAWINGS.
- ROLLED STEEL SHAPES, PLATES AND BARS SHALL BE NO LESS THAN 3/16 INCHES IN THICKNESS AND SHALL COMPLY WITH ASTM A-36 AS A MINIMUM.
- 4. STEEL PIPE SHALL COMPLY WITH ASTM A-501 OR ASTM A-53, TYPE E OR S, GRADE B. A-500 GRADE B STEEL MAY BE SUBSTITUTED.
- 5. GALVANIZED STEEL GRATING SHALL BE A MINIMUM 1-1/4 INCH X 1/8 INCH AT 3/16 INCHES ON CENTER.
- COLD FORMED CHANNELS, C'S AND Z'S USED AS GIRTS SHALL CONFORM TO THE REQUIREMENTS OF ASTM STANDARD A607 GRADE 50.
- 7. CONNECTIONS:
 - A. CONTRACTOR SHALL PROVIDE ALL HARDWARE REQUIRED TO COMPLETE FIELD ERECTION OF STRUCTURE AS INDICATED BY CONTRACT DOCUMENTS OR THESE SPECIFICATIONS.
 - B. HIGH STRENGTH THREADED FASTENERS SHALL BE INSTALLED IN ACCORDANCE WITH AISC SPECIFICATIONS FOR STRUCTURAL JOINTS USING ASTM A-325 BOLTS. USE A-325N BEARING-TYPE CONNECTION BOLTS UNLESS NOTED OTHERWISE.
 - C. GRATING AND PLATES SHALL BE FASTENED WITH SADDLE CLIPS. THE NECESSARY HOLES TO COMPLETE ALL PHASES OF CONSTRUCTION SHALL BE PROVIDED AND CALLED OUT ON THE APPROVED SHOP DRAWINGS. ALL HOLES SHALL BE DRILLED OR PUNCHED PERPENDICULAR TO METAL SURFACES, FLAME CUT OR BURNED HOLES WILL NOT BE PERMITTED.
 - D. ALL UNFINISHED THREADED FASTENERS SHALL COMPLY WITH ASTM A-307, GRADE A, REGULAR LOW-CARBON STEEL BOLTS AND NUTS WITH HEXAGONAL HEADS.
 - E. ALL HIGH STRENGTH THREADED FASTENERS SHALL BE HEAVY HEXAGONAL BOLTS AND NUTS WITH HARDENED WASHERS, ALL FROM QUENCHED AND TEMPERED MEDIUM CARBON STEEL COMPLYING WITH ASTM A-325.

WATER TOWER NOTES:

HEALTH AND SAFETY

- CONTRACTOR SHALL PROVIDE ALL SAFETY EQUIPMENT AND FALL PROTECTION TO ENSURE THE SAFETY OF ON SITE PERSONNEL DURING CONSTRUCTION.
- ACCESS TO THE TANK INTERIOR WATER COMPARTMENT SHALL NOT BE PERMITTED WITHOUT THE APPROVAL OF THE WATER DEPARTMENT SUPERVISOR. PRECAUTIONS SHALL BE TAKEN TO PREVENT WATER CONTAMINATION.
- 3. THE PAINT SYSTEM SHALL BE CHECKED FOR HAZARDOUS METALS. WHERE HAZARDOUS METALS ARE FOUND IN THE PAINT SYSTEM, THE ENVIRONMENT AND WORKERS MUST BE PROTECTED FROM CONTAMINATION.

ADDITIONAL WATER TOWER GENERAL NOTES

- ALL STEEL ANTENNA INSTALLATION COMPONENTS MUST BE PAINTED TO MATCH EXISTING PAINT SYSTEMS ON THE EXTERIOR AND DRY INTERIOR.
- 2. NO COMPONENTS CAN REMAIN GALVANIZED OR STAINLESS STEEL. THE SPECIFIED PAINT SYSTEMS WILL NOT HAVE GOOD ADHESION ON GALVANIZED OR STAINLESS STEEL SURFACES.
- 3. CONTACT WATER TOWER PAINT MANUFACTURER TNEMEC OR EQUAL TO OBTAIN A SUITABLE SURFACE PREPARATION SYSTEM FOR GALVANIZED AND STAINLESS STEEL SURFACES. THE SYSTEM MUST MAKE PREVIOUSLY GALVANIZED AND STAINLESS STEEL SURFACES COMPATIBLE WITH THE SPECIFIED PAINT SYSTEMS THAT WILL BE APPLIED.
- 4. IF APPLICABLE, PAINT ALL NEW STEEL IN A SHOP SETTING, PRIOR TO DELIVERY TO THE SITE.
- 5. FOLLOW ALL PAINT MANUFACTURERS' RECOMMENDATIONS WHEN USING THEIR PRODUCTS.
- 6. CONTRACTOR SHALL REPAIR ALL DAMAGED PAINT AREAS OF TANK DUE TO CUTTING, WELDING AND GRINDING. DUE TO THE GENERATION OF METAL FILINGS WHICH WILL RUST STAIN THE TANK SURFACES IF NOT CLEANED OFF IN A TIMELY MANNER, CONTRACTOR SHALL REMOVE ALL METAL FILINGS IMMEDIATELY. DAMAGED PAINT SURFACES SHOULD BE REPAIRED PER WATER TANK OWNER SPECIFICATIONS. CONTRACTOR SHALL COORDINATE ALL PAINT MATERIALS & METHODS WITH TANK OWNER PRIOR TO WORK BEING DONF.



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SITE ADDRESS


8249 ARTHUR ST NE SPRING LAKE PARK, MN 55432

SHEET NAME

STRUCTURAL NOTES

SHEET NUMBER

S-1

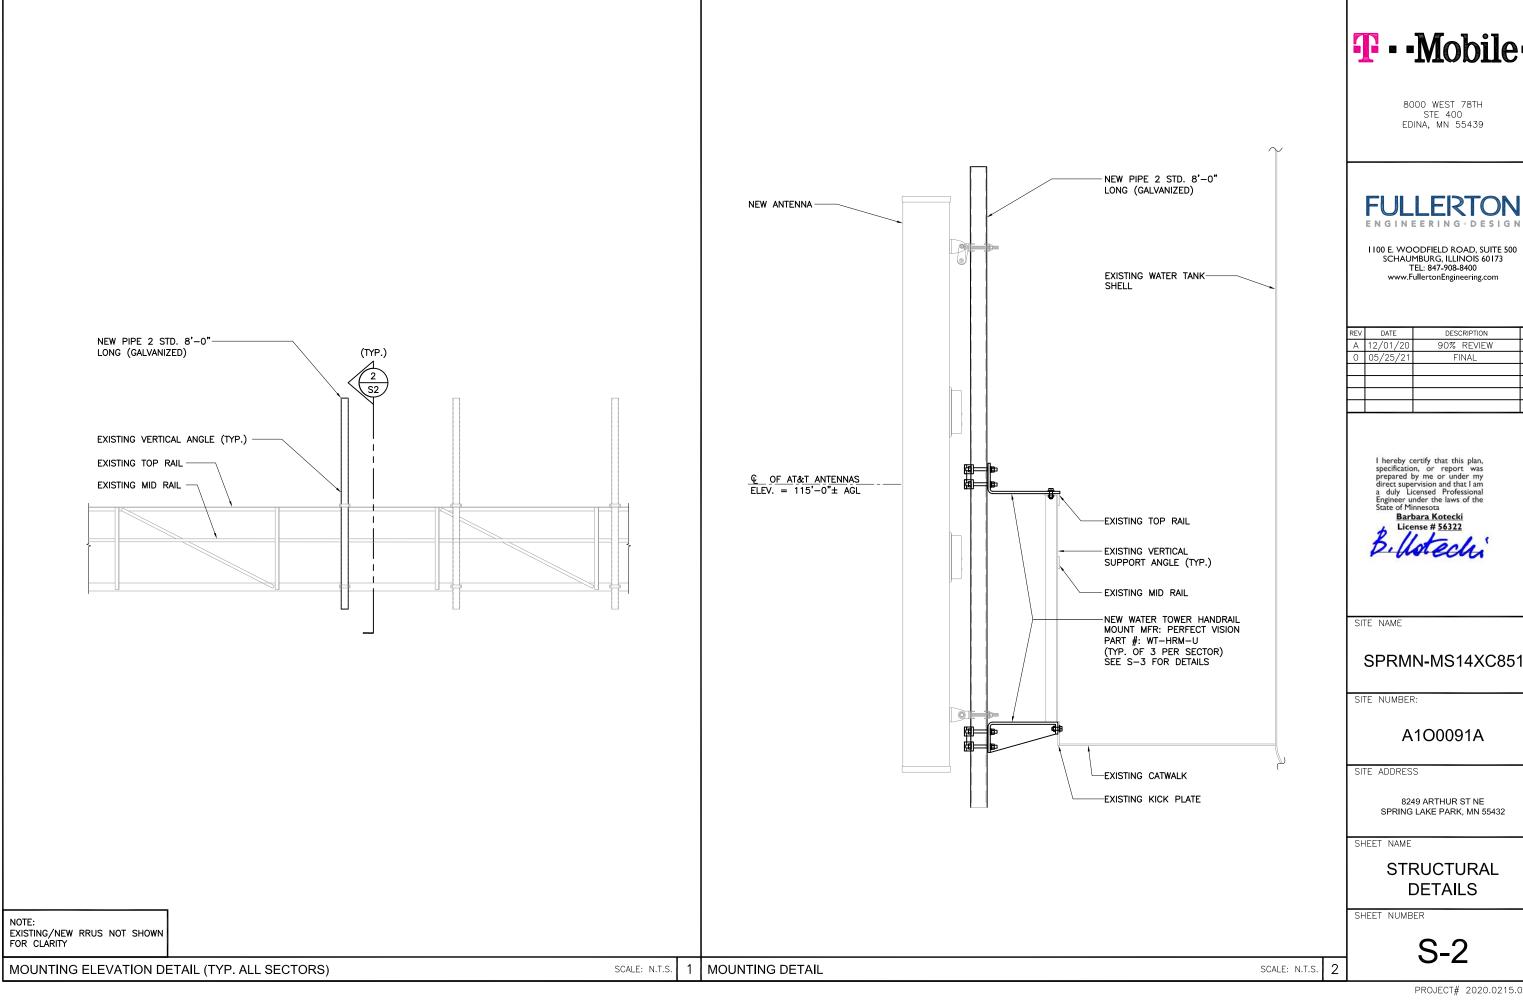




FULLERTON

REV	DATE	DESCRIPTION	BY
Α	12/01/20	90% REVIEW	MK
0	05/25/21	FINAL	RO
_			

SPRMN-MS14XC851

8249 ARTHUR ST NE SPRING LAKE PARK, MN 55432

STRUCTURAL **DETAILS**

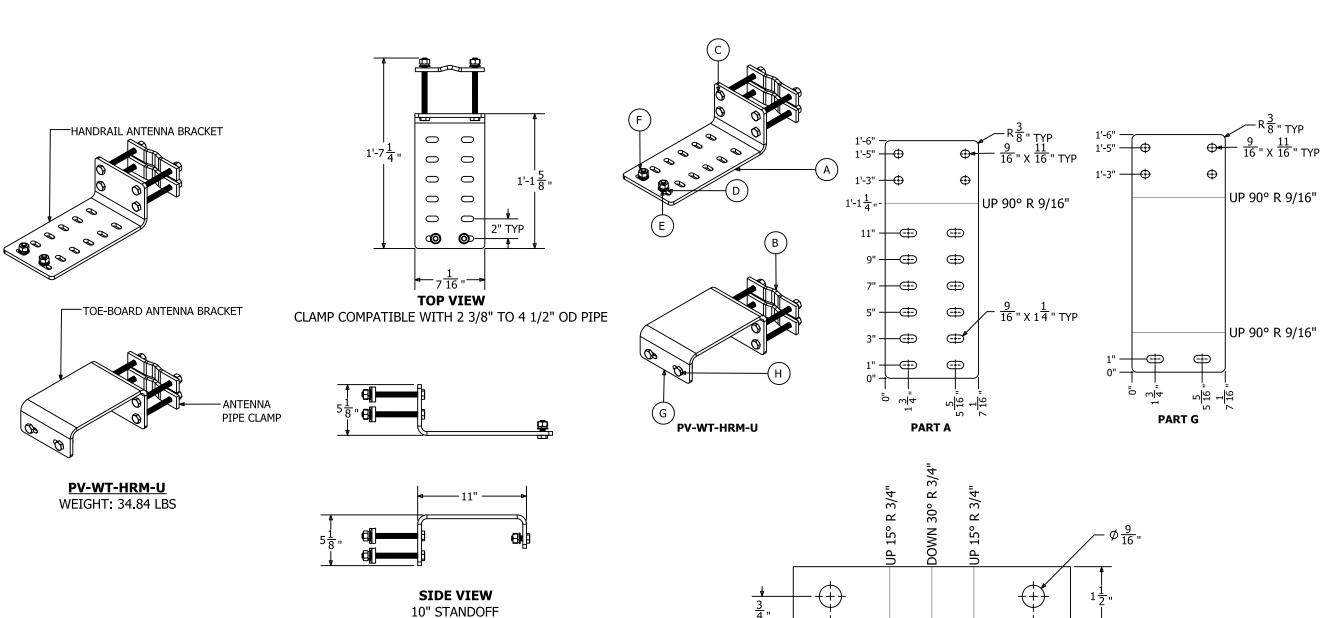

SHAPE LENGTH GRADE NOTES PL 3/8" - 71/16" BENT - BEND RADIUS 9/16" PL 3/8" - 1 1/2" A36 BENT - BEND RADIUS 3/4" 1/2" - 13 SAE GR.5 BOLT FLAT WASHER 1/2" DIA F436 D LOCK WASHER 1/2" DIA A563DH NUT 1/2" - 13 A36 BENT - BEND RADIUS 9/16" PL 3/8" - 7 1/16" 18" G 1/2" - 13 1 1/2" A325 BOLT

 $6\frac{1}{16}$ "

115 16

PART B

T - - Mobile -

8000 WEST 78TH STE 400 EDINA, MN 55439

I 100 E. WOODFIELD ROAD, SUITE 500 SCHAUMBURG, ILLINOIS 60173 TEL: 847-908-8400 www. Fuller ton Engineering. com

REV	DATE	DESCRIPTION	BY
Α	12/01/20	90% REVIEW	MK
0	05/25/21	FINAL	RO
$\overline{}$			

I hereby certify that this plan, specification, or report was prepared by me or under my direct supervision and that I am a duly Licensed Professional Engineer under the laws of the State of Minnesota



SITE NAME

SPRMN-MS14XC851

SITE NUMBER:

A100091A

SITE ADDRESS

8249 ARTHUR ST NE SPRING LAKE PARK, MN 55432

SHEET NAME

STRUCTURAL **DETAILS**

SHEET NUMBER

STRUCTURAL DETAILS SCALE: N.T.S.

PV-WT-HRM-U

WATER TOWER HANDRAIL ANTENNA MOUNT

NOTE: ANTENNA PIPE NOT INCLUDED