SOUTH JORDAN CITY PLANNING COMMISSION REPORT

Issue: Everbrook Academy Daycare Center

SITE PLAN APPLICATION

Address: 1720 W Shields Lane South Jordan, UT 84095

File No: PLSPR202300037 Applicant: Allison Morgan

Submitted by: Miguel Aguilera, Planner I

Shane Greenwood, Supervising Senior Engineer

Staff Recommendation (Motion Ready): I move that the Planning Commission **approve** the Site Plan application, file number **PLSPR202300037**, with the condition of the cross access easement, to allow for construction of a daycare center in the C-N zone at 1720 W Shields Lane.

ACREAGE: 1.308 acres

CURRENT ZONE: C-N (Commercial Neighborhood) Zone

CURRENT USE: Vacant Land

FUTURE LAND USE PLAN: EC (Economic Center)

NEIGHBORING ZONES/USES: North – MU-V (Santorini Village)

South – MU-R_D (PD) (Vacant Land) West – P-O (Jordan River Medical) East – C-N (Kum & Go Gas Station)

Meeting Date: 07/11/2023

STANDARD OF REVIEW:

All proposed commercial, office, industrial, multi-family dwelling or institutional developments and alterations to existing developments shall meet the site plan review requirements outlined in Chapter 16.24 and the requirements of the individual zone in which a development is proposed. All provisions of Title 16 & 17 of South Jordan City Code, and other City requirements shall be met in preparing site plan applications and in designing and constructing the development. The Planning Commission shall receive public comment regarding the site plan and shall approve, approve with conditions, or deny the site plan.

BACKGROUND:

Pending approval of the subdivision amendment for 1720 W Shields Lane, the proposed development will occupy lot 2A on the west side of the subdivision. Everbrook Academy will

have the addresses 1816 W Shields Lane and 9777 S Emporio Drive once the subdivision amendment process is completed.

The project will be a one-story, 12,870 square foot daycare center situated on a 1.308 acre lot. The building will be oriented towards the northeast corner of the lot with parking and landscaping wrapping around the building facing Shields Lane and Emporio Drive. Everbrook Academy will have a capacity of 155 students and staff. The playground will be behind the building bordered by the Santorini Village masonry walls on the north and a 6 foot tall vinyl fence that will be installed by the developer on the east. The parking requirement for the daycare use is 1 per 300 square feet. There will be 33 parking stalls, which is based on the total intended use floor space of 9,135 square feet. The intended use floor space will consist of a multi-purpose room, a lobby, 11 classrooms, and the corridor space connecting all the rooms. Vehicles will be able to access the daycare center through Shields Lane and Emporio Drive.

It is noted that the underlying zone does not allow parking between a building and public right of way. However, Section F-3 of the South Jordan Commercial Zone Development Standards allows the Planning Director to make exceptions to this should the requirement not be reasonable. In this case, it is reasonable for a daycare center to have parking stalls along its front facades so that its rear facades may remain an enclosed area where children will be.

The building façade will be 6,602 square feet of masonry/stone and 1,135 square feet of stucco. The main entrance will be located on the south façade and consist of clear store front glazing glass. The building's stucco and stone materials will follow a brown and tan color pallet. The building received a positive recommendation from the Architectural Review Committee (ARC).

Landscaping will consist of trees, shrubs, rock mulch, and lawn cover. A mix of 36 trees and 154 shrubs will be planted throughout all landscaped areas. Lawn area will be 2,890 square feet of the landscape area. The landscaping plans meet city landscaping requirements for commercial zones.

STAFF FINDINGS, CONCLUSIONS & RECOMMENDATION:

Findings:

- The proposed building use is a daycare center and is permitted in the C-N zone.
- The Architectural Review Committee reviewed the proposed building on April 26, 2023. The project received a positive recommendation from the committee.
- The development's parking requirement is based on the intended use floor area of 9,135 square feet.
- The development's parking stalls will be located between the building and public right of way, which allows the rear to be an enclosed playground.
- The signs shown on elevation plans are not approved as part of the site plan application and will require a separate sign permit application.

Conclusion:

• The proposed project will meet the requirements of the Subdivision and Development (Title 16) and the Planning and Zoning (Title 17) Codes and thus should be approved.

Recommendation:

• Based on the Findings and Conclusions listed above, Staff recommends that the Planning Commission take comments at the public hearing and **approve** the Application, unless, during the hearing, facts are presented that contradict these findings or new facts are presented, either of which would warrant further investigation by Staff.

ALTERNATIVES:

- Approve an amended Application.
- Deny the Application.
- Schedule the Application for a decision at some future date.

SUPPORT MATERIALS:

- Location Map
- Zoning Map
- Site Plan
- Landscape Plan
- Building Elevations


Miguel Aguilera


Miguel Aguilera Planner I, Planning Department Brad Klavano
Brad Klavano (Jul 5, 2023 16:54 MDT)

Brad Klavano, P.E. City Engineer



Zoning Map *City of South Jordan*Everbrook Academy Site

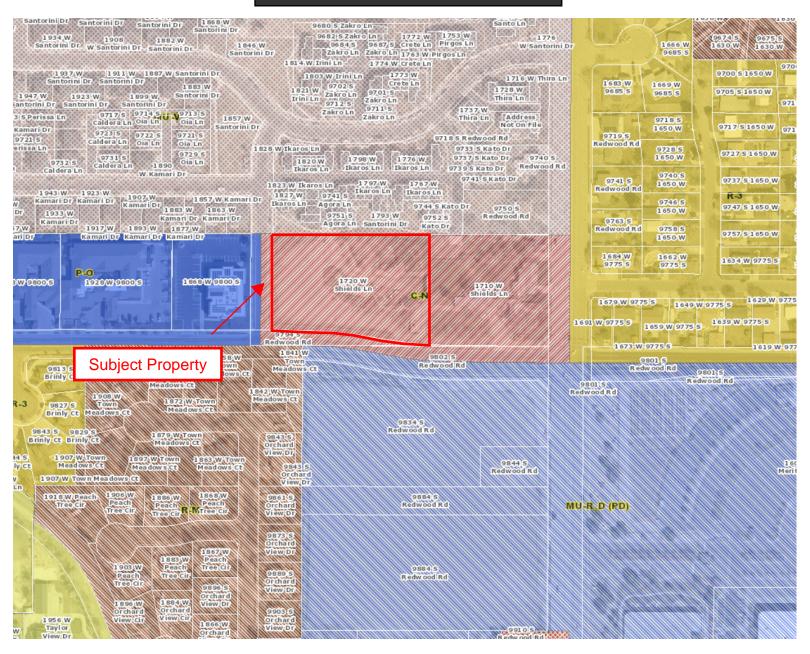

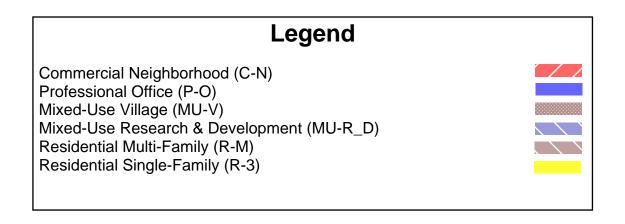

DEVELOPER: NLD SHIELDS LLC ATTN: ALLISON MORGAN 60 SOUTH SIXTH STREET, SUITE 2630 MINNEAPOLIS, MN 55402 PH: (612) 313-0126

SURVEYOR: **GALLOWAY** ATTN: TROY KENDALL 2015 W. GROVE PARKING, SUITE H PLEASANT GROVE, UT 84062 PH: (385) 248-0460

CIVIL ENGINEER (PROJECT CONTACT): **HUNT DAY** ATTN: THOMAS HUNT, PE 3445 ANTELOPE DRIVE SYRACUSE, UT 84075 PH: (801) 664-4724

ARCHITECT: ADA ARCHITECTS ATTN: JAVIER CORA 17710 DETROIT AVENUE LAKEWOOD, OHIO 44107 PH: (216) 521-5134

Site Data

LANDSCAPE AREA:

LOCATION: SOUTH JORDAN ZONING: C-N COMMERCIAL NEIGHBORHOOD

PROPERTY SIZE: 56,976 SF / 1.31 AC BUILDING FOOTPRINT: 12,877 SF (22.6%) 28,058 SF (49.2%) HARD SURFACE AREA:

PARKING: 30 STALLS REQUIRED 33 STALLS PROVIDED

2 BICYCLE STALLS PROV. FLOOD INFORMATION FLOOD ZONE DESIGN 'X' PER F.E.M.A. FLOOD INSURANCE RATE

16,041 SF (28.2%)

MAPS, COMMUNITY PANEL NUMBERS 49035C0429G, DATED SEPTEMBER 25, 2009.

AREAS DETERMINED TO BE OUTSIDE THE 0.2% ANNUAL CHANCE FLOODPLAIN.

DATUM INFORMATION SITE BENCHMARK:

SECTION CORNER LOCATED IN REDWOOD ROAD AND SHIELDS LANE, NAVD88

ELEVATION = 4395.85'

GEOTECH REPORT DATED: DECEMBER 20, 2022


TERRACON 6949 S. HIGH TECH DRIVE MIDVALE, UT 84047

PH: (801) 545-8500

Notice To Contractors:

THE EXISTENCE AND LOCATION OF ANY UNDERGROUND UTILITIES OR STRUCTURES SHOWN ON THESE PLANS WERE OBTAINED FROM AVAILABLE INFORMATION PROVIDED BY THE SURVEYOR OR CITY PRODUCED DOCUMENTS. THE LOCATIONS SHOWN ARE APPROXIMATE AND SHALL BE CONFIRMED IN THE FIELD BY THE CONTRACTOR, SO THAT ANY NECESSARY ADJUSTMENT CAN BE MADE. IF ANY CONFLICT/DISCREPENCIES ARISE, PLEASE CONTACT THE ENGINEER OF RECORD IMMEDIATELY. THE CONTRACTOR IS REQUIRED TO CONTACT THE UTILITY COMPANIES AND TAKE

PRECAUTIONARY MEASURES TO PROTECT ANY UTILITIES SHOWN OR NOT SHOWN ON THESE PLANS.

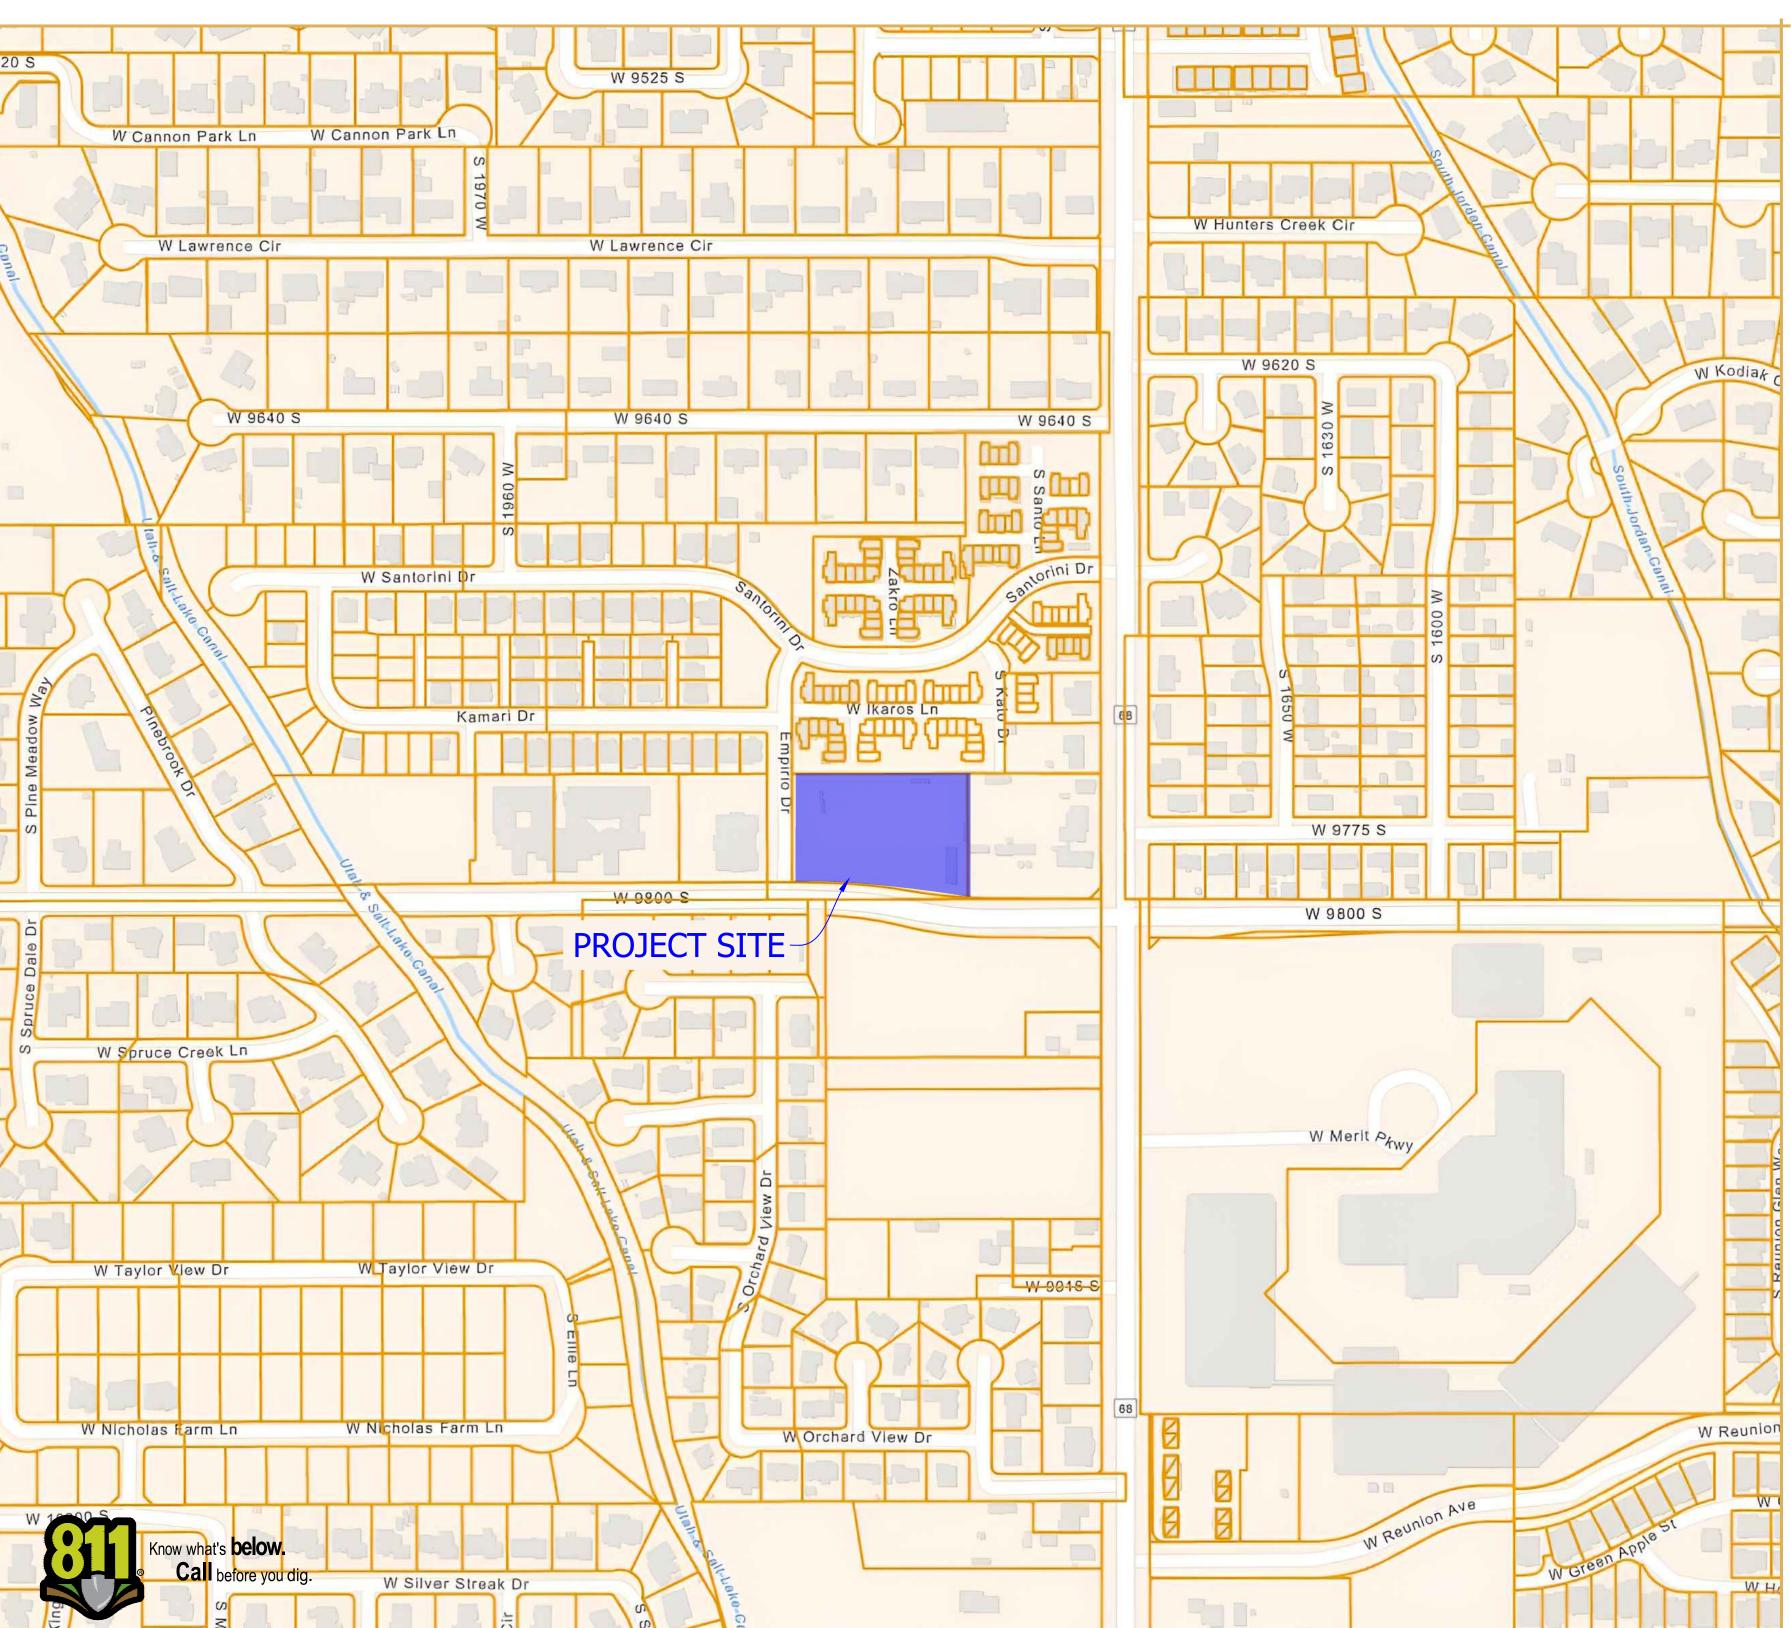

Location Map



Sheet Index

C001 - Cover Sheet C002 - South Jordan Standard Notes C003 - Notes, Legend & Abbreviations C100 - Demolition Plan C200 - Site Plan C201 - Overall Site Layout C202 - Striping Plan C300 - Grading & Drainage Plan C400 - Utility Plan C600 - Civil Details C601 - Civil Details C602 - Civil Details C700 - SWPPP Exhibit C701 - SWPPP Details L100 - Landscape Plan L101 - Irrigation Plan

Agency/Utility Contacts

PLANNING & ZONING: SOUTH JORDAN CITY 1600 WEST TOWNE CENTER DRIVE SOUTH JORDAN, UT 84095 PHONE: (801) 446-4357

BUILDING & ENGINEERING SOUTH JORDAN CITY ATTN: SHANE GREENWOOD 1600 WEST TOWNE CENTER DRIVE SOUTH JORDAN, UT 84095 PHONE: (801) 254-3742

FIRE DEPARTMENT: SOUTH JORDAN PUBLIC SAFETY BUILDING 10655 SOUTH REDWOOD ROAD SOUTH JORDAN, UT 84095 PHONE: (801) 446-HELP (4357)

> STORMWATER: SOTUH JORDAN CITY PUBLIC WORKS **SOUTH JORDAN CITY** 10996 S REDWOOD ROAD SOUTH JORDAN, UT 84095 PHONE: (801) 253-5230

> > SOUTH JORDAN CITY 10996 S REDWOOD ROAD SOUTH JORDAN, UT 84095 PHONE: (801) 253-5230


SOUTH VALLEY SEWER DISTRICT 1253 JORDAN BASIN LANE BLUFFDALE, UT 84065 PHONE: (801) 576-6326

> POWER COMPANY: ROCKY MOUNTAIN POWER CUSTOMER SERVICE LINE PHONE: (800) 469-3981

GAS SERVICE: **DOMINION ENERGY** CUSTOMER SERVICE LINE PHONE: (866) 366-4357

TELECOMMUNICATIONS: CENTURYLINK 1425 WEST 3100 SOUTH WEST VALLEY, UT 84119 PHONE: (801) 974-8143

EVOLVE NETWORK EMAIL: KEN@EVOLVENETWORX.COM

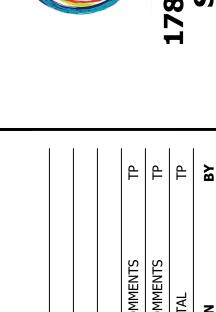

erbro

ENGINEERS STAMP



VERIFY SCALES BAR IS ONE INCH ON ORIGINAL DRAWING

IF NOT ONE INCH ON THIS SHEET, ADJUST

SCALES ACCORDINGLY

PROJECT INFO. Engineer: T. Hunt T. Pridemore Drawn: Checked: Date: 12 / 09 / 2022

SHEET TITLE

Cover Sheet

SHEET NO.

1.1 South Jordan City General Notes

- 1. ALL WORK DONE OR IMPROVEMENTS INSTALLED WITHIN SOUTH JORDAN CITY INCLUDING BUT NOT LIMITED TO EXCAVATION, CONSTRUCTION, ROADWORK AND UTILITIES SHALL CONFORM TO THE SOUTH JORDAN CITY CONSTRUCTION STANDARDS AND SPECIFICATIONS, CITY MUNICIPAL CODE, THE LATEST EDITION OF THE APWA MANUAL OF STANDARD SPECIFICATIONS AND MANUAL OF STANDARD PLANS, THE LATEST EDITION OF THE MANUAL ON UNIFORM TRAFFIC CONTROL DEVICES (MUTCD) AND ANY STATE OR FEDERAL REGULATIONS AND PERMIT REQUIREMENTS OF VARIOUS GOVERNING BODIES. THE CONTRACTOR IS RESPONSIBLE TO HAVE A COPY OF THESE SPECIFICATIONS AND TO KNOW AND CONFORM TO THE APPROPRIATE CODES, REGULATIONS, DRAWINGS, STANDARDS AND SPECIFICATIONS.
- 2. THE EXISTENCE AND LOCATION OF ANY OVERHEAD OR UNDERGROUND UTILITY LINES, PIPES, OR STRUCTURES SHOWN ON THESE PLANS ARE OBTAINED BY A RESEARCH OF THE AVAILABLE RECORDS. EXISTING UTILITIES ARE LOCATED ON PLANS ONLY FOR THE CONVENIENCE OF THE CONTRACTOR. THE CONTRACTOR SHALL BEAR FULL RESPONSIBILITY FOR THE PROTECTION OF UTILITIES AND THE ENGINEER BEARS NO RESPONSIBILITY FOR UTILITIES NOT SHOWN ON THE PLANS OR NOT IN THE LOCATION SHOWN ON THE PLANS. THIS INCLUDES ALL SERVICE LATERALS OF ANY KIND. THE CONTRACTOR SHALL, AT HIS OWN EXPENSE, LOCATE ALL UNDERGROUND AND OVERHEAD INTERFERENCES, WHICH MAY AFFECT HIS OPERATION DURING CONSTRUCTION AND SHALL TAKE ALL NECESSARY PRECAUTIONS TO AVOID DAMAGE TO SAME. THE CONTRACTOR SHALL USE EXTREME CAUTION WHEN WORKING NEAR OVERHEAD UTILITIES SO AS TO SAFELY PROTECT ALL PERSONNEL AND EQUIPMENT, AND SHALL BE RESPONSIBLE FOR ALL COST AND LIABILITY IN CONNECTION THEREWITH.
- 3. THE CONTRACTOR SHALL TAKE ALL PRECAUTIONARY MEASURES NECESSARY TO PROTECT EXISTING UTILITY LINES, STRUCTURES, SURVEY MONUMENTS AND STREET IMPROVEMENTS WHICH ARE TO REMAIN IN PLACE, FROM DAMAGE, AND ALL SUCH IMPROVEMENTS OR STRUCTURES DAMAGED BY THE CONTRACTOR'S OPERATIONS SHALL BE REPAIRED OR REPLACED SATISFACTORY TO THE CITY ENGINEER AND OWNING UTILITY COMPANY AT THE EXPENSE OF THE
- CONTRACTOR.

 4. ALL CONSTRUCTION SHALL BE AS SHOWN ON THESE PLANS, ANY REVISIONS SHALL HAVE THE PRIOR WRITTEN APPROVAL OF THE CITY ENGINEER.
- 5. PERMITS ARE REQUIRED FOR ANY WORK IN THE PUBLIC WAY. THE CONTRACTOR SHALL SECURE ALL PERMITS AND INSPECTIONS REQUIRED FOR THIS CONSTRUCTION.
- CURB, GUTTER, AND SIDEWALK, FOUND TO BE UNACCEPTABLE PER CITY STANDARDS AND APWA SHALL BE REMOVED AND REPLACED.
 CONTRACTOR SHALL PROVIDE ALL NECESSARY HORIZONTAL AND VERTICAL TRANSITIONS BETWEEN NEW
- CONSTRUCTION AND EXISTING SURFACES TO PROVIDE FOR PROPER DRAINAGE AND FOR INGRESS AND EGRESS TO NEW CONSTRUCTION. THE EXTENT OF TRANSITIONS TO BE AS SHOWN ON PLANS.
- 8. ANY SURVEY MONUMENTS DISTURBED SHALL BE REPLACED AND ADJUSTED PER SALT LAKE COUNTY SURVEYORS REQUIREMENTS.
- 9. ALL PRIVACY WALLS, NEW OR EXISTING, ARE ONLY SHOWN ON CIVIL PLANS FOR THE PURPOSE OF REVIEWING GRADING RELATIONSHIPS; FLOOD CONTROL AND SIGHT DISTANCE AT INTERSECTIONS. ALL WALLS SHALL HAVE A MINIMUM 2 FT X 2 FT X 30 INCH DEEP SPOT FOOTINGS. BOTTOM OF ALL FOOTINGS ON ALL WALLS SHALL BE A MINIMUM OF 30 INCHES BELOW FINISHED GRADE. WALLS GREATER THAN 6 FEET REQUIRE A SEPARATE PERMIT AND INSPECTION BY THE BUILDING DEPARTMENT.
- 10. ALL CONSTRUCTION MATERIALS PER APWA MUST BE SUBMITTED AND APPROVED BY THE CITY ENGINEER PRIOR TO THE PLACEMENT OF ASPHALT WITHIN CITY RIGHT OF WAY.
- 11. REQUEST FOR INSPECTION BY THE CITY OF SOUTH JORDAN ENGINEERING DEPT. SHALL BE MADE BY THE CONTRACTOR AT LEAST 48 HOURS BEFORE THE INSPECTION SERVICES WILL BE REQUIRED, EXCEPT IN AN EMERGENCY AS DEFINED BY THE SOUTH JORDAN CITY MUNICIPAL CODE § 12.08.010.
- 12. WORK IN PUBLIC WAY, ONCE BEGUN, SHALL BE PROSECUTED TO COMPLETION WITHOUT DELAY AS TO PROVIDE
- MINIMUM INCONVENIENCE TO ADJACENT PROPERTY OWNERS AND TO THE TRAVELING PUBLIC.

 13. THE CONTRACTOR SHALL TAKE ALL NECESSARY AND PROPER PRECAUTIONS TO PROTECT ADJACENT PROPERTIES FROM ANY AND ALL DAMAGE THAT MAY OCCUR FROM STORM WATER RUNOFF AND/OR DEPOSITION OF DEBRIS
- RESULTING FROM ANY AND ALL WORK IN CONNECTION WITH CONSTRUCTION.

 14. POWER POLES AND/OR OTHER EXISTING FACILITIES NOT IN PROPER LOCATION BASED ON PROPOSED IMPROVEMENTS SHOWN HEREON WILL BE RELOCATED AT NO EXPENSE TO THE CITY OF SOUTH JORDAN. POWER LINES AND ALL OTHER AERIAL UTILITIES ARE TO BE BURIED AND POLES REMOVED AS DETERMINED BY THE CITY
- ENGINEER.

 15. CURB AND GUTTER WITH A GRADE OF LESS THAN FOUR-TENTHS OF ONE PERCENT SHALL BE CONSTRUCTED BY FORMING. EACH JOINT SHALL BE CHECKED FOR A GRADE PRIOR TO CONSTRUCTION AND WATER TESTED AS SOON
- AS POSSIBLE AFTER CONSTRUCTION.

 16. CONTRACTOR TO FOLLOW SALT LAKE COUNTY NOISE ORDINANCE STANDARDS.
- 17. CONTRACTOR ARE RESPONSIBLE FOR ALL OSHA REQUIREMENTS ON THE PROJECT SITE.
- 18. A UPDES (UTAH POLLUTANT DISCHARGE ELIMINATION SYSTEM) PERMIT IS REQUIRED FOR ALL CONSTRUCTION ACTIVITIES AS PER STATE LAW AS WELL AS PROVIDING A STORM WATER POLLUTION PREVENTION PLAN TO THE CITY.
- 19. DEVELOPER IS RESPONSIBLE FOR LOCATING AND REPAIRING ALL UNDERGROUND STREETLIGHT WIRES, WATER LINES, STORM DRAIN LINES AND IRRIGATION LINES UNTIL 90% OF THE BOND HAS BEEN RELEASED.
- 20. ALL CITY MAINTAINED UTILITIES INCLUDING; WATERLINE, FIRE HYDRANTS, STREETLIGHT WIRING, AND STORM DRAIN MUST BE IN PUBLIC RIGHT OF WAY OR IN RECORDED EASEMENTS.
- 21. CONTRACTOR SHALL WORK SOUTH JORDAN CITY REGULAR WORKING HOURS OF MONDAY THROUGH FRIDAY 7:00 AM TO 4:00 PM. IF CONTRACTOR PERMITS OVERTIME WORK OR WORK ON A SATURDAY, SUNDAY OR ANY LEGAL HOLIDAY, CONTRACTOR SHALL RECEIVE PRIOR APPROVAL BY CITY ENGINEER. CONTRACTOR SHALL OBTAIN ALL PERMITS AND PAY OVERTIME INSPECTION FEE'S TO THE CITY OF SOUTH JORDAN ON THE THURSDAY PRIOR TO THE SATURDAY, SUNDAY OR LEGAL HOLIDAY REQUESTED. THIS APPLIES TO ALL WORK WITHIN THE PUBLIC RIGHT OF
- WAY INCLUDING TRAFFIC CONTROL AND ACCESS.

 22. PRIOR TO 90% BOND RELEASE, A LEGIBLE AS-BUILT DRAWING MUST BE SUBMITTED TO THE CITY OF SOUTH JORDAN STAMPED AND SIGNED BY A PROFESSIONAL ENGINEER. AS-BUILTS MUST SHOW ALL CHANGES AND ACTUAL FIELD LOCATIONS OF STORM DRAINAGE, WATERLINES, IRRIGATION, STREET LIGHTING, AND POWER. AS-BUILTS WILL BE HELD TO THE SAME STANDARD AS APPROVED DESIGN DRAWINGS, NO "REDLINED PLANS" ALLOWED. IN THE ABSENCE OF CHANGES, COPIES OF THE APPROVED DRAWINGS WILL BE REQUIRED STATING "INSTALLED AS PER DRAWINGS". AS-BUILT DRAWINGS FOR NEW DEVELOPMENTS SHALL BE SUBMITTED TO THE CITY IN THE FOLLOWING FORMATS AND QUANTITIES PRIOR TO THE 90% BOND RELEASE: 1 .DXF COPY, 1 .PDF COPY.
- 23. FILTER FABRIC WRAPPED AROUND AN INLET GRATE IS NOT AN ACCEPTABLE INLET SEDIMENT BARRIER. SEE CHAPTER 9 OF SOUTH JORDAN CITY CONSTRUCTION STANDARDS AND SPECIFICATIONS FOR DETAILS OF APPROVED STORM WATER BMPS.
- 24. ASPHALT PAVING BETWEEN OCTOBER 15 AND APRIL 15 IS NOT ALLOWED WITHOUT A WRITTEN EXCEPTION FROM THE ENGINEERING DEPARTMENT.
- 25. TO ENSURE PROPER PLANTING, PROTECTION AND IRRIGATION OF TREES, MITIGATING RISK OF TREE FAILURE OR FUTURE DAMAGE TO INFRASTRUCTURE, CONTRACTORS ARE REQUIRED TO FOLLOW THE STANDARDS AND SPECIFICATIONS OF THE ISA INTERNATIONAL SOCIETY OF ARBORICULTURE.
- 26. ALL SMALL CELL CONSTRUCTION MUST FOLLOW THE SOUTH JORDAN CITY SMALL CELL INFRASTRUCTURE DESIGN GUIDELINES.
- 27. ALL CONSTRUCTION OF LOW IMPACT DEVELOPMENT (LID) MUST FOLLOW THE SOUTH JORDAN CITY LOW IMPACT DEVELOPMENT HANDBOOK 2020. WITH THE DEVELOPMENT OF ANY RESIDENTIAL SUBDIVISION THAT PROPOSES LID IN PUBLIC PARK STRIPS, THE DEVELOPER MUST CONSTRUCT/INSTALL SUCH TO COMPLETENESS, INCLUDING BUT NOT LIMITED TO VEGETATION AND LANDSCAPE IRRIGATION. THE DEVELOPER IS RESPONSIBLE TO MAINTAIN THE LID (INCLUDING LANDSCAPE) UNTIL SUCH TIME THE DEVELOPER CONNECTS ANY LID LANDSCAPE IRRIGATION TO OWNER'S IRRIGATION OF THE RESPECTIVE BUILDING LOT. DEVELOPER'S LID MAINTENANCE RESPONSIBILITIES INCLUDE BUT NOT LIMITED TO CLEANING, REPAIRING, PROTECTING AND CLEAR OF ANY DEBRIS. THE BUILDING LOT OWNER SHALL MAINTAIN IN PERPETUITY ANY LID CONSTRUCTED ANYWHERE ON THE BUILDING LOT, INCLUDING THE PARK STRIP AREA WITHIN PUBLIC RIGHT OF WAY.
- 28. WHEN A PROPOSED DEVELOPMENT BORDERS A COLLECTOR, MINOR COLLECTOR OR ARTERIAL STREET AND IS REQUIRED TO CONSTRUCT COLLECTOR STREET FENCING ALONG THE BACK OF SIDEWALK, THE DEVELOPMENT SHALL ALSO BE REQUIRED PUT IN A CONCRETE MOW STRIP FROM THE BACK OF SIDEWALK TO UNDERNEATH THE FENCE PANELS. CONCRETE MOW STRIPS SHALL ALSO BE REQUIRED BETWEEN THE SIDEWALK AND FENCING ALONG THE REAR OF DOUBLE FRONTAGE LOTS.
- 29. ONE-WAY VALVES ARE REQUIRED ON RESIDENTIAL LAND DRAIN LINES THAT GO FROM A FOUNDATION DRAIN ON A HOME TO A PUBLIC STORM DRAIN SYSTEM.

1.2 City of South Jordan Traffic Notes

- 1. WHEN A DESIGNATED "SAFE ROUTE TO SCHOOL" IS ENCROACHED UPON BY A CONSTRUCTION WORK ZONE THE SAFE ROUTE SHALL BE MAINTAINED IN A MANNER ACCEPTABLE TO SOUTH JORDAN CITY AND THE JORDAN SCHOOL DISTRICT.
- 2. IF THE IMPROVEMENTS NECESSITATE THE OBLITERATION, TEMPORARY OBSTRUCTION, TEMPORARY REMOVAL OR RELOCATION OF ANY EXISTING TRAFFIC PAVEMENT MARKING, SUCH PAVEMENT MARKING SHALL BE RESTORED OR REPLACED WITH LIKE MATERIALS TO THE SATISFACTION OF THE CITY ENGINEER, PUBLIC WORKS DIRECTOR OR DESIGNEE.
- 3. THE STREET SIGN CONTRACTOR SHALL OBTAIN STREET NAMES AND BLOCK NUMBERING FROM THE PLANNING DEPARTMENT PRIOR TO CONSTRUCTION.
- 4. THE CONTRACTOR SHALL BE RESPONSIBLE FOR PROVIDING AND INSTALLING ALL PERMANENT SIGNS SHOWN ON THE PLANS. STREET NAME SIGNS SHALL CONFORM IN THEIR ENTIRETY TO CURRENT CITY STANDARDS. ALL OTHER SIGNS SHALL BE STANDARD SIZE UNLESS OTHERWISE SPECIFIED ON THE PLANS. ALL SIGN POSTS SHALL BE INSTALLED IN ACCORDANCE WITH THE CURRENT CITY STANDARDS.
- 5. ALL PERMANENT TRAFFIC CONTROL DEVICES CALLED FOR HEREON SHALL BE IN PLACE AND IN FINAL POSITION PRIOR TO ALLOWING ANY PUBLIC TRAFFIC ONTO THE PORTIONS OF THE ROAD(S) BEING IMPROVED HEREUNDER, REGARDLESS OF THE STATUS OF COMPLETION OF PAVING OR OTHER OFF-SITE IMPROVEMENTS CALLED FOR PER APPROVED CONSTRUCTION DRAWINGS UNLESS APPROVED BY THE CITY ENGINEER.
- 6. THE CONTRACTOR SHALL BE RESPONSIBLE FOR NOTIFYING UTAH TRANSIT AUTHORITY (UTA) IF THE CONSTRUCTION INTERRUPTS OR RELOCATES A BUS STOP OR HAS AN ADVERSE EFFECT ON BUS SERVICE ON THAT STREET TO ARRANGE FOR TEMPORARY RELOCATION OF STOP.
- 7. BEFORE ANY WORK IS STARTED IN THE RIGHT-OF-WAY, THE CONTRACTOR SHALL INSTALL ALL ADVANCE WARNING SIGNS FOR THE CONSTRUCTION ZONE. THE CONTRACTOR SHALL INSTALL TEMPORARY STOP SIGNS AT ALL NEW STREET ENCROACHMENTS INTO EXISTING PUBLIC STREETS. ALL CONSTRUCTION SIGNING, BARRICADING, AND TRAFFIC DELINEATION SHALL CONFORM TO THE MANUAL OF UNIFORM TRAFFIC CONTROL DEVICES (MUTCD) PER THE CURRENT EDITION ADOPTED BY UDOT AND BE APPROVED BY THE CITY OF SOUTH JORDAN BEFORE CONSTRUCTION BEGINS.
- 8. ALL SIGNS LARGER THAN 36" X 36" OR 1296 SQUARE INCHES PER SIGN POLE SHALL BE MOUNTED ON A SLIP BASE SYSTEM PER UDOT STANDARD DRAWING SN 10B (DETAIL DRAWING ATTACHED TO STANDARD DRAWINGS) WITH A "Z" BAR BACKING. SIGNS OF THIS SIZE ARE NOT ALLOWED TO BE MOUNTED ON A YIELDING POLE.
- 9. SIGN COMPONENTS SUCH AS SHEETING, EC FILM, INKS, LETTERS AND BORDERS ARE ALL REQUIRED TO BE FROM THE SAME MANUFACTURER. ONLY EC FILM MAY BE USED TO ACHIEVE COLOR. VINYL EC FILM IS NOT ACCEPTED.
- 10. ALL NEW ROUNDABOUTS, CROSSWALKS, STOP BARS AND LEGENDS SHALL BE INSTALLED WITH 90 MIL PREFORMED THERMO PLASTIC.

 11. PAVING ASPHALT RINDER GRADE SHALL BE DG 58-28 LINI ESS OTHERWISE APPROVED BY THE CITY ENGINEER.
- 11. PAVING ASPHALT BINDER GRADE SHALL BE PG 58-28 UNLESS OTHERWISE APPROVED BY THE CITY ENGINEER. ASPHALT AGGREGATE SIZE SHALL BE ½ INCH FOR RESIDENTIAL AND COLLECTOR ROADS. NO MORE THAN 15% RAP (RECLAIMED ASPHALT PAVEMENT) BY WEIGHT WILL BE ALLOWED IN THE ASPHALT MIX DESIGN FOR THE PAVING OF PUBLIC AND PRIVATE STREETS. UP TO THE 15 PERCENT WILL BE ALLOWED WITH NO CHANGE IN THE SPECIFIC BINDER GRADE. THE ASPHALT MIX DESIGN SHALL HAVE NO MORE THAN 3½ % AIR VOIDS.
- 12. POTHOLING: ALL POTHOLES MUST BE SAW CUT SQUARE AND HAVE A MINIMUM SIZE OF 1 SQUARE FOOT. WHEN REPAIRING A POTHOLE, SAND OR PEA GRAVEL MEETING SOUTH JORDAN CITY STANDARDS SHALL BE PLACED OVER THE EXPOSED UTILITY TO A DEPTH OF 6 INCHES. FOLLOWING THE PEA GRAVEL WILL BE FLOWABLE FILL UP TO 1 INCH BELOW THE BOTTOM EDGE OF THE EXISTING ASPHALT. THE REMAINING PORTION OF THE HOLE SHALL BE FILLED WITH ASPHALT, WHICH WILL HAVE AN OVERALL THICKNESS OF THE EXISTING ASPHALT PLUS 1 INCH.
- 13. ALL FILL WITHIN THE PUBLIC RIGHT OF WAY SHALL BE A-1-A TO A-3, WITH THE EXCEPTION OF TOP SOIL IN THE PARK STRIP FOR LANDSCAPING AND TRENCH BACKFILL. TRENCH BACKFILL MATERIAL UNDER PAVEMENTS OR SURFACE IMPROVEMENTS SHALL BE CLEAN, NON-CLUMPING, GRANULAR AND FLOWABLE, 2" MINUS, A-1-A TO A-2-7 SOILS ACCORDING TO AASHTO 145 SOIL CLASSIFICATION SYSTEM. LIME TREATED FLOWABLE FILLS, IF APPROVED,
- SHALL HAVE A 28-DAY STRENGTH OF 65 PSI.

 14. ALL TRAFFIC ROAD CLOSURES INVOLVING 1 OR MORE LANES OF TRAFFIC MUST RECEIVE PRIOR APPROVAL FROM THE CITY ENGINEER OR HIS/HER REPRESENTATIVE. VMS PCMS BOARDS MUST BE PLACED A MINIMUM OF 7 DAYS IN ADVANCE OF ANY LANE CLOSURE ON COLLECTOR, MINOR COLLECTOR OR ARTERIAL STREET. VMS PCMS BOARDS MUST ALSO BE PLACED IN ADVANCE OF ANY LANE CLOSURES ON A SUBDIVISION STREET PER THE CITY ENGINEER'S DIRECTION.
- 15. ROUNDABOUTS, INCLUDING THEIR INGRESS AND EGRESS, SHALL BE CONSTRUCTED WITH CONCRETE PAVEMENT. ENGINEER SHALL DESIGN CROSS SECTION AND SUBMIT TO THE CITY FOR REVIEW AND APPROVAL.
- 16. ALLEYWAYS AND LANES ARE TO HAVE 6 FEET MAXIMUM SPACING FOR CONTROL JOINTS IN STRAIGHT SECTIONS AND ARE TO HAVE AN EXPANSION JOINT EVERY 60 FEET AND AT ALL PC'S AND PT'S.
- 17. CONSTRUCTION OF ANY PUBLIC STREET REQUIRES A SIGN OFF CHECKLIST PRIOR TO THE ROAD BEING OPENED TO TRAFFIC FOR USE BY THE GENERAL PUBLIC. THE CHECKLIST MUST BE REQUESTED BY THE DEVELOPER. THE CITY'S ASSIGNED PROJECT ENGINEER WILL PREPARE THE CHECKLIST AND PROVIDE IT TO THE DEVELOPER/CONTRACTOR.
- 18. TREES ARE NOT ALLOWED TO BE PLANTED WITHIN 30' OF A STOP SIGN.

1.3 City of South Jordan Street Light Notes

ALL WORK SHALL BE INSTALLED IN ACCORDANCE WITH THE MOST CURRENT SOUTH JORDAN CITY STANDARDS AND N.E.C. (NATIONAL ELECTRIC CODE). A STREET LIGHT PLAN SHOWING WIRING LOCATION, WIRING TYPE, VOLTAGE, POWER SOURCE LOCATION, CONDUIT SIZE AND LOCATION SHALL BE SUBMITTED TO THE CITY OF SOUTH JORDAN AND BE APPROVED PRIOR TO CONSTRUCTION. NO DEVIATION OF STREETLIGHT, PULL BOXES, CONDUITS, ETC. LOCATIONS SHALL BE PERMITTED WITHOUT PRIOR WRITTEN APPROVAL FROM THE CITY ENGINEER OR HIS/HER REPRESENTATIVE.

AN ELECTRONIC COPY OF THE STREET LIGHT REDLINES, SHOWING THE SAME ITEMS LISTED ABOVE FOR THE STREET LIGHT PLAN, SHALL BE SUBMITTED TO THE SOUTH JORDAN CITY ENGINEERING DEPARTMENT AFTER THE STREET LIGHTS HAVE BEEN INSTALLED BUT PRIOR TO THEM BEING CONNECTED BY ROCKY MOUNTAIN POWER.

1. LOCATION OF THE STREET LIGHT POLE.

- A. SHALL NOT BE INSTALLED WITHIN 5 FEET OF A FIRE HYDRANT. THE LOCATION SHALL BE SUCH THAT IT DOES NOT HINDER THE OPERATION OF THE FIRE HYDRANT AND WATER LINE OPERATION VALVES.

 B. SHALL BE A MINIMUM OF 5 FEET FROM ANY TREE, UNLESS WRITTEN APPROVAL IS RECEIVED FROM THE CITY ENGINEER. BRANCHES MAY NEED TO BE PRUNED AS DETERMINED BY THE ENGINEERING INSPECTOR IN THE FIELD AT THE TIME OF INSTALLATION.
- C. SHALL NOT BE INSTALLED WITHIN 5 FEET FROM THE EDGE OF ANY DRIVEWAY.
- ANTI-SEIZE LUBRICANT SHALL BE USED ON ALL COVER BOLTS AND GROUND BOX BOLTS.
 ALL EXISTING STREET LIGHTING SHALL REMAIN OPERATIONAL DURING CONSTRUCTION.
- 4. ANY STRUCTURE SUCH AS BLOCK WALLS, CHAIN LINK FENCES, RETAINING WALLS, ETC. SHALL LEAVE A MINIMUM OF EIGHTEEN (18) INCHES TO THE FACE OF THE STREET LIGHT POLE ON ALL SIDES.
- 5. ALL SERVICE POINT(S) SHALL BE COORDINATED WITH ROCKY MOUNTAIN POWER AND WHENEVER POSSIBLE BE LOCATED NEAR THE CENTER OF THE CIRCUIT. SERVICE POINT(S) SHALL BE SHOWN ON THE PLANS WITH A SCHEMATIC FROM ROCKY MOUNTAIN POWER. POLE LOCATIONS AS SHOWN ON THE APPROVED PLANS MAY BE ADJUSTED IN THE FIELD BY THE ENGINEERING INSPECTOR AT TIME OF INSTALLATION AT NO ADDITIONAL COST TO
- 6. IT SHALL BE REQUIRED THAT IN THE ABSENCE OF AN EXISTING WORKABLE CIRCUIT TO ATTACH TO, THAT ALL INSTALLATIONS SHALL REQUIRE A NEW SERVICE FOR OPERATION OF THE CIRCUITS IN THIS CASE DEVELOPER AND OR HIS ENGINEER SHALL CONTACT ROCKY MOUNTAIN POWER.
- 7. WHEREVER THERE IS AN OVERHEAD UTILITY THAT MAY CONFLICT WITH THE INSTALLATION OF THE STREET LIGHT CIRCUITS AND/OR STREETLIGHT POLES, THOSE CONFLICTS MUST BE RESOLVED BETWEEN THE DEVELOPER AND THE UTILITIES INVOLVED BEFORE THE STREET LIGHT BASES ARE CONSTRUCTED AT NO EXPENSE TO THE CITY OF SOUTH JORDAN OR ROCKY MOUNTAIN POWER. THE RESOLUTION MUST BE APPROVED BY THE CITY OF SOUTH JORDAN AND ROCKY MOUNTAIN POWER.
- 8. THE CONTRACTOR SHALL FURNISH A COMPLETE SERVICE TO THE TRANSFORMERS AND CONTROL SYSTEMS IF REQUIRED ON THE PLANS AND/OR IS DEEMED NECESSARY BY ROCKY MOUNTAIN POWER AND/OR SOUTH JORDAN CITY.
- 9. A STREET LIGHT PLAN SHOWING WIRING LOCATION, WIRING TYPE, VOLTAGE, POWER SOURCE LOCATION, CONDUIT SIZE AND LOCATION SHALL BE SUBMITTED TO THE CITY OF SOUTH JORDAN AND BE APPROVED PRIOR TO CONSTRUCTION.
- 10. THE CONTRACTOR SHALL BE REQUIRED TO PERFORM A 10 DAY BURN TEST OF THE STREET LIGHTS AFTER THEY ARE CONNECTED AND ENERGIZED BY ROCKY MOUNTAIN POWER. THIS TEST SHALL BE COORDINATED AND WITNESSED BY A SOUTH JORDAN ENGINEERING INSPECTOR.
- 11. EACH STREETLIGHT POLE SHALL HAVE ITS OWN PHOTO CELL INDEPENDENT OF A MASTER CONTROL. ON DOUBLE HEAD FIXTURES A SINGLE PHOTO CELL SHALL BE INSTALLED ON THE NORTH MOST FACING HEAD AND BE WIRED TO ENERGIZE BOTH HEADS.

1.4 City of South Jordan Grading Notes

- 1. IN THE EVENT THAT ANY UNFORESEEN CONDITIONS NOT COVERED BY THESE NOTES ARE ENCOUNTERED DURING GRADING OPERATIONS, THE OWNER AND CITY ENGINEER SHALL BE IMMEDIATELY NOTIFIED FOR DIRECTION.
- 2. IT SHALL BE THE RESPONSIBILITY OF THE CONTRACTOR TO PERFORM ALL NECESSARY CUTS AND FILLS WITHIN THE LIMITS OF THIS PROJECT AND THE RELATED OFF-SITE WORK, SO AS TO GENERATE THE DESIRED SUBGRADE, FINISH GRADES AND SLOPES SHOWN.
- 3. CONTRACTOR SHALL TAKE FULL RESPONSIBILITY FOR ALL EXCAVATION. ADEQUATE SHORING SHALL BE DESIGNED AND PROVIDED BY THE CONTRACTOR TO PREVENT UNDERMINING OF ANY ADJACENT FEATURES OR FACILITIES AND/OR CAVING OF THE EXCAVATION.
- 4. THE CONTRACTOR IS WARNED THAT AN EARTHWORK BALANCE WAS NOT NECESSARILY THE INTENT OF THIS PROJECT. ANY ADDITIONAL MATERIAL REQUIRED OR LEFTOVER MATERIAL FOLLOWING EARTHWORK OPERATIONS
- BECOMES THE RESPONSIBILITY OF THE CONTRACTOR.

 5. CONTRACTOR SHALL GRADE TO THE LINES AND ELEVATIONS SHOWN ON THE PLANS WITHIN THE FOLLOWING HORIZONTAL AND VERTICAL TOLERANCES AND DEGREES OF COMPACTION, IN THE AREAS INDICATED: HORIZONTAL
- VERTICAL COMPACTION

 A. PAVEMENT AREA SUBGRADE 0.1'+ +0.0' TO -0.1' SEE SOILS REPORT
- B. ENGINEERED FILL 0.5'+ +0.1' TO -0.1' SEE SOILS REPORT COMPACTION TESTING WILL BE PERFORMED BY THE DEVELOPER OR HIS REPRESENTATIVE.
- ALL CUT AND FILL SLOPES SHALL BE PROTECTED UNTIL EFFECTIVE EROSION CONTROL HAS BEEN ESTABLISHED.
 THE USE OF POTABLE WATER WITHOUT A SPECIAL PERMIT FOR BUILDING OR CONSTRUCTION PURPOSES INCLUDING CONSOLIDATION OF BACKFILL OR DUST CONTROL IS PROHIBITED. THE CONTRACTOR SHALL OBTAIN ALL NECESSARY PERMITS FOR CONSTRUCTION WATER FROM THE PUBLIC WORKS DEPARTMENT.
- 8. THE CONTRACTOR SHALL MAINTAIN THE STREETS, SIDEWALKS AND ALL OTHER PUBLIC RIGHT-OF-WAY IN A CLEAN, SAFE AND USABLE CONDITION. ALL SPILLS OF SOIL, ROCK OR CONSTRUCTION DEBRIS SHALL BE PROMPTLY REMOVED FROM THE PUBLICLY OWNED PROPERTY DURING CONSTRUCTION AND UPON COMPLETION OF THE PROJECT. ALL ADJACENT PROPERTY, PRIVATE OR PUBLIC SHALL BE MAINTAINED IN A CLEAN, SAFE AND USABLE CONDITION.
- 9. IN THE EVENT THAT ANY TEMPORARY CONSTRUCTION ITEM IS REQUIRED THAT IS NOT SHOWN ON THESE DRAWINGS, THE DEVELOPER AGREES TO PROVIDE AND INSTALL SUCH ITEM AT HIS OWN EXPENSE AND AT THE DIRECTION OF THE CITY ENGINEER. TEMPORARY CONSTRUCTION INCLUDES DITCHES, BERMS, ROAD SIGNS AND BARRICADES, ETC.
- 10. ALL GRADING WORK SHALL CONFORM TO THE SOILS REPORT AS PREPARED BY THE SOILS ENGINEER AND APPROVED BY THE CITY ENGINEER, AND AS SHOWN ON THESE PLANS.

1.5 City of South Jordan Fire Department Notes

- 1. ON ANY NEW HOME OR BUILDING INSTALLATION, ACCESSIBLE FIRE HYDRANTS SHALL BE INSTALLED BEFORE COMBUSTIBLE CONSTRUCTION COMMENCES AND SAID FIRE HYDRANTS SHALL BE IN GOOD WORKING ORDER WITH AN ADEQUATE WATER SUPPLY.
- 2. CONTRACTOR SHALL CALL THE PUBLIC WORKS DEPARTMENT AND ENGINEERING INSPECTOR FOR UNDERGROUND INSPECTION, PRESSURE AND FLUSH VERIFICATION OF ALL FIRE HYDRANTS AND FIRE LINES BEFORE BACK FILLING.
- INSPECTION, PRESSURE AND FLUSH VERIFICATION OF ALL FIRE HYDRANTS AND FIRE LINES BEFORE BACK FILLING.

 3. PAINTING OF THE CURBS AND HYDRANT AND ANY WORK NECESSARY FOR PROTECTION OF HYDRANTS FROM PHYSICAL DAMAGE SHALL BE APPROVED BEFORE BEING CONSTRUCTED.
- A FLOW TEST MUST BE WITNESSED BY THE FIRE DEPARTMENT PRIOR TO OCCUPANCY FOR VERIFICATION OF REQUIRED ON-SITE WATER SUPPLY.
- 5. ALL ON-SITE FIRE MAIN MATERIALS MUST BE U.L. LISTED AND A.W.W.A. APPROVED.
- 6. THE TURNING RADIUS FOR ANY FIRE APPARATUS ACCESS ROAD AND/OR FIRE LANE, PUBLIC OR PRIVATE, SHALL BE NOT LESS THAN FORTY-FIVE FEET (45') OUTSIDE RADIUS AND TWENTY-TWO FEET (22') INSIDE RADIUS AND SHALL BE PAVED.
- 7. A FIRE APPARATUS ROAD SHALL BE REQUIRED WHEN ANY PORTION OF AN EXTERIOR WALL OF THE FIRST STORY IS LOCATED MORE THAN ONE-HUNDRED FIFTY FEET (150') FROM FIRE DEPARTMENT VEHICLE ACCESS ROADS AND/OR FIRE LANES, PUBLIC OR PRIVATE, IN EXCESS OF ONE-HUNDRED FIFTY FEET (150') IN LENGTH SHALL BE PROVIDED WITH AN APPROVED TURN AROUND AREA.
- 8. ACCESS ROADS SHALL BE MARKED BY PLACING APPROVED SIGNS AT THE START OF THE DESIGNATED FIRE LANE, ONE SIGN AT THE END OF THE FIRE LANE AND WIDTH SIGNS AT INTERVALS OF ONE-HUNDRED FEET (100') ALONG ALL DESIGNATED FIRE LANES. SIGNS TO BE PLACED ON BOTH SIDES OF AN ACCESS ROADWAY IF NEEDED TO PREVENT PARKING ON EITHER SIDE. SIGNS SHALL BE INSTALLED AT LEAST 5', MEASURED FROM THE BOTTOM EDGE OF THE SIGN TO THE NEAR EDGE OF PAVEMENT. WHERE PARKING OR PEDESTRIAN MOVEMENTS OCCUR, THE CLEARANCE TO THE BOTTOM OF THE SIGN SHALL BE AT LEAST 7'. THE CURB ALONG OR ON THE PAVEMENT OR CEMENT IF CURB IS NOT PRESENT, SHALL BE PAINTED WITH RED WEATHER RESISTANT PAINT IN ADDITION TO THE
- ELECTRICALLY CONTROLLED ACCESS GATES SHALL BE PROVIDED WITH AN APPROVED EMERGENCY VEHICLE
 DETECTOR/RECEIVER SYSTEM. SAID SYSTEM SHALL BE INSTALLED IN ACCORDANCE WITH THE SOUTH JORDAN CITY
 F.D. APPROVAL. GATES ARE ONLY ALLOWED WITH PRIOR APPROVAL.
- ALL UNDERGROUND FIRE LINES THAT SERVICE AUTOMATIC FIRE SPRINKLER SYSTEMS SHALL BE NO SMALLER THAN SIX (6) INCHES IN DIAMETER AND HAVE A PIV BETWEEN THE WATER MAIN AND THE BUILDING. IF A PIV ISN'T FEASIBLE DUE TO SITE CONSTRAINTS, A WIV MAY BE USED WITH THE APPROVAL OF THE CITY ENGINEER OR FIRE CODE OFFICIAL. FOR A WIV TO BE ALLOWED, ANOTHER VALVE MUST BE INSTALLED ON THE FIRE SERVICE LINE BACK AT THE CONNECTION TO THE WATER MAIN, WHICH WILL BE MAINTAINED BY THE CITY AS PART OF IT'S CULINARY WATER SYSTEM. ALL FIRE LINES MATERIAL SHALL BE DUCTILE IRON. (DUCTILE IRON FROM THE PIV TO THE BUILDING SHALL BE PERMITTED OR DUCTILE IRON FROM THE MAIN WATER LINE TO THE WIV).
 POST INDICATOR VALVES (PIV) SHALL BE BETWEEN 6 AND 40 FEET FROM BUILDINGS NOT EXCEEDING THREE
- 11. POST INDICATOR VALVES (PIV) SHALL BE BETWEEN 6 AND 40 FEET FROM BUILDINGS NOT EXCEEDING THREE STORIES OR EQUIVALENT IN HEIGHT AND BETWEEN 30 AND 40 FEET ON BUILDINGS IN EXCESS OF THREE OR MORE STORIES IN HEIGHT OR EQUIVALENT.
- 12. ROADS AND ACCESSES SHALL BE DESIGNED AND MAINTAINED TO SUPPORT THE IMPOSED LOADS OF FIRE APPARATUS. SURFACE SHALL BE PAVED BEFORE THE APPLICATION OF COMBUSTIBLE MATERIAL.
- 13. ALL NEW BUILDINGS EQUIPPED WITH A FIRE DEPARTMENT CONNECTION (FDC) MUST HAVE INLETS SECURED WITH KNOX BRAND LOCKING FDC CAP(S) WITH A SWIVEL COLLAR. ALL NEW BUILDINGS ARE ALSO REQUIRED TO HAVE A KNOX BRAND KEY LOCK BOX MOUNTED ON THE EXTERIOR BUILDING, SUCH THAT FIRE DEPARTMENT PERSONNEL MAY GAIN ACCESS IN CASE OF AN EMERGENCY.

1.6 South Jordan City Water Notes

- 1. THE FOLLOWING SOUTH JORDAN CITY WATER NOTES ARE INTENDED FOR GENERAL WATER STANDARDS ONLY AND ARE NOT ALL INCLUSIVE. THE CITY HAS INCLUDED THE CULINARY WATER DESIGN AND CONSTRUCTION STANDARDS WITHIN THE CITY CONSTRUCTION STANDARDS AND SPECIFICATIONS.
- 2. NO WORK SHALL BEGIN UNTIL THE WATER PLANS HAVE BEEN RELEASED FOR CONSTRUCTION BY THE ENGINEERING DEPARTMENT. FOLLOWING WATER PLAN APPROVAL, FORTY-EIGHT (48) HOUR NOTICE SHALL BE GIVEN TO THE ENGINEERING INSPECTOR AND THE PUBLIC WORKS DEPARTMENT (253- 5230) PRIOR TO THE START OF CONSTRUCTION. NOTICE MUST BE GIVEN BY 2:00 P.M. THE BUSINESS DAY PRIOR TO AN INSPECTION.
- 3. ALL WORK WITHIN SOUTH JORDAN CITY SHALL CONFORM TO SOUTH JORDAN CITY STANDARDS AND SPECIFICATIONS, AWWA AND APWA.
- 4. FOR RESIDENTIAL DEVELOPMENTS THE DEVELOPER SHALL PURCHASE AND INSTALL METER BOXES AND SETTERS ACCORDING TO CITY STANDARDS ON NEWLY DEVELOPED LOTS AND REAL PROPERTY AT THE TIME OF WATER MAIN INSTALLATION. WATER METERS WILL BE SUPPLIED AND INSTALLED BY THE SOUTH JORDAN PUBLIC WORKS DEPARTMENT (AT DEVELOPER'S EXPENSE). THE DEVELOPER SHALL ALSO PROVIDE THE SITE ADDRESS, LOT NUMBER, METER SIZE AND PAY METER FEES PRIOR TO BUILDING PERMIT APPROVAL.
- 5. FOR COMMERCIAL AND CONDOMINIUM DEVELOPMENTS THE DEVELOPER SHALL PURCHASE AND INSTALL METER BOXES AND SETTERS ACCORDING TO CITY STANDARDS. WATER METERS WILL BE SUPPLIED BY SOUTH JORDAN PUBLIC WORKS DEPARTMENT (AT DEVELOPER'S EXPENSE) AND INSTALLED BY DEVELOPER.
- 6. ALL WATER FACILITIES SHALL BE FILLED, DISINFECTED, PRESSURE TESTED, FLUSHED, FILLED AND AN ACCEPTABLE WATER SAMPLE OBTAINED PRIOR TO COMMISSIONING THE NEW WATER LINE TO THE SOUTH JORDAN CITY CULINARY WATER DISTRIBUTION SYSTEM.
- 7. SOUTH JORDAN PUBLIC WORKS DEPARTMENT MUST APPROVE WATER SHUT DOWN WHICH MAY REQUIRE EVENING AND WEEKEND SHUT DOWN AS DEEMED NECESSARY, REQUIRING THE CONTRACTOR TO BE BILLED FOR OVERTIME. 48 HOUR NOTICE IS REQUIRED.
- WATER STUB-OUT INSTALLATIONS WILL NOT BE CONSTRUED AS A COMMITMENT FOR WATER SERVICE.
 CONDITIONAL APPROVAL OF VALVED OUTLET (6" AND LARGER): IN THE EVENT THE WATER PLANS SHOW ONE OR MORE VALVED OUTLETS EXTENDING OUT OF PAVED AREAS, INSTALLATIONS OF THESE OUTLETS IS ACCEPTABLE, HOWEVER, IF THE OUTLETS ARE INCORRECTLY LOCATED OR NOT USED FOR ANY REASON WHEN THE PROPERTY IS DEVELOPED, THE DEVELOPER SHALL ABANDON THE OUTLETS AT THE CONNECTION TO THE ACTIVE MAIN IN ACCORDANCE WITH THE CITY STANDARDS AND AT THE DEVELOPER'S EXPENSE.

1.6 South Jordan City Water Notes (cont'd)

PRE-ENGINEERED AND RECEIVE PRIOR CITY APPROVAL.

VEHICLES MUST BE PAID IN ADVANCE.

- 11. ALL FITTINGS TO BE COATED WITH POLY FM GREASE AND WRAPPED WITH 8-MIL THICK POLYETHYLENE.
- 12. NO OTHER UTILITY LINES MAY BE PLACED IN THE SAME TRENCH WITH WATER LINE UNLESS APPROVED BY THE CITY ENGINEER.

 13. ANY CONFLICT WITH EXISTING LITERIES SHALL BE IMMEDIATELY CALLED TO THE ATTENTION OF THE CITY.
- ENGINEER.

 13. ANY CONFLICT WITH EXISTING UTILITIES SHALL BE IMMEDIATELY CALLED TO THE ATTENTION OF THE CITY ENGINEER OR DESIGNEE.
- 14. ALL WATER VAULTS WILL BE CONSTRUCTED PER CITY OF SOUTH JORDAN STANDARD DRAWINGS AND
- SPECIFICATIONS. NO VAULTS ARE ALLOWED IN TRAFFIC AREAS WITHOUT PRIOR APPROVAL OF THE CITY ENGINEER.

 15. LANDSCAPING AND IRRIGATION ADJACENT TO VAULTS SHALL DRAIN AWAY FROM VAULTS.
- 16. ONCE THE WATERLINE HAS BEEN TESTED, APPROVED AND CITY WATER IS FLOWING THROUGH THE PIPE, ONLY CITY PERSONNEL ARE AUTHORIZED TO SHUT DOWN AND CHARGE THE WATERLINE.
- MEGALUG FOLLOWING RING OR AN APPROVED EQUIVALENT SHALL BE USED ON ALL FITTINGS.
 APWA PLAN 562, CITY REQUIRES STAINLESS STEEL TIE-DOWN RESTRAINTS WITH TURNBUCKLES ONLY. 5/8" REBAR IS NOT ACCEPTABLE. MEGALUG FOLLOWERS REQUIRED ON ALL FITTINGS AND ALL DIMENSIONS OF THRUST BLOCKING STILL APPLY. THRUST BLOCKS MAY BE ELIMINATED IF HORIZONTAL TIE DOWN RESTRAINTS HAVE BEEN
- 19. WATER MAINS WILL BE HOT TAPPED AS CALLED OUT ON THE APPROVED PLANS. UNDER SPECIAL CIRCUMSTANCES, WHEN A CONTRACTOR SUBMITS A REQUEST FOR A SHUTDOWN CONTRARY TO THE APPROVED PLANS AND THE REQUEST IS APPROVED AT THE DISCRETION OF THE CITY ENGINEER OR DESIGNEE, THE CONTRACTOR MUST PROVIDE 48-HOUR NOTICE TO NEIGHBORS AND THOSE AFFECTED. IF BUSINESSES ARE IMPACTED BY THE SHUTDOWN IT WILL BE DONE AFTER HOURS AND ALL OVERTIME FEES FOR CITY PERSONNEL, EQUIPMENT AND
- 20. CONTRACTORS ARE REQUIRED TO WRITE THE LOT NUMBER WITH A BLACK PERMANENT MARKER ON THE INSIDE OF THE WATER METER BARRELS AS THEY ARE INSTALLED.



Syracuse, UT 84075

PH: 801.664.4724



2 06-22-2023 REVISED PER CITY COMMENTS T
1 04-19-2023 REVISED PER CITY COMMENTS T
0 03-08-2023 INITIAL SUBMITTAL T

REV. DATE DESCRIPTION B

ENGINEERS STAMP



IF NOT ONE INCH ON THIS SHEET, ADJUST

SCALES ACCORDINGLY

PROJECT INFO.

Engineer: T. Hunt

Drawn: T. Pridemore

Checked:
Date: 12 / 09 / 2022

SHEET TITLE

S. Jordan

SHEET NO.

C002

Note: THE SOUTH JORDAN CITY STANDARD NOTES ARE REQUIRED TO BE INCLUDED AS PART OF ALL CONSTRUCTION PLANS FOR RESIDENTIAL OR COMMERCIAL DEVELOPMENT. PLANS SUBMITTED

CONSTRUCTION PLANS FOR RESIDENTIAL OR COMMERCIAL DEVELOPMENT. PLANS SUBMITTED BY PUBLIC OR PRIVATE ENTITIES FOR ALL OTHER TYPES OF PROJECTS WITHIN CITY RIGHT-OF-WAY, ITS EASEMENTS OR PROPERTY SHALL REFERENCE THE SOUTH JORDAN CITY STANDARD NOTES AND SPECIFICATIONS.

- 1.1 ALL WORK TO CONFORM TO GOVERNING MUNICIPALITY'S STANDARDS, SPECIFICATIONS AND REQUIREMENTS.
- 1.2 ALL CONSTRUCTION AND MATERIALS SHALL BE IN ACCORDANCE WITH THESE CONTRACT DOCUMENTS AND THE MOST RECENT, ADOPTED EDITIONS OF THE FOLOWING:
- INTERNATIONAL BUILDING CODES (IBC)
- INTERNATIONAL PLUMBING CODES
- STATE DRINKING WATER REGULATIONS - APWA MANUAL OF STANDARD PLANS AND SPECIFICATIONS
- ADA ACCESSIBILITY GUIDELINES. ALL CONSTRUCTION SHALL BE AS SHOWN ON THESE PLANS, ANY REVISIONS MUST HAVE PRIOR

2.0 PERMITTING AND INSPECTIONS

WRITTEN APPROVAL

- 2.1 PRIOR TO STARTING CONSTRUCTION, THE CONTRACTOR SHALL BE RESPONSIBLE FOR MAKING SURE THAT ALL REQUIRED PERMITS AND APPROVALS HAVE BEEN OBTAINED. NO CONSTRUCTION OR FABRICATION SHALL BEGIN UNTIL THE CONTRACTOR HAS RECEIVED THOROUGHLY REVIEWED PLANS AND OTHER DOCUMENTS APPROVED BY ALL OF THE PERMITTING AUTHORITIES.
- 2.2 CONTRACTOR IS RESPONSIBLE FOR SCHEDULING AND NOTIFYING ARCHITECT/ENGINEER OR INSPECTING AUTHORITY 48 HOURS IN ADVANCE OF COVERING UP ANY PHASE OF CONSTRUCTION
- REOUIRING OBSERVATION. ANY WORK IN THE PUBLIC RIGHT-OF-WAY WILL REQUIRE PERMITS FROM THE APPROPRIATE CITY, COUNTY OR STATE

3.0 COORDINATION AND VERIFICATION

- 3.1 ALL DIMENSIONS, GRADES & UTILITY DESIGNS SHOWN ON THE PLANS SHALL BE VERIFIED BY THE CONTRACTOR PRIOR TO CONSTRUCTION. CONTRACTOR SHALL NOTIFY ARCHITECT/ENGINEER OF ANY DISCREPANCIES PRIOR TO PROCEEDING WITH CONSTRUCTION FOR NECESSARY PLAN OR GRADE CHANGES. NO EXTRA COMPENSATION SHALL BE PAID TO THE CONTRACTOR FOR WORK HAVING TO BE REDONE DUE TO THE DIMENSIONS OR GRADES SHOWN INCORRECTLY ON THESE PLANS, IF NOT VERIFIED AND NOTIFICATION OF CONFLICTS HAVE NOT BEEN BROUGHT TO THE ATTENTION OF THE ARCHITECT/ENGINEER.
- CONTRACTOR MUST VERIFY ALL EXISTING CONDITIONS BEFORE BIDDING AND BRING UP ANY
- QUESTIONS BEFOREHAND. NO ALLOWANCE WILL BE MADE FOR DISCREPANCIES OR OMISSIONS THAT CAN BE EASILY
- CONTRACTOR TO COORDINATE WITH ALL OTHER DISCIPLINES, INCLUDING BUT NOT LIMITED TO:
- LANDSCAPE PLANS

AGENCY CONTROLLING THE ROAD AND WITH APPROPRIATE INSPECTIONS.

- SITE ELECTRICAL PLANS AND ELECTRICAL SERVICE TO THE BUILDING(S)
- FIRE PROTECTION - ARCHITECTURAL SITE PLANS
- ACCESSIBLE ROUTES
- CONTRACTOR IS TO COORDINATE LOCATION OF NEW TELEPHONE SERVICE, GAS SERVICE, CABLE, ETC. TO BUILDING WITH THE APPROPRIATE UTILITY COMPANY. FOR TELEPHONE, CONTRACTOR TO FURNISH CONDUIT, PLYWOOD BACKBOARD, AND GROUND WIRE, AS REQUIRED.

- CONTRACTOR IS SOLELY RESPONSIBLE FOR THE MEANS AND METHODS OF CONSTRUCTION.
- CONTRACTOR IS RESPONSIBLE FOR THE SAFETY OF THE PROJECT AND SHALL MEET ALL OSHA REQUIREMENTS. CONTRACTOR IS RESPONSIBLE FOR CONFORMING TO LOCAL AND FEDERAL CODES GOVERNING
- SHORING AND BRACING OF EXCAVATIONS AND TRENCHES, AND FOR THE PROTECTION OR WORKERS AND PUBLIC.
- CONTRACTOR SHALL TAKE ALL MEASURES NECESSARY TO PROTECT ALL EXISTING PUBLIC AND
- PRIVATE PROPERTY, ROADWAYS, AND UTILITY IMPROVEMENTS. DAMAGE TO EXISTING IMPROVEMENTS CAUSED BY THE CONTRACTOR MUST BE REPAIRED BY THE CONTRACTOR AT HIS/HER EXPENSE TO THE SATISFACTION OF THE OWNER OF SAID IMPROVEMENTS.
- CONTRACTOR IS REQUIRED TO KEEP ALL CONSTRUCTION ACTIVITIES WITHIN THE APPROVED PROJECT LIMITS. THIS INCLUDES, BUT IS NOT LIMITED TO, VEHICLE AND EQUIPMENT STAGING,
- MATERIAL STORAGE AND LIMITS OF TRENCH EXCAVATION.
- 4.6 IT IS THE CONTRACTOR'S RESPONSIBILITY TO OBTAIN PERMISSION AND/OR EASEMENTS FROM THE APPROPRIATE GOVERNMENT AGENCY AND/OR INDIVIDUAL PROPERTY OWNER(S) FOR WORK OR STAGING OUTSIDE OF THE PROJECT
- 4.7 CONTRACTOR SHALL PROVIDE BARRICADES, SIGNS, FLASHERS, OTHER EQUIPMENT AND FLAG PERSONS NECESSARY TO INSURE THE SAFETY OF WORKERS AND VISITORS. ALL CONSTRUCTION SIGNING, BARRICADING, AND TRAFFIC DELINEATION SHALL CONFORM TO THE "MANUAL ON UNIFORM
- TRAFFIC CONTROL DEVICES", LATEST EDITION. 4.8 CONTRACTOR SHALL COMPLY WITH LOCAL NOISE ORDINANCE STANDARDS.
- 4.9 CONTRACTOR IS RESPONSIBLE FOR DUST CONTROL ACCORDING TO GOVERNING AGENCY STANDARDS.
- 4.10 CONTRACTOR SHALL TAKE ALL NECESSARY AND PROPER PRECAUTIONS TO PROTECT ADJACENT
- PROPERTIES FROM ANY AND ALL DAMAGE THAT MAY OCCUR FROM STORM WATER RUNOFF AND/OR DEPOSITION OF DEBRIS RESULTING FROM ANY AND ALL WORK IN CONNECTION WITH CONSTRUCTION. SUBMIT A STORM WATER POLLUTION PREVENTION PLAN, IF REQUIRED.
- 4.11 WORK IN PUBLIC STREETS, ONCE BEGUN, SHALL BE PROSECUTED TO COMPLETION WITHOUT DELAY AS TO PROVIDE MINIMUM INCONVENIENCE TO ADJACENT PROPERTY OWNERS AND TO THE TRAVELING PUBLIC.
- 4.12 CONTRACTOR SHALL PROVIDE ALL NECESSARY HORIZONTAL AND VERTICAL TRANSITIONS BETWEEN NEW CONSTRUCTION AND EXISTING SURFACES TO PROVIDE FOR PROPER DRAINAGE AND FOR INGRESS AND EGRESS TO NEW CONSTRUCTION.
- 4.13 NATURAL VEGETATION AND SOIL COVER SHALL NOT BE DISTURBED PRIOR TO ACTUAL
- CONSTRUCTION OF A REQUIRED FACILITY OR IMPROVEMENT. MASS CLEARING OF THE SITE IN ANTICIPATION OF CONSTRUCTION SHALL BE AVOIDED. CONSTRUCTION TRAFFIC SHALL BE LIMITED TO ONE APPROACH TO THE SITE. THE APPROACH SHALL BE DESIGNATED BY THE OWNER OR GOVERNING AGENCY.
- 4.14 THE CONTRACTOR SHALL TAKE REASONABLE MEASURES TO PROTECT EXISTING IMPROVEMENTS FROM DAMAGE AND ALL SUCH IMPROVEMENTS DAMAGED BY THE CONTRACTOR'S OPERATION SHALL BE

REPAIRED OR RECONSTRUCTED TO THE ENGINEER/OWNER'S SATISFACTION AT THE EXPENSE OF THE CONTRACTOR.

5.0 MATERIALS

- 5.1 SITE CONCRETE SHALL BE A MINIMUM 6.5 BAG MIX, 4000 P.S.I. @ 28 DAYS, 4" MAXIMUM SLUMP WITH 5 + OR -1% AIR ENTRAINMENT, UNLESS SPECIFIED OTHERWISE. SEE SPECIFICATION:
- SLABS-ON-GRADE WILL BE TYPICALLY SCORED (1/4 THE DEPTH) AT INTERVALS NOT TO EXCEED THEIR WIDTH OR 12 TIMES THEIR DEPTH, WHICHEVER IS LESS. SCORING WILL BE PLACED TO PREVENT RANDOM CRACKING. FULL DEPTH EXPANSION JOINTS WILL BE PLACED AGAINST ANY OBJECT DEEMED TO BE FIXED, CHANGES IN DIRECTION AND AT EQUAL
- INTERVALS NOT TO EXCEED 50 FEET. - CONCRETE WATERWAYS, CURBWALLS, MOWSTRIPS, CURB AND GUTTER, ETC. WILL TYPICALLY BE SCORED 1/4 THE DEPTH AT INTERVALS NOT TO EXCEED 10 FEET AND HAVE FULL DEPTH EXPANSION JOINTS AT EQUAL SPACING NOT TO EXCEED 50
- UNLESS OTHERWISE NOTED, ALL SLABS-ON-GRADE WILL HAVE A MINIMUM 8" TURNED-DOWN EDGE TO HELP CONTROL
- UNLESS OTHERWISE NOTED, ALL ON-GRADE CONCRETE WILL BE PLACED ON A MINIMUM 4" GRAVEL BASE OVER A WELL COMPACTED (90%) MIN. SUBGRADE. ALL EXPOSED SURFACES WILL HAVE A TEXTURED FINISH, RUBBED OR BROOMED. ANY "PLASTERING" OF NEW CONCRETE WILL BE DONE WHILE IT IS STILL "GREEN."
- ALL JOINTS (CONTROL, CONSTRUCTION OR EXPANSION JOINTS, ETC.) WILL BE SEALED WITH A ONE PART POLYURETHANE
- 5.2 ASPHALT CONCRETE PAVEMENT SHALL BE A MINIMUM 3" OVER 6" OF COMPACTED (95%) ROAD BASE OVER PROPERLY PREPARED AND COMPACTED (90%) SUBGRADE, UNLESS NOTED OTHERWISE. ASPHALT COMPACTION SHALL BE A MINIMUM 96%.
- SURFACE COARSE SHALL BE 1/2" MINUS. MIX DESIGN TO BE SUBMITTED FOR APPROVAL AT LEAST TWO WEEKS PRIOR TO ANTICIPATED PAVING SCHEDULE.
- AC PAVEMENT TO BE A 1/4" ABOVE LIP OF ALL GUTTER AFTER COMPACTION.
- THICKNESS OVER 3" WILL BE LAID IN TWO LIFTS WITH THE FIRST LIFT BEING AN APPROVED 3/4" MINUS DESIGN.

- SITE GRADING SHALL BE PERFORMED IN ACCORDANCE WITH THESE PLANS AND SPECIFICATIONS AND THE RECOMMENDATIONS SET FORTH IN THE SOILS REPORT, WHICH BY REFERENCE ARE A PART OF THE REQUIRED CONSTRUCTION DOCUMENTS AND IN CASE OF CONFLICT SHALL TAKE PRECEDENCE, UNLESS SPECIFICALLY NOTED OTHERWISE ON THE PLANS, OR IN THE SPECIFICATIONS. THE CONTRACTOR SHALL NOTIFY THE ENGINEER OF RECORD OF ANY DISCREPANCY BETWEEN THE SOILS REPORT AND THESE PLANS AND SPECIFICATIONS.
- THE CONTRACTOR SHALL BE RESPONSIBLE FOR REMOVING AND REPLACING ALL SOFT, YIELDING OR UNSUITABLE MATERIALS AND REPLACING WITH SUITABLE MATERIALS AS SPECIFIED IN THE SOILS REPORT.
- ALL EXCAVATED OR FILLED AREAS SHALL BE COMPACTED TO 95% OF MODIFIED PROCTOR MAXIMUM DENSITY PER ASTM TEST D-1557, EXCEPT UNDER BUILDING FOUNDATIONS WHERE IT SHALL BE 98% MIN. OF MAXIMUM DENSITY. MOISTURE CONTENT AT TIME OF PLACEMENT SHALL NOT EXCEED 2% ABOVE NOR 3% BELOW OPTIMUM.
- CONTRACTOR SHALL SUBMIT A COMPACTION REPORT PREPARED BY A QUALIFIED REGISTERED SOILS ENGINEER, VERIFYING THAT ALL FILLED AREAS AND SUBGRADE AREAS WITH THE BUILDING PAD AREA AND AREAS TO BE PAVED, HAVE BEEN COMPACTED IN ACCORDANCE WITH THESE PLANS AND SPECIFICATIONS AND THE RECOMMENDATIONS SET FORTH IN THE SOILS REPORT.
- SITE CLEARING SHALL INCLUDE THE LOCATING AND REMOVAL OF ALL UNDERGROUND TANKS, PIPES, VALVES, ETC.
- ALL EXISTING VALVES, MANHOLES, ETC. SHALL BE RAISED OR LOWERED TO GRADE AS REQUIRED.

7.0 UTILITIES

- THE LOCATIONS OF UNDERGROUND FACILITIES SHOWN ON THESE PLANS ARE BASED ON FIELD
 - SURVEYS AND LOCAL UTILITY COMPANY RECORDS. IT SHALL BE THE CONTRACTOR'S FULL RESPONSIBILITY TO CONTACT THE VARIOUS UTILITY COMPANIES EITHER DIRECT OR THROUGH BLUE STAKE TO LOCATE THEIR FACILITIES PRIOR TO STARTING CONSTRUCTION.
- CONTRACTOR TO VERIFY BY POTHOLING BOTH THE VERTICAL AND HORIZONTAL LOCATION OF ALL EXISTING UTILITIES PRIOR TO INSTALLING ANY NEW LINES, NOT ADDITIONAL COMPENSATION SHALL BE PAID TO THE
- CONTRACTOR FOR DAMAGE AND REPAIR TO THESE FACILITIES CAUSED BY HIS WORK FORCE CONTRACTOR MUST START AT LOW END OF ALL NEW GRAVITY UTILITY LINES. MECHANICAL SUB-CONTRACTOR MUST BE PROVIDED CIVIL SITE DRAWINGS FOR COORDINATION AND TO CHECK THE FLOW FROM THE LOWER POINT IN BUILDING TO THE FIELD VERIFIED CONNECTION AT THE EXISTING MAIN. NO EXTRA COMPENSATION IS TO BE PAID TO THE
- CONTRACTOR FOR WORK HAVING TO BE REDONE DUE TO FAILURE TO COMPLY WITH THESE REQUIREMENTS. 7.4 CONTRACTOR IS TO VERIFY LOCATION, DEPTH, SIZE, TYPE, AND OUTSIDE DIAMETERS OF UTILITIES IN THE FIELD BY POTHOLING A MINIMUM OF 300 FEET AHEAD, PIPELINE CONSTRUCTION TO AVOID CONFLICTS WITH DESIGNED PIPELINE GRADE AND ALIGNMENT. EXISTING UTILITY INFORMATION SHOWN ON PLANS OR OBTAINED FROM UTILITY COMPANIES OR BLUE STAKED MUST BE ASSUMED AS APPROXIMATE, REQUIRING FIELD VERIFICATION.
- 7.5 CULINARY WATER AND FIRE SERVICE LINES TO BE CONSTRUCTED IN ACCORDANCE WITH LOCAL GOVERNING MUNICIPALITY STANDARDS AND SPECIFICATIONS.
- SANITARY SEWER MAINS AND LATERALS TO BE CONSTRUCTED IN ACCORDANCE WITH LOCAL GOVERNING MUNICIPALITY SEWER DISTRICT STANDARDS AND SPECIFICATIONS.
- STORM SEWER TO BE CONSTRUCTED IN ACCORDANCE WITH THE GOVERNING MUNICIPALITY STANDARDS AND
- ALL STORM DRAIN AND IRRIGATION CONDUITS SHALL BE INSTALLED WITH WATER TIGHT JOINTS AND CONNECTIONS.
- ALL STORM DRAIN PIPE PENETRATIONS INTO BOXES SHALL BE CONSTRUCTED WITH WATER TIGHT SEALS ON THE OUTSIDE AND GROUTED SMOOTH WITH A NON-SHRINK GROUT ON THE INSIDE. CONDUITS SHALL BE CUT OFF FLUSH
- 7.10 NO CHANGE IN THE DESIGN OF UTILITIES AS SHOWN WILL BE MADE BY THE CONTRACTOR WITHOUT THE WRITTEN
- APPROVAL OF THE GOVERNING MUNICIPALITY, OR AUTHORITY HAVING JURISDICTION OVER THAT UTILITY. ALL STORM DRAIN CONDUITS AND BOXES SHALL BE CLEAN AND FREE OF ROCKS, DIRT, AND CONSTRUCTION DEBRIS PRIOR TO FINAL INSPECTION.

8.0 SURVEY CONTROL

- 8.1 CONTRACTOR MUST PROVIDE A REGISTERED LAND SURVEY OR PERSONS UNDER THE SUPERVISION OF A REGISTERED LAND SURVEYOR TO SET STAKES FOR THE ALIGNMENT AND GRADE OF EACH MAIN AND/OR FACILITY AS SHOWN ON THE PLANS. THE STAKES SHALL BE MARKED WITH THE HORIZONTAL LOCATION (STATION) AND VERTICAL LOCATION (GRADE) WITH CUTS AND/OR FILLS TO THE APPROVED GRADE OF THE MAIN AND OR FACILITY AS SHOWN ON THE PLANS.
- THE CONTRACTOR SHALL PROTECT ALL STAKES AND MARKERS FOR VERIFICATION PURPOSES. CONTRACTOR WILL BE RESPONSIBLE FOR FURNISHING, MAINTAINING, OR RESTORING ALL MONUMENTS AND REFERENCE MARKS WITHIN THE PROJECT SITE.

- 9.1 PEDESTRIAN / ADA ROUTES SHALL MEET THE FOLLOWING SPECIFICATIONS:
 - ROUTES SHALL HAVE A 2.00% (1:50) MAXIMUM CROSS SLOPE.
 - ROUTES SHALL HAVE A 5.00% (1:20) MAXIMUM RUNNING SLOPE RAMPS SHALL HAVE A 8.33% (1:12) MAXIMUM RUNNING SLOPE.
- ADA PARKING STALLS AND ADJACENT ROUTES SHALL HAVE A 2.00% MAXIMUM SURFACE SLOPE IN ANY DIRECTION.
- THE CONTRACTOR SHALL ADHERE TO THE ABOVE SPECIFICATIONS. IN THE EVENT OF A DISCREPANCY IN THE CONSTRUCTION DOCUMENTS, THE CONTRACTOR SHALL NOTIFY THE ARCHITECT/ENGINEER PRIOR TO ANY CONSTRUCTION.

10.0 EROSION CONTROL

- 10.1 THE CONTRACTOR TO USE BEST MANAGEMENT PRACTICES FOR PROVIDING EROSION CONTROL FOR CONSTRUCTION OF THIS PROJECT. ALL MATERIAL AND WORKMANSHIP SHALL CONFORM TO GOVERNING AGENCIES ORDINANCES AND ALL WORK SHALL BE SUBJECT TO INSPECTION BY THE COUNTIES. ALSO, INSPECTORS WILL HAVE THE RIGHT TO CHANGE THE FACILITIES AS NEEDED.
- 10.2 CONTRACTOR SHALL KEEP THE SITE WATERED TO CONTROL DUST. CONTRACTOR TO LOCATE A NEARBY HYDRANT FOR USE AND TO INSTALL TEMPORARY METER. CONSTRUCTION WATER COST TO BE INCLUDED IN BID.
- 10.3 WHEN GRADING OPERATIONS ARE COMPLETED AND THE DISTURBED GROUND IS LEFT "OPEN" FOR 14 DAYS OR MORE,
- THE AREA SHALL BE FURROWED PARALLEL TO THE CONTOURS. 10.4 THE CONTRACTOR SHALL MODIFY EROSION CONTROL MEASURES TO ACCOMMODATE PROJECT PLANNING.
- 10.5 ALL ACCESS TO PROPERTY WILL BE FROM PUBLIC RIGHT-OF-WAYS. THE CONTRACTOR IS REQUIRED BY STATE AND FEDERAL REGULATIONS TO PREPARE A STORM WATER POLLUTION PREVENTION.

11.0 MAINTENANCE

- 11.1 ALL BEST MANAGEMENT PRACTICES (BMP'S) SHOWN ON THIS PLAN MUST BE MAINTAINED AT ALL TIMES UNTIL PROJECT
- 11.2 THE CONTRACTOR'S RESPONSIBILITY SHALL INCLUDE MAKING BI-WEEKLY CHECKS ON ALL EROSION CONTROL MEASURES TO DETERMINE IF REPAIR OR SEDIMENT REMOVAL IS NECESSARY. CHECKS SHALL BE DOCUMENTED AND COPIES OF THE INSPECTIONS KEPT ON SITE.
- 11.3 SEDIMENT DEPOSITS SHOULD BE REMOVED AFTER EACH RAINFALL. THEY MUST BE REMOVED WHEN THE LEVEL OF DEPOSITION REACHES APPROXIMATELY ONE-HALF THE HEIGHT OF BARRIER.
- 11.4 SEDIMENT TRACKED ONTO PAVED ROADS MUST BE CLEANED UP AS SOON AS PRACTICAL, BUT IN NO CASE LATER THAN THE END OF THE NORMAL WORK DAY. THE CLEAN UP WILL INCLUDE SWEEPING OF THE TRACKED MATERIAL, PICKING IT UP, AND DEPOSITING IT TO A CONTAINED AREA.
- 11.5 ANY EXPOSED SLOPE THAT WILL REMAIN UNTOUCHED FOR LONGER THAN 14 DAYS MUST BE STABILIZED BY ONE OR MORE OF THE FOLLOWING METHODS:
- SPRAYING DISTURBED AREAS WITH A TACKIFIER VIA HYDROSEED
- TRACKING STRAW PERPENDICULAR TO SLOPES
- INSTALLING A LIGHT-WEIGHT, TEMPORARY EROSION CONTROL BLANKET

Linetype Legend

Abbreviations

PRC

PUE

RCP

RIM

TBC

TOA

TOC

TOS

TOW

= POINT OF RETURN CURVATURE

= PUBLIC UTILITY EASEMENT

= REINFORCED CONCRETE PIPE

= POINT OF TANGENCY

= RIM OF MANHOLE

= RIGHT-OF-WAY

= STORM DRAIN

= SANITARY SEWER

= TOP BACK OF CURB

= TOP OF ASPHALT

= TOP OF CONCRETE

= TOP OF STAIRS

= TOP OF SIDEWALK

= CULINARY WATER


= WATER METER

= TOP OF WALL

= TOP OF FINISHED FLOOR

= BASEMENT FLOOR ELEVATION BOUNDARY BLDG = BUILDING ------ - CENTERLINE = BOTTOM OF STAIRS BOW = BOTTOM OF WALL ----- EASEMENT = BEGINNING POINT C&G = CURB & GUTTER STORM DRAIN = CATCH BASIN SANITARY SEWER CB CULINARY WATER = CUBIC FEET CF = CUBIC FEET PER SECOND SECONDARY WATER = FINISH FLOOR ROOF DRAIN = FINISH FLOOR ELEVATION —— GAS —— GAS —— GAS —— GAS —— GAS = FINISHED GRADE = FIRE HYDRANT — — — EX.XX"SD — — — EX STORM DRAIN = FLOW LINE — — — — EX.xx"SS — — — — EX SANITARY SEWER = GRADE BREAK — — — EX.W — — — EX CULINARY WATER = INVERT — — — — EX.SW — — — — EX SECONDARY WATER = LINEAR FEET ____ EX.GAS ___ _ EX GAS = NATURAL GRADE — — — — EX.FIBER — — — — EX FIBER = POINT OF CURVATURE = POWER/UTILITY POLE — 4355 — CONTOUR MAJOR

Hatching Legend

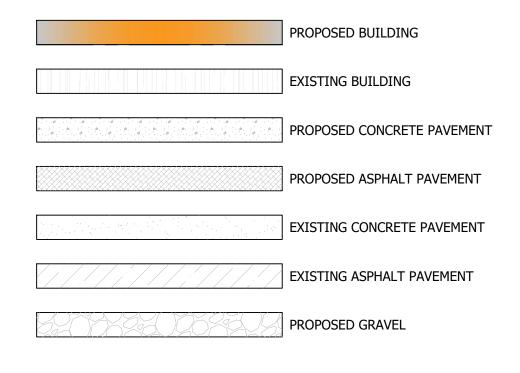

— 4355 — CONTOUR MINOR

- \cdot - EXIST. CONTOUR MINOR


__O__O__O__ FENCE

EXIST. CONTOUR MAJOR


Symbol Legend



Detail Identification

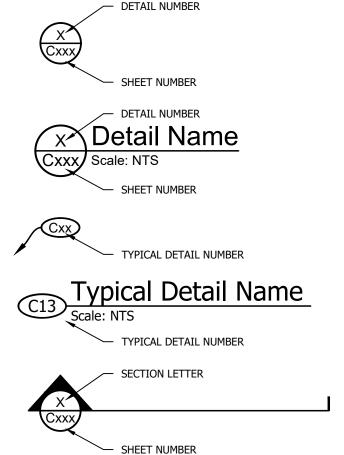



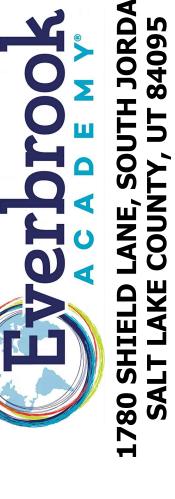

ENGINEERS STAMP



BAR IS ONE INCH ON ORIGINAL DRAWING IF NOT ONE INCH ON THIS SHEET, ADJUST SCALES ACCORDINGLY


PROJECT INFO.

VERIFY SCALES


Engineer: T. Hunt Drawn: T. Pridemore Checked: Date: 12 / 09 / 2022 SHEET TITLE

Legend &

SHEET NO.

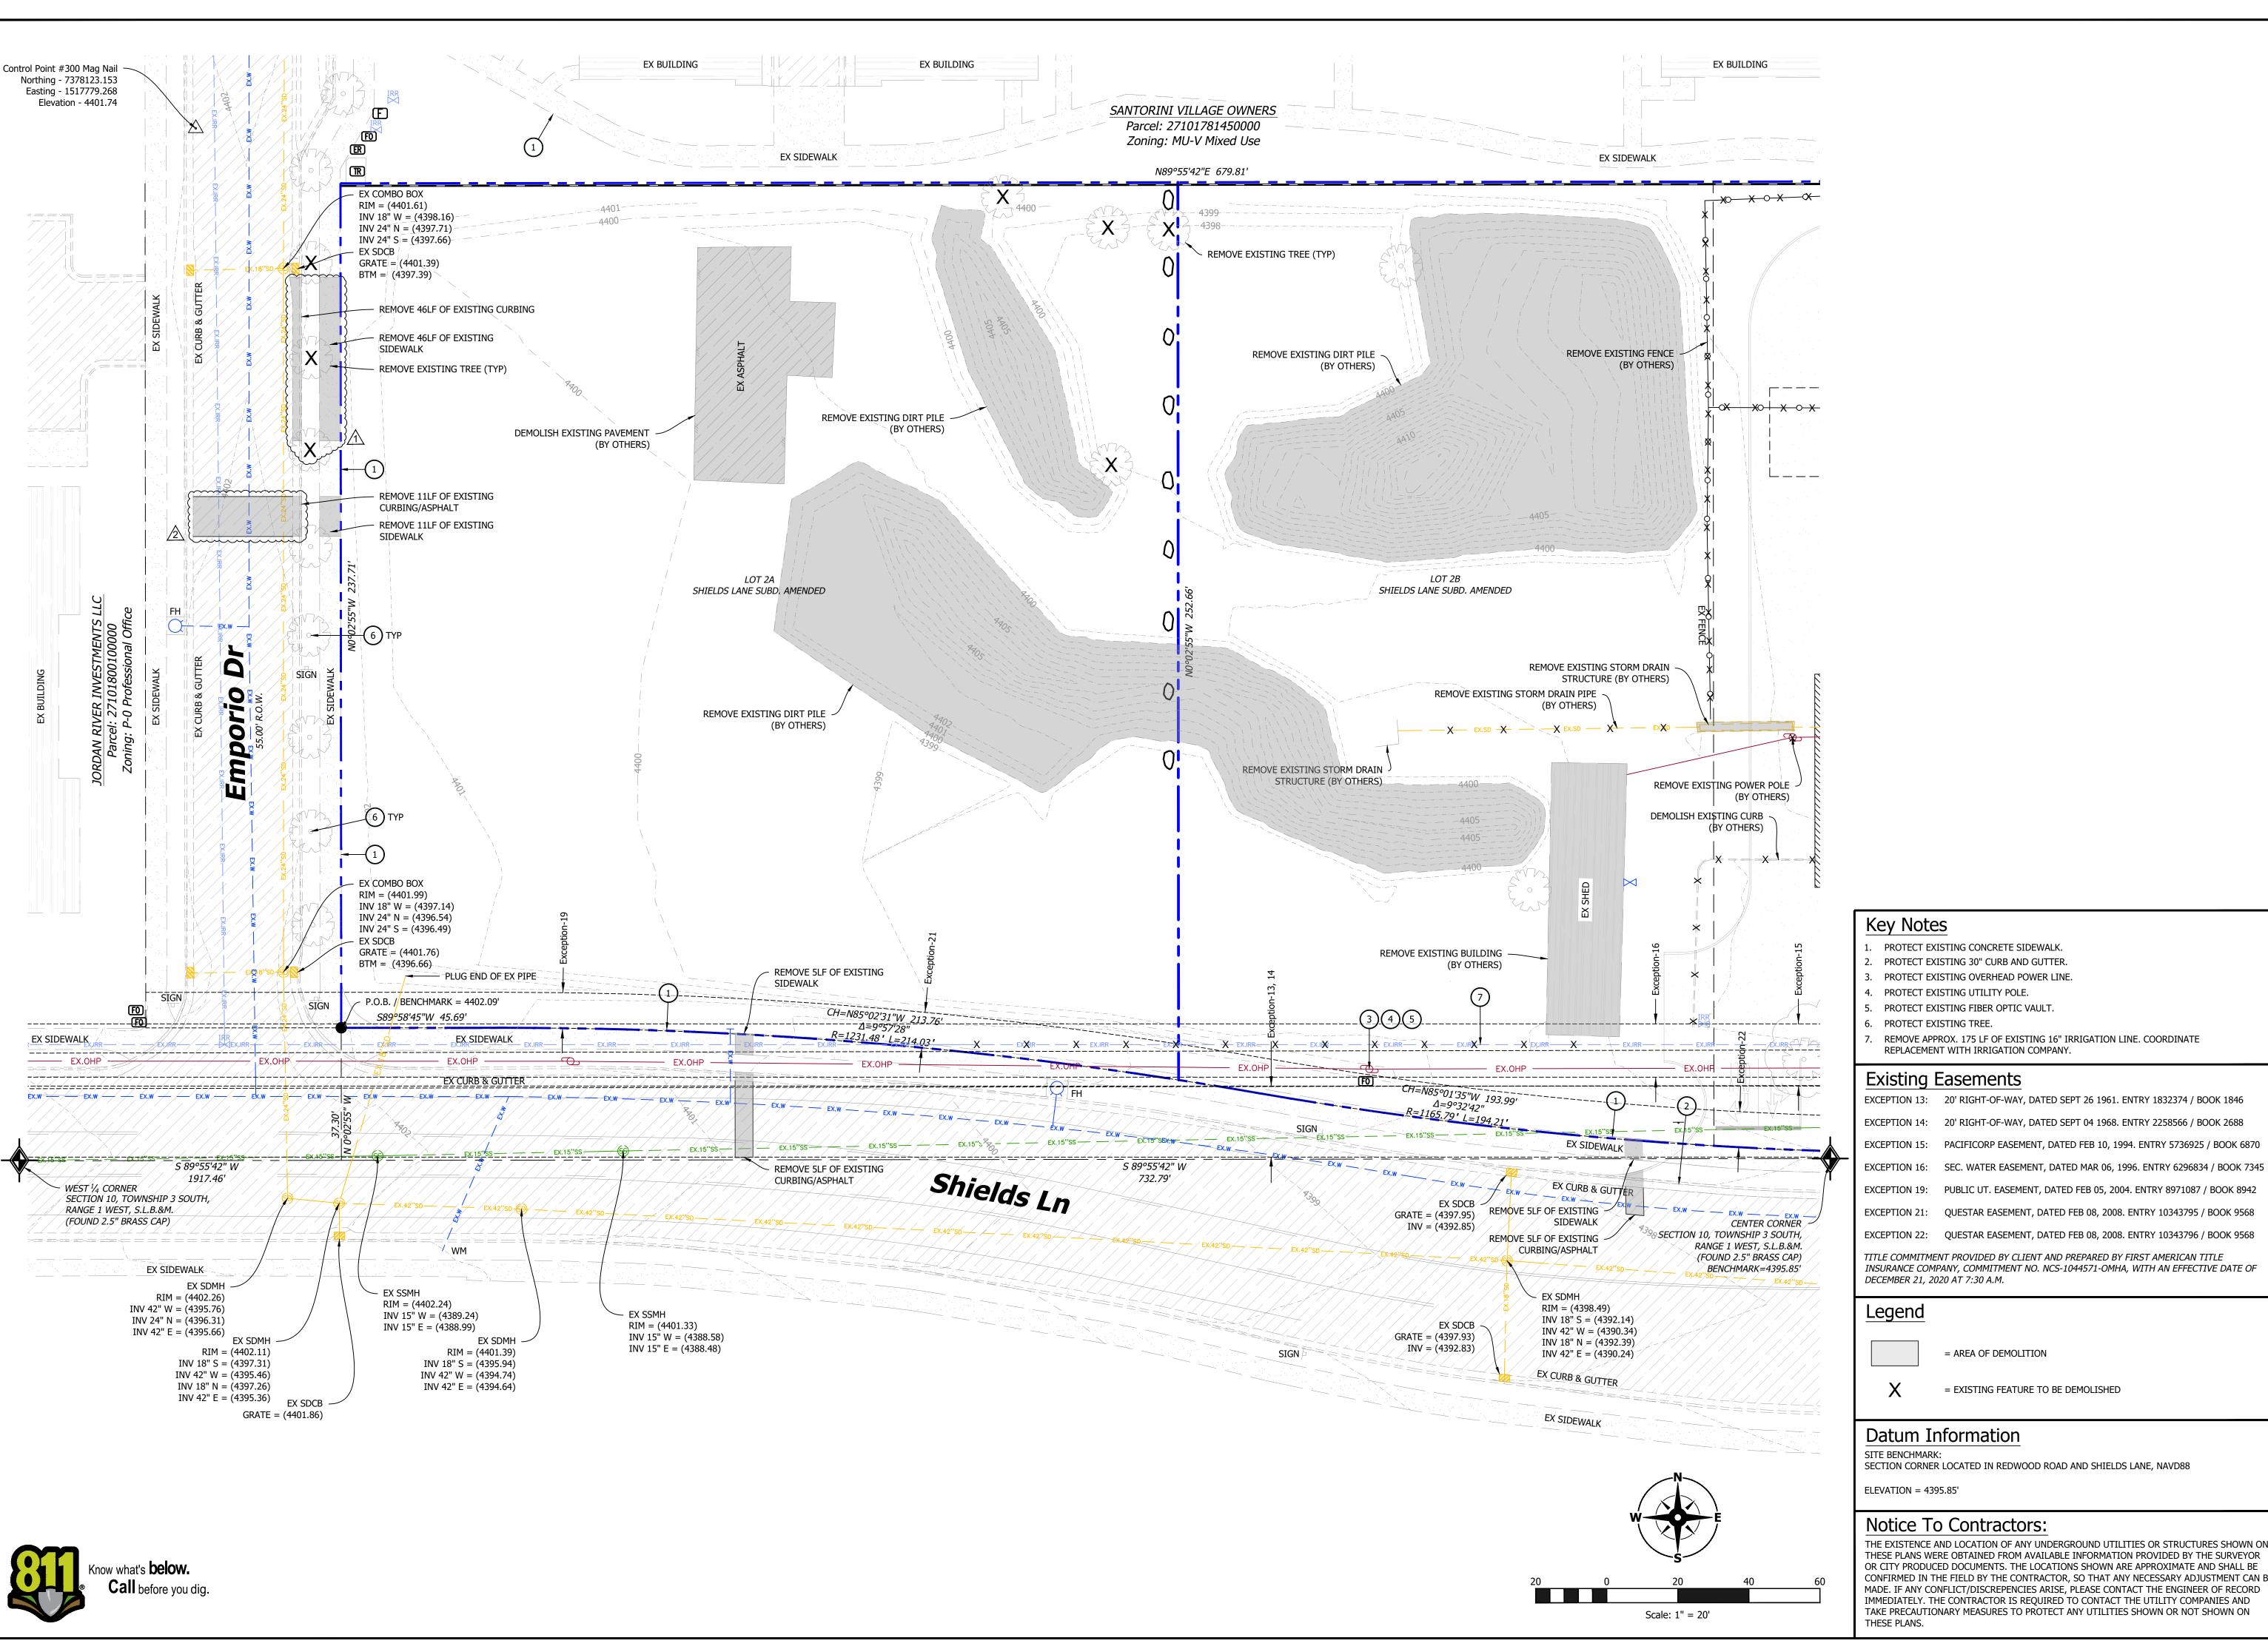



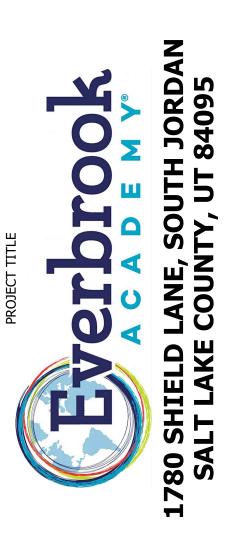



VERIFY SCALES

BAR IS ONE INCH ON ORIGINAL DRAWING IF NOT ONE INCH ON THIS SHEET, ADJUST

SCALES ACCORDINGLY

PROJECT INFO. Drawn: T. Pridemore

Checked: Date: 12 / 09 / 2022

SHEET TITLE

Datum Information

SITE BENCHMARK:

SECTION CORNER LOCATED IN REDWOOD ROAD AND SHIELDS LANE, NAVD88

= EXISTING FEATURE TO BE DEMOLISHED

= AREA OF DEMOLITION


ELEVATION = 4395.85'

Notice To Contractors:


THE EXISTENCE AND LOCATION OF ANY UNDERGROUND UTILITIES OR STRUCTURES SHOWN ON THESE PLANS WERE OBTAINED FROM AVAILABLE INFORMATION PROVIDED BY THE SURVEYOR MADE. IF ANY CONFLICT/DISCREPENCIES ARISE, PLEASE CONTACT THE ENGINEER OF RECORD IMMEDIATELY. THE CONTRACTOR IS REQUIRED TO CONTACT THE UTILITY COMPANIES AND TAKE PRECAUTIONARY MEASURES TO PROTECT ANY UTILITIES SHOWN OR NOT SHOWN ON

Demolition Plan

SHEET NO.

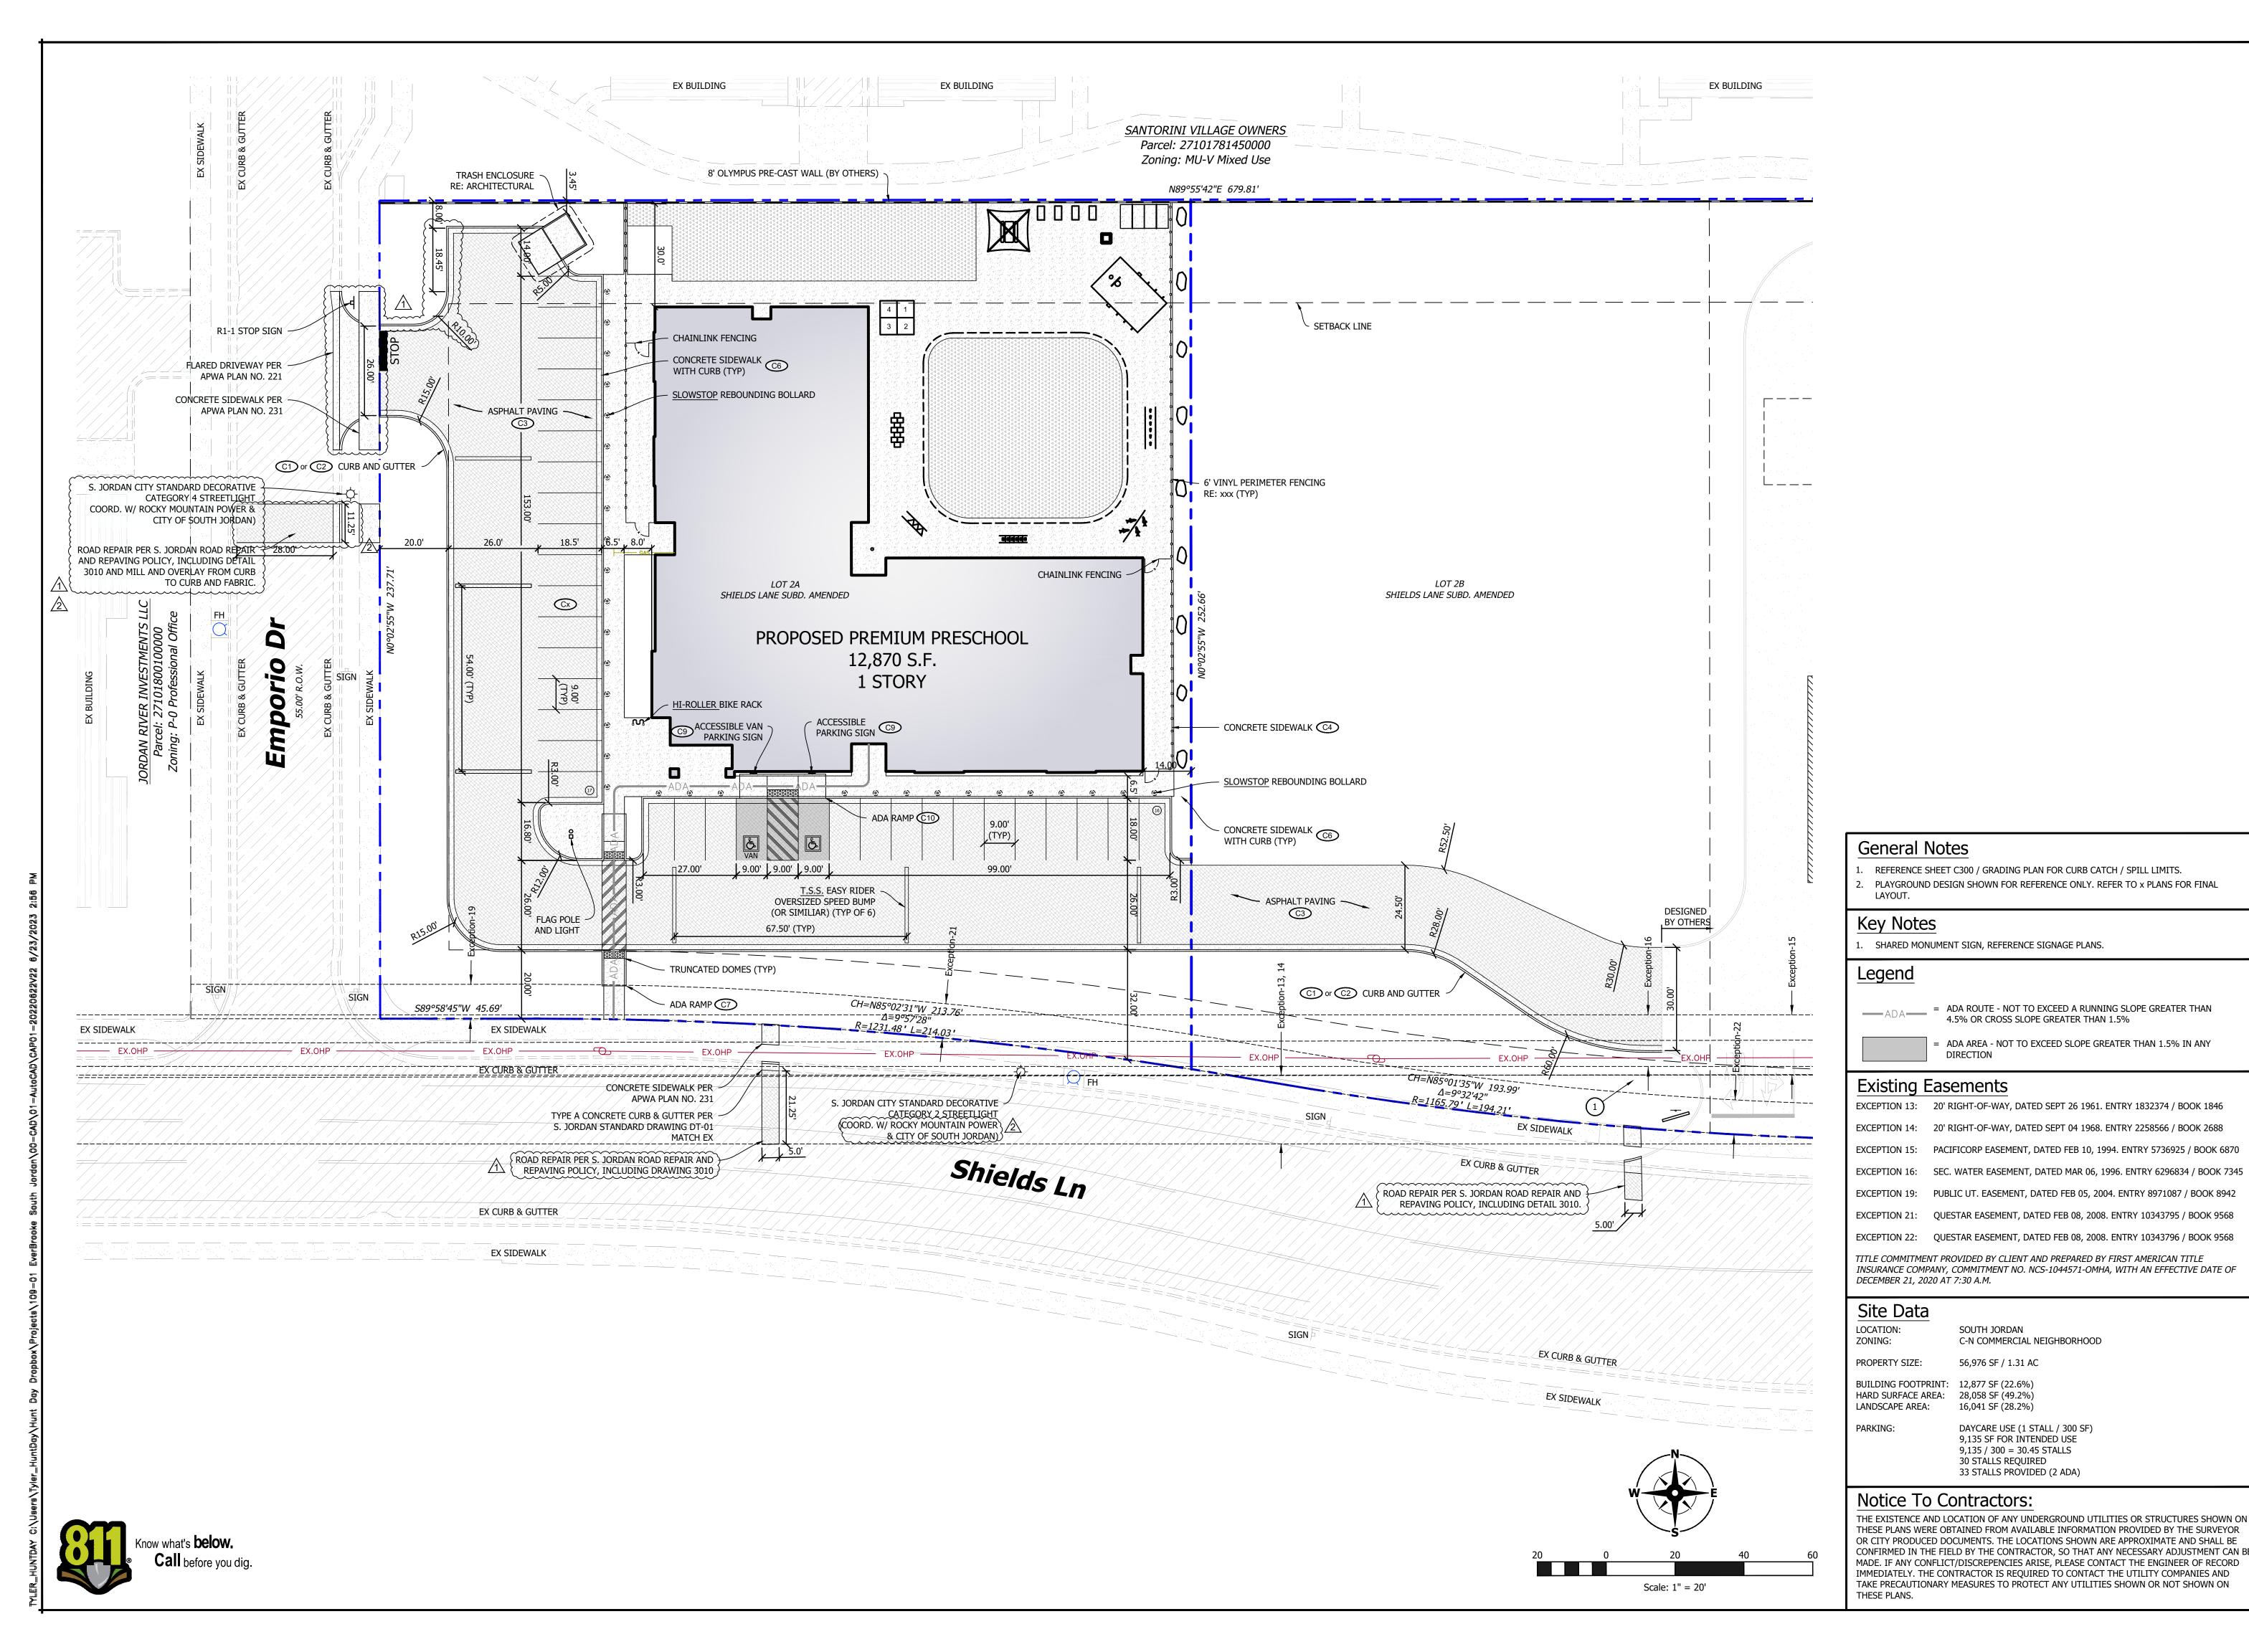



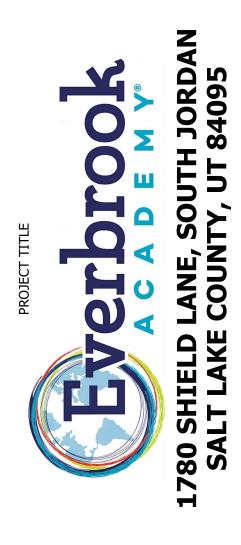

ENGINEERS STAMP

VERIFY SCALES

BAR IS ONE INCH ON ORIGINAL DRAWING IF NOT ONE INCH ON THIS SHEET, ADJUST SCALES ACCORDINGLY


PROJECT INFO. Engineer: T. Hunt Drawn: T. Pridemore Checked:

Date: 12 / 09 / 2022

SHEET TITLE

Site Plan

SHEET NO.

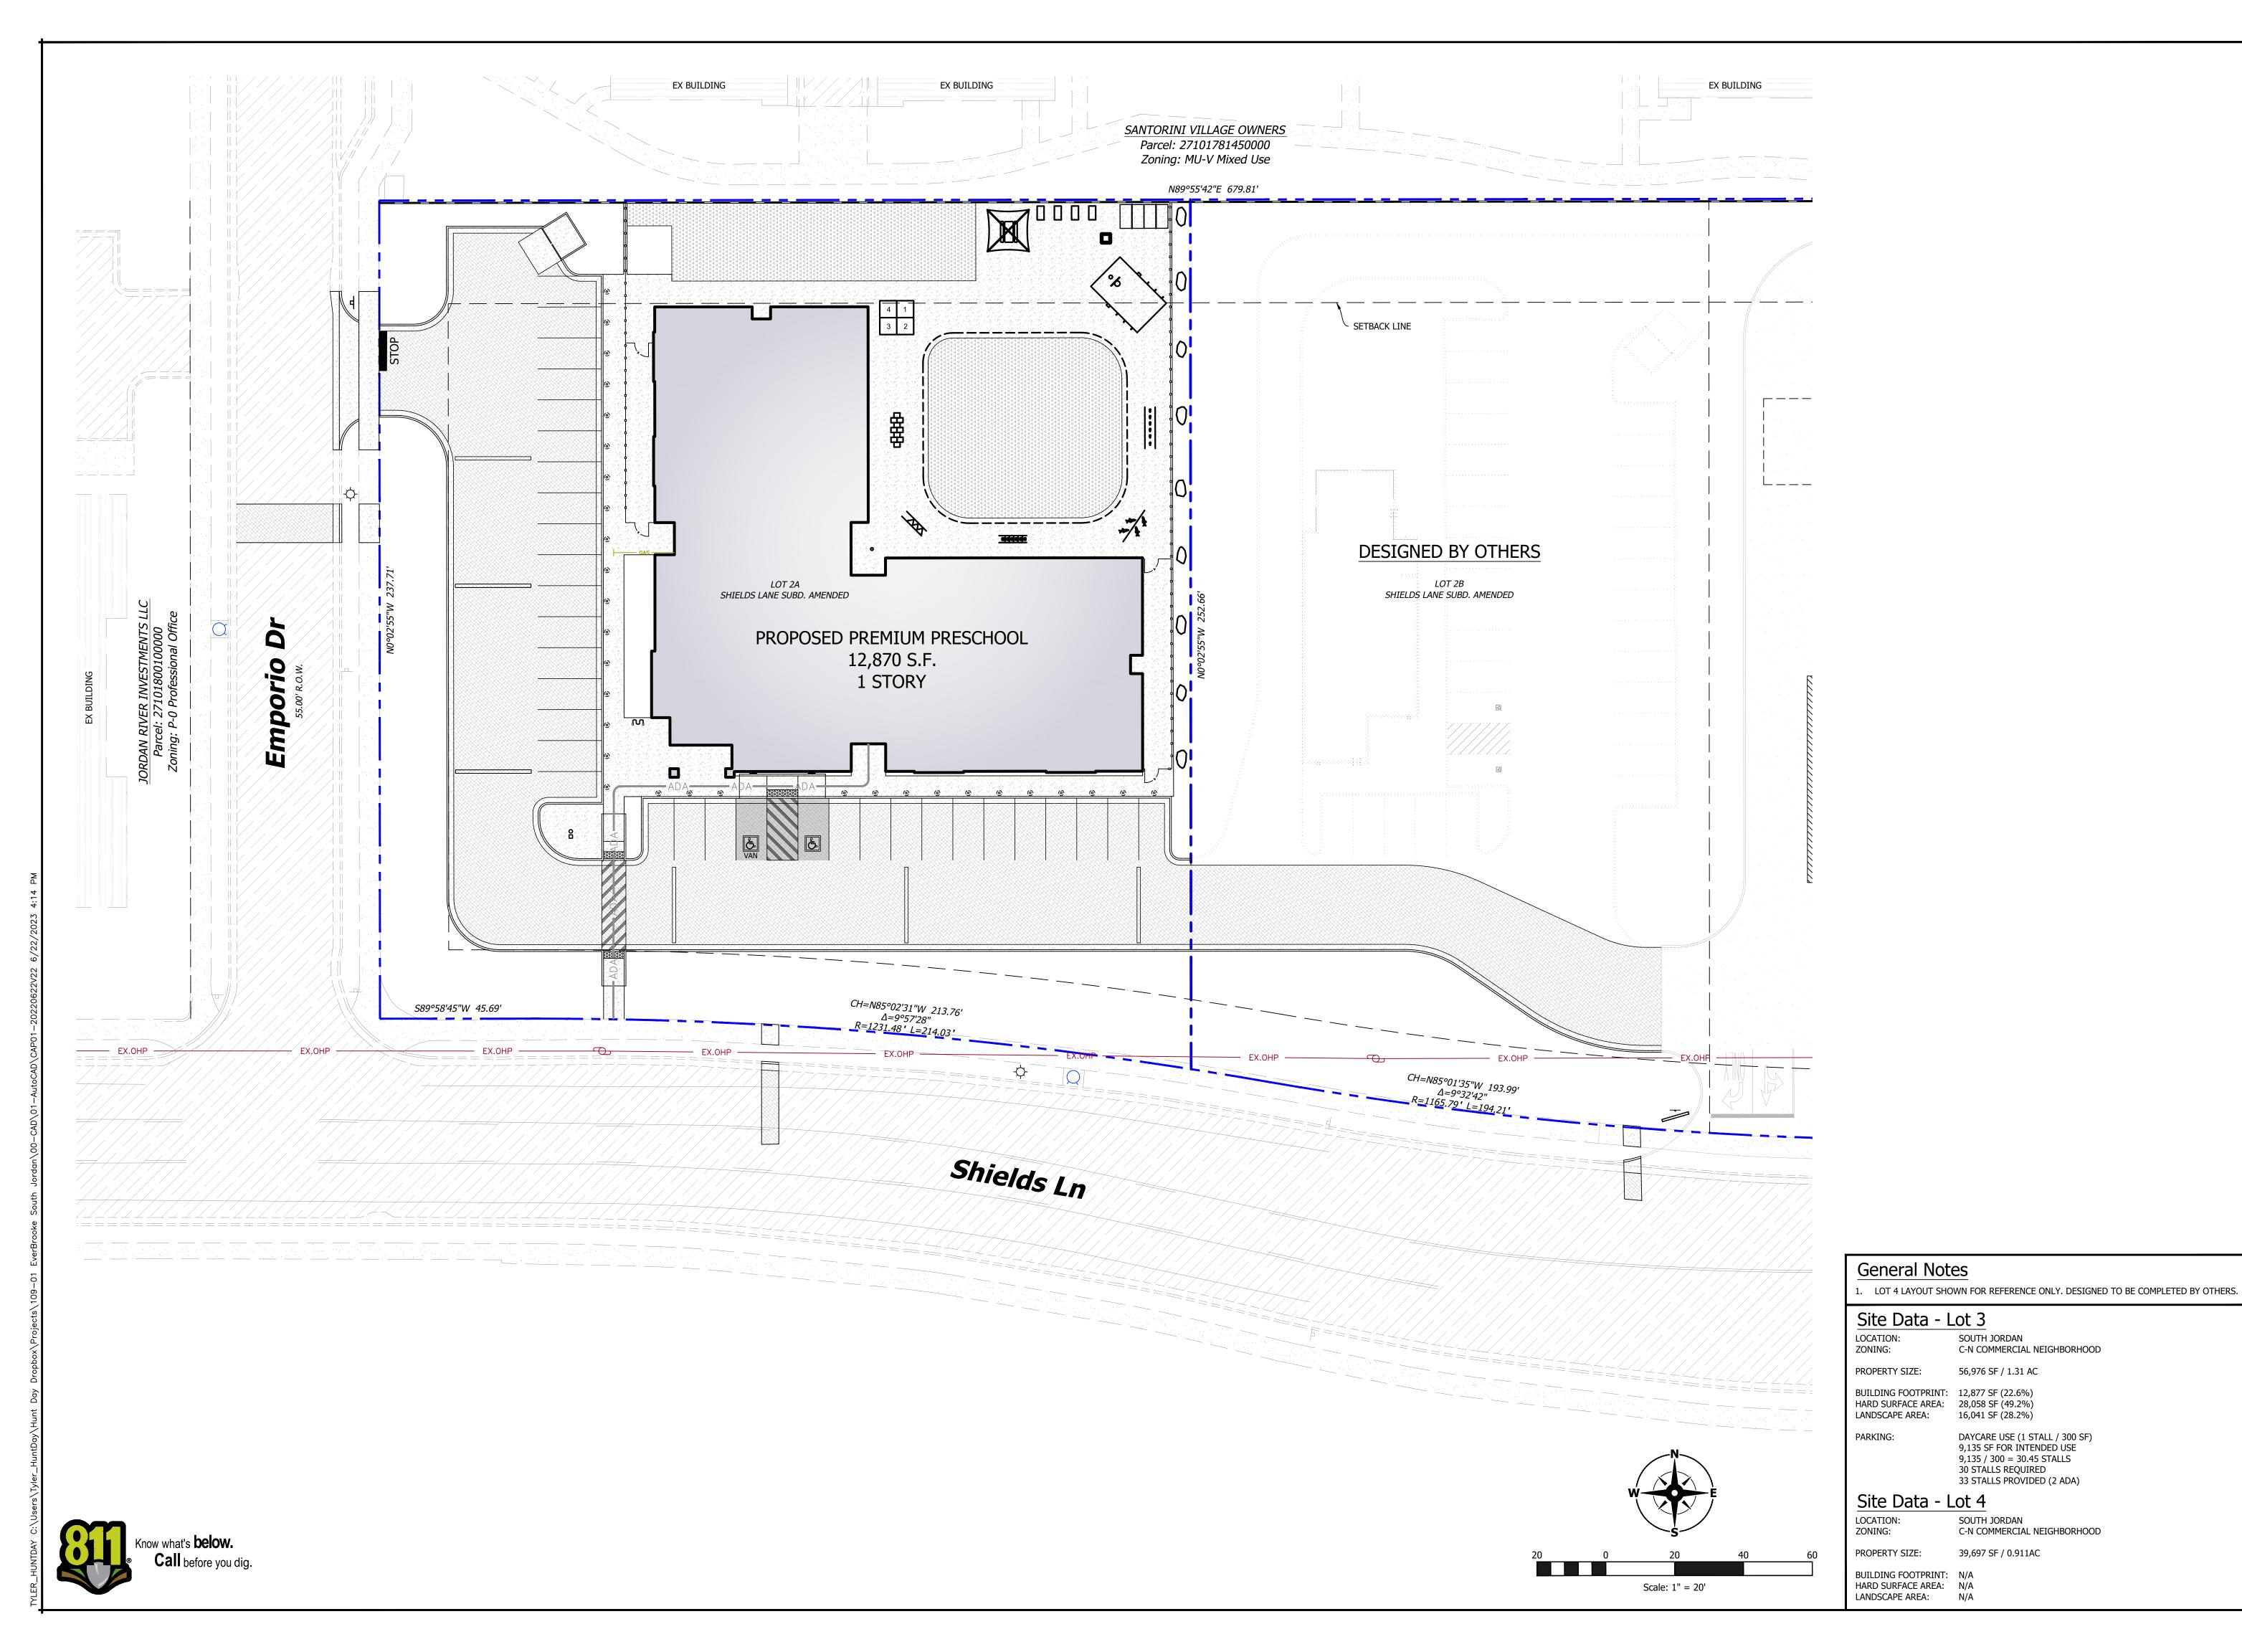





2 06-22-2023 REVISED PER CITY COMMENTS THE 1 04-19-2023 REVISED PER CITY COMMENTS THE 0 03-08-2023 INITIAL SUBMITTAL THE PECK. DATE DESCRIPTION BY

ENGINEERS STAMP

SELECTIONAL ENGINEERS

THOMAS J. HUNT

CO-21-2023

STATE OF UTAH

VERIFY SCALES

BAR IS ONE INCH ON ORIGINAL DRAWING

0 1"

IF NOT ONE INCH ON THIS SHEET, ADJUST SCALES ACCORDINGLY

PROJECT INFO.


Engineer: T. Hunt
Drawn: T. Pridemore
Checked: Date: 12 / 09 / 2022


Date: 12 / 09 / 20
Proj. No. SHEET TITLE

Overall

Overall Site Layout

SHEET NO.

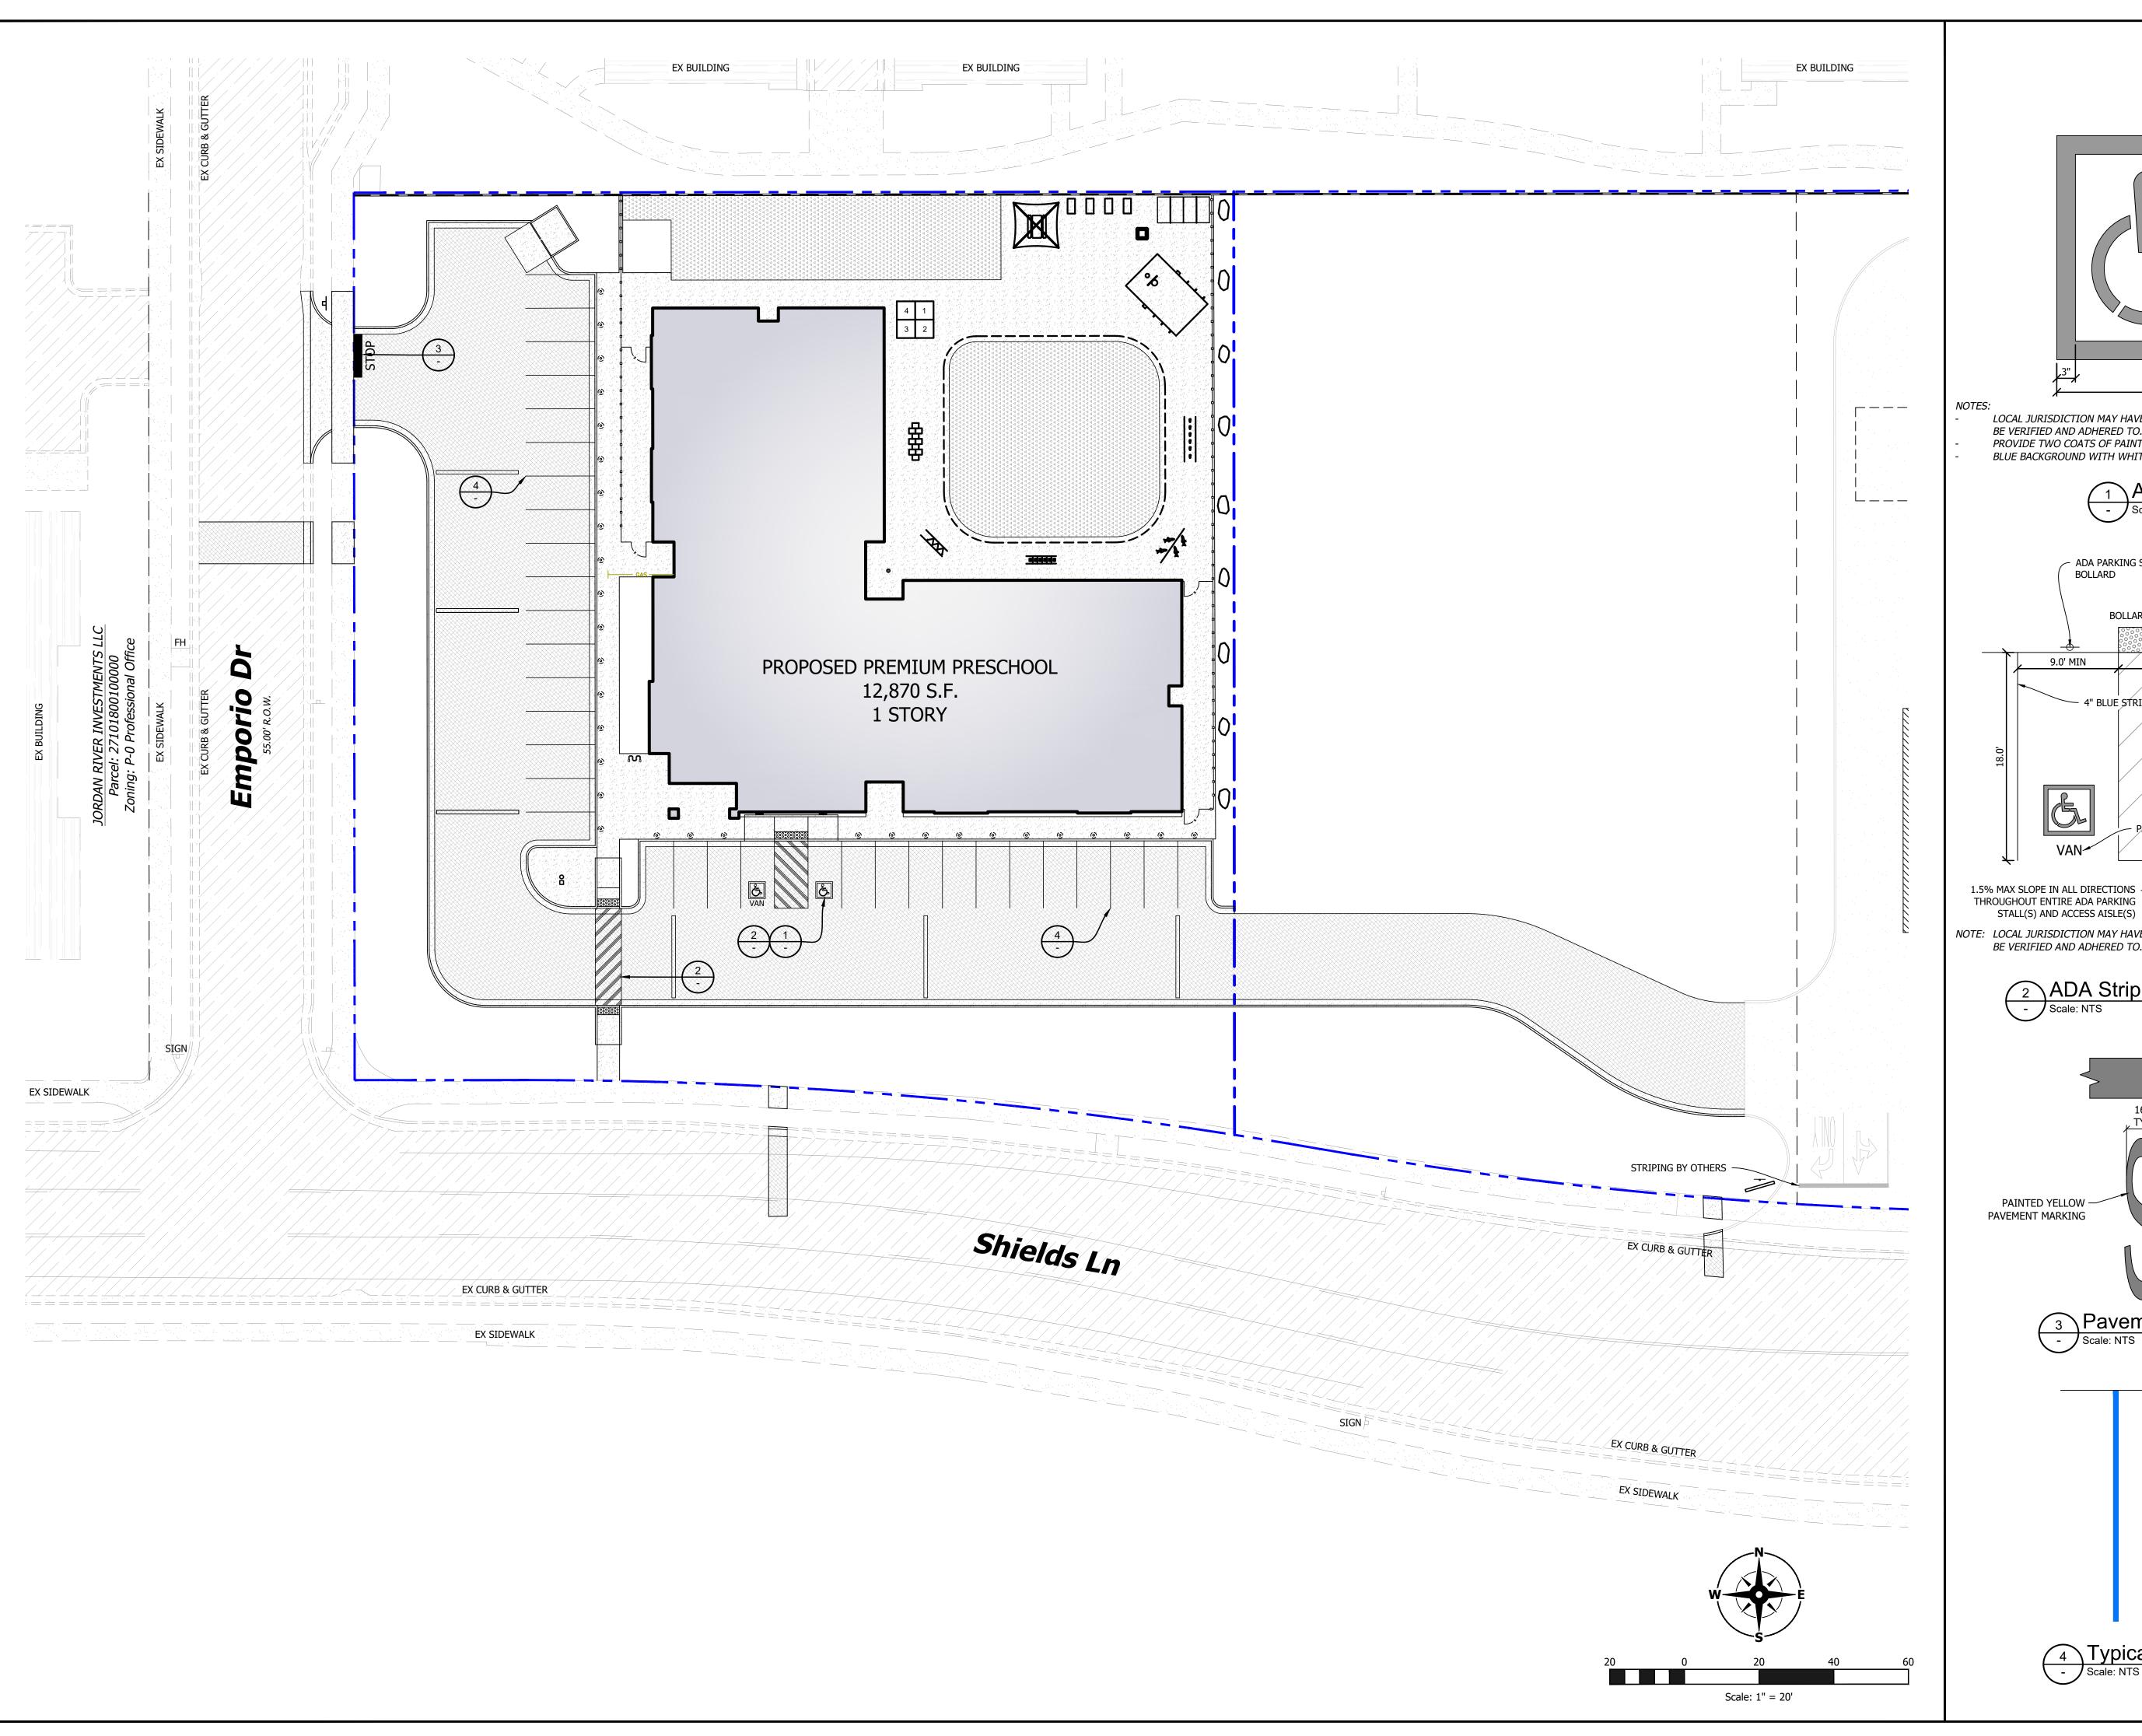


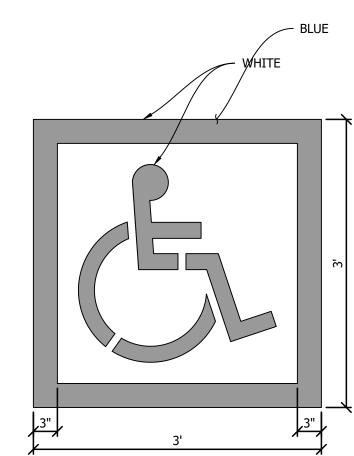

LOCAL JURISDICTION MAY HAVE MORE STRINGENT REQUIREMENTS THAT SHALL BE VERIFIED AND ADHERED TO.
PROVIDE TWO COATS OF PAINT

1 ADA Sybmol


BLUE BACKGROUND WITH WHITE SYMBOL

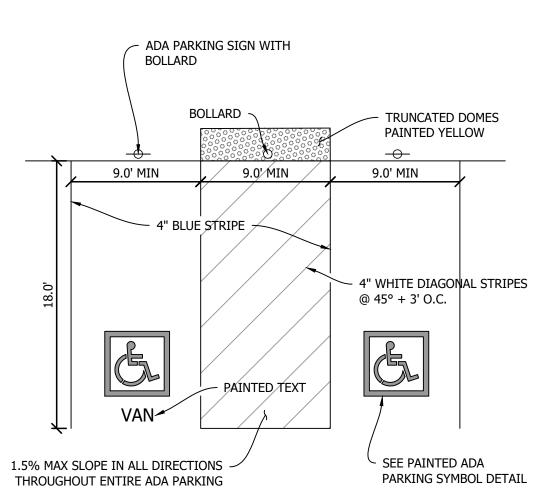

NOTE: LOCAL JURISDICTION MAY HAVE MORE STRINGENT REQUIREMENTS THAT SHALL BE VERIFIED AND ADHERED TO.


ADA Striping and PED Access

Scale: NTS

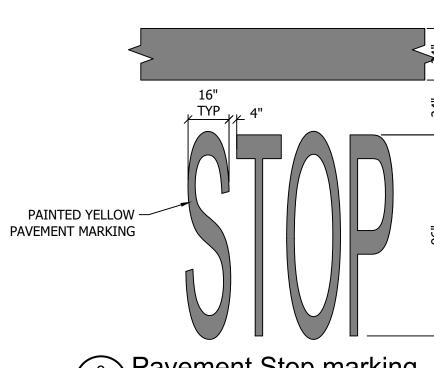

Pavement Stop marking

Scale: NTS

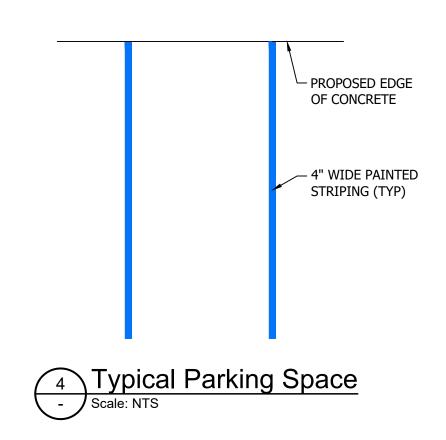



ΒY	DESCRIPTION	DATE	REV.
ПР	INITIAL SUBMITTAL	03-08-2023	0
TP	REVISED PER CITY COMMENTS	04-19-2023	1
ТР	REVISED PER CITY COMMENTS	2 06-22-2023	2

ENGINEERS STAMP


VERIFY SCALES BAR IS ONE INCH ON ORIGINAL DRAWING

PROJECT INFO. Engineer: T. Hunt Drawn: T. Pridemore Checked: 12 / 09 / 2022

Proj. No. -SHEET TITLE

Striping Plan

SHEET NO.

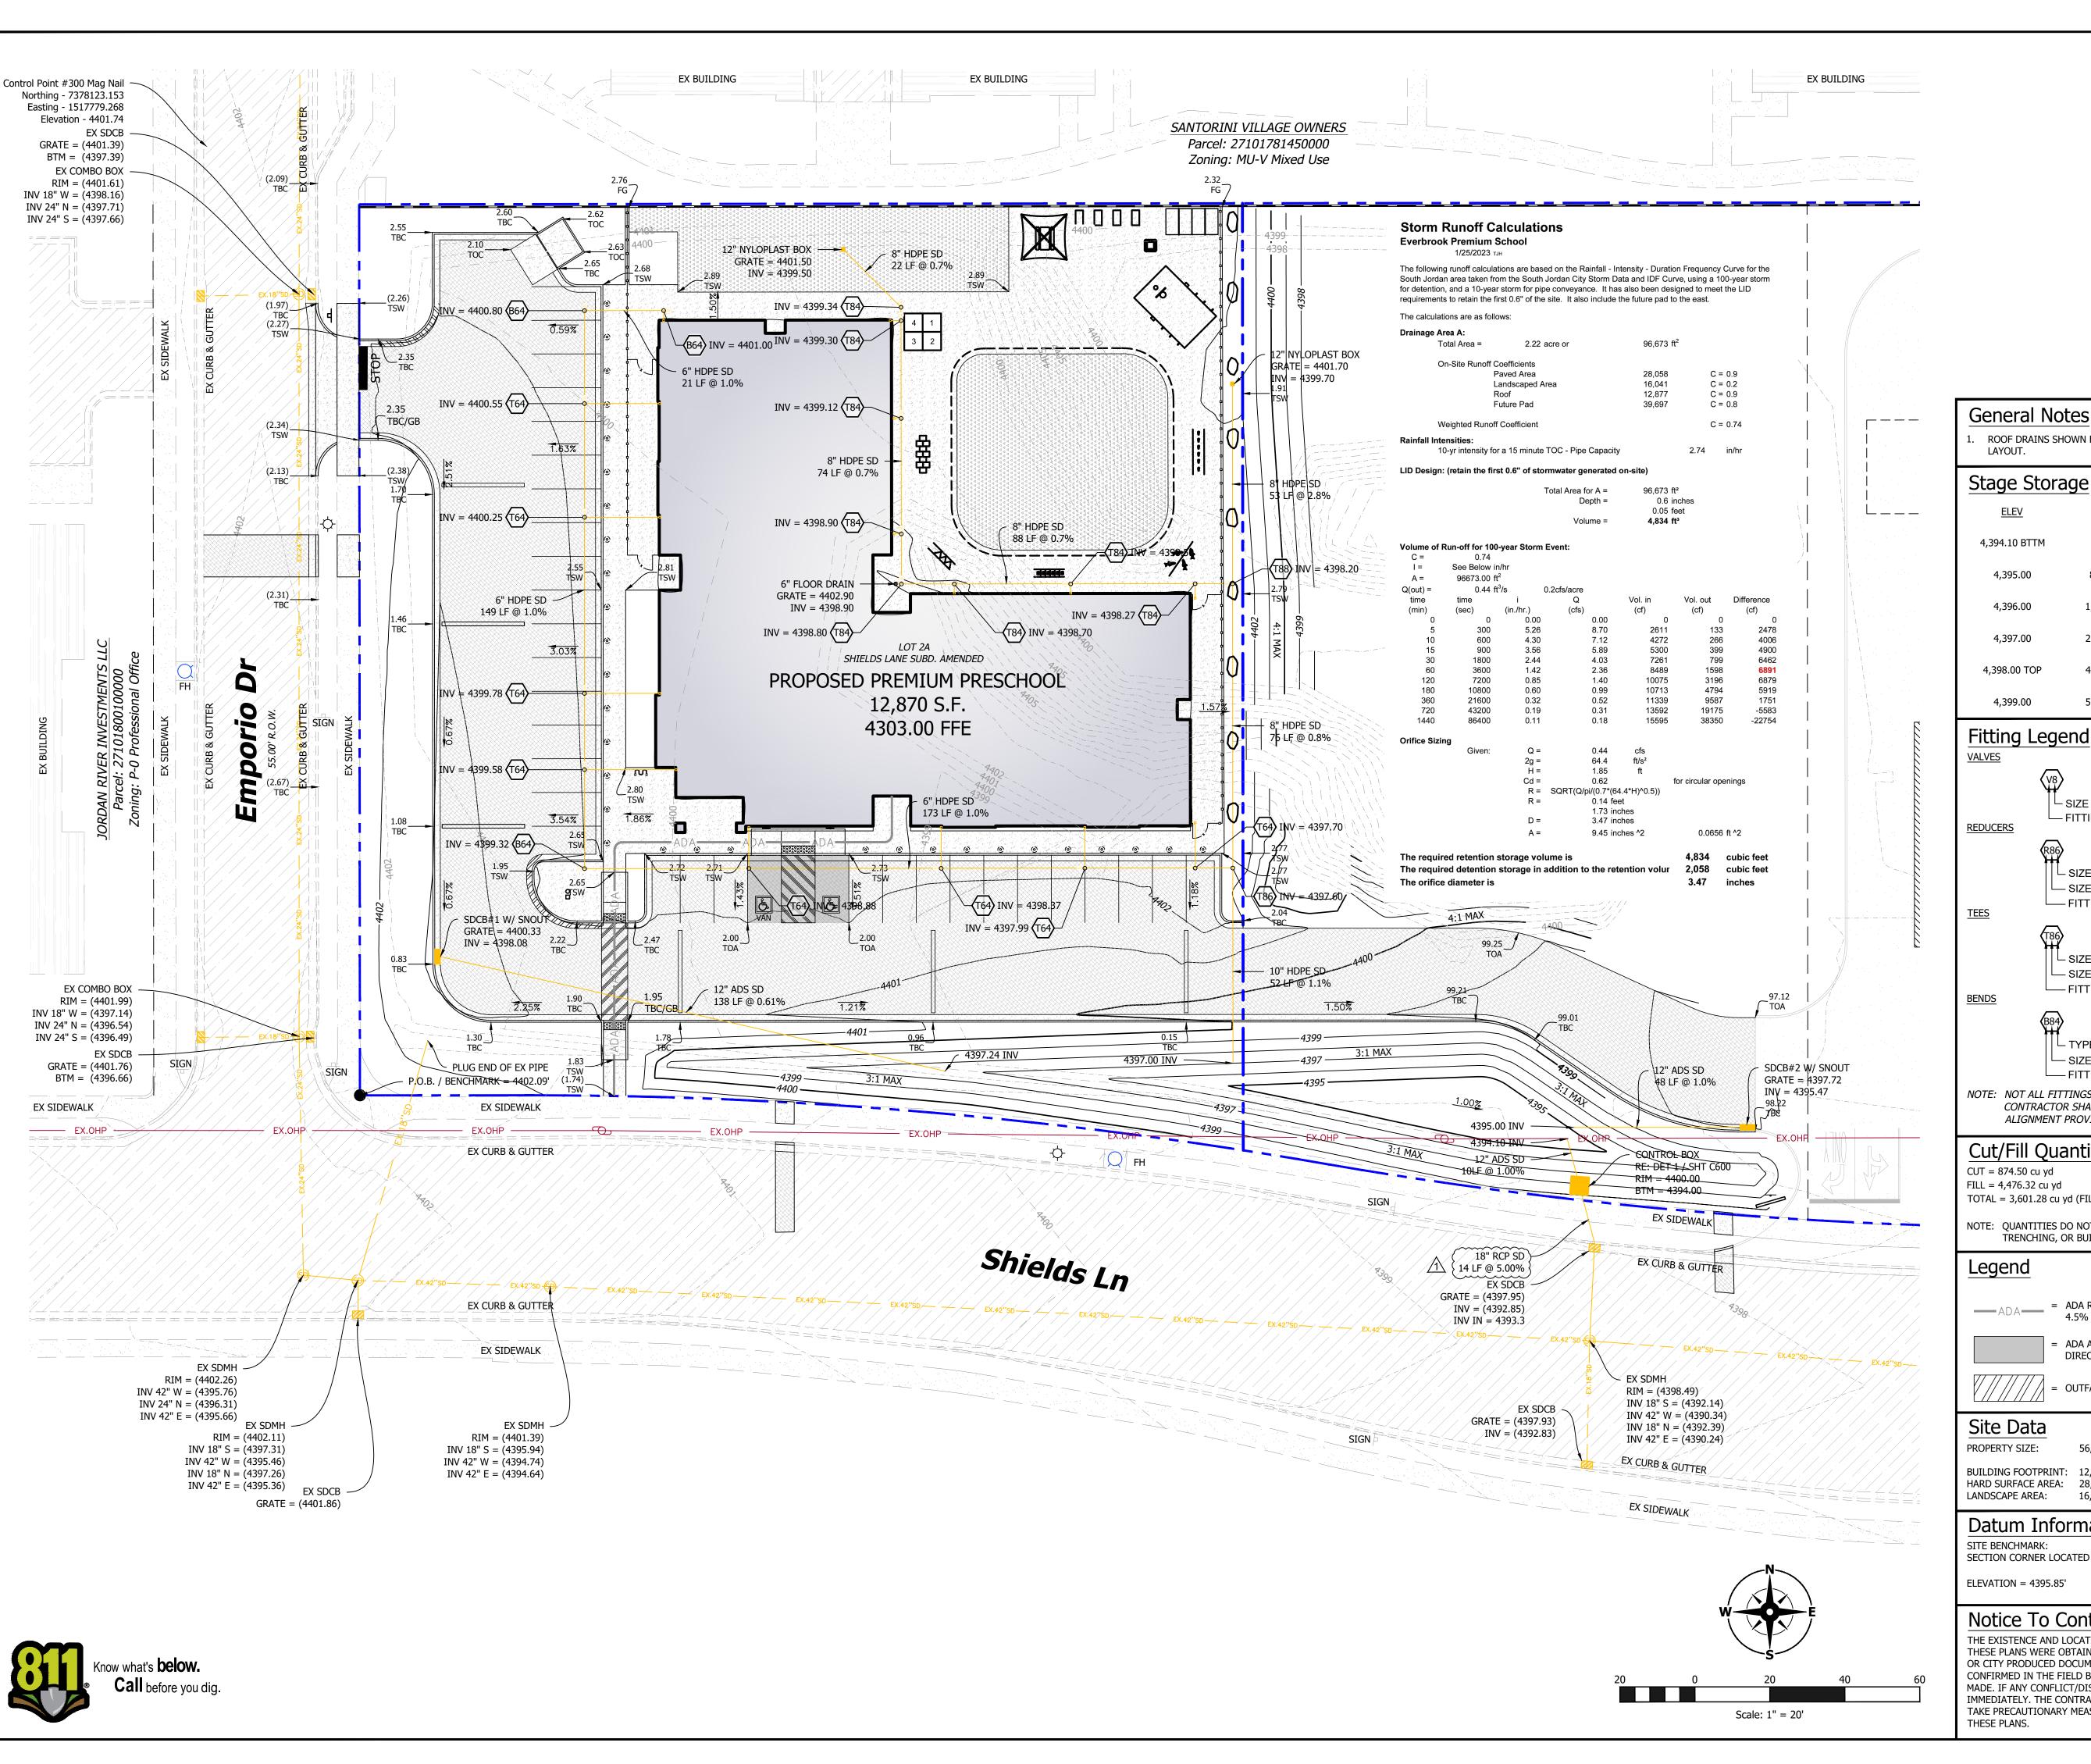



PH: 801.664.4724



ROOF DRAINS SHOWN FOR REFERENCE ONLY. REFER TO PLUMBING PLANS FOR FINAL

398.82 cu ft 398.82 cu ft 1276.40 cu ft 1675.22 cu ft 2253.67 cu ft 3928.89 cu ft 3564.34 cu ft 7493.23 cu ft 4998.80 cu ft 12492.03 cu ft

AVG END TOTAL VOL.

0.00 cu ft

V8 8" VALVE

(X88) 8" x 8" CROSS

└─ SIZE IN INCHES FITTING DESIGNATION (VALVE) (R86) 8" x 6" REDUCER \sqcup SIZE IN INCHES (SMALL END) SIZE IN INCHES (LARGE END) — FITTING DESIGNATION (REDUCER) (T86) 8" x 8" x 6" TEE

SIZE IN INCHES (BRANCH) SIZE IN INCHES (THRU PIPE) FITTING DESIGNATION (TEE) ☐ TYPE OF BEND (SEE LEGEND)

0.69 sq ft

885.59 sq ft

1,667.20 sq ft

2,840.14 sq ft

4,288.53 sq ft

5,709.08 sq ft

0 cu ft

P8 8" PLUG 8" 90d BEND BEND LEGEND 1 = 11.25d 2 = 22.5d— SIZE IN INCHES 3 = 45d— FITTING DESIGNATION (BEND)

NOTE: NOT ALL FITTINGS ARE SHOWN, AND PROVIDED FOR REFERENCE ONLY. CONTRACTOR SHALL INSTALL ALL FITTINGS REQUIRED TO FOLLOW THE ALIGNMENT PROVIDED IN THE DRAWINGS.

Cut/Fill Quantities

CUT = 874.50 cu ydFILL = 4,476.32 cu yd TOTAL = 3,601.28 cu yd (FILL)

NOTE: QUANTITIES DO NOT ACCOUNT FOR COMPACTION OR SHRINKAGE, UTILITY TRENCHING, OR BUILDING FOOTINGS.

= ADA ROUTE - NOT TO EXCEED A RUNNING SLOPE GREATER THAN 4.5% OR CROSS SLOPE GREATER THAN 1.5%

ADA AREA - NOT TO EXCEED SLOPE GREATER THAN 1.5% IN ANY

////// = OUTFALL CURB

Site Data

56,976 SF / 1.31 AC BUILDING FOOTPRINT: 12,877 SF (22.6%) HARD SURFACE AREA: 28,058 SF (49.2%) 16,041 SF (28.2%)

Datum Information

SITE BENCHMARK: SECTION CORNER LOCATED IN REDWOOD ROAD AND SHIELDS LANE, NAVD88

ELEVATION = 4395.85'

Notice To Contractors:

THE EXISTENCE AND LOCATION OF ANY UNDERGROUND UTILITIES OR STRUCTURES SHOWN ON THESE PLANS WERE OBTAINED FROM AVAILABLE INFORMATION PROVIDED BY THE SURVEYOR MADE. IF ANY CONFLICT/DISCREPENCIES ARISE, PLEASE CONTACT THE ENGINEER OF RECORD IMMEDIATELY. THE CONTRACTOR IS REQUIRED TO CONTACT THE UTILITY COMPANIES AND TAKE PRECAUTIONARY MEASURES TO PROTECT ANY UTILITIES SHOWN OR NOT SHOWN ON

ENGINEERS STAMP



VERIFY SCALES


BAR IS ONE INCH ON ORIGINAL DRAWING IF NOT ONE INCH ON THIS SHEET, ADJUST SCALES ACCORDINGLY

PROJECT INFO. Engineer: T. Hunt Drawn: T. Pridemore Checked: Date: 12 / 09 / 2022

SHEET TITLE

Grading Plan

SHEET NO.

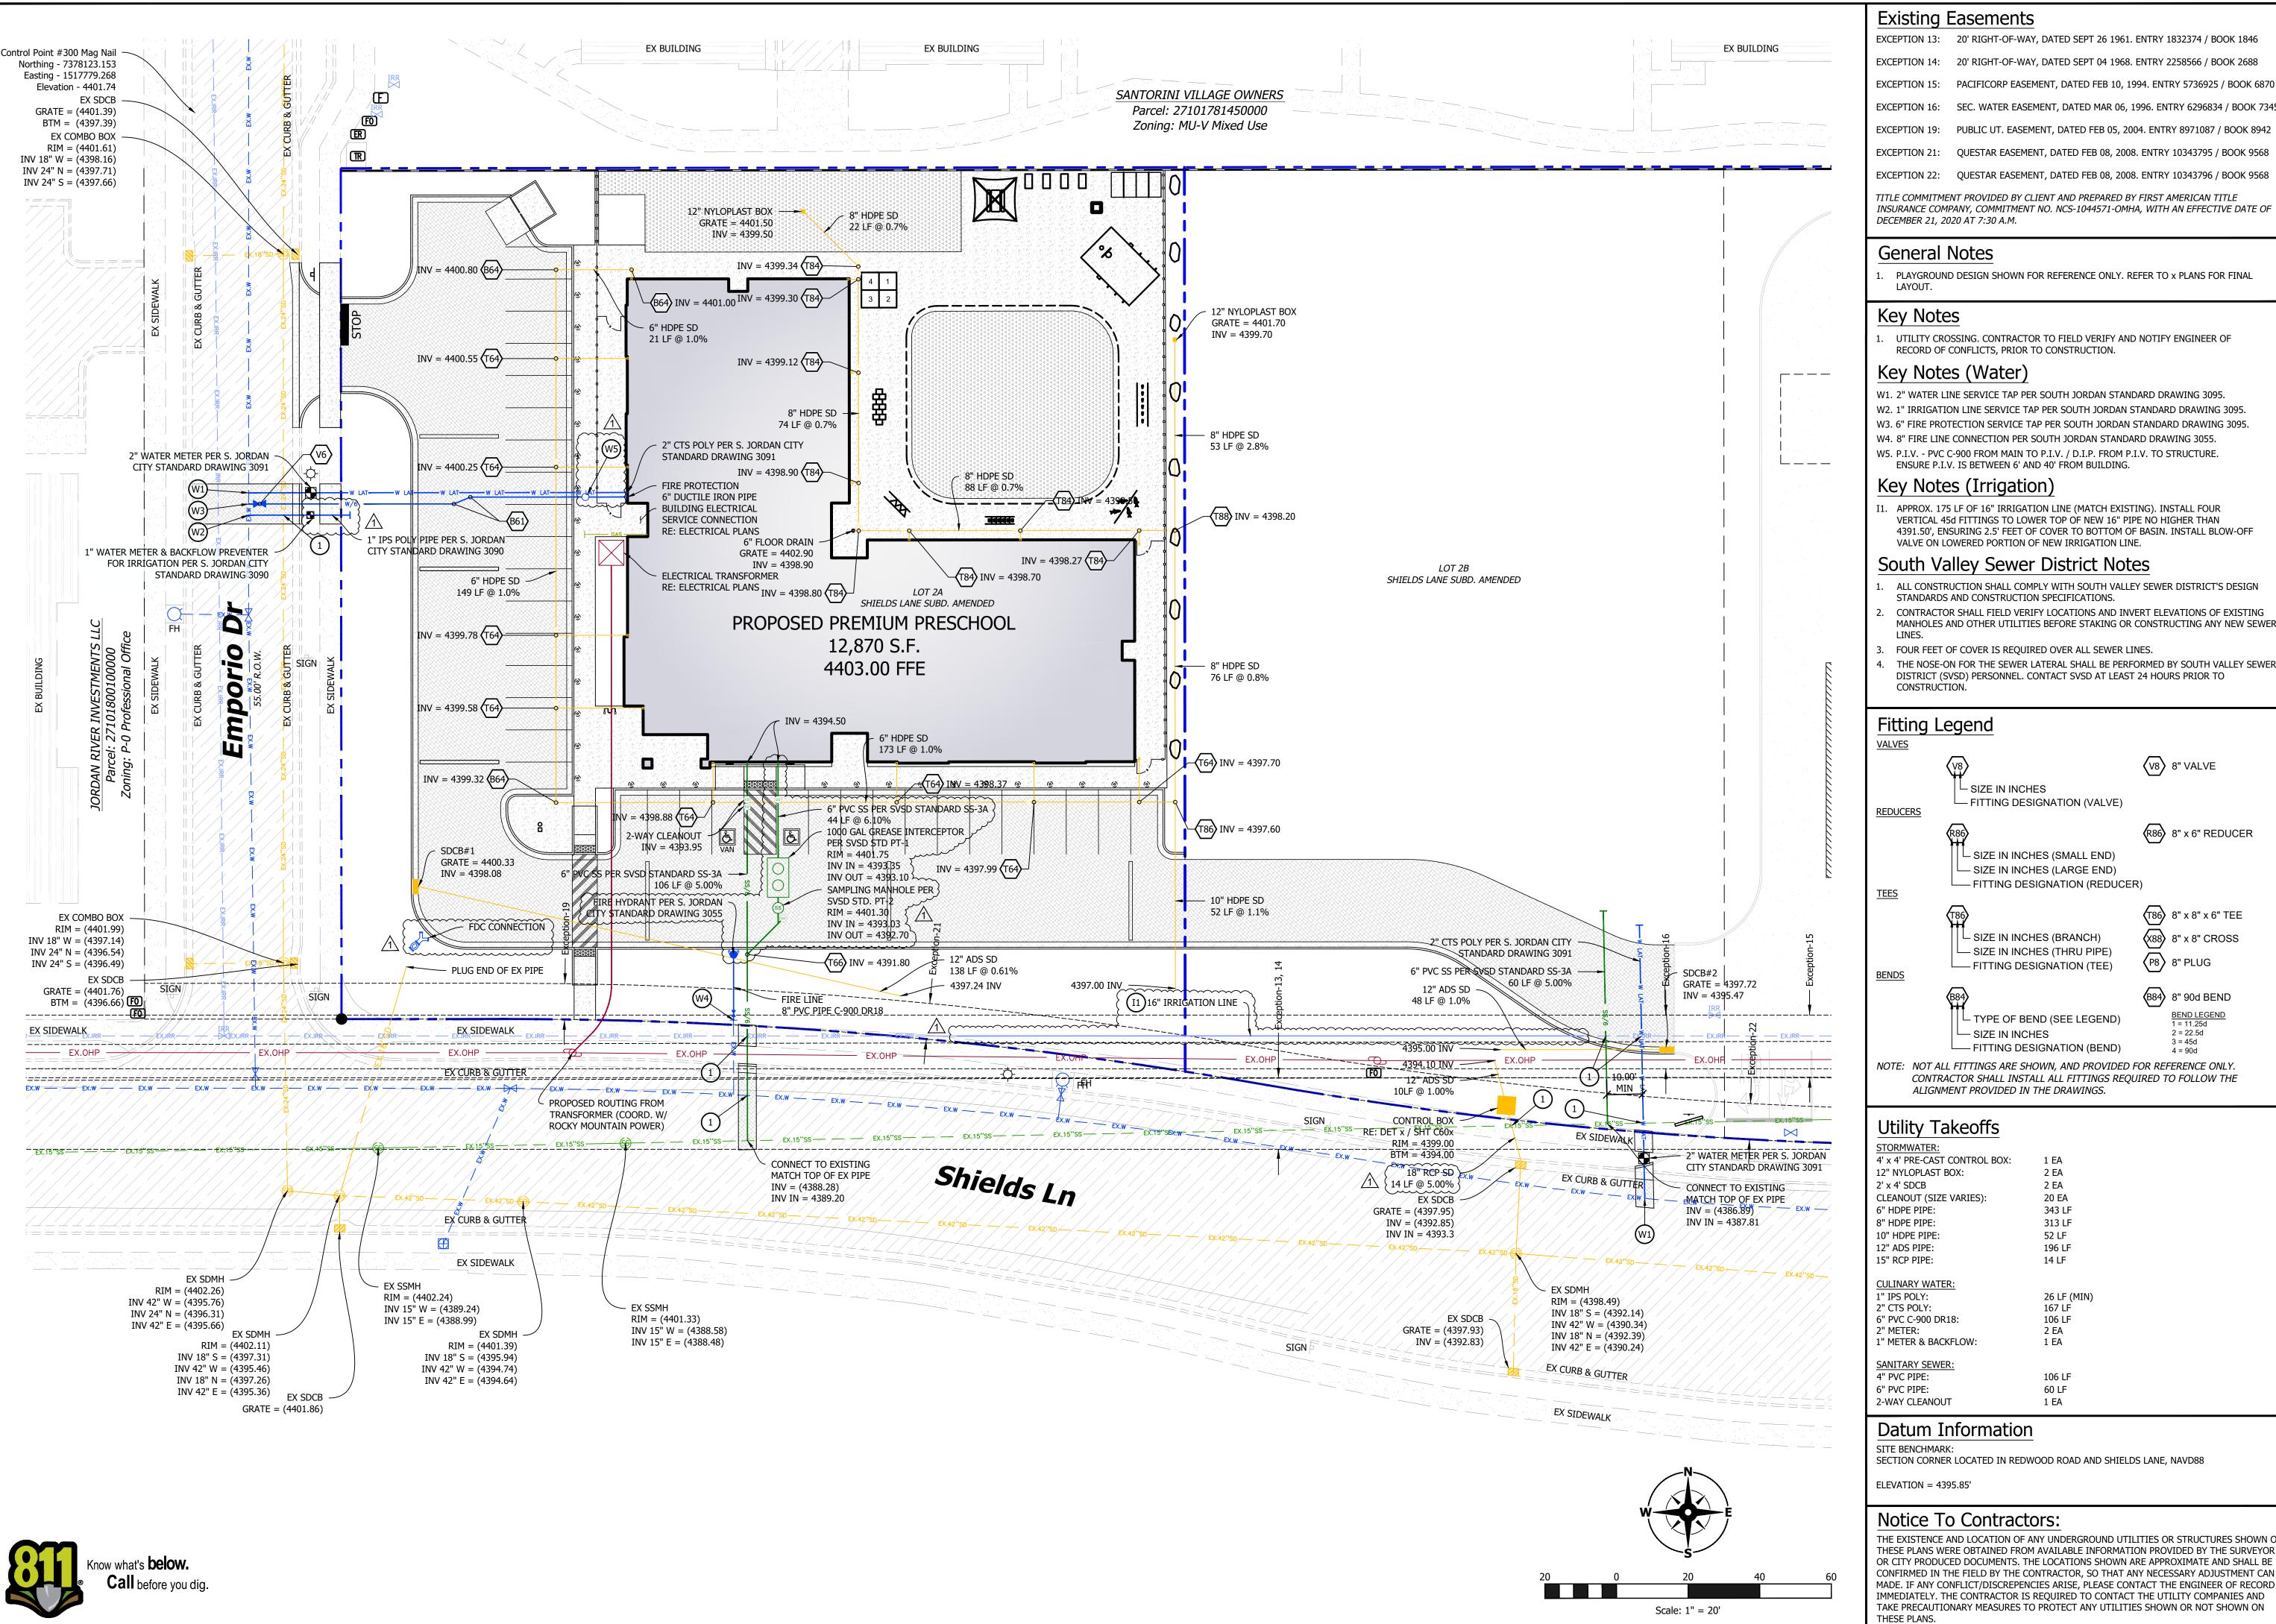

Existing Easements

EXCEPTION 13: 20' RIGHT-OF-WAY, DATED SEPT 26 1961. ENTRY 1832374 / BOOK 1846 EXCEPTION 14: 20' RIGHT-OF-WAY, DATED SEPT 04 1968. ENTRY 2258566 / BOOK 2688 PACIFICORP EASEMENT, DATED FEB 10, 1994. ENTRY 5736925 / BOOK 6870 SEC. WATER EASEMENT, DATED MAR 06, 1996. ENTRY 6296834 / BOOK 7345 PUBLIC UT. EASEMENT, DATED FEB 05, 2004. ENTRY 8971087 / BOOK 8942 QUESTAR EASEMENT, DATED FEB 08, 2008. ENTRY 10343795 / BOOK 9568

EXCEPTION 22: QUESTAR EASEMENT, DATED FEB 08, 2008. ENTRY 10343796 / BOOK 9568 TITLE COMMITMENT PROVIDED BY CLIENT AND PREPARED BY FIRST AMERICAN TITLE

General Notes

PLAYGROUND DESIGN SHOWN FOR REFERENCE ONLY. REFER TO x PLANS FOR FINAL

. UTILITY CROSSING. CONTRACTOR TO FIELD VERIFY AND NOTIFY ENGINEER OF RECORD OF CONFLICTS, PRIOR TO CONSTRUCTION.

Key Notes (Water

W1. 2" WATER LINE SERVICE TAP PER SOUTH JORDAN STANDARD DRAWING 3095. W2. 1" IRRIGATION LINE SERVICE TAP PER SOUTH JORDAN STANDARD DRAWING 3095. W3. 6" FIRE PROTECTION SERVICE TAP PER SOUTH JORDAN STANDARD DRAWING 3095. W4. 8" FIRE LINE CONNECTION PER SOUTH JORDAN STANDARD DRAWING 3055. W5. P.I.V. - PVC C-900 FROM MAIN TO P.I.V. / D.I.P. FROM P.I.V. TO STRUCTURE.

ENSURE P.I.V. IS BETWEEN 6' AND 40' FROM BUILDING.


Key Notes (Irrigation)

APPROX. 175 LF OF 16" IRRIGATION LINE (MATCH EXISTING). INSTALL FOUR VERTICAL 45d FITTINGS TO LOWER TOP OF NEW 16" PIPE NO HIGHER THAN 4391.50', ENSURING 2.5' FEET OF COVER TO BOTTOM OF BASIN. INSTALL BLOW-OFF VALVE ON LOWERED PORTION OF NEW IRRIGATION LINE.

South Valley Sewer District Notes

- ALL CONSTRUCTION SHALL COMPLY WITH SOUTH VALLEY SEWER DISTRICT'S DESIGN STANDARDS AND CONSTRUCTION SPECIFICATIONS.
- CONTRACTOR SHALL FIELD VERIFY LOCATIONS AND INVERT ELEVATIONS OF EXISTING MANHOLES AND OTHER UTILITIES BEFORE STAKING OR CONSTRUCTING ANY NEW SEWER
- FOUR FEET OF COVER IS REQUIRED OVER ALL SEWER LINES. THE NOSE-ON FOR THE SEWER LATERAL SHALL BE PERFORMED BY SOUTH VALLEY SEWER DISTRICT (SVSD) PERSONNEL. CONTACT SVSD AT LEAST 24 HOURS PRIOR TO CONSTRUCTION.

Fitting Legend

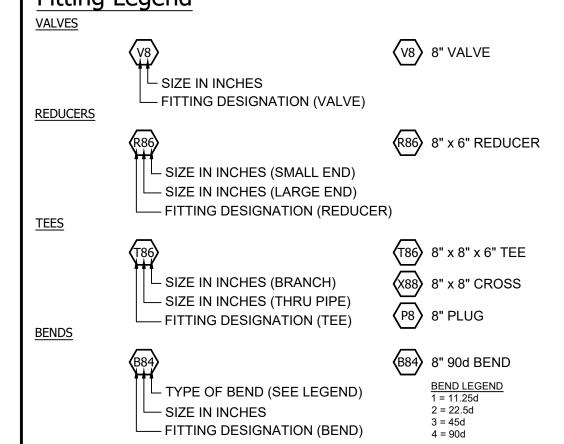

Utility Takeoffs

STORMWATER:	
4' x 4' PRE-CAST CONTROL BOX:	1 EA
12" NYLOPLAST BOX:	2 EA
2' x 4' SDCB	2 EA
CLEANOUT (SIZE VARIES):	20 EA
6" HDPE PIPE:	343 LF
8" HDPE PIPE:	313 LF
10" HDPE PIPE:	52 LF
12" ADS PIPE:	196 LF
15" RCP PIPE:	14 LF
CULINARY WATER:	
1" IPS POLY:	26 LF (MIN)
2" CTS POLY:	167 LF
6" PVC C-900 DR18:	106 LF
2" METER:	2 EA
1" METER & BACKFLOW:	1 EA
CANITADY CENTED	
SANITARY SEWER:	
4" PVC PIPE:	106 LF
6" PVC PIPE:	60 LF

Datum Information

SITE BENCHMARK: SECTION CORNER LOCATED IN REDWOOD ROAD AND SHIELDS LANE, NAVD88

1 EA

Notice To Contractors:


THE EXISTENCE AND LOCATION OF ANY UNDERGROUND UTILITIES OR STRUCTURES SHOWN ON THESE PLANS WERE OBTAINED FROM AVAILABLE INFORMATION PROVIDED BY THE SURVEYOR MADE. IF ANY CONFLICT/DISCREPENCIES ARISE, PLEASE CONTACT THE ENGINEER OF RECORD IMMEDIATELY. THE CONTRACTOR IS REQUIRED TO CONTACT THE UTILITY COMPANIES AND TAKE PRECAUTIONARY MEASURES TO PROTECT ANY UTILITIES SHOWN OR NOT SHOWN ON




3445 Antelope Drive, St 200

Syracuse, UT 84075

PH: 801.664.4724

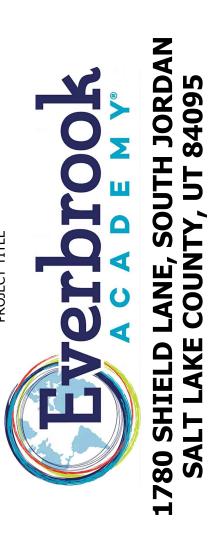

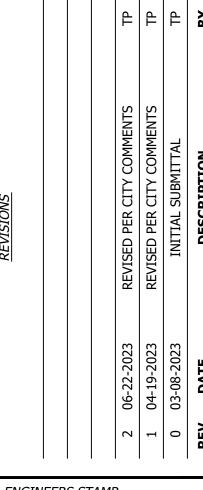



VERIFY SCALES

BAR IS ONE INCH ON ORIGINAL DRAWING


IF NOT ONE INCH ON THIS SHEET, ADJUST SCALES ACCORDINGLY

PROJECT INFO. Engineer: T. Hunt Drawn: T. Pridemore Checked: Date: 12 / 09 / 2022

SHEET TITLE

Utility Plan

SHEET NO.

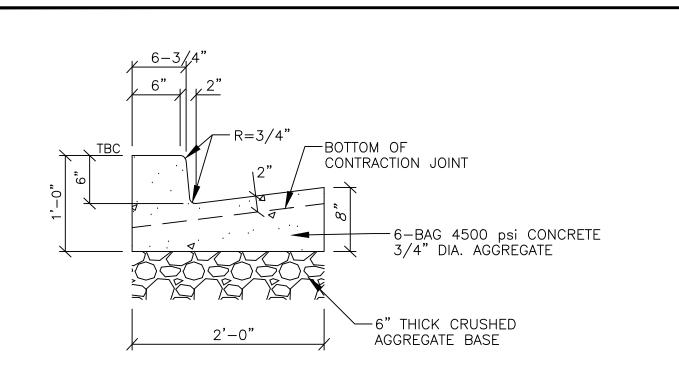




5" THICK CRUSHED

AGGREGATE BASE

6-BAG 4500 psi CONCRETE 3/4" DIA. AGGREGATE #4 REBAR @ 18" ON CENTER BOTH WAYS.

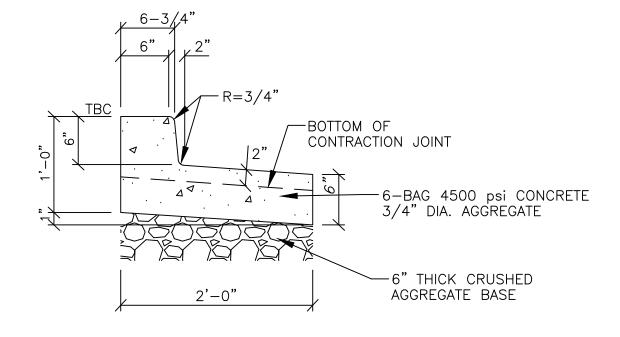

On-Site Outfall Curb & Gutter

| Scale: NTS |

WIDTH VARIES (SEE PLAN)


4" MIN. UNTREATED —

#4 DEFORMED REBAR -

"SPACE EVENLY WITHIN CURB


Concrete Sidewalk with Curb

ALL WALKWAYS TO BE FINISHED — WITH A MEDIUM BROOM TEXTURE

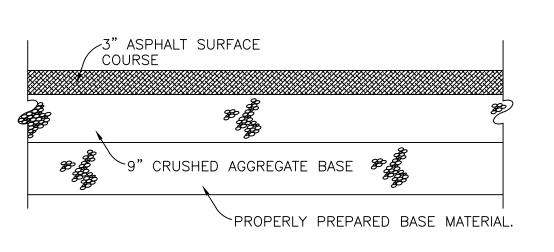


Typical On-Site Asphalt Paving

Scale: NTS

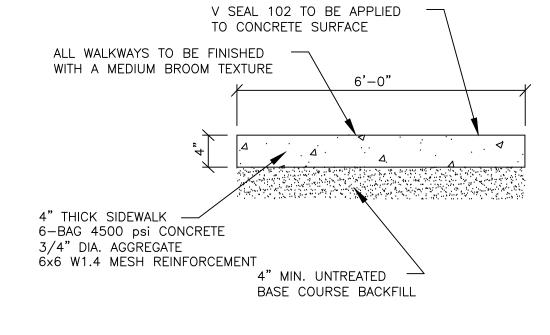


C4 Cale: NTS

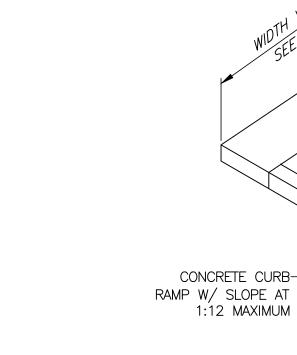


-SEE APPLICABLE CURB DETAIL


ADA Ramp at Roadway Crossing


Scale: NTS

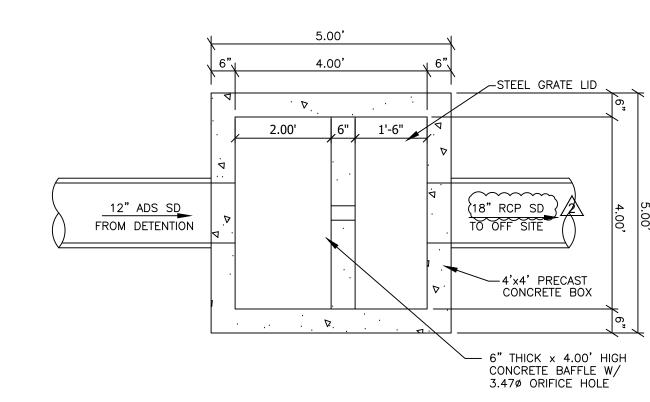



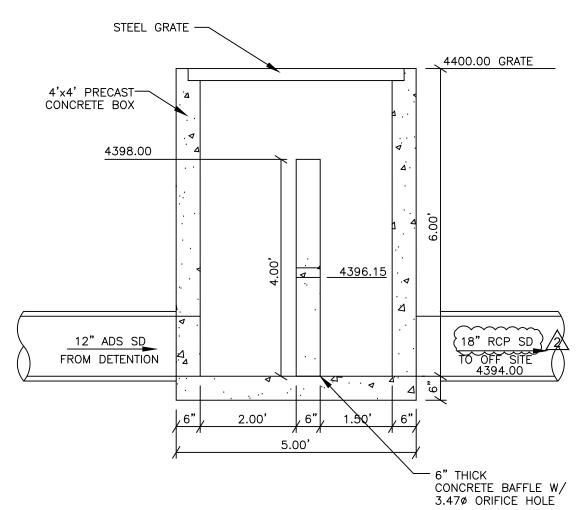

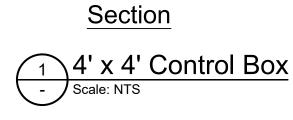


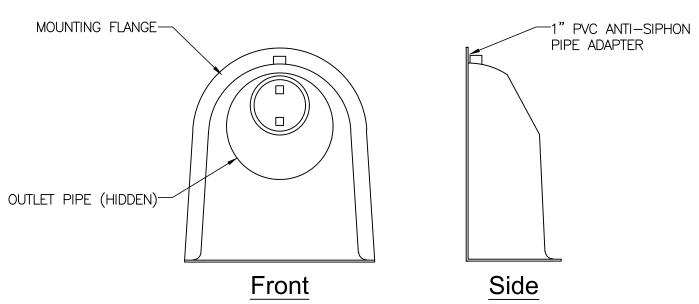


SNOUT OIL-WATER DEBRIS SEPATRATOR NOTE USE 24-HR SERIES ONLY




(REFER TO THE SITE SPECIFIC GEOTECHNICAL REPORT, GEOTECHNICAL REPORT TO GOVERN & CONTROL.)

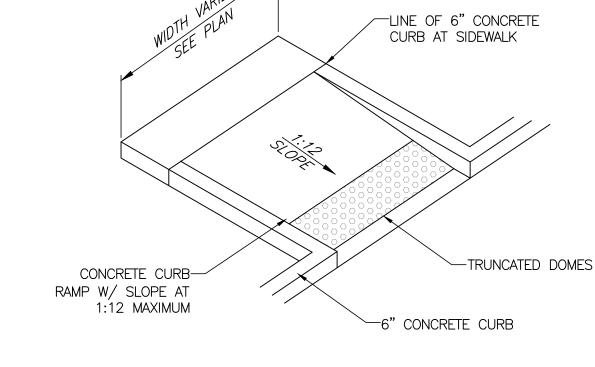

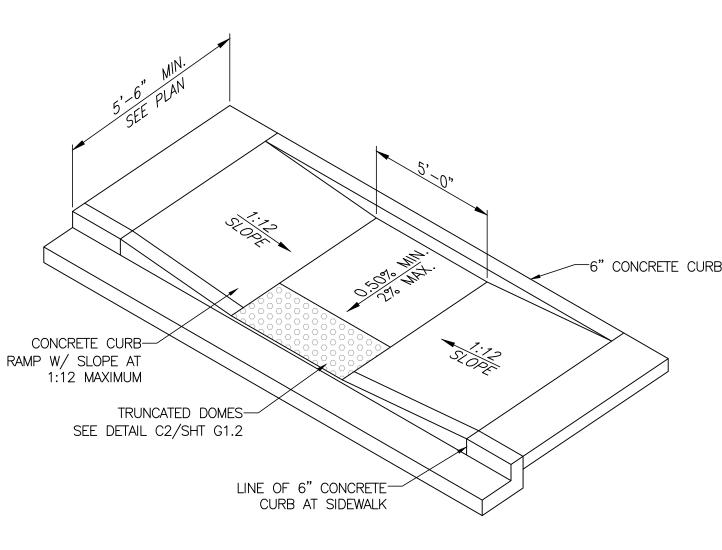


C10 ADA Ramp
Scale: NTS

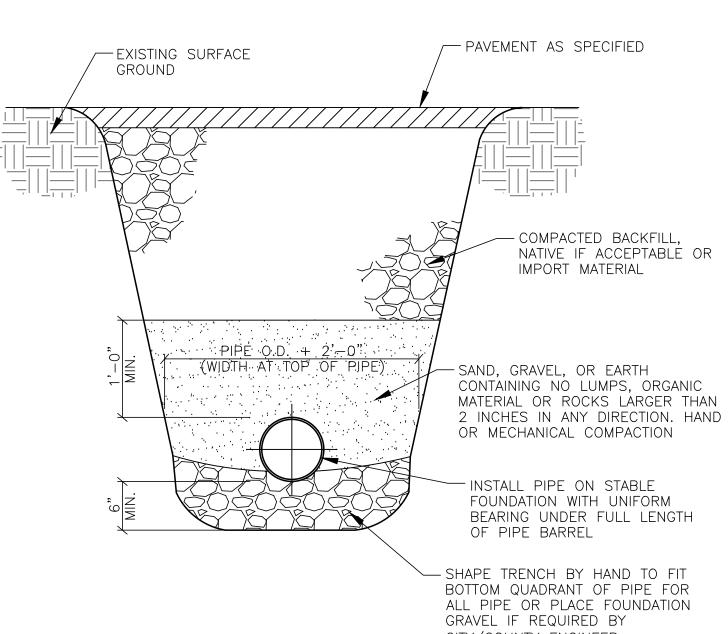


Trash Enclosure Concrete Pad Scale: NTS


Typical On-Site Pipe Bed Section

Scale: NTS

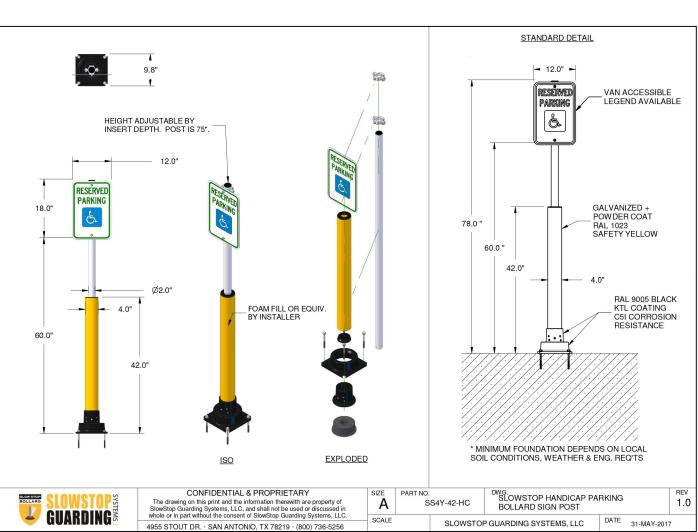

C9 ADA Parking Sign with Bollard Scale: NTS

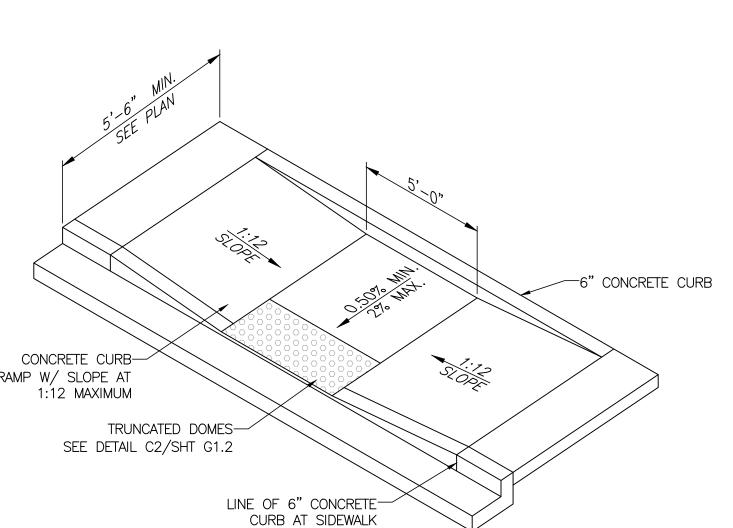

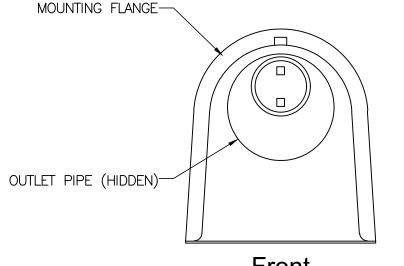



SHEET NO.

C600

ENGINEERS STAMP

VERIFY SCALES

BAR IS ONE INCH ON ORIGINAL DRAWING

IF NOT ONE INCH ON THIS SHEET, ADJUST

SCALES ACCORDINGLY

T. Pridemore

12 / 09 / 2022

Civil

Details

PROJECT INFO.

Drawn:

Checked:

SHEET TITLE

Date:

Engineer: T. Hunt


HUNT DAY

3445 Antelope Drive, St 200 Syracuse, UT 84075 PH: 801.664.4724

erbro

LANE, SOUTH JORD COUNTY, UT 84095



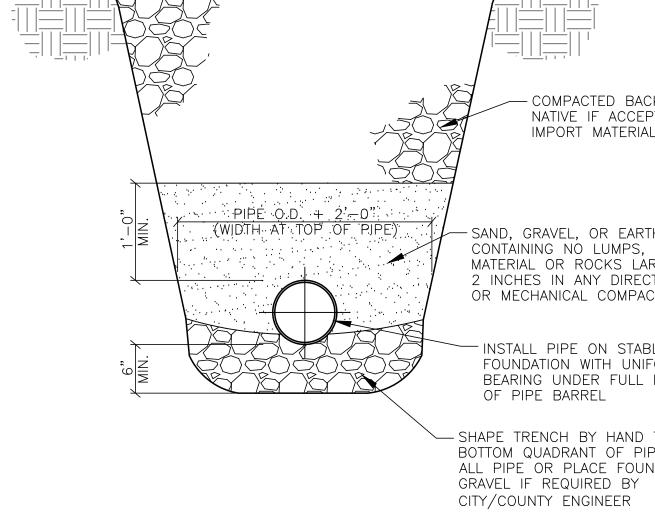


Open driveway approach

- UNTREATED BASE COURSE: Provide material specified in APWA Section 32 11 23.
 Do not use gravel as a substitute for untreated base course without ENGINEER's
- B. Place material per APWA Section 32 05 10.
- C. Compact per APWA Section 31 23 26 to a modified proctor density of 95 percent or greater. Maximum lift thickness before compaction is 8 inches when using riding compaction equipment or 6 inches when using hand held compaction equipment.
- 2. CONCRETE: Class 4000 per APWA Section 03 30 04.
- A. If necessary, provide concrete that achieves design strength in less than 7 days. Use caution; however, as concrete crazing (spider cracks) may develop if air temperature exceeds 90 degrees F.
- B. Place concrete per APWA Section 03 30 10.
- C. Provide 1/2 inch radius on concrete edges exposed to public view.
- D. Cure concrete per APWA Section 03 39 00 with type ID Class A or B (clear with fugitive dye) membrane forming compound unless specified otherwise.
- 3. EXPANSION JOINT: Make expansion joints vertical, full depth, 1/2 inch wide with type F1 joint filler material per APWA Section 32 13 73. Set top of filler flush with surface of concrete.
- 4. CONTRACTION JOINT: Make contraction joints vertical.
- A. 1/8 inch wide and 1 inch deep or 1/4 slab thickness if slab is greater than 4 inches thick.
 B. Maximum length to width ratio for non-square panels is 1.5 to 1.
- C. Maximum panel length (in feet) is 2.5 times the slab thickness (in inches) to a maximum of 15 feet.
- 5. REINFORCEMENT: ASTM A 615, grade 60, galvanized or epoxy coated deformed steel. See APWA Section 03 20 00 requirements. Not required if driveway ramp is constructed without a cold joint.
- 6. FIELD CHANGES TO SLOPE REQUIREMENTS: The following design parameters are to be used as a guide. Specific uses or site conditions may require profile design submittal for review and acceptance.
- A. As a rule, driveway grades may have a 6 percent change in slope over a 11 feet wheel base run for both crest or sag vertical curves.
- B. Where heavy truck use and fire truck access applies, or to improve design speed, design grades should be cut in half.
- 7. FINISH: Broomed.
- 8. PROTECTION AND REPAIR:
- A. Fill flow-line with water. Repair construction that doesn't drain.
- B. Protect concrete from deicing chemicals during cure period.

Concrete sidewalk


- UNTREATED BASE COURSE: Provide material specified in APWA Section 32 11 23.
 Do not use gravel as a substitute for untreated base course without ENGINEER's
- permission.
- B. Place material per APWA Section 32 05 10.
 C. Compact per APWA Section 31 23 26 to a modified proctor density of 95 percent or greater. Maximum lift thickness before compaction is 8 inches when using
- or greater. Maximum lift thickness before compaction is 8 inches when using riding compaction equipment or 6 inches when using hand held compaction equipment.
- 2. CONCRETE: Class 4000 per APWA Section 03 30 04.
- A. If necessary, provide concrete that achieves design strength in less than 7 days. Caution; concrete crazing (spider cracks) may develop if air temperature exceeds 90 degrees F.
- B. Place concrete per APWA Section 03 30 10.
- C. Provide 1/2 inch radius on concrete edges exposed to public view
 D. Cure concrete per APWA Section 03 39 00 with type ID Class A or B (clear with fugitive dye) membrane forming compound unless specified otherwise.
- 3. EXPANSION JOINT: Make expansion joints vertical, full depth, 1/2 inch wide with
- type F1 joint filler material per APWA Section 32 13 73.


 A. Set top of filler flush with surface of concrete.
- B. Expansion joints are not required in slip formwork except at the start or end of the installation activity.
- 4. CONTRACTION JOINT: Make contraction joints vertical.
 A. 1/8 inch wide and 1 inch deep or 1/4 slab thickness if slab is greater than 4 inches
- thick.
 B. Maximum length to width ratio for non-square panels is 1.5 to 1.
- 2. Maximum longin to main rade for t
- 5. FINISH: Broomed.

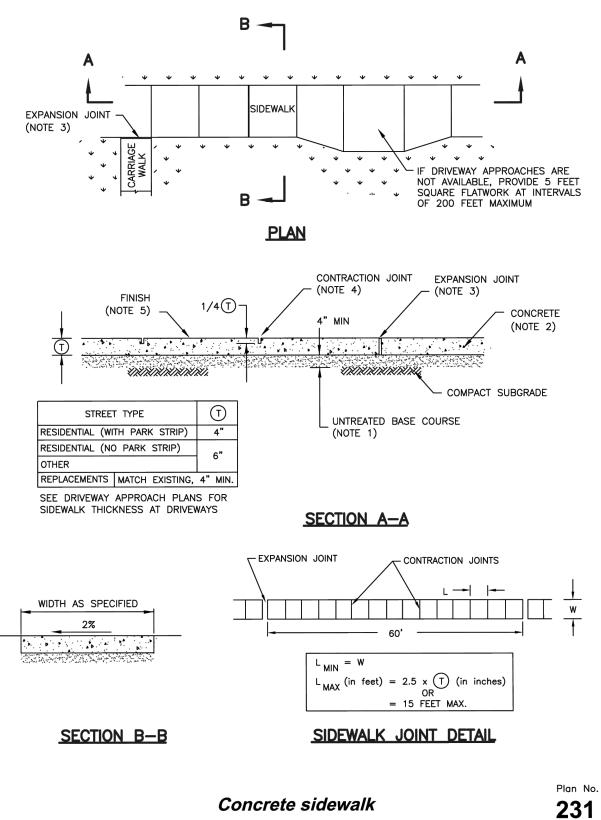

Concrete sidewalk

December 2005 51

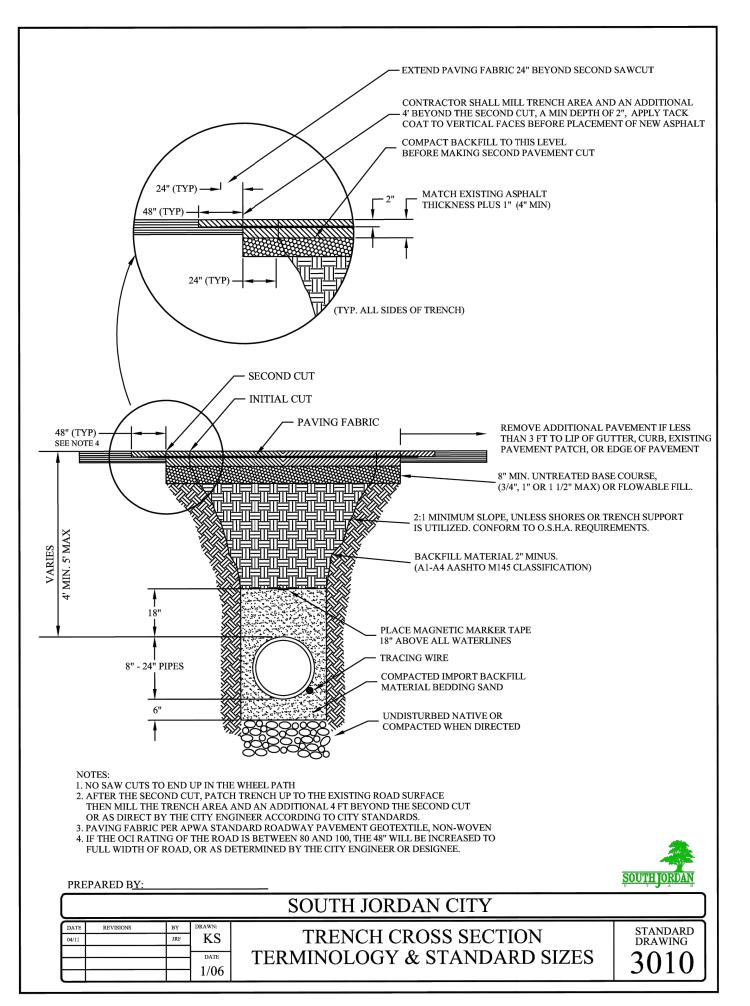

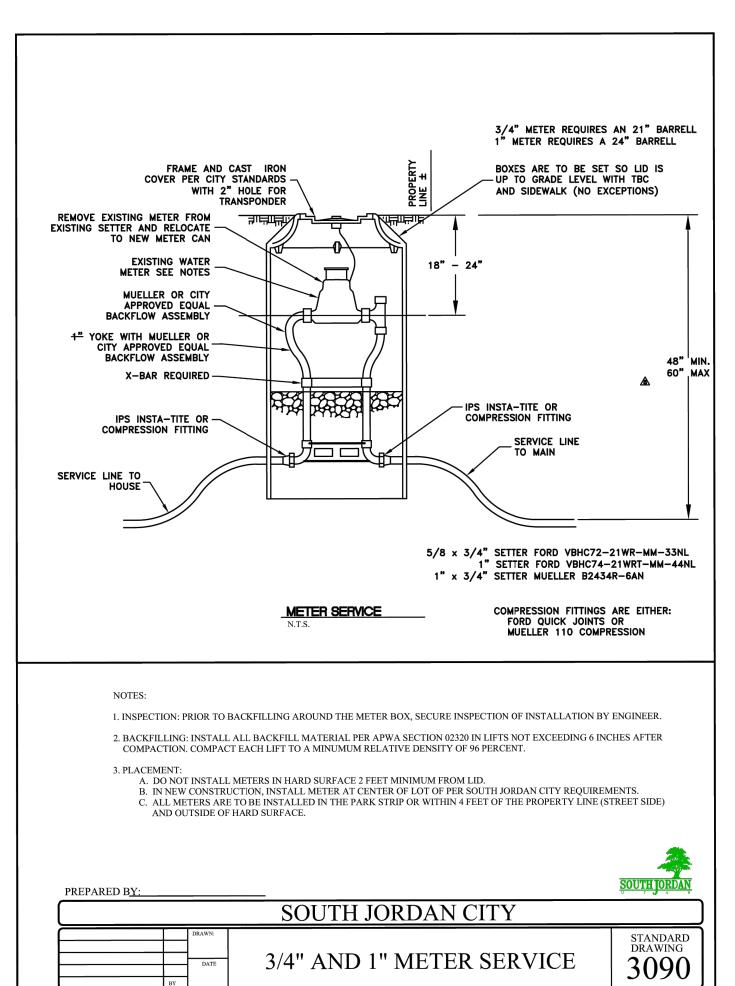

UNTREATED BASE

BREAKOVER ANGLE

(MAXIMUM)

(A) (B) (C)

6% 8% 10%

225

RESIDENTIAL 16% 12% 16%

(D) (E) (F)

6% 8% 10%

ESIDENTIAL | 16% | 12% | 16%

Y T R

OBLIQUE

SECTION A-A - APPROACH REQUIRING SERVICE TRUCK ACCESS

SECTION A-A - TYPICAL DRIVEWAY APPROACH


Open driveway approach


RESIDENTIAL 6" 6" 5 FT.

OTHER 24" 8" 5 to 25 FT.

PAVEMENT TIE-IN 751 OR 252)

December 2005

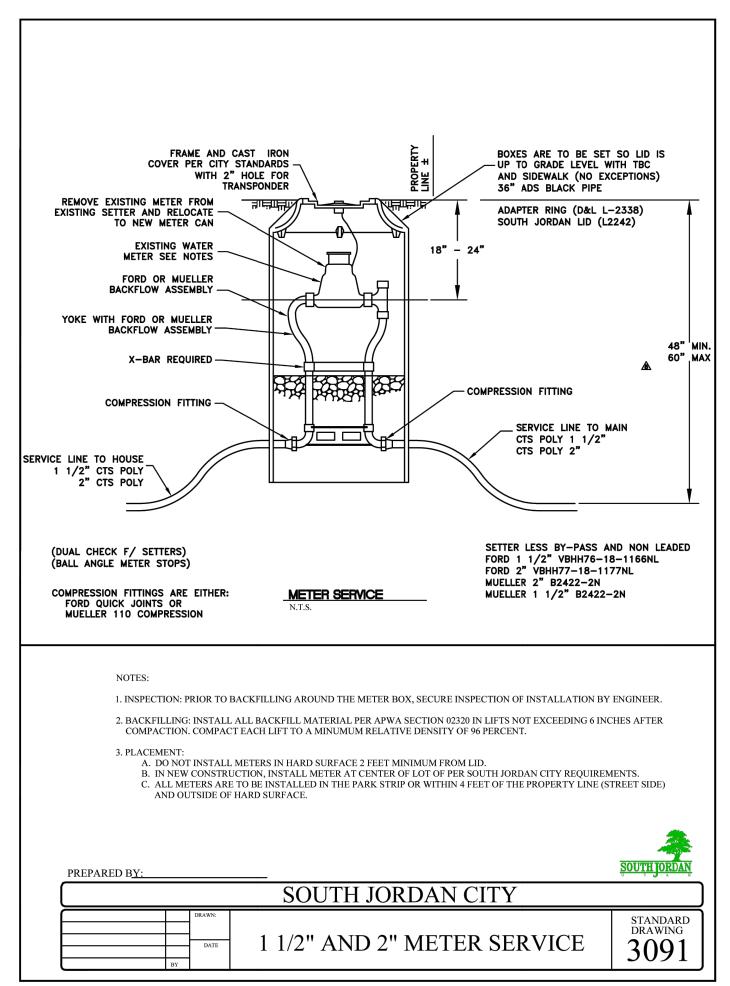

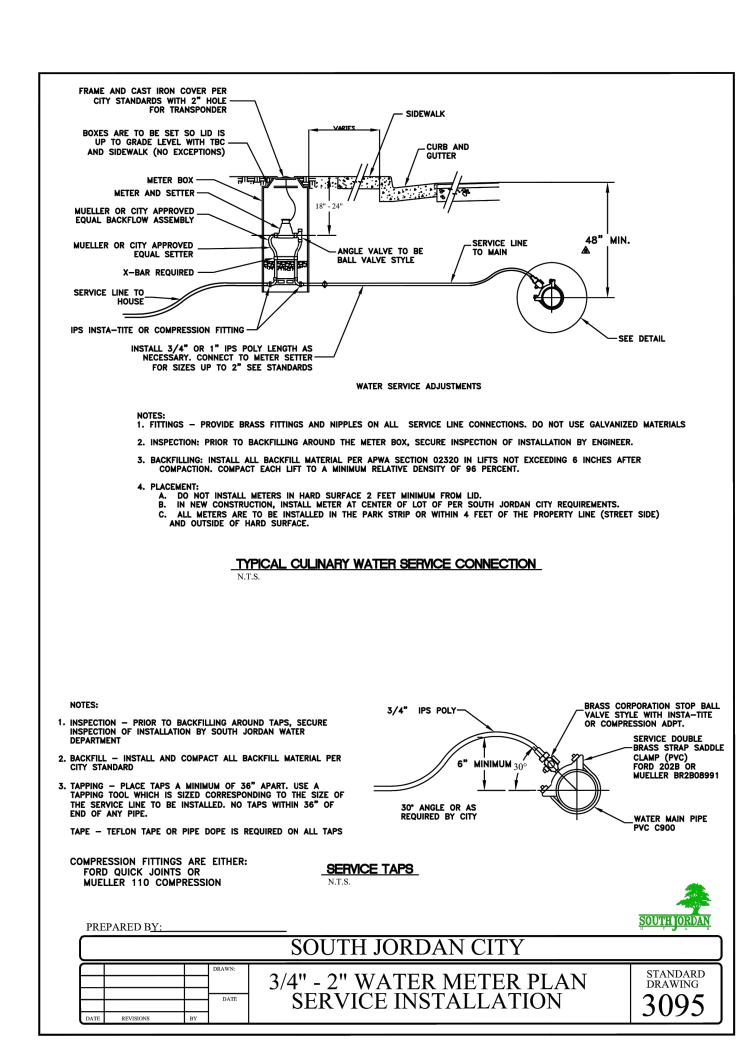





2 06-22-2023 REVISED PER CITY COMMENTS
1 04-19-2023 REVISED PER CITY COMMENTS
0 03-08-2023 INITIAL SUBMITTAL

ENGINEERS STAMP

SIONAL ENGINEERS STAMP

THOMAS J. HUNT

OG-21-2033

TATE OF UTBIL

VERIFY SCALES

BAR IS ONE INCH ON ORIGINAL DRAWING

0 1"

IF NOT ONE INCH ON THIS SHEET, ADJUST


SCALES ACCORDINGLY


PROJECT INFO.


Engineer: T. Hunt
Drawn: T. Pridemore
Checked: Date: 12 / 09 / 2022
Proj. No. SHEET TITLE


Civil Detail


SHEET NO.

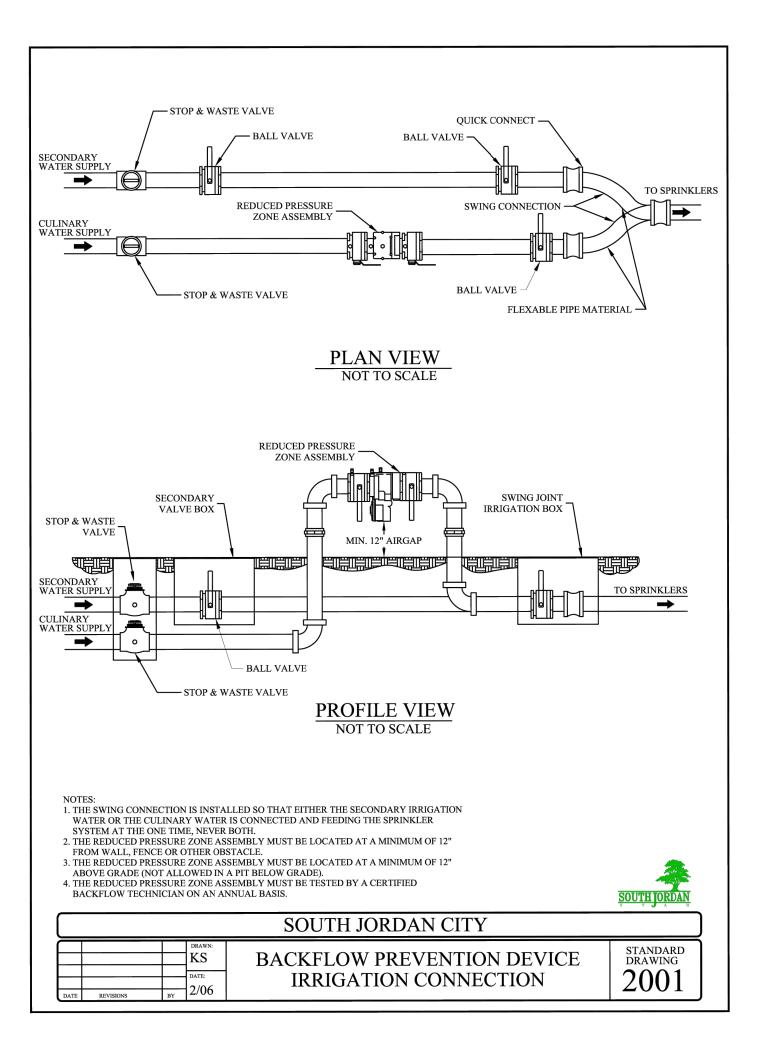


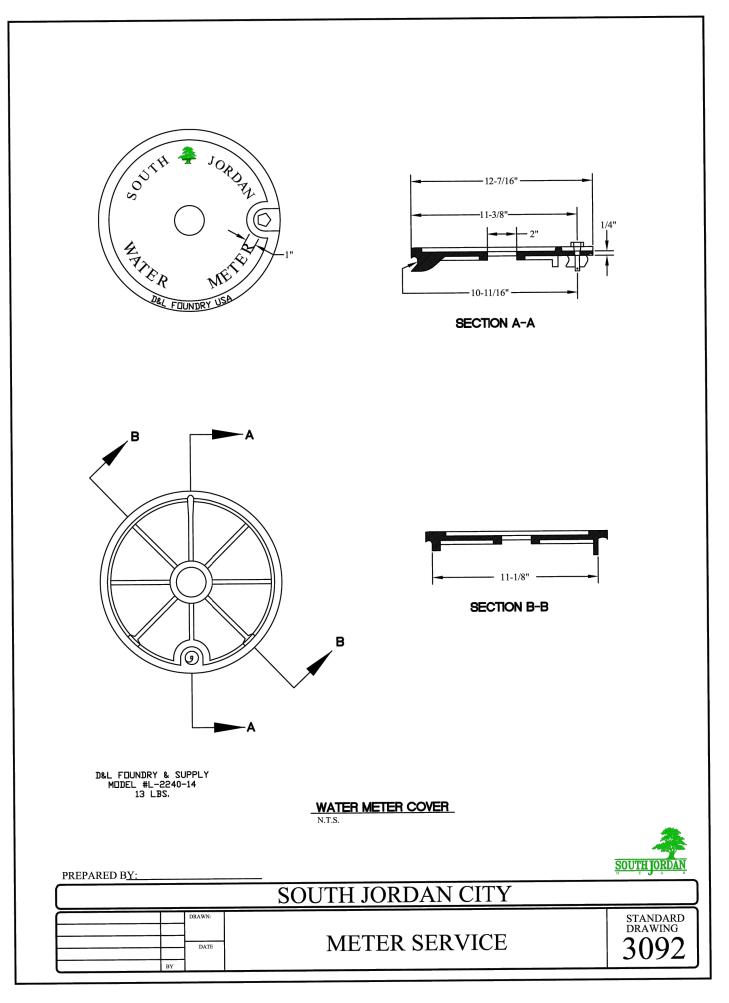


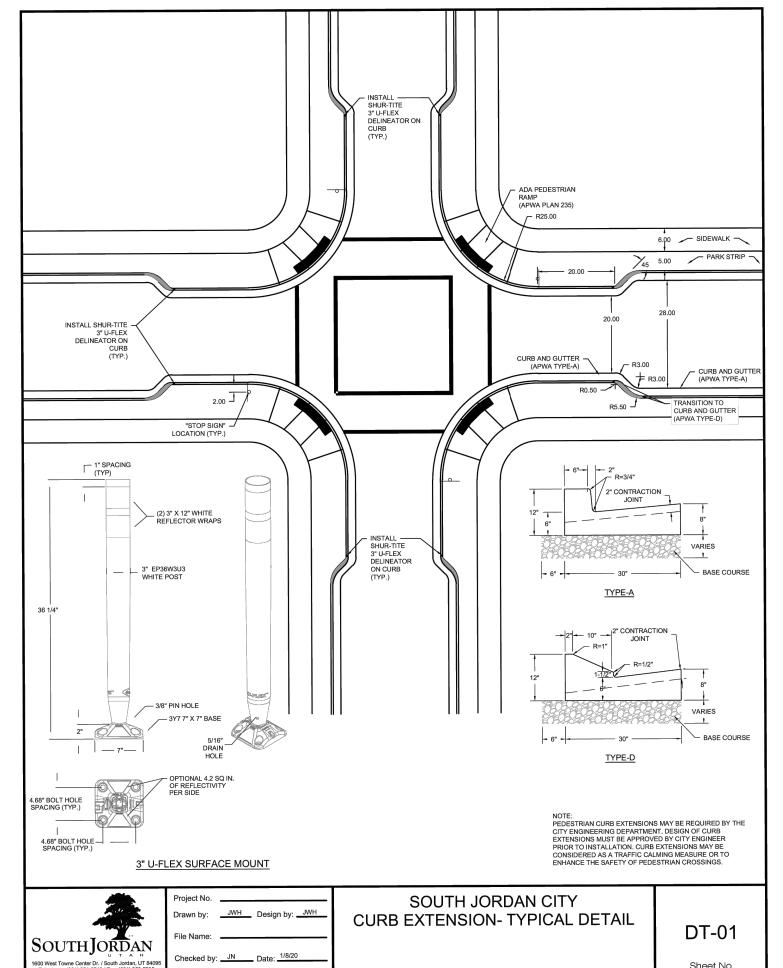

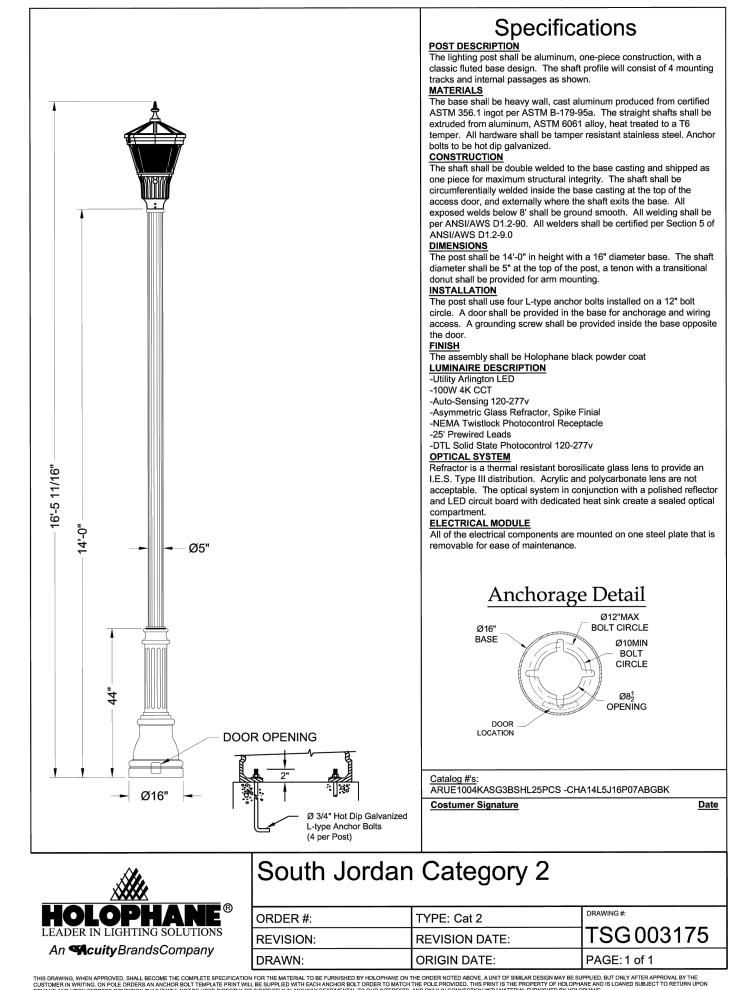


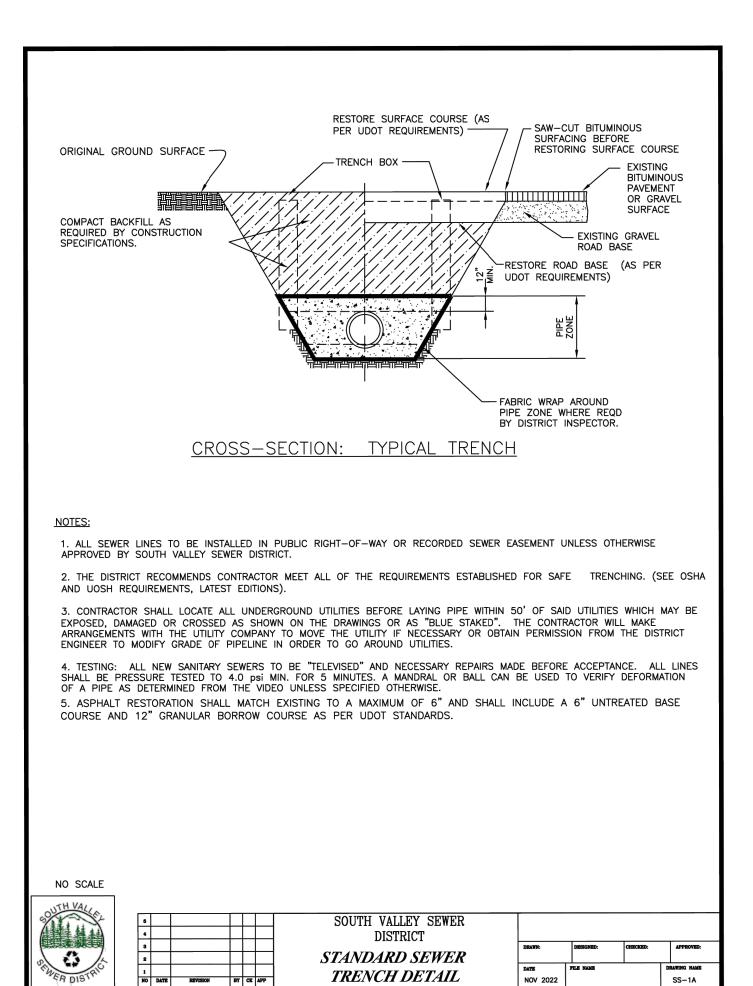


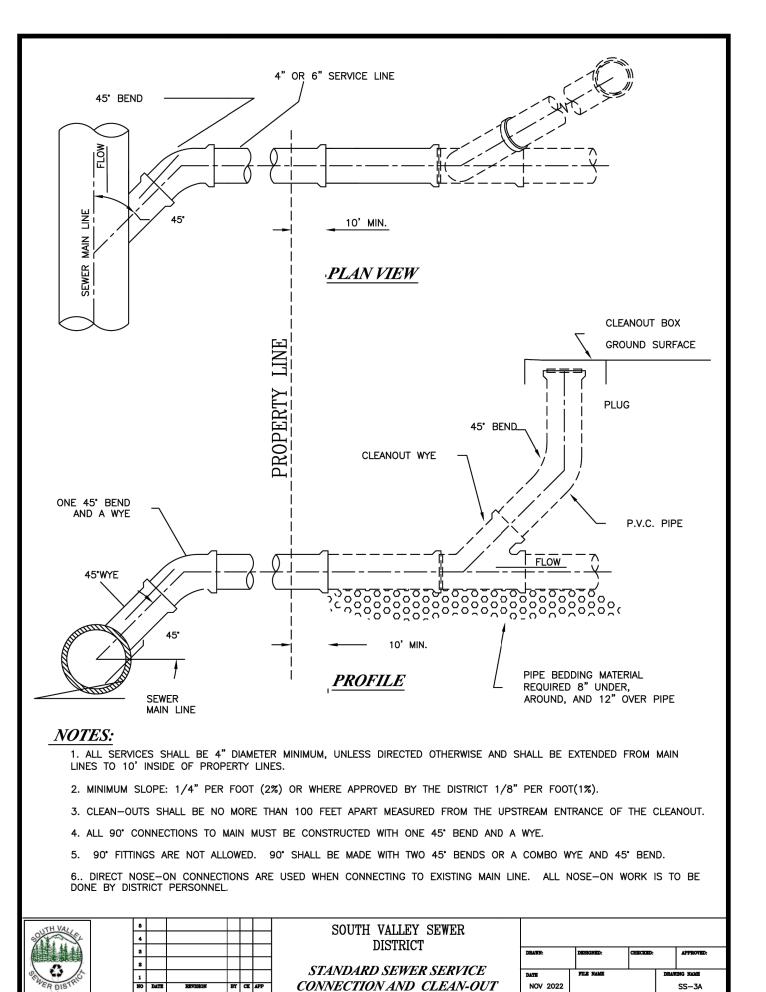


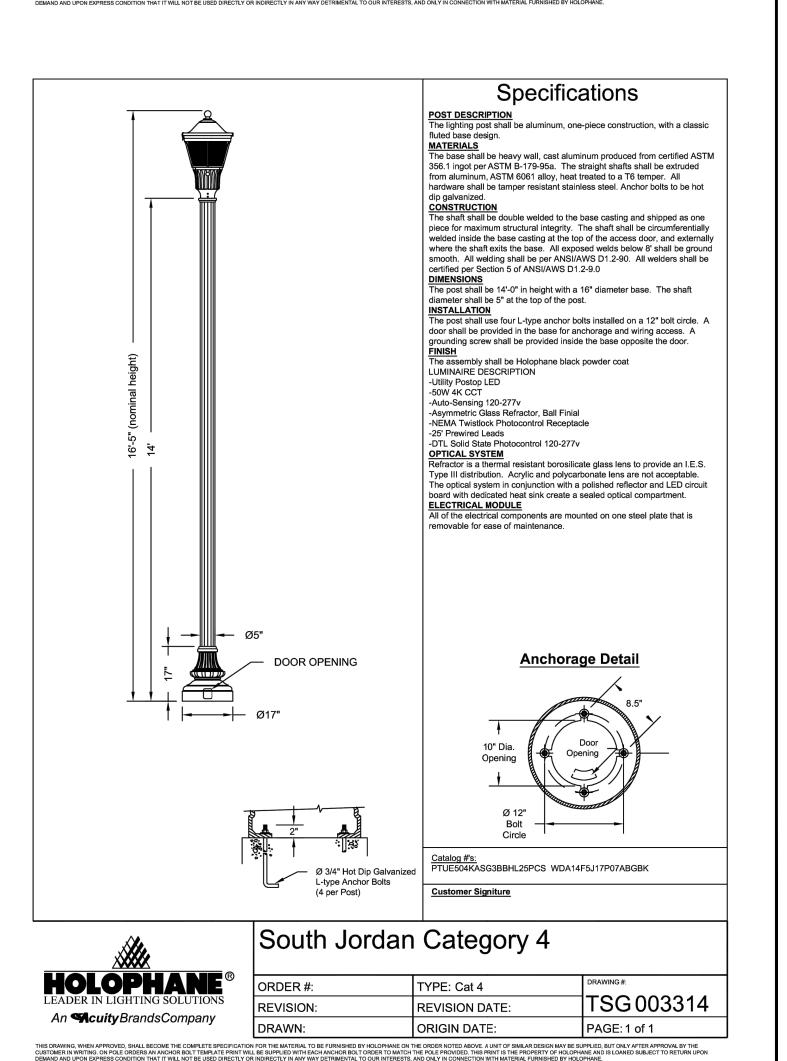



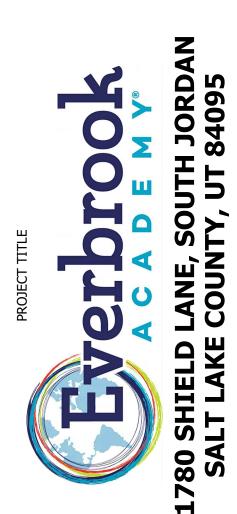

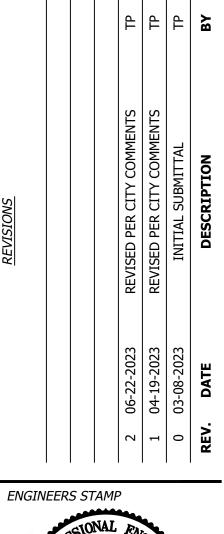

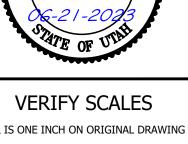

BAR IS ONE INCH ON ORIGINAL DRAWING IF NOT ONE INCH ON THIS SHEET, ADJUST SCALES ACCORDINGLY


PROJECT INFO. Engineer: T. Hunt Drawn: T. Pridemore Checked: Date: 12 / 09 / 2022 SHEET TITLE

Details

SHEET NO.

Everbrook Academy STORM WATER POLLUTION PREVENTION PLAN

LOCATED IN THE WEST HALF OF SECTION 10, TOWNSHIP 3 SOUTH, RANGE 1 WEST, SALT LAKE BASE AND MERIDIAN SOUTH JORDAN, SALT LAKE COUNTY, UT

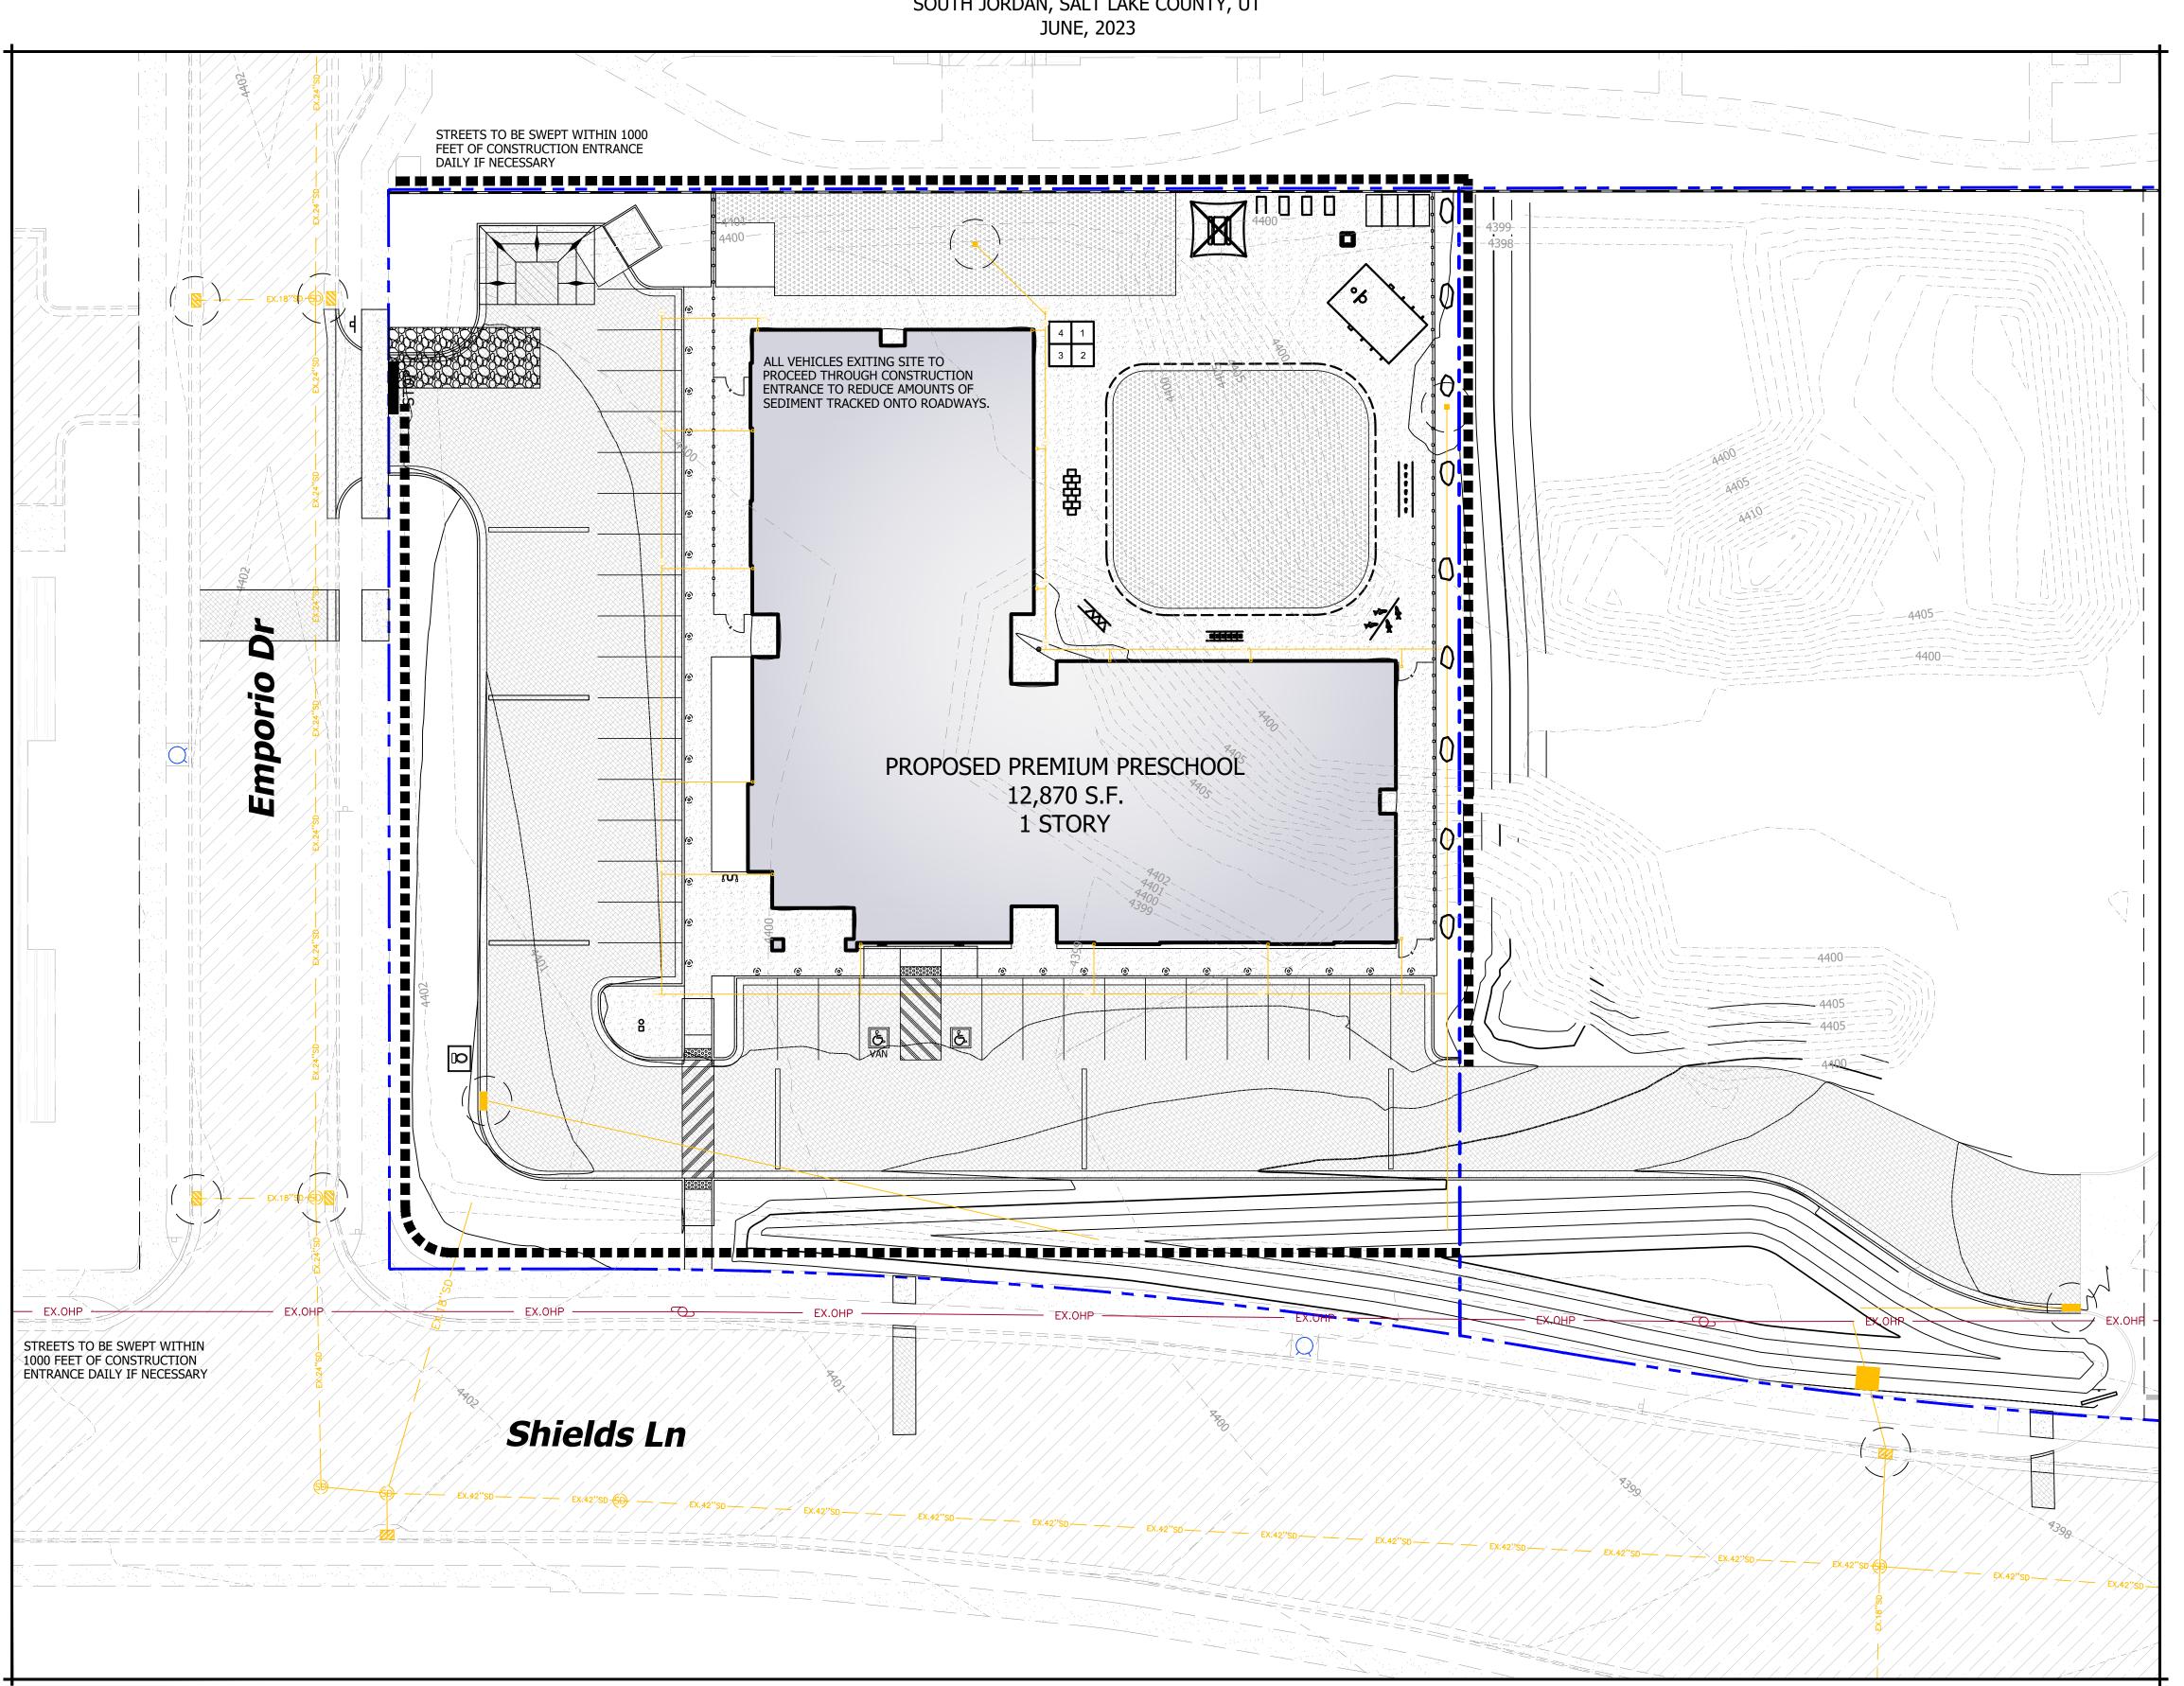

Vicinity Map



PROJECT LOCATION (LAT/LONG):
NORTHING:40°34'25" EASTING:111°56'26"

RECEIVING WATERS: GREAT SALT LAKE

- TOTAL PROJECT AREA IS 1.31 ACRES. AN ESTIMATED 1.31 ACRES WITHIN THE PROJECT
- THE EXISTING DRAINAGE SYSTEM FOR THIS SITE CONSISTS OF EXISTING STORM DRAIN
- GRADING RAISES THE SITE APPROXIMATELY 3.00' WITH ROADS OF APPROXIMATELY
- THE INITIAL SITE IS APPROXIMATELY 0% IMPERVIOUS. THE FINISHED SITE WILL BE

- PLANNED ACTIVITIES INCLUDE CONSTRUCTION OF THE INFRASTRUCTURE, VERTICAL
- INSTALL BMP'S ACCORDING TO THE PHASE OF CONSTRUCTION AS INDICATED IN THIS
- CONSTRUCTION ACTIVITIES WILL PROCEED AS FOLLOWS: ROUGH GRADING, UTILITY LANDSCAPING. AS NEW DRAINAGE ELEMENTS ARE COMPLETED, CONTRACTOR SHALL IMPLEMENT THE USE OF PROPER BMP'S AS OUTLINED IN SECTION 3.5.1B IN THE UPDES PERMIT REGULATIONS.
- SITE STABILIZATION OF AREAS DISTRIBUTED BY CONSTRUCTION ACTIVITIES MUST BE FINISHED WITHIN 14 DAYS OF COMPLETION OF CONSTRUCTION AND PRIOR TO OBTAINING AN "NOT" PERMIT.
- CLEAR SITE OF NON-ESSENTIAL MATERIALS AND CLEAN STREETS AND ASSOCIATED GUTTERS, UPON PROJECT COMPLETION AND OBTAINING "NOT" PERMIT. REMOVE TEMPORARY STORM WATER MEASURES AND PERFORM REQUIRED STORM DRAIN SYSTEM MAINTENANCE PRIOR TO RELEASE OF SYSTEM TO THE OWNER.

RUNOFF COEFFICIENTS OF DISCHARGE:


- THE EXISTING RUNOFF COEFFICIENT FOR THE PROJECT AREA IS ESTIMATED TO BE X.XX. THE PROPOSED RUNOFF COEFFICIENT WILL BE APPROXIMATELY X.XX FOR THE PROPOSED IMPROVEMENTS UPON COMPLETION OF IMPROVEMENTS.
- DISCHARGE FROM THE SITE WILL BE THROUGH THE EXISTING STORM DRAIN SYSTEM.

GENERAL STORM WATER POLLUTION CONTROL NOTES:

- FOR INSTALLATION PROCEDURES, SEE SWPPP DETAIL BEST MANAGEMENT PRACTICES (BMP) SPECIFICATIONS.
- THE BMPS AND SITE WILL BE INSPECTED AND MAINTAINED AT LEAST WEEKLY. ANY ADDITIONAL BMPS THAT ARE NEEDED WILL BE DETERMINED DURING REGULAR INSPECTIONS AND INSTALLED ACCORDING TO SPECIFICATION. ANY CHANGES TO PROTECT BMPS WILL NEED TO BE REFLECTED ON THE SWPPP MAP(S).
- SWPPP PLAN COMPILED FROM INFORMATION OBTAINED FROM MATERIAL PRODUCED BY: 345 ANTELOPE DRIVE SYRACUSE, UT 84075 PH: (801) 664-4724


ALL INFORMATION SHOWN ON SWPPP MAPS WAS TAKEN OR DERIVED FROM THE ABOVE STATED SOURCE. ANY INFORMATION NOT DEPICTED WAS NOT PROVIDED AS PART OF THIS

Legend

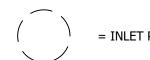

■ ■ ■ ■ = SILT FENCE

50' x 20' CONSTRUCTION ENTRANCE WITH 8" CLEAN GRAVEL

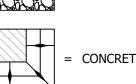


CONCRETE WASH AREA, OR AS SELECTED BY CONTRACTOR

Developer Contact:

CONNER ATKINS TAGG-N-GO EXPRESS CAR WASH 2300 W PIONEER CROSSING SARATOGA SPRINGS, UT PH: (435) 628-2256



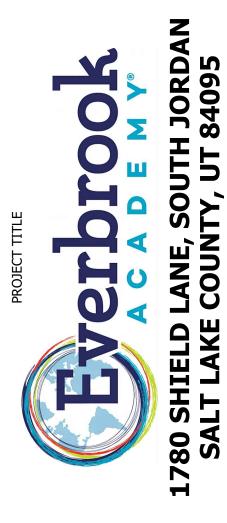

ENGINEERS STAMP

VERIFY SCALES

BAR IS ONE INCH ON ORIGINAL DRAWING

IF NOT ONE INCH ON THIS SHEET, ADJUST

SCALES ACCORDINGLY

PROJECT INFO.

Checked: 12 / 09 / 2022

SWPPP Exhibit


SHEET NO.

SWPPP Notes


PRACTICABLE.

AND LEAKS.


- AT ALL TIMES DURING CONSTRUCTION, THE CONTRACTOR SHALL BE RESPONSIBLE FOR PREVENTING AND CONTROLLING EROSION DUE TO WIND AND RUNOFF. THE CONTRACTOR SHALL ALSO BE RESPONSIBLE FOR MAINTAINING EROSION CONTROL FACILITIES SHOWN.
- THE CONTRACTOR SHALL REMOVE LITTER, CONSTRUCTION DEBRIS, AND CONSTRUCTION CHEMICALS EXPOSED TO STORM WATER, FROM THE SITE ON A DAILY BASIS, OR AS A MINIMUM, PRIOR TO ANY ANTICIPATED STORM EVENT; OR OTHERWISE PREVENT SUCH MATERIAL FROM BECOMING A POLLUTANT SOURCE FOR STORM WATER DISCHARGES.
- CONTRACTOR SHALL USE VEHICLE TRACKING CONTROL AT ALL LOCATIONS WHERE VEHICLE WILL ENTER OR EXIT THE SITE. VEHICLE TRACKING CONTROL FACILITIES, SILT FENCE, AND INLET PROTECTION WILL BE MAINTAINED WHILE CONSTRUCTION IS IN PROGRESS, MOVED WHEN NECESSARY FOR PHASING OF THE WORK, UNTIL ALL WORK IS COMPLETE.
- CONTRACTOR SHALL BE RESPONSIBLE FOR KEEPING STREETS CLEAN OF DEBRIS FROM TRAFFIC FROM THE SITE. IF SEDIMENT ESCAPES THE CONSTRUCTION SITE, THE CONTRACTOR SHALL REMOVE OFF-SITE ACCUMULATIONS OF SEDIMENT IMMEDIATELY TO MINIMIZE OFF SITE IMPACTS. AT NO TIME SHALL SEDIMENT BE WASHED DOWN UNPROTECTED INLETS INTO THE PUBLIC STORM SEWER SYSTEM.
- CONTRACTOR SHALL BE RESPONSIBLE FOR CLEANING DRAINAGE AND EROSION CONTROL FACILITIES AS REQUIRED, AND SHALL REMOVE SEDIMENT FROM SEDIMENT TRAPS OR PONDS WHEN THE DESIGN CAPACITY HAS BEEN REDUCED BY 50%.
- EXCEPT AS PROVIDED IN (A), (B), AND (C) BELOW, THE CONTRACTOR SHALL INITIATE STABILIZATION MEASURES AS SOON AS PRACTICABLE IN PORTIONS OF THE SITE WHERE CONSTRUCTION ACTIVITIES HAVE TEMPORARILY OR PERMANENTLY CEASED, BUT IN NO CASE MORE THAN 14 DAYS AFTER THE CONSTRUCTION ACTIVITY IN THAT PORTION OF THE SITE HAS TEMPORARILY OR PERMANENTLY CEASED.
 - (A)WHERE THE INITIATION OF STABILIZATION MEASURES BY THE 14TH DAY AFTER CONSTRUCTION ACTIVITY TEMPORARILY OR PERMANENTLY CEASES IS PRECLUDED BY SNOW COVER OR FROZEN GROUND CONDITIONS. STABILIZATION MEASURES SHALL BE INITIATED AS SOON AS
 - PRACTICABLE (B)WHERE CONSTRUCTION ACTIVITY ON A PORTION OF THE SITE IS TEMPORARILY CEASED, AND EARTH DISTURBING ACTIVITIES WILL BE RESUMED WITHIN
 - 21 DAYS, TEMPORARY STABILIZATION MEASURES DO NOT HAVE A TO BE INITIATED ON THAT PORTION OF THE SITE. (C) IN ARID AREAS (AREAS WITH AN AVERAGE ANNUAL RAINFALL OF 0-10 INCHES), SEMI-ARID AREAS (AREAS WITH AN AVERAGE ANNUAL RAINFALL OF 10-20 INCHES), AND AREAS EXPERIENCING DROUGHTS WHERE THE INITIATION OF STABILIZATION MEASURES BY THE 14TH DAY AFTER CONSTRUCTION ACTIVITY HAS TEMPORARILY OR PERMANENTLY CEASED IS PRECLUDED BY SEASONAL ARID CONDITIONS, STABILIZATION SHALL BE INITIATED AS SOON AS
- EROSION CONTROL STRUCTURES BELOW SODDED AREAS MAY BE REMOVED ONCE SOD AND FINAL LANDSCAPING IS IN PLACE, EROSION CONTROL STRUCTURES BELOW SEEDED AREAS MUST REMAIN IN PLACE UNTIL THE ENTIRE AREA HAS ESTABLISHED A MATURE COVERING OF HEALTHY VEGETATION. EROSION CONTROL IN PROPOSED PAVED AREAS SHALL REMAIN IN PLACE UNTIL PAVEMENT IS COMPLETE.
- 8. ALL AREAS DISTURBED DURING CONSTRUCTION SHALL BE PAVED OR SEEDED PER PLAN.
- ADDITIONAL EROSION CONTROL MEASURES MAY BE REQUIRED DUE TO UNFORSEEN PROBLEMS OR IF THE PLAN DOES NOT FUNCTION AS INTENDED. A REPRESENTATIVE OF THE LOCAL JURISDICTION MAY REQUIRE ADDITIONAL CONTROL DEVICES UPON INSPECTION OF PROPOSED FACILITIES. THE CONTRACTOR SHALL BE RESPONSIBLE FOR IMPLEMENTING ANY NECESSARY CHANGES AND POSTING ANY UPDATES TO THE PLANS AND RECORDING CHANGES IN THE STORMWATER POLLUTION PLAN DOCUMENT.
- 10. THIS PLAN IS ONLY TO BE USED FOR INSTALLATION OF EROSION CONTROL FACILITIES. DO NOT USE THIS PLAN FOR FINISH GRADING OR STORM SEWER CONSTRUCTION.
- 11. THE CONTRACTOR SHALL AMEND THE STORM WATER POLLUTION PREVENTION PLAN (SWPPP) WHENEVER:
 - · THERE IS A CHANGE IN DESIGN, CONSTRUCTION OPERATION, OR MAINTENANCE, WHICH HAS A SIGNIFICANT EFFECT ON THE DISCHARGE OF POLLUTANTS TO THE WATERS OF THE STATE AND WHICH HAS NOT OTHERWISE BEEN ADDRESSED IN THE PLAN; - INSPECTIONS OR INVESTIGATIONS BY SITE OPERATORS, LOCAL, STATE, OR FEDERAL OFFICIALS INDICATE THE SWPPP IS PROVIING INEFFECTIVE IN ELIMINATING OR SIGNIFICANTLY MINIMIZING POLLUTANTS FROM SOURCES INDENTIFIED UNDER PART III.D.1 OF THE PERMIT, OR IS OTHERWISE NOT ACHIEVING THE GENERAL OBJECTIVES OF CONTROLLING POLLUTANTS IN STORM WATER DISCHARGES ASSOCIATED WITH CONSTRUCTION ACTIVITY; AND - A NEW CONTRACTOR AND/OR SUBCONTRACTOR WILL IMPLEMENT A MEASURE OF THE SWPPP IN ORDER TO IDENTIFY THEIR ROLE AND RESPONSIBILITY FOR THE SWPPP. AMENDMENTS TO THE PLAN MAY BE REVIEWED BY THE EXECUTIVE SECRETARY (OR AUTHORIZED REPRESENTATIVE) IN THE SAME MANNER AS PART III.B.2 OF THE PERMIT.
- 12. THE CONTRACTOR SHALL KEEP A RECORD OF THE DATES WHEN MAJOR GRADING ACTIVITIES OCCUR, WHEN CONSTRUCTION ACTIVITIES TEMPORARILY OR PERMANENTLY CEASE ON A PORTION OF THE SITE, AND WHEN STABILIZATION MEASURES ARE INITIATED, AND INCLUDE THIS INFORMATION IN THE SWPPP.
- 13. THE CONTRACTOR SHALL NOTE THAT FLUCTUATIONS OF THE GROUNDWATER TABLE MAY OCCUR DUE TO VARIOUS FACTORS NOT EVIDENT AT THE TIME OF PREPARATION OF THIS PLAN. THE CONTRACTOR IS RESPONSIBLE FOR OBTAINING ANY DEWATERING PERMITS REQUIRED FOR THE PROJECT.
- 14. THE PROJECT SITE IN IN FLOOD ZONE "X" WHICH DENOTES AREAS OUTSIDE THE 0.2% ANNUAL CHANCE OF FLOOD.
- THERE ARE NO SURFACE WATER FEATURES LOCATED ON THIS SITE.
- 16. THE TEMPORARY PARKING AND STORAGE AREA SHALL ALSO BE USED AS THE EQUIPMENT MAINTENANCE AREA, EQUIPMENT CLEANING AREA. EMPLOYEES BREAK AREA, AND AREA FOR LOCATING PORTABLE FACILITIES, OFFICE TRAILERS, AND TOILET FACILITIES. THE CONTRACTOR SHALL CONTAIN AND TREAT ALL LEAKS AND SPILLS FROM ANY EQUIPMENT OR FACILITIES.
- 17. ALL WASH WATER (CONCRETE TRUCKS, VEHICLE CLEANING, ETC.) SHALL BE DISPOSED OF IN A MANNER THAT PREVENTS CONTACT WITH STORM WATER DISCHARGES FROM THE SITE. CONCRETE TRUCK WASHING SHALL BE DONE AT THE LOCATION SHOWN.
- 18. MAINTAIN ON THE SITE OR HAVE READILY AVAILABLE SUFFICIENT OIL AND GREASE ABSORBING MATERIALS TO CONTAIN AND CLEANUP FUEL OR CHEMICAL SPILLS
- 19. FUGITIVE DUST BLOWING FROM THE SITE SHALL BE CONTROLLED BY SPRAYING WATER ON DRY AREAS OF THE SITE. THE USE OF MOTOR OILS AND OTHER PETROLEUM BASED OR TOXIC LIQUIDS FOR DUST SUPPRESSION OPERATIONS IS ABSOLUTELY PROHIBITED.
- 20. NO RUBBISH, TRASH, GARBAGE, OR OTHER SUCH MATERIALS SHALL BE DISCHARGED INTO DRAINAGE DITCHES OR WATERS OF THE STATE.
- 21. ALL MEASURES PRESENTED IN THE SWPPP SHALL BE INITIATED AS SOON AS PRACTICABLE.
- 22. IF THE GRAVEL CONSTRUCTION ENTRANCES ARE NOT EFFECTIVE IN REMOVING THE MAJORITY OF DIRT OR MUD FROM THE TIRES OF THE CONSTRUCTION VEHICLES, THEN THE TIRES MUST BE WASHED BEFORE THE VEHICLES ENTER THE PUBLIC ROAD. IF WASHING IS USED, PROVISIONS MUST BE MADE TO INTERCEPT THE WASH WATER AND TRAP THE SEDIMENT BEFORE IT IS CARRIED OFF THE SITE.
- 23. ALL MATERIALS SPILLED, DROPPED, WASHED, OR TRACKED FROM VEHICLES ONTO ROADWAYS OR INTO STORM DRAINS MUST BE REMOVED IMMEDIATELY.
- 24. IF SOIL STOCKPILING IS EMPLOYED ON THE SITE, SILT FENCES SHALL BE USED TO HELP CONTAIN THE SEDIMENT.
- 25. ALL TEMPORARY EROSION AND SEDIMENT CONTROL MEASURES SHALL BE DISPOSED OF WITHIN 30 DAYS AFTER FINAL STABILIZATION. FINAL STABILIZATION HAS OCCURRED WHEN ALL SOIL DISTURBING ACTIVITIES ARE COMPLETED AND A UNIFORM PERENNIAL VEGETATIVE COVER WITH A DENSITY OF 70% OF THE COVER FOR UNPAVED AREAS AND AREAS NOT COVERED BY PERMANENT STRUCTURES HAS BEEN EMPLOYED.
- 26. THE CONTRACTOR SHALL BE RESPONSIBLE FOR ADJUSTING THE EROSION CONTROL MEASURES (SILT FENCES, STRAW BALES, ETC.) DUE TO GRADE CHANGES DURING THE DEVELOPMENT OF THE PROJECT.
- 27. ALL OFF-SITE CONSTRUCTION SHALL BE STABILIZED AT THE END OF EACH WORKING DAY. THIS INCLUDES BACKFILLING OF TRENCHES FOR STORM DRAIN CONSTRUCTION AND PLACEMENT OF GRAVEL OR BITUMINOUS PAVING FOR ROAD CONSTRUCTION.
- 28. THE CONTRACTOR SHALL POST THESE PLANS AND THE SWPPP IN THE JOB TRAILER, LOG ALL CHANGES, AND UPDATE PLANS AND THE SWPPP AS REQUIRED.
- 29. THE CONTRACTOR SHALL IMPLEMENT BEST MANAGEMENT PRACTICES (BMPS) AND CONFORM TO ALL CITY AND STATE REQUIREMENTS FOR EROSION CONTROL AND STORM WATER PROTECTION.
- 30. IN THE UNLIKELY EVENT THAT A PHASE DOES NOT IMPROVE ACCESS AND/OR AN ACCESS ROAD IS CONSTRUCTED, BEST MANAGEMENT PRACTICES SHALL BE APPLIED IN ANY TEMPORARY OR PERMANENT STRUCTURES OR ACCESS POINTS.
- 31. THE CONTRACTOR SHALL COMPLETE WEEKLY INSPECTION FORMS FOR THE CITY'S RECORDS, COVERING WEEKLY INSPECTIONS AND MAINTENANCE.
- 32. EXISTING PERIMETER FENCING TO ACT AS CONSTRUCTION FENCING. IF PERIMETER FENCING IS REMOVED, A CONSTRUCTION SHALL BE INSTALLED UNTIL A NEW FENCE OR WALL IS CONSTRUCTED.

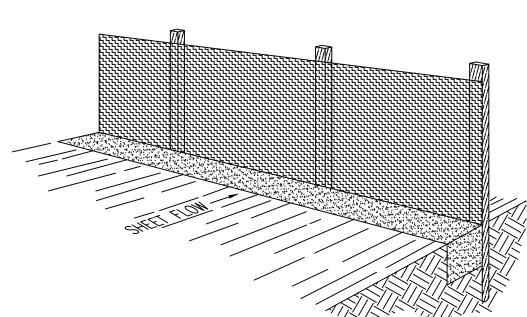

Perspective View

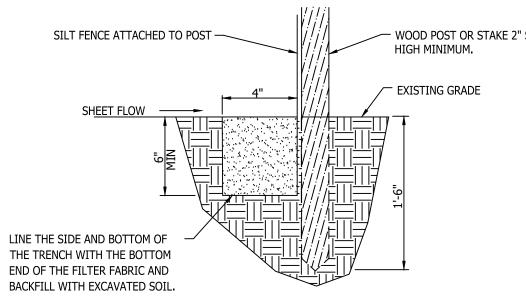



Section

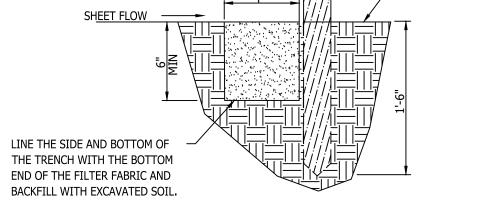


Silt Fence Notes:

- 1. WHERE POSSIBLE, LAYOUT THE SILT FENCE 5' TO 10' BEYOND THE TOE OF THE SLOPE.
- 2. ALIGN THE FENCE ALONG THE CONTOUR AS CLOSE AS POSSIBLE.
- WHEN EXCAVATING THE TRENCH, USE MACHINERY THAT WILL PRODUCE NO MORE THAN THE DESIRED DIMENSIONS.
- 4. AVOID USING JOINTS ALONG THE FENCE AS MUCH AS POSSIBLE. IF A JOINT IS NECESSARY, SPLICE THE SILT FENCE AT A POST WITH A 6" OVERLAP AND SECURELY FASTEN BOTH ENDS TO THE POST.
- MAINTAIN A PROPERLY FUNCTIONING SILT FENCE THROUGHOUT THE DURATION OF THE PROJECT OR UNTIL DISTURBED AREAS HAVE BEEN VEGETATED.
- 6. REMOVE SEDIMENT AS IT ACCUMULATES AND PLACE IT IN A STABLE AREA.
- 7. WHEN PLACING FENCE ON SLOPES STEEPER THAN 2:1 SEE SWPPP REPORT.

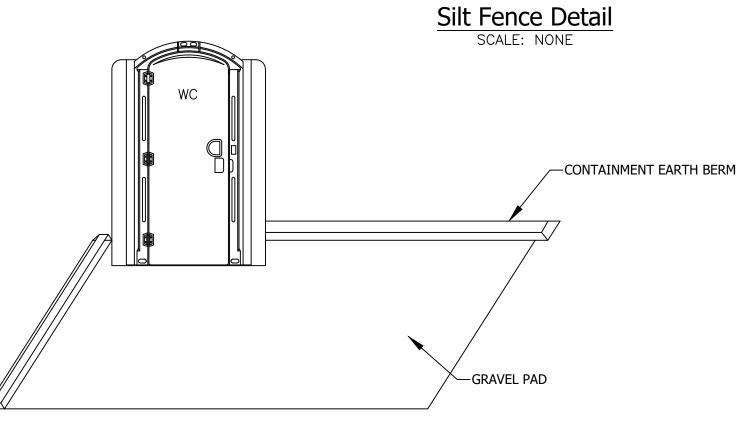


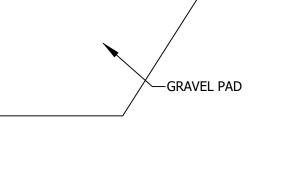


Portable Toilet

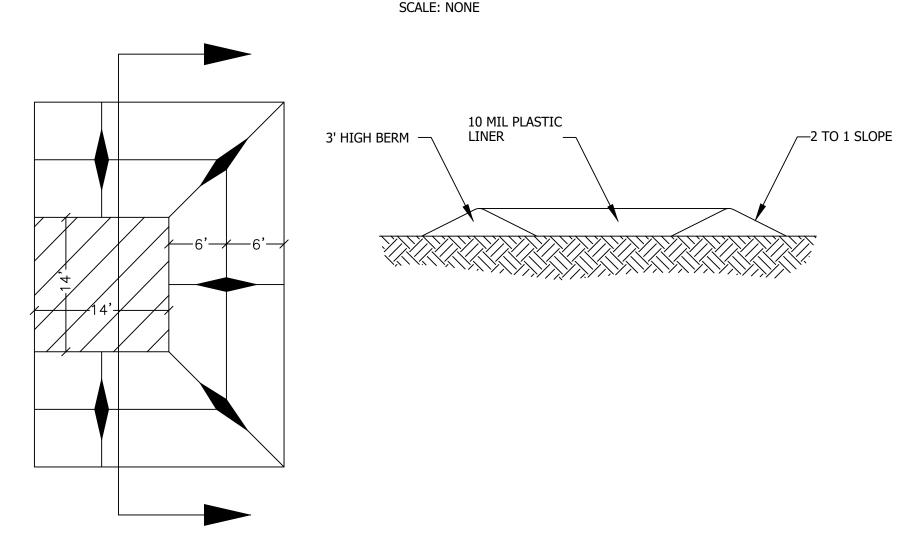


Concrete Washout Area w/ 10 mil Plastic Liner

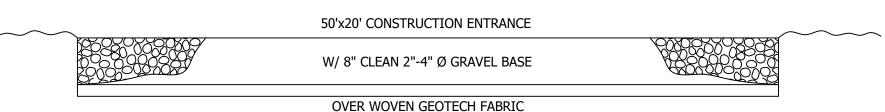


Cross Section 50' x 20' Construction Entrance

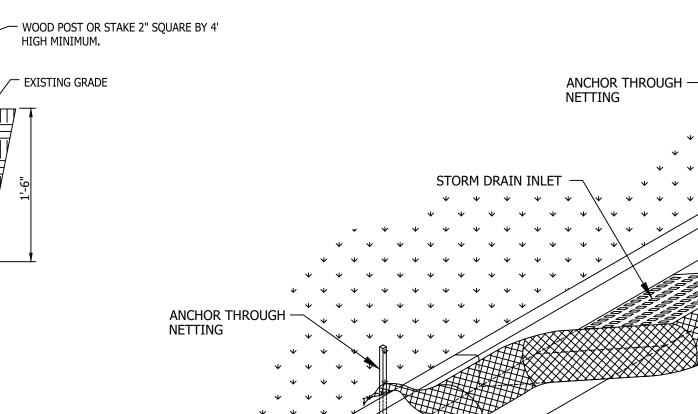


Inlet Box Protection

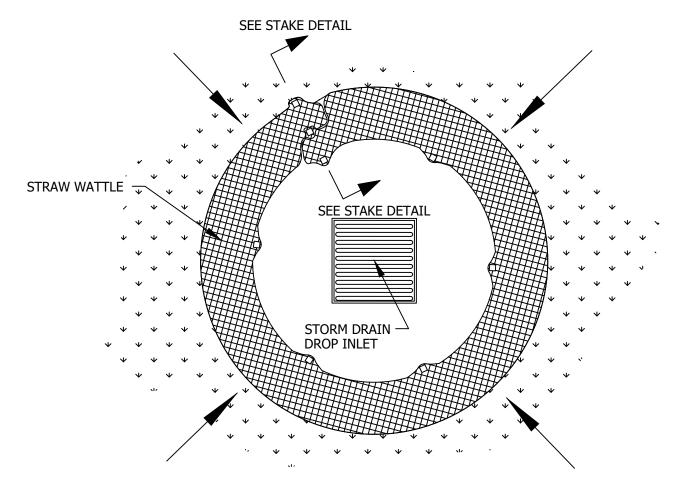

. 44.4 4 44

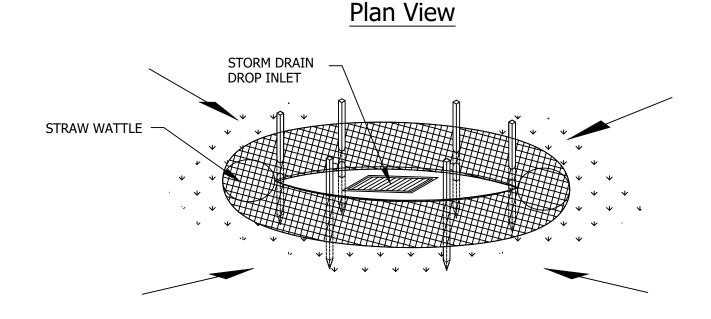

Drop Inlet Protection

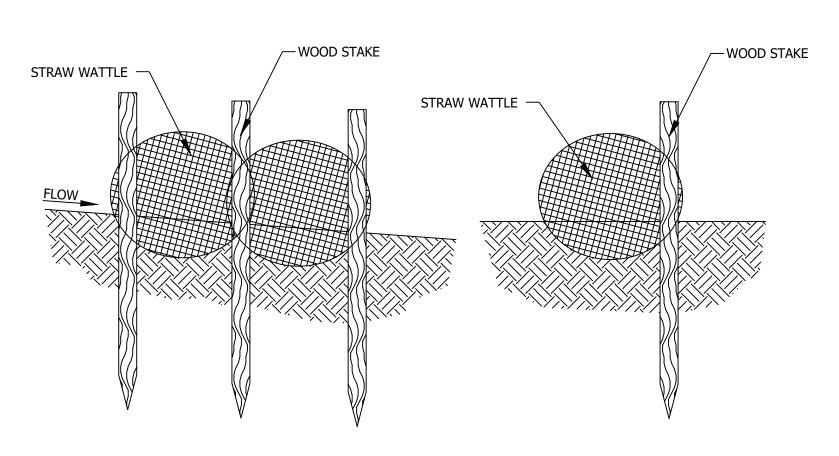





-Gravel Bags

ENGINEERS STAMP

VERIFY SCALES BAR IS ONE INCH ON ORIGINAL DRAWING IF NOT ONE INCH ON THIS SHEET, ADJUST SCALES ACCORDINGLY


PROJECT INFO. Engineer: T. Hunt Drawn: T. Pridemore Checked: Date: 12 / 09 / 2022

SHEET TITLE

SWPPP

Notes

SHEET NO.

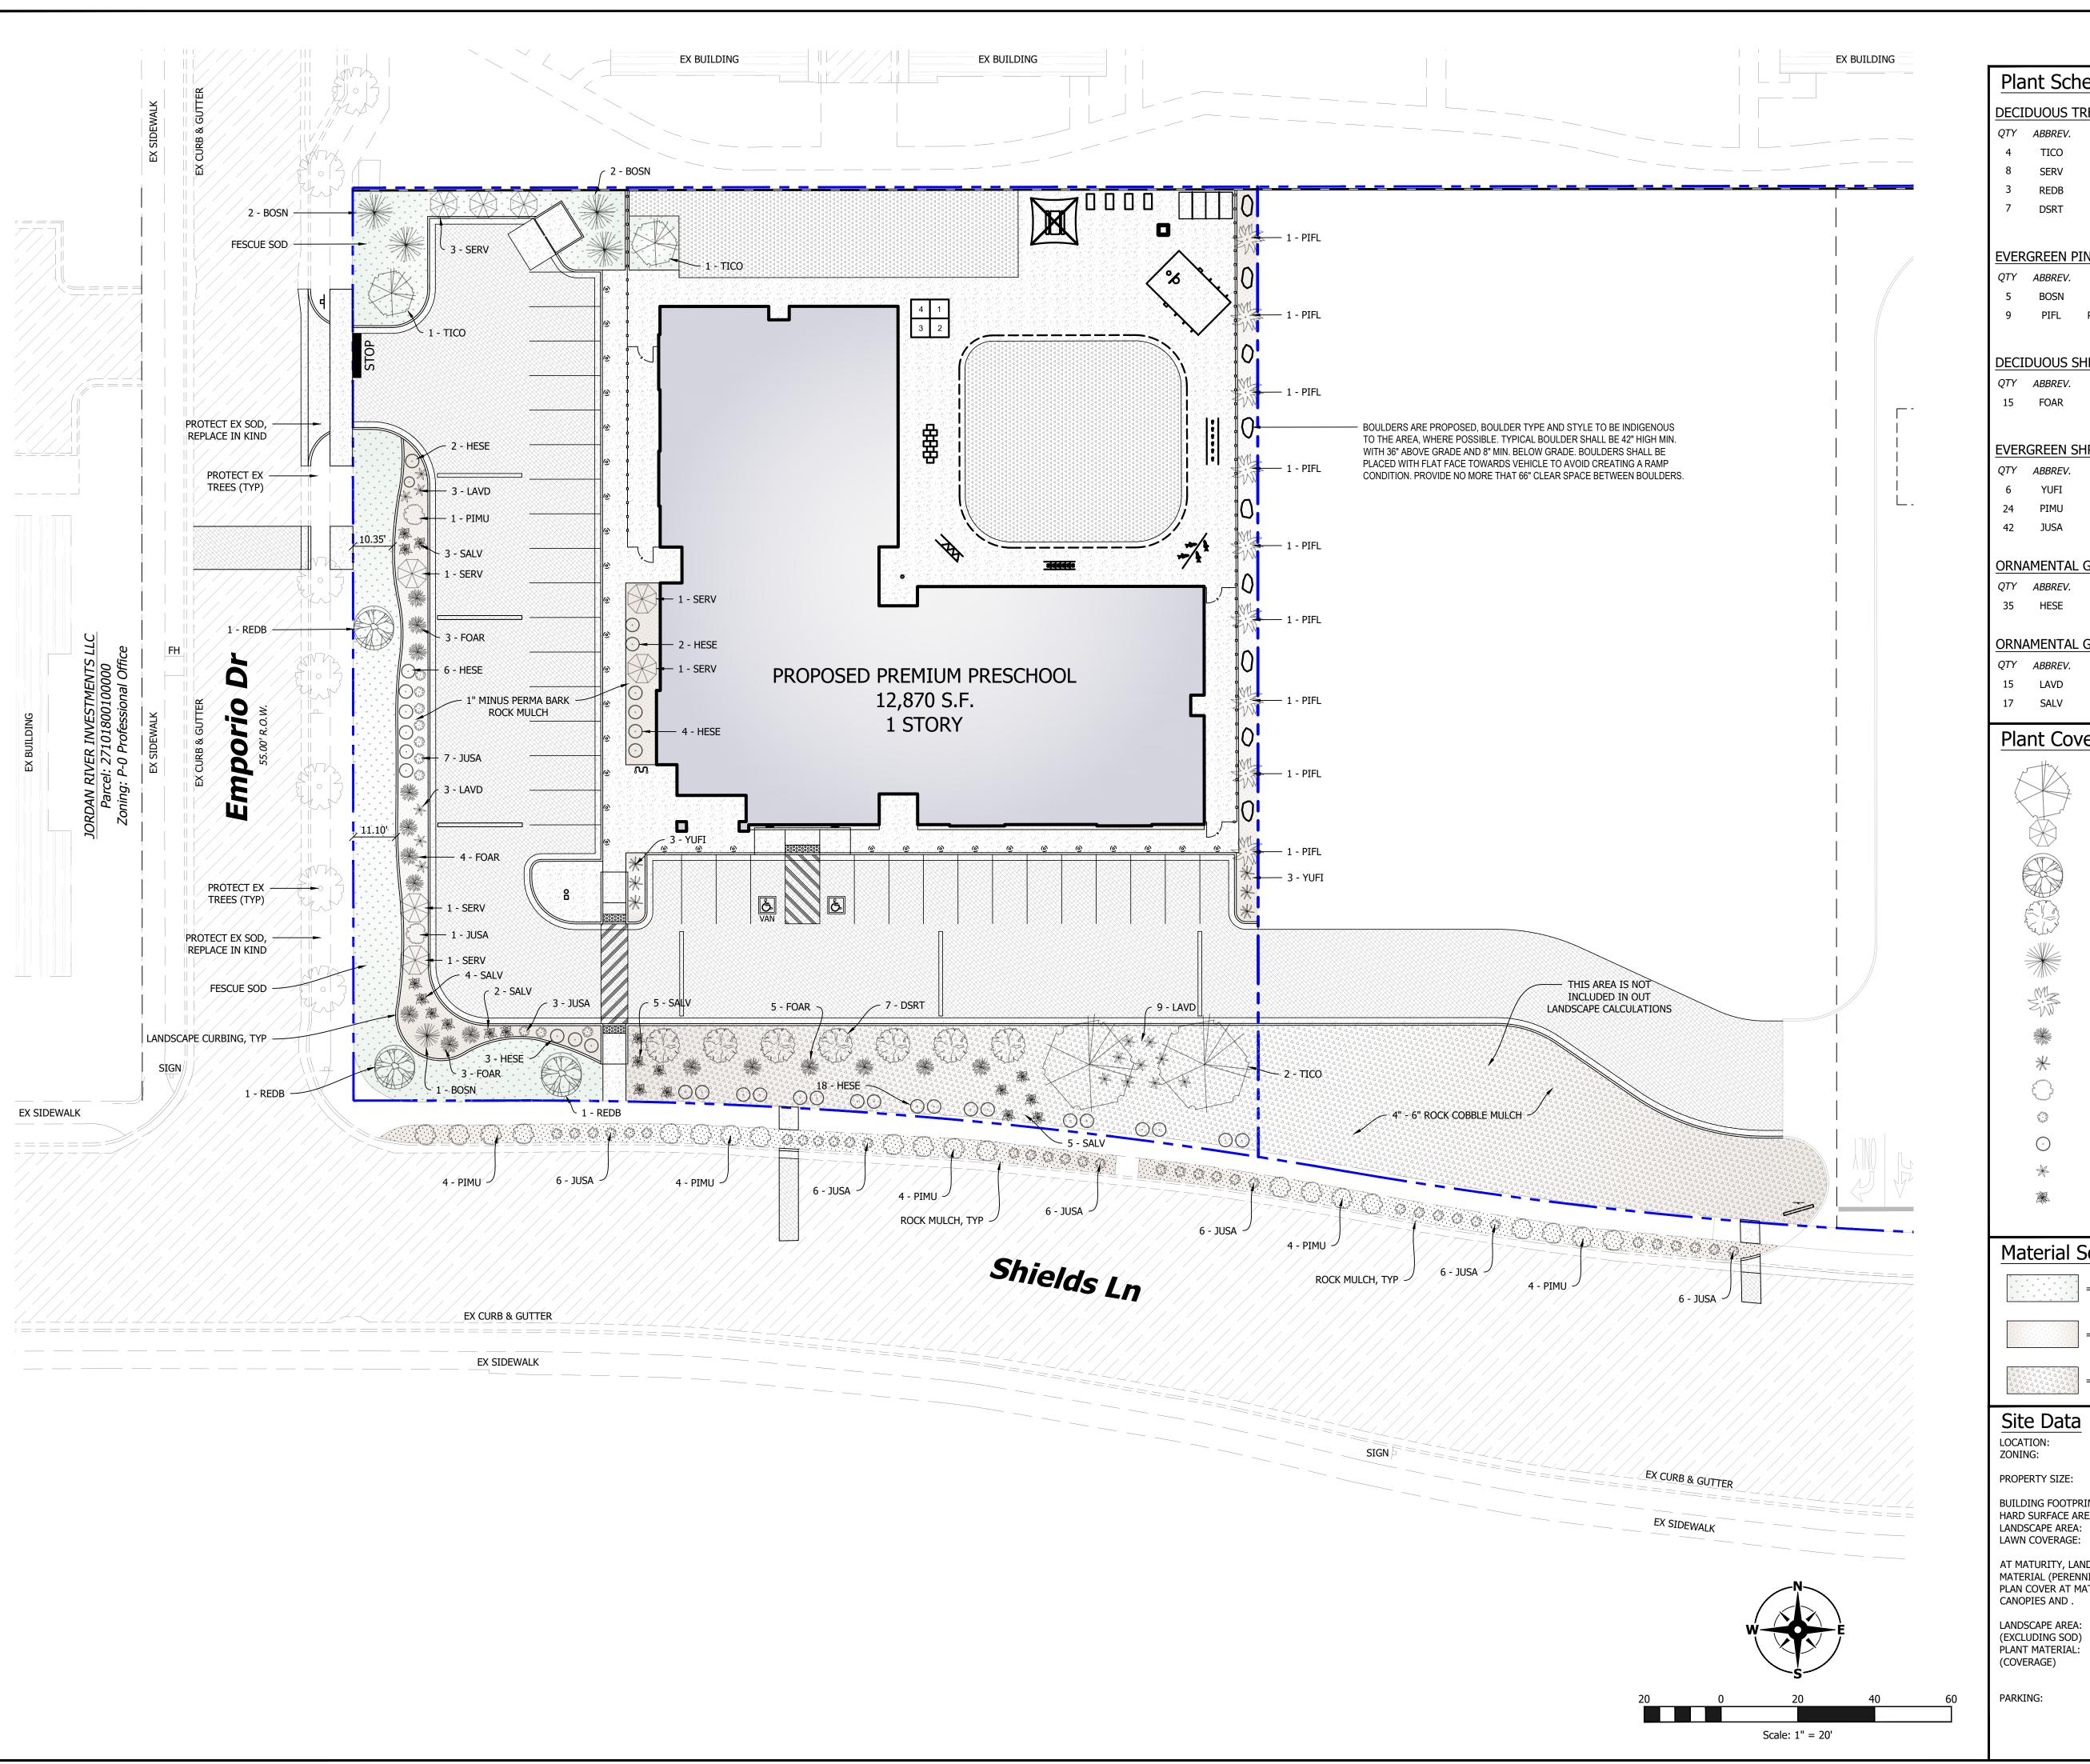



DECIDUOUS TREES

COMMON NAME **BOTANIC NAME** 4 TICO TILIA CORDATA LITTLELEAF LINDEN 8 SERV **UTAH SERVICEBERRY** AMELANCHIER UTAHENSIS REDB CERCIS OCCIDENTALIS WESTERN REDBUD DSRT CHILOPSIS LINEARIS DESERT WILLOW

EVERGREEN PINES

BOTANIC NAME COMMON NAME PINUS 'HELDRECHII' BOSNIAN PINE PINUS FLEXILIS 'VANDERWOLF'S PYRAMID' LIMBER PINE

DECIDUOUS SHRUBS

BOTANIC NAME COMMON NAME ARNOLD DWARF FORSYTHIA FORSYTHIA 'ARNOLD DWARF'

EVERGREEN SHRUBS

QTY	ABBREV.	BOTANIC NAME	COMMON NAME
6	YUFI	YUCCA FILAMENTOSA ' GOLDEN SWORD'	GOLDEN SWORD YUCCA
24	PIMU	PINUS MUGO V. PUMILO	MUGO PINE
42	JUSA	JUNIPERUS SABINA 'BUFFALO'	BUFFALO JUNIPER


ORNAMENTAL GRASSES

COMMON NAME **BOTANIC NAME BLUE AVENA** HELICTOTRICHON SEMPERVIRENS

ORNAMENTAL GRASSES

BOTANIC NAME COMMON NAME LAVANDULA ANGUSTIFOLIA 'MUNSTEAD' MUNSTEAD LAVENDER SALVIA X SYLVESTRIS 'MAY NIGHT' MAY NIGHT SALVIA

Plant Coverage

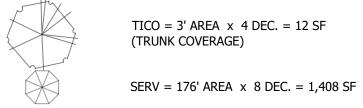

(TRUNK COVERAGE)

DSRT = 78' AREA x 7 DEC. = 546 SF

PIFL = 123' AREA x 9 PINES= 1,107 SF

REDB = 176' AREA \times 3 DEC. = 530 SF

 $BOSN = 38' AREA \times 5 PINES = 190 SF$

(TRUNK COVERAGE)

FOAR = 38' AREA x 15 SHRUBS = 570 SF

YUFI = 7' AREA \times 6 SHRUBS = 42 SF

 $PIMU = 50' AREA \times 24 SHRUBS = 1,200 SF$

 $JUSA = 14' AREA \times 42 SHRUBS = 588 SF$

HESE = 7' AREA \times 35 GRASSES = 245 SF

LAVD = 7' AREA \times 6 GRASSES = 105 SF

TOTAL COVERAGE = 6,591 SF

SALV = 2' AREA \times 17 GRASSES = 34 SF

Material Schedule

FESCUE SOD

1" MINUS PERMA BARK ROCK MULCH

= 4" - 6" ROCK COBBLE MULCH

Site Data

SOUTH JORDAN ZONING: C-N COMMERCIAL NEIGHBORHOOD PROPERTY SIZE: 56,976 SF / 1.31 AC

BUILDING FOOTPRINT: 12,877 SF (22.6%) HARD SURFACE AREA: 28,058 SF (49.2%) LANDSCAPE AREA: 16,041 SF (28.2%) 2,890 SF (18.0%)

AT MATURITY, LANDSCAPES ARE REQUIRED TO HAVE ENOUGH PLANT MATERIAL (PERENNIALS AND SHRUBS) TO CREATE AT LEAST 50% LIVING PLAN COVER AT MATURITY AT THE GROUND PLAN, NOT INCLUDING TREE

LANDSCAPE AREA: (EXCLUDING SOD) PLANT MATERIAL:


13,151 SF 6,591 SF - 50%


PARKING:

DAYCARE USE (1 STALL / 300 SF) 9,135 SF FOR INTENDED USE 9,135 / 300 = 30.45 STALLS 30 STALLS REQUIRED 33 STALLS PROVIDED (2 ADA)



PH: 801.664.4724

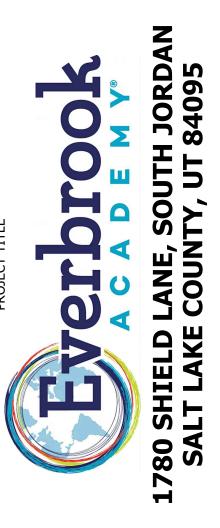

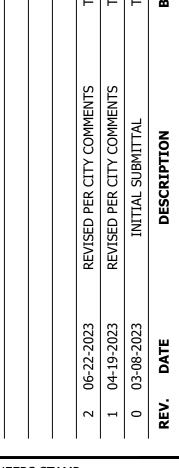



VERIFY SCALES BAR IS ONE INCH ON ORIGINAL DRAWING

IF NOT ONE INCH ON THIS SHEET, ADJUST SCALES ACCORDINGLY

PROJECT INFO. Engineer: T. Hunt T. Pridemore Drawn:


Checked: Date: 12 / 09 / 2022

SHEET TITLE


Landscape Plan

SHEET NO.

L100

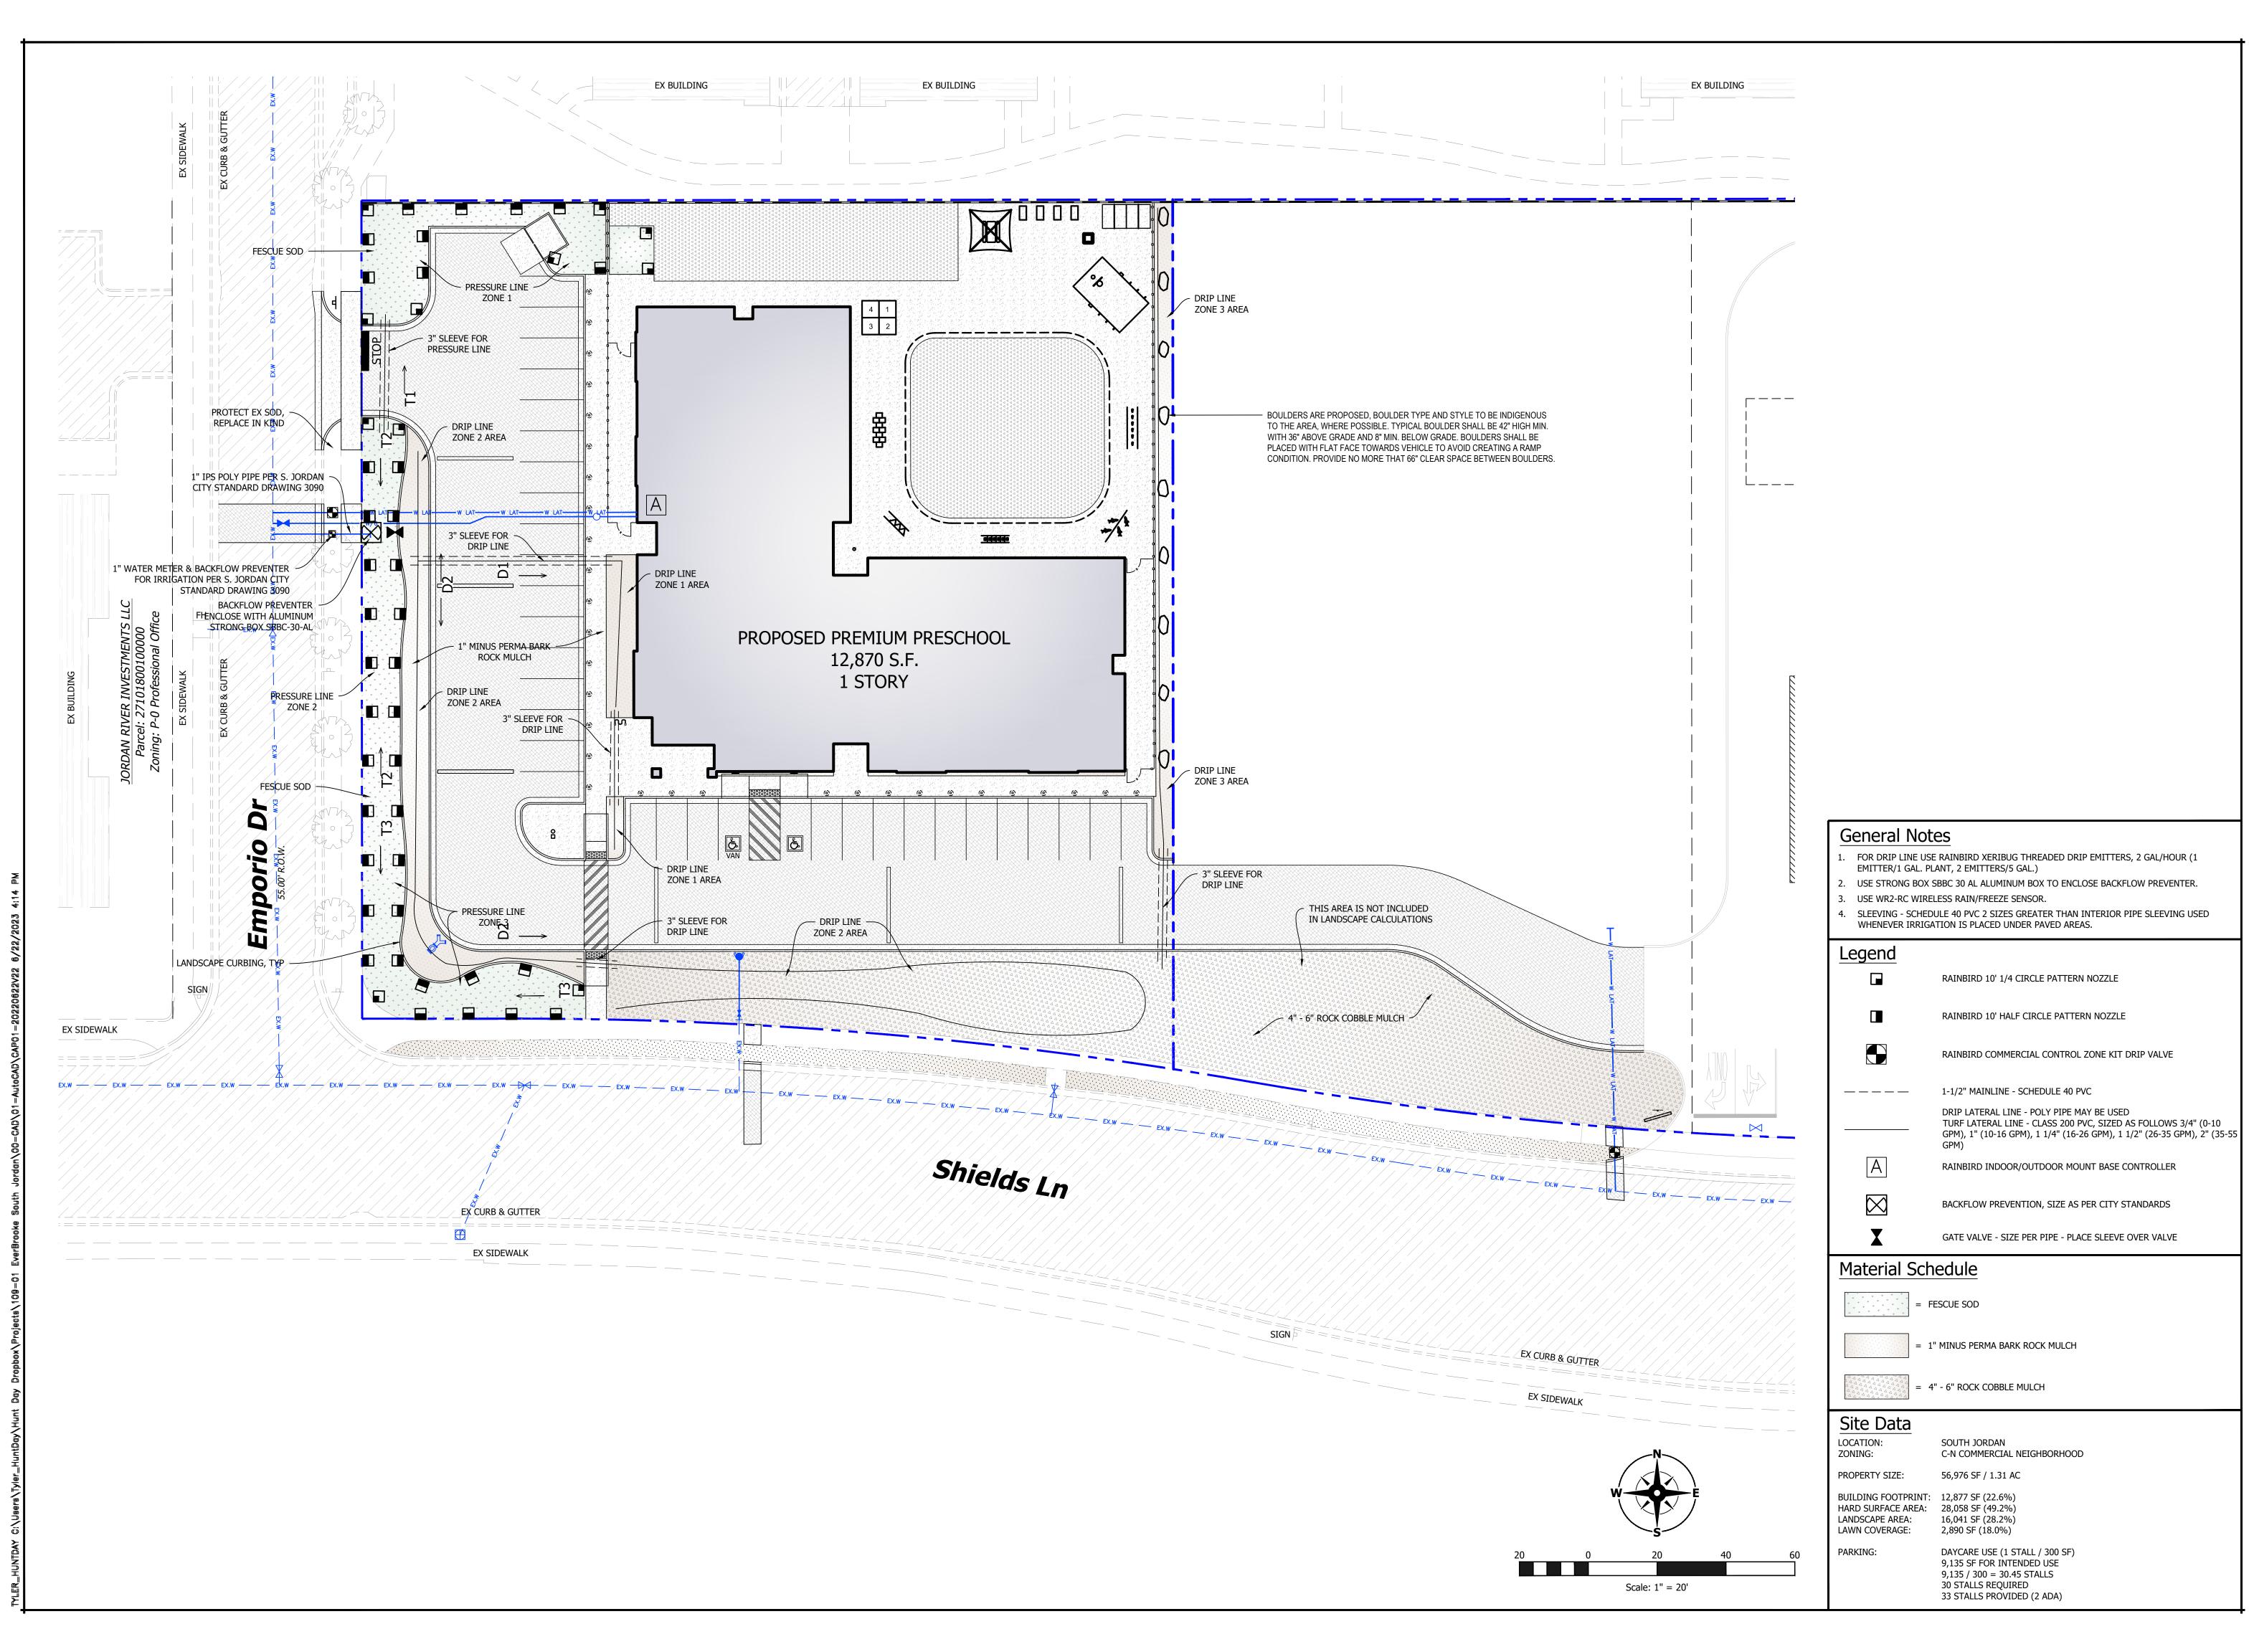



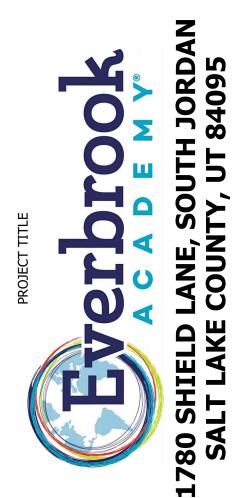

ENGINEERS STAMP

VERIFY SCALES BAR IS ONE INCH ON ORIGINAL DRAWING

IF NOT ONE INCH ON THIS SHEET, ADJUST SCALES ACCORDINGLY

PROJECT INFO. Engineer: T. Hunt Checked:


Drawn: T. Pridemore Date: 12 / 09 / 2022


SHEET TITLE

Irrigation Plan

SHEET NO.


L101

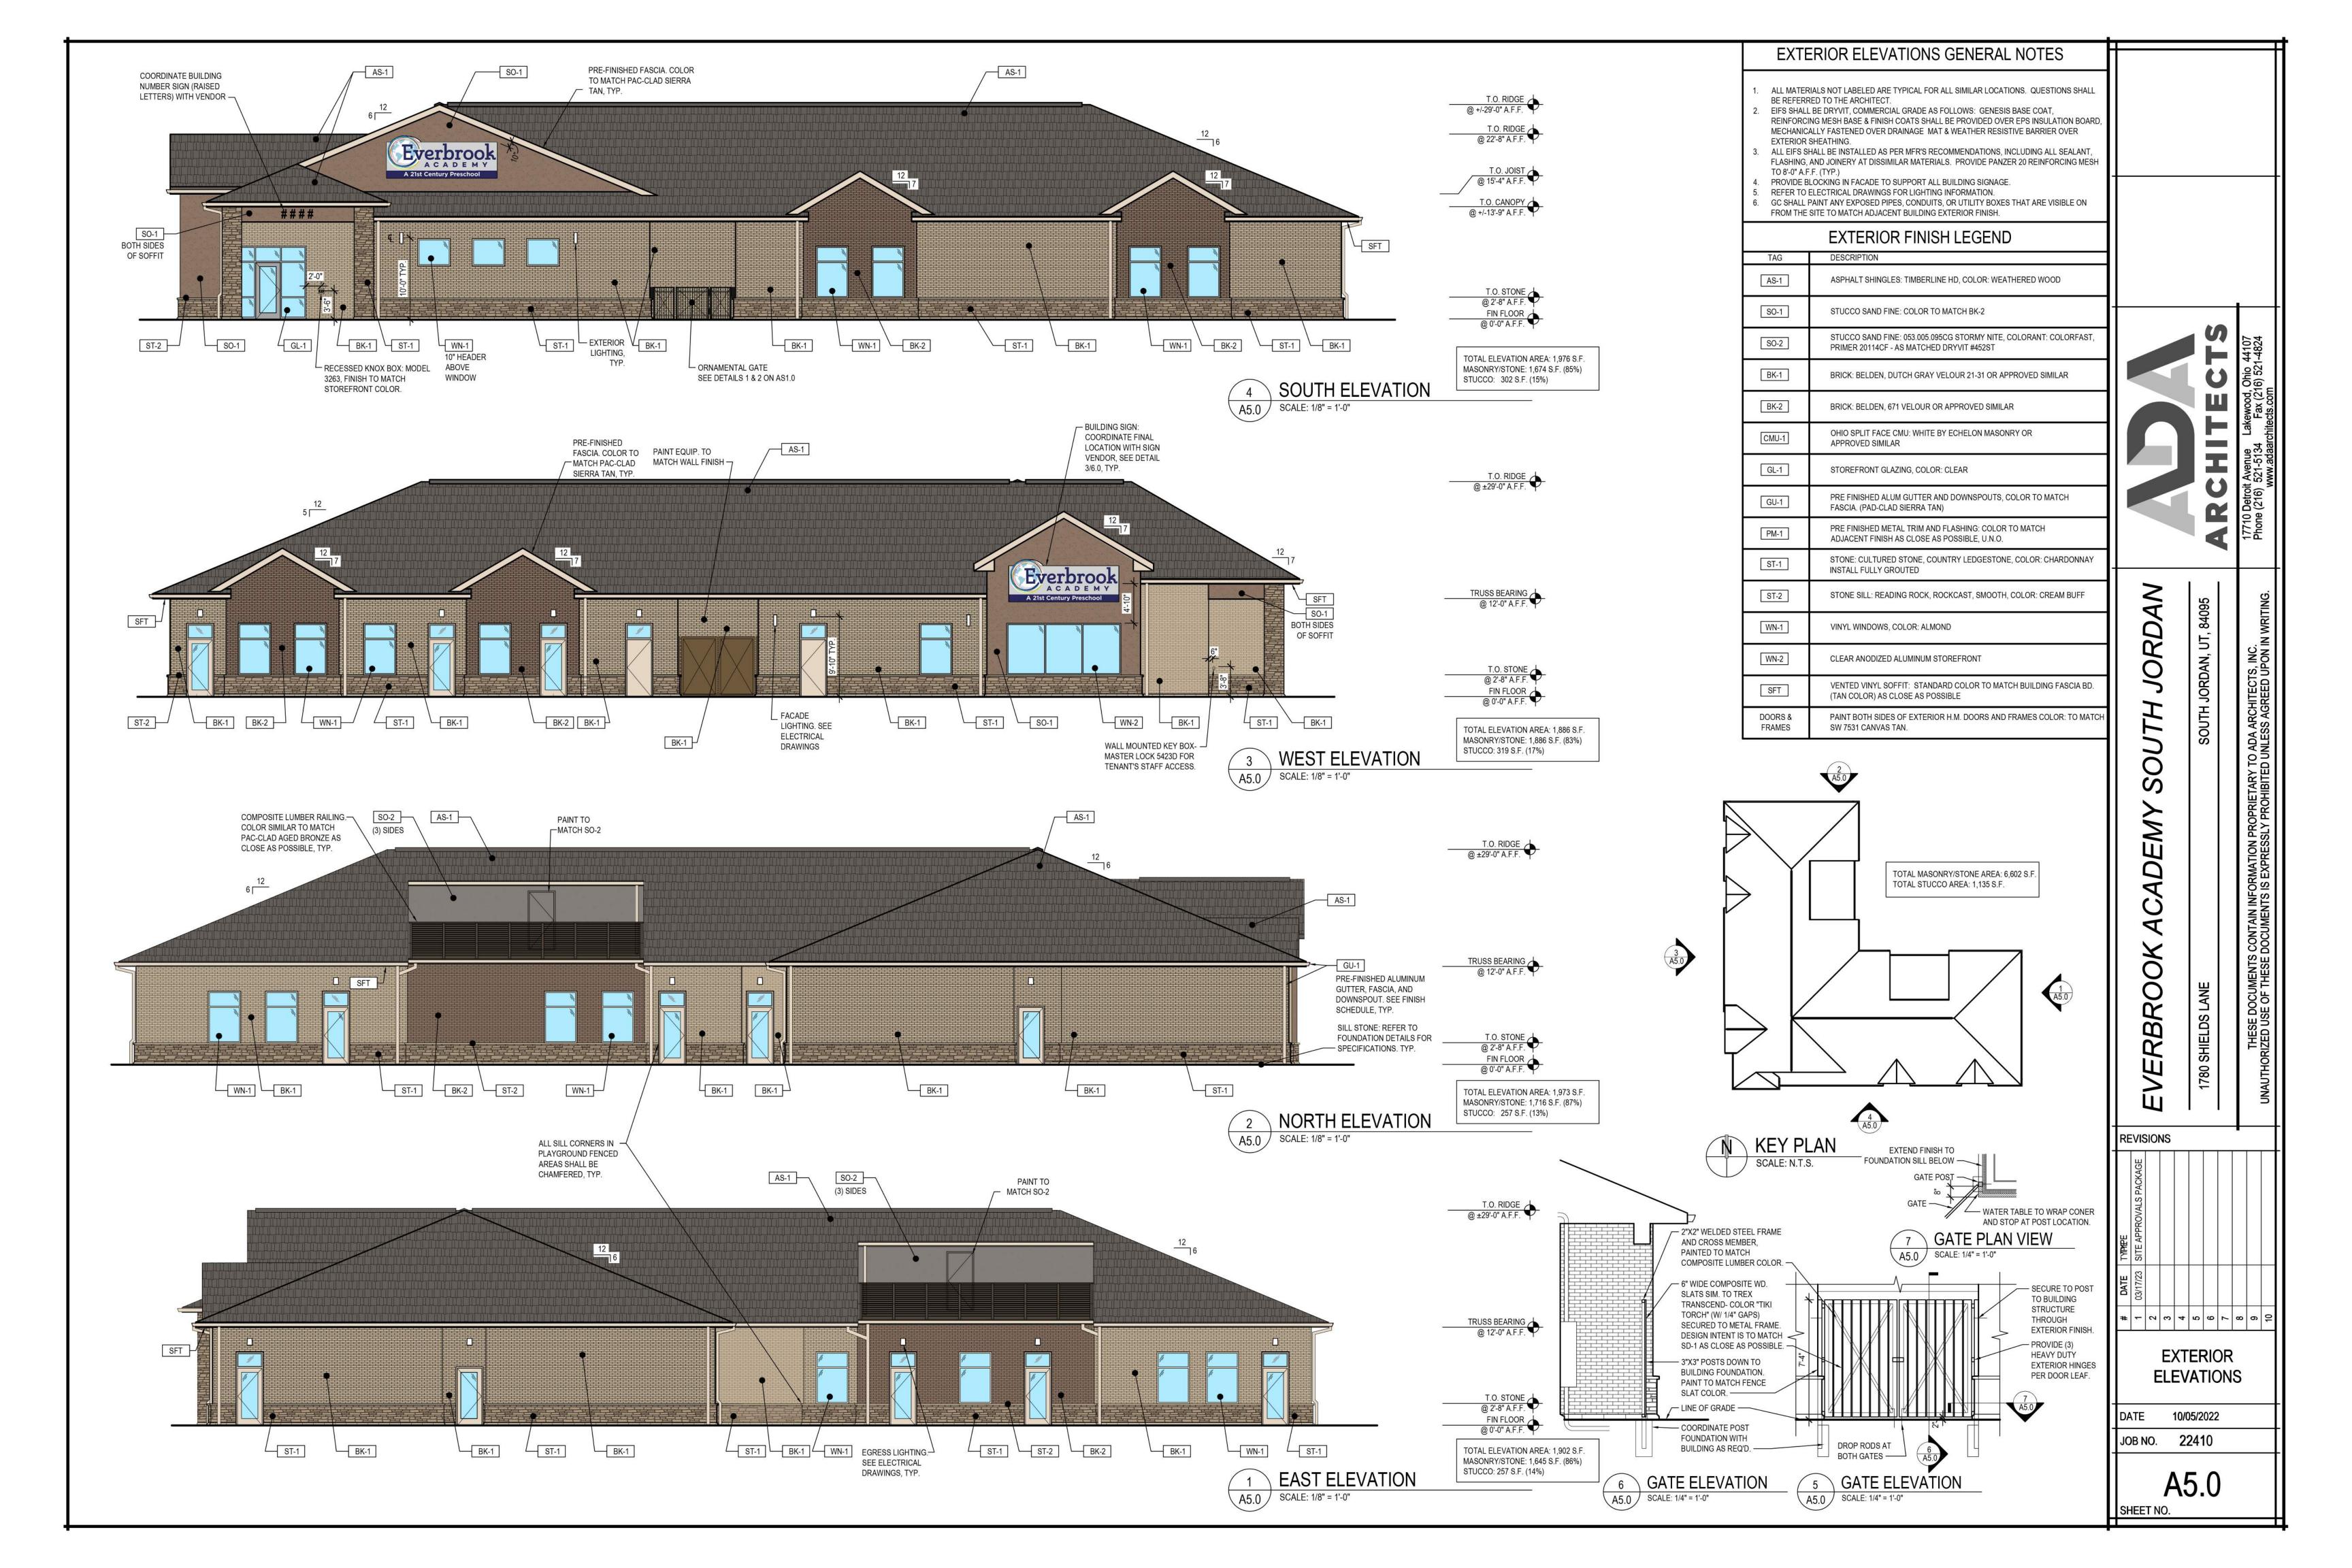

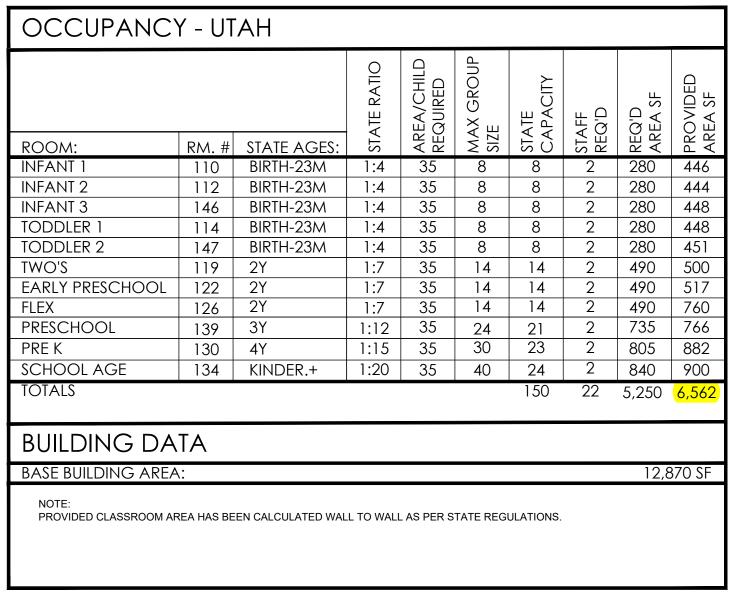

11 Classrooms per Chart: 6,562 SF
Multi-Purpose Room: 766 SF
Lobby: 426 SF
Corridor: 1,381 SF

TOTAL SF for PARKING: 9,135 SF

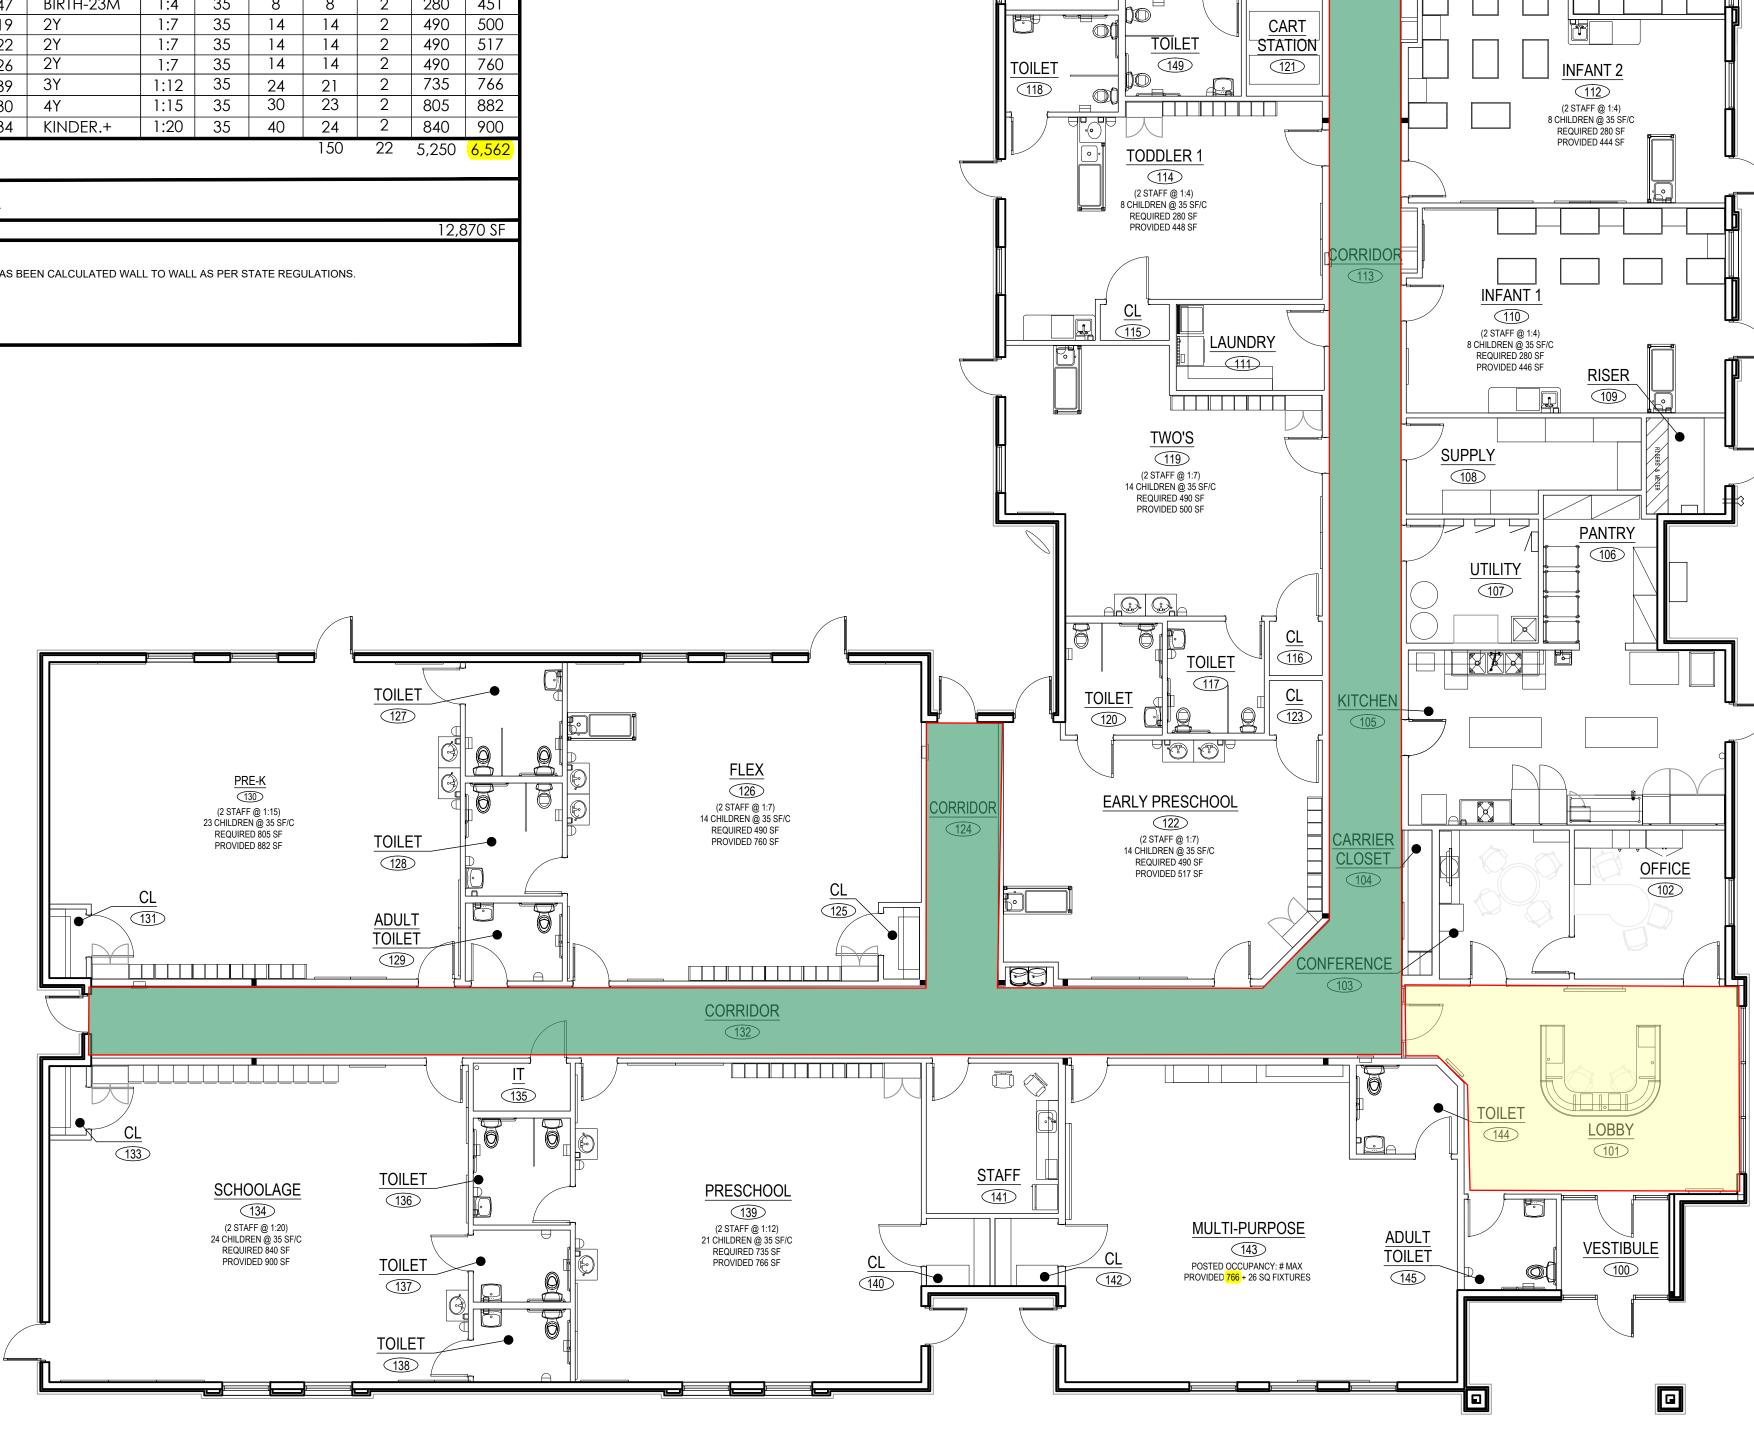

INFANT 3

(2 STAFF @ 1:4)
8 CHILDREN @ 35 SF/C
REQUIRED 280 SF

TODDLER 2

(2 STAFF @ 1:4) 8 CHILDREN @ 35 SF/C REQUIRED 280 SF PROVIDED 451 SF REVISIONS FIXTURE PLAN (UTAH) 03/22/2022 JOB NO. JOB NO. FP-1 SHEET NO.

FIXTURE PLAN

SCALE:1/8"=1'-0"

A1.0