

CITY OF SHEBOYGAN

SPECIAL USE AND SITE PLAN REVIEW APPLICATION

Fee: \$100	
Review Date:	

Read all instructions before completing. If additional space is needed, attach additional pages.

SECTION 1: Applicant/ Permittee Information				
Name (Ind., Org. or Entity)	Authorized Repres	entative	Title	
KURT MANG-ABACUS	KUMT DAV	15	AREL	hnect
Mailing Address	City		State	ZIP Code
1135A MICHIGAN AVE.	5HEBOY4A	N	Wl	530B
Email Address		Phone Number (inc		e)
KDANSE ABACUS A RCHITECUS.	NET	920-207-2	1629	
SECTION 2: Landowner Information (co	omplete these fields	when project site o	wner is dif	ferent than applicant)
Name (Ind., Org. or Entity)	Contact Person		Title	
VOURANT CO., LLC	GARY SAUE	XR.	FACILI	NES DIRECTOR
Mailing Address .	City		State	ZIP Code
1236 NORTH 18th P.U. 611	SHEBOY6A	N	W	ZIP Code 53081
Email Address		Phone Number (inc	l. area cod	e)
GARYSAVERC VOLIZATILE	D. COM	920 - 459	- 5205	,
SECTION 3: Architect Information				
Name				<u> </u>
KURT PAUS				
Mailing Address	City		State	Z <u>i</u> p
1135A MICHIGAN AVE.	City SHEBOY4	AN	wI	53081
Email Address		Phone Number (inc	l. arga code	e)
KDAUSE ABACUS ARCHITE	as. Net	920 - 207	-4829	
SECTION 4: Contractor Information				
Name TBD				
		1		
Mailing Address	City		State	Zip
E -ilall				
Email Address		Phone Number (inc	l. area code	e)
SECTION 5: Certification and Permissio				
Certification: I hereby certify that I am I				
the subject of this Site Plan Review App				
are true and accurate. I certify that the project will be in compliance with all conditions. I understand that failure to				
comply with any or all of the provisions of the permit may result in permit revocation and a fine and/or forfeiture				
under the provisions of applicable laws.				
Permission: I hereby give the City permission to enter and inspect the property at reasonable times, to evaluate this				
notice and application, and to determine compliance with any resulting permit coverage.				
Name of Owner/Authorized Representa	itive (please print)	Title	I	Phone Number
KURT DAMS		ARCHITECT		720.207-4829
Signature of Applicant			Date Signe	10 17 25
Complete application is to be filed with the		. 5		L-11-11

Complete application is to be filed with the Department of City Development, 828 Center Avenue, Suite 208. To be placed on the agenda of the City Plan Commission, application must be filed three weeks prior to date of meeting – check with City Development on application submittal deadline date. Applications will not be processed if all required attachments and filing fee of \$100 (payable to the City of Sheboygan) are not submitted along with a complete and legible application. Application filing fee is non-refundable.

SECTION 6: Description of the Subject Site/Proposed Project	
Parcel No. 59281214074 Zoning Classification SUBURGAY - FUNDUSTRIAL	
Name of Proposed/Existing Business: VOLLRATI CO., INC.	7
Address of Property Affected: 1236 NH 18th ST. SHUBOYLAW, WI 53081	
New Building: Remodeling: Remodeling:	
SECTION 7: Brief Description of Type of Structure	
VOLUMENTU CO., FINC. IS CONSTRUCTIVE A NEW 40'X60' METAL POLE PUILDING ON EXISTING PARCEL TO BE USED FOR STORAGE IN PLACE OF AREA (BUILDING) TO BE REMOVED AS PART OF A MASTER PLAN FOR NEW BUILDING STRUCTURE(S)	
SECTION 8: Description of EXISTING Operation or Use	
N/A	
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SECTION 9: Description of the PROPOSED Operation or Use	
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SPECIAL USE AND SITE PLAN USE APPLICATION SUBMITTAL REQUIREMENTS

- A. Name of project/development.
- B. Summary of general operation and proposed use:
 - Description of existing use
 - Description of proposed use (indoor, outdoor, etc.), why was this site selected?
 - All services, products, etc. to be provided
 - Projected number of residents, employees, and/or daily customers
 - Proposed number of dwelling units, floor area, landscape area, and parking area expressed in square feet and acreage to the nearest one-hundredth of an acre
 - Description of proposed building and all new site improvements (square footage of new and existing structure(s), traffic, ingress/egress, parking, sidewalk, retaining walls, storm drainage, landscaping, lighting, dumpster enclosure, screening of mechanicals, etc.)
 - A written description of the proposed general orientation, design, arrangement, texture, material and color of the building or structure and how it is compatible with the development and redevelopment in and around the area
 - An explanation of any interior and/or exterior renovations
 - Is access appropriate and is their sufficient customers/resident off-street parking?
 - Proposed signage
 - Project timeline and estimated value of project
 - Compatibility of the proposed use and design with adjacent and other properties in the area.
 - How will you insure that the business will not become a nuisance to adjacent properties (i.e. parking, noise, smells, hours of operations, etc.
 - Other information that would be considered pertinent by the Plan Commission.



Submit TWO (2) copies of a property site plan drawing, which includes:

- A certified survey map showing existing property boundaries and improvements
- A map providing the following information:
 - \circ The map and all its parts shall be clearly reproducible with a photocopier at a size of 11" X 17" and map scale not less than 1' = 600' with lot dimensions of the subject property provided and a graphic scale and north arrow
 - All lands for which the conditional use is proposed
 - All other lands within 100 feet of the boundaries of the subject property
 - o The current zoning of the subject property and its environs (200 feet)
- A site plan (conforming to the requirements of Section 15.908(3) of the subject property as proposed for development):
 - Submit TWO (2) hardcopies of the site plan and ONE (1) 11" X 17" reduction of the site plan
 - Submit digital plans and drawings of the project by email, flash drive, etc.
 - Title block that provides all contact information for the petitioner and/or owner, if different
 - Full name and contact information of petitioner's engineers/surveyors/architects, or other design professionals used in the plan preparation
 - The date of the original plan and latest date of revision to the plan
 - A north arrow and graphic scale. Said scale is not to be smaller than one inch equals 100 feet
 - All property lines & existing/proposed right-of-way lines with bearings & dimensions clearly labeled

- Existing /proposed easement lines and dimensions with an explanation of ownership and purpose
- All required building setback lines
- Existing and proposed buildings, structures and paved areas, including building entrances, walks, drives, decks, patios, fences, utility poles, drainage facilities and walls
- Location and dimension of all curb cuts and throat widths of all access points onto public streets or alleys
- The location and dimension of all on-site parking including a summary of the number of parking stalls provided versus the requirements of the ordinance
- The location and dimension of all loading and service areas on subject property
- o The location of all outdoor storage areas and the design of all screening devices
- Location of all outdoor storage and refuse disposal areas and the design and materials used for construction and operation
- The location, type, height, size and lighting of all signage
- Location, height, design, illumination power and orientation of all exterior lighting on the property including a photometrics plan
- Location of all exterior mechanical equipment and utilities and elevations of proposed screening devices where applicable (i.e. visible from a public street or residential use or district). Mechanical equipment includes, but is not limited to; HVAC equipment, electrical transformers and boxes, exhaust flues, plumbing vents, gas regulators, generator
- o Location of all existing and proposed landscape areas, storm water areas, etc.

D. Building elevations and perspectives.

NOTE: A Traffic Impact Study (TIA) may be required with large development proposals.

NOTE

Initiation of Land Use or Development Activity

Absolutely no land use or development activity, including site clearing, grubbing, or grading shall occur on the subject property prior to the approval of the site plan by the City Plan Commission. Any such activity prior to such approval shall be a violation of law and shall be subject to all applicable enforcement mechanisms and penalties.

Modification of an Approved Site Plan

Any and all unauthorized variations between development and/or land use activity on the subject property and the approved site plan is a violation of law. An approved site plan may be revised so as to clearly and completely depict any and all proposed modifications to a previously approved site plan by the City Plan Commission. Prior to the initiation of said modifications, the City Plan Commission must approve the revised plan.

Office Use Only

ACTION BY CITY PLAN COMMISSION

DATE OF MEET	ING:		
CONDITIONS	CONDITIONALLY APPROVED:		
-			
,			
		* ***	
SIGNATURE		DATE:	
	Director or Representative Department of City Development	DAIL.	

NOTES

Permit may be revoked without notice if misrepresentation of any of the above information or attachments is found to exist.

Permit shall expire within six (6) months from date of approval unless substantial work has commenced.

Permit is null and void if issued in error. It is understood that any permit issued on this application will not grant any right or privilege to erect any structure or to use any permits for any purpose that is prohibited by the City Zoning Ordinance or any other state or local laws.

Changes in the plans or specifications submitted in the original application shall not be made without prior written approval of the City Plan Commission.

Check sidewalk grades from City Engineering Department with finished site grade.

APPLICATION SUBMITTAL

STEP 1: Initial Meeting with City Planning Office:

An initial meeting is to ensure that both the applicant and the city staff have a proper understanding of what is being requested and to explain the approvals necessary. An engineered drawing is not required for this meeting, but an accurate sketch and any applicable background information may be needed. Additional meetings can be arranged by calling the Department of City Development.

STEP 2: Official Submission:

A special use permit and site plan application may be filed at the City of Sheboygan Planning and Development office located on the 2nd floor of City Hall or may be submitted electronically via email: Steve.Sokolowski@SheboyganWI.gov

If submitting electronically, please verify application has been accepted and will be placed on the next Plan Commission agenda.

Payment of the application fee must be received prior to the application filing deadline. Payment may be submitted via postal delivery, in person, or by phone using credit card.

Mailing Address: Department of City Development

828 Center Ave. Suite 208 Sheboygan, WI 53081

NOTE: Applications will not be accepted until complete. A complete application includes all items in the respective checklists above. Applications must be complete before they are scheduled for a meeting before the Plan Commission.

PLAN COMMISSION MEETING

Meeting Date: The Plan Commission meets on the 2nd and 4th Tuesdays of the month at 4:00 p.m. in the Council Chambers of City Hall, 828 Center Ave. The project applicant or a representative must attend the Plan Commission meeting to present the request and answer questions regarding the proposal. Public comment will be invited at the Plan Commission meeting.

Project Review: The purpose of a special use permit and site plan is to assure compatibility between land uses. City staff analyzes a proposal and prepares a recommendation for the Plan Commission. The project analysis considers the location of the affected property, surrounding uses, and the operational details of a proposed use.

Plan Commission: The Plan Commission is charged with the authority to approve or deny a special use permit and site plan request. In the event an applicant wishes to contest the decision of the Plan Commission, the applicant may appeal the decision to the Sheboygan County Circuit Court.

Plan Commission meeting agendas and minutes may be viewed on the City's website: www.SheboyganWl.gov

FOR INFORMATION OR ASSISTANCE CONTACT THE ZONING MANAGER: (920) 459-3382



February 18th, 2025

City of Sheboygan 828 Center Avenue Sheboygan, WI 53081

SITE PLAN REVIEW

The Vollrath Company, Inc. – Pole Building Sheboygan, WI

THE VOLLRATH COMPANY

The Vollrath Co., Inc., founded in 1874 has been providing high quality, commercial cooking and serving equipment that provides efficiency and ease of use in the demanding environment of commercial kitchens and foodservice operations.

Vollrath offers OEM Solutions, Wholesale Food Service Products, and advanced cleaning products.

Vollrath serve both U.S. and International Markets.

PROJECT DESCRIPTION

The Vollrath Co., Inc. will be constructing a new Metal Pole Building (approx. 40' x 60') on their property to accommodate storage needs for equipment. This is required as they prepare for new and improve existing building areas to accommodate future growth. The structure will be located in the vicinity of the existing Production area on the North end of the site approx. a few hundred feet from Superior Avenue to the North. Site plan and Survey are attached.

The structure itself is a Pre-Engineered Metal Pole Building (plans and elevations attached). This type of Architectural Design will match existing buildings on the Vollrath Campus and surrounding buildings such as S.E.A.S. on the Northeast corner of 18th and Superior Avenue. Materials – Colors will be similar to many other buildings on The Vollrath Campus so that new building blends in with Architectural character of surrounding building on property and those adjoining.

SITE

The existing site is zoned Suburban Industrial. Please find attached to this submittal an overall Site Plan and Zoning classification of adjacent properties.

PROJECT TIMELINE

Project Start will be as soon as possible relative to City of Sheboygan Plan Commission, Architectural Review Board and Building Inspection Approvals.



OTHER PROJECT INFORMATION

The Pole Building is required to facilitate growth at The Vollrath Company. It is the first piece of Long-Range Master Planning to not only improve current operations, but to efficiently and methodically build for the next generation.

The structure will not require additional parking, revised loading and/ or service areas, Site Lighting, Signage or new lighting-illumination.

Please call me directly if you have any questions that I can answer before the Plan Commission Meeting.

Sincerely,

Kurt Davis, Vice President Abacus Architects, Inc.

1/15/2025 CHAPPA, TYLER Doc ID: 21183220250115125039

Cleary/Owner Project Proposal - Material Only

Roof Finish and Accessories for Building 1

Exterior Finishes

Roof: Premium Steel Panel

- Lifetime Film Integrity Warranty, 35 Year Fade and Chalk Warranty, and G-90 Galvanizing Up to 1.0 ounce of Zinc

Ventilation

Roof

Ridge Cap(s):

62' 0" of Standard Ridge Cap. Marco LP2 Weather-Tite Ridge Vent "Low Profile" (Add ventilation to ridge).

Accessories

Roof

Condensation Control for Building 1: None

Weathervane: Cleary weathervane not included with building

Elevations for Building 1

South Side Wall 1 on Building 1

Note: These colors are as close to the actual colors as permitted by printing. Actual metal samples must be reviewed with your Sales Specialist. Colors vary depending upon position and angles.

Exterior Finishes

Side Wall 1 on Building 1

Siding: Premium Steel Panel


- Lifetime Film Integrity Warranty, 35 Year Fade and Chalk Warranty, and G-90 Galvanizing Up to 1.0 ounce of Zinc Protection.

House Wrap: None

Wainscot: None

Eave Filler Strips: None

C-110 v12/10

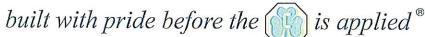





1/15/2025 CHAPPA, TYLER Doc ID: 21183220250115125039

Cleary/Owner Project Proposal - Material Only

Treated Plank Filler Strips: None

Ventilation

Side Wall 1 on Building 1

Overhang: 12" Aluminum soffit (Sidewall) with vented soffit

Bird Screening for the interior to prevent birds from nesting in overhang.

Accessories

Side Wall 1 on Building 1


None

Interior Finishes / Insulation

Side Wall 1 on Building 1

Condensation Control: None

Insulation: None

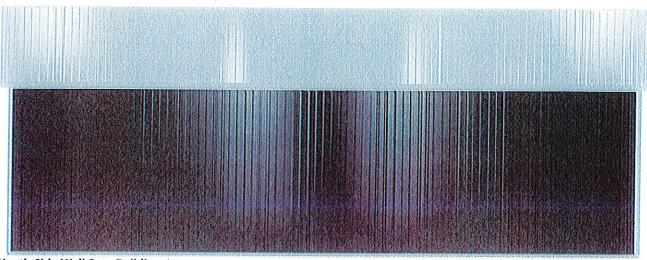

North Side Wall 2 on Building 1

Note: These colors are as close to the actual colors as permitted by printing. Actual metal samples must be reviewed with your Sales Specialist. Colors vary depending upon position and angles.

Exterior Finishes

Side Wall 2 on Building 1

Siding: Premium Steel Panel

- Lifetime Film Integrity Warranty, 35 Year Fade and Chalk Warranty, and G-90 Galvanizing Up to 1.0 ounce of Zinc Protection.

House Wrap: None

Wainscot: None

Eave Filler Strips: None

Treated Plank Filler Strips: None

Ventilation

Side Wall 2 on Building 1


Overhang: 12" Aluminum soffit (Sidewall) with vented soffit

Bird Screening for the interior to prevent birds from nesting in overhang.

Accessories

C-110 v12/10

built with pride before the (is applied *

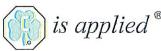

5 of 13




1/15/2025 CHAPPA, TYLER Doc ID: 21183220250115125039

Cleary/Owner Project Proposal - Material Only

Side Wall 2 on Building 1 None

Interior Finishes / Insulation

Side Wall 2 on Building 1 Condensation Control: None Insulation: None

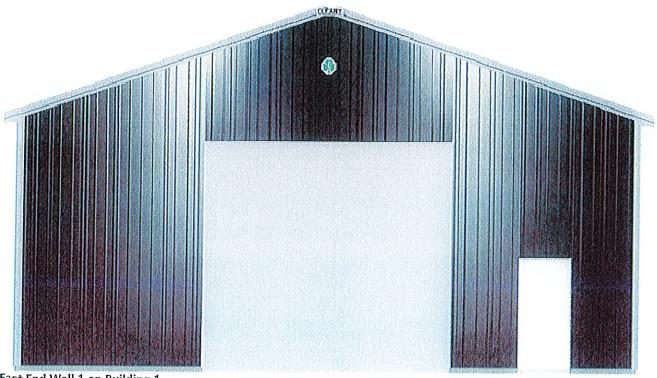

East End Wall 1 on Building 1

Note: These colors are as close to the actual colors as permitted by printing. Actual metal samples must be reviewed with your Sales Specialist. Colors vary depending upon position and angles.

Exterior Finishes

End Wall 1 on Building 1

Siding: Premium Steel Panel

- Lifetime Film Integrity Warranty, 35 Year Fade and Chalk Warranty, and G-90 Galvanizing Up to 1.0 ounce of Zinc Protection.

House Wrap: None

Wainscot: None

Gable Filler Strips: Gable filler strips not included.

Treated Plank Filler Strips: None

Ventilation

End Wall 1 on Building 1

Overhang: 12" Aluminum soffit (Endwall) with vented soffit

C-110 v12/10

built with pride before the (ii) is applied *





1/15/2025 CHAPPA, TYLER Doc ID: 21183220250115125039

Cleary/Owner Project Proposal - Material Only

Accessories

End Wall 1 on Building 1

Overhead Frame Out(s):

16' 0" Width x 14' 0" Height

Headroom Available: 1' 10"

Additional Header material required: Overhead Frame Out with 13" to 20" of Required Headroom without Liner

Distance from left edge of wall to left edge: 12' 0 1/4"

Distance from 100'+0" mark to bottom of the overhead frame out plus: 4"

Inside edge of overhead frame out to be trimmed with door edge.

OVERHEAD DOOR NOT INCLUDED UNLESS OTHERWISE NOTED IN WRITING IN THE ADDITIONAL BUILDING COMPONENTS OR CLOPAY BUILDING PRODUCTS SECTION.

Walk Door(s):

Standard, Steel Jamb 3 1/2" 3'-0"x6'-8"

Distance from left edge of wall to left edge: 32' 7"

Distance from 100'+0" mark to bottom of door plus: 4"

Anchor: ANCHOR KIT (WOOD)

Closer: No Closer Dead Bolt: Key/Latch

Door Chain: No Chain

Embossment: No Embossment

Frame: 2x6

Hinge: 4" 304 STAINLESS STEEL FIXED PIN

Jamb: 3 1/2" Jamb Kick Plate: No Kick Plate Latch Guard: No Latch Guard

Latch: None

Lockset: Knob/Knob

Panic Hardware: No Panic Hardware

Skin: Blank

Swing: Right Hand Swing In Single Door

Window: None

Keyed Alike. Group 1

Interior Finishes / Insulation

End Wall 1 on Building 1

Condensation Control: None

Insulation: None



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Cleary/Owner Project Proposal - Material Only



West End Wall 2 on Building 1

Note: These colors are as close to the actual colors as permitted by printing. Actual metal samples must be reviewed with your Sales Specialist. Colors vary depending upon position and angles.

Exterior Finishes

End Wall 2 on Building 1

Siding: Premium Steel Panel

- Lifetime Film Integrity Warranty, 35 Year Fade and Chalk Warranty, and G-90 Galvanizing Up to 1.0 ounce of Zinc Protection.

House Wrap: None

Wainscot: None

Gable Filler Strips: Gable filler strips not included.

Treated Plank Filler Strips: None

Ventilation

End Wall 2 on Building 1

Overhang: 12" Aluminum soffit (Endwall) with vented soffit

Accessories

End Wall 2 on Building 1

Walk Door(s):

Standard, Steel Jamb 3 1/2" 3'-0"x6'-8"

Distance from left edge of wall to left edge: 33' 6"

Distance from 100'+0" mark to bottom of door plus: 4"

Anchor: ANCHOR KIT (WOOD)





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Cleary/Owner Project Proposal - Material Only

Closer: No Closer Dead Bolt: Key/Latch Door Chain: No Chain

Embossment: No Embossment

Frame: 2x6

Hinge: 4" 304 STAINLESS STEEL FIXED PIN

Jamb: 3 1/2" Jamb Kick Plate: No Kick Plate Latch Guard: No Latch Guard

Latch: None

Lockset: Knob/Knob

Panic Hardware: No Panic Hardware

Skin: Blank

Swing: Right Hand Swing In Single Door

Window: None Keyed Alike. Group 1


Interior Finishes / Insulation

End Wall 2 on Building 1 Condensation Control: None Insulation: None



1/15/2025 CHAPPA, TYLER Doc ID: 21183220250115125039

Cleary/Owner Project Proposal - Material Only

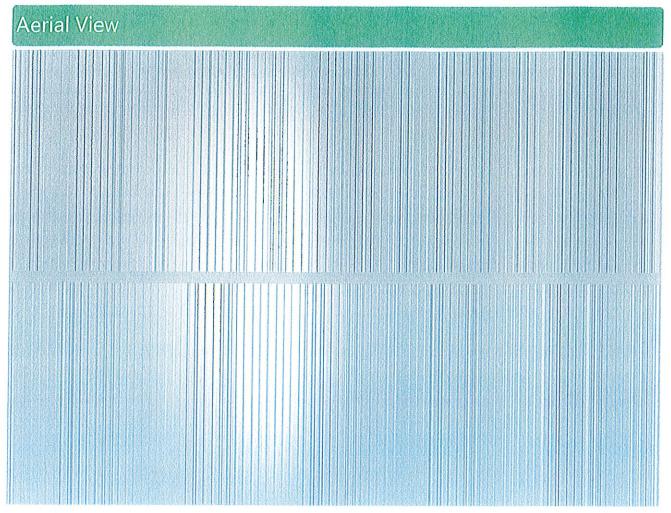

Note: These colors are as close to the actual colors as permitted by printing. Actual metal samples must be reviewed with your Sales Specialist. Colors vary depending upon position and angles.

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1/15/2025 CHAPPA, TYLER Doc ID: 21183220250115125039

Cleary/Owner Project Proposal - Material Only

Project Colors

Building - Exterior

Siding

Premium Steel Panel: Umber Corner Trim: Light Gray Bottom Trim: Light Gray

Roof

Premium Steel Panel: Light Gray

Trim

Gable: Light Gray Eave/Fascia: Light Gray Ridge Cap: Light Gray

Trim Color Unless Otherwise Specified: Light Gray

Overhangs

Soffit: Light Gray

WallToSoffitTrim: Light Gray CeilingEnclosureTrim: Light Gray

Overhead Frameout

J-Trim: Light Gray InsideTrim: Light Gray

Walk Doors

Standard Blocked 3068: Brilliant

J-Trim: Light Gray

All applicable Wall Steel, Roof Steel, Walk Door, and Trim colors have been reviewed using steel color chips.

Purchaser Initials

Purchaser and BSS to meet at a later date to confirm colors with color chips. This will be documented with a change order.

Purchaser Initials



GENERAL NOTES AND SPECIFICATIONS 1. The materials and labor shown on these plans that are provided by Cleary Building Corp. are limited to those materials and labor as defined by the Cleary Building Corp. contract. Additional materials or accessories that are not being provided by Cleary Building Corp. may be shown on plans for context or building code compliance. 2. This building is designed in accordance with the following codes and specifications as applicable:

2018 Wisconsin Administrative Code chs. SPS 361-366 2015 International Building Code (IBC) as amended by SPS 362 2015 International Energy Conservation Code (IECC) as amended by SPS 363 2015 International Existing Building Code (IEBC) as amended by SPS 365 2015 National Design Specification for Wood Construction (NDS)

Use Group(s) Classification:

Building Use:

Type of Construction:

Building Area:

2400 Sq. Ft.

Building Design Loads: Snow Design Data: Ground Snow Load (Pg): — 47 PSF
Snow Exposure Factor (Ce): 1 37 PSF Leeward 20.39 PSF Leeward surcharge 8.1 Ft. Width of surcharge

Wind Design Data: Design Internal Pressure Coefficient: ± 0.18

Earthquake Design Data: Basic Seismic Force Resisting System:————————————————————————Building Frame System/Light Frame Walls Sheathed with Wood Structural Panels or Steel Sheets Design Base Shear:—— Seismic Response Coefficient (Cs)————— 0.012 Analysis Procedure Used: ———— Equivalent Lateral Force Procedure Seismic Design Category:— Mapped Spectral Response Accelerations (Ss): 6.6%q Spectral Response Coefficients (Sps):——— Seismic Importance Factor (I_F)

- 3. All lumber, unless noted otherwise, shall be S4S #2 SPF or better. All lumber embedded in the ground shall be treated with Chromated Copper Arsenate to a retention level of .60 lbs. per cubic foot. AWPA U1, UC4B.
- 4. All nails are to be threaded hardened steel unless otherwise noted.


- 5. Grading should be such that the surface water is drained away from the foundation. Minimum grade would be six inches of vertical drop per ten feet of horizontal away from the foundation (5%).
- 6. Fill used for concrete floor slab sub grade, if present, shall be reasonably graded granular material. Fill used in columns holes shall be the excavated soil unless noted otherwise. All fill shall be free from debris, stones over 4"\$\psi\$ and frozen material.
- Electrical work, heating, ventilating, air conditioning, plumbing, and site draining is not a part of this drawing and shall be installed as per applicable codes.
- 8. This design is based on a building site with sand, silty sand, clayey sand, silty gravel, clayey gravel soil. As per the IBC building code and Referenced Standard ASAE 486.1, an assumed soil bearing design value of 1500 psf with increases for depth and width has been used in this design. If information is discovered before or during construction contrary to this, the building designer should be contacted.


This building, as depicted, must be constructed 10 feet or more from any and all lot lines and 20 feet or more from any other buildings on the same lot. See IBC code and/or the local building official for exceptions.

This document, as presented and sealed, is not intended to be, nor should i be construed as such, a complete building design. It is intended to represent just the building itself. It should also be noted that the designer is unaware of any subsoil investigation reports. Footings have been sized on assumed values as per note 8.0 under General Specifications and Notes. The designer excludes determination that the assumed soil conditions are present at the site. If a concrete floor will be installed, the design of the concrete floor is not part of these plans, nor is it intended to be. If shown, the concrete floor is only depicted to show its location with respect to related components of the building. The client or general contractor is encouraged to contract with other professional engineers or architects for the design of the concrete floor and its subgrade.


110. ELEVATIONS 120. FLOOR PLAN 125. ROOF FRAMING PLAN 130. TYPICAL SECTION 140. DIAGONAL BRACING DETAILS 150. DIAPHRAGM ACTION and MISC. DETAILS 160. TRUSS DIAGRAMS

SOUTH ELEVATION

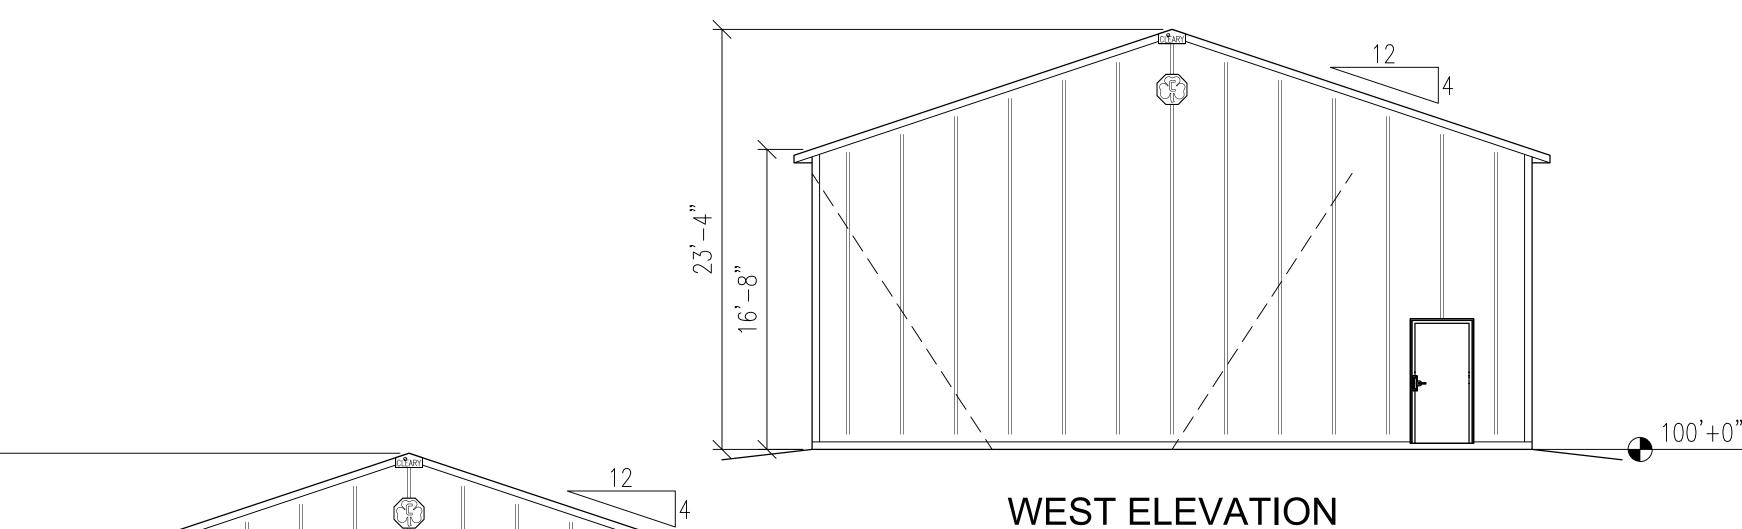

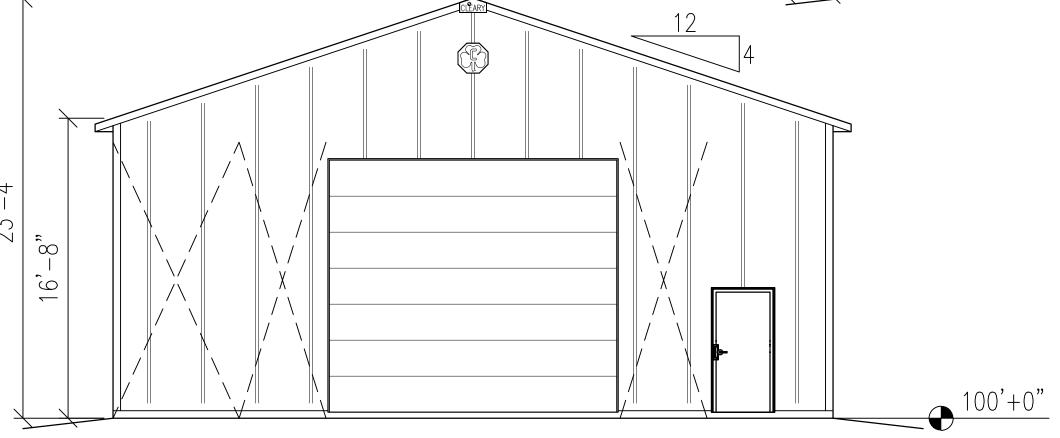

EAST ELEVATION

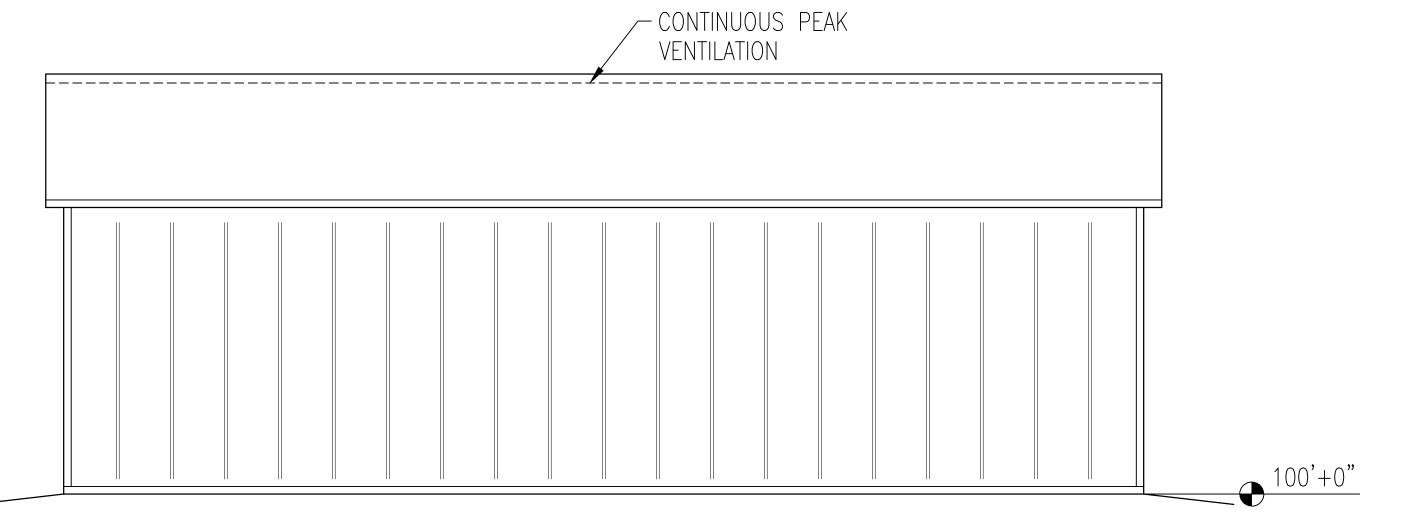

NORTH ELEVATION



190 PAOLI STREET / P.O. BOX 930220 VERONA, WI 53593 / (800) 373-5550

DRAWN BY: JENKINS

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DATE DRAWN: 02/10/25

PLAN REVISIONS:

NUMBER 3

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TYLER

PROJECT NUMBER: 2025100424

SHEET NUMBER: 110

WHEN PRINTED ON 24"x36" PAPER SCALE IS 3/16"=1'-0"



CLEARY BUILDING CORP
190 PAOLI STREET / P.O. BOX 930

VERONA, WI 53593 / (800) 373-5550

DRAWN BY: JENKINS

DATE DRAWN: 02/10/25

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Р	LAN REVISIONS) :
NUMBER	DATE	B'
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83 (SHEBOYGAN)

ER

SHEET NAME: FLOOR PLAN PROJECT NUMBER: 2025100424

SHEET NUMBER: 120

WHEN PRINTED ON 24"x36" PAPER SCALE IS 1/4"=1'-0"



NUMBER OF BUILDING ACCESSORY SCHEDULE HOLE DEPTH HOLE COLUMN SIZE COLUMNS **FOOTING SIZE** COLUMNS DIAMETER ITEM B.E./T.E. REQUIRED 1 | SOLID WALK DOOR | 3' 0"x6' 8" B.E. =100' 4" 2 R.O. 3' 4 3/8"x6' 9 3/4", STANDARD, BRILLIANT, LEV./LEV. (A) CORNER 3-PLY 2x6x22'-0" 18"ø 4"x14"Ø PRECAST CONCRETE FOOTING 5'-6" LOCKSET, LATCH GUARD, KEYED ALIKE, CLOSER, H.CAP THRESHOLD (B) SIDEWALL 5'-6" 4-PLY 2x6x22'-0" AGCO FP-24 FOOTING PAD (SEE NOTE/DETAIL) 10 24**"**ø 16' 0"x14' 0" B.E. =100' 4" 2 OVERHEAD DOOR I.D. =15' 11 1/2", 13-20" HEADROOM OPTION WITHOUT LINER, © VERT. BRACE 2-PLY 2x6x9'-2" VERTICAL BRACE B.E.=14' 1 1/2" TRIM INSIDE EDGE, DOOR NOT BY CLEARY (D) ENDWALL 3-PLY 2x6x24'-4" 5'-6" 4"x14"Ø PRECAST CONCRETE FOOTING 5'-6" (E) ENDWALL 3-PLY 2x6x25'-4" 4"x14"ø PRECAST CONCRETE FOOTING 5'-6" (F) ENDWALL 3-PLY 2x6x26'-0" 4"x14"ø PRECAST CONCRETE FOOTING

4"x14"ø PRECAST CONCRETE FOOTING

- 1. FIELD VERIFY ALL DOOR AND WINDOW ROUGH OPENING SIZES PRIOR TO INSTALLING FRAME-OUTS
- 2. ENDWALL COLUMNS ARE 3-PLY TO THE BUILDING EAVE HEIGHT AND 1-PLY FROM THERE TO THE ROOF PLANE

ROUGH OPENING & ACCESSORY FEATURES

- 3. 2x6 STANDARD DIAGONAL CORNER BRACING AT ALL CORNERS (UNLESS OTHERWISE NOTED)
- 4. END WALL 1 ON BUILDING 1 (EAST) INSTALL STANDARD 15" SHAMROCK
- 5. END WALL 2 ON BUILDING 1 (WEST) INSTALL STANDARD 15" SHAMROCK

THE FOOTING PAD IS THE AGCO

75 TOTAL BAGS OF SACKCRETE


REQUIRED FOR COLUMN ANCHORAGE

3-PLY 2x6x28'-8"

5'-6"


18"ø

MOLDED COMPOSITE CIRCULAR FOOTING PAD (SEE ESR-2147)

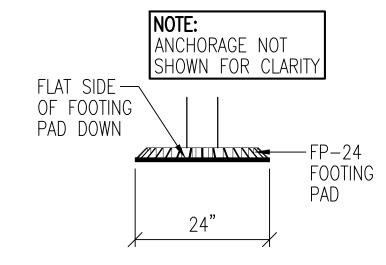


FOOTING PAD DETAIL

= ANCHOR COLUMNS WITH (6) 60# BAGS OF SACKCRETE AND (1) #4x12" REBAR FOR UPLIFT = ANCHOR COLUMNS WITH (3) 60# BAGS OF SACKCRETE AND (1) #4x12" REBAR FOR UPLIFT NOTE: COLUMN SETS ON TOP OF FOOTING - CHECK COLUMN CHART FOR EXACT FOOTING SIZE REQUIREMENTS

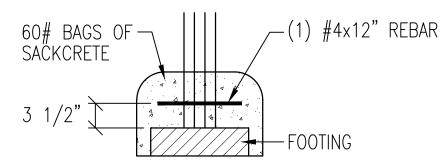


COLUMN ANCHOR DETAIL

ANCHOR COLUMNS WITH (2) 2x6x8" TREATED BLOCKS ATTACHED TO COLUMN WITH (3) 20d NAILS PER EACH BLOCK FOR UPLIFT NOTE: COLUMN SETS ON TOP OF FOOTING — CHECK COLUMN CHART FOR EXACT FOOTING SIZE REQUIREMENTS

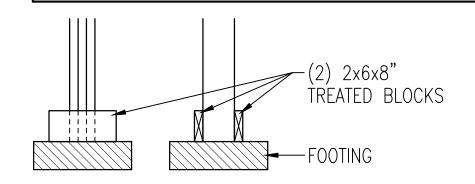

COLUMN ANCHOR DETAIL

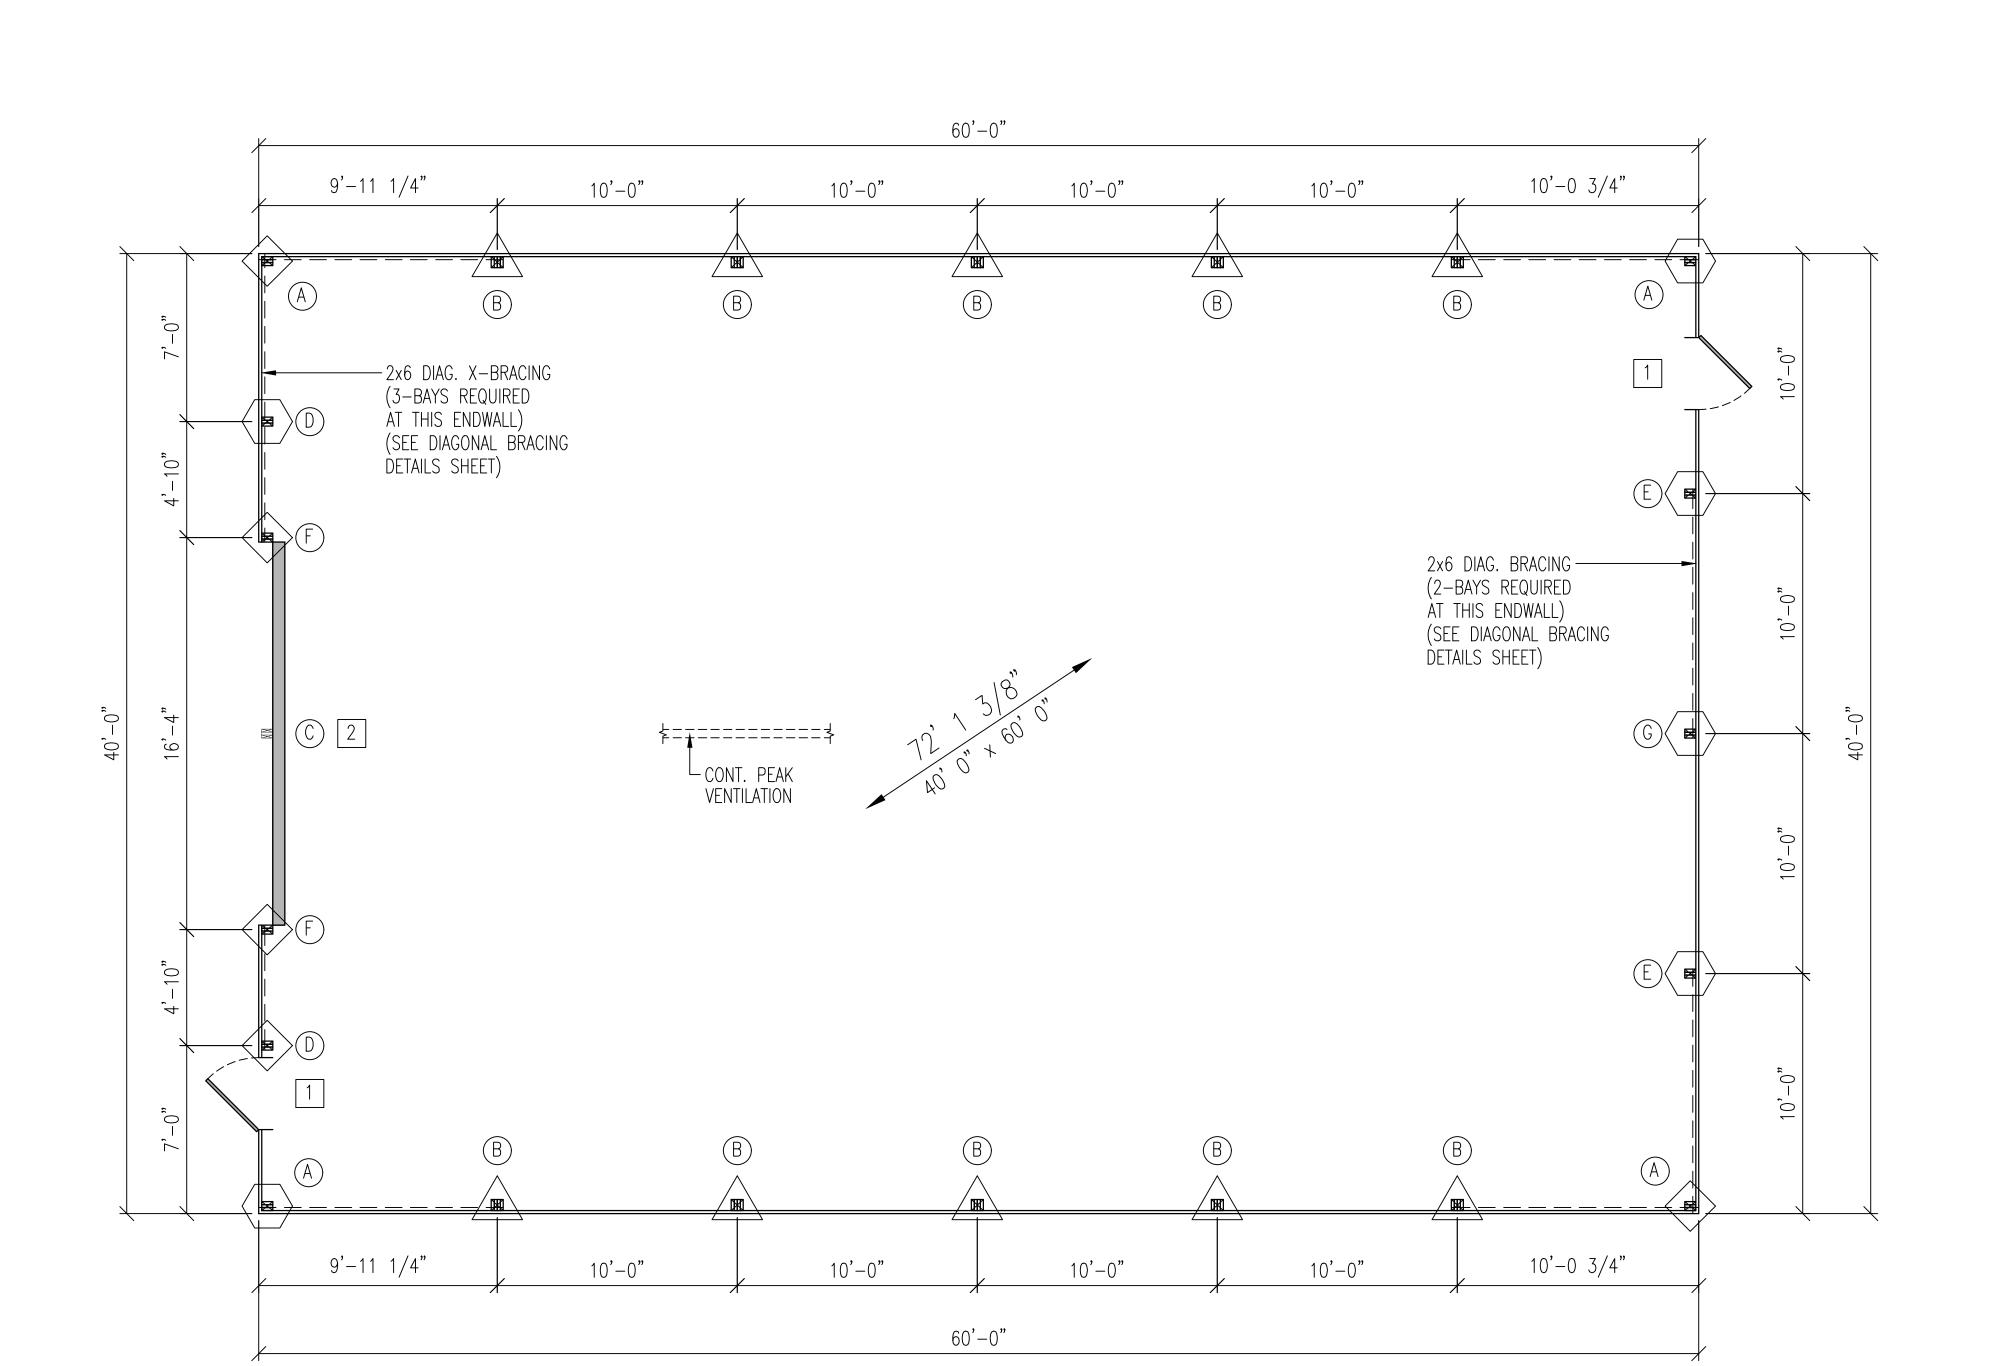

:\\1CAD FILES\2025\20251(ited: 2/10/2025 12:19 PM

G ENDWALL

IUMBER	DATE	BY
1		
2		
3		
4		

FRAMING

TYLEF

PROJECT NUMBER: 2025100424

SHEET NUMBER: 125


WHEN PRINTED ON 24"x36" PAPER SCALE IS 1/4"=1'-0"




TRUSS INFORMATION SCREW PLACEMENT HOLE DESCRIPTION NONE TB39-9SEW4WO-H12HEEL125W PURLINS NAILED NONE TA39-9PLSC37STNO100C4TRUSS125W PURLINS NAILED NONE PURLINS NAILED TA39-9PLSC37STN0100C4TRUSS125W NONE PURLINS NAILED TA39-9PLSC37STNO100C4TRUSS125W NONE TA39-9PLSC37STN0100C4TRUSS125W PURLINS NAILED NONE TA39-9PLSC37STN0100C4TRUSS125W PURLINS NAILED NONE TB39-9SEW4WO-H12HEEL125W PURLINS NAILED

- 1. 2x6 JACKBRACING AT ENDWALL COLUMNS (NOT NEEDED AT FULL LENGTH COLUMNS) ├─ = LOCATION ON THIS SHEET FOR JACKBRACING (SEE DETAIL THIS SHEET)
- 2. 2x4 PURLIN BLOCKING AT ENDWALL TRUSSES
- 3. (>>>) = BAYS WITH 2x4 ROOFLINE X-BRACING (SEE DETAIL THIS SHEET)


ATTACH ALL PURLINS TO TRUSS WITH 1) 60d NAIL AND TOE-NAIL WITH) 10d NAIL, ALSO ATTACH ROOF

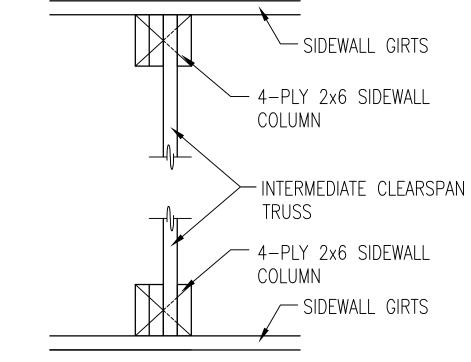

TYPICAL TRUSS PLACEMENT DETAIL

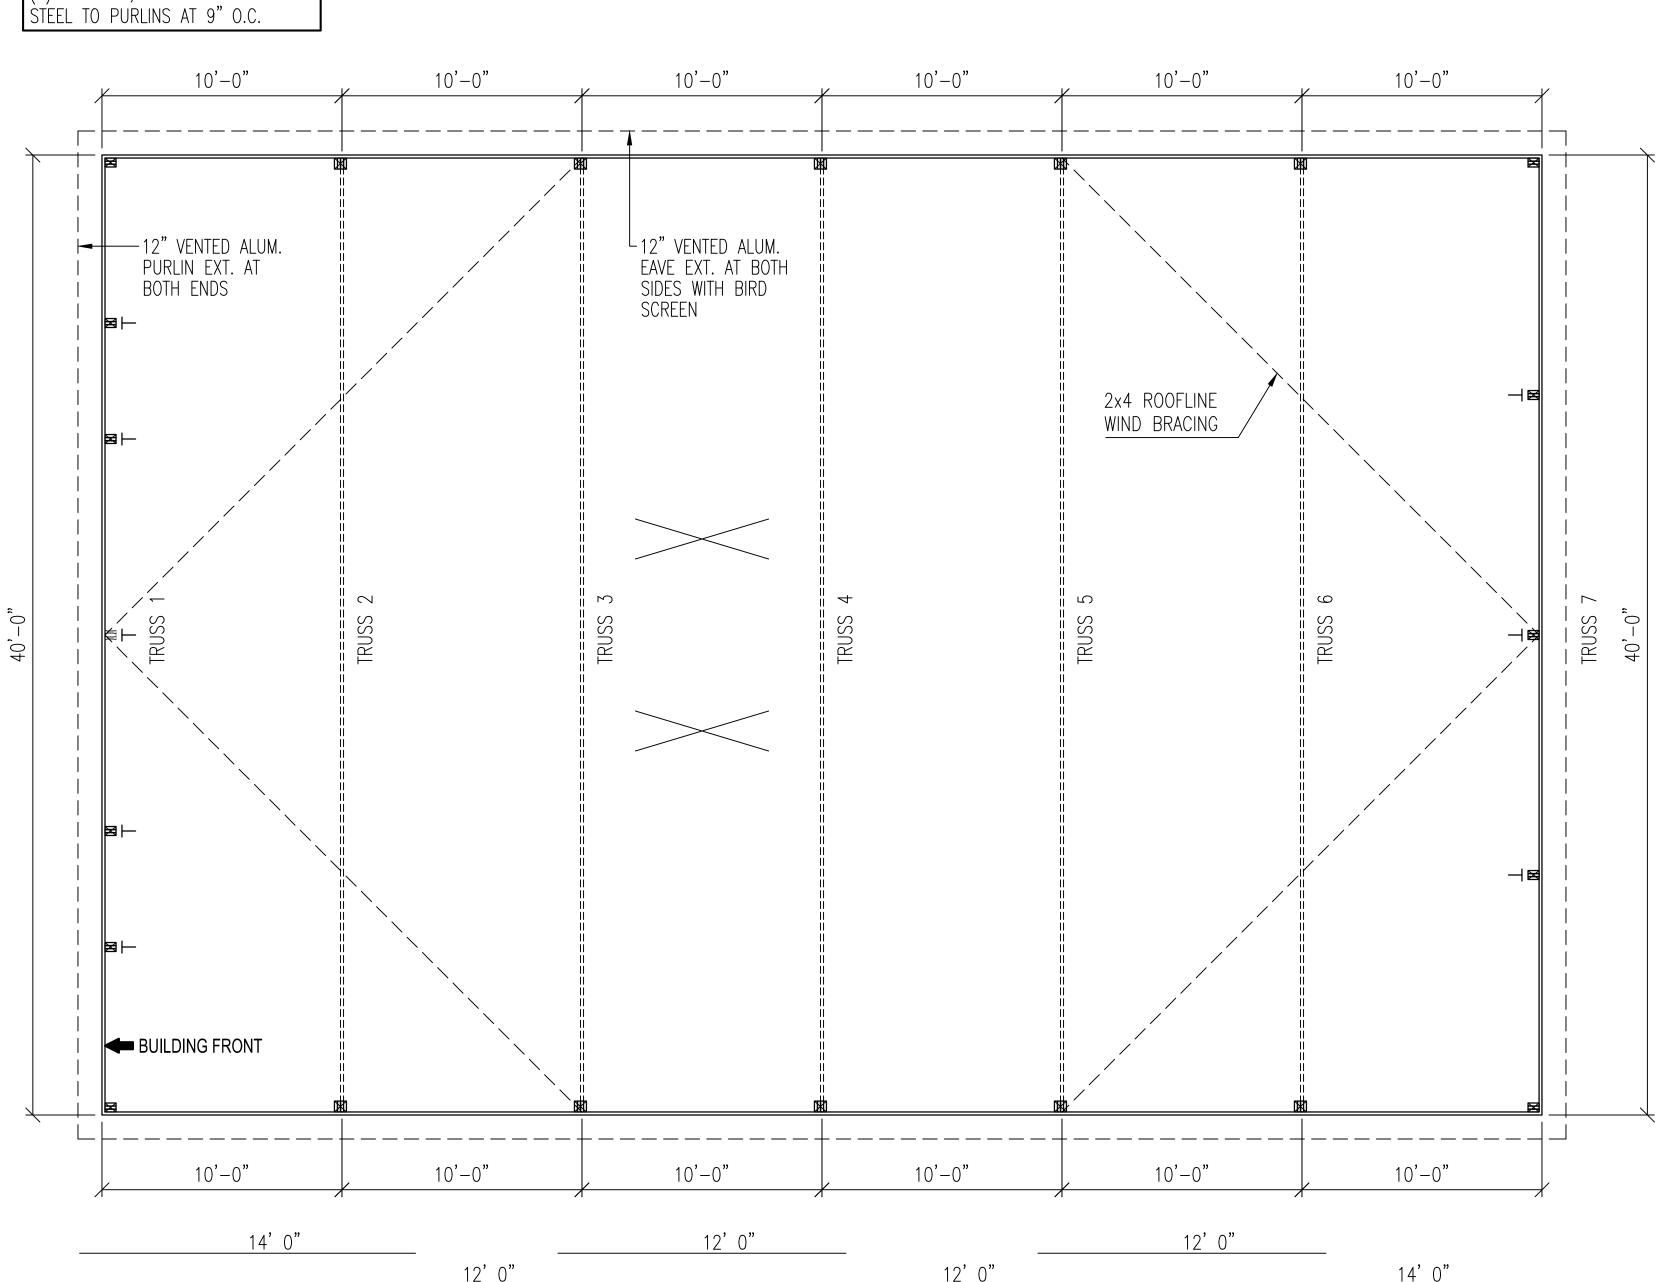





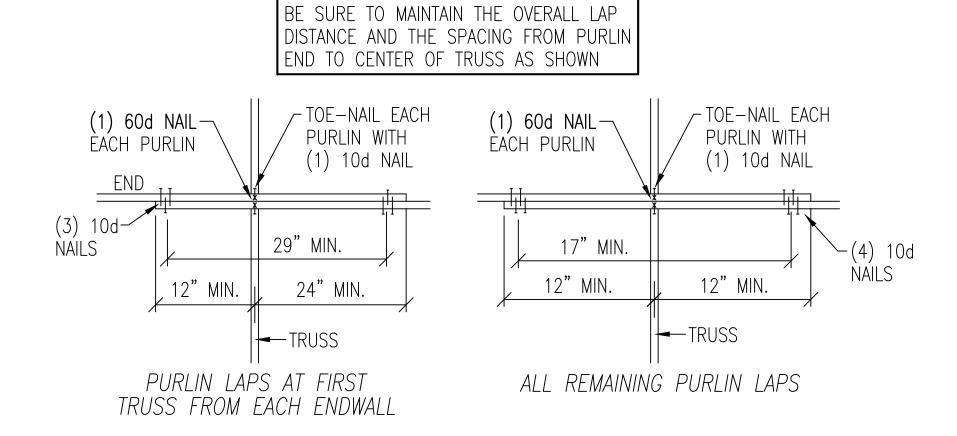

CONT. PURLIN DESIGN


CONSTRUCTION FOREMAN NOTE:

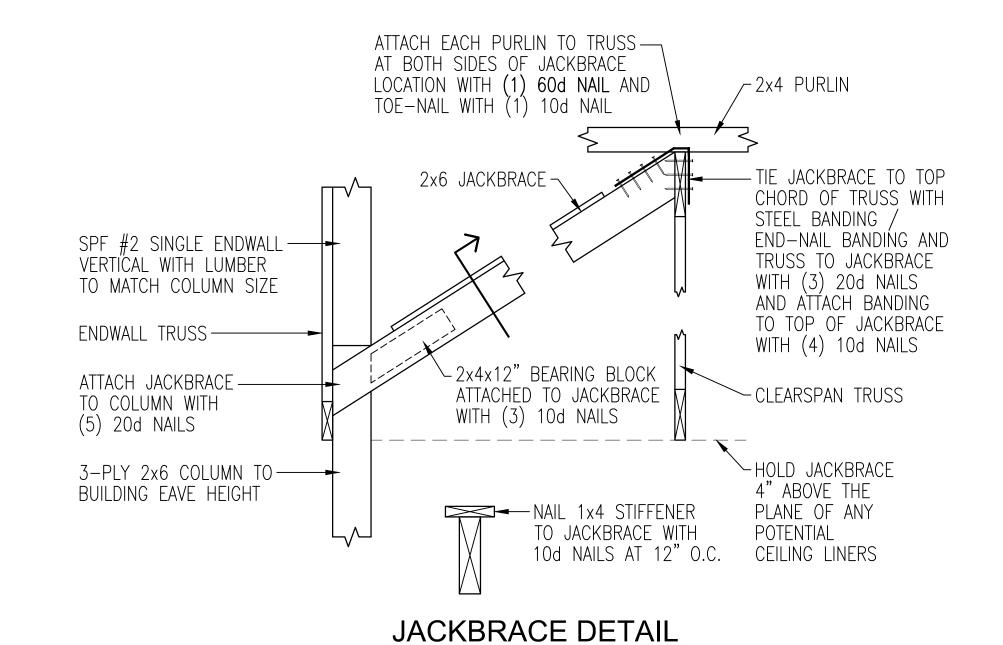

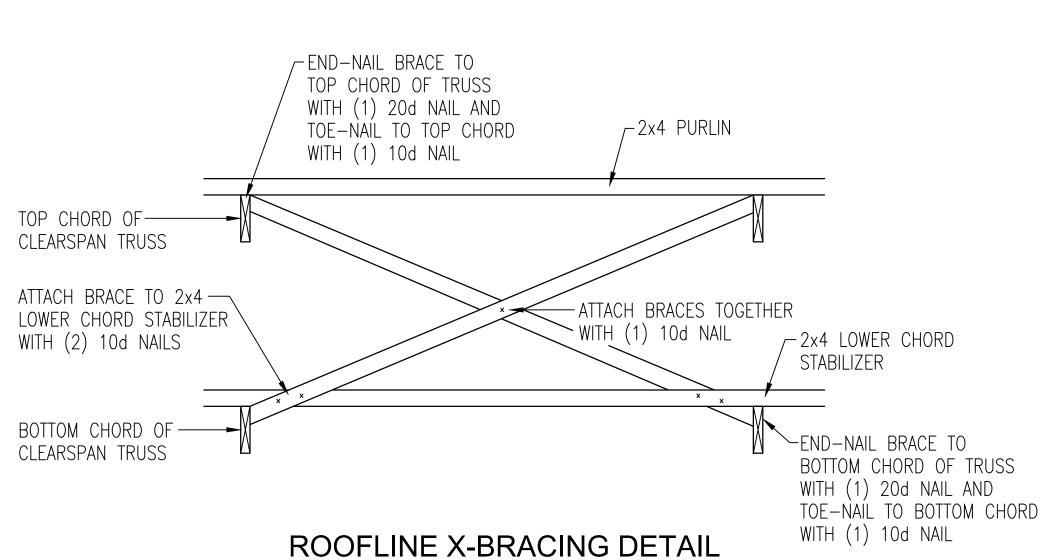

AT ENDWALL COLUMNS

X—BRACING IS ATTACHED TO LOWER CHORD STABILIZER

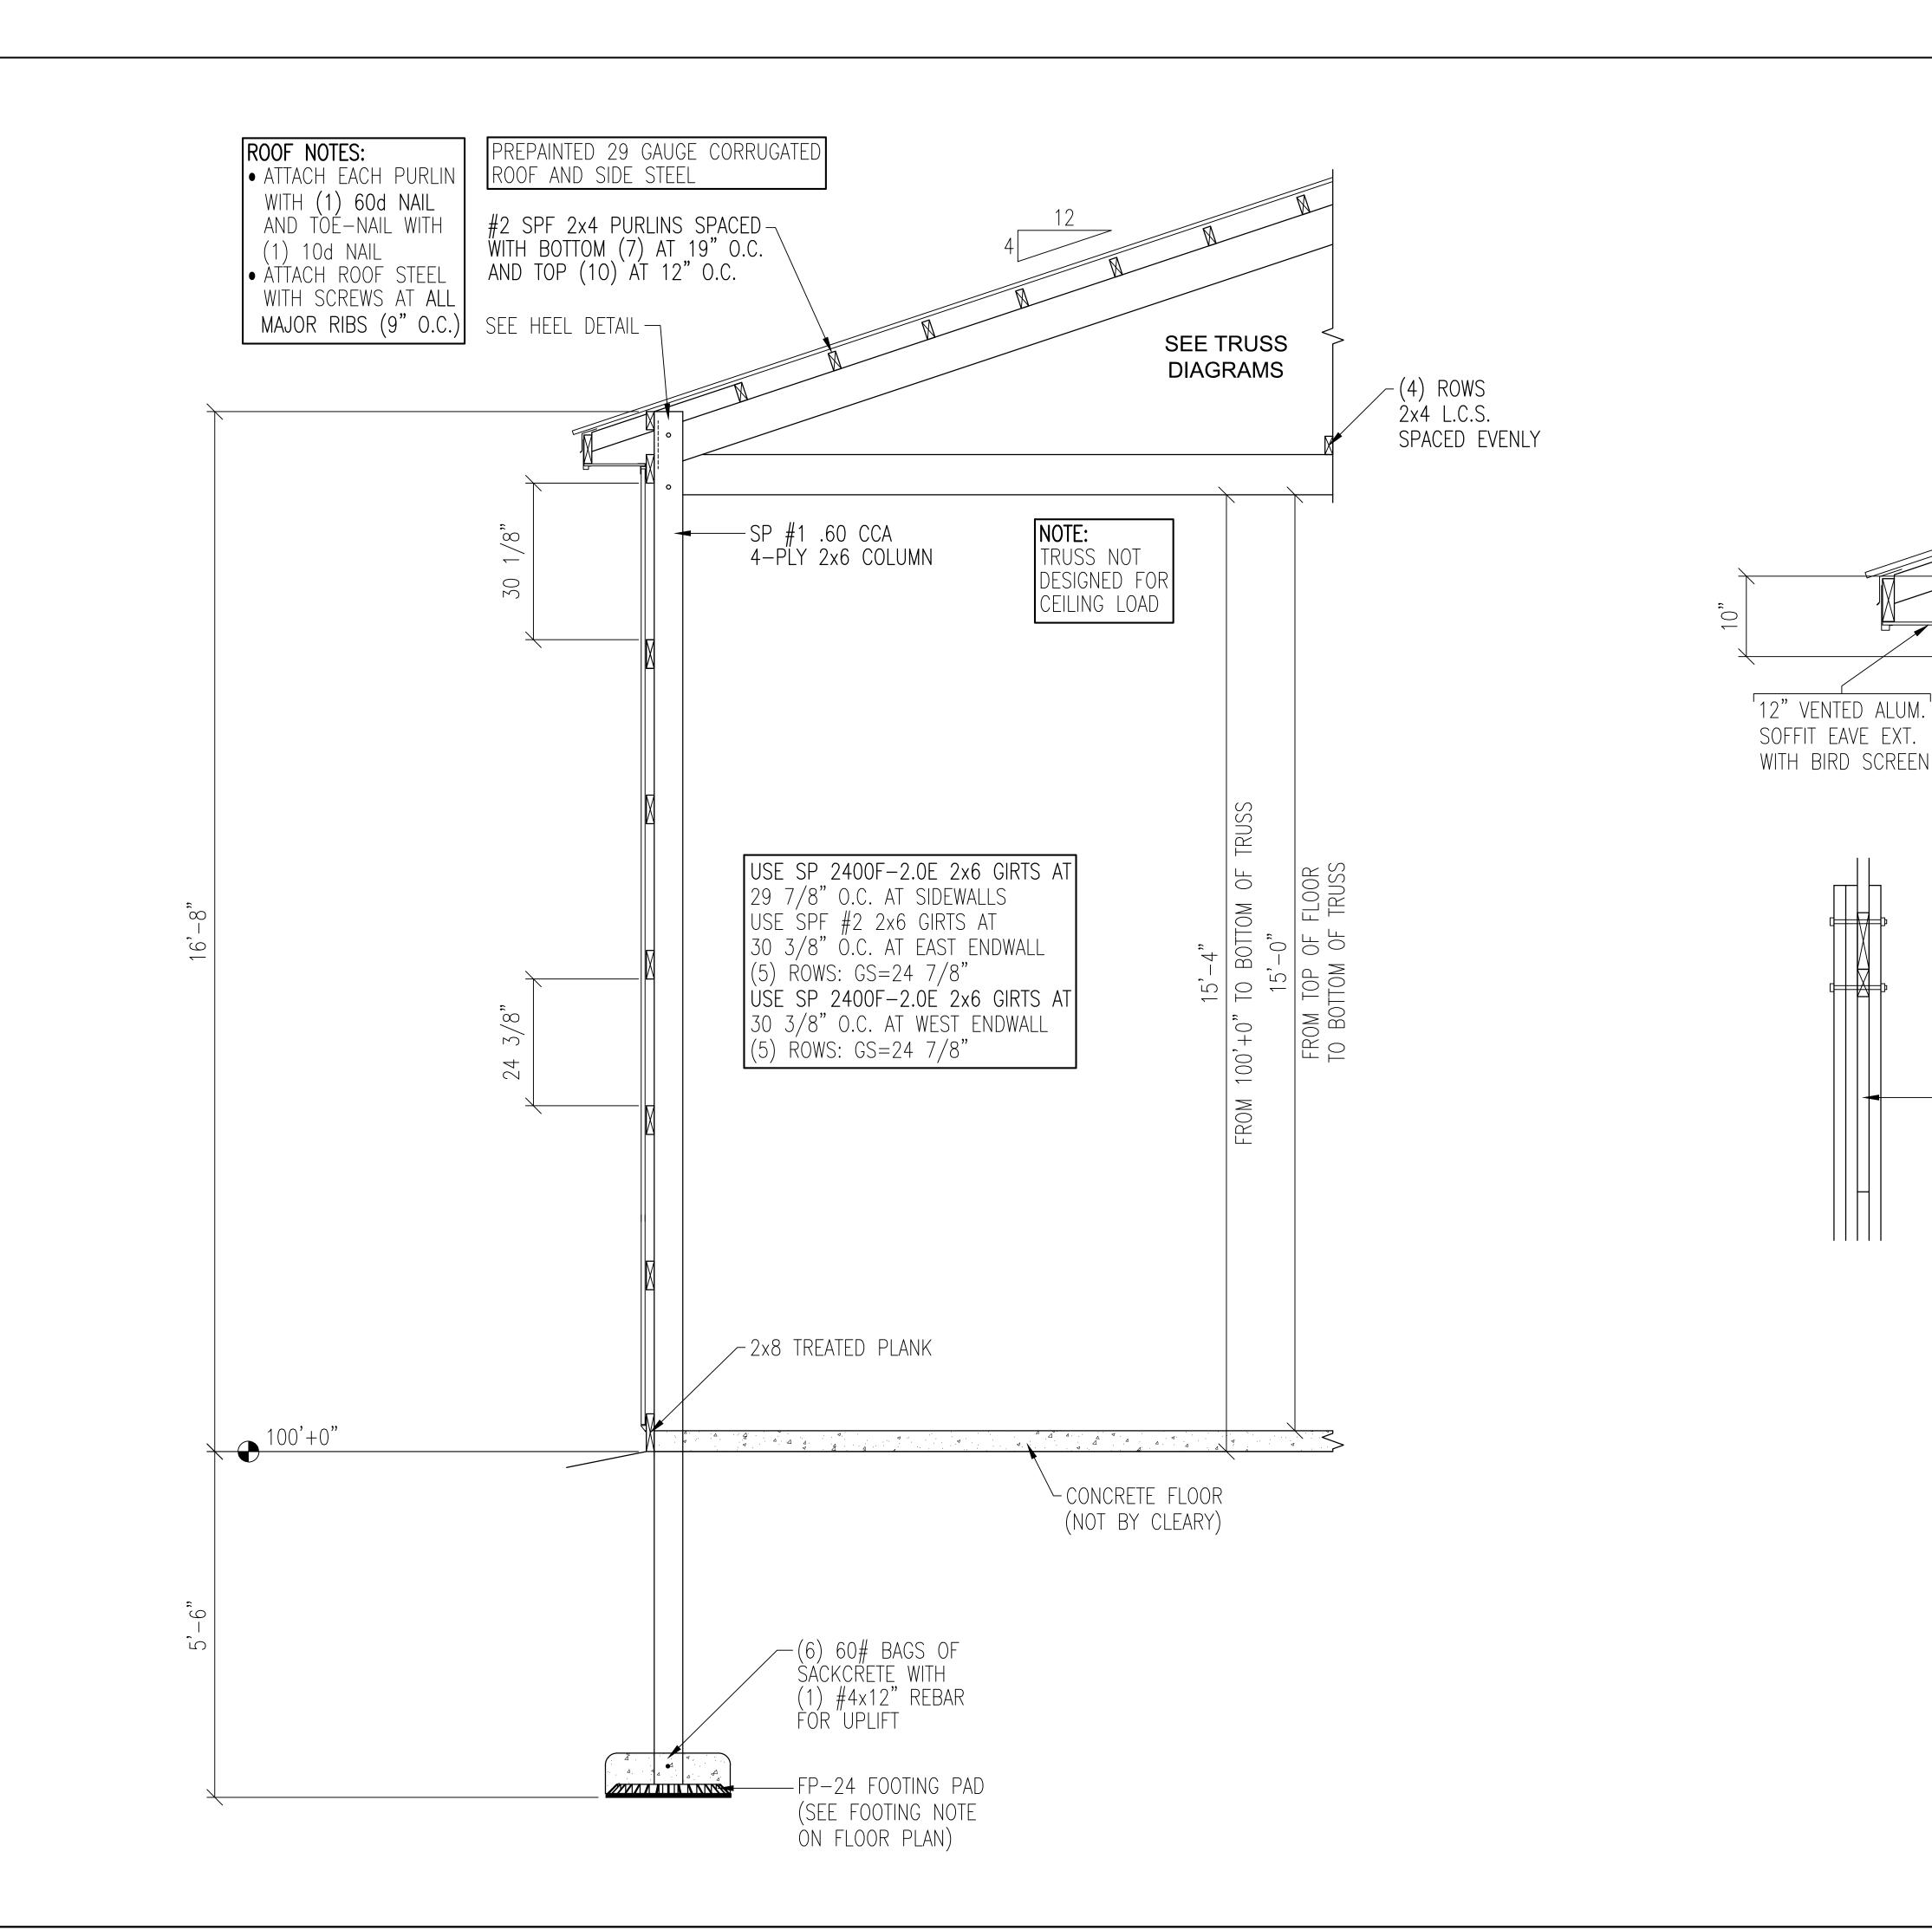

nerd\1CAD FILES\2025\20251 Printed: 2/10/2025 12:19 PM LEARY
BUILDING CORP.

190 PAOLI STREET / P.O. BOX 930220
VERONA, WI 53593 / (800) 373-5550

DRAWN BY: JENKINS

DATE DRAWN: 02/10/25

PLAN REVISIONS:

NUMBER DATE BY

1
2

- ATTACH TRUSS TO COLUMN

WITH (2) 1/2"øx7" BOLTS AND NAIL WITH (2) 20d NAILS PER BOLT

- ADJUSTING BLOCK

HEEL AND CENTER

PLY OF COLUMN TO

BE FIELD CUT TO FIT

HEEL DETAIL

BETWEEN TRUSS

UMBER DATE BY

1
2
3
4

1236 N 18TH ST SHEBOYGAN, WI 53083 (SHEBOYGAN) JILDING SIZE: 40' 0" x 60' 0" x 16' 8" HEET NAME:

TYLER


PROJECT NUMBER: 2025100424

SHEET NUMBER:

130

WHEN PRINTED ON 24"x36" PAPER SCALE IS 3/4"=1'-0"



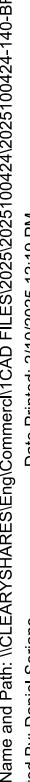

#2 SPF 2x6-DIAGONAL BRACE ATTACH DIAGONAL BRACE-TO EACH GIRT WITH (4) 10d NAILS

BRACE TO GIRT CONNECTION DETAIL

ATTACH 2x4 BEARING BLOCK

COLUMN WITH (5) 20d NAILS

- ATTACH BOTTOM CHORD OF

ENDWALL TRUSS TO BUILDING

COLUMN WITH (5) 20d NAILS

BRACE WITH (11) 10d NAILS


(BEARING BLOCK BEARS ON


BOTTOM CHORD OF TRUSS)

OR TRUSS VERTICAL TO


— 2x6x24" BEARING BLOCK

ATTACHED TO DIAGONAL

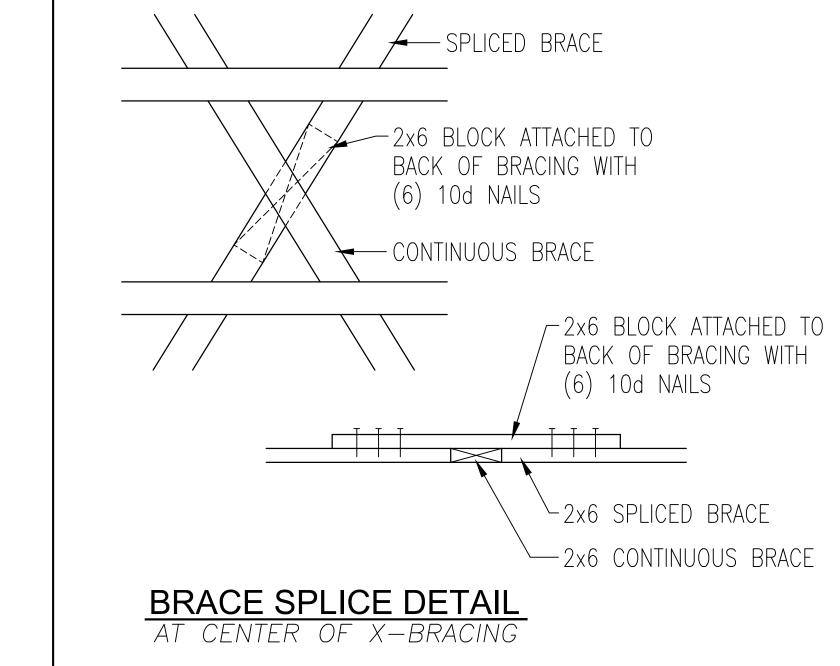

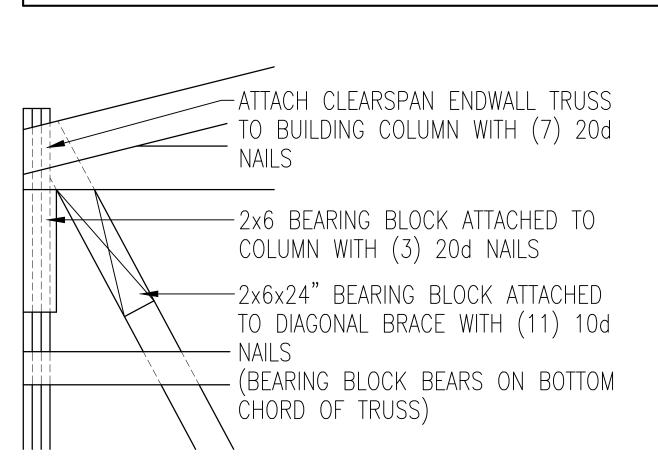


BRACE CONNECTION DETAIL AT TOP OF BRACE AT CORNER COLUMN

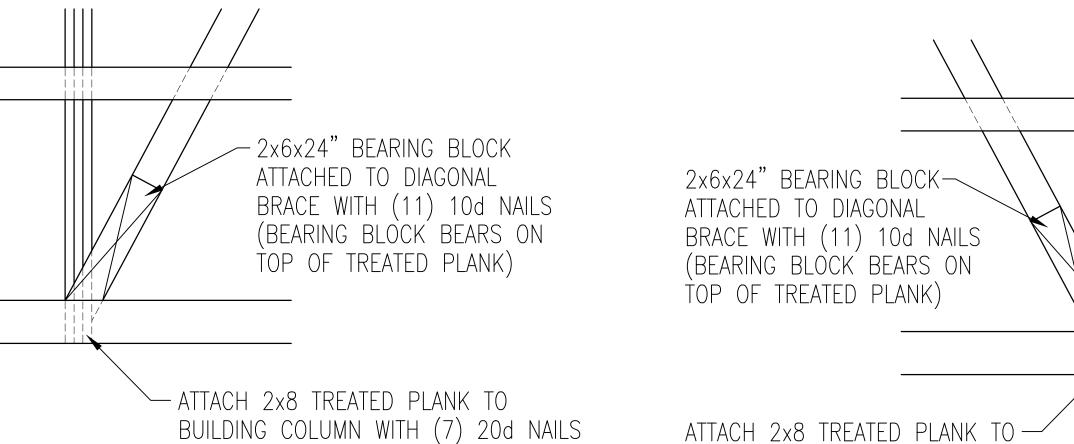

BRACE CONNECTION DETAIL AT BOTTOM OF BRACE AT ENDWALL COLUMN

BRACE CONNECTION DETAIL


AT TOP OF BRACE AT ENDWALL COLUMN

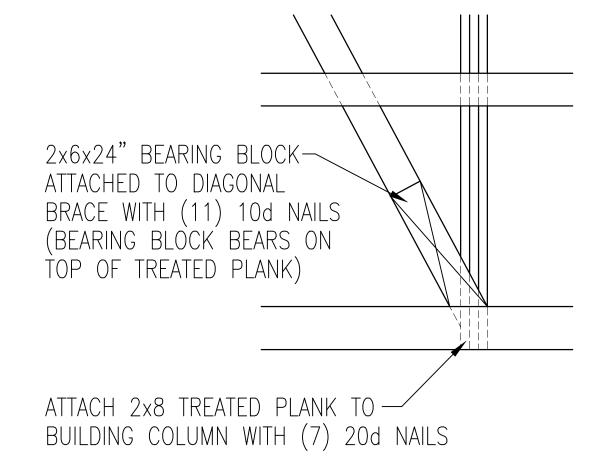


BRACE CONNECTION DETAIL AT BOTTOM OF BRACE AT ENDWALL COLUMN

ENDWALL DIAGONAL BRACING DETAIL


AT WEST ENDWALL

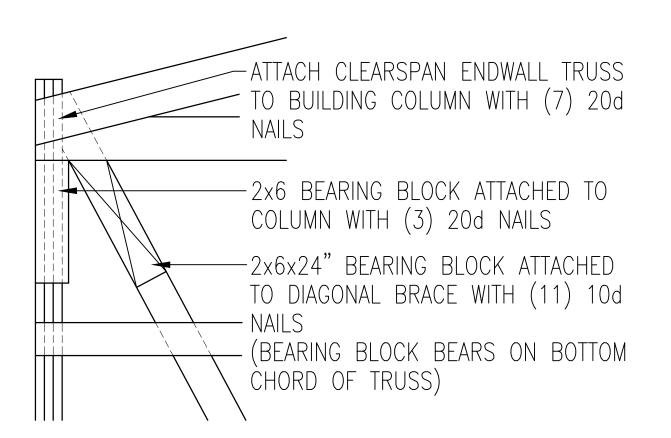


BRACE CONNECTION DETAIL AT TOP OF BRACE AT CORNER COLUMN

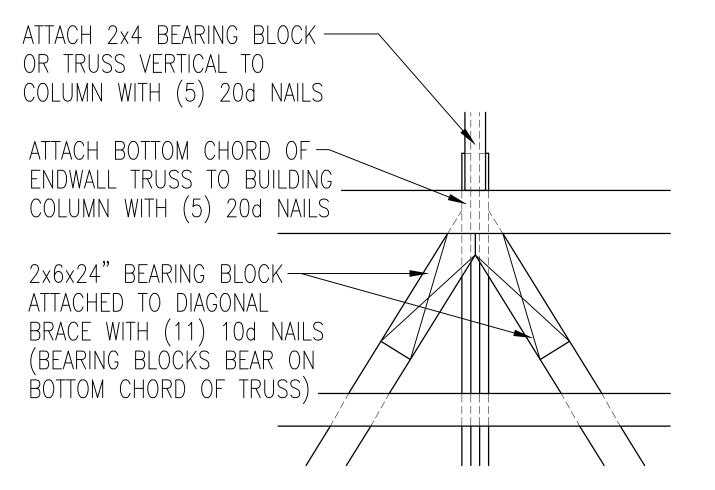


BRACE CONNECTION DETAIL AT TOP OF BRACE AT ENDWALL COLUMN

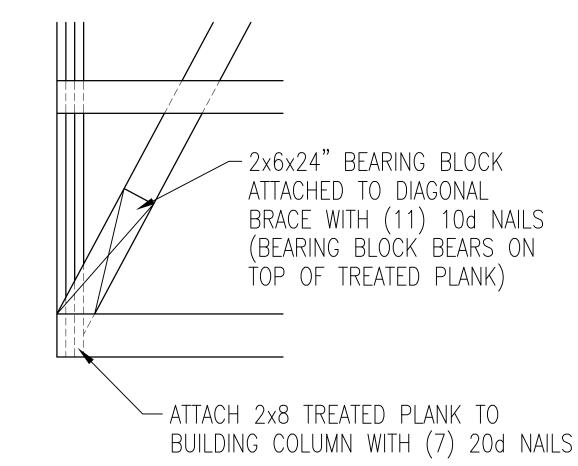

BRACE CONNECTION DETAIL AT BOTTOM OF BRACE AT ENDWALL COLUMN

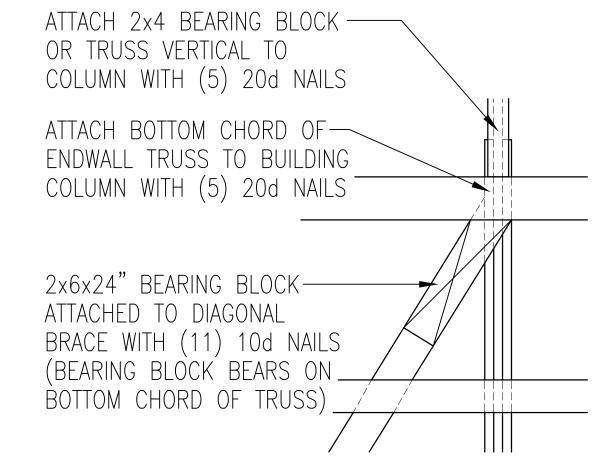

BRACE CONNECTION DETAIL AT TOP OF BRACE AT ENDWALL COLUMN

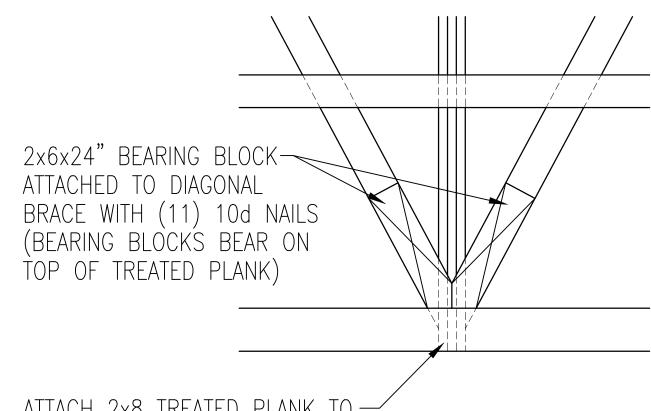

ATTACH 2x8 TREATED PLANK TO-BUILDING COLUMN WITH (7) 20d NAILS

BRACE CONNECTION DETAIL AT BOTTOM OF BRACE AT ENDWALL COLUMN

2x6x24" BEARING BLOCK— ATTACHED TO DIAGONAL BRACE WITH (11) 10d NAILS (BEARING BLOCK BEARS ON TOP OF TREATED PLANK)

ATTACH 2x8 TREATED PLANK TO — BUILDING COLUMN WITH (7) 20d NAILS


BRACE CONNECTION DETAIL

AT BOTTOM OF BRACE AT ENDWALL COLUMN

PAPER SCALE IS N.T.S.

ENDWALL DIAGONAL X-BRACING DETAIL


AT EAST ENDWALL

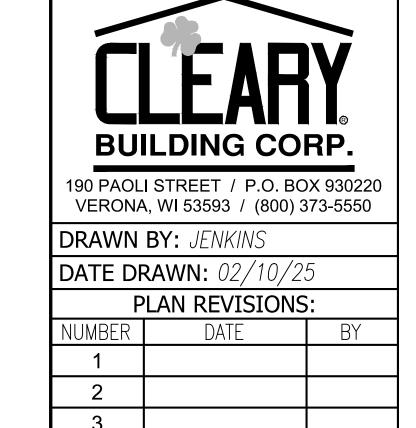


PROJECT NUMBER: 2025100424

SHEET NUMBER: 140



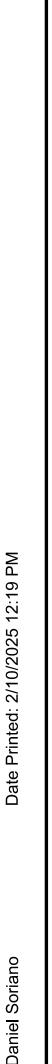

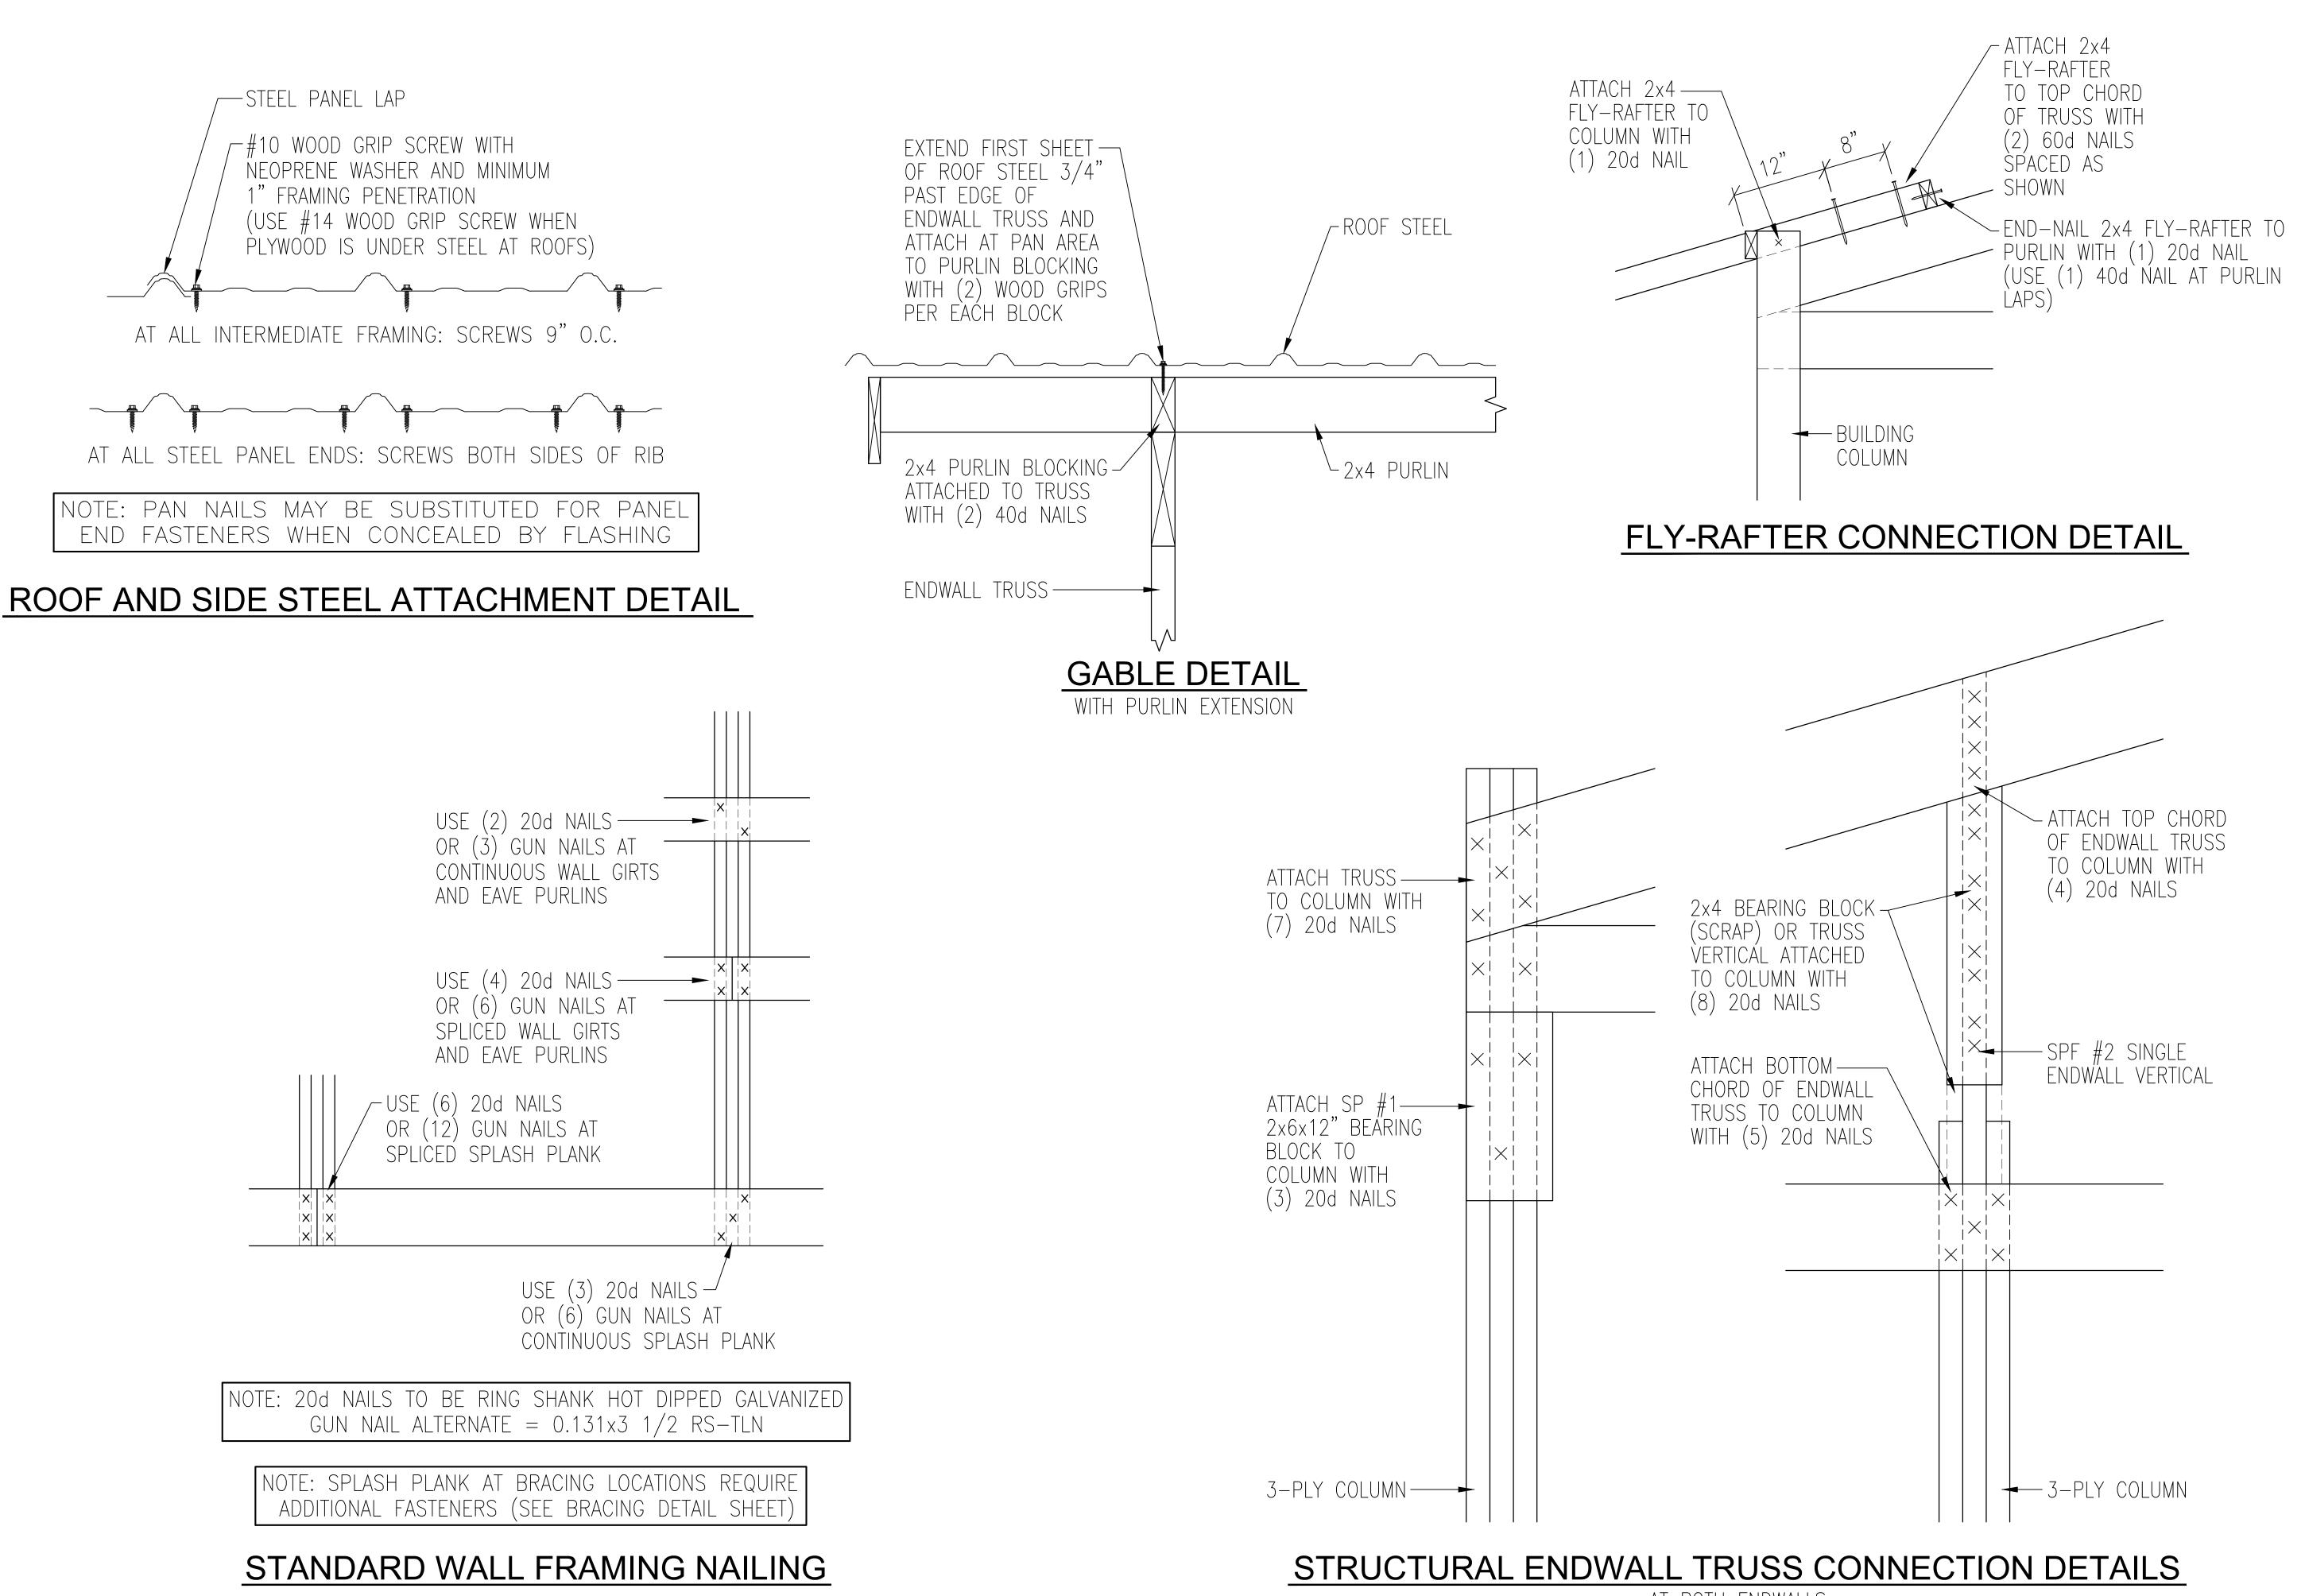

BUILDING CORP.

190 PAOLI STREET / P.O. BOX 930220 VERONA, WI 53593 / (800) 373-5550 DRAWN BY: JENKINS

DATE DRAWN: 02/10/25

PLAN REVISIONS:

NUMBER

2 3 4

ACTION

PROJECT NUMBER: 2025100424

SHEET NUMBER: 150

PAPER SCALE IS N.T.S.



AT BOTH ENDWALLS

SEQN: 136600

FROM: AJY

COMN | Ply: 1

Qty: 1

Job Number: 2025100424


Truss Label: TA39-9PLSC37STNO10OC4truss125W


19'10"8

25'8"8

Cust: R 7054 JRef: 1Y7a70540001 T2887

DrwNo: 037.25.1022.03087

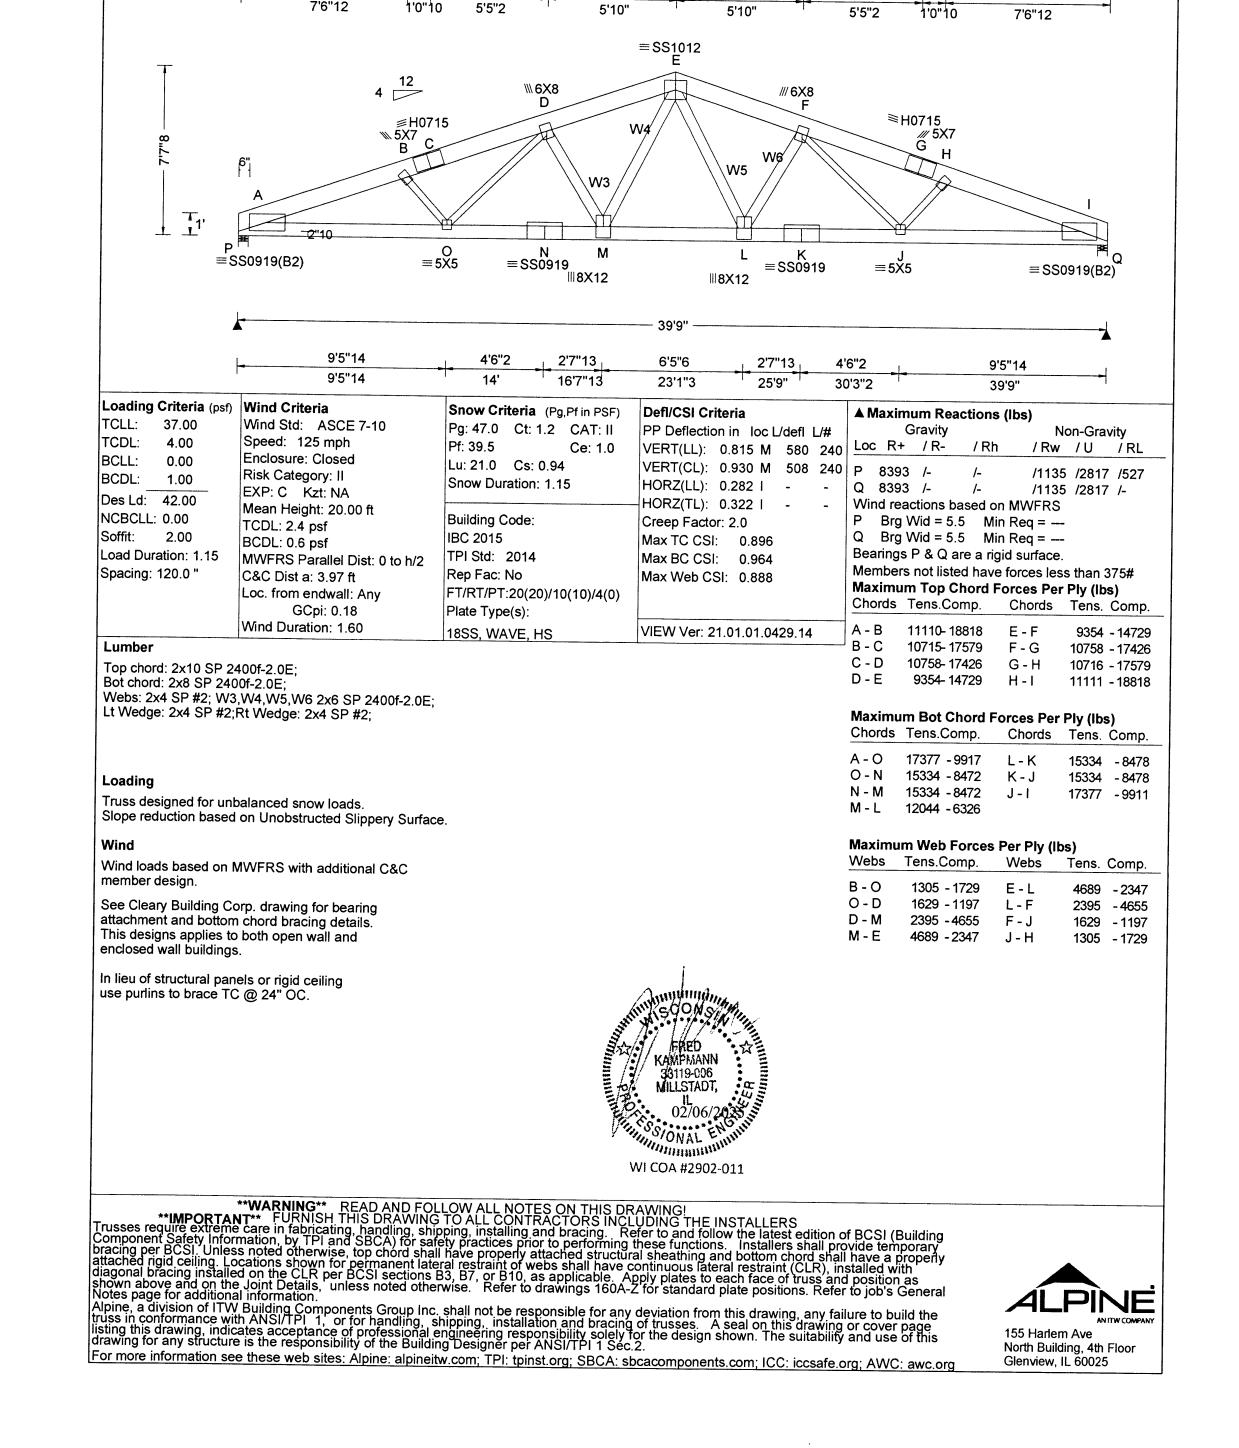

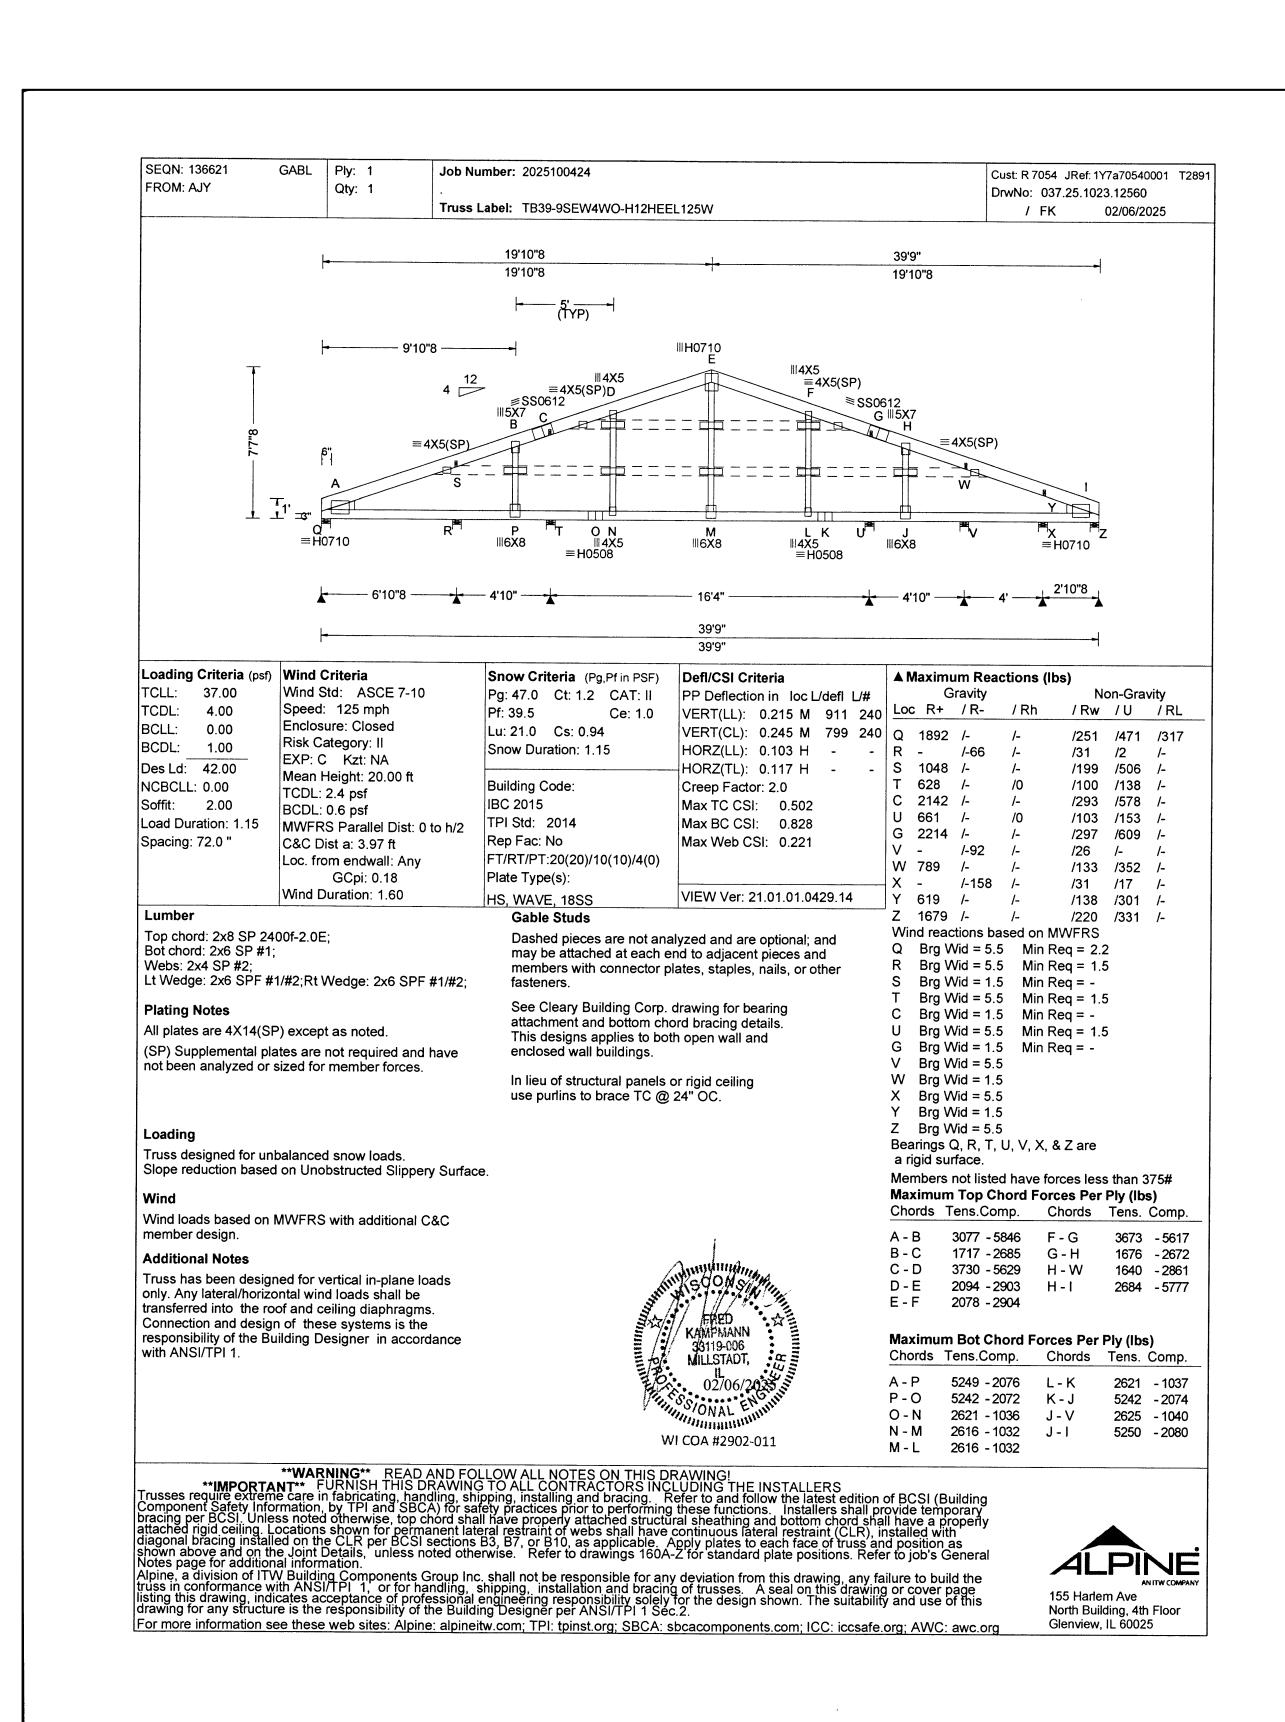

TRUSS CHECK (CHECK BOX AND INITIAL)

X TRUSS SIZE

X ROOF PITCH NJJ

X BAY SPACING

X SLC / RLC

X DESIGN LOADS NJJ

X OVERHANGS NJJ

CLEARY
BUILDING CORP.
400 BAOLL CEREET / D.O. BOY 0202

190 PAOLI STREET / P.O. BOX 930220 VERONA, WI 53593 / (800) 373-5550

DRAWN BY: JENKINS

DATE DRAWN: 02/10/25

PLAN REVISIONS:

NUMBER 4

2

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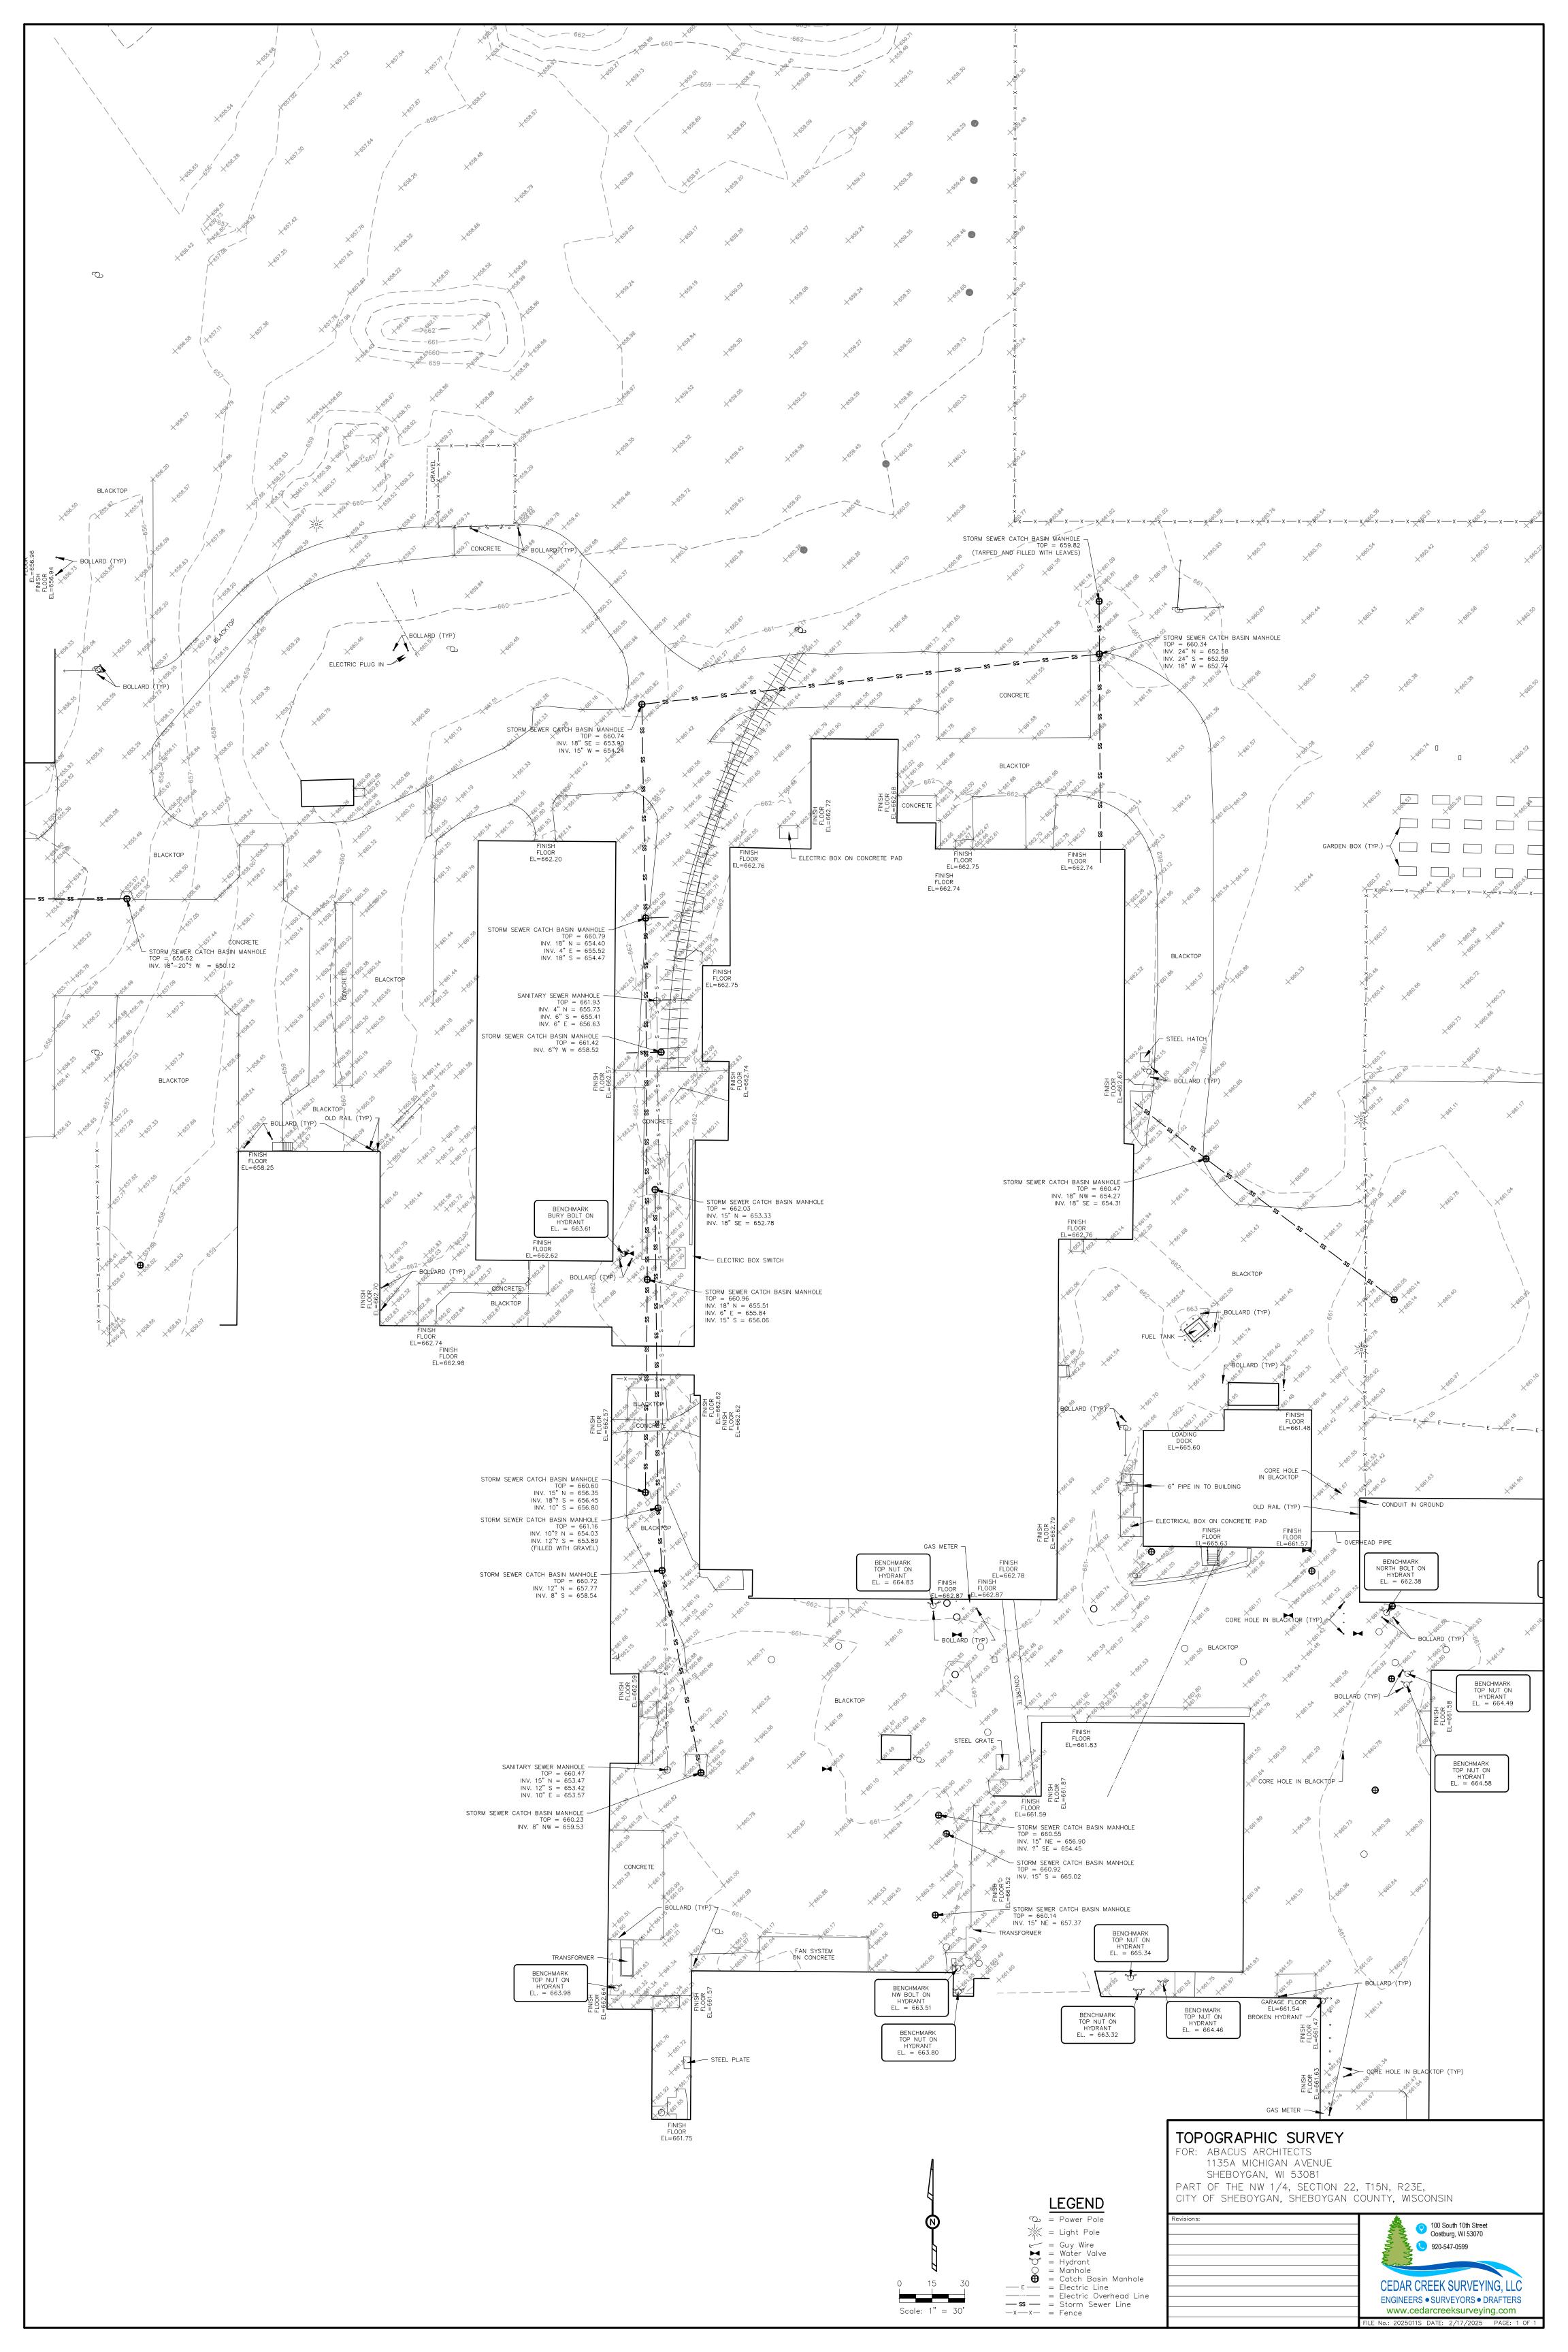
16' × PROJECT SITE ADI 1236 N 18TH S SHEBOYGAN, V BUILDING SIZE: 40' 0" x 60' 0" SHEET NAME: TRUSS DIAGRA 0


ROJECT NAME CHAPPA PROJECT NUMBER: 2025100424


> SHEET NUMBER: 160


PAPER SCALE IS N.T.S.





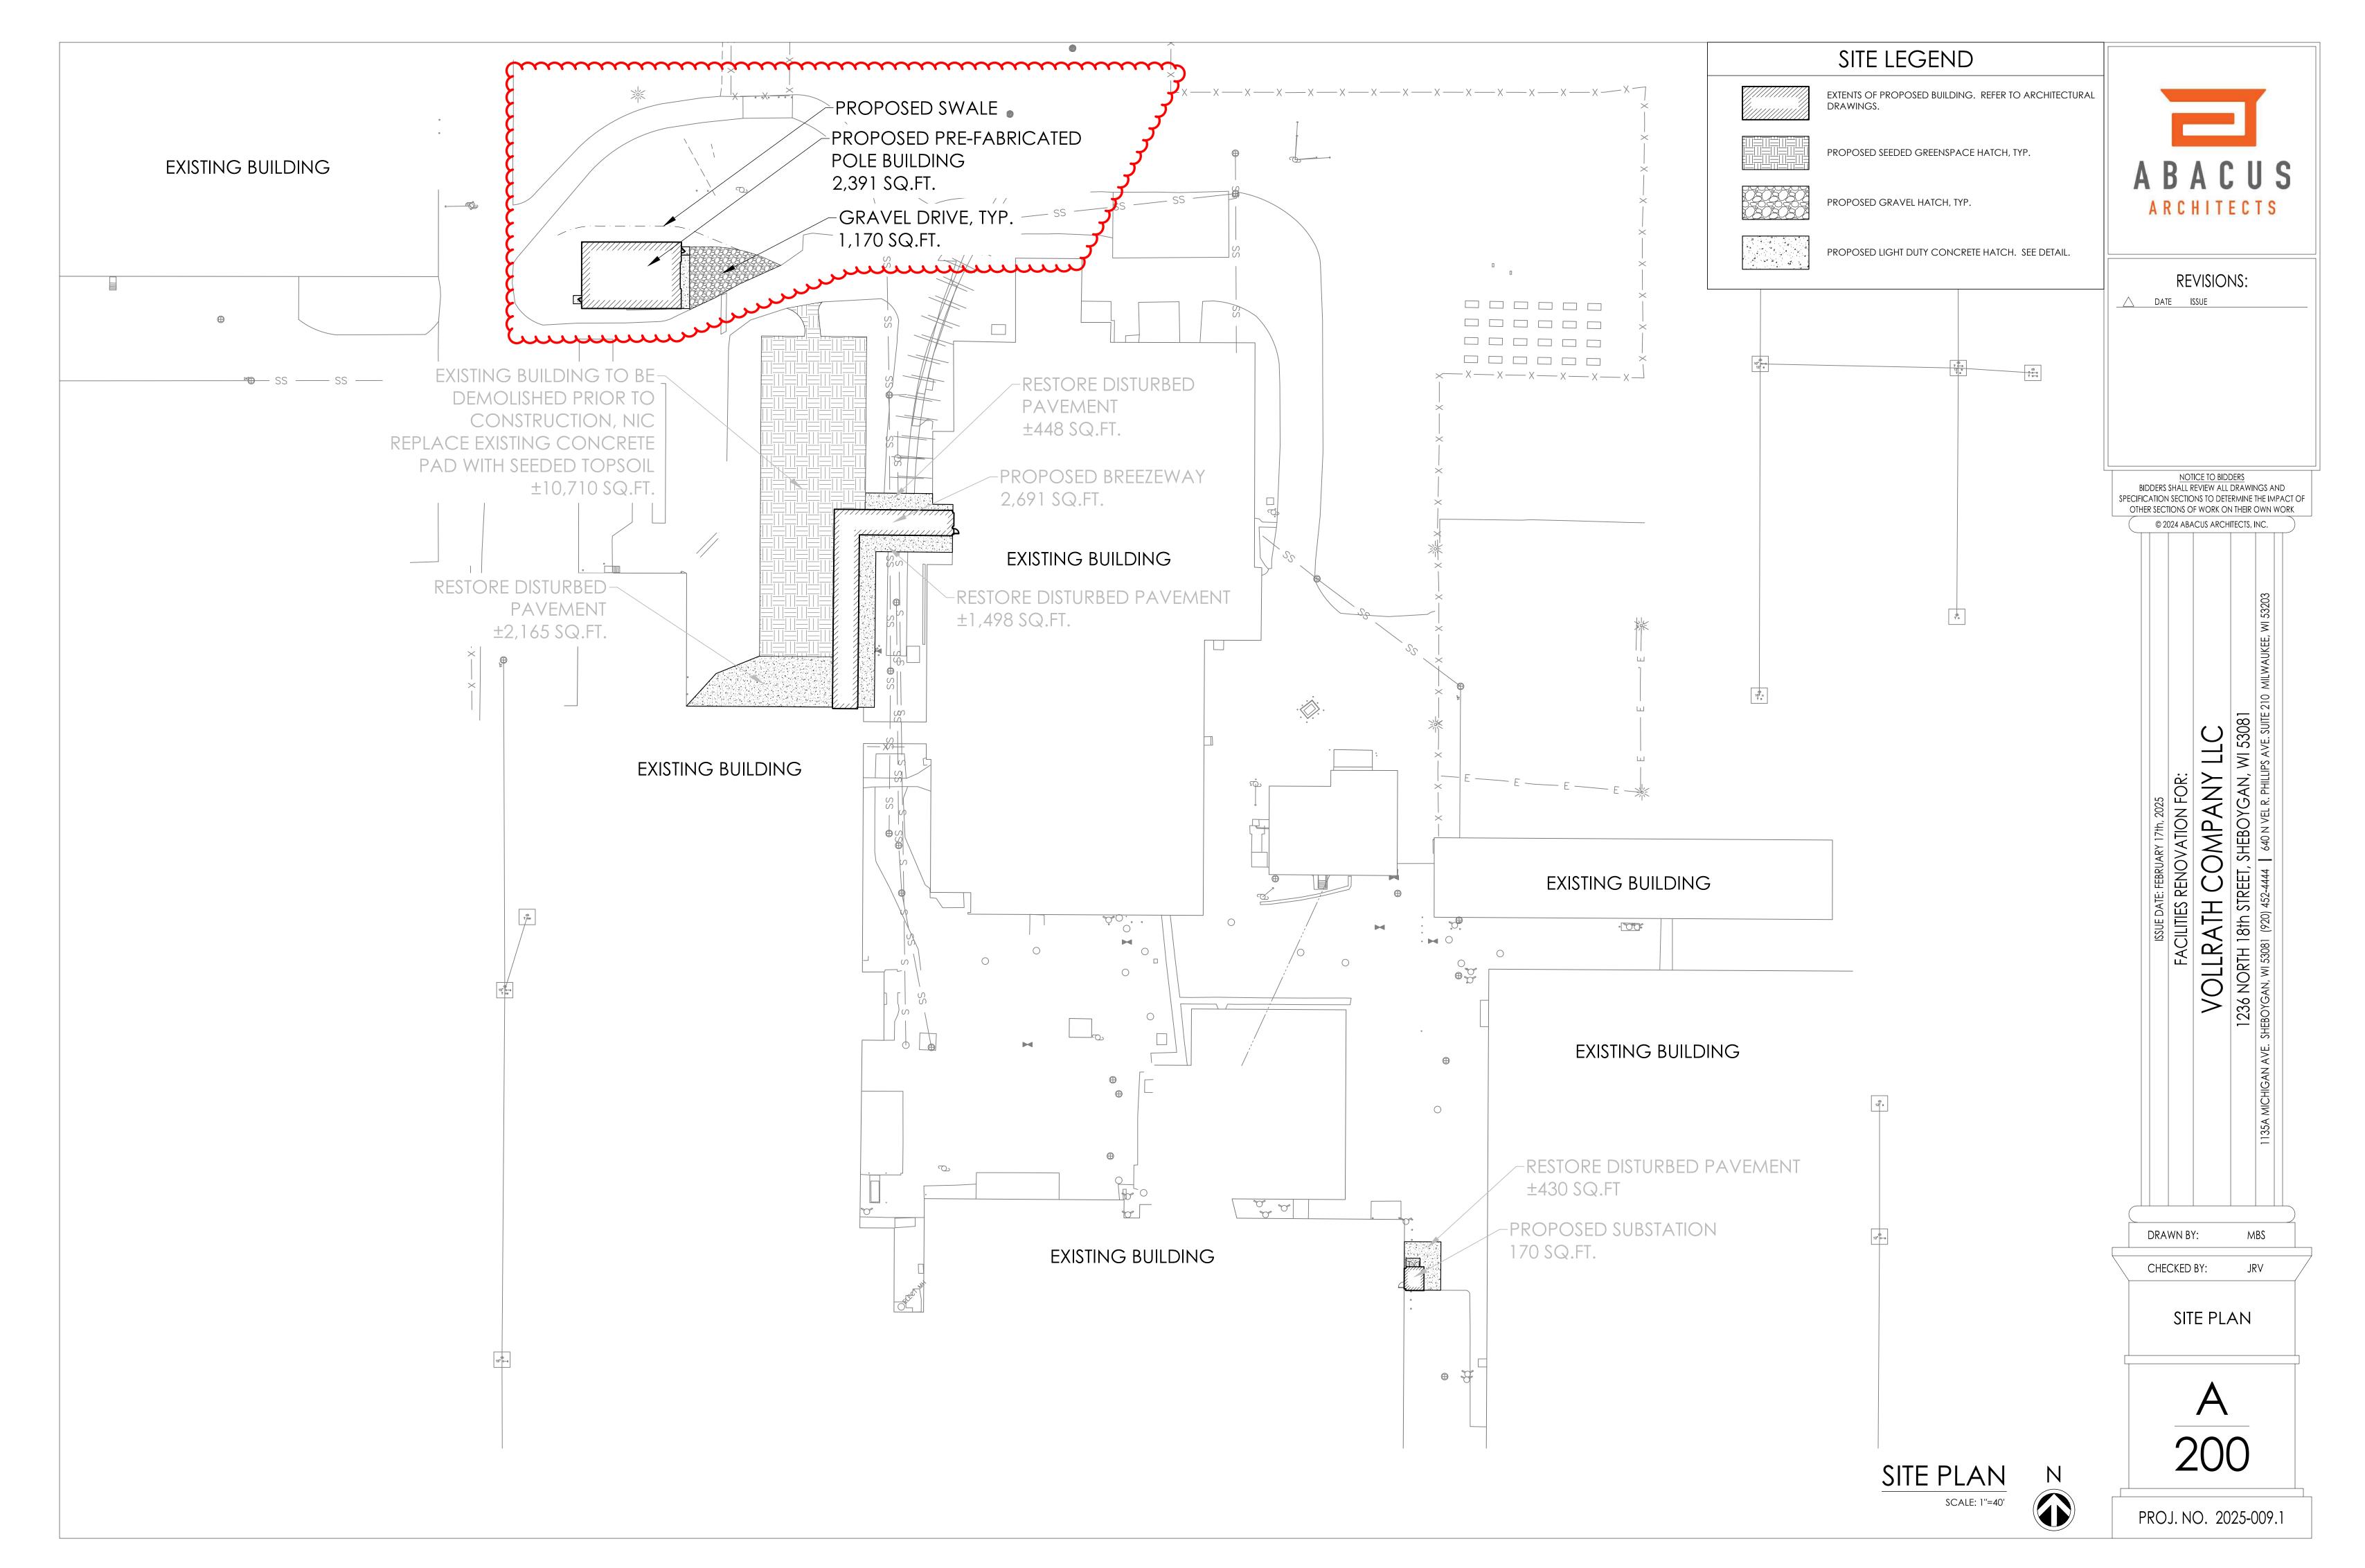

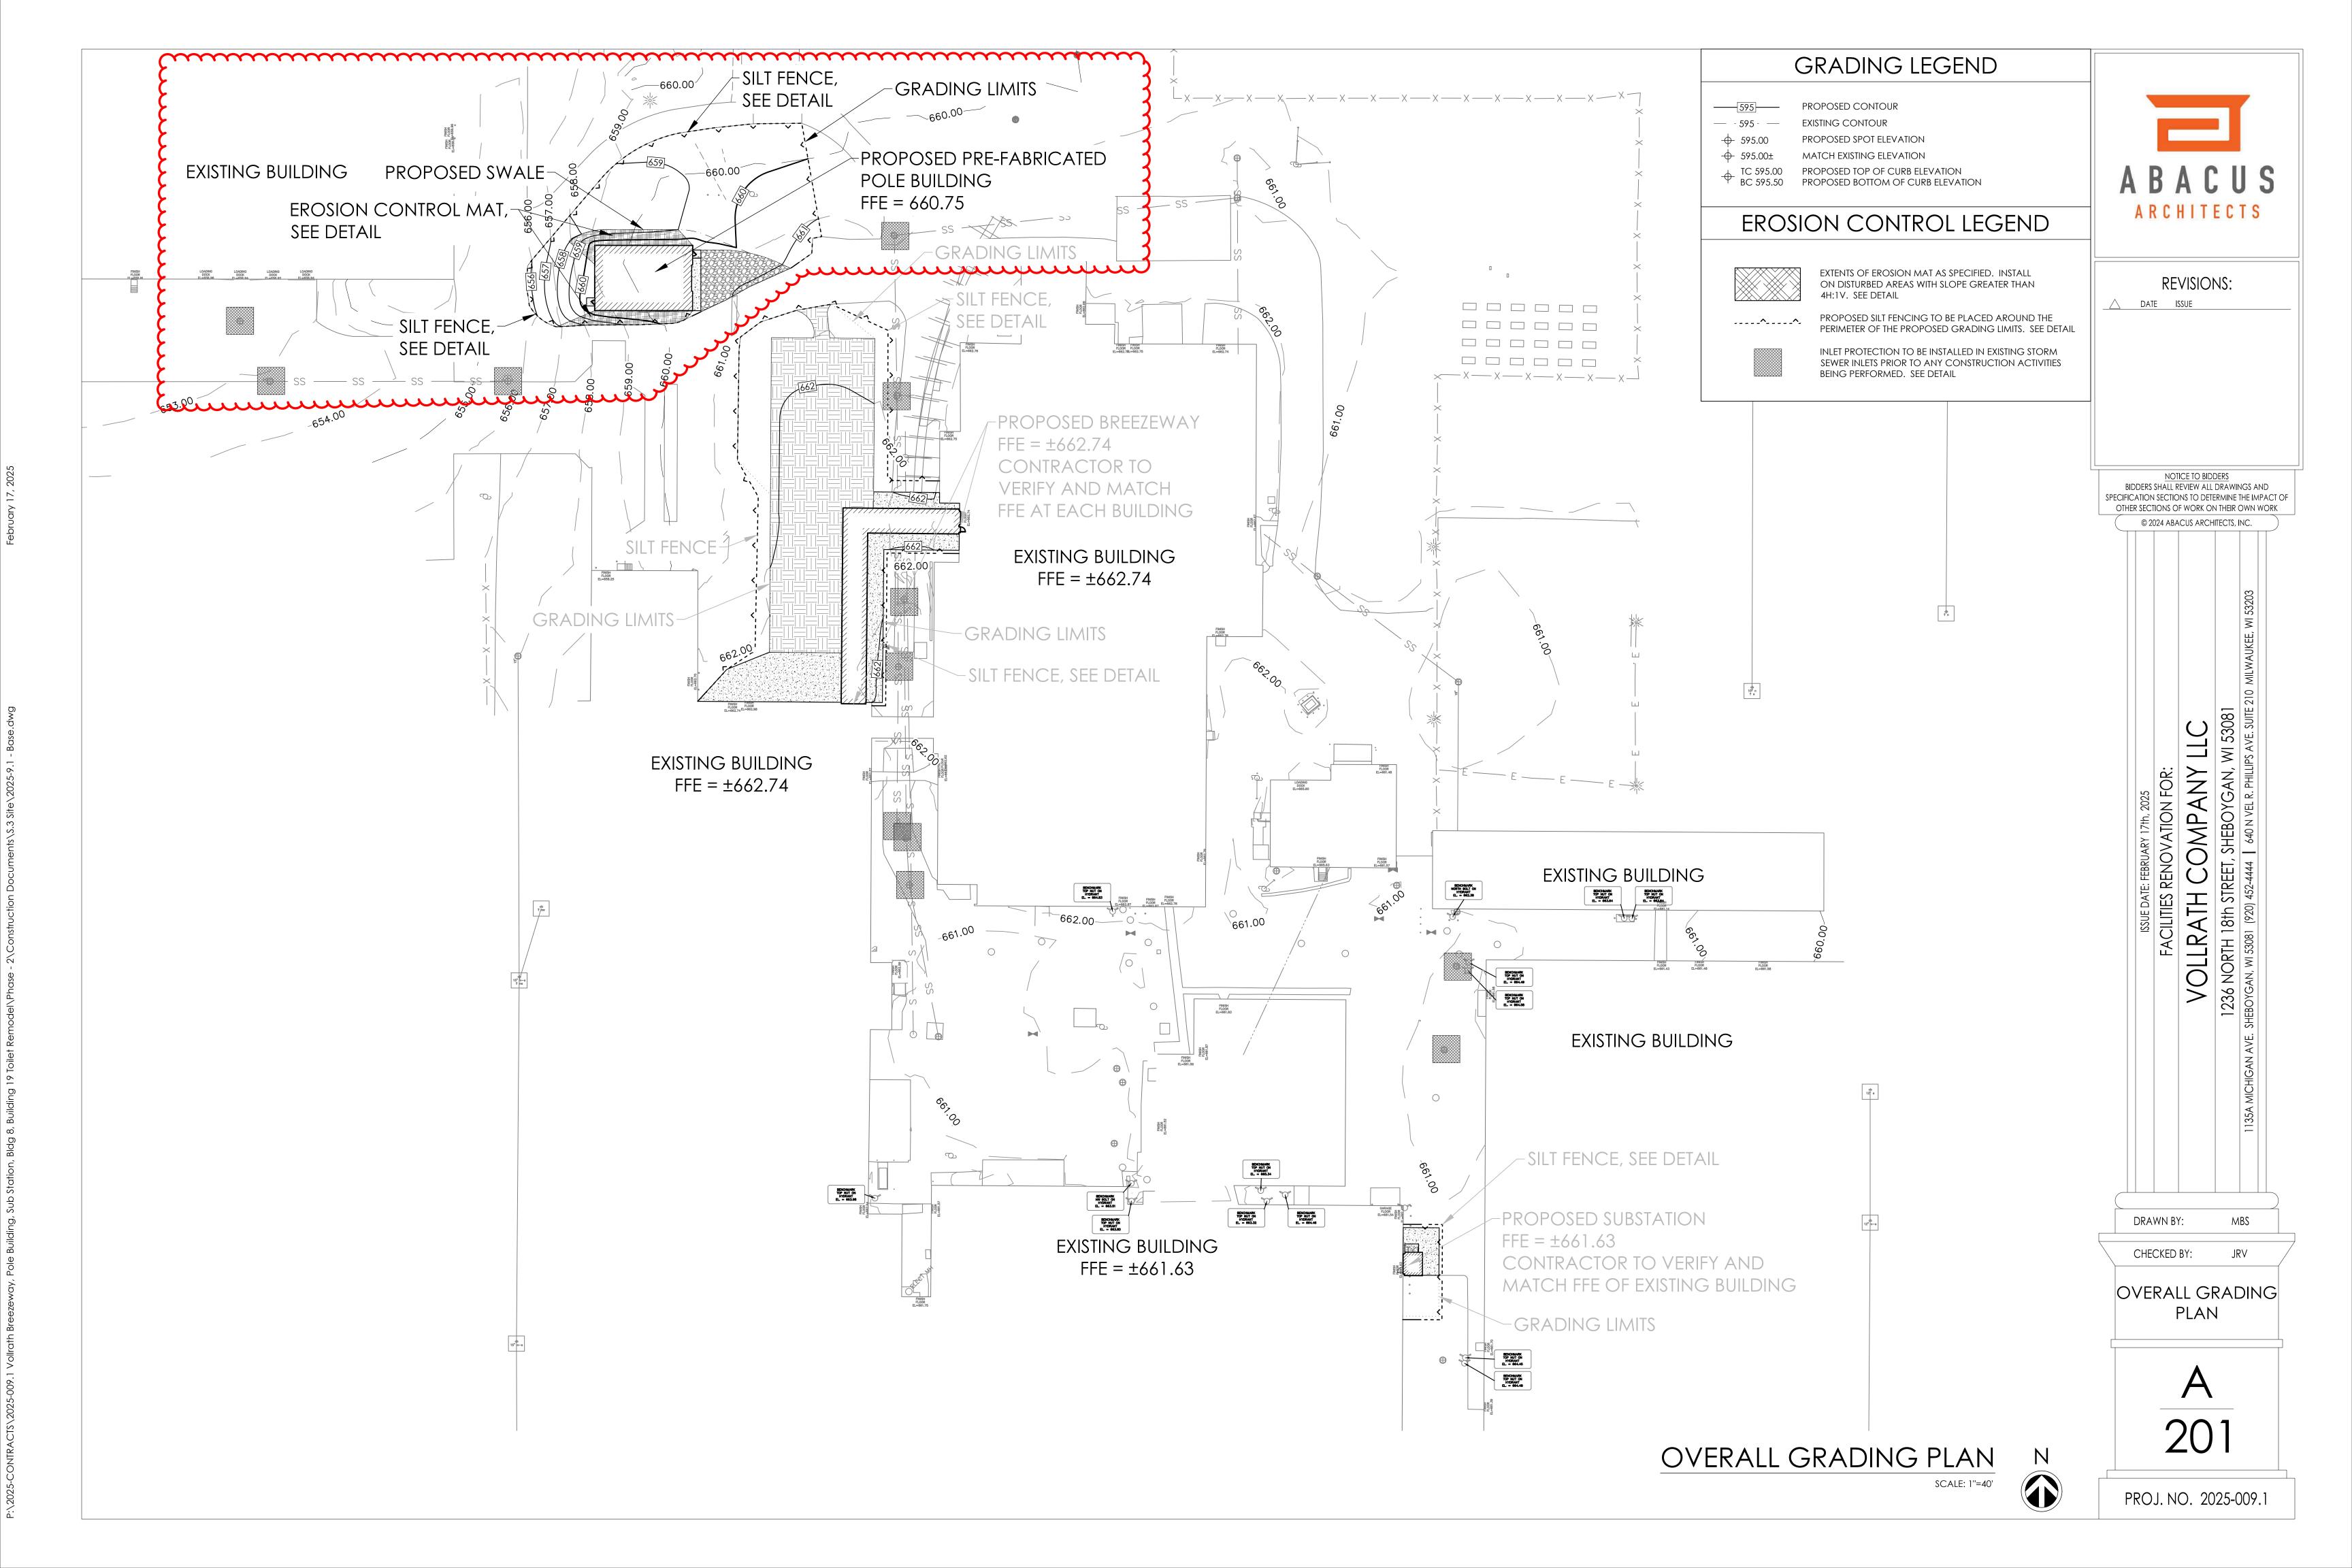

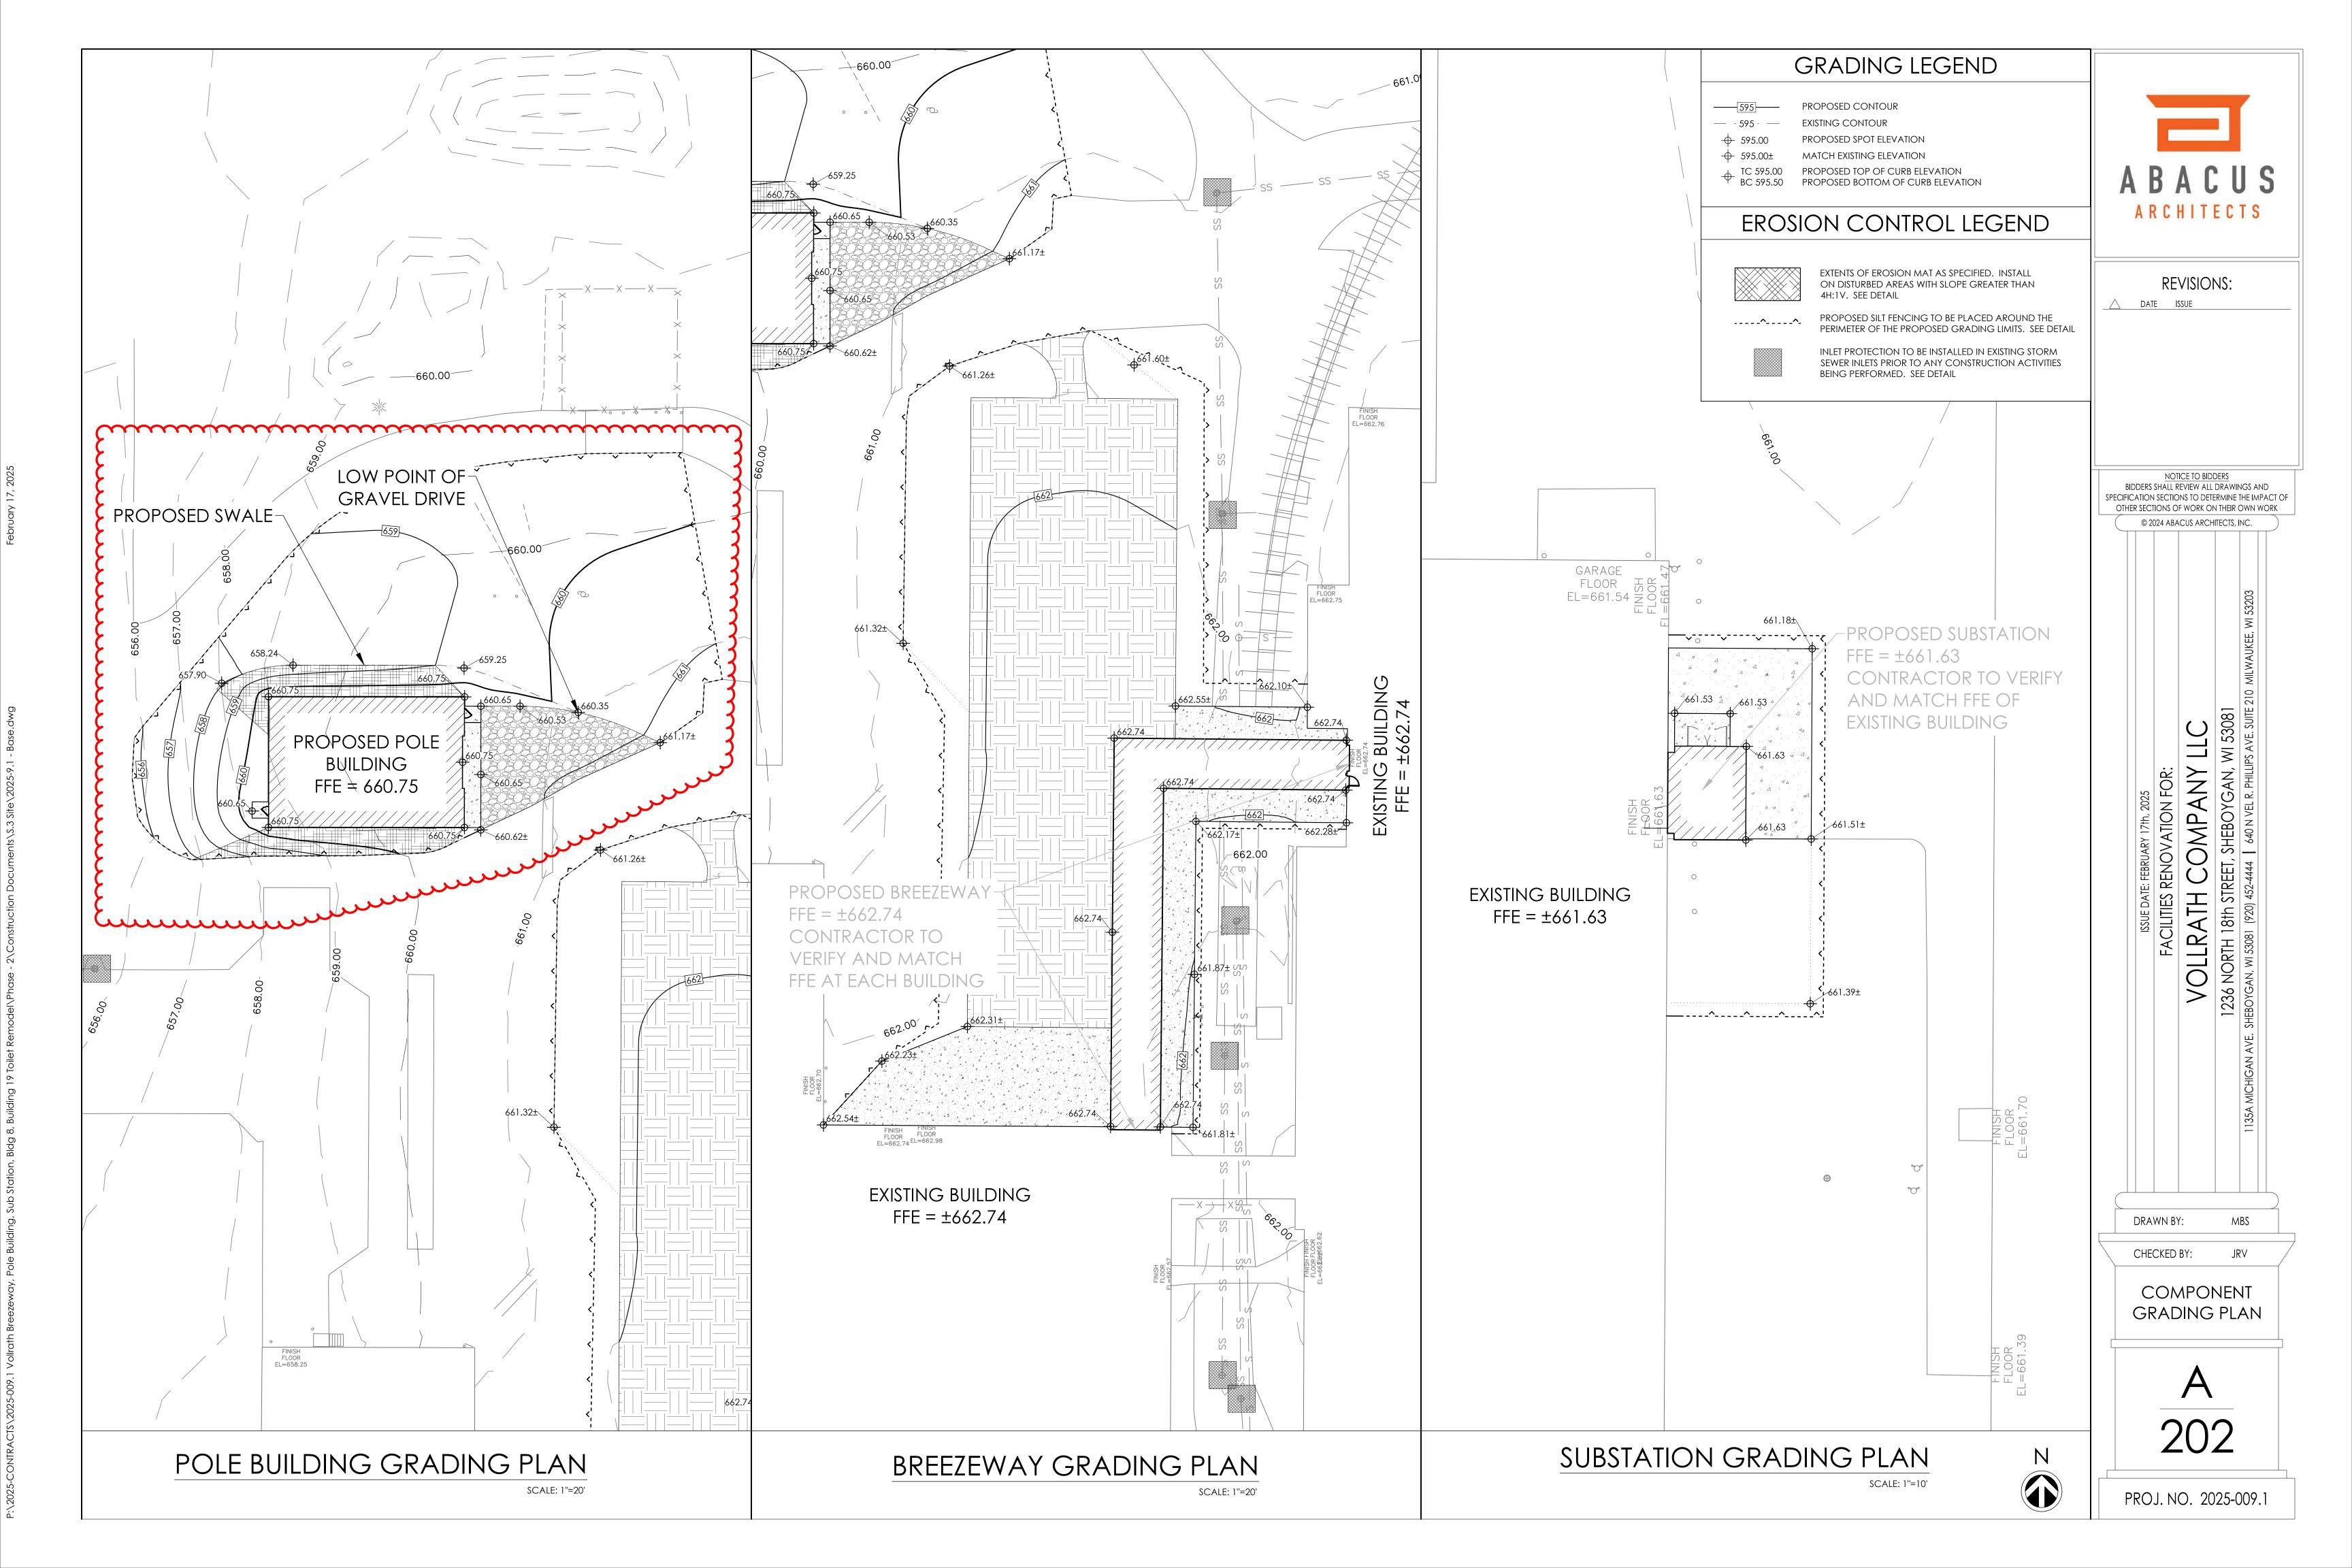


4" CONCRETE WITH FIBER MESH
REINFORCEMENT (LIGHT DUTY)
8" CONCRETE WITH FIBER MESH
REINFORCEMENT (HEAVY DUTY)


6" COMPACTED AGGREGATE
BASE COURSE (LIGHT DUTY)
8" COMPACTED AGGREGATE
BASE COURSE (HEAVY DUTY)

EXISTING SUBGRADE (COMPACTED
PRIOR TO PLACING BASE COURSE)

CONCRETE PAVEMENT CROSS SECTION

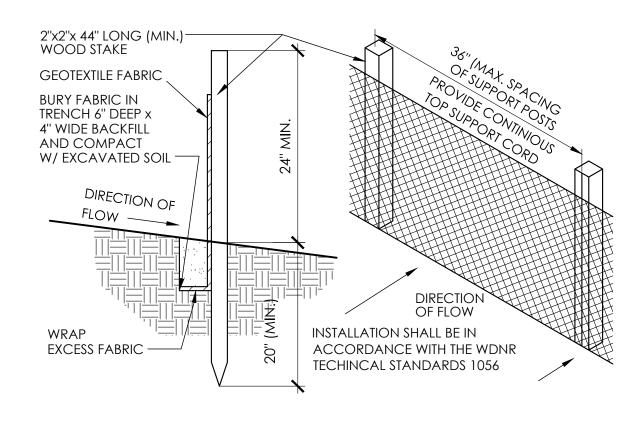


SILT FENCE SECTION & DETAIL

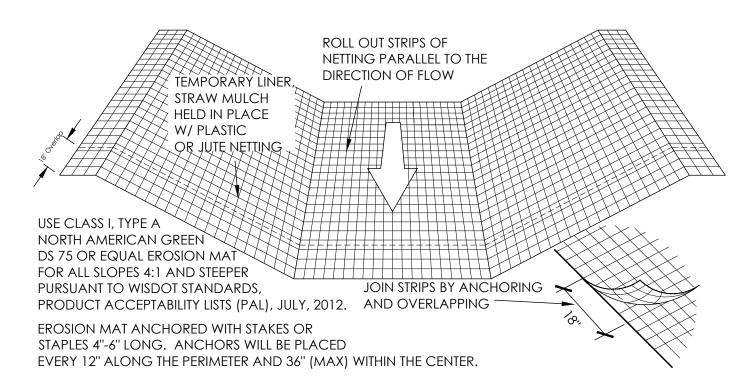

EROSION MATTING DETAIL (FOR SIDE SLOPES ONLY - NOT FOR CHANNELIZED FLOW)


FABRIC SHALL BE REPLACED AT THE ENGINEERS DISCRETION.

WHEN REMOVING OR MAINTAINING INLET PROTECTION, CARE SHALL BE TAKEN SO THAT THE SEDIMENT TRAPPED ON THE GEOTEXTILE FABRIC DOES NOT FALL INTO THE INLET, ANY MATERIAL FALLING INTO THE INLET SHALL BE REMOVED IMMEDIATELY.

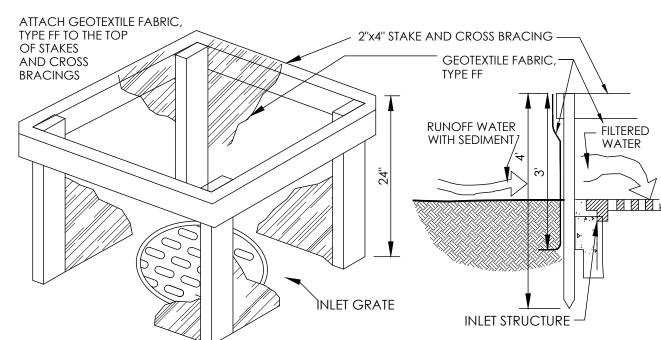

INLET PROTECTION, TYPE 'A'

INSTALLATION PURSUANT TO WDNR TECHNICAL STANDARD 1060

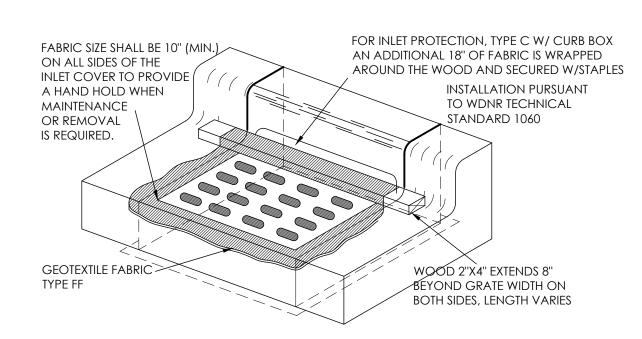

INLET PROTECTION, TYPE 'C'

TRIM EXCESS FABRIC IN THE FLOW LINE TO WITHIN 3" OF THE GRATE.

THE CONTRACTOR SHALL DEMONSTRATE A METHOD OF MAINTENANCE, USING A SEWN FLAP, HAND HOLDS OR OTHER METHOD TO PREVENT ACCUMULATED SEDIMENT FROM ENTERING THE INLET.

TYPE 'C' INLET PROTECTION TO BE IMPLEMENTED UPON CONSTRUCTION OF CURB AND GUTTER. PRIOR TO CURB AND GUTTER CONSTRUCTION, TYPE 'A' INLET PROTECTION SHALL BE PROVIDED.



REVISIONS:

NOTICE TO BIDDERS

BIDDERS SHALL REVIEW ALL DRAWINGS AND
SPECIFICATION SECTIONS TO DETERMINE THE IMPACT OF
OTHER SECTIONS OF WORK ON THEIR OWN WORK

© 2024 ABACUS ARCHITECTS, INC.

ISSUE DATE: FEBRUARY 1/fh, 2025	-ACILITIES RENOVATION FOR:	-RATH COMPANY LLC	TH 18th STREET, SHEBOYGAN, WI 53081	53081 (000) 450 444 440 N VEI DE PHILIPS AVE SIITE OLD MILWALIKEE
ISSOE	-ACILITI	-RAT	TH 18th	53081 (00C

DRAWN BY: MBS


CIVIL DETAILS

CHECKED BY:

A 203

PROJ. NO. 2025-009.1

CIVIL DETAILS

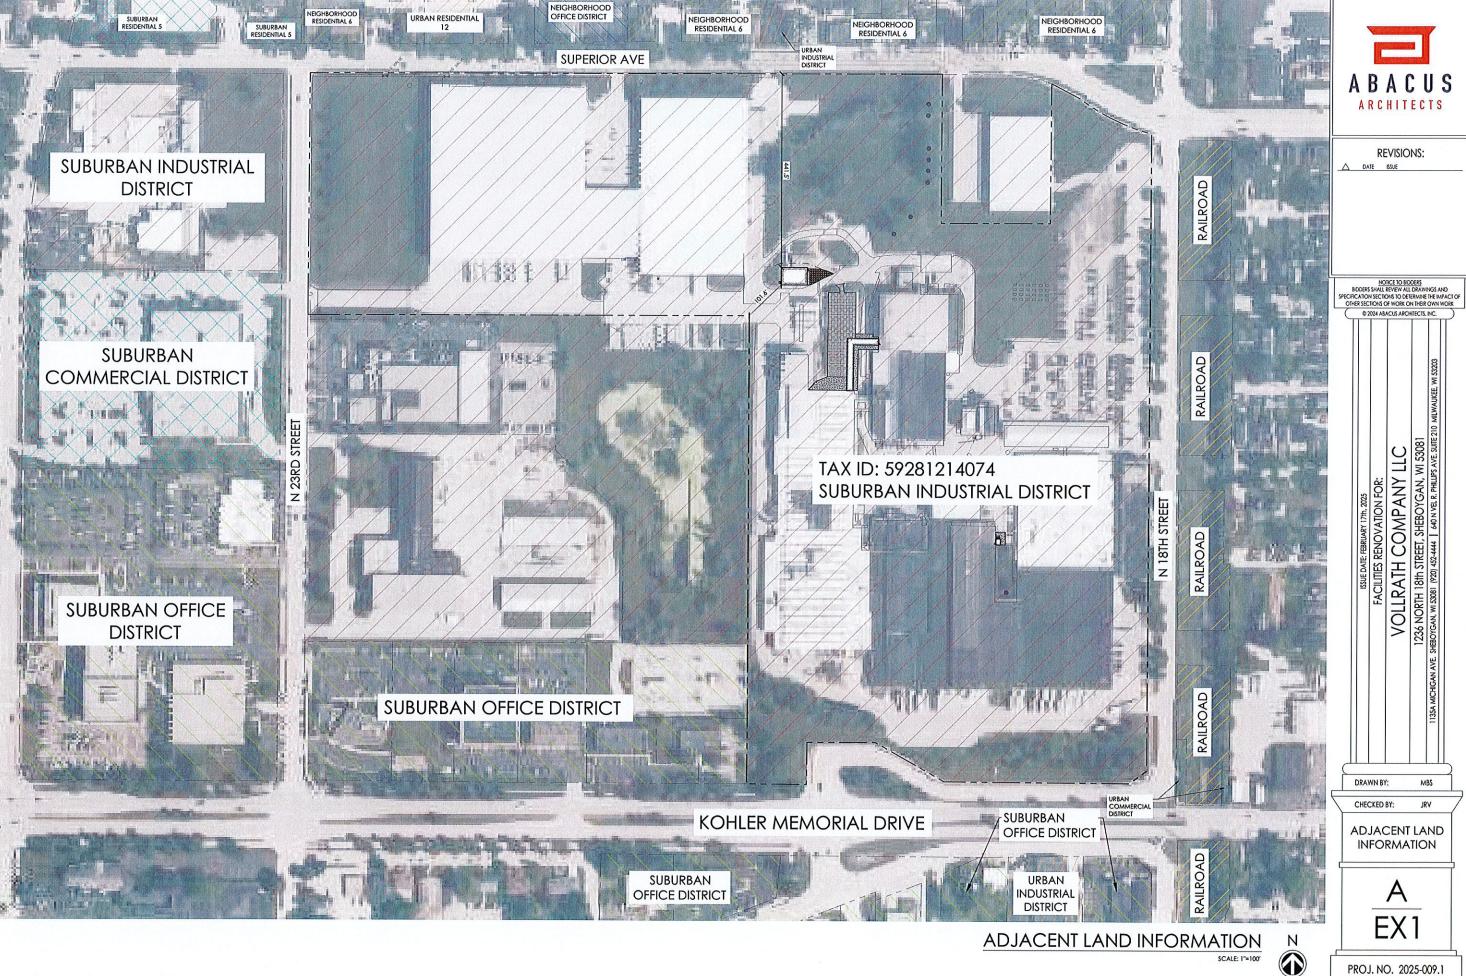

PROJ. NO. 2025-009.1