

ISSUED Plan Commission Set - January 17, 2025

Red Earth

Development

N. 15th St. & Luedke Ct.

Sheboygan, Wisconsin

CONDITIONS

SHEET TITLE

PLAN

**EXISTING** 

SHEET NUMBER



Dial or (800)242-8511

- FOUND REBAR/PIN
- FOUND STEEL PIPE
- SET 5/8" REBAR
- □ CATCH BASIN
- STORM MANHOLE
- SANITARY MANHOLE

- POWER POLE
- - SANITARY SEWER


- STORM SEWER
- WATERMAIN
- G-B UNDERGROUND GAS
- FO-B UNDERGROUND FIBER OPTICS

C100


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PROJECT NO.

2427



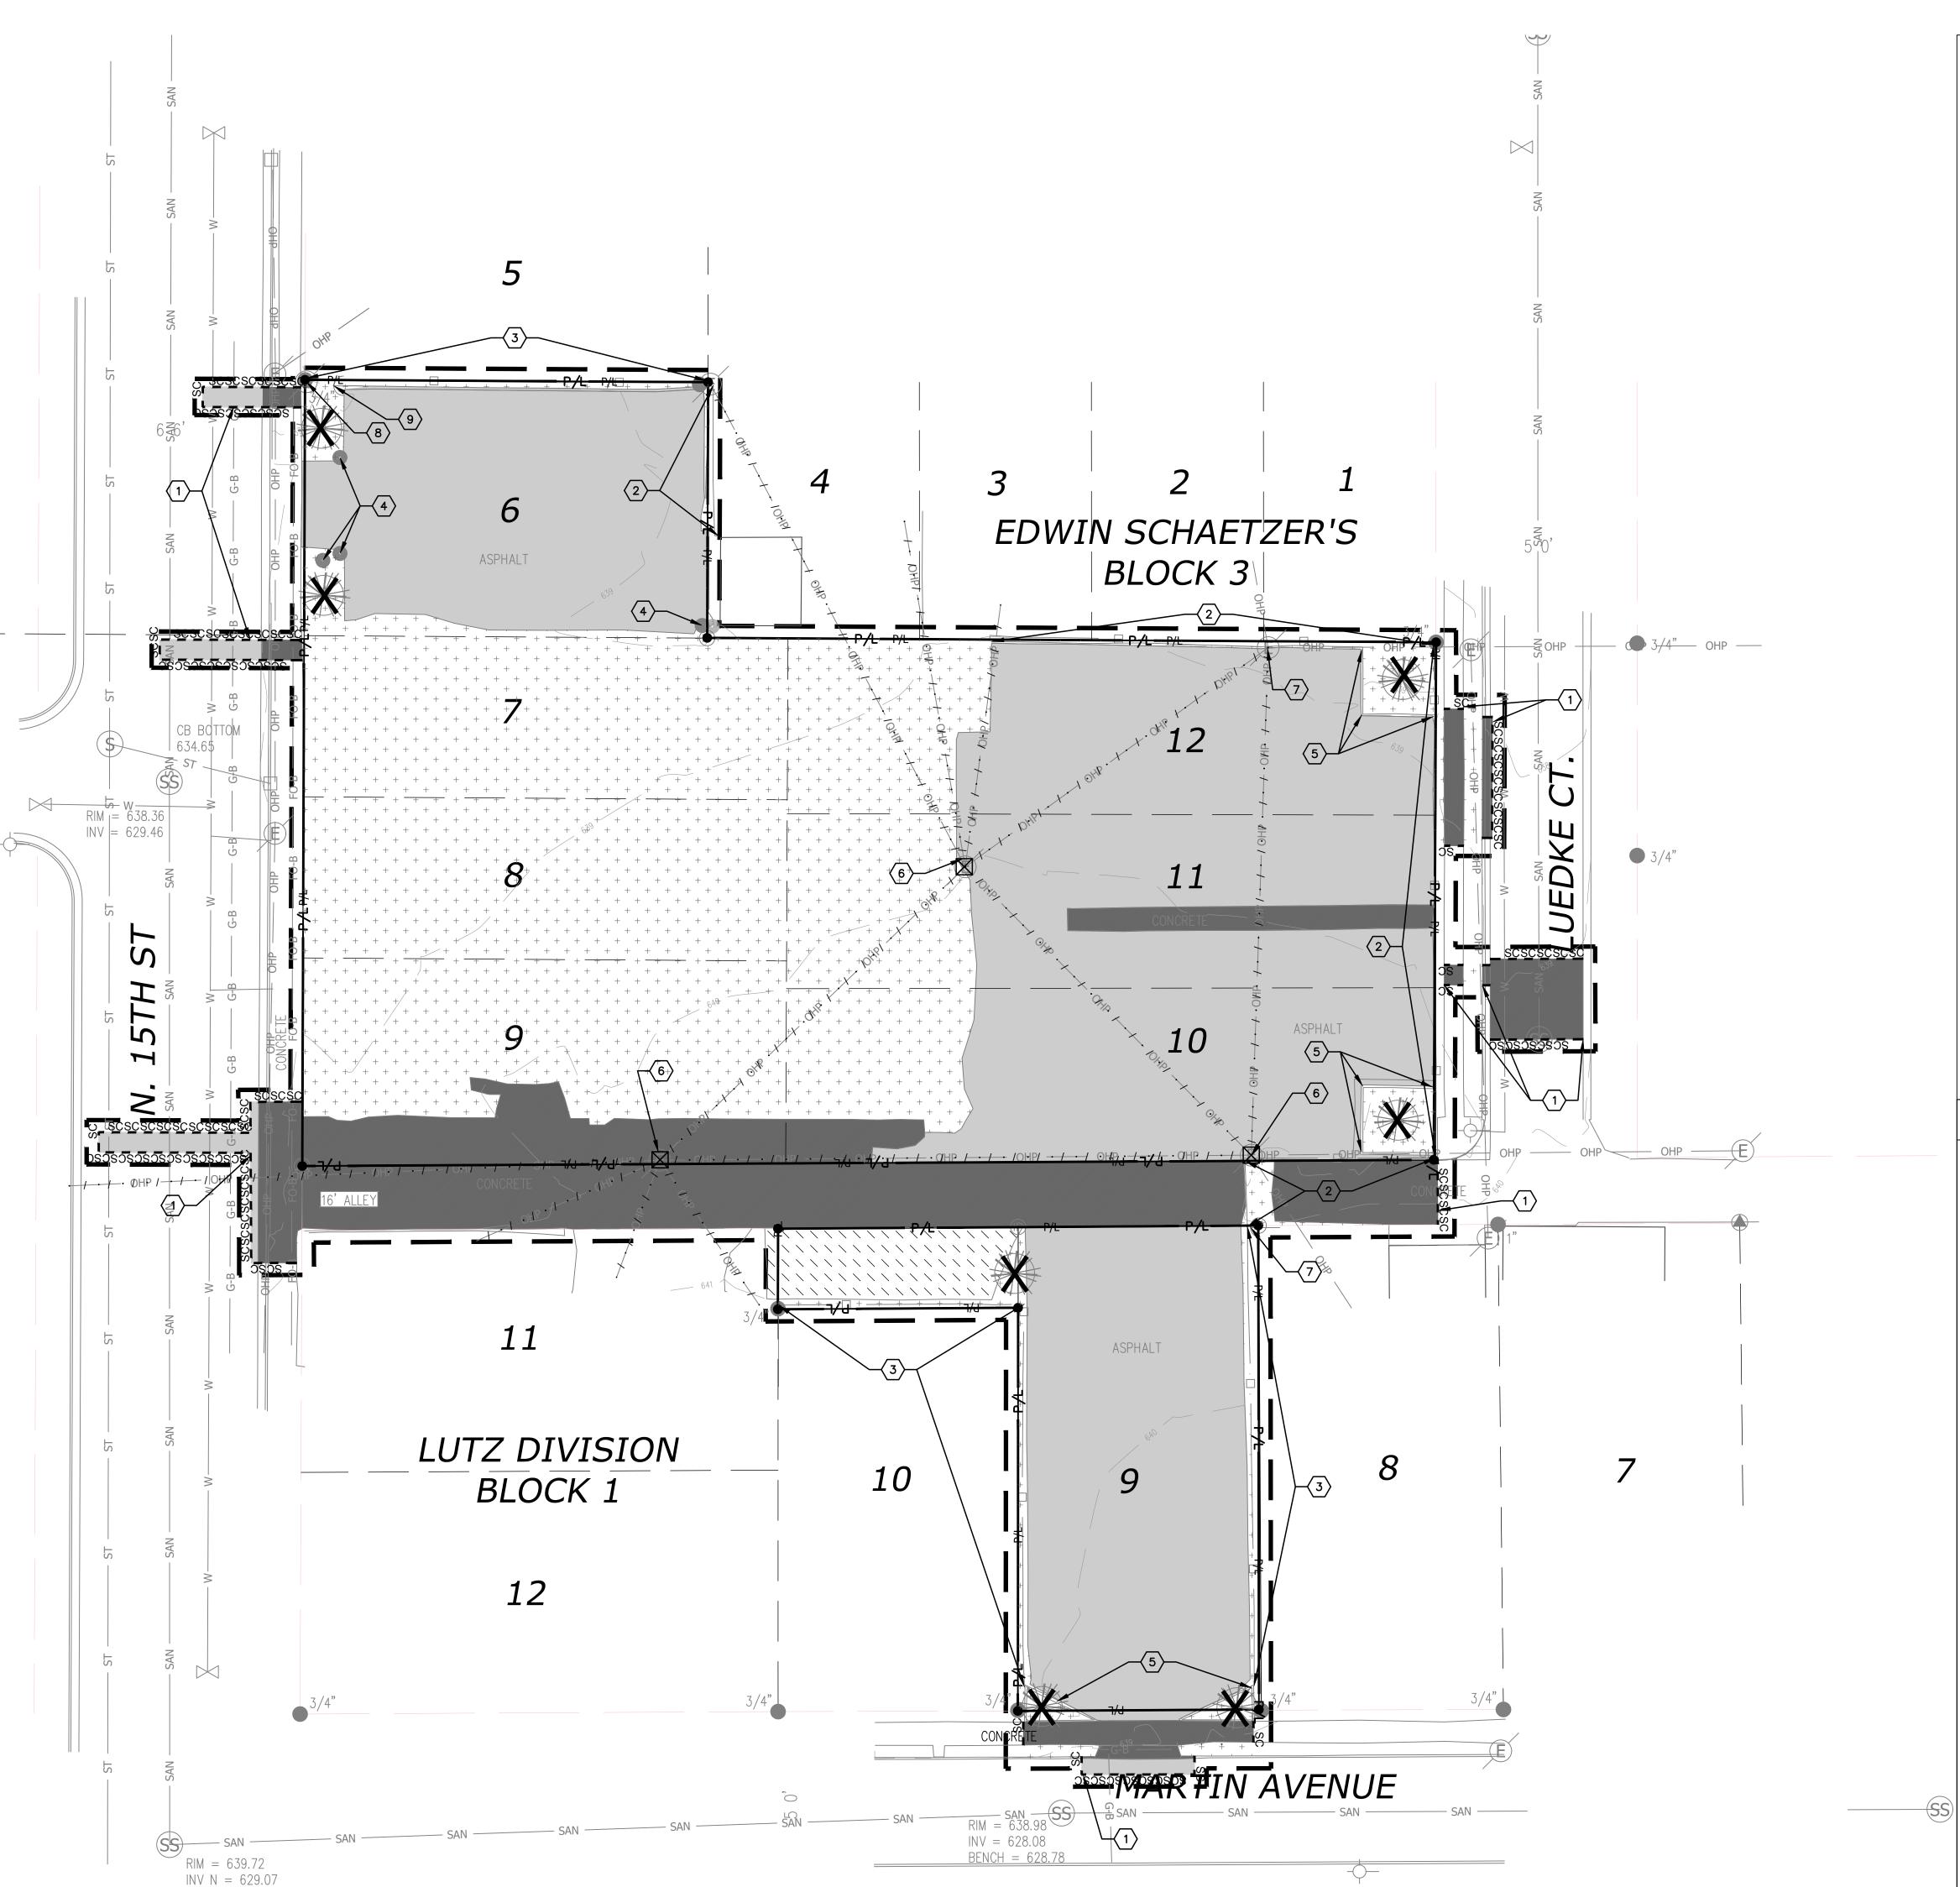

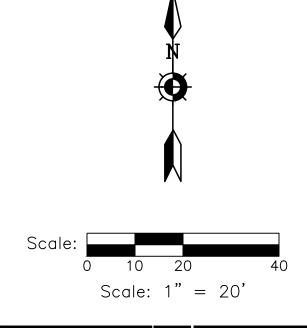

Dial or (800)242-8511 www.DiggersHotline.com

## **KEY INDEX**

PROJECT LIMITS P/L PROPERTY LINE VEGETATION TO BE REMOVED & DISPOSED OF OFFSITE. IF SUITABLE FOR REUSE, TOPSOIL TO BE STOCKPILED. UNUSED & UNSUITABLE TOPSOIL TO BE REMOVED OFFSITE. TOPSOIL THICKNESS MAY VARY. REFER TO GEOTECHNICAL REPORT.

ASPHALT PAVEMENT & BASE MATERIAL TO BE REMOVED TO SUB-BASE & DISPOSED OF OFFSITE. PAVEMENT & BASE THICKNESS MAY VARY. REFER TO GEOTECHNICAL REPORT.

CONCRETE & BASE MATERIAL TO BE REMOVED TO SUB-BASE & DISPOSED OF OFFSITE. CONCRETE & BASE THICKNESS MAY VARY. REFER TO GEOTECHNICAL REPORT. GRAVEL MATERIAL TO BE REMOVED & DISPOSED OF OFFSITE. IF SUITABLE FOR REUSE, GRAVEL TO BE STOCKPILED. UNUSED GRAVEL MATERIAL TO BE REMOVED OFFSITE. GRAVEL THICKNESS MAY VARY. REFER TO GEOTECHNICAL REPORT.

\_SCSCSCSC SAWCUT FULL DEPTH

TREES & STUMPS TO BE REMOVED

DENOTES UTILITIES TO BE ABANDONED & REMOVED.

-UTILITY STRUCTURE REMOVAL/ABANDONMENT

SAWCUT APPROXIMATELY 2' OF ASPHALT PAVEMENT OFF THE EDGE OF THE ROADWAY TO PROVIDE A SMOOTH EDGE FOR INSTALLATION OF NEW PAVEMENT.

REMOVE & DISPOSE OF EXISTING WOOD FENCE INCLUDING POSTS & FOOTINGS

EXISTING FENCE TO REMAIN. CONTRACTOR TO PROTECT THROUGHOUT CONSTRUCTION.

REMOVE & DISPOSE OF EXISTING POST.

REMOVE & DISPOSE OF WOODEN PLANTER BEDS

REMOVE & RELOCATE EXISTING UTILITY POLE AND OVERHEAD WIRES. CONTRACTOR TO COORDINATE REMOVAL AND RELOCATION WITH EXISTING UTILITY OWNER.

REMOVE & RELOCATE EXISTING GUY WIRE.
CONTRACTOR TO COORDINATE REMOVAL AND
RELOCATION WITH EXISTING UTILITY OWNER.

EXISTING UTILITY POLE TO REMAIN. CONTRACTOR TO PROTECT THROUGHOUT CONSTRUCTION. EXISTING GUY WIRE TO REMAIN. CONTRACTOR TO PROTECT THROUGHOUT CONSTRUCTION.

PROJECT TITLE Jakum Site Redevelopment

ISSUED

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Red Earth Development


N. 15th St. & Luedke Ct. Sheboygan, Wisconsin


SHEET TITLE SITE **DEMOLITION** PLAN


SHEET NUMBER

C101

PROJECT NO.

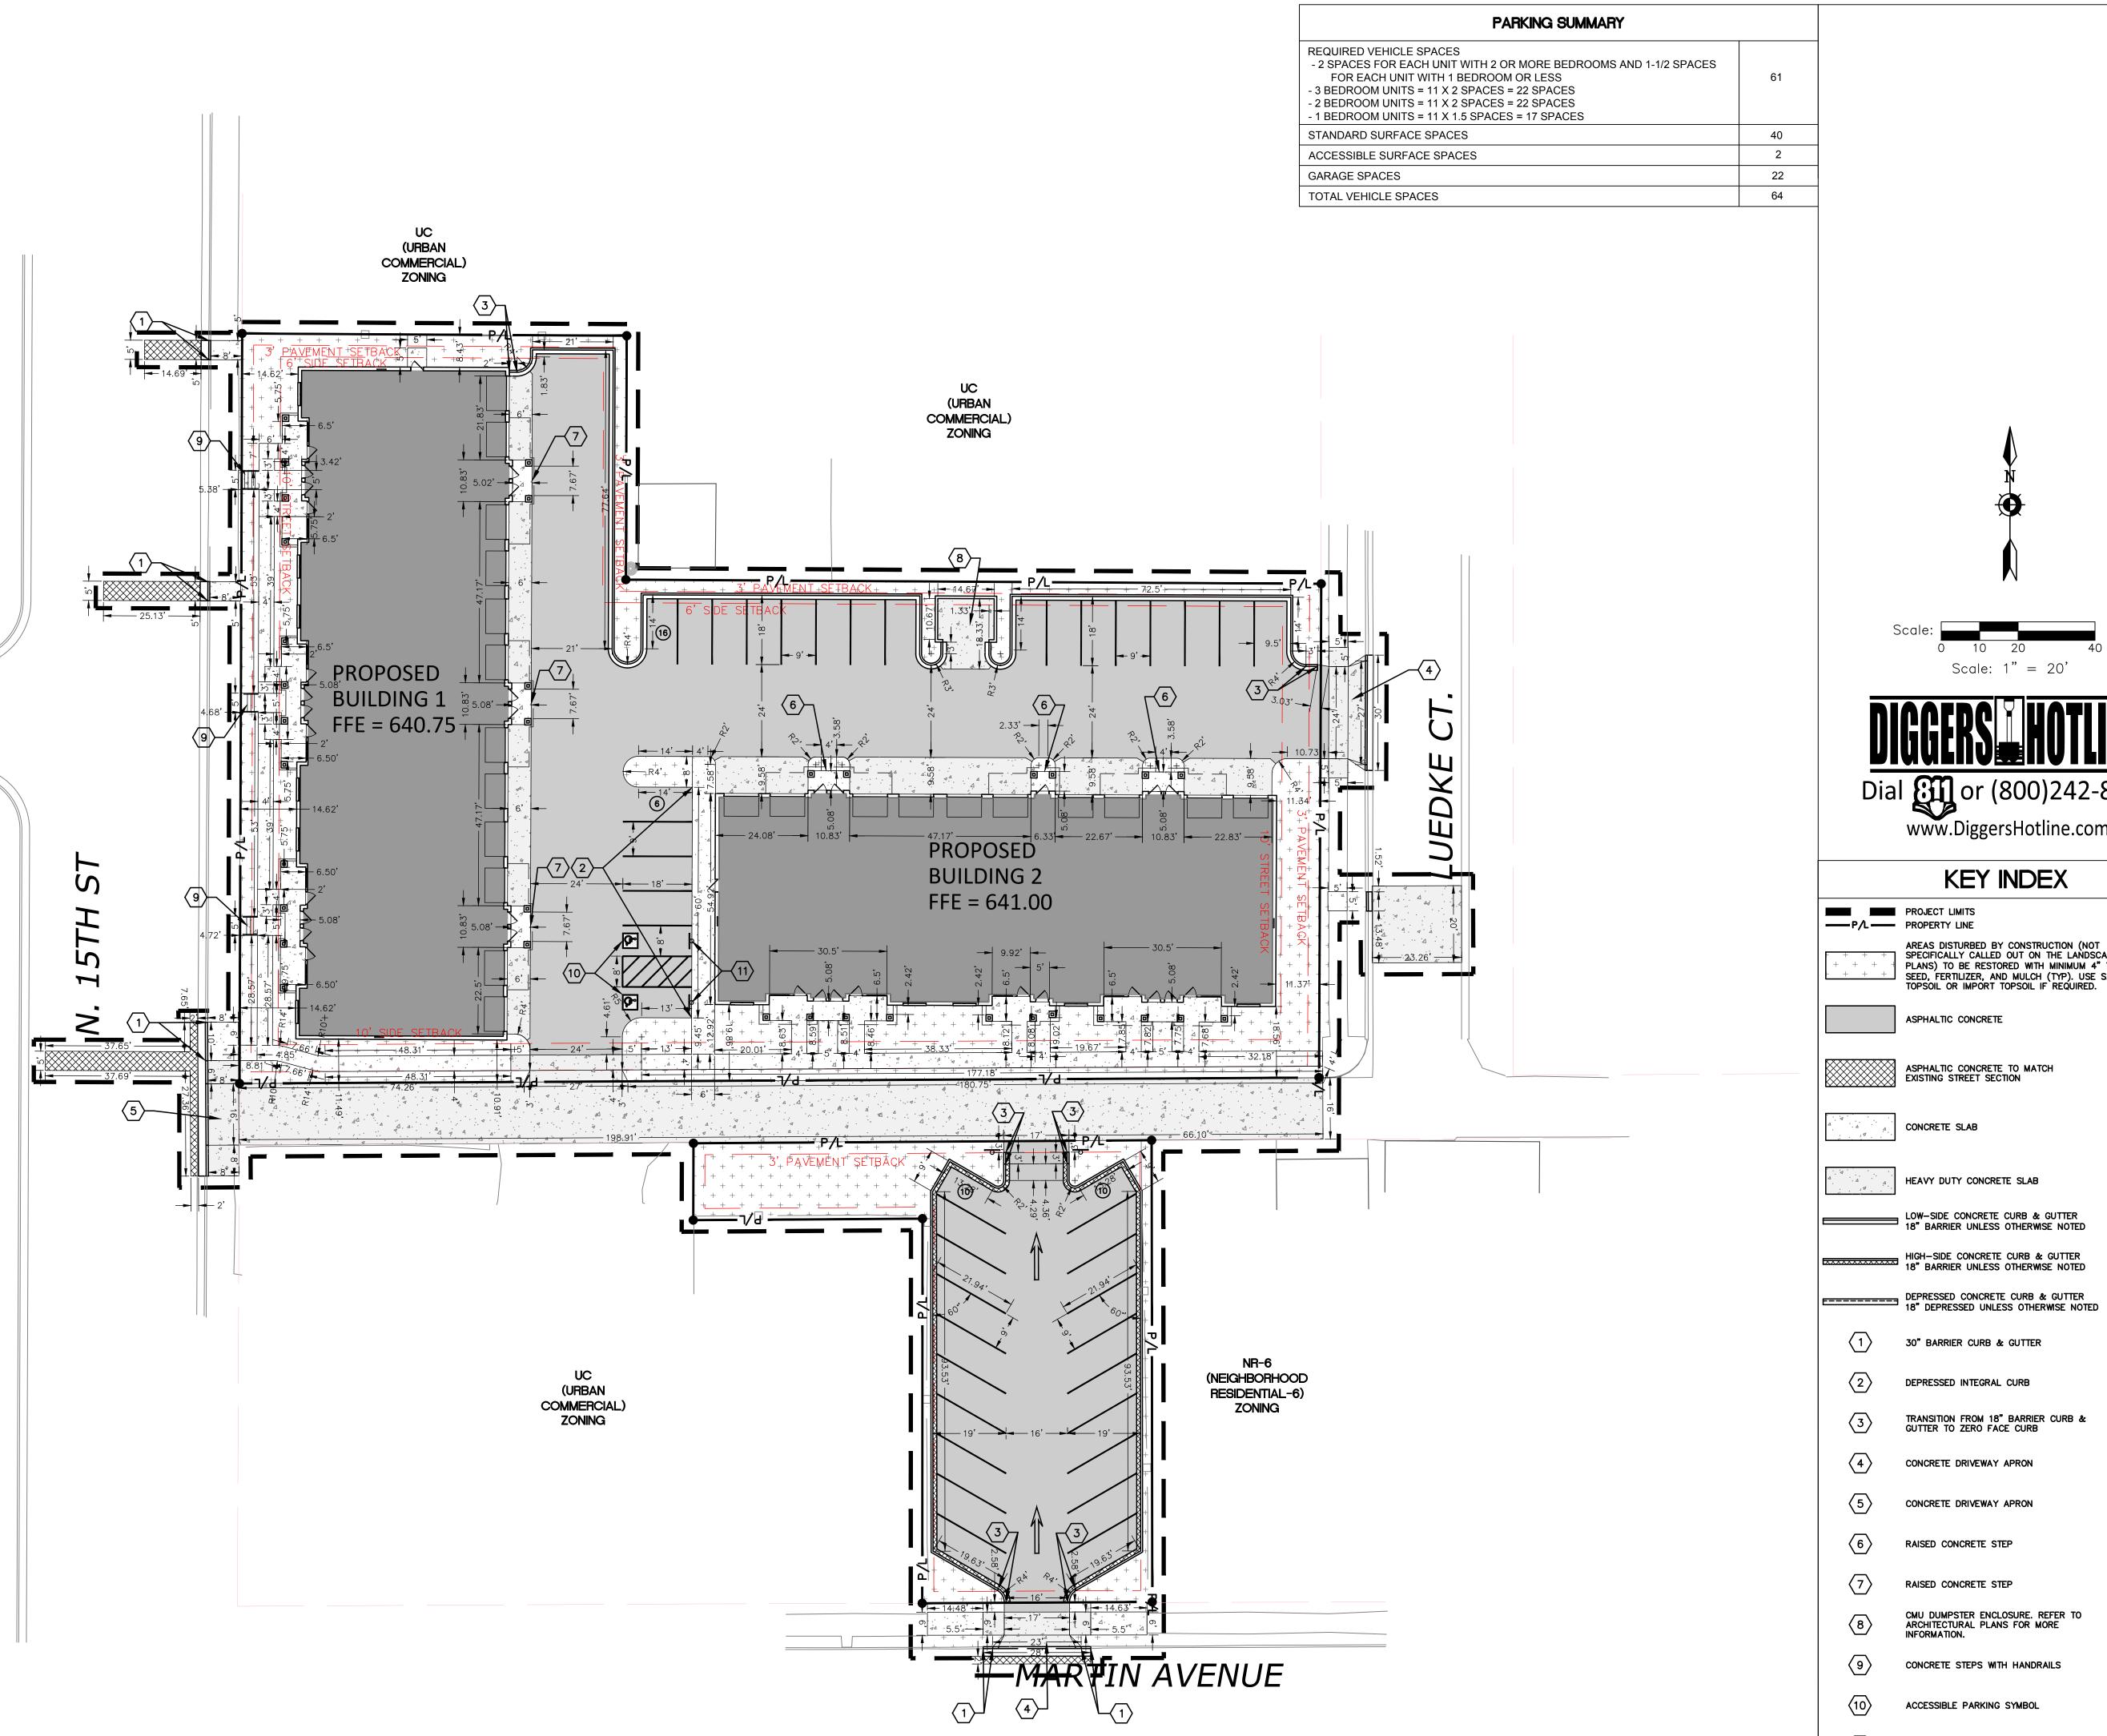

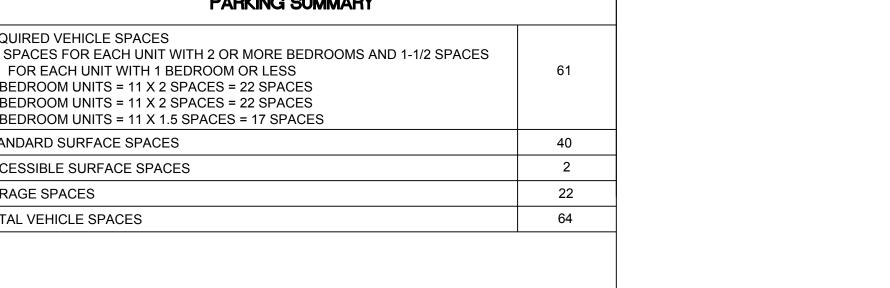

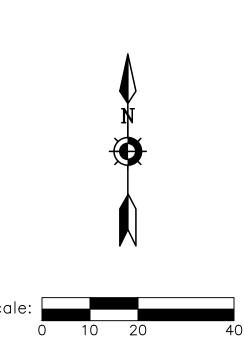

Scale: 1" = 20'

# Dial or (800)242-8511

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## KEY INDEX

PROJECT LIMITS
PROPERTY LINE

AREAS DISTURBED BY CONSTRUCTION (NOT SPECIFICALLY CALLED OUT ON THE LANDSCAPE PLANS) TO BE RESTORED WITH MINIMUM 4" TOPSOIL, SEED, FERTILIZER, AND MULCH (TYP). USE SALVAGED TOPSOIL OR IMPORT TOPSOIL IF REQUIRED.

ASPHALTIC CONCRETE

ASPHALTIC CONCRETE TO MATCH EXISTING STREET SECTION

CONCRETE SLAB

HEAVY DUTY CONCRETE SLAB LOW-SIDE CONCRETE CURB & GUTTER
18" BARRIER UNLESS OTHERWISE NOTED

HIGH-SIDE CONCRETE CURB & GUTTER
18" BARRIER UNLESS OTHERWISE NOTED

30" BARRIER CURB & GUTTER

DEPRESSED INTEGRAL CURB

TRANSITION FROM 18" BARRIER CURB & GUTTER TO ZERO FACE CURB

CONCRETE DRIVEWAY APRON

CONCRETE DRIVEWAY APRON

RAISED CONCRETE STEP

RAISED CONCRETE STEP

CMU DUMPSTER ENCLOSURE. REFER TO ARCHITECTURAL PLANS FOR MORE INFORMATION.

CONCRETE STEPS WITH HANDRAILS

ACCESSIBLE SIGN

Phone: 8401 Greenway Blvd., Suite

788 N. Jefferson Street, Ste 900 Milwaukee, Wisconsin 53202 kapurinc.com

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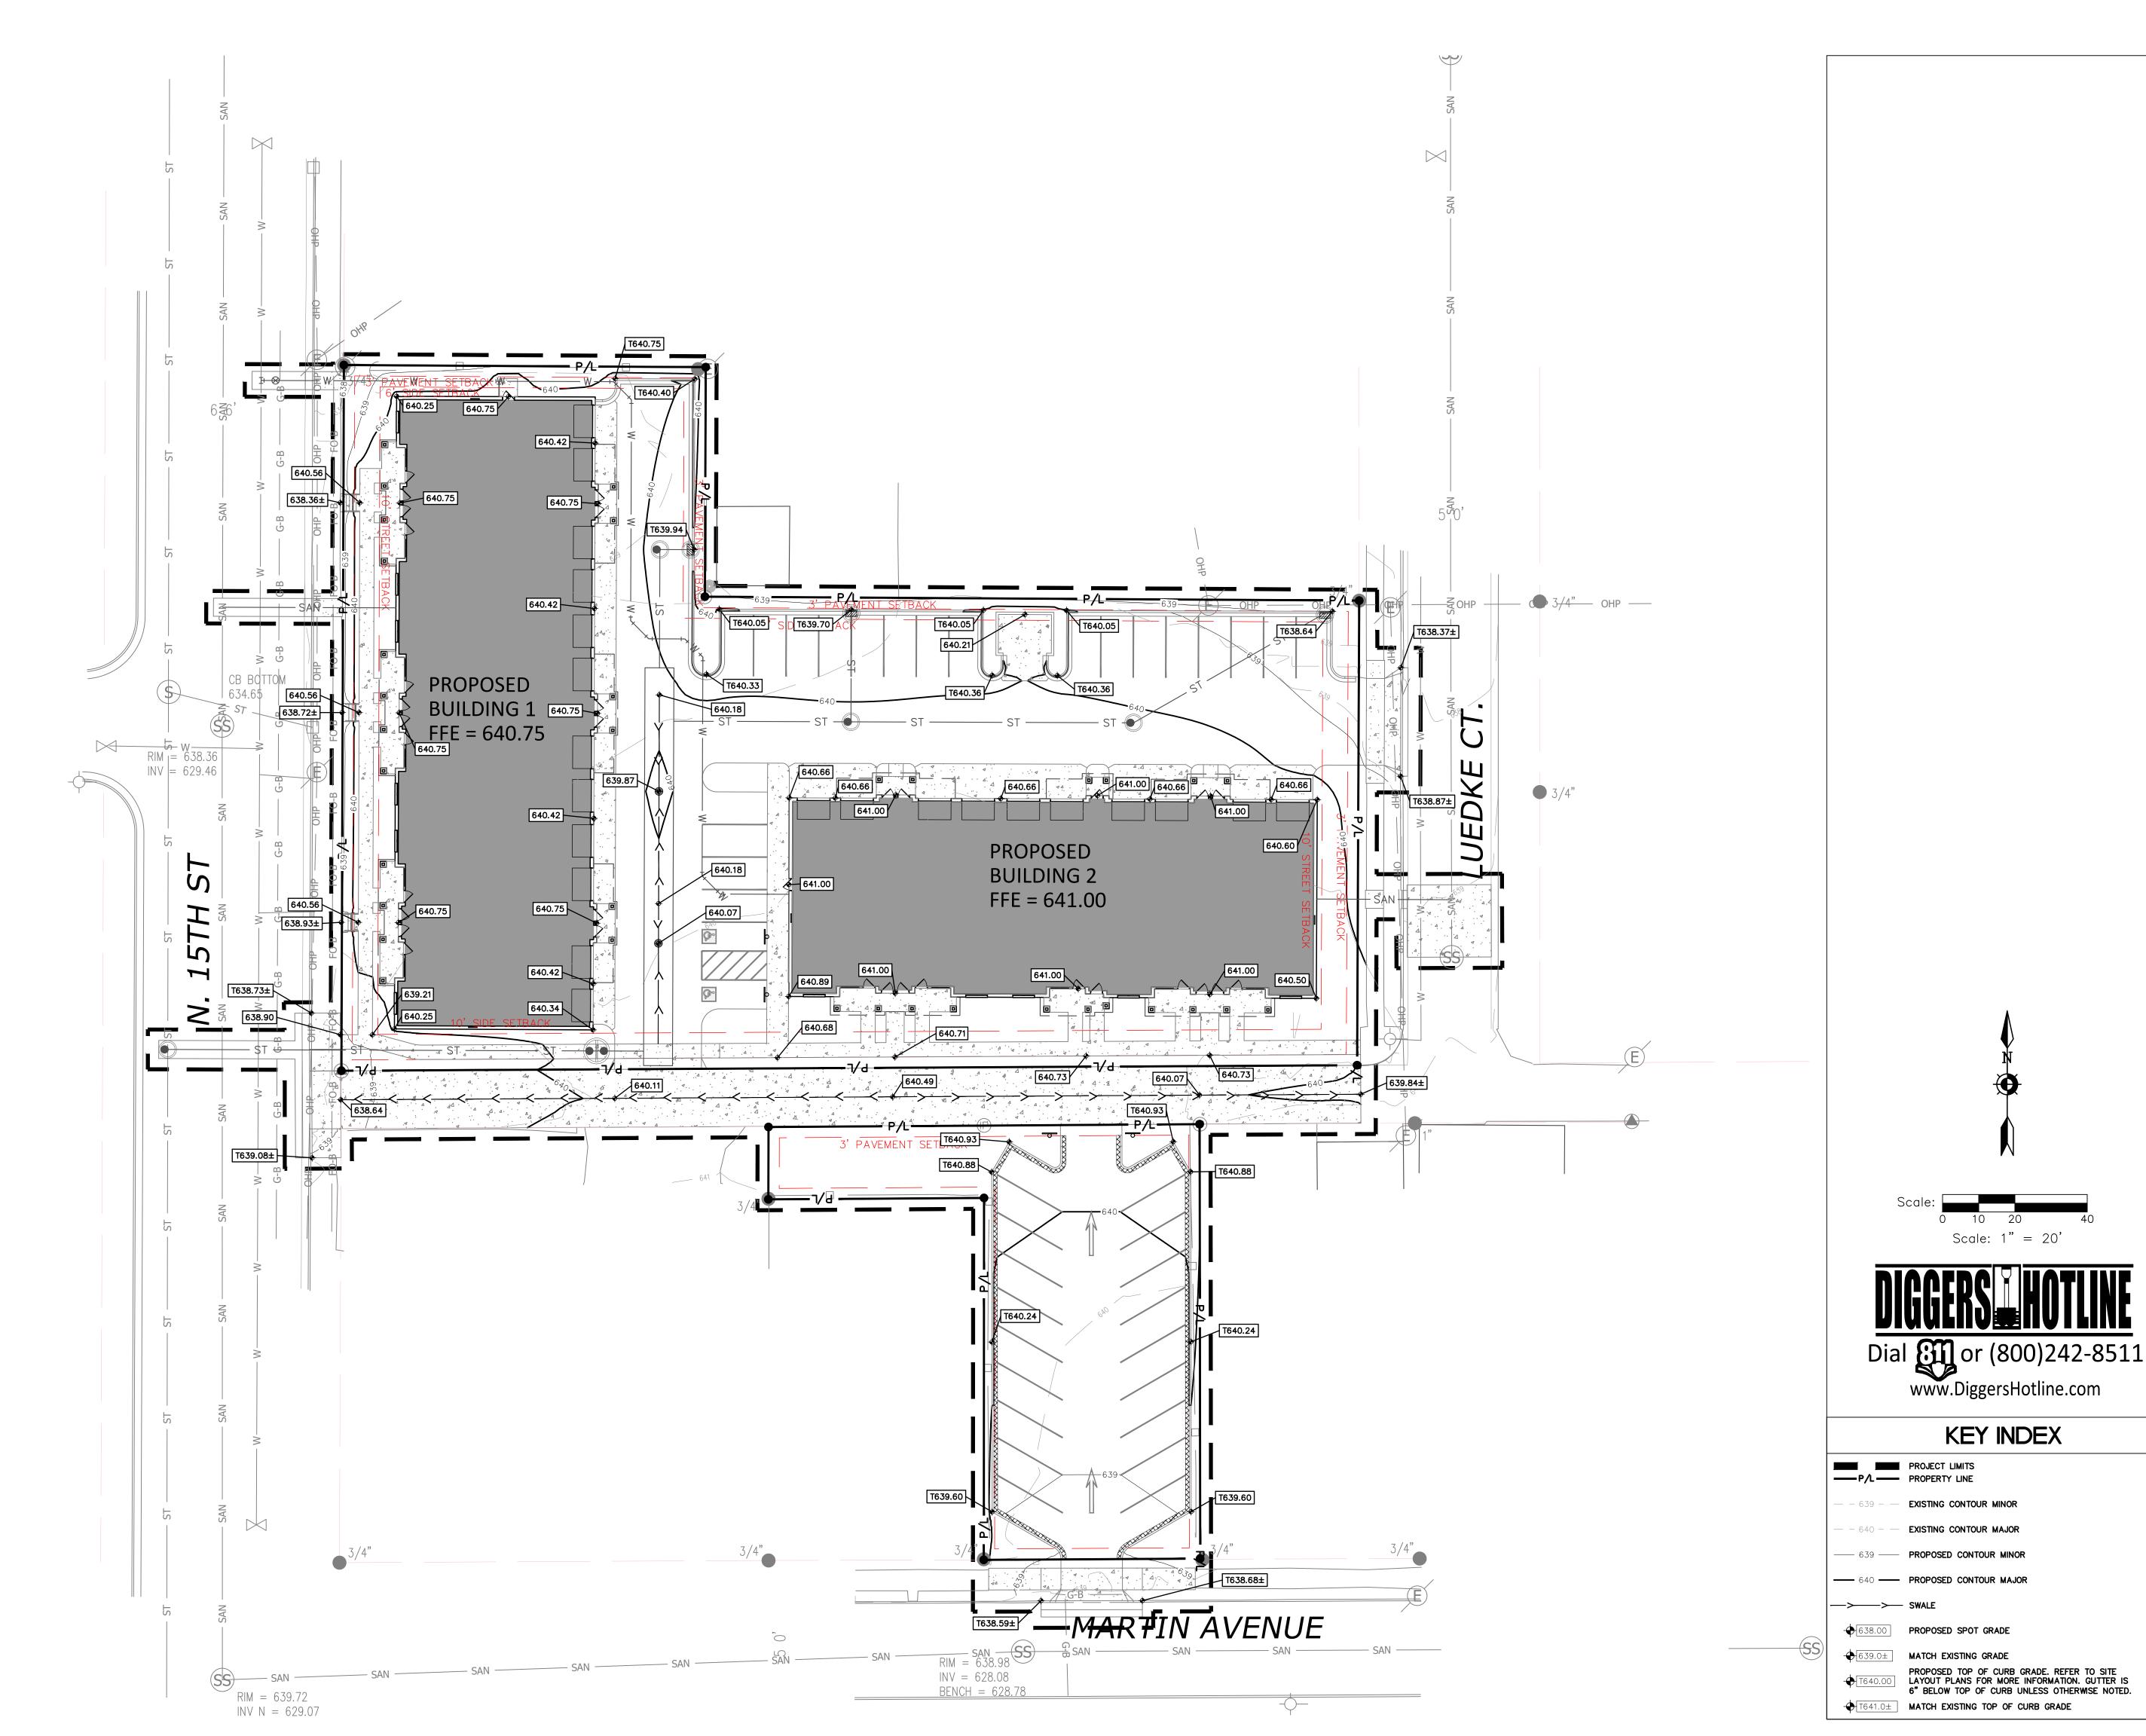
N. 15th St. & Luedke Ct. Sheboygan, Wisconsin

SHEET TITLE SITE LAYOUT PLAN

SHEET NUMBER

C102

PROJECT NO.





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PROJECT TITLE Jakum Site Redevelopment

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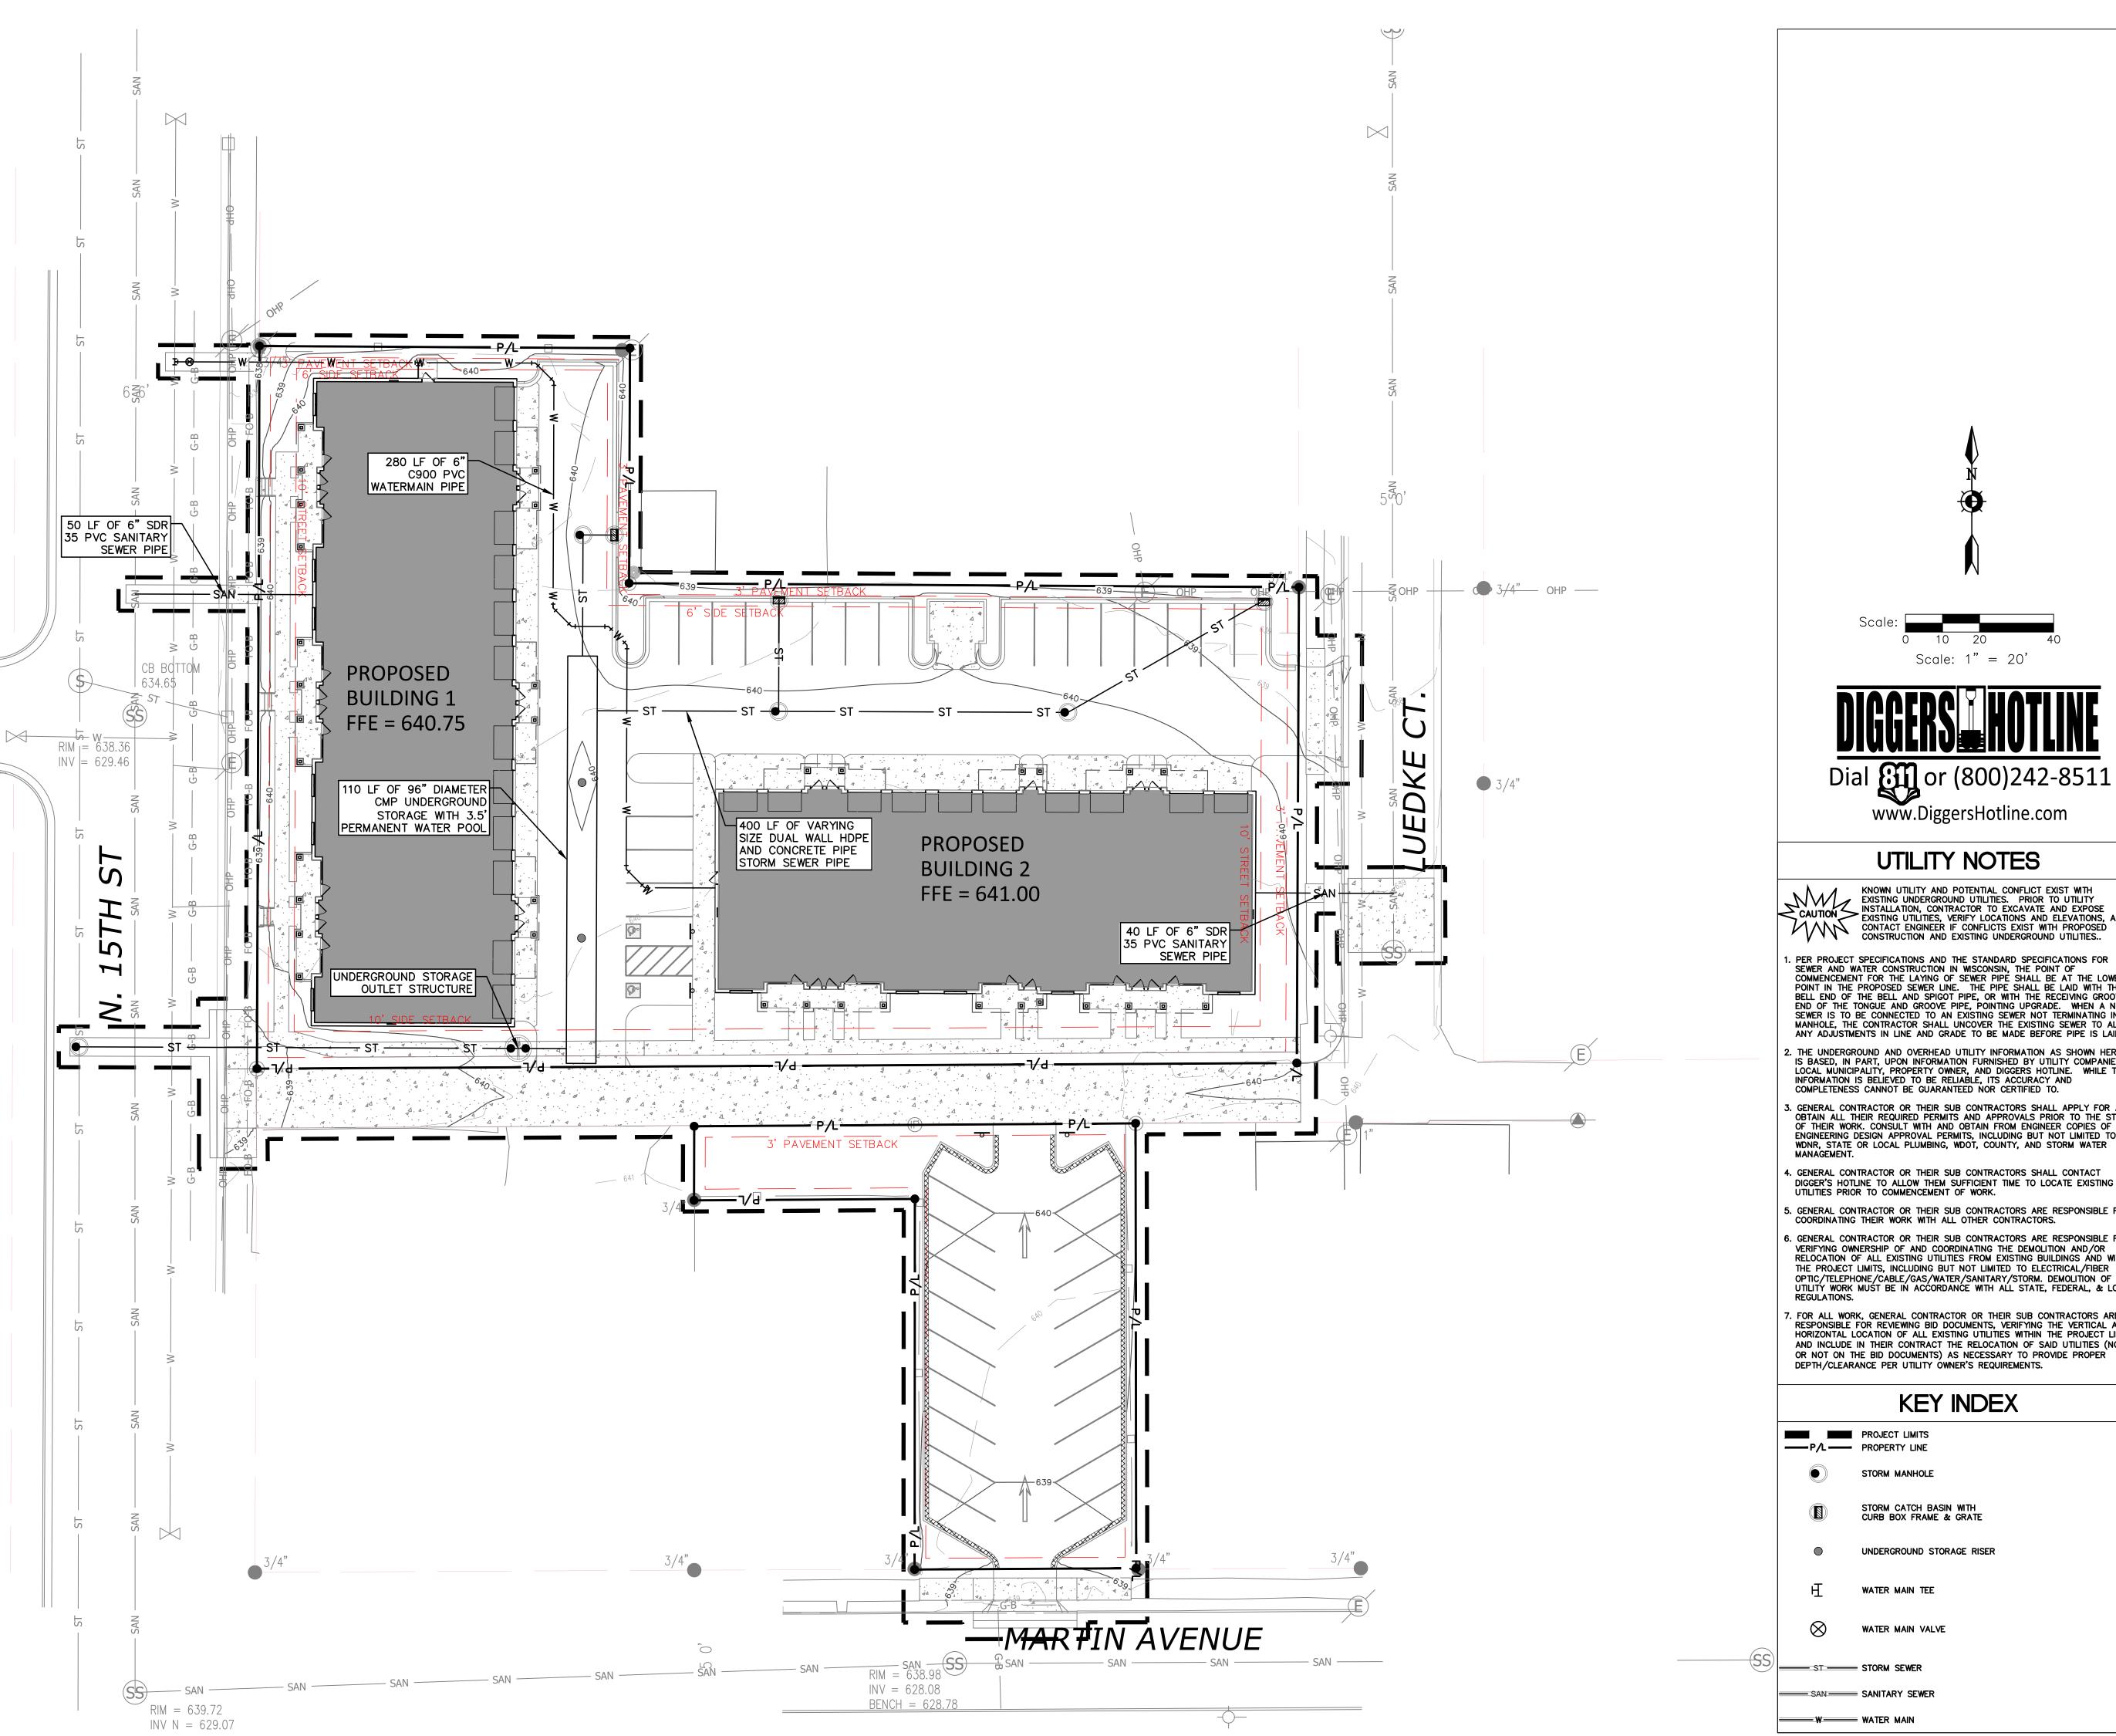
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SHEET TITLE SITE GRADING PLAN

SHEET NUMBER

C104

PROJECT NO.





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UTILITY NOTES

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Scale: 1" = 20'

KNOWN UTILITY AND POTENTIAL CONFLICT EXIST WITH EXISTING UNDERGROUND UTILITIES. PRIOR TO UTILITY INSTALLATION, CONTRACTOR TO EXCAVATE AND EXPOSE EXISTING UTILITIES, VERIFY LOCATIONS AND ELEVATIONS, AND CONTACT ENGINEER IF CONFLICTS EXIST WITH PROPOSED CONSTRUCTION AND EXISTING UNDERGROUND UTILITIES...

1. PER PROJECT SPECIFICATIONS AND THE STANDARD SPECIFICATIONS FOR SEWER AND WATER CONSTRUCTION IN WISCONSIN, THE POINT OF COMMENCEMENT FOR THE LAYING OF SEWER PIPE SHALL BE AT THE LOWEST POINT IN THE PROPOSED SEWER LINE. THE PIPE SHALL BE LAID WITH THE BELL END OF THE BELL AND SPIGOT PIPE, OR WITH THE RECEIVING GROOVE FIRE TO SHALL AND SPIGOT PIPE, OR WITH THE RECEIVING GROOVE FIRE TO SHALL AND SPIGOT PIPE, OR WITH THE RECEIVING GROOVE FIRE TO SHALL AND SPIGOT PIPE. END OF THE TONGUE AND GROOVE PIPE, POINTING UPGRADE. WHEN A NEW SEWER IS TO BE CONNECTED TO AN EXISTING SEWER NOT TERMINATING IN A MANHOLE, THE CONTRACTOR SHALL UNCOVER THE EXISTING SEWER TO ALLOW ANY ADJUSTMENTS IN LINE AND GRADE TO BE MADE BEFORE PIPE IS LAID.

- 2. THE UNDERGROUND AND OVERHEAD UTILITY INFORMATION AS SHOWN HEREON IS BASED, IN PART, UPON INFORMATION FURNISHED BY UTILITY COMPANIES, LOCAL MUNICIPALITY, PROPERTY OWNER, AND DIGGERS HOTLINE. WHILE THIS INFORMATION IS BELIEVED TO BE RELIABLE, ITS ACCURACY AND COMPLETENESS CANNOT BE GUARANTEED NOR CERTIFIED TO.
- 3. GENERAL CONTRACTOR OR THEIR SUB CONTRACTORS SHALL APPLY FOR AND OBTAIN ALL THEIR REQUIRED PERMITS AND APPROVALS PRIOR TO THE START OF THEIR WORK. CONSULT WITH AND OBTAIN FROM ENGINEER COPIES OF ENGINEERING DESIGN APPROVAL PERMITS, INCLUDING BUT NOT LIMITED TO WDNR, STATE OR LOCAL PLUMBING, WDOT, COUNTY, AND STORM WATER
- 4. GENERAL CONTRACTOR OR THEIR SUB CONTRACTORS SHALL CONTACT DIGGER'S HOTLINE TO ALLOW THEM SUFFICIENT TIME TO LOCATE EXISTING UTILITIES PRIOR TO COMMENCEMENT OF WORK.
- 5. GENERAL CONTRACTOR OR THEIR SUB CONTRACTORS ARE RESPONSIBLE FOR COORDINATING THEIR WORK WITH ALL OTHER CONTRACTORS.
- 6. GENERAL CONTRACTOR OR THEIR SUB CONTRACTORS ARE RESPONSIBLE FOR VERIFYING OWNERSHIP OF AND COORDINATING THE DEMOLITION AND/OR RELOCATION OF ALL EXISTING UTILITIES FROM EXISTING BUILDINGS AND WITHIN THE PROJECT LIMITS, INCLUDING BUT NOT LIMITED TO ELECTRICAL/FIBER OPTIC/TELEPHONE/CABLE/GAS/WATER/SANITARY/STORM. DEMOLITION OF THIS UTILITY WORK MUST BE IN ACCORDANCE WITH ALL STATE, FEDERAL, & LOCAL
- 7. FOR ALL WORK, GENERAL CONTRACTOR OR THEIR SUB CONTRACTORS ARE RESPONSIBLE FOR REVIEWING BID DOCUMENTS, VERIFYING THE VERTICAL AND HORIZONTAL LOCATION OF ALL EXISTING UTILITIES WITHIN THE PROJECT LIMITS, AND INCLUDE IN THEIR CONTRACT THE RELOCATION OF SAID UTILITIES (NOTED OR NOT ON THE BID DOCUMENTS) AS NECESSARY TO PROVIDE PROPER DEPTH/CLEARANCE PER UTILITY OWNER'S REQUIREMENTS.

## **KEY INDEX**

PROJECT LIMITS P/L PROPERTY LINE STORM MANHOLE STORM CATCH BASIN WITH CURB BOX FRAME & GRATE UNDERGROUND STORAGE RISER WATER MAIN TEE WATER MAIN VALVE 

SHEET NUMBER

N. 15th St. & Luedke Ct. Sheboygan, Wisconsin

SHEET TITLE

PROJECT TITLE


Jakum Site

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Red Earth

Development

N. 15th St. & Luedke Ct.

Sheboygan, Wisconsin

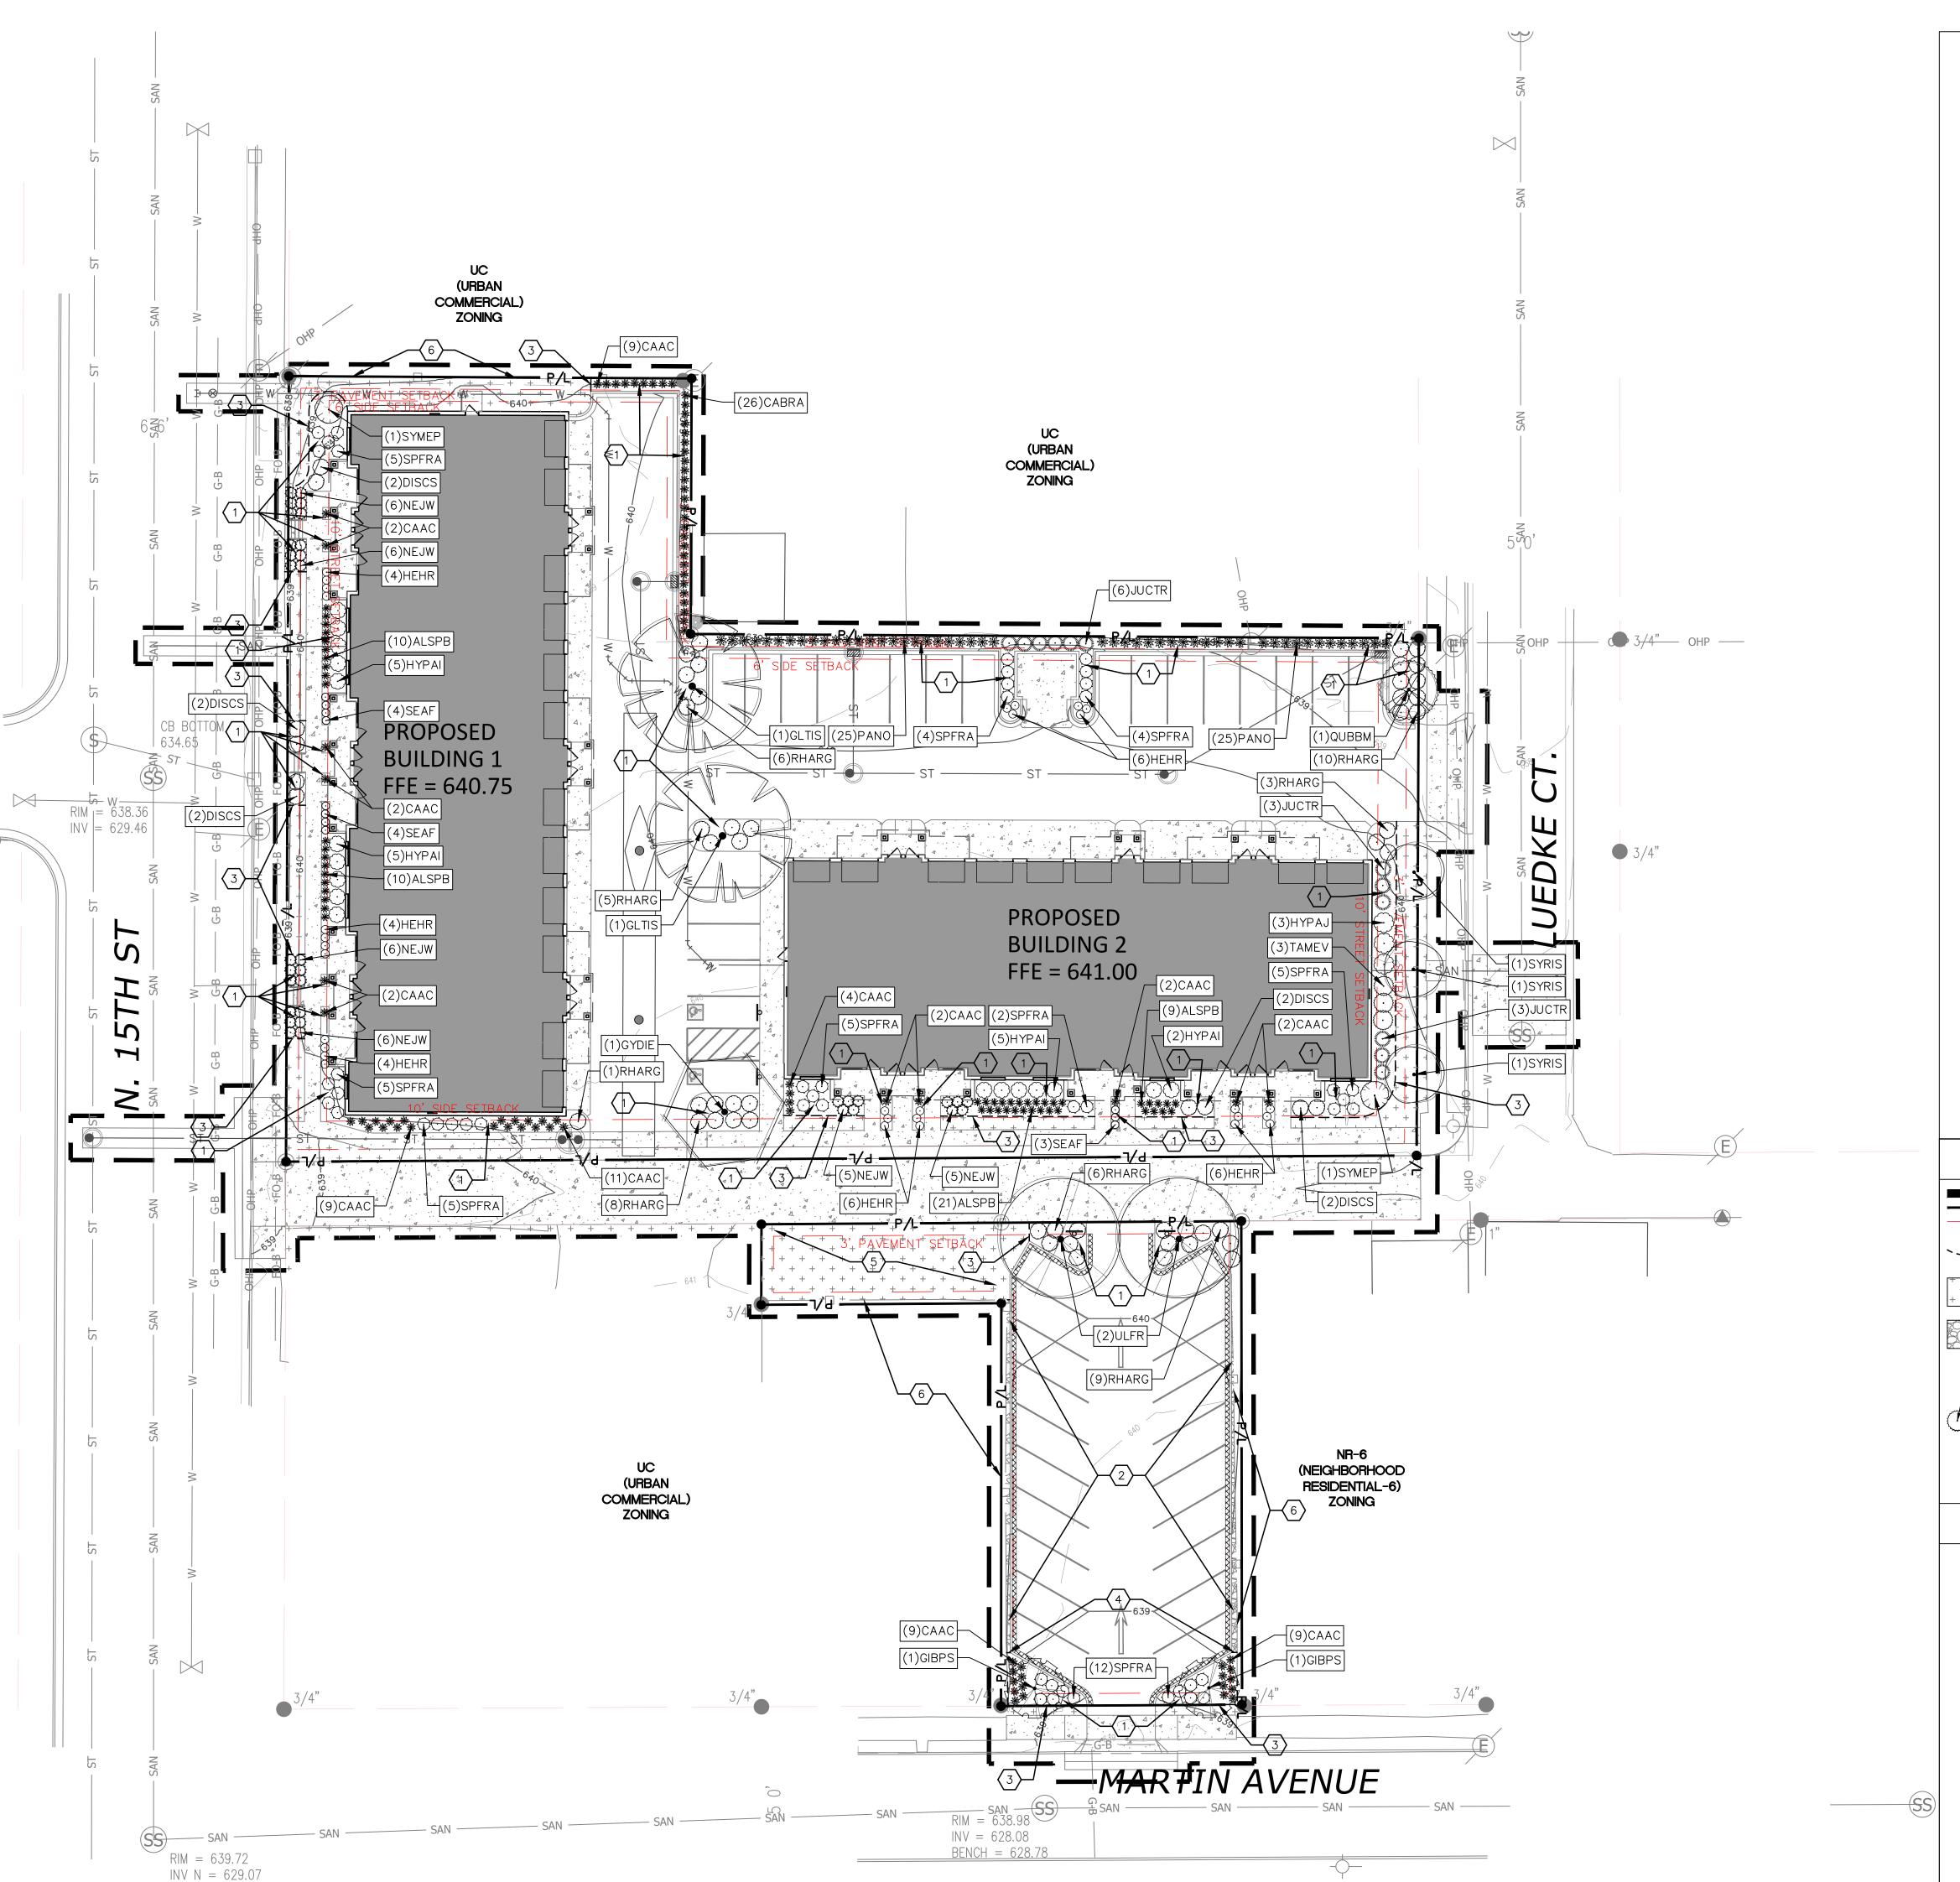LANDSCAPE


SHEET TITLE

SITE

PLAN


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# HATCH LEGEND

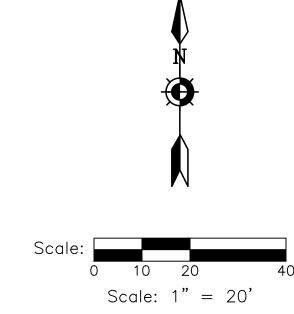

- PLANT SYMBOL (SYMBOL VARIES)

### KEY INDEX

	KET INDEX
1	SHREDDED HARDWOOD MULCH
2	DECORATIVE STONE MULCH
3	ALUMINUM EDGING AT PLANTING BED
4	ALUMINUM EDGING AT MULCH SEPERA

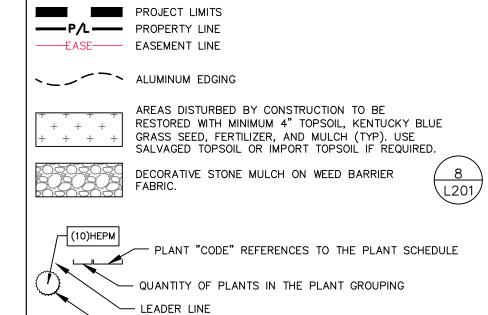SNOW STORAGE AREA

EXISTING FENCE

9 L201 10 L201

SHEET NUMBER

PROJECT NO.

Code	Scientific Name	Common Name	Quantity	Spacing	Install Size	Mature Size
Code	Scientific Name	Common Name	Quantity	Spacing	ilistali Size	(Height/Spread
Shade and T	all Trees: (Install in accordance with detail 3/L201)					
GIBPS	Ginkgo biloba 'Princeton Sentry'	Princeton Sentry Ginkgo (male)	2	Per Plan	2" caliper B&B	40'/15'
GLTIS	Gleditsia tricanthos 'Shademaster' PP1,515	Shademaster Honeylocust	2	Per Plan	2" caliper B&B	60'/35'
GYDIE	Gymnocladus dioicus 'Espresso'	Espresso Kentucky Coffee Tree	1	Per Plan	2" caliper B&B	50'/35'
QUBBM	Quercus bicolor 'Bonnie and Mlke'	Beacon Swamp White Oak	1	Per Plan	2" caliper B&B	35'/15'
ULFR	Ulmus 'Frontier'	Frontier Elm	2	Per Plan	2" caliper B&B	40'-50'/25-35'
	Law Trees, (In stall in accordance with datail 2/10	04)				
	Low Trees: (Install in accordance with detail 3/L2			D D	4.5" 1. 000	051/451
SYRIS	Syringa reticulata 'Ivory Silk'	Ivory Silk Japanese Tree Lilac	3	Per Plan	1.5" caliper B&B	25'/15'
vergreen Tr	rees: (Install in accordance with detail 4/L201)					
JUCTR	Juniperus chinensis 'Trautman'	Trautman Juniper	12	Per Plan	4' tall B&B	12'/4'
Deciduous S	hrubs: (Install in accordance with detail 5/L201)					
DISCS	Diervilla sessilifolia 'LPDC Podras' PP19,391	Cool Splash Dwarf Bush Honeysuckle	10	Per Plan	24" tall pot	30"/30"-54"
HYPAI	Hydrangea paniculata 'ILVOBO' PP22,782	Bobo Hydrangea	17	Per Plan	24" tall pot	3'/3'-4'
HYPAJ	Hydrangea paniculata 'Jane'	Little Lime Hydrangea	3	Per Plan	18" tall pot	3'-5'/3'-5'
RHARG	Rhus aromatica 'Gro-Low'	Gro-Low Sumac	48	Per Plan	18" spread pot	2'-3'/6'-8'
SPFRA	Spiraea x fritschiana 'JN Select A'	Pink-a-licious Fritsch Spirea	47	Per Plan	18" tall pot	2'-3'/2'-3'
SYMEP	Syringa meyeri 'Palibin'	Meyer Lilac (Dwarf Korean Lilac)	2	Per Plan	36" tall pot	4'-5'/5'-7'
	hrubs: (Install in accordance with detail 5/L201)	Cuadam Van	2	Der Dlen	40" annead not	21 21/41 EI
TAMEV	Taxus x media 'Everlow'	Everlow Yew	3	Per Plan	18" spread pot	2'-3'/4'-5'
erennials:	(Install in accordance with detail 6/L201)					
ALSPB	Allium x 'Summer Peek-a-Boo'	Summer Peek-a-Boo Globe Lily	50	Per Plan	#1 cont.	8"-12"/18"-24"
BECOW	Bergenia cordifolia 'Winterglut'	Winter Glow Bergenia	2	Per Plan	#1 cont.	12"-18"/12"-18"
CAAC	Calamagrostis x acutiflora Karl Foerster	Karl Foerster Reed Grass	61	Per Plan	#1 cont.	5'-6'/18"-24"
CABRA	Calamagrostis brachytricha	Fall Blooming Feather Reed Grass	26	Per Plan	#1 cont.	36"-60"/24"
HEHR	Hemerocallis 'Happy Returns'	Happy Returns Daylily	30	Per Plan	#1 cont.	12"-18"/16"-24"
NEJW	Nepeta x 'Junior Walker'	Junior Walker Catmint	34	Per Plan	#1 cont.	15"-18"/30"-36"
PANO	Panicum virgatum 'Northwinds'	Northwinds Switch Grass	50	Per Plan	#1 cont.	4'-5'/24"-30"
	Sedum x 'Autumn Fire'	Autumn Fire Sedum	11	Per Plan	#1 cont.	18"-24"/24"



- 1. ALL PLANT MATERIAL SHALL BE OBTAINED FROM A NURSERY LOCATED IN ZONE 5, CONFORM TO APPLICABLE REQUIREMENTS OF THE CURRENT EDITION OF THE AMERICAN STANDARD FOR NURSERY STOCK, AND BOTANICAL NAMES SHALL BE ACCORDING TO THE CURRENT EDITION OF "STANDARDIZED PLANT NAMES" PREPARED BY THE AMERICAN JOINT COMMITTEE ON HORTICULTURE NOMENCLATURE.
- 2. CONTRACTOR TO PROVIDE TO THE LANDSCAPE ARCHITECT SAMPLES OF ALL WOOD AND MINERAL/STONE MULCHES OR OTHER GROUND COVER MATERIALS FOR APPROVAL PRIOR TO INSTALLATION.
- 3. SHREDDED HARDWOOD MULCH TO BE FRESHLY ACQUIRED SHREDDED HARDWOOD MULCH. DOUBLE MILLED, EXCESSIVE DIRT AND DUST LIKE MATERIAL OR OLD MATERIAL IS NOT ACCEPTABLE.
- 4. LANDSCAPE EDGING TO BE ALUMINUM EDGING. REFER TO SPECIFICATION 32 93 00 PLANTS FOR ADDITIONAL INFORMATION.
- 5. ALL PLANTING AREAS TO RECEIVE A 2 TO 3-INCH THICK LAYER OF SHREDDED HARDWOOD MULCH OVER TYPAR PROFESSIONAL WEED BARRIER FABRIC WITH EDGING. EDGING TO BE INSTALLED BETWEEN DIFFERENT TYPES OF MULCHES, BETWEEN MULCHES AND TURF, AND/OR WHERE SPECIFICALLY NOTED ON THE PLAN. REFER TO SPECIFICATION 32 93 00 PLANTS FOR ADDITIONAL INFORMATION.
- 6. INSTALL SHOVEL CUT EDGE AROUND ALL INDIVIDUAL TREES AND SHRUBS IN LAWN AREAS AND ALONG PAVEMENT WHERE PLANTING AREAS ABUT TO PREVENT SHREDDED HARDWOOD MULCH FROM SPILLING OUT OF PLANTING AREA.
- 7. CONTRACTOR RESPONSIBLE FOR MAINTENANCE OF PLANT MATERIAL FOR 90 DAYS FROM INSTALLATION, INCLUDING WATERING, WEEDING, ETC. CONTRACTOR IS RESPONSIBLE FOR MAINTENANCE OF SEEDED AREAS FOR 60 DAYS FROM INSTALLATION, INCLUDING WATERING, WEEDING, ETC. CONTRACTOR TO PROVIDE AND REVIEW MAINTENANCE INSTRUCTIONS WITH THE OWNER PRIOR TO THE COMPLETION OF THESE MAINTENANCE PERIODS. REFER TO SPECIFICATIONS FOR
- 8. CLEANLY PRUNE AND REMOVE DAMAGED BRANCHES, DEAD WOOD, AND ROOTS IMMEDIATELY PRIOR TO PLANTING. DO NOT CUT LEADERS OR LEAVE "V" CROTCHES OR DOUBLE LEADERS UNLESS A MULTI-STEM TREE IS SPECIFIED.
- 9. REMOVE BURLAP, WIRE BASKET, ROPE, TWINE, AND ALL SYNTHETIC MATERIAL FROM THE ROOTS, TRUNK, OR CROWN OF
- 10. REMOVE EXCESS SOIL ABOVE ROOT COLLAR.
- 11. PLANT TREES AND SHRUBS SO THAT THE ROOT COLLAR IS 2" ABOVE FINISHED GRADE OR SEVERAL INCHES ABOVE GRADE IF PLANT IS INSTALLED IN POOR SOILS.
- 12. PLANT TREES AND SHRUBS WITH SAME ORIENTATION AS WHEN HARVESTED FROM THE NURSERY OR TO SHOWCASE THE MOST AESTHETIC VIEW.
- 13. PLANT ALL TREES WITH THREE SLOW RELEASE FERTILIZER PACKETS, SPACED EQUIDISTANT AROUND THE EDGE OF THE
- 14. PLANT ALL SHRUBS WITH ONE SLOW RELEASE FERTILIZER PACKET, PLACED BELOW THE ROOTING SYSTEM.


LAWN AREAS, 5'-0" DIA. FOR EVERGREEN TREES. KEEP MULCH 2" AWAY FROM TRUNKS.

- 15. WATER AND TAMP BACKFILL AND ROOTS OF ALL NEWLY SET PLANT MATERIAL SO THE SOIL AND ROOTS ARE THOROUGHLY SOAKED AND AIR POCKETS ARE REMOVED.
- 16. FOR INDIVIDUAL TREES & SHRUBS PLANTED IN TURF AREAS, PROVIDE CONTINUOUS 3" SOIL SAUCER TO CONTAIN WATER &

17. INSTALL 3" THICK SHREDDED HARDWOOD MULCH RING 3'-0" DIA. FOR DECIDUOUS TREES AND ALL INDIVIDUAL SHRUBS IN

- MULCH (TREES ON SLOPES SHALL BE SAUCERED ON THE DOWNHILL SIDE)
- 18. STAKING ONLY STAKE EVERGREEN TREES 5'-0" OR GREATER IN HEIGHT OR TREES THAT ARE UNABLE TO REMAIN UPRIGHT AFTER PLANTING. TREES WILL BECOME STRONGER FASTER WHEN THE TOP 2/3 OF THE TREE IS FREE TO SWAY. DO NOT ATTACH WIRE DIRECTLY TO TREES OR THROUGH HOSES - UTILIZE GROMMETED, SYNTHETIC STRAPS AT LEAST 2" WIDE AROUND THE TREE, ATTACH STRAPPING TO STAKE WITH WIRE. STAKE ONLY WHEN NECESSARY. STAKES SHOULD BE DRIVEN DEEPLY INTO THE GROUND TO PREVENT DISLODGING. CHECK AT LEAST EVERY THREE MONTHS FOR BINDING OR OTHER PROBLEMS. STAKES AND TIES SHOULD BE REMOVED SIX MONTHS TO ONE YEAR AFTER PLANTING.
- 19. LAWN AREAS BEING CONVERTED TO PLANTING BEDS SHALL HAVE THE LAWN KILLED AND ENTIRELY REMOVED INCLUDING ROOTS. REPLACE THE REMOVED SOIL WITH IMPORTED TOPSOIL. DO NOT TILL THE EXISTING LAWN INTO THE SOIL.
- 20. PAVED AREAS BEING CONVERTED TO PLANTING BEDS SHALL HAVE ALL STONE AGGREGATE BASE DOWN TO SUBGRADE REMOVED AND REPLACED WITH PLANTING SOIL.
- 21. STONE MULCH TO BE 3/4-INCH RAVENS BLACK DECORATIVE STONE CHIP FROM HALQUIST STONE OR APPROVED EQUIVALENT. CONTRACTOR TO CONTACT HALQUIST STONE N51 W23563 LISBON ROAD SUSSEX, WI 53089 TELEPHONE (262)246-9000 EMAIL: INFO@HALQUISTSTONE.COM
- 22. REFER TO SPECIFICATIONS 32 93 00 PLANTS AND 32 92 00 TURF AND GRASSES FOR ADDITIONAL INFORMATION.




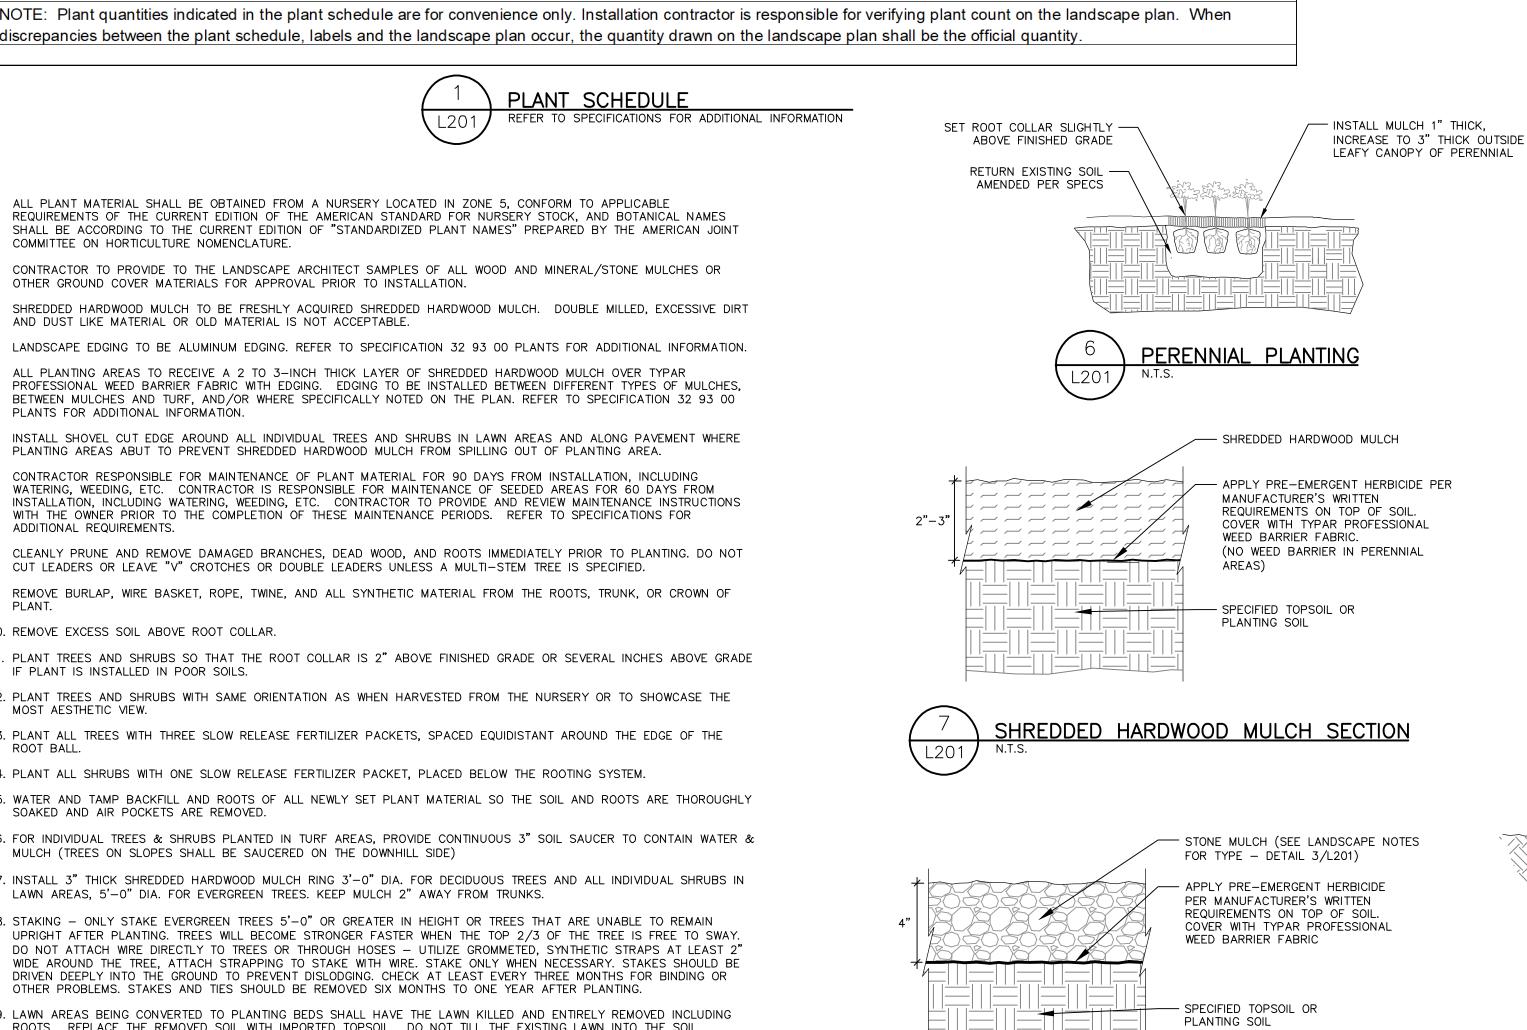

1. FINAL GRADE OF STONE MULCH SHALL BE FLUSH WITH TOP OF PAVEMENT


STONE MULCH SECTION


OR TOP OF CURB WHEN ADJACENT TO PAVEMENT OR CURBS.

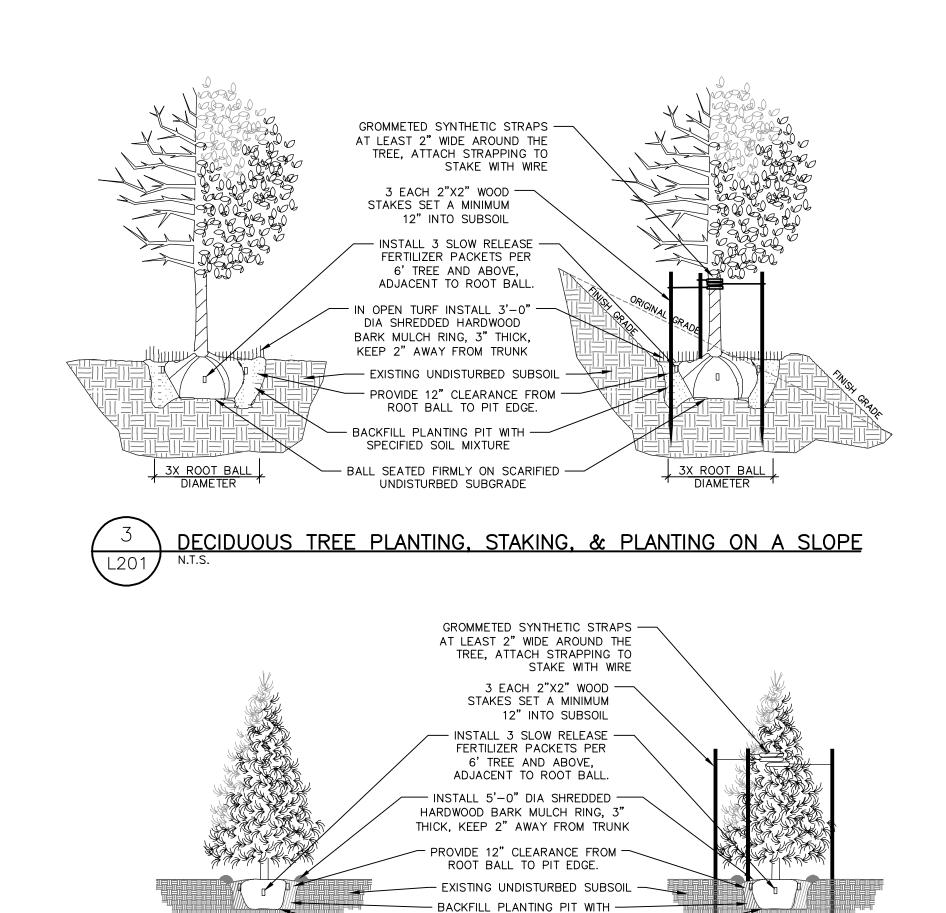

SPECIFIED SOIL MIXTURE  $-\!\!-\!\!-$  BALL SEATED FIRMLY ON  $-\!\!-\!\!-$ SCARIFIED UNDISTURBED SUBGRADE

**EVERGREEN TREE PLANTING & STAKING** 

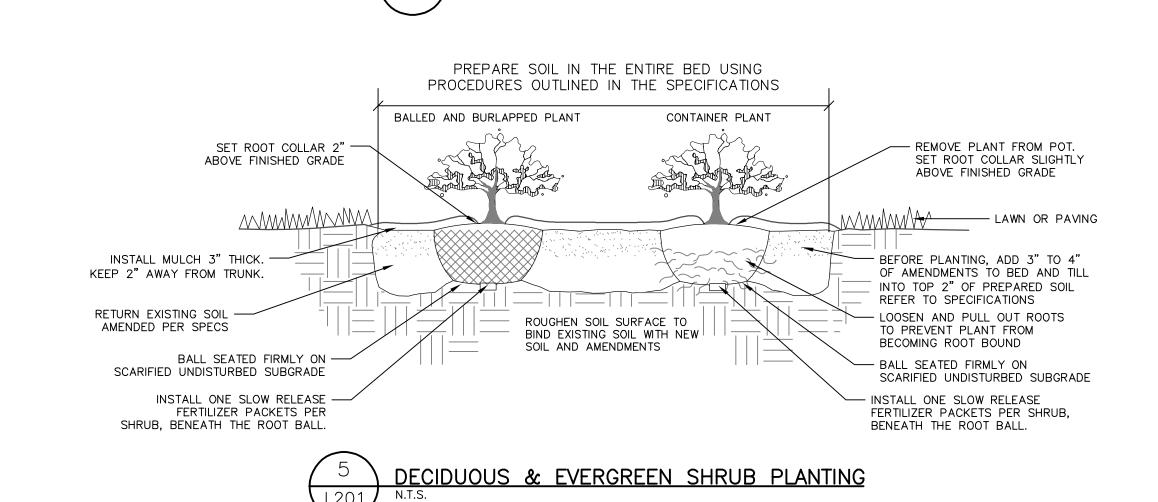

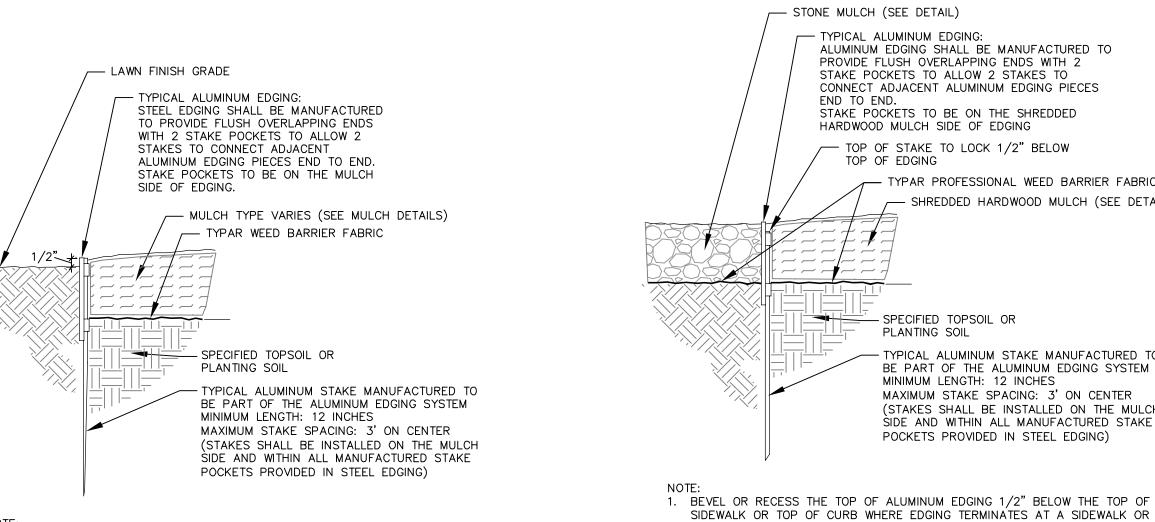




1. BEVEL OR RECESS THE TOP OF ALUMINUM EDGING 1/2" BELOW THE TOP OF

CURB TO PREVENT A TRIPPING HAZARD.

SIDEWALK OR TOP OF CURB WHERE EDGING TERMINATES AT A SIDEWALK OR

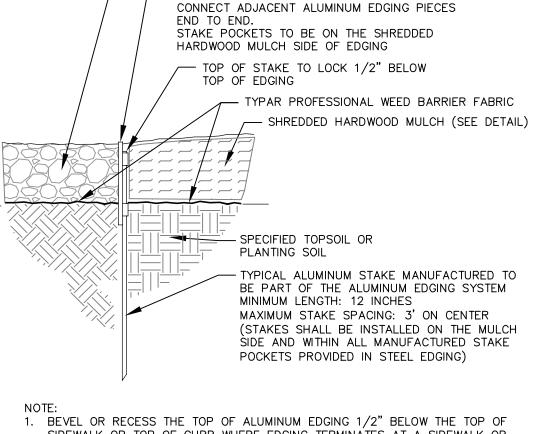

CURB TO PREVENT A TRIPPING HAZARD. 2. TOP OF MULCH TO MATCH THE TOP OF THE EDGING.





788 N. Jefferson Street, Ste 900 Milwaukee, Wisconsin 53202

kapurinc.com

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PROJECT TITLE Jakum Site Redevelopment

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N. 15th St. & Luedke Ct. Sheboygan, Wisconsin SHEET TITLE SITE LANDSCAPE **DETAILS** 

SHEET NUMBER

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