

#### **CITY OF SHEBOYGAN**

## APPLICATION FOR CONDITIONAL USE

Fee:	\$250.00	-
Revie	ew Date:	
Zonir	ng:	<u> </u>

Read all instructions before completing. If additional space is needed, attach additional pages.

SECTION 1: Applicant/ Permittee Info	mation					
Applicant Name (Ind., Org. or Entity)	Authorized Representative		Title			
H & R Construction	Nate Herbst		Owner Representative		tive	
Mailing Address	City		State		ZIP Code	
307 E. 39 <sup>th</sup> Street	South Sioux City		NE		68776	
Email Address	Email Address Phone Number (in		cl. area code)			
nherbst@hnrco.com		712-203-0394				
SECTION 2: Landowner Information (c		when project site o		fferent th	an applicant)	
Applicant Name (Ind., Org. or Entity)	Contact Person		Title			
Sheboygan Auto Group	John Berger		GM			
Mailing Address	City		State		ZIP Code	
2701 Washington Ave	Sheboygan		WI		53081	
Email Address		Phone Number (inc	cl. area code)			
John.berger@sheboyganauto.com		262-305-9081				
SECTION 3: Project or Site Location						
Project Address/Description			Parcel No			
2701 Washington Ave			5928141	772		
SECTION 4: Proposed Conditional Use						
Name of Proposed/Existing Business:	Sheboygan Auto G					
Existing Zoning:	Suburban Commercial District (SC)					
Present Use of Parcel:	Auto dealer, repair center, car wash					
Proposed Use of Parcel:	Same as present use					
Present Use of Adjacent Properties:	ent Properties: Commercial, Railroad, S Business Dr.					
SECTION 5: Certification and Permission	ET HER DEPARTMENT OF THE PARTY					
Certification: I hereby certify that I am	the owner or author	rized representative	of the ow	ner of the	property which is	
the subject of this Permit Application. I certify that the information contained in this form and attachments is true and						
accurate. I certify that the project will be in compliance with all permit conditions. I understand that failure to comply						
with any or all of the provisions of the permit may result in permit revocation and a fine and/or forfeiture under the						
provisions of applicable laws.						
<b>Permission:</b> I hereby give the City permission to enter and inspect the property at reasonable times, to evaluate this						
notice and application, and to determine compliance with any resulting permit coverage.						
Name of Owner/Authorized Represent	Title		Phone N	umber		
Nate Herbst	Owner's Represent		402-412	-3550		
Signature of Applicant    Digitally signed by Nate Herbst     DN; C-US, E=nherbst@hnrco.com, O-H & R Construction Co., CN-Nate Herbst     Date: 2023.00.311:55:25-0600'			Date Sign	ned		
I we we supply		3/3/2023	3			

Complete application is to be filed with the Department of City Development, 828 Center Avenue, Suite 208. To be placed on the agenda of the City Plan Commission, application must be filed three weeks prior to date of meeting – check with City Development on application submittal deadline date. Applications will not be processed if all required attachments and filing fee of \$250 (payable to the City of Sheboygan) are not submitted along with a complete and legible application. Application filing fee is non-refundable.

#### **CUP & Architectural Review Project Description**

PROJECT NAME AND EXISTING SITE ADDRESS: Sheboygan Auto Group 2701 Washington Ave Sheboygan, WI 53081

PARCEL INFORMATION/ZONING CLASSIFICATION/SITE DATA Parcel - 59281431772 SC-Suburban Commercial District Total area of parcel is 10.4 acres

#### **EXISTING SITE CONDITIONS/LAND USE:**

• Site is existing Sheboygan Auto Group dealership, repair center, quick lube plus, and car wash.

#### PROPOSED USE:

No change in use is proposed.

#### SITE SELECTION

• Sheboygan Auto Group is already in operation at this parcel.

#### **DESCRIPTION OF SITE IMPROVEMENTS:**

- This project previously had Plan Commission approval for a Conditional Use Permit, Architectural Review Board approval, landscape approval and erosion control approval. Due to budgeting, 1 car wash bay (16') on the east side of the building has been removed. The project is being resubmitted to obtain new approvals with the updated design.
- Two (2) existing buildings containing existing car wash facility and quick lube facility to be demolished.
- New building 7,314 SF building proposed in the same general location of the demolished buildings. The new building will contain one (1) location for a car wash, quick lube & emission testing facility.
- No access changes are proposed. However, there will be new paving and parking proposed
  where the existing service building is, and the entire lot is planned to restriped. The delta
  between existing and proposed is within a few percent. The proposed parking configuration will
  gain some spaces where the existing service building is, but ultimately will lose spaces for the
  extended queue length.
- Site disturbance will total 0.70 acres.
- New utility connections will be made onsite to the existing utility services.
- The project is a redevelopment site with no increase in exposed parking or roads and is therefore exempt from stormwater requirements. Stormwater from the site will be directed towards proposed inlets and will outfall in the ROW. The project will be less than one (1) acre of disturbance, not requiring an NOI with Wisconsin DNR.
- Landscaping will be provided in accordance with the City ordinance, in an approach which ensures species resiliency and complimentary aesthetics. Consistent with the existing

- landscaping variance for the site, bufferyards will not be provided due to the existing paving extents onsite. New landscaping will be provided within the islands adjacent to the building.
- Site lighting will comply with the City ordinance in a fashion that provides appropriate light intensity for safety with cut-off fixtures for minimal light trespass.
- Waste enclosure no new enclosure is needed.
- All required building setback requirements are met.
- Rooftop mechanicals will be screened with a building parapet and the exterior transformer will be screened with plantings.

#### **EXPLANATION BUSINESS ACTIVITIES:**

- The car wash/quick lube facility will be open Monday-Friday, 7 AM 5:30 PM. Saturday, 7:30 AM 12:00 PM.
- The current number of employees at the facility is 15-20. No new additional employees are proposed as part of the project.
- The new facility will be available for use by the general public via drive- through service for instant oil change, instant emissions testing. Car washes will be provided within the single east most service bay dedicated to dealership vehicle washes.
- Projected number of daily customers: +/-100
- Bulk Oil will be stored in a containment area in the basement of the new facility. Waste oil will
  also be stored in this manner. All fluids stored in bulk will be filled or removed (bulk oil) about
  once every two months based on current and projected demand.

#### PARKING REQUIREMENTS:

• Total Parking Provided: site will be serviced by the existing onsite parking; the new building will not create any additional parking demand.

#### HOW WILL SITE BE SERVICED WITH STREETS AND UTILITIES:

- The existing ingress/egress drives will remain as currently constructed and will continue to provide adequate service to the site.
- A three-quarter inch (3/4") water service line exists to the existing buildings and is proposed to be tied into for the proposed building.
- A six-inch (6") sanitary sewer service line exists for the existing car wash/quick lube and will be connected to with the proposed building.

## PROPOSED TRAFFIC IMPACTS TO ADJOINING STREETS IN THE NEIGHBORHOOD BASED ON THIS DEVELOPMENT:

• No negative traffic impacts to the neighborhood are anticipated as no change in use is proposed.

#### PROPOSED SIGNAGE:

- No new ground signage is proposed with this project.
- Building signage will be included on the northern and southern elevations. This building mounted signage will be permitted separately by the chosen sign vendor.

DESCRIPTION OF THE GENERAL ORIENTATATION, DESIGN, ARRANGEMENT, TEXTURE, MATERIAL AND COLOR OF THE BUILDING OR STRUCTURE AND HOW IIT IS COMPATIBLE WITH THE DEVELOPMENT IN AND AROUND THE AREA:

- The proposed development will include a single-story building with a 7,314 square foot footprint, and vehicle queue lanes for entering and exiting the service/carwash facility. Exterior finishes will be made of a mixture of pre-finished metal wall panels, as well as aluminum with clear glazing. The roof will have parapet wall heights that screen any rooftop equipment.
- The shape of the building is designed to illustrate hierarchy and separation between the three elements of the facility (Lobby, Service, Car Wash) rather than portray as a singular overbearing mass so close to the street. Variations in color and depth of the envelope system, while also attributing to breaking up the larger mass into smaller pieces, uses similar materials and colors as the adjacent dealerships on the site. The addition of a tertiary accent color relates to each dealership having their own accent colors, but different enough as the new facility is agnostic of a specific automotive brand. The use of large glass overhead doors aligned on the north and south facades allow light and line-of-sight to travel through the façade, further softening the visual impact of an otherwise solid mass.

#### POTENTIAL NUISANCES TO ADJOINING PROPERTY OWNERS:

- The proposed development will have no negative impacts to the neighborhood.
- No outside storage is proposed.
- Site lighting will meet City light intensity requirements and cut-off fixtures will be used for minimal light trespass.
- The architectural style of the building will fit in and compliment surrounding commercial developments.

#### **ESTIMATED VALUE OF PROJECT:**

Approximately \$2.8M

#### CONSTRUCTION TIMELINE:

 The proposed development timeline is a March 2023 start with an anticipated completion date of September 2023.

#### **VARIANCE REQUESTS**

- Exception to the landscape bufferyard requirements is requested; these were previously approved via a landscape variance granted in 2018.
- Exception to the internal landscape/greenspace percentage of 25% is being requested for this portion of the site. This also was approved as a variance with the 2018 plans. The project will slightly decrease impervious area onsite and increase greenspace from the existing amount within the project area.
- Exception to the maximum number of signs for this site is also being requested. Within the Suburban Commercial (SC) Zoning District, a maximum of four (4) on-building signs are allowed for each fronting business for all walls not directly abutting a residentially zoned property. The existing Chrysler, Dodge, Jeep, RAM dealership building currently already exceeds this standard. The proposed additional service and carwash building proposes to add six (6) additional onbuilding signs for the purpose of identification, direction, and advertising necessary to alert business patrons of location, services, and products provided at this specific site. This will include the signage shown on the proposed north and south elevations along with smaller way-finding signage over each bay door on the entry side of the facility (south / non street side) so that customers can identify the three lube bays from the emission test bay.

HOW IS THE PROPOSED CONDITIONAL USE (INDEPENDENT OF ITS LOCATION) IN HARMONY WITH THE PURPOSES, GOALS, OBJECTIVES, POLICIES AND STANDARDS OF THE CITY OF SHEBOYGAN COMPREHENSIVE MASTER PLAN?

• The City of Sheboygan Comprehensive Plan Future Land Use Map designates this property as "Community Mixed-Use". The existing and proposed use is consistent with the Plan, provides needed services to the public, and is therefore consistent with the purposes, goals, objectives, policies, and standards of the Plan.

DOES THE CONDITIONAL USE, IN ITS PROPOSED LOCATION, RESULT IN ANY SUBSTANTIAL OR UNDUE ADVERSE IMPACT ON NEARBY PROPERTY, THE CHARACTER OF THE NEIGHBORHOOD, ENVIRONMENT, TRAFFIC, PARKING, PUBLIC IMPROVEMENTS, PUBLIC PROPERTY OR RIGHTS-OF WAY?

No negative impacts to neighboring properties, environment, traffic, or the public are
anticipated from the proposed project. The project will combine the current uses with an
additional needed service in one efficient and attractive facility. The proposed demolition of
existing 2 buildings and the areas to be regraded for new paving, parking spaces, and queuing
lanes for the service facility will offer improvement to current issues on the existing site.
 Currently the queue for service gets quite backed up which causes traffic issues on the property.
 The new facility features a significantly longer queue depth and brings that traffic farther away
from the main street.


HOW DOES THE PROPOSED CONDITIONAL USE MAINTAIN THE DESIRED CONSISTENCY OF LAND USES IN RELATION TO THE SETTING WITHIN WHICH THE PROPERY IS LOCATED?

• The proposed project is not requesting a change in use and the use will be consistent with the existing Sheboygan Automotive use.

IS THE PROPOSED CONDITIONAL USE LOCATED IN AN AREA THAT WILL BE ADEQUATELY SERVED BY UTILITIES, OR SERVICES PROVIDED BY PUBLIC AGENCIES? IF NOT, PLEASE EXPLAIN.

• Yes, existing utility services are in place and will be utilized for the new building.



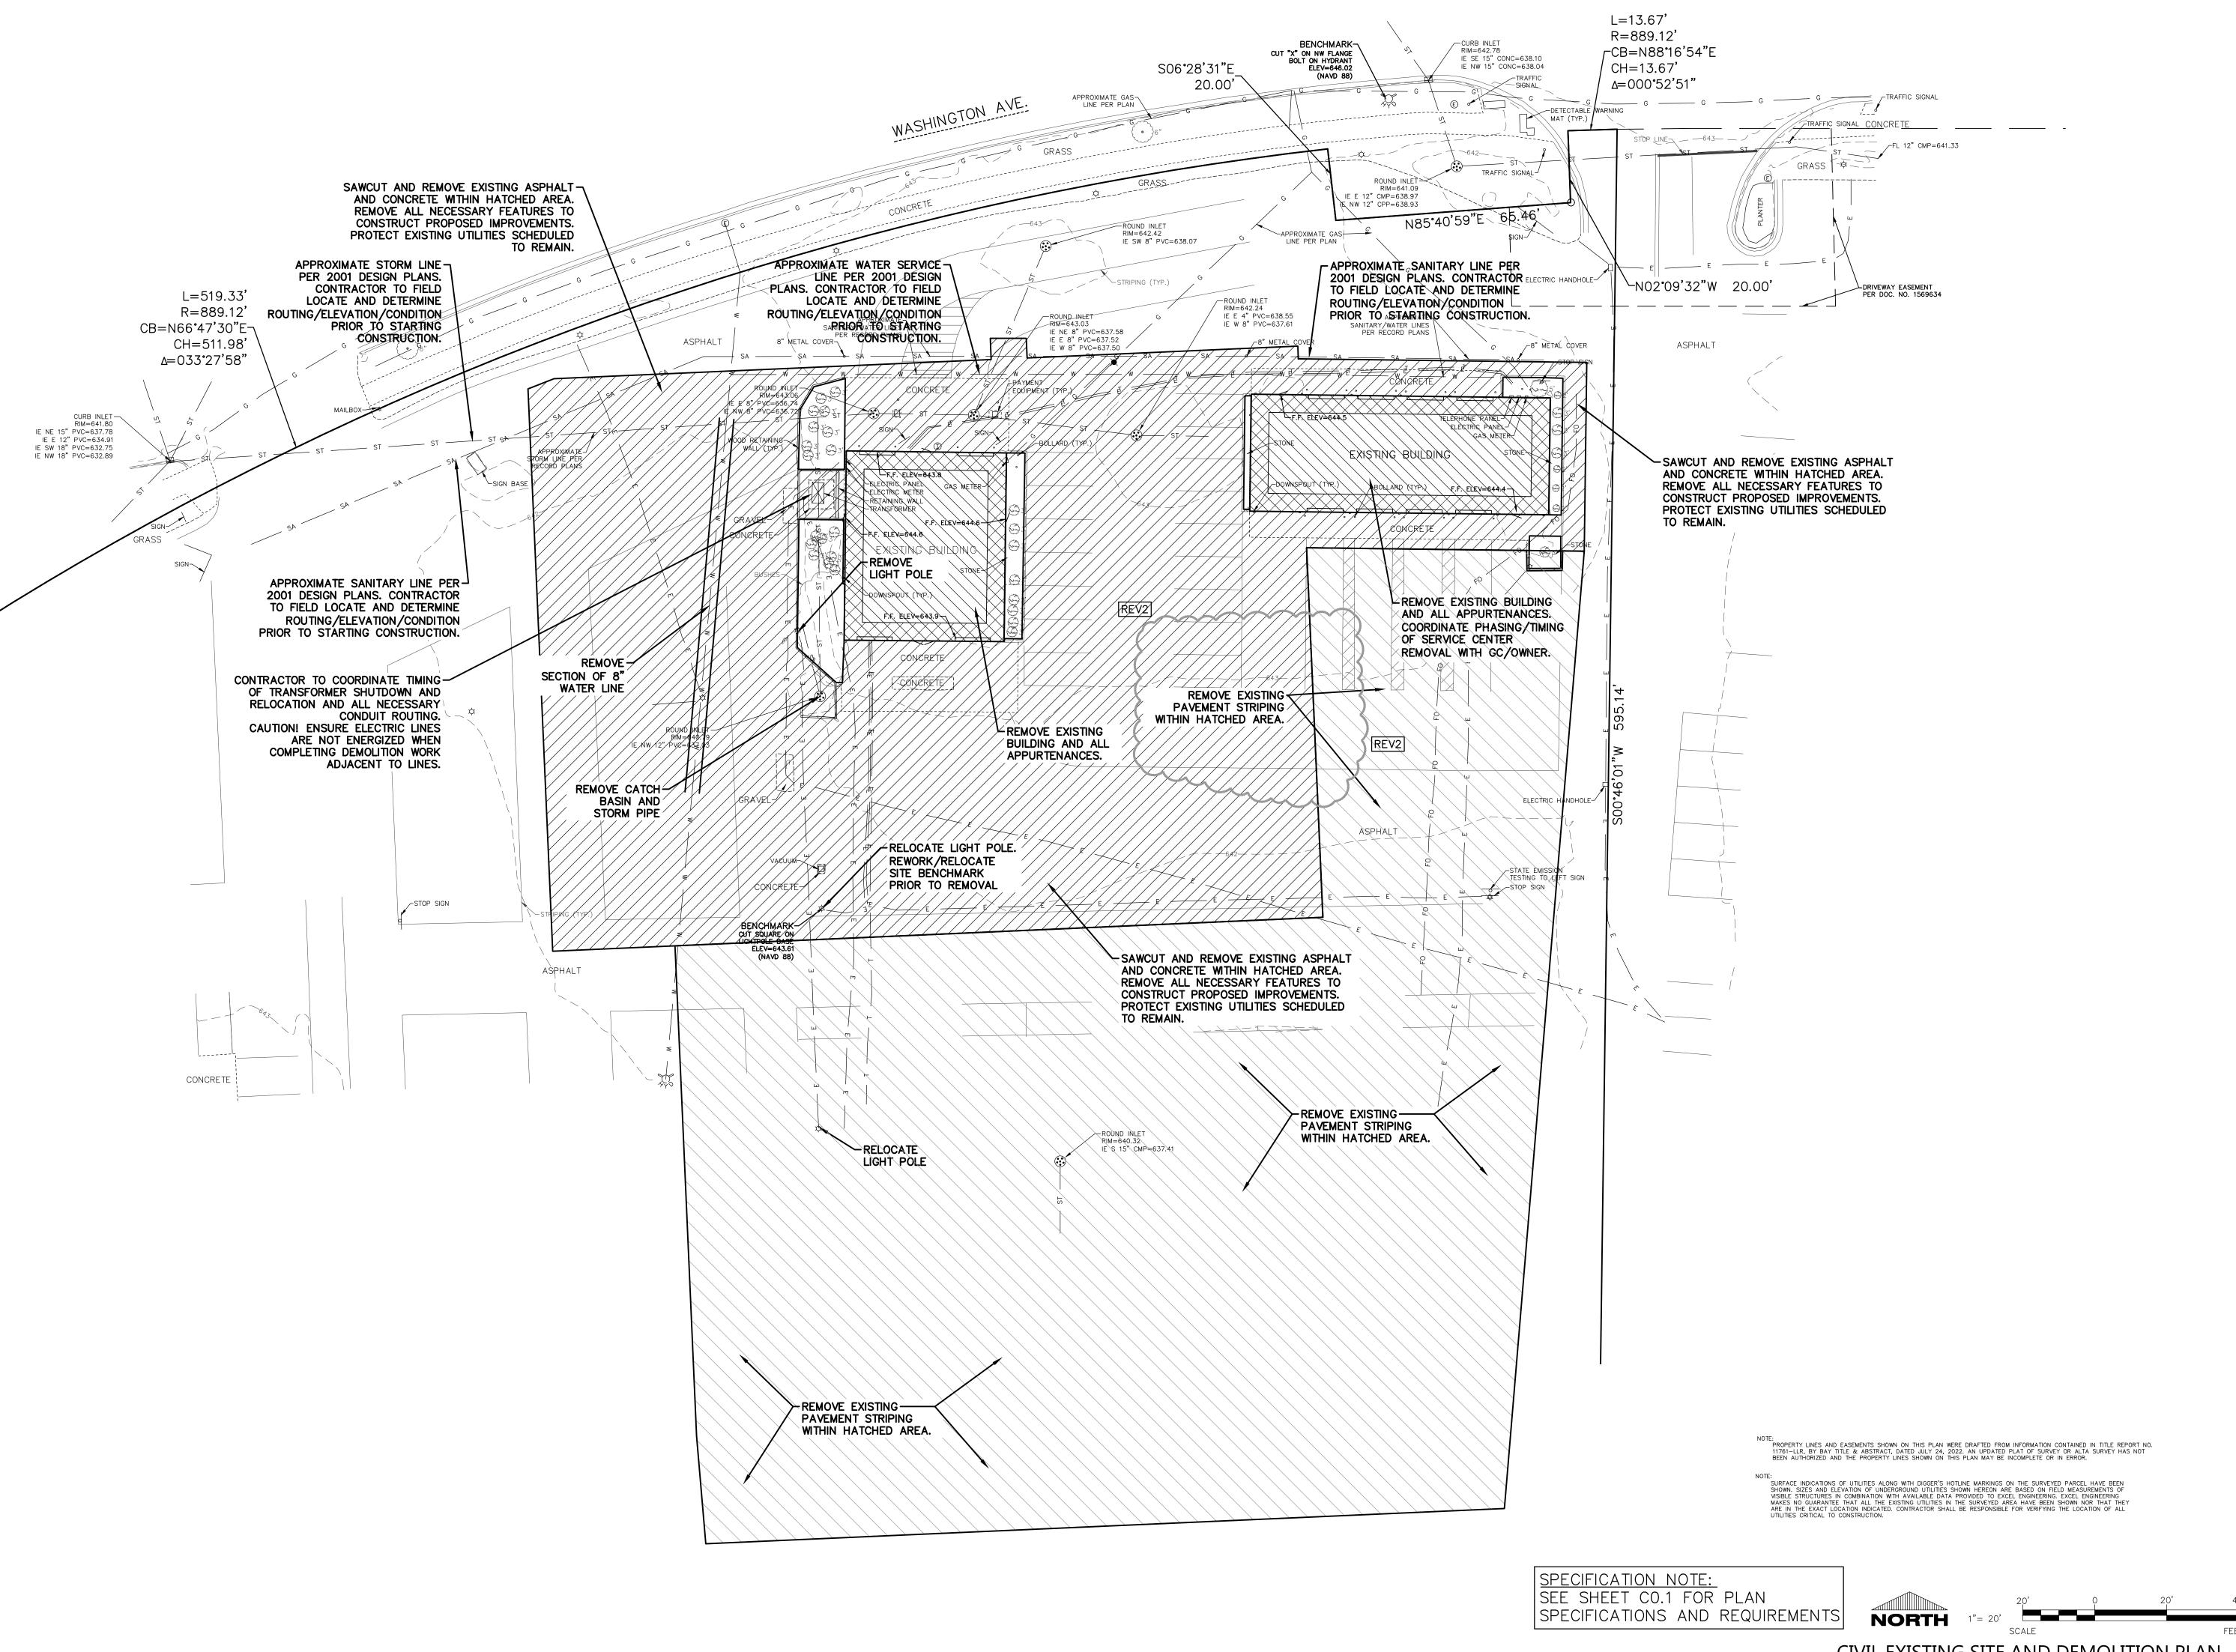

Always a Better Plan 100 Camelot Drive Fond du Lac, WI 54935 920-926-9800

PROJECT INFORMATION

excelengineer.com

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PROFESSIONAL SEAL

REVISIONS

SHEET DATES NOV. 8, 2022


REV2 MAR. 2, 2023

JOB NUMBER 2251400

SHEET NUMBER

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CIVIL EXISTING SITE AND DEMOLITION PLAN

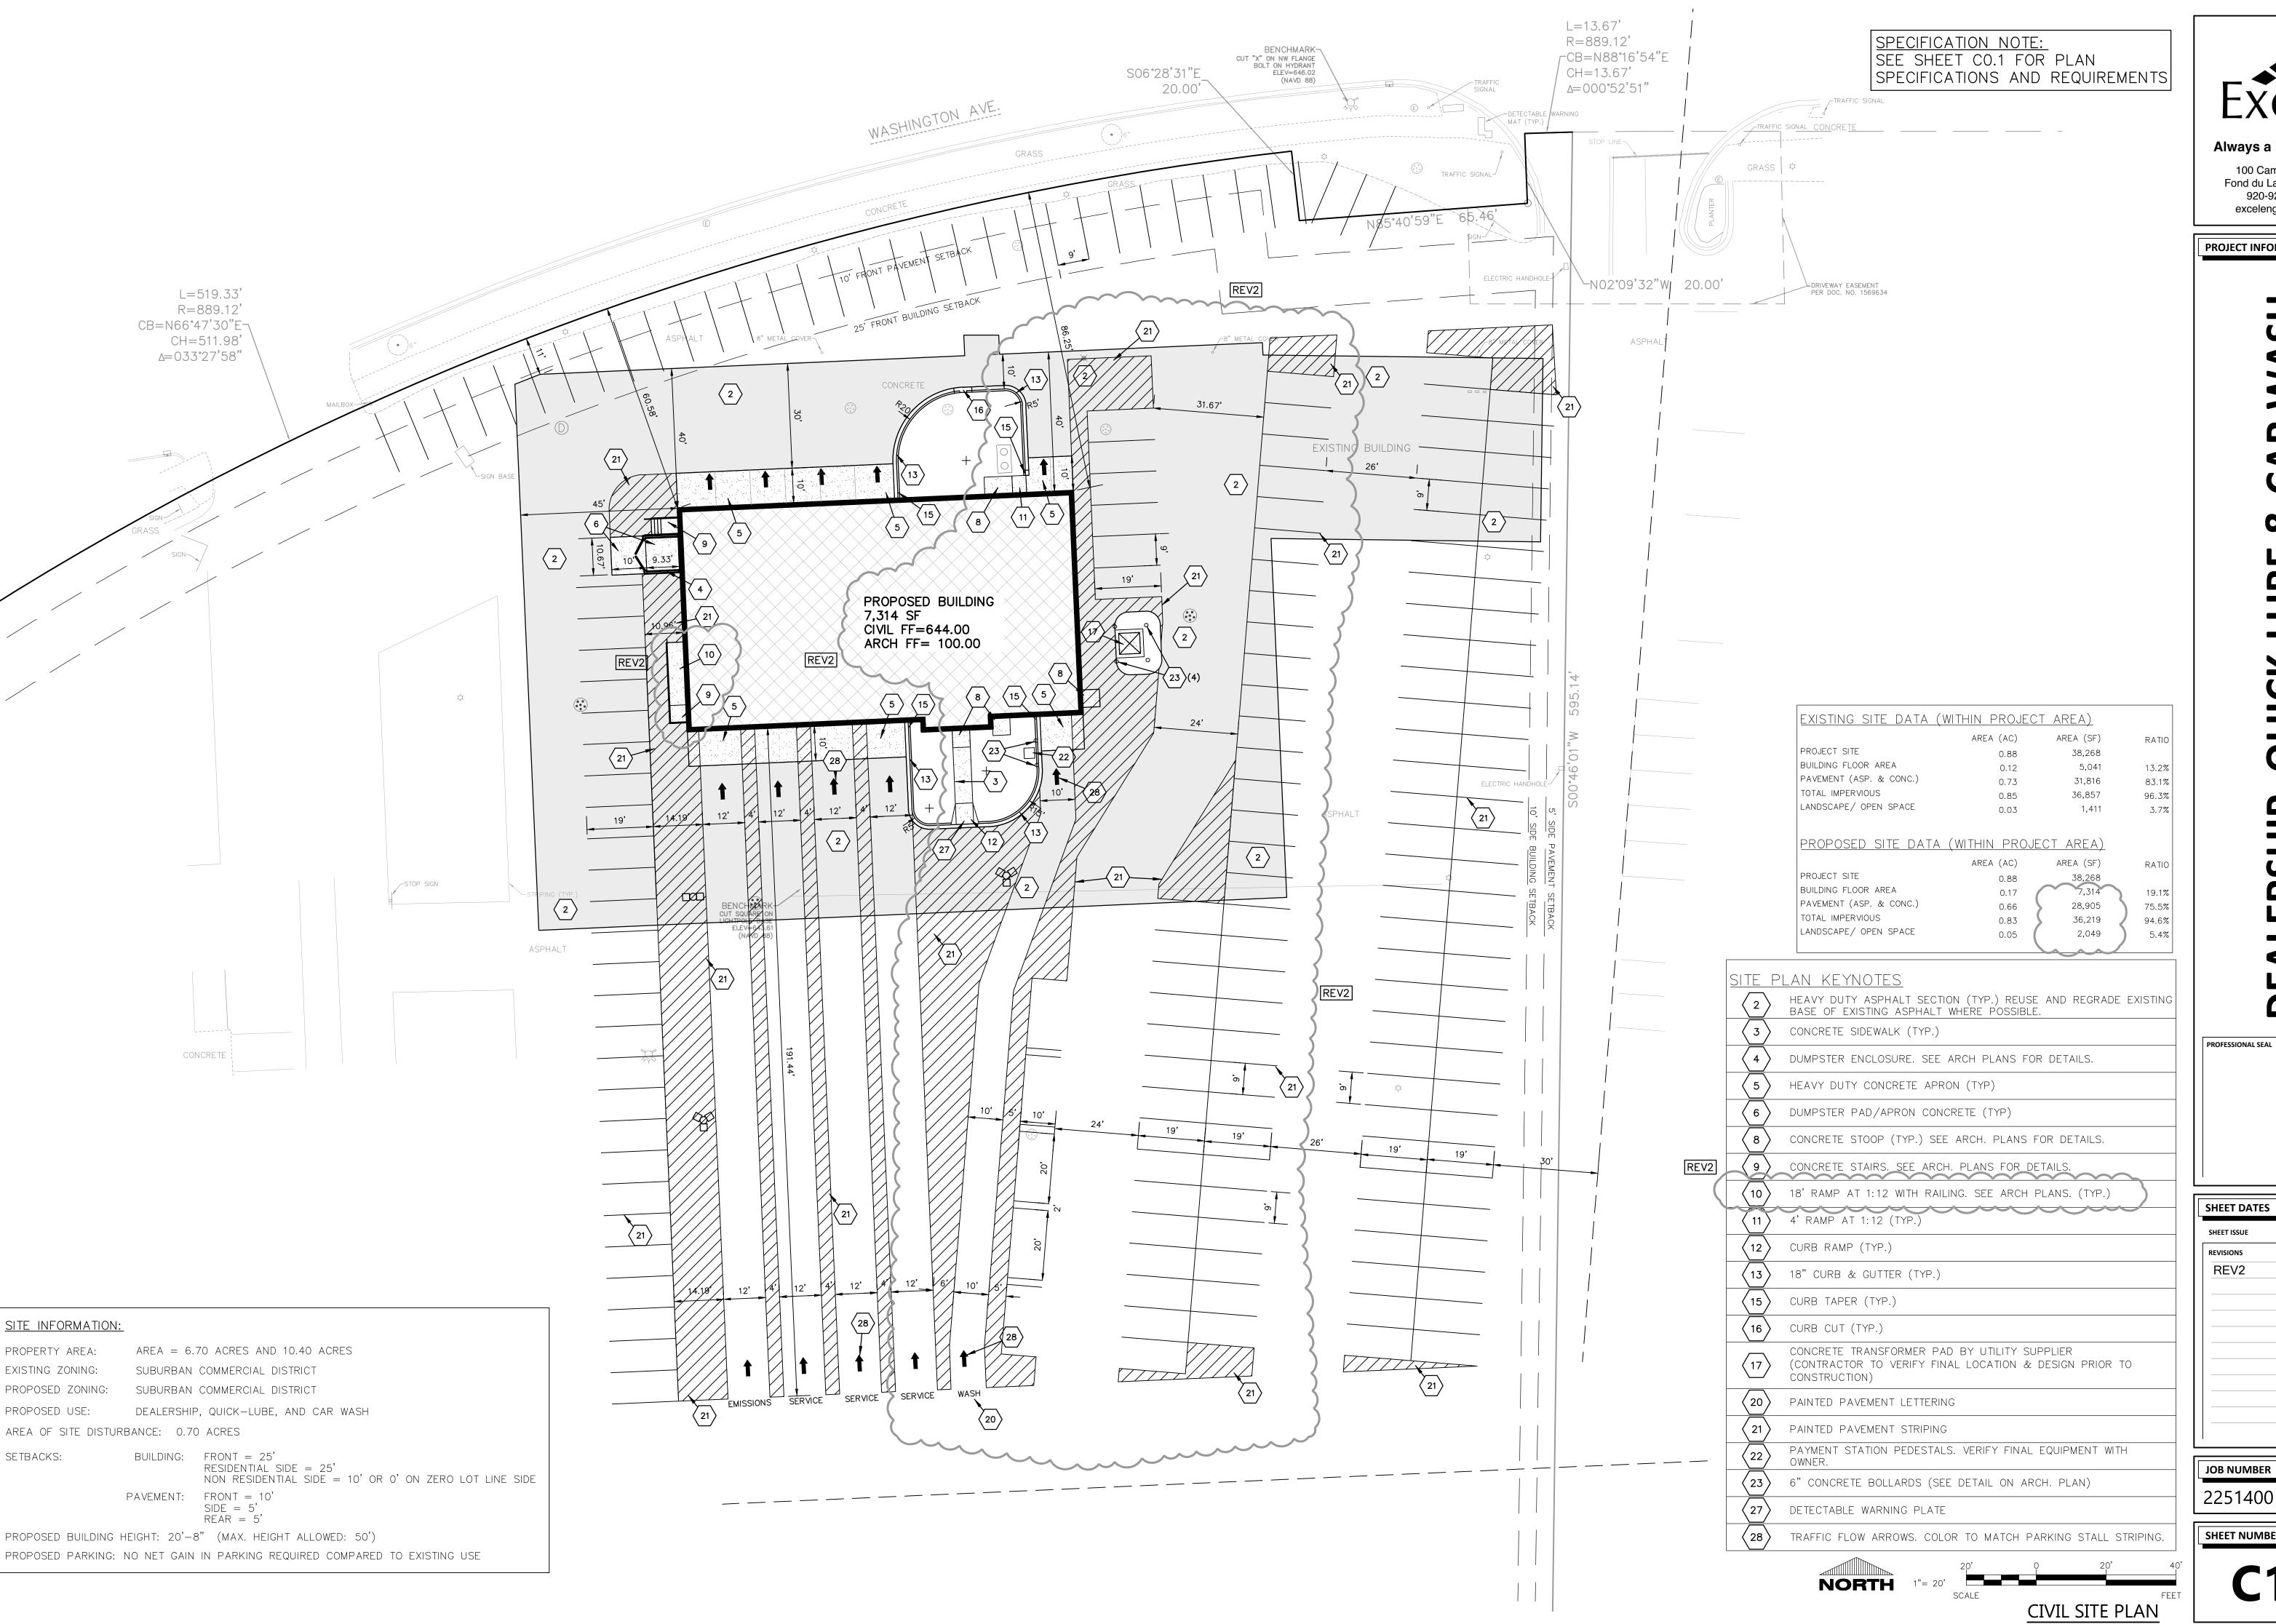

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PROJECT INFORMATION

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SHEET DATES NOV. 8, 2022


MAR. 2, 2023 REV2

JOB NUMBER

2251400

SHEET NUMBER

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PROJECT INFORMATION
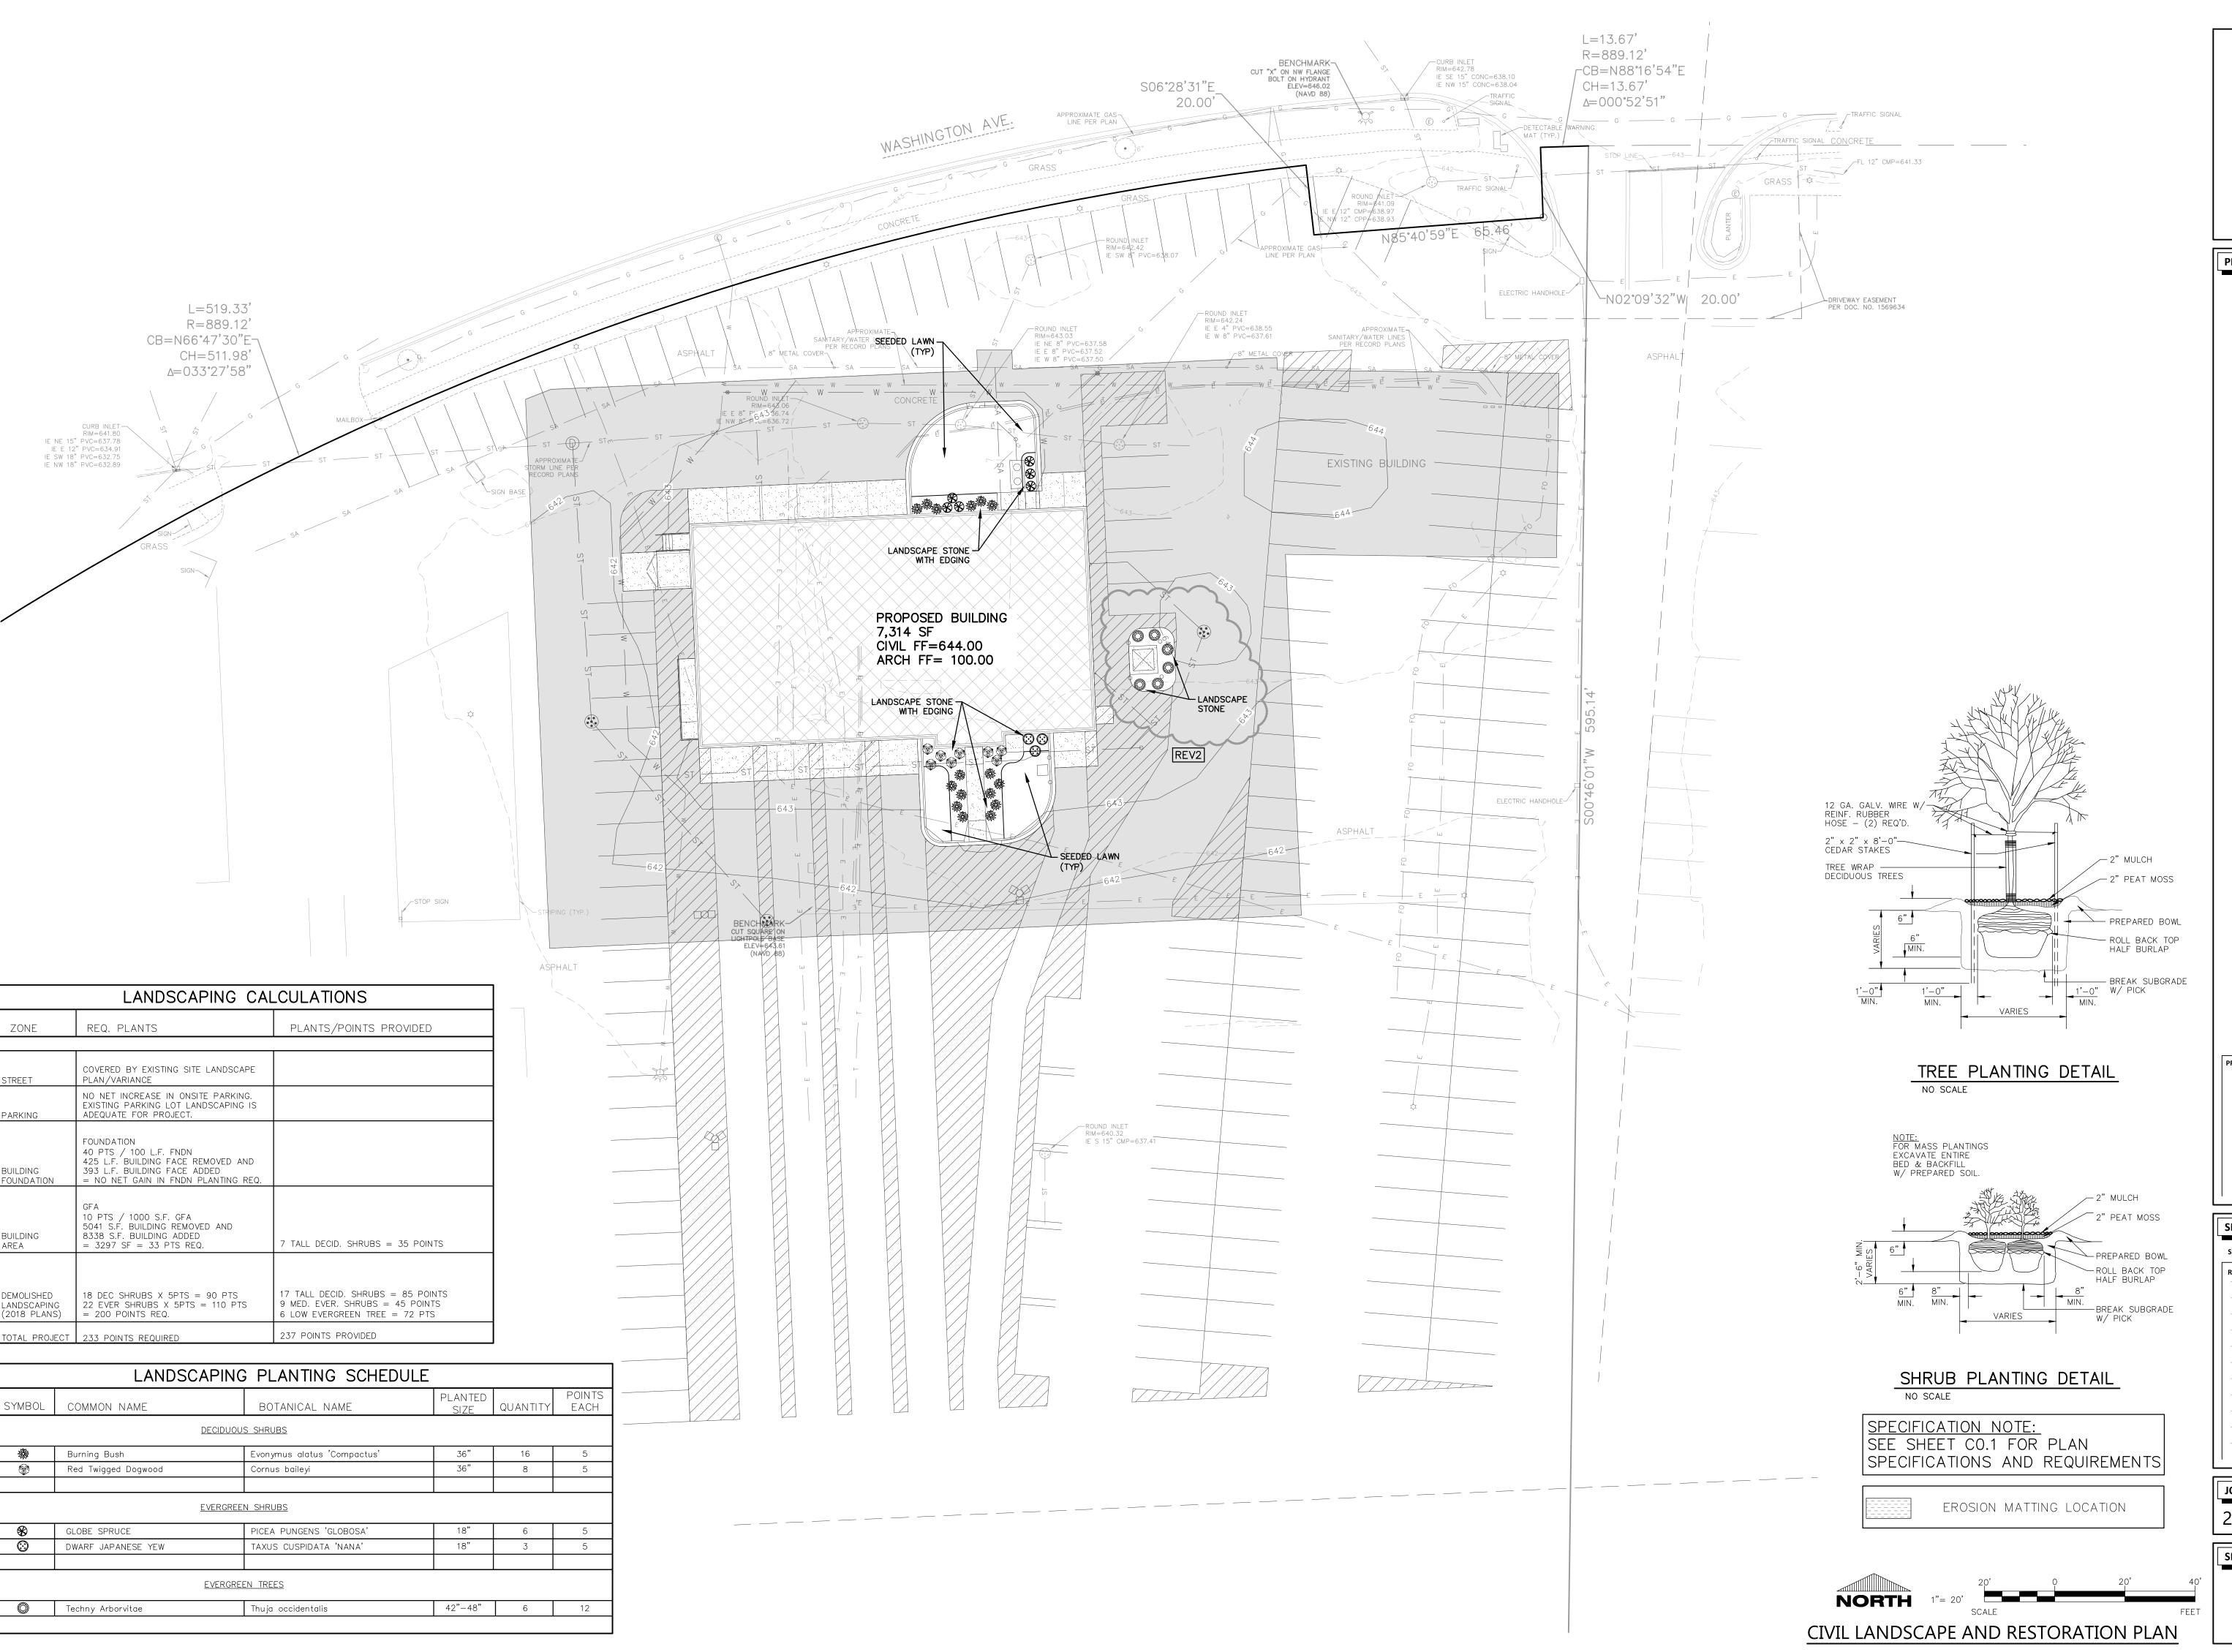
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PROFESSIONAL SEAL

SHEET DATES NOV. 8, 2022 MAR. 2, 2023

REVISIONS REV2

JOB NUMBER 2251400




2021 © EXCEL ENGINEERING, INC.

### GENERAL NOTES - ARCH. SITE PLAN

- IMPORTANT: ARCHITECTURAL SITE PLAN SHOWN FOR REFERENCE AND DESIGN INTENT ONLY, AND NOT TO BE USED FOR CONSTRUCTION. REFER TO CIVIL FOR ALL DIMENSIONING, SLOPING & GRADING, SPOT ELEVATIONS & ADDITIONAL
- CONTRACTOR TO VERIFY ALL EXISTING SITE CONDITIONS PRIOR TO SITE PREP. REPORT ANY DISCREPANCIES TO ARCHITECT AND CIVIL ENGINEER IMMEDIATELY.
- CONTRACTOR TO VERIFY ANY CRITICAL DIMENSIONS WITH REGARDS TO EXISTING CONSTRUCTION, IF ANY.
- D. SEE ELECTRICAL FOR PROPOSED NEW SITE LIGHTING @ QUICKLUBE

## ○ KEYNOTES - ARCH. SITE PLAN

- BOLLARD, SEE TYPICAL DETAIL THIS SHEET..
- GAS METER (SEE MECH.).
- ELEC. METER (SEE ELEC.). DESIGNATED TRANSFORMER LOCATION (SEE ELEC.).
- 5'-0" x 5'-0" FROST-PROTECTED STOOP (SEE STRUCT.) 8'-0" x 5'-0" FROST-PROTECTED STOOP (SEE STRUCT.)
- TRASH ENCLOSURE
- CHEMICAL PRODUCT FILL STATION
- DESIGNATED DRIVE-LANE/QUEUING
- A. POWER COMPANY TO RELOCATE ELEC. TRANSFORMER. DEMOLISH EXISTING CAR WASH (ECW) BUILDING. (SEE CIVIL)
- DEMOLISH INTERIORS OF DEALERSHIP. (SEE A7 & A8 SERIES) 11. PHASE 2:
- NEW CONSTRUCTION OF QUICK-LUBE & CAR WASH. REMODEL INTERIORS OF DEALERSHIPS. (SEE A7 & A8 SERIES)
- 12. PHASE 3: (UPON COMPLETION OF QUICK-LUBE & CAR WASH)
- A. RELOCATE EQUIPMENT FROM EXISTING QUICK-LUBE TO NEW CONSTRUCTION.
- DEMOLISH EXISTING QUICK-LUBE.

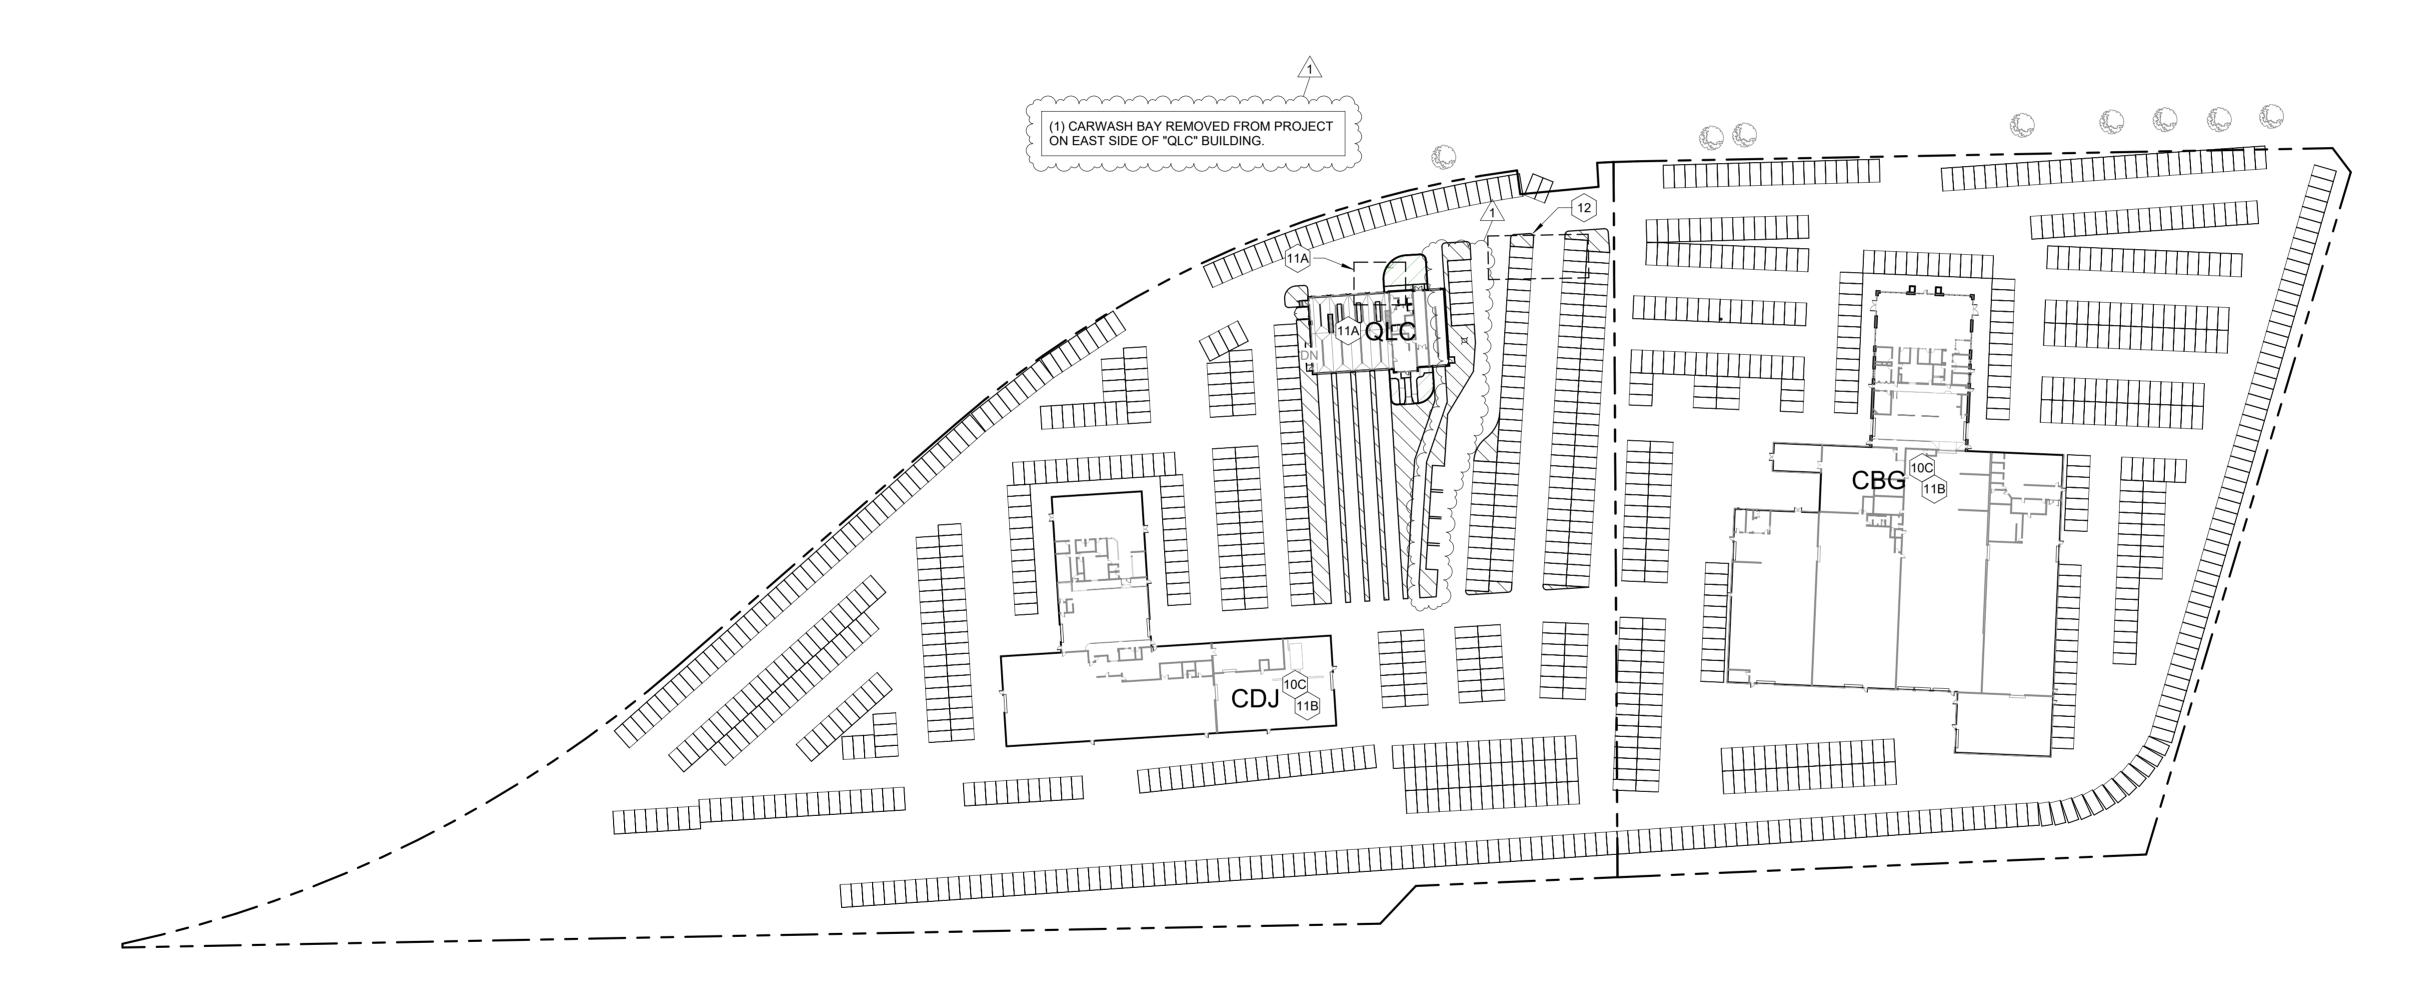

1 ARCHITECTURAL SITE PLAN
1" = 80'-0"

CBG - CHEVROLET | BUICK | GMC

CDJ - CHRYSLER | DODGE | JEEP | RAM

QLC - QUICK-LUBE | CAR WASH

- EXISTING QUICK-LUBE

ECW - EXISTING CAR WASH

STAMP: 11-8-2002 PACHITECT

group

Architecture | Planning | Interiors

Brookings, SD 57006 | P: 605.692.4008

2301 W. Russell St, Ste.

Sioux Falls, SD 57104 | P: 605.692.4008

434 5th Street, Suite 1

NO. DESCRIPTION:
1 STATE REVIEW

DA22 041

DEALERSHIP, QUICK-LUBE & CAR **WASH** 

SHEBOYGAN, WI

PROJECT MANAGER:
KYLE JAMISON

11.08.2022

AC1.1



**FOR PERMITTING &** 

CONSTRUCTION


(1) CARWASH BAY REMOVED FROM PROJECT ON EAST SIDE OF "QLC" BUILDING.

## GENERAL NOTES - ARCH. SITE PLAN


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- B. CONTRACTOR TO VERIFY ALL EXISTING SITE CONDITIONS PRIOR TO SITE PREP. REPORT ANY DISCREPANCIES TO ARCHITECT AND
- CIVIL ENGINEER IMMEDIATELY. C. CONTRACTOR TO VERIFY ANY CRITICAL DIMENSIONS WITH
- REGARDS TO EXISTING CONSTRUCTION, IF ANY. D. SEE ELECTRICAL FOR PROPOSED NEW SITE LIGHTING @
- QUICKLUBE

## ○ KEYNOTES - ARCH. SITE PLAN


- BOLLARD, SEE TYPICAL DETAIL THIS SHEET.. GAS METER (SEE MECH.).
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- 8'-0" x 5'-0" FROST-PROTECTED STOOP (SEE STRUCT.)
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- A. POWER COMPANY TO RELOCATE ELEC. TRANSFORMER.
- DEMOLISH EXISTING CAR WASH (ECW) BUILDING. (SEE CIVIL)
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- CONSTRUCTION.
  - B. DEMOLISH EXISTING QUICK-LUBE.

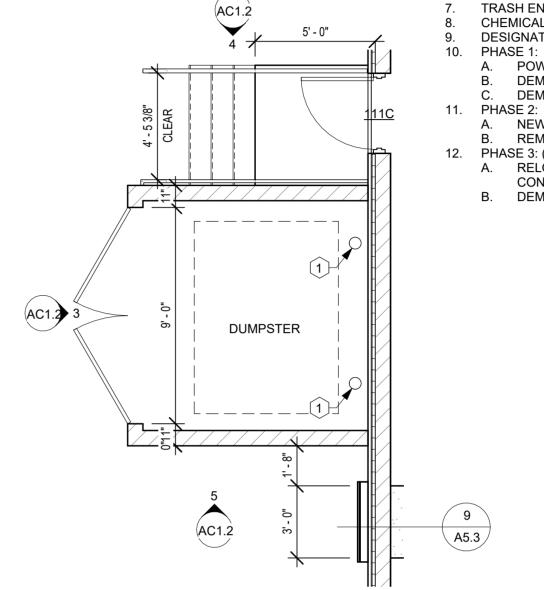

# 2 TRASH ENCLOSURE ENLARGED PLAN 1/4" = 1'-0"

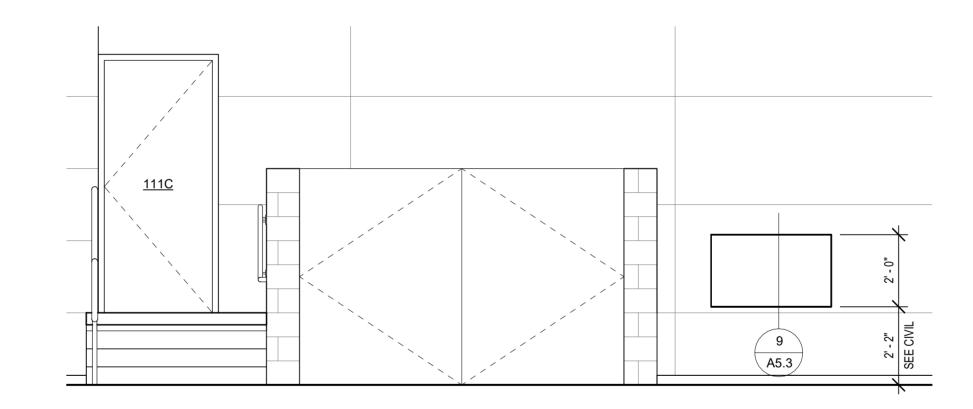

# T/E ELEVATION - WEST 3/8" = 1'-0"

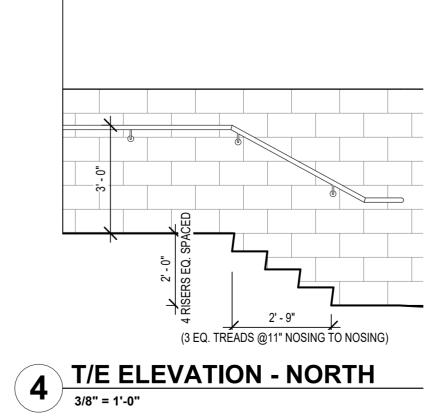

5 T/E ELEVATION - SOUTH
3/8" = 1'-0"

**FOR PERMITTING &** CONSTRUCTION



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PROJECT NO.

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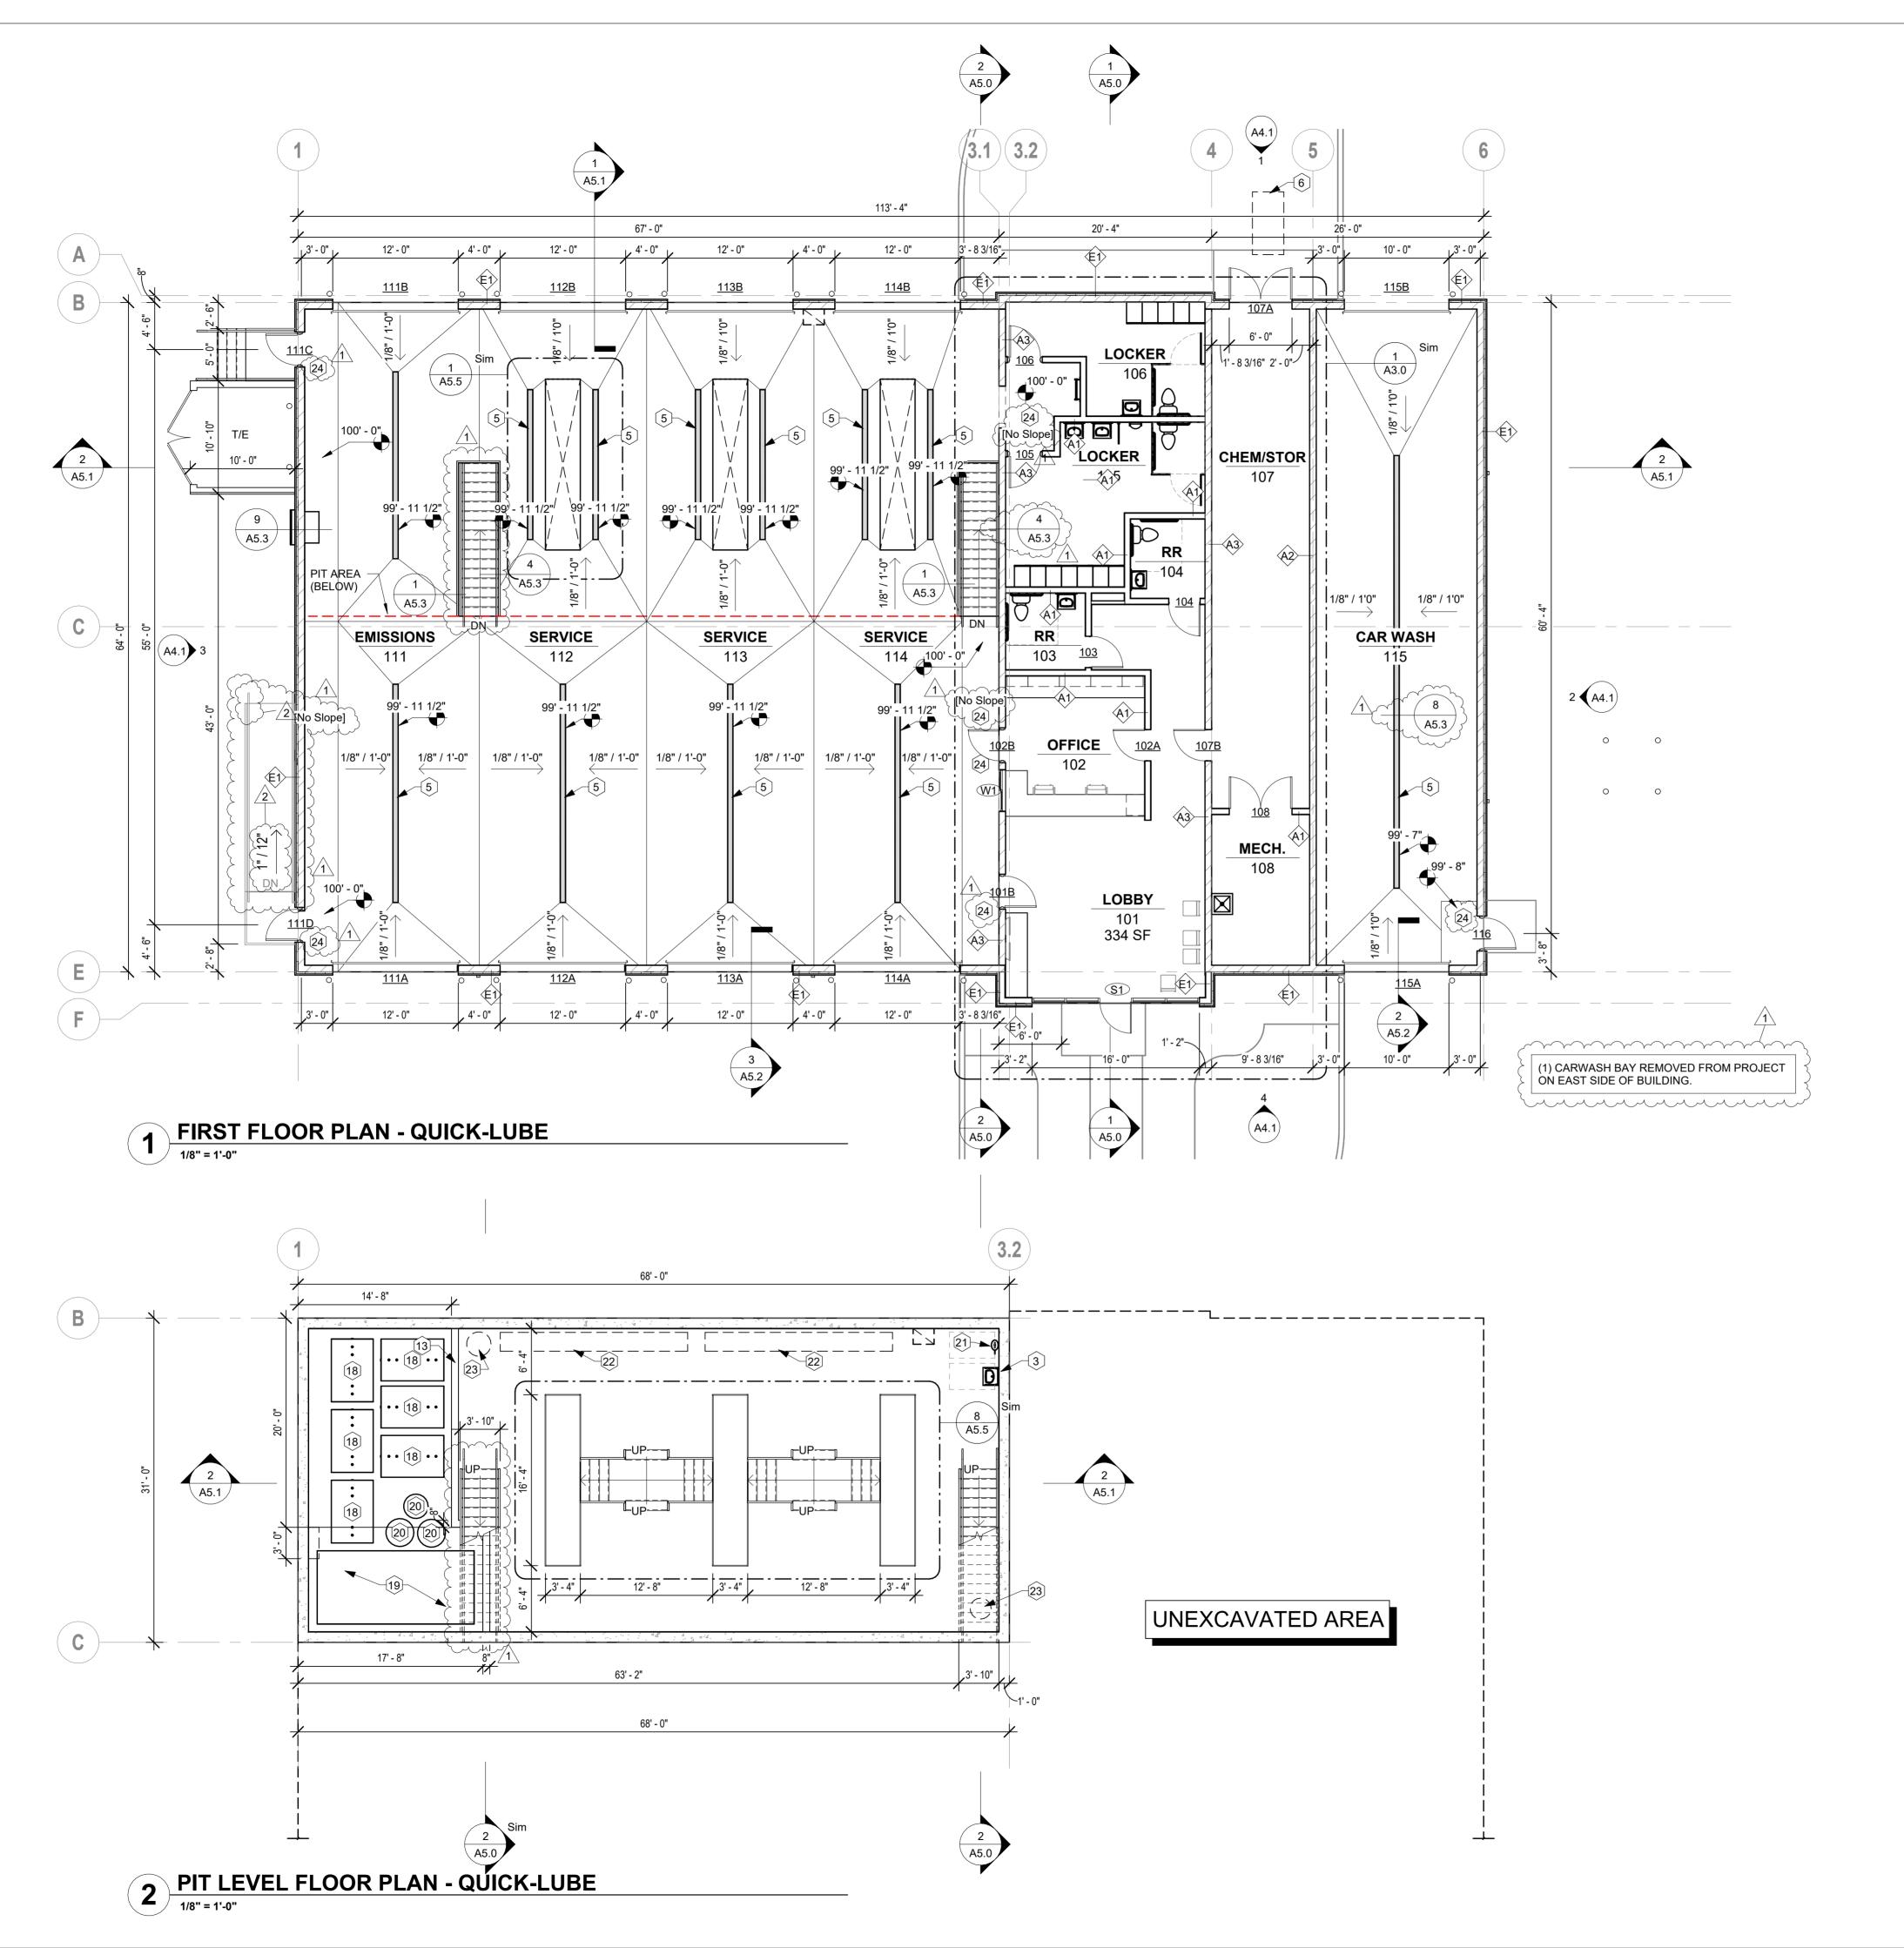
DEALERSHIP, QUICK-LUBE & CAR **WASH** 

SHEBOYGAN, WI PROJECT MANAGER:
KYLE JAMISON

11.08.2022

AC1.2

1 ARCHITECTURAL SITE PLAN
1" = 20'-0"



## GENERAL NOTES - FLOOR PLANS

- ALL DIMENSIONS FROM FACE OF STUD UNLESS CLEARLY NOTED
- ALL INTERIOR WALL TYPES TO BE WALL TYPE 'A1' UNLESS
- OTHERWISE NOTED. WALL TYPES LISTED ON SHEET T1.3. C. FLOOR FINISH TRANSITIONS TO BE 1/4" MAX. BETWEEN FINISH
- VERIFY ALL APPLIANCE DIMENSIONS PRIOR TO CONSTRUCTION.
- REPORT ANY DISCREPANCIES TO ARCHITECT IMMEDIATELY. PROVIDE WATER-RESISTANT GYP. BD. AT ALL BATHROOM WALL SURFACES UNLESS CLEARLY NOTED OTHERWISE. MAINTAIN FIRE-
- RESISTANCE RATING, WHERE REQ'D. CAULK PERIMETER OF ALL BACKSPLASHES. CAULK JOINT TO BE CLEAR OR MATCH COLOR OF ADJ. WALL FINISH.
- SEE SHEET A7.1 FOR DOOR/WINDOW/FRAME ELEVATIONS, DOOR SCHEDULE AND WINDOW SCHEDULE.
- SEE ROOM FINISH SCHEDULE ON SHEET A7.1 FOR ALL INTERIOR
- FINISHES TO BE PROVIDED. MOVABLE FURNITURE SHOWN AS REFERENCE ONLY (NOT IN
- PROVIDE CORNER GUARDS AT ALL INTERIOR OUTSIDE-CORNER APPLICATIONS EQUAL TO OR GREATER THAN 90 DEGREES.

### KEYNOTES - FLOOR PLANS

- CAR WASH EQUIPMENT, SEE SUPPLIER DRAWINGS. UNDER-COUNTER BEVERAGE FRIDGE FOR COMPLIMENTARY BOTTLED WATER IN LOBBY, PROVIDED BY OWNER. COFFEE STATION.
  - ACCESSIBLE GRAB BARS, SEE ADA REQUIREMENTS FOR MOUNTING HEIGHTS REQUIRED.
  - TRENCH DRAIN (SEE MECH).
  - OIL/SAND SEPARATOR (SEE MECH). LOCKERS PROVIDED BY OWNER, INSTALLED BY G.C.
  - WALL-MOUNTED FLAT SCREEN TV MONITOR BY OWNER, MOUNT @
  - DESIGNATED BUILDING FIRE SPRINKLER RISER LOCATION (SEE
  - 10. ELECTRICAL PANEL LOCATION (SEE ELEC).
  - 11. FACP (SEE ELEC). 12. 24" x 24" MOP SINK (SEE MECH).
  - 13. PARTIAL HEIGHT WALL.
  - 14. WATER HEATER LOCATION (SEE MECH). ROOF HATCH AND LADDER LOCATION.
  - 16. WALL-MOUNTED FLAT SCREEN TV MONITOR BY OWNER, MOUNT @ 6'-0" AFF
  - 17. 42"H GUARDRAIL.
  - 18. METAL FRESH-PRODUCT STORAGE TANKS, TO BE PLACED PRIOR TO INSTALLATION OF CORE-FLOOR ABOVE. PROVIDED AND
  - INSTALLED BY AUTOMOTIVE EQUIPMENT CONTRACTOR. 19. METAL WASTE-OIL STORAGE TANK, TO BE PLACED PRIOR TO
  - INSTALLATION OF CORE-FLOOR ABOVE, PROVIDED AND INSTALLED BY AUTOMOTIVE EQUIPMENT CONTRACTOR. 20. POLY STORAGE TANKS FOR WASHER FLUID, DEF, & ANTIFREEZE, PROVIDED AND INSTALLED BY AUTOMOTIVE EQUIPMENT
  - CONTRACTOR. 21. EYE-WASH STATION (SEE MECH.). 22. SHELVING, PROVIDED AND INSTALLED BY AUTOMOTIVE
  - EQUIPMENT CONTRACTOR.
  - 23. SUMP PIT (SEE MECH.)
  - 24. CLEAR FLOOR SPACE AT EGRESS DOORS AND STAIR LANDINGS MUST NOT SLOPE. ADJACENT SLOPING FLOORS MAX. 1:20



INDICATES ACCESSIBLE ROOM INDICATES HEARING IMPAIRED

WALL TYPE, SEE SHEET T1.3.

ROOM, SEE ELECTRICAL.

DOOR #, SEE SHEET A7.1.

WINDOW / STOREFRONT TYPE, SEE SHEET A7.1.

DOOR APPROACH FOR ADA CLEARANCES

SHEAR WALL, SEE STRUCT.

FLOOR DRAIN, SEE MECH. FLOOR SINK, SEE MECH.

DOWNSPOUT

NOTE: NOT ALL DESIGNATIONS WILL APPEAR.



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PROJECT NO.

DA22 041

DEALERSHIP, **QUICK-LUBE & CAR WASH** 

SHEBOYGAN, WI PROJECT MANAGER:

**KYLE JAMISON** 11.08.2022

SHEET:



**FOR PERMITTING &** CONSTRUCTION




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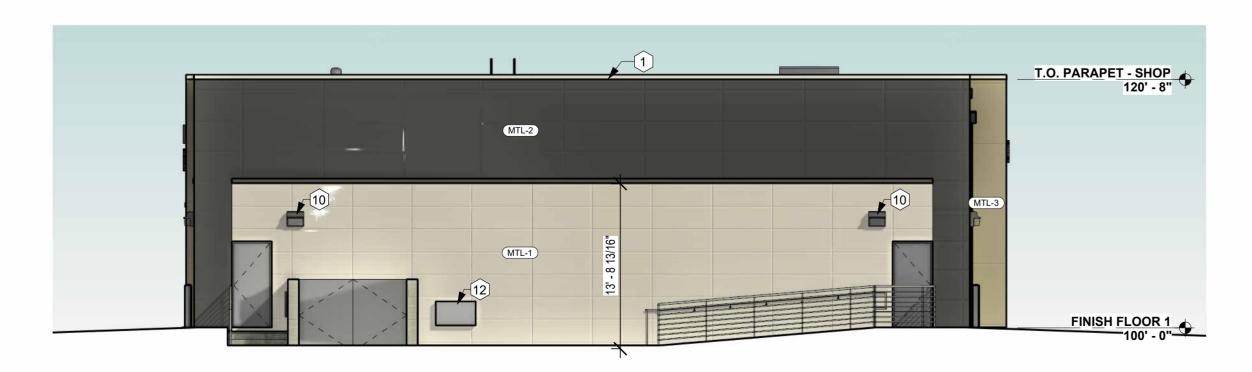
**BUILDING ELEVATION - North** 1/8" = 1'-0"



**BUILDING ELEVATION - South** 2 BUILD

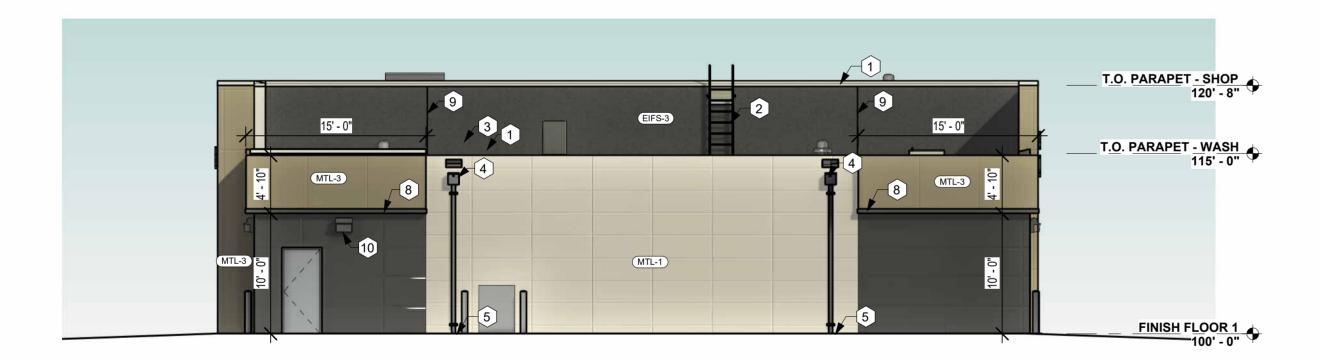

3 BUILDING ELEVATION - East
1/8" = 1'-0"



4 BUILDING ELEVATION - West

1/8" = 1'-0"

**GENERAL NOTES - BUILDING ELEVATIONS** 

A. EXTERIOR LIGHTING INDICATED FOR PLACEMENT ONLY. SEE ELEC.

FOR LIGHTING SPECIFICATIONS.

B. SEE SPECIFICATIONS FOR FULL REQUIREMENTS FOR EXTERIOR BUILDING MATERIALS. MATERIALS INDICATED GENERICALLY ON PLANS FOR CLARITY.

C. INSTALL ALL EXTERIOR BUILDING PRODUCTS PER MANUFACTURER'S RECOMMENDATIONS. REPORT ANY DISCREPANCIES TO ARCHITECT IMMEDIATELY.

## ○ KEYNOTES - BUILDING ELEVATIONS

PREFINISHED METAL PARAPET CAP FLASHING, SEE TYPICAL DETAILS.

OSHA REQUIREMENTS. VERIFY ACTUAL TRANSITION HEIGHTS IN FIELD AFTER INSULATION INSTALL. MECHANICAL ROOFTOP EQUIPMENT (SEE MECH). MIN. 8" x 16" OVERFLOW ROOF SCUPPER W/ RAIN LEADER, SLEEVE

2. ROOF TRANSITION LADDER, FABRICATOR TO DESIGN TO MEET ALL

INTO -STS- LINE PER CIVIL DRAWINGS. CONFIRM ACTUAL WALL OPENING HEIGHT IN FIELD W/ HEIGHT OF INSULATION PROVIDED. PRECAST CONC. SPLASHBLOCKS AT ALL DOWNSPOUTS UNLESS TYING DIRECTLY INTO -STS- LINE.

BUILDING PREMISES IDENTIFICATION, OWNER TO CONFIRM EXACT LOCATIONS.

7. FIRE DEPARTMENT ACCESS KEY BOX, COORDINATE EXACT LOCATION W/ LOCAL FIRE DEPT.

4" METAL TRIM BOARD.

EIFS 3/4" V-GROOVE CONTROL JOINT.

10. EXTERIOR BUILDING LIGHTING (SEE ELEC). 11. BUILDNG SIGNAGE, SHOWN ON DRAWINGS FOR LOCATION REFERENCE ONLY, DESIGN BY OTHERS, TO BE IN SEPARATE PERMITTING PACKAGE. DESIGNER TO VERIFY ALL LOCAL ZONING

SIGNAGE REQUIREMENTS. 12. PRODUCT FILLING AND WASTE OIL EMPTYING STATION.

(13. OVERFLOW ROOF DRAIN. SEE 7 / A5.4. NEW TRANSFORMER LOCATION (SEE CIVIL AND ELECTRICAL DRAWINGS).



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REV	REVISIONS:	
.ON	NO. DESCRIPTION:	DATE:
2	STATE REVIEW COMMENTS	03/02/2022

SHEET NAME:	COLOR BUILDING ELEVATIONS	FULL-SCALE: 24x36 HALF-SCALE: 12x18
		NO.
•	COLCI	١٠.

COLOR E ELEVATI	FULL-SCALE: HALF-SCALE: DRAWING MA				
ROJECT NO.  DA22_041					
DEALERSHIP, UICK-LUBE & CAR					

**QUICK-LUBE & CAR WASH** 

SHEBOYGAN, WI

PROJECT MANAGER: **KYLE JAMISON** 

11.08.2022

**EXTERIOR MATERIALS LEGEND** MATERIAL **MATERIAL DESCRIPTION** COMMENTS EIFS Finish over 1-1/2" insulation, STO 800 Series, MATCH MRL-2 FINISH COLOR CMX CHAMPAGNE METALLIC Concealed Fastener ACM panel, 3" x 9" SBR DARK BRONZE Concealed Fastener ACM Panel, 2" x 6" Concealed Fastener ACM Panel, 5" x 5" METALLIC BRONZE

> **FOR PERMITTING &** CONSTRUCTION

