



ISSUED 10/31/2024 - Iss

10/31/2024 - Issued for Review 1/18/2025 - Issued for Review 2/28/2025 - Issued for Common Council 4/25/2025 - Issued for Bidding 6/4/2025 - Revised Site

6/4/2025 - Revised Site 6/17/2025 - Issued For Land Use Submittal

Jakum Site Redevelopment

Red Earth
Development


N 15th St & Luedke Ct
Sheboygan, Wisconsin

SHEET TITLE
Architectural
Site Plan

SHEET NUMBER

CAIOI

PROIECT NO.

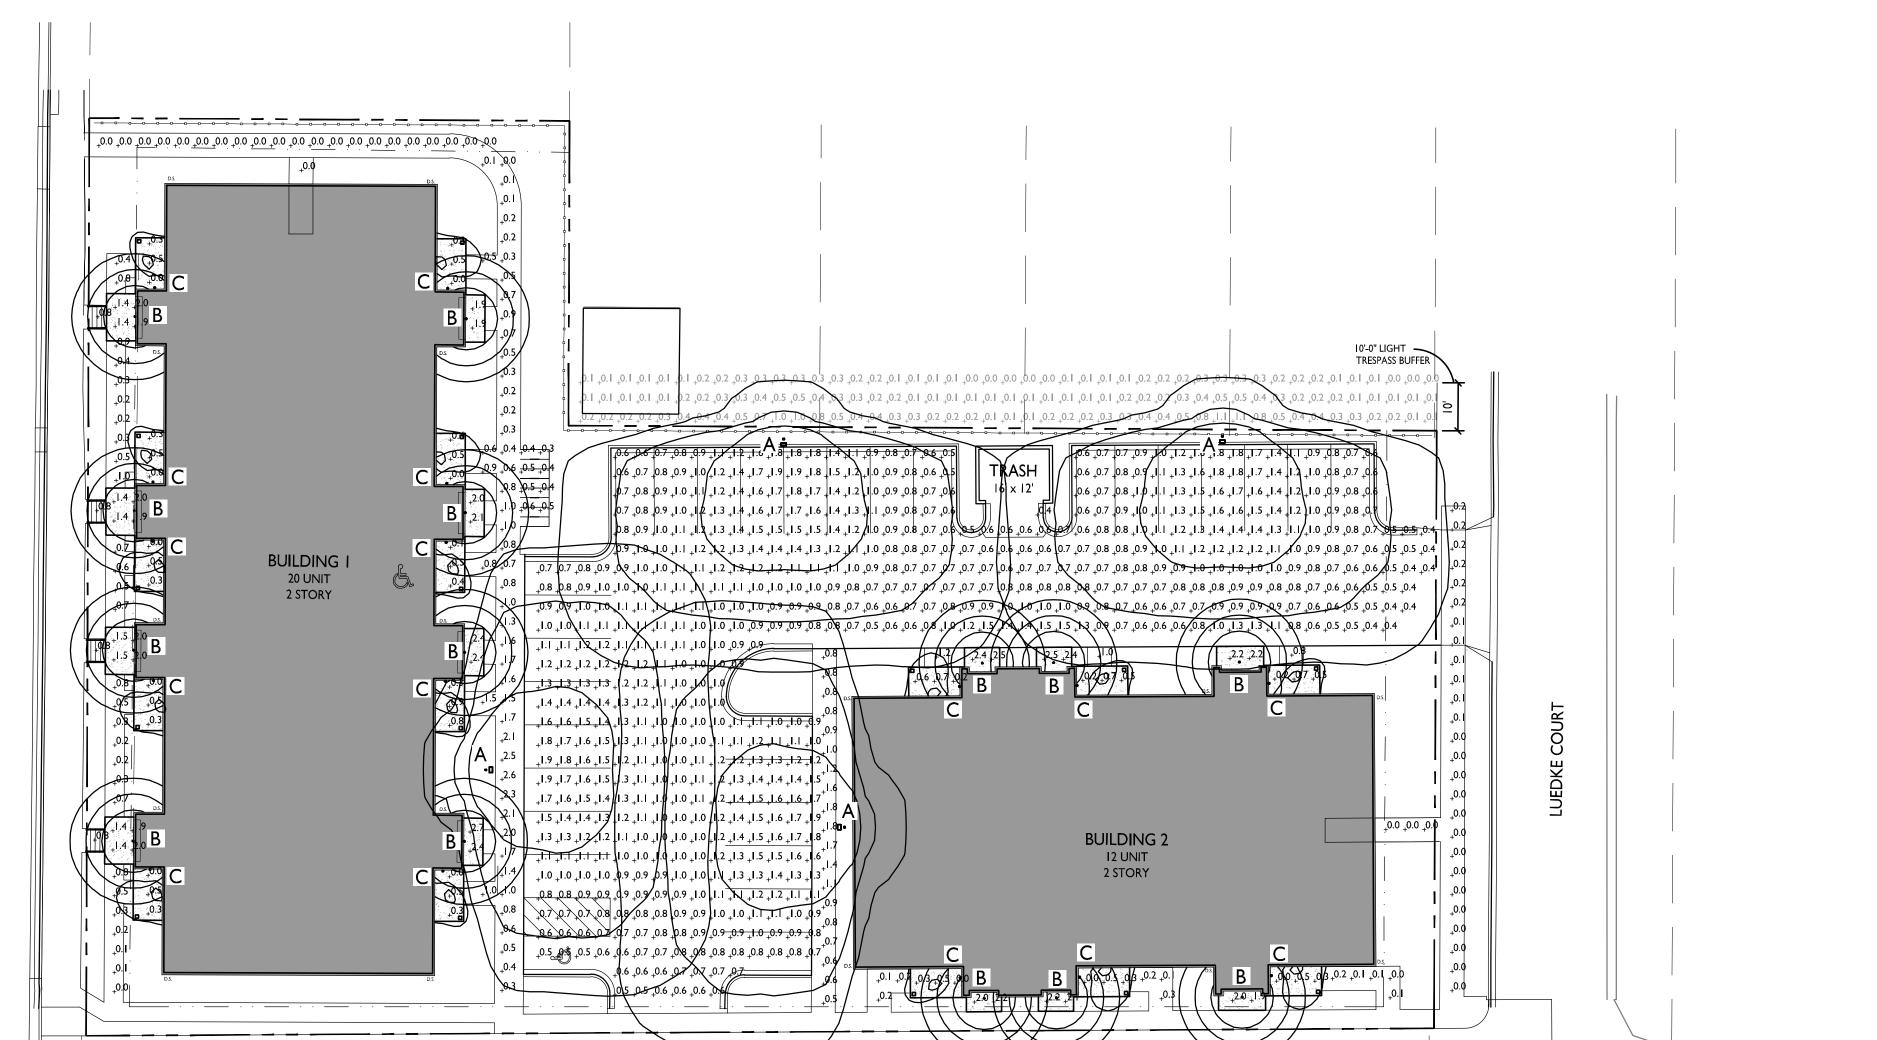

ARCHITECTS Phone: 8401 Greenway Blvd., Suite 900 608.836.3690 Middleton, WI 53562

10/31/2024 - Issued for Review 1/18/2025 - Issued for Review 2/28/2025 - Issued for Common Council 4/25/2025 - Issued for Bidding

6/4/2025 - Revised Site 6/17/2025 - Issued For Land Use Submittal

PROJECT TITLE Jakum Site Redevelopment

MAX. MIN. MAX. / MIN. AVG. / MIN.

_T4M_MVOLT_HS.ies ON 2'-0"

FILE

DSX0_LED_PI_30K

WF3_LED_30K.ies

IES-WS-W47809.ies

ISOLUX CONTOUR = 0.25 FC

ISOLUX CONTOUR = 0.5 FC

ISOLUX CONTOUR = 1.0 FC

LIGHT FIXTURE

7.7:I

3.3:1

MOUNTING

CONC. BASE

10'-0" ABOVE

GRADE ON

BUILDING

7'-0" ABOVE

GRADE ON

BUILDING

14'-0' POLE

SYMBOL AVG.

DESCRIPTION

LED PI POLE LIGHT,

3" LED ULTRA-THIN

LED WALL MOUNT

LIGHT, 3000K, 411 lumens

3000K

EXAMPLE LIGHT FIXTURE DISTRIBUTION

WAFER DOWNLIGHT,

3000K, NATURAL **ALUMINUM FINISH**

1.0 fc 2.3 fc 0.3 fc

Red Earth Development

N 15th St & Luedke Ct Sheboygan, Wisconsin SHEET TITLE

Site Lighting Plan

SHEET NUMBER

CAI02


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2427

PROJECT NO.

SITE LIGHTING PLAN

CA102

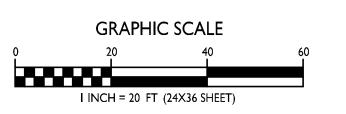

LIGHT LEVEL STATISTICS

Surfeace Parking & Drive Aisle

LUMINAIRE SCHEDULE

SYMBOL LABEL QTY. MANUF.

CATALOG

A 4 LITHONIA DSX0 LED PI 30K

14 LITHONIA WF3 LED 30K


LIGHTING


LIGHTING


LIGHTING T4M MVOLT HS

WS-W47809


DESCRIPTION

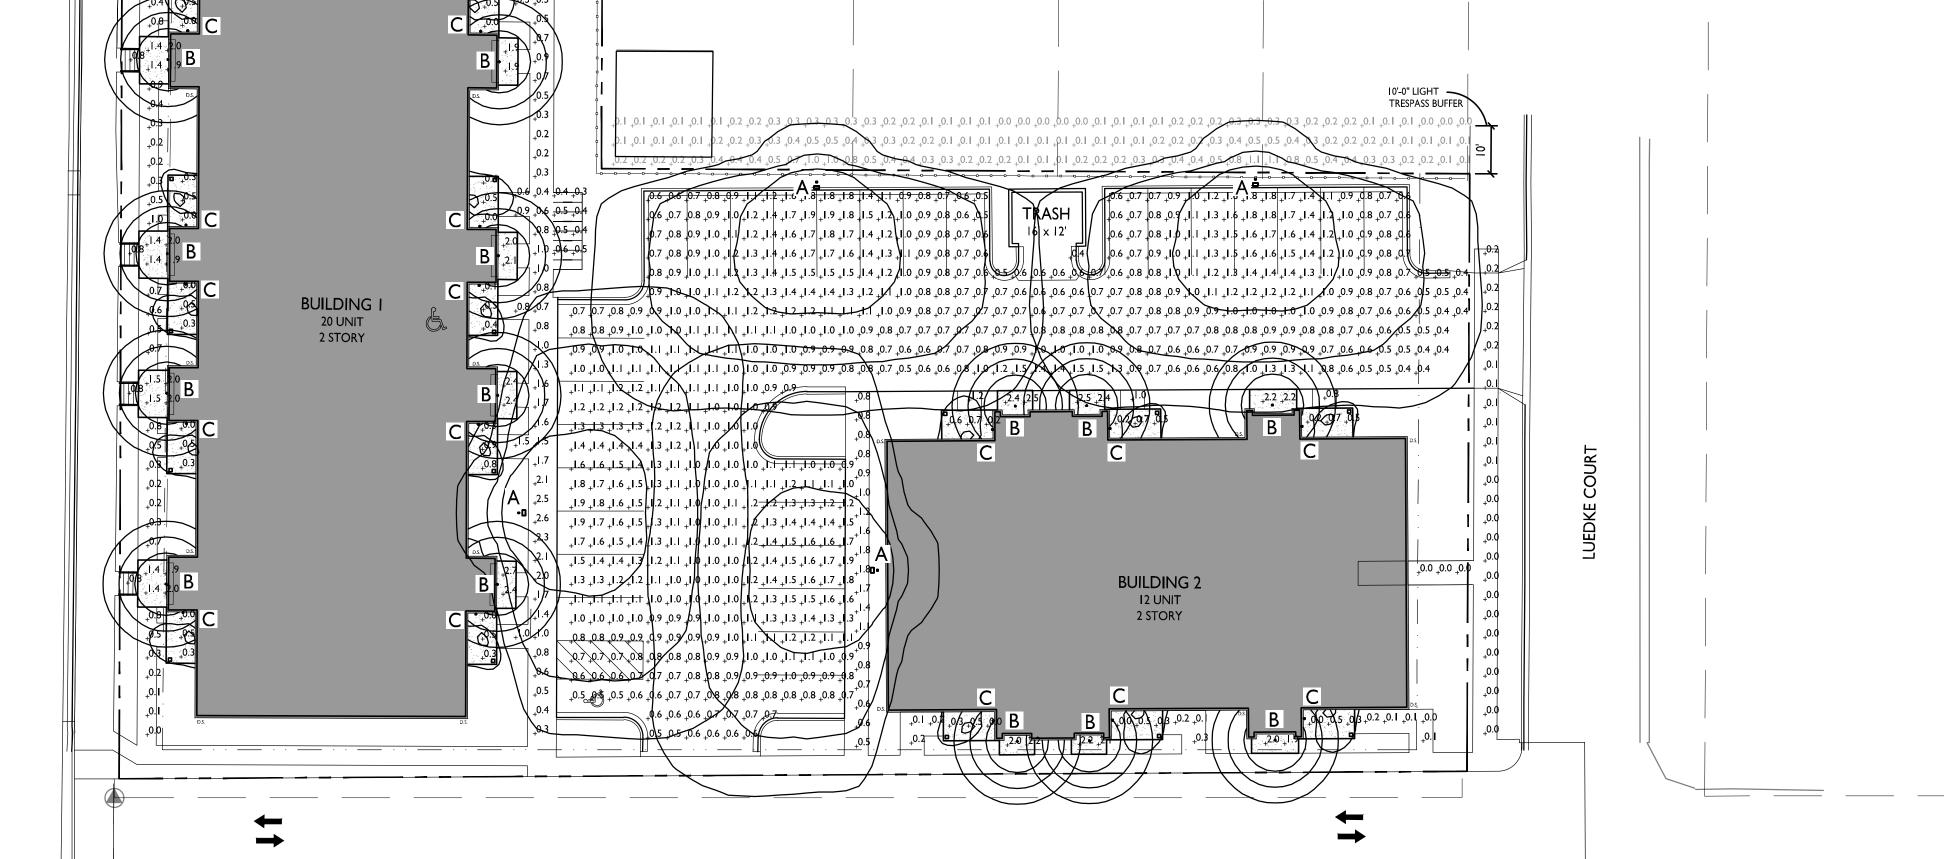

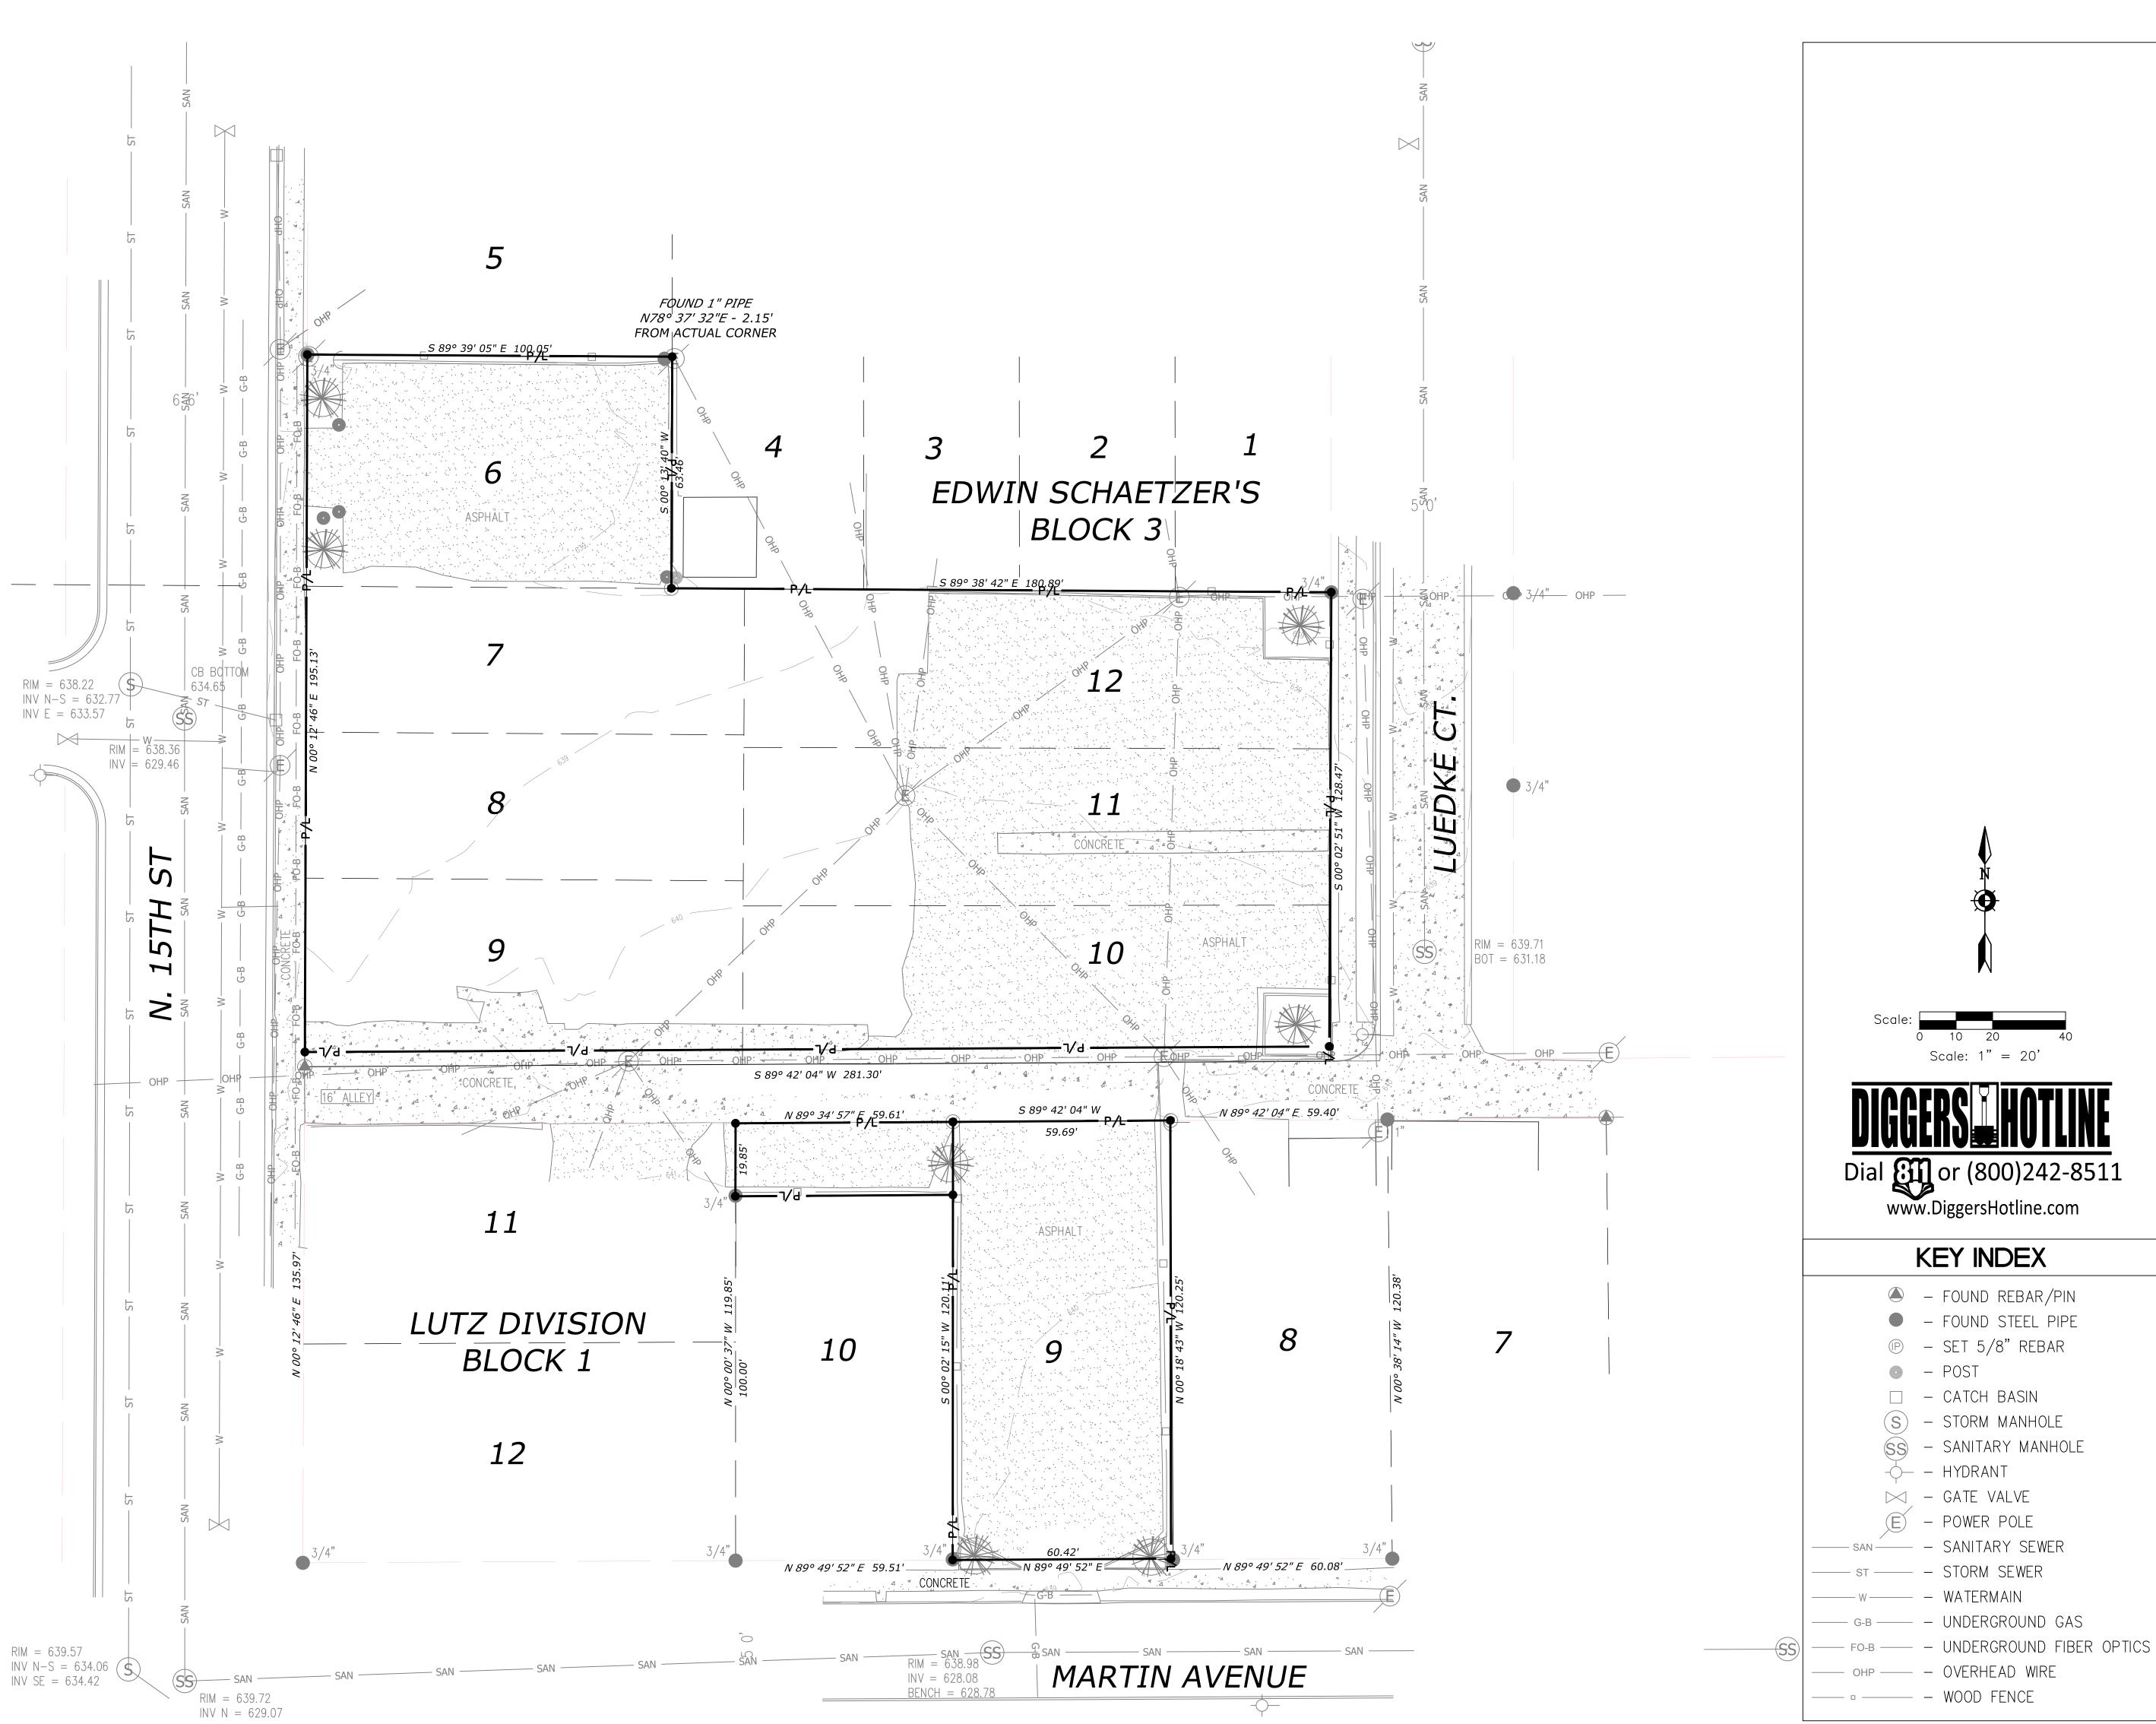

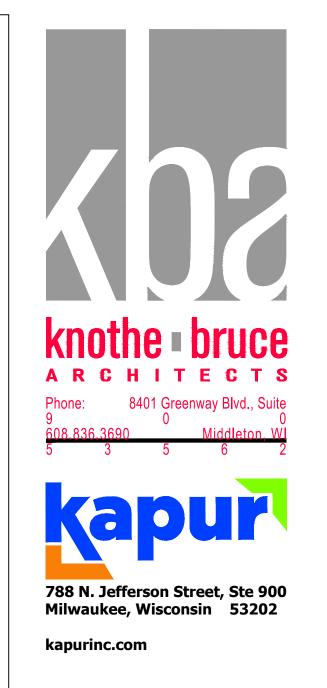

ISSUED Land Use Submittal - June 17, 2025

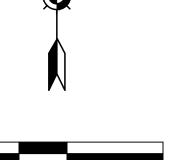

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KEY INDEX

- FOUND REBAR/PIN
- FOUND STEEL PIPE
- SET 5/8" REBAR
- □ CATCH BASIN
- STORM MANHOLE
- SANITARY MANHOLE

- POWER POLE
- san - SANITARY SEWER
- ---- STORM SEWER
- WATERMAIN
- G-B UNDERGROUND GAS

N. 15th St. & Luedke Ct. Sheboygan, Wisconsin

SHEET TITLE **EXISTING** CONDITIONS PLAN

PROJECT TITLE

Jakum Site

Red Earth

Development

Redevelopment


SHEET NUMBER

C100


PROJECT NO.

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2427



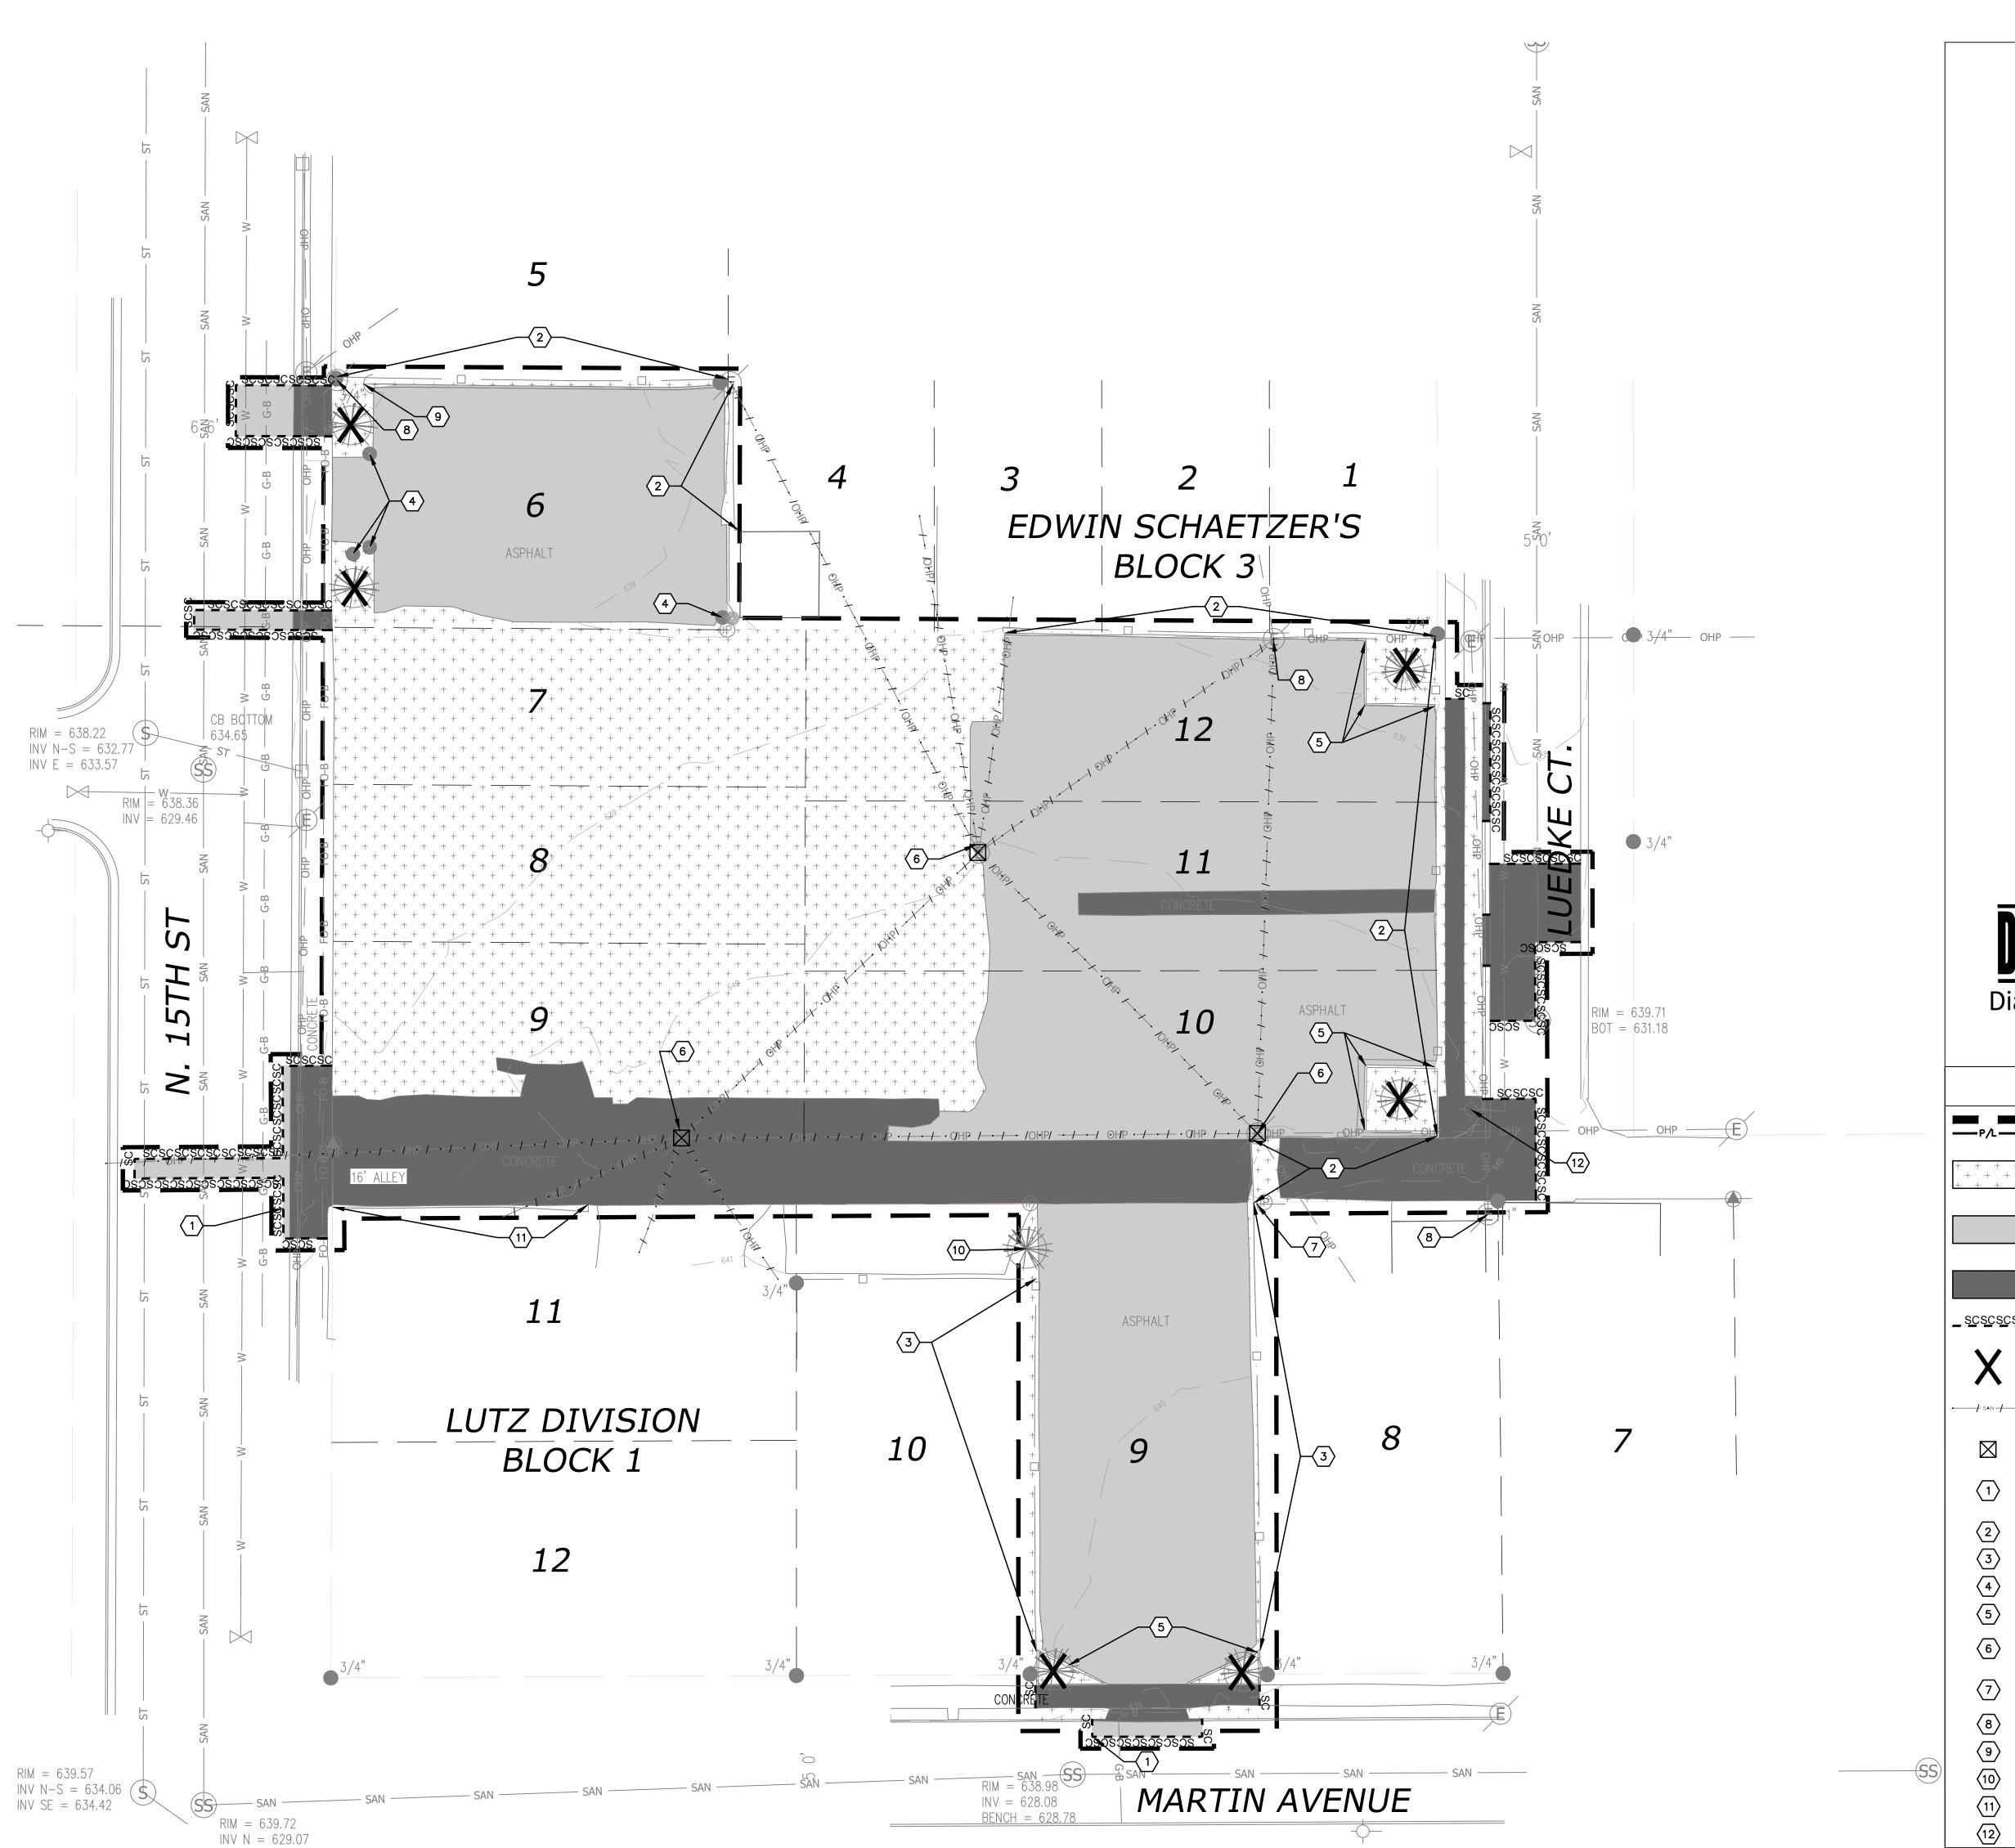


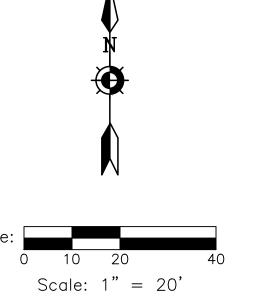

DIGGERS HOTLINE

Dial or (800)242-8511 www.DiggersHotline.com

KEY INDEX

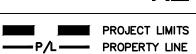

VEGETATION TO BE REMOVED & DISPOSED OF OFFSITE. IF SUITABLE FOR REUSE, TOPSOIL TO BE STOCKPILED. UNUSED & UNSUITABLE TOPSOIL TO BE REMOVED OFFSITE. TOPSOIL THICKNESS MAY VARY. REFER TO GEOTECHNICAL REPORT.

ASPHALT PAVEMENT & BASE MATERIAL TO BE REMOVED TO SUB-BASE & DISPOSED OF OFFSITE. PAVEMENT & BASE THICKNESS MAY VARY. REFER TO GEOTECHNICAL REPORT.

CONCRETE & BASE MATERIAL TO BE REMOVED TO SUB-BASE & DISPOSED OF OFFSITE. CONCRETE & BASE THICKNESS MAY VARY. REFER TO GEOTECHNICAL REPORT.

_ SCSCSCSC SAWCUT FULL DEPTH

TREES & STUMPS TO BE REMOVED

DENOTES UTILITIES TO BE ABANDONED & REMOVED.

-UTILITY STRUCTURE
REMOVAL/ABANDONMENT
SAWCUT APPROXIMATELY

SAWCUT APPROXIMATELY 2' OF ASPHALT PAVEMENT OFF THE EDGE OF THE ROADWAY TO PROVIDE A SMOOTH EDGE FOR INSTALLATION OF NEW PAVEMENT.

REMOVE & DISPOSE OF EXISTING WOOD FENCE INCLUDING POSTS & FOOTINGS.

EXISTING FENCE TO REMAIN. CONTRACTOR TO PROTECT THROUGHOUT CONSTRUCTION.

PROTECT THROUGHOUT CONSTRUCTION.

REMOVE & DISPOSE OF EXISTING POST INCLUDING FOOTING.

REMOVE & DISPOSE OF WOODEN PLANTER BEDS.

REMOVE & RELOCATE EXISTING UTILITY POLE AND OVERHEAD WIRES. CONTRACTOR TO COORDINATE REMOVAL AND RELOCATION WITH EXISTING UTILITY OWNER.

REMOVE & RELOCATE EXISTING GUY WIRE.
CONTRACTOR TO COORDINATE REMOVAL AND RELOCATION WITH EXISTING UTILITY OWNER.

EXISTING UTILITY POLE TO REMAIN. CONTRACTOR TO PROTECT THROUGHOUT CONSTRUCTION.

EXISTING GUY WIRE TO REMAIN. CONTRACTOR

EXISTING GUY WRE TO REMAIN. CONTRACTOR TO PROTECT THROUGHOUT CONSTRUCTION.

EXISTING TREE TO REMAIN. CONTRACTOR TO PROTECT THROUGHOUT CONSTRUCTION.

EXISTING CONCRETE CURB TO REMAIN. CONTRACTOR TO PROTECT THROUGHOUT CONSTRUCTION.

EXISTING HYDRANT TO REMAIN. CONTRACTOR TO PROTECT THROUGHOUT CONSTRUCTION.

PROJECT TITLE

Jakum Site

Redevelopment

ISSUED

Land Use Submittal - June 17, 2025

Red Earth Development


N. 15th St. & Luedke Ct. Sheboygan, Wisconsin


SHEET TITLE
SITE
DEMOLITION
PLAN

SHEET NUMBER

C101

PROJECT NO. 242

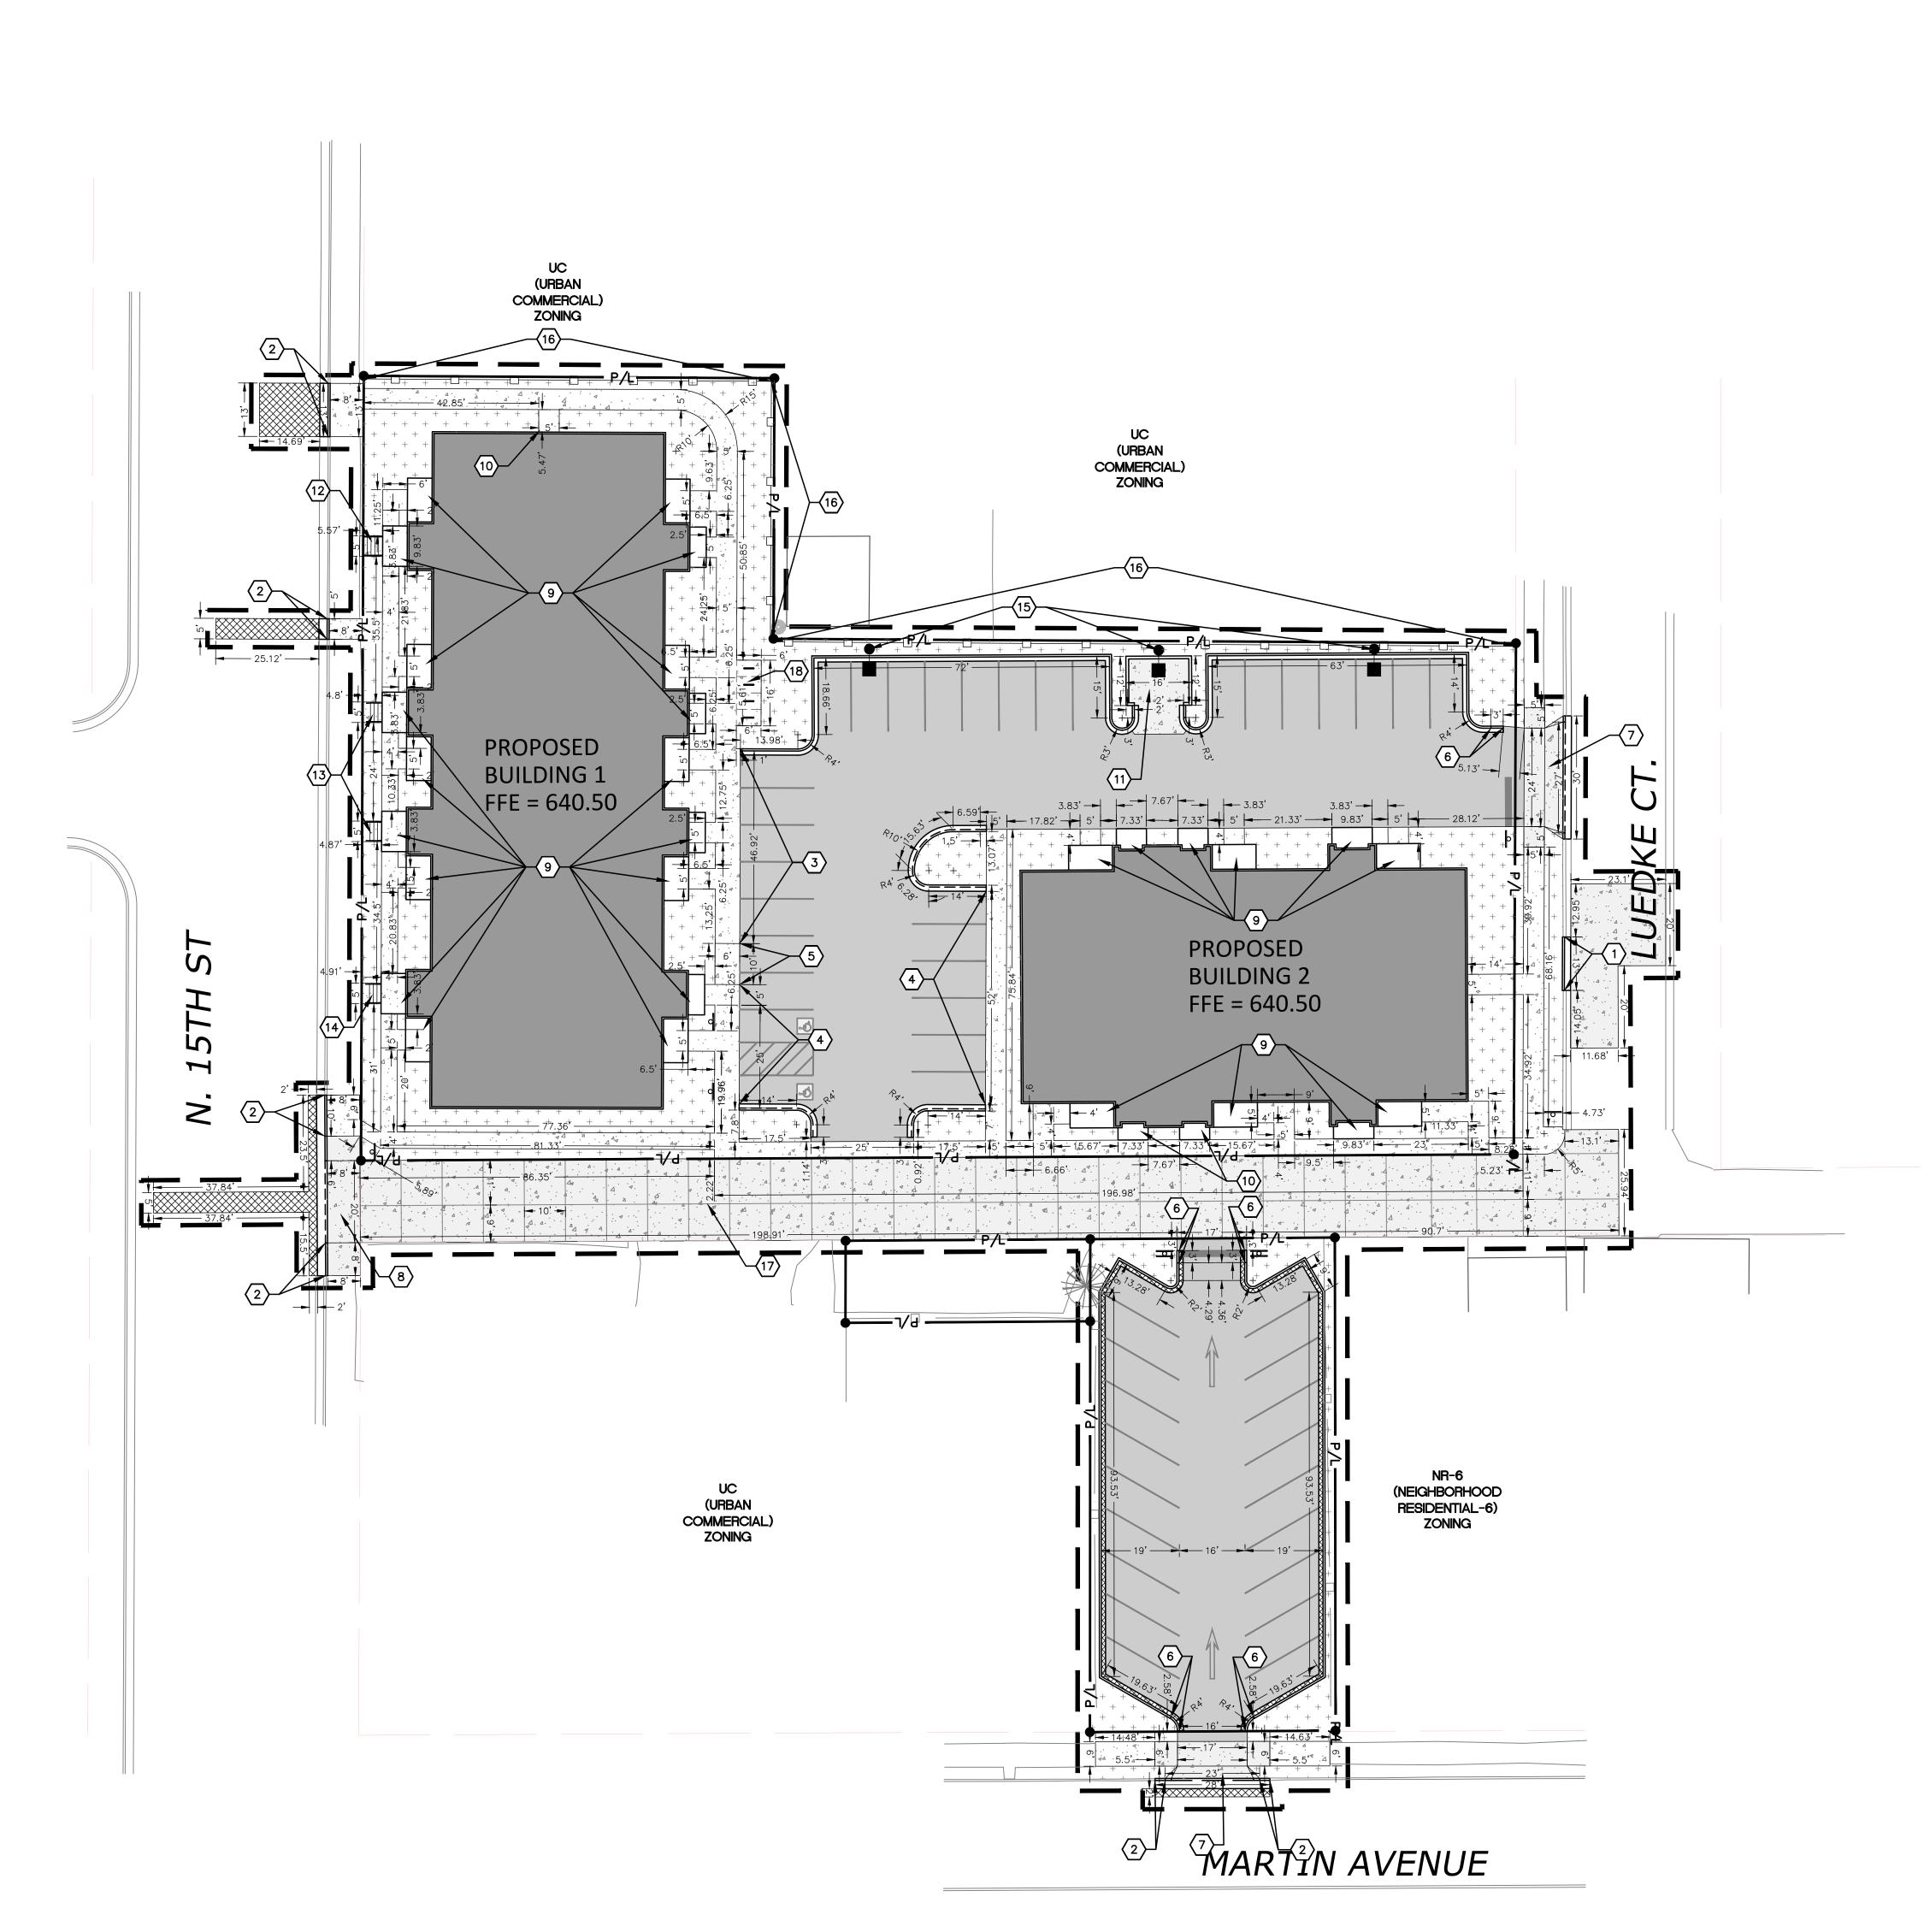

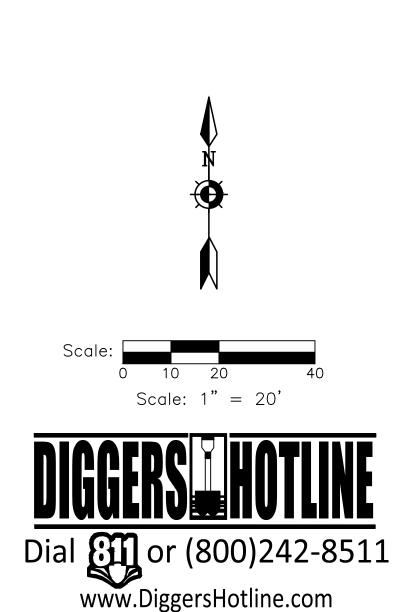

KEY INDEX

PROJECT LIMITS
PROPERTY LINE

AREAS DISTURBE
SPECIFICALLY CA
+ + + + + PLANS) TO BE R

AREAS DISTURBED BY CONSTRUCTION (NOT SPECIFICALLY CALLED OUT ON THE LANDSCAPE PLANS) TO BE RESTORED WITH MINIMUM 4" TOPSOIL, SEED, FERTILIZER, AND MULCH (TYP). USE SALVAGED TOPSOIL OR IMPORT TOPSOIL IF REQUIRED.

ASPHALTIC CONCRETE (LIGHT DUTY)


1.50" SURFACE COURSE

2.00" BINDER COURSE

8.50" AGGREGATE BASE COURSE





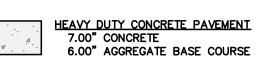

LOW-SIDE CONCRETE CURB & GUTTER
18" BARRIER UNLESS OTHERWISE NOTED

HIGH-SIDE CONCRETE CURB & GUTTER
18" BARRIER UNLESS OTHERWISE NOTED

DEPRESSED CONCRETE CURB & GUTTER
18" DEPRESSED UNLESS OTHERWISE NOTED

24" BARRIER CURB & GUTTER

2 30" BARRIER CURB & GUTTER

3 INTEGRAL CURB

DEPRESSED INTEGRAL CURB

TRANSITION FROM INTEGRAL CURB TO DEPRESSED INTEGRAL CURB

TRANSITION FROM 18" BARRIER CURB & GUTTER TO ZERO FACE CURB

CONCRETE DRIVEWAY APRON

CONCRETE DRIVEWAY APRON

9 AT GRADE STOOP

10 RAISED CONCRETE STEP

CMU DUMPSTER ENCLOSURE. REFER TO ARCHITECTURAL PLANS FOR MORE INFORMATION.

CONCRETE STEPS WITH HANDRAILS

(13) CONCRETE STEPS WITH HANDRAILS

(14) CONCRETE STEPS WITH HANDRAILS

LIGHT POLE. REFER TO ELECTRICAL DRAWINGS FOR ADDITIONAL INFORMATION.

6'-0" HIGH CEDAR PALING FENCE

ALLEY SHALL NOT BE MONOLITHIC POUR.
ALLEY SHALL BE TWO POURS WITH
CONSTRUCTION JOINT OFFSET 1' FROM
FLOWLINE TO ALLOW FOR PROPER DRAINAGE.

MADRAX "LOFTY" BIKE RACK OR APPROVED EQUAL. INSTALL PER MANUFACTURER DETAILS AND SPECIFICATIONS.



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(1) (C202)

2 C202 C202

> 4 C202 5 C202 7 C202 8 C202

> 2 C203 3 C203

(4 C203

<u>9</u> <u>C203</u>

PROJECT TITLE

Jakum Site

Redevelopment

Red Earth Development

N. 15th St. & Luedke Ct. Sheboygan, Wisconsin


SHEET TITLE
SITE LAYOUT
PLAN

SHEET NUMBER

C102

PROJECT NO.

2427

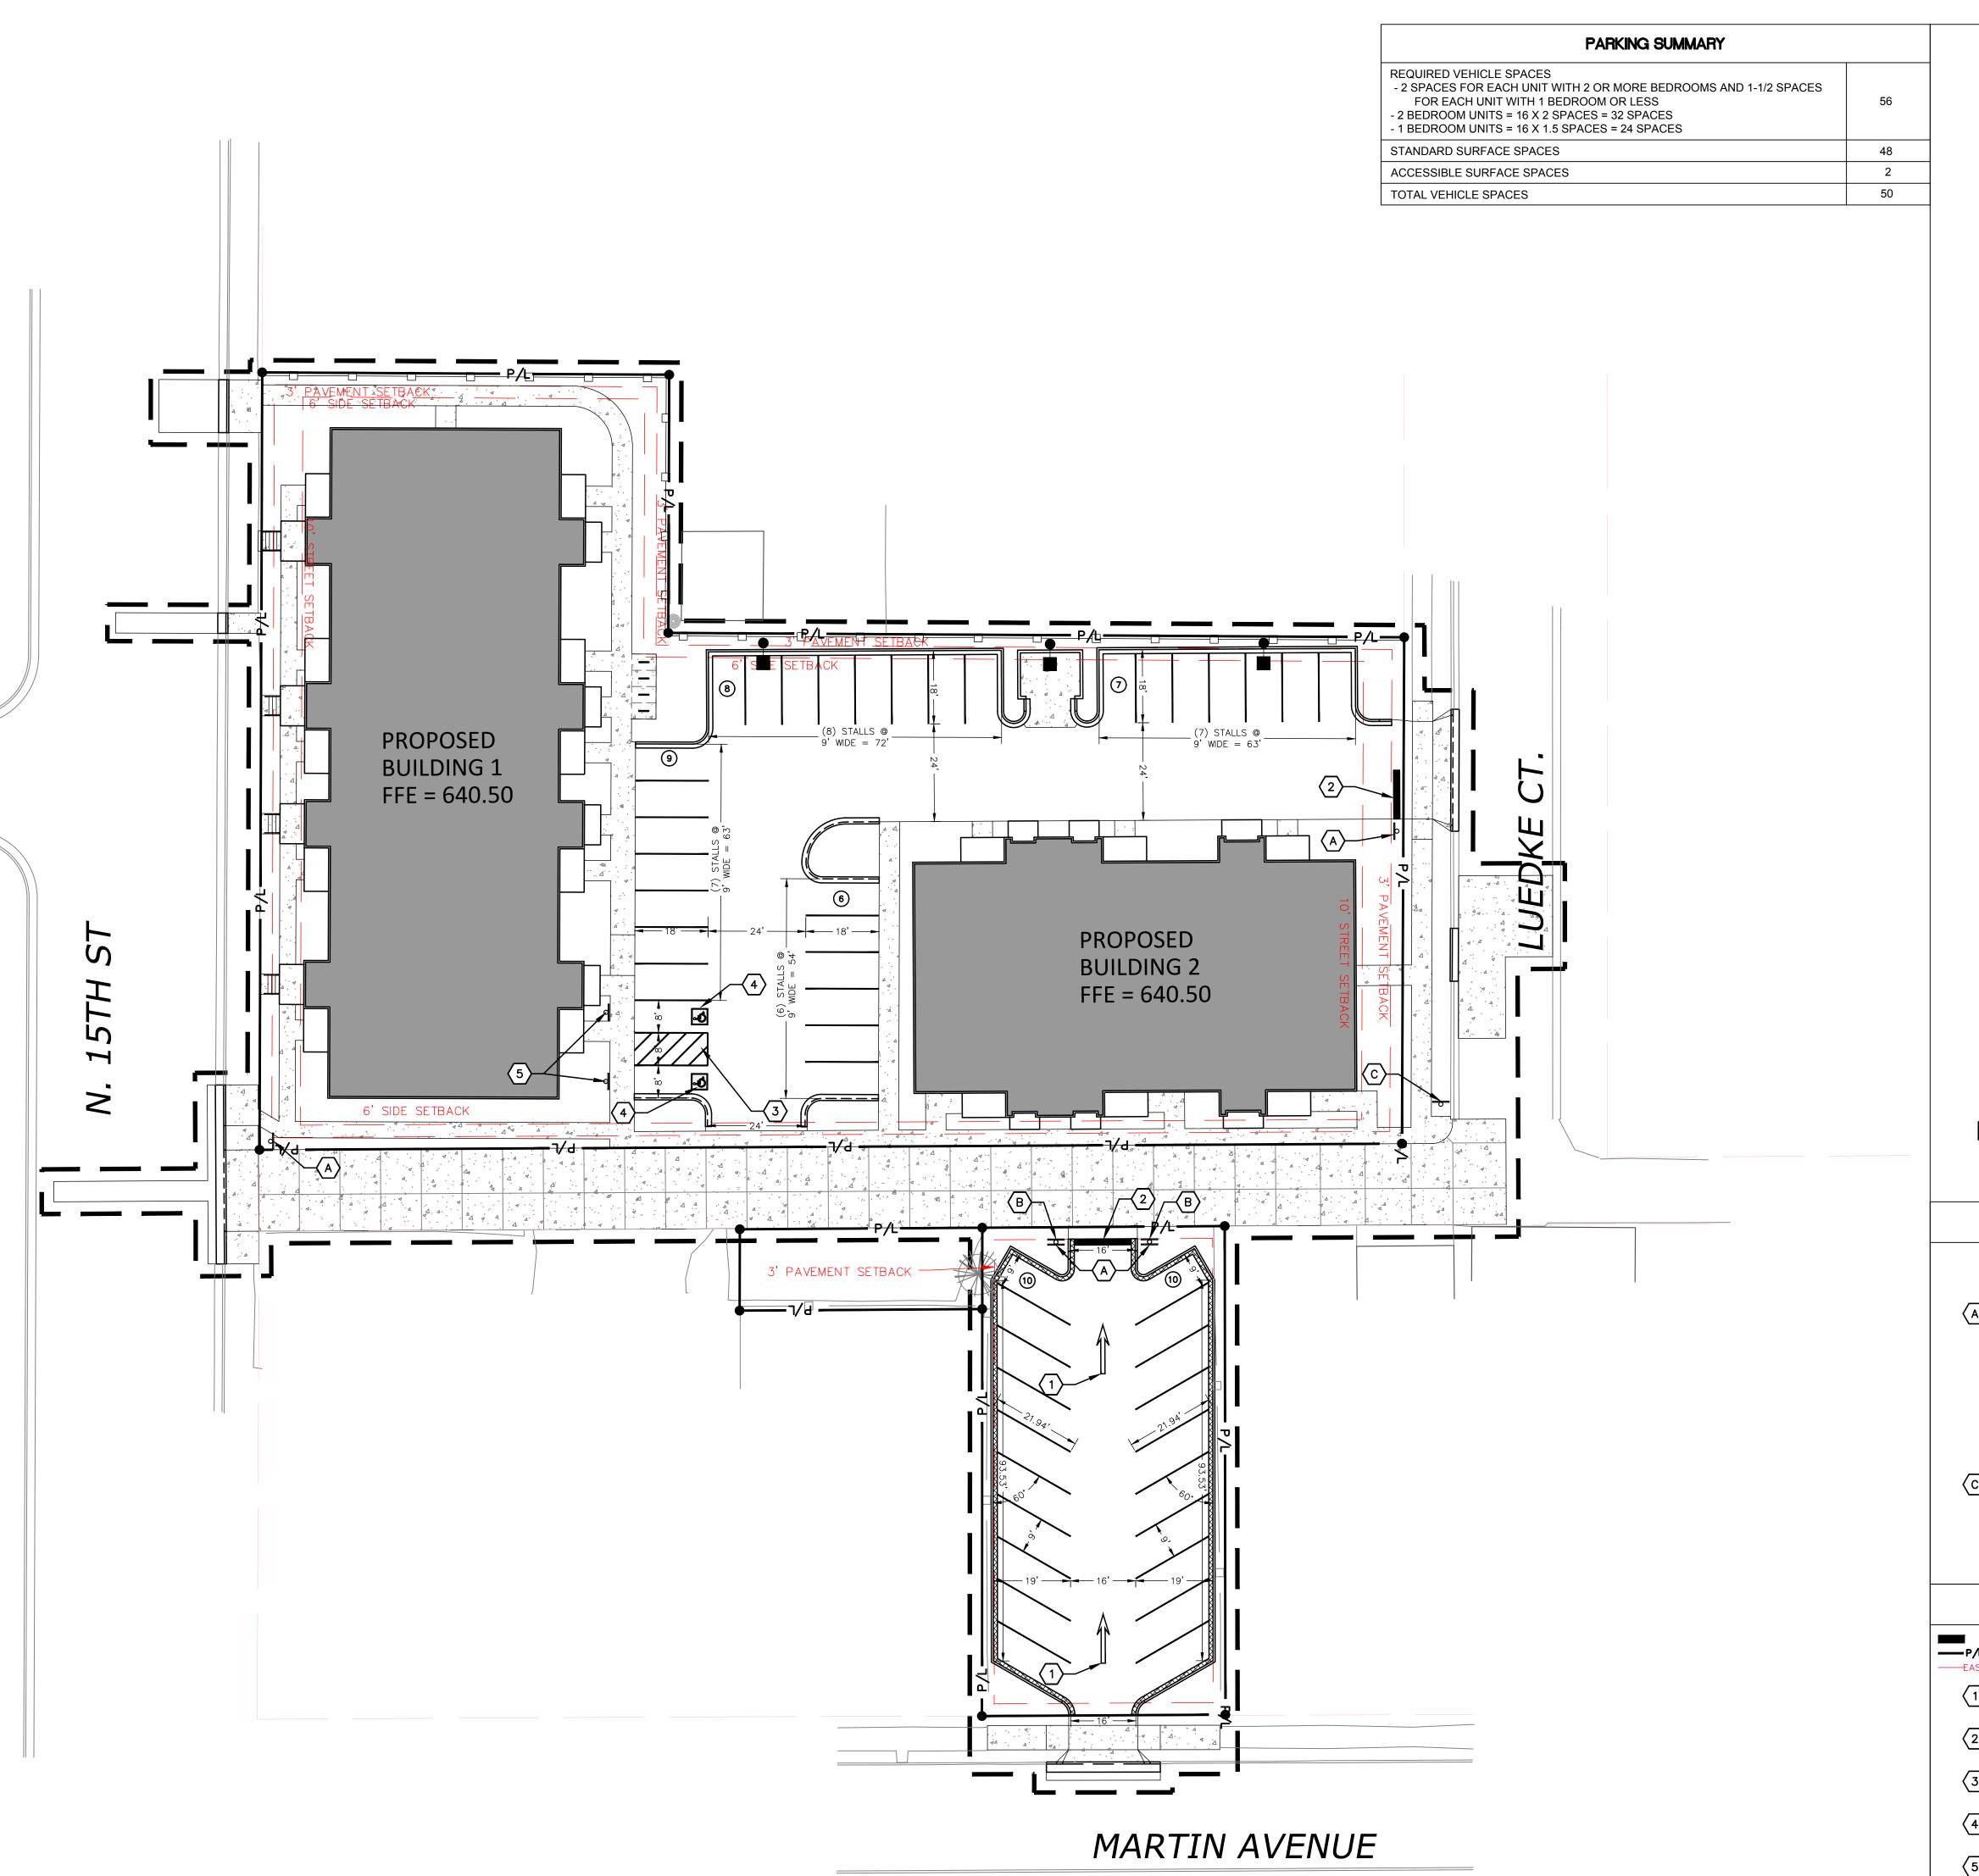



ISSUED

Land Use Submittal - June 17, 2025

PROJECT TITLE

Jakum Site

Red Earth


Development

Redevelopment

Scale: 1" = 20' Dial or (800)242-8511


SIGN INDEX

www.DiggersHotline.com

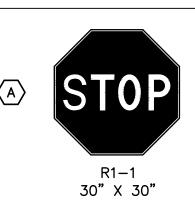

ENTER

R5-1 30" X 30"

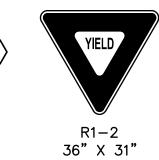

KEY INDEX

PROJECT LIMITS PROPERTY LINE EASE EASEMENT LINE

PAVEMENT MARKING ARROWS, LATEX PAVEMENT MARKING PAINT, WHITE (SEE WDOT PAVEMENT MARKING S.D.D.)

ACCESSIBLE PARKING SYMBOL

PAVEMENT MARKING STOP LINE, LATEX PAVEMENT MARKING PAINT, WHITE (SEE WDOT PAVEMENT MARKING S.D.D.)

4" WHITE PAINT 36" O.C. FOR DIAGONALS

ACCESSIBLE SIGNS

1 C203 11 C202 12 13 C202 C202

SHEET NUMBER

& TRAFFIC

C103

N. 15th St. & Luedke Ct.


Sheboygan, Wisconsin

SITE SIGNAGE

CONTROL PLAN

SHEET TITLE

PROJECT NO.

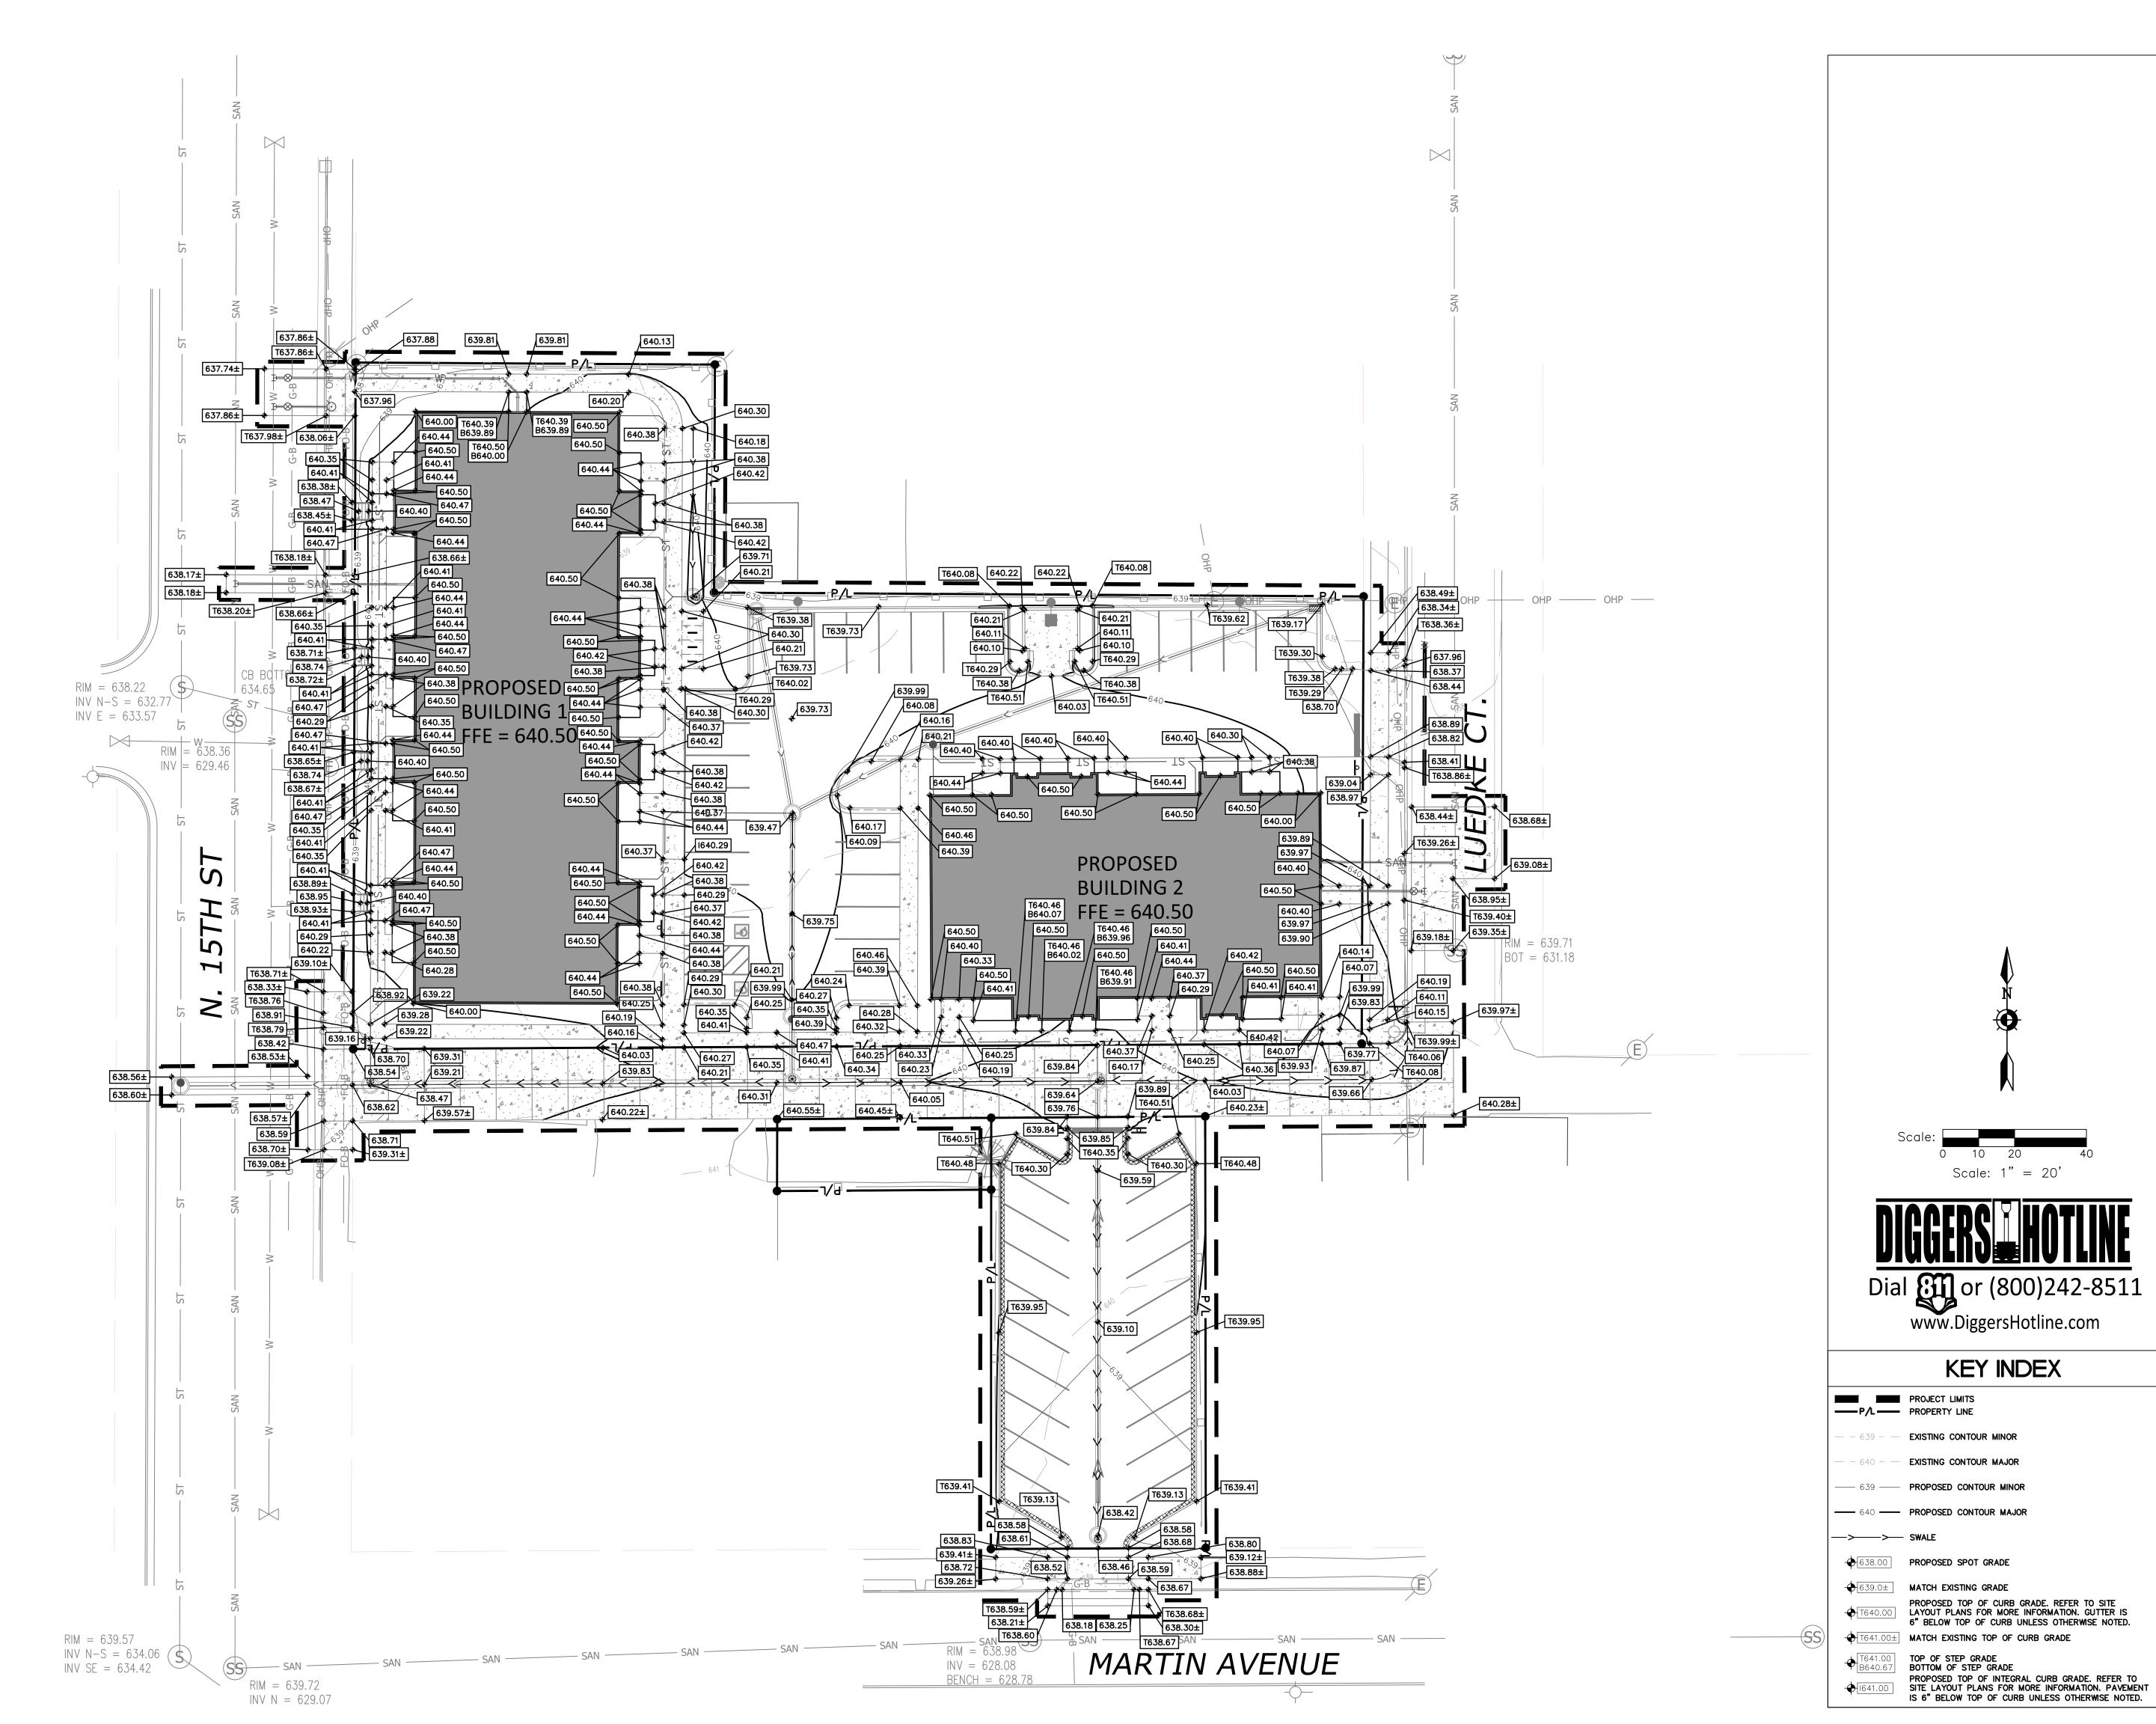



ISSUED Land Use Submittal - June 17, 2025

PROJECT TITLE Jakum Site Redevelopment

Red Earth Development


N. 15th St. & Luedke Ct. **KEY INDEX**

Sheboygan, Wisconsin SHEET TITLE SITE GRADING PLAN

SHEET NUMBER

C104

PROJECT NO.

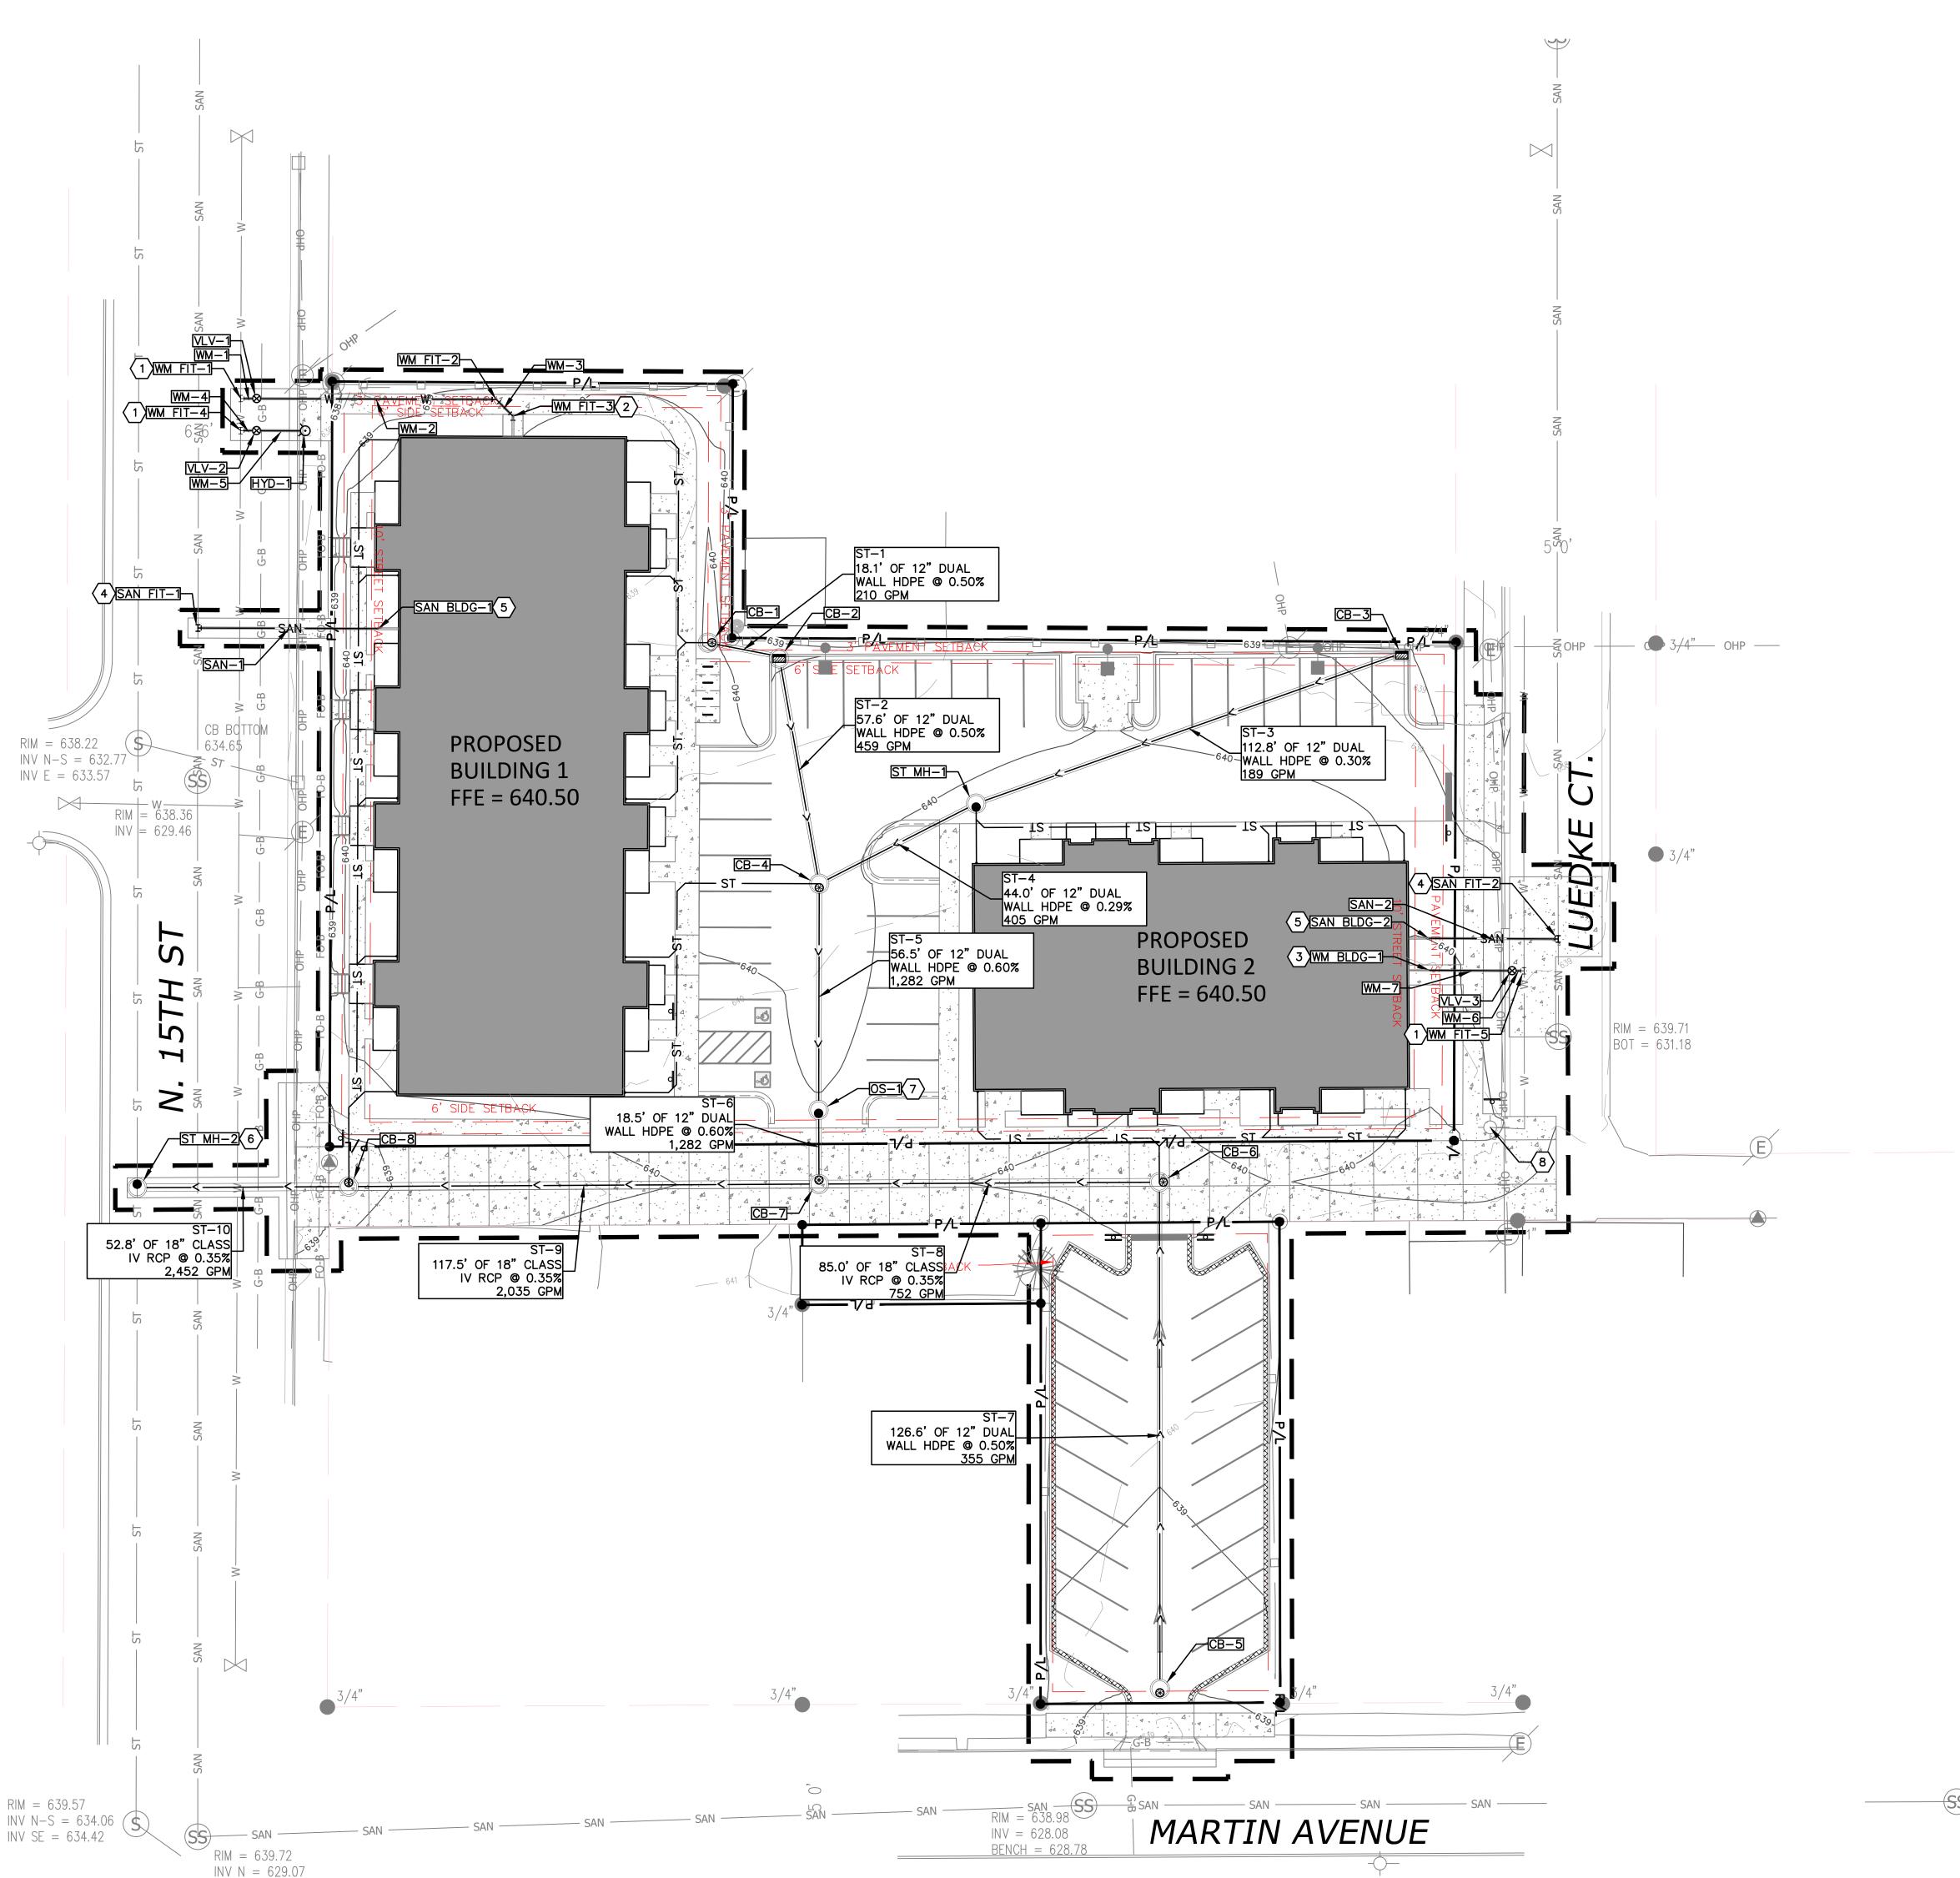



UTILITY NOTES

- KNOWN UTILITY AND POTENTIAL CONFLICT EXIST WITH EXISTING UNDERGROUND UTILITIES. PRIOR TO UTILITY INSTALLATION, CONTRACTOR TO EXCAVATE AND EXPOSE EXISTING UTILITIES, VERIFY LOCATIONS AND ELEVATIONS, AND CONTACT ENGINEER IF CONFLICTS EXIST WITH PROPOSED CONSTRUCTION AND EXISTING UNDERGROUND UTILITIES...
- 1. PER PROJECT SPECIFICATIONS AND THE STANDARD SPECIFICATIONS FOR SEWER AND WATER CONSTRUCTION IN WISCONSIN, THE POINT OF COMMENCEMENT FOR THE LAYING OF SEWER PIPE SHALL BE AT THE LOWEST POINT IN THE PROPOSED SEWER LINE. THE PIPE SHALL BE LAID WITH THE BELL END OF THE BELL AND SPIGOT PIPE, OR WITH THE RECEIVING GROOVE FIND OF THE TONGUE AND GROOVE PIPE POINTING LIPCRADE. WHEN A NEW END OF THE TONGUE AND GROOVE PIPE, POINTING UPGRADE. WHEN A NEW SEWER IS TO BE CONNECTED TO AN EXISTING SEWER NOT TERMINATING IN A MANHOLE, THE CONTRACTOR SHALL UNCOVER THE EXISTING SEWER TO ALLOW ANY ADJUSTMENTS IN LINE AND GRADE TO BE MADE BEFORE PIPE IS LAID.
- 2. THE UNDERGROUND AND OVERHEAD UTILITY INFORMATION AS SHOWN HEREON IS BASED, IN PART, UPON INFORMATION FURNISHED BY UTILITY COMPANIES, LOCAL MUNICIPALITY, PROPERTY OWNER, AND DIGGERS HOTLINE. WHILE THIS INFORMATION IS BELIEVED TO BE RELIABLE, ITS ACCURACY AND COMPLETENESS CANNOT BE GUARANTEED NOR CERTIFIED TO.
- 5. GENERAL CONTRACTOR OR THEIR SUB CONTRACTORS SHALL APPLY FOR AND OBTAIN ALL THEIR REQUIRED PERMITS AND APPROVALS PRIOR TO THE START OF THEIR WORK. CONSULT WITH AND OBTAIN FROM ENGINEER COPIES OF ENGINEERING DESIGN APPROVAL PERMITS, INCLUDING BUT NOT LIMITED TO WDNR, STATE OR LOCAL PLUMBING, WDOT, COUNTY, AND STORM WATER
- 4. GENERAL CONTRACTOR OR THEIR SUB CONTRACTORS SHALL CONTACT DIGGER'S HOTLINE TO ALLOW THEM SUFFICIENT TIME TO LOCATE EXISTING UTILITIES PRIOR TO COMMENCEMENT OF WORK.
- 5. GENERAL CONTRACTOR OR THEIR SUB CONTRACTORS ARE RESPONSIBLE FOR COORDINATING THEIR WORK WITH ALL OTHER CONTRACTORS.
- 6. GENERAL CONTRACTOR OR THEIR SUB CONTRACTORS ARE RESPONSIBLE FOR VERIFYING OWNERSHIP OF AND COORDINATING THE DEMOLITION AND/OR RELOCATION OF ALL EXISTING UTILITIES FROM EXISTING BUILDINGS AND WITHIN THE PROJECT LIMITS, INCLUDING BUT NOT LIMITED TO ELECTRICAL/FIBER OPTIC/TELEPHONE/CABLE/GAS/WATER/SANITARY/STORM. DEMOLITION OF THIS UTILITY WORK MUST BE IN ACCORDANCE WITH ALL STATE, FEDERAL, & LOCAL REGULATIONS.
- . FOR ALL WORK, GENERAL CONTRACTOR OR THEIR SUB CONTRACTORS ARE RESPONSIBLE FOR REVIEWING BID DOCUMENTS, VERIFYING THE VERTICAL AND HORIZONTAL LOCATION OF ALL EXISTING UTILITIES WITHIN THE PROJECT LIMITS, AND INCLUDE IN THEIR CONTRACT THE RELOCATION OF SAID UTILITIES (NOTED OR NOT ON THE BID DOCUMENTS) AS NECESSARY TO PROVIDE PROPER DEPTH/CLEARANCE PER UTILITY OWNER'S REQUIREMENTS.

KEY INDEX

PROJECT LIMITS P/L PROPERTY LINE 1 C204 4 C204 5 C204 6 C204 STORM MANHOLE 2' X 3' RECTANGULAR CATCH BASIN WITH CURB BOX FRAME & GRATE ROUND FRAME & GRATE STORM CATCH BASIN WITH CURB BOX FRAME & GRATE WATER MAIN TEE WATER MAIN VALVE HYDRANT ST STORM SEWER SAN SANITARY SEWER WATER MAIN

- SITE UTILITY CONTRACTOR TO CONNECT TO EXISTING WATER MAIN PER STANDARD SPECIFICATIONS FOR SEWER AND WATER CONSTRUCTION IN WISCONSIN AND CITY OF SHEBOYGAN SPECIFICATIONS. CONTRACTOR VERIFY EXISTING WATER MAIN SIZE AND DEPTH IN FIELD PRIOR TO CONSTRUCTION.
- SITE UTILITY CONTRACTOR TO PROVIDE CONTINUATION OF 6" WATER LATERAL TO WM FIT-3 FROM BUILDING. CONTRACTOR TO FIELD VERIFY LOCATION AND INVERT IN FIELD.
- SITE UTILITY CONTRACTOR TO PROVIDE CONTINUATION OF 6" WATER 5' FROM BUILDING. CONTRACTOR TO FIELD VERIFY LOCATION AND
- SITE UTILITY CONTRACTOR TO CONNECT TO EXISTING SANITARY SEWER WITH 8" X 6" TEE. CONTRACTOR TO VERIFY EXISTING SANITARY SEWER SIZE AND INVERT PRIOR TO CONSTRUCTION. CONTACT ENGINEER IF CONFLICTS ARISE.
 - SITE UTILITY CONTRACTOR TO PROVIDE CONTINUATION OF 6" SANITARY SEWER 5' FROM BUILDING. CONTRACTOR TO FIELD VERIFY LOCATION AND INVERT IN FIELD.
- SITE UTILITY CONTRACTOR TO INSTALL STORM STRUCTURE OVER EXISTING STORM SEWER. CONTRACTOR TO FIELD VERIFY EXACT SIZE, DEPTH, AND LOCATION OF EXISTING STORM SEWER PRIOR TO START OF CONFILER ARISES. IF CONFLICTS ARISE.
- 48" DIAMETER UPFLO FILTER MANHOLE WITH 2 FILTER MODULES.

EXISTING HYDRANT

(1 C205)

PROJECT NO.

© Knothe & Bruce Architects, LLC

PROJECT TITLE Jakum Site Redevelopment

ARCHITECTS

Phone: 8401 Greenway Blvd., Suite

788 N. Jefferson Street, Ste 900

Milwaukee, Wisconsin 53202

Land Use Submittal - June 17, 2025

kapurinc.com

ISSUED

Red Earth Development

N. 15th St. & Luedke Ct.

Sheboygan, Wisconsin SHEET TITLE SITE UTILITY

PLAN

SHEET NUMBER

C105

STORM SEWER STRUCTURE TABLE							
STRUCTURE NAME:	TYPE (FRAME AND GRATE):	RIM ELEVATION:	PIPES IN:	PIPES OUT	воттом:		
CB-1	48" DIAMETER (R-2502-D)	639.71	ST, 4" W INV = 637.00	ST-1, 12" E INV = 636.03	634.53		
CB-2	48" DIAMETER (R-3067-R)	638.88	ST-1, 12" W INV = 635.94	ST-2, 12" S INV = 635.94	634.44		
CB-3	2' X 3' RECTANGULAR (R-3067-R)	638.67	N/A	ST-3, 12" W INV = 636.12	634.62		
CB-4	48" DIAMETER (R-2502-D)	639.47	ST-2, 12" N INV = 635.65 ST-4, 12" NE INV = 635.65 ST, 4" W INV = 636.50	ST-5, 12" S INV = 635.65	633.85		
CB-5	48" DIAMETER (R-2502-D)	638.42	N/A	ST-7, 12" N INV = 635.33	633.83		
CB-6	48" DIAMETER (R-2502-D)	639.64	ST-7, 12" S INV = 634.70 ST, 6" N INV = 636.31	ST-8, 18" W INV = 634.20	632.70		
CB-7	48" DIAMETER (R-2502-D)	640.28	ST-8, 18" E INV = 633.90 ST-6, 12" N INV = 634.40	ST-9, 18" W INV = 633.90	632.40		
CB-8	48" DIAMETER (R-2502-D)	638.47	ST-9, 18" E INV = 633.49 ST, 6" N INV = 635.52	ST-10, 18" W INV = 633.49	631.99		
OS-1	48" DIAMETER UPFLO MANHOLE	640.23	ST-5, 12" N INV = 635.31	ST-6, 12" S INV = 634.51	631.51		
ST MH-1	48" DIAMETER (R-1661)	640.14	ST-3, 12" E INV = 635.78 ST, 6" S INV = 636.31	ST-4, 12" SW INV = 635.78	635.78		
ST MH-2	48" DIAMETER (R-1661)	638.63	ST-10, 18" E INV = 633.30	EX ST, 18" N INV = 633.30±	633.30		

SANITARY SEWER STRUCTURE TABLE							
STRUCTURE NAME:	TYPE (FRAME AND GRATE):	PIPES IN:	PIPES OUT				
SAN BLDG-1	N/A		SAN-1, 6" W INV = 630.54				
SAN BLDG-2	N/A		SAN-2, 6" E INV = 631.57				
SAN FIT-1	6" X 8" TEE	SAN-1, 6" E INV = 630.09 EX SAN, 8" N, INV = 629.51±	EX SAN, 8" S INV = 629.51±				
SAN FIT-2	6" X 8" TEE	SAN-2, 6" W INV = 631.25 EX SAN, 8" S INV = 630.67±	EX SAN, 8" N INV = 630.67±				

	SANITARY SEWER PIPE TABLE							
PIPE NAME:	FROM:	TO:	UPSTREAM INVERT ELEVATION:			SLOPE:	SIZE AND MATERIAL:	DFU:
SAN-1	SAN BLDG-1	SAN FIT-1	630.54	630.09	45.08'	1.00%	6" SCH 40 PVC	
SAN-2	SAN BLDG-2	SAN FIT-2	631.57	631.25	32.38'	1.00%	6" SCH 40 PVC	

WATER MAIN FITTINGS TABLE						
STRUCTURE NAME:	TYPE:	INVERT ELEVATION				
HYD-1	N/A	630.84				
VLV-1	6" GATE VALVE W/ VALVE BOX	630.79				
VLV-2	6" GATE VALVE W/ VALVE BOX	630.72				
VLV-3	6" GATE VALVE W/ VALVE BOX	632.19				
WM BLDG-1	N/A	633.22				
WM FIT-1	6" X 8" STAINLESS STEEL TAPPING SLEEVE	630.59±				
WM FIT-2	45 DEGREE HORIZONTAL BEND	633.78				
WM FIT-3	45 DEGREE HORIZONTAL BEND	633.89				
WM FIT-4	6" X 8" STAINLESS STEEL TAPPING SLEEVE	630.68±				
WM FIT-5	6" X 8" STAINLESS STEEL TAPPING SLEEVE	631.95±				

	WATER MAIN PIPE TABLE							
PIPE NAME:	FROM:	TO:	FROM INVERT ELEVATION:	TO INVERT ELEVATION:	LENGTH:	SLOPE:	SIZE AND MATERIAL:	
WM-1	WM FIT-1	VLV-1	630.59	630.79	4.00'	-5.00%	6" C900 PVC PIPE	
WM-2	VLV-1	WM FIT-2	630.79	633.78	59.85'	-5.00%	6" C900 PVC PIPE	
WM-3	WM FIT-2	WM FIT-3	633.78	633.89	5.93'	-1.85%	6" C900 PVC PIPE	
WM – 4	WM FIT-4	VLV-2	630.68	630.72	4.00'	-1.00%	6" DUCTILE IRON PIPE	
WM-5	VLV-2	HYD-1	630.72	630.84	12.19'	-1.00%	6" DUCTILE IRON PIPE	
WM-6	WM FIT-5	VLV-3	631.95	632.19	3.00'	-8.00%	6" C900 PVC PIPE	
WM-7	VLV-3	WM BLDG-1	632.19	633.22	20.67'	-5.00%	6" C900 PVC PIPE	



788 N. Jefferson Street, Ste 900 Milwaukee, Wisconsin 53202

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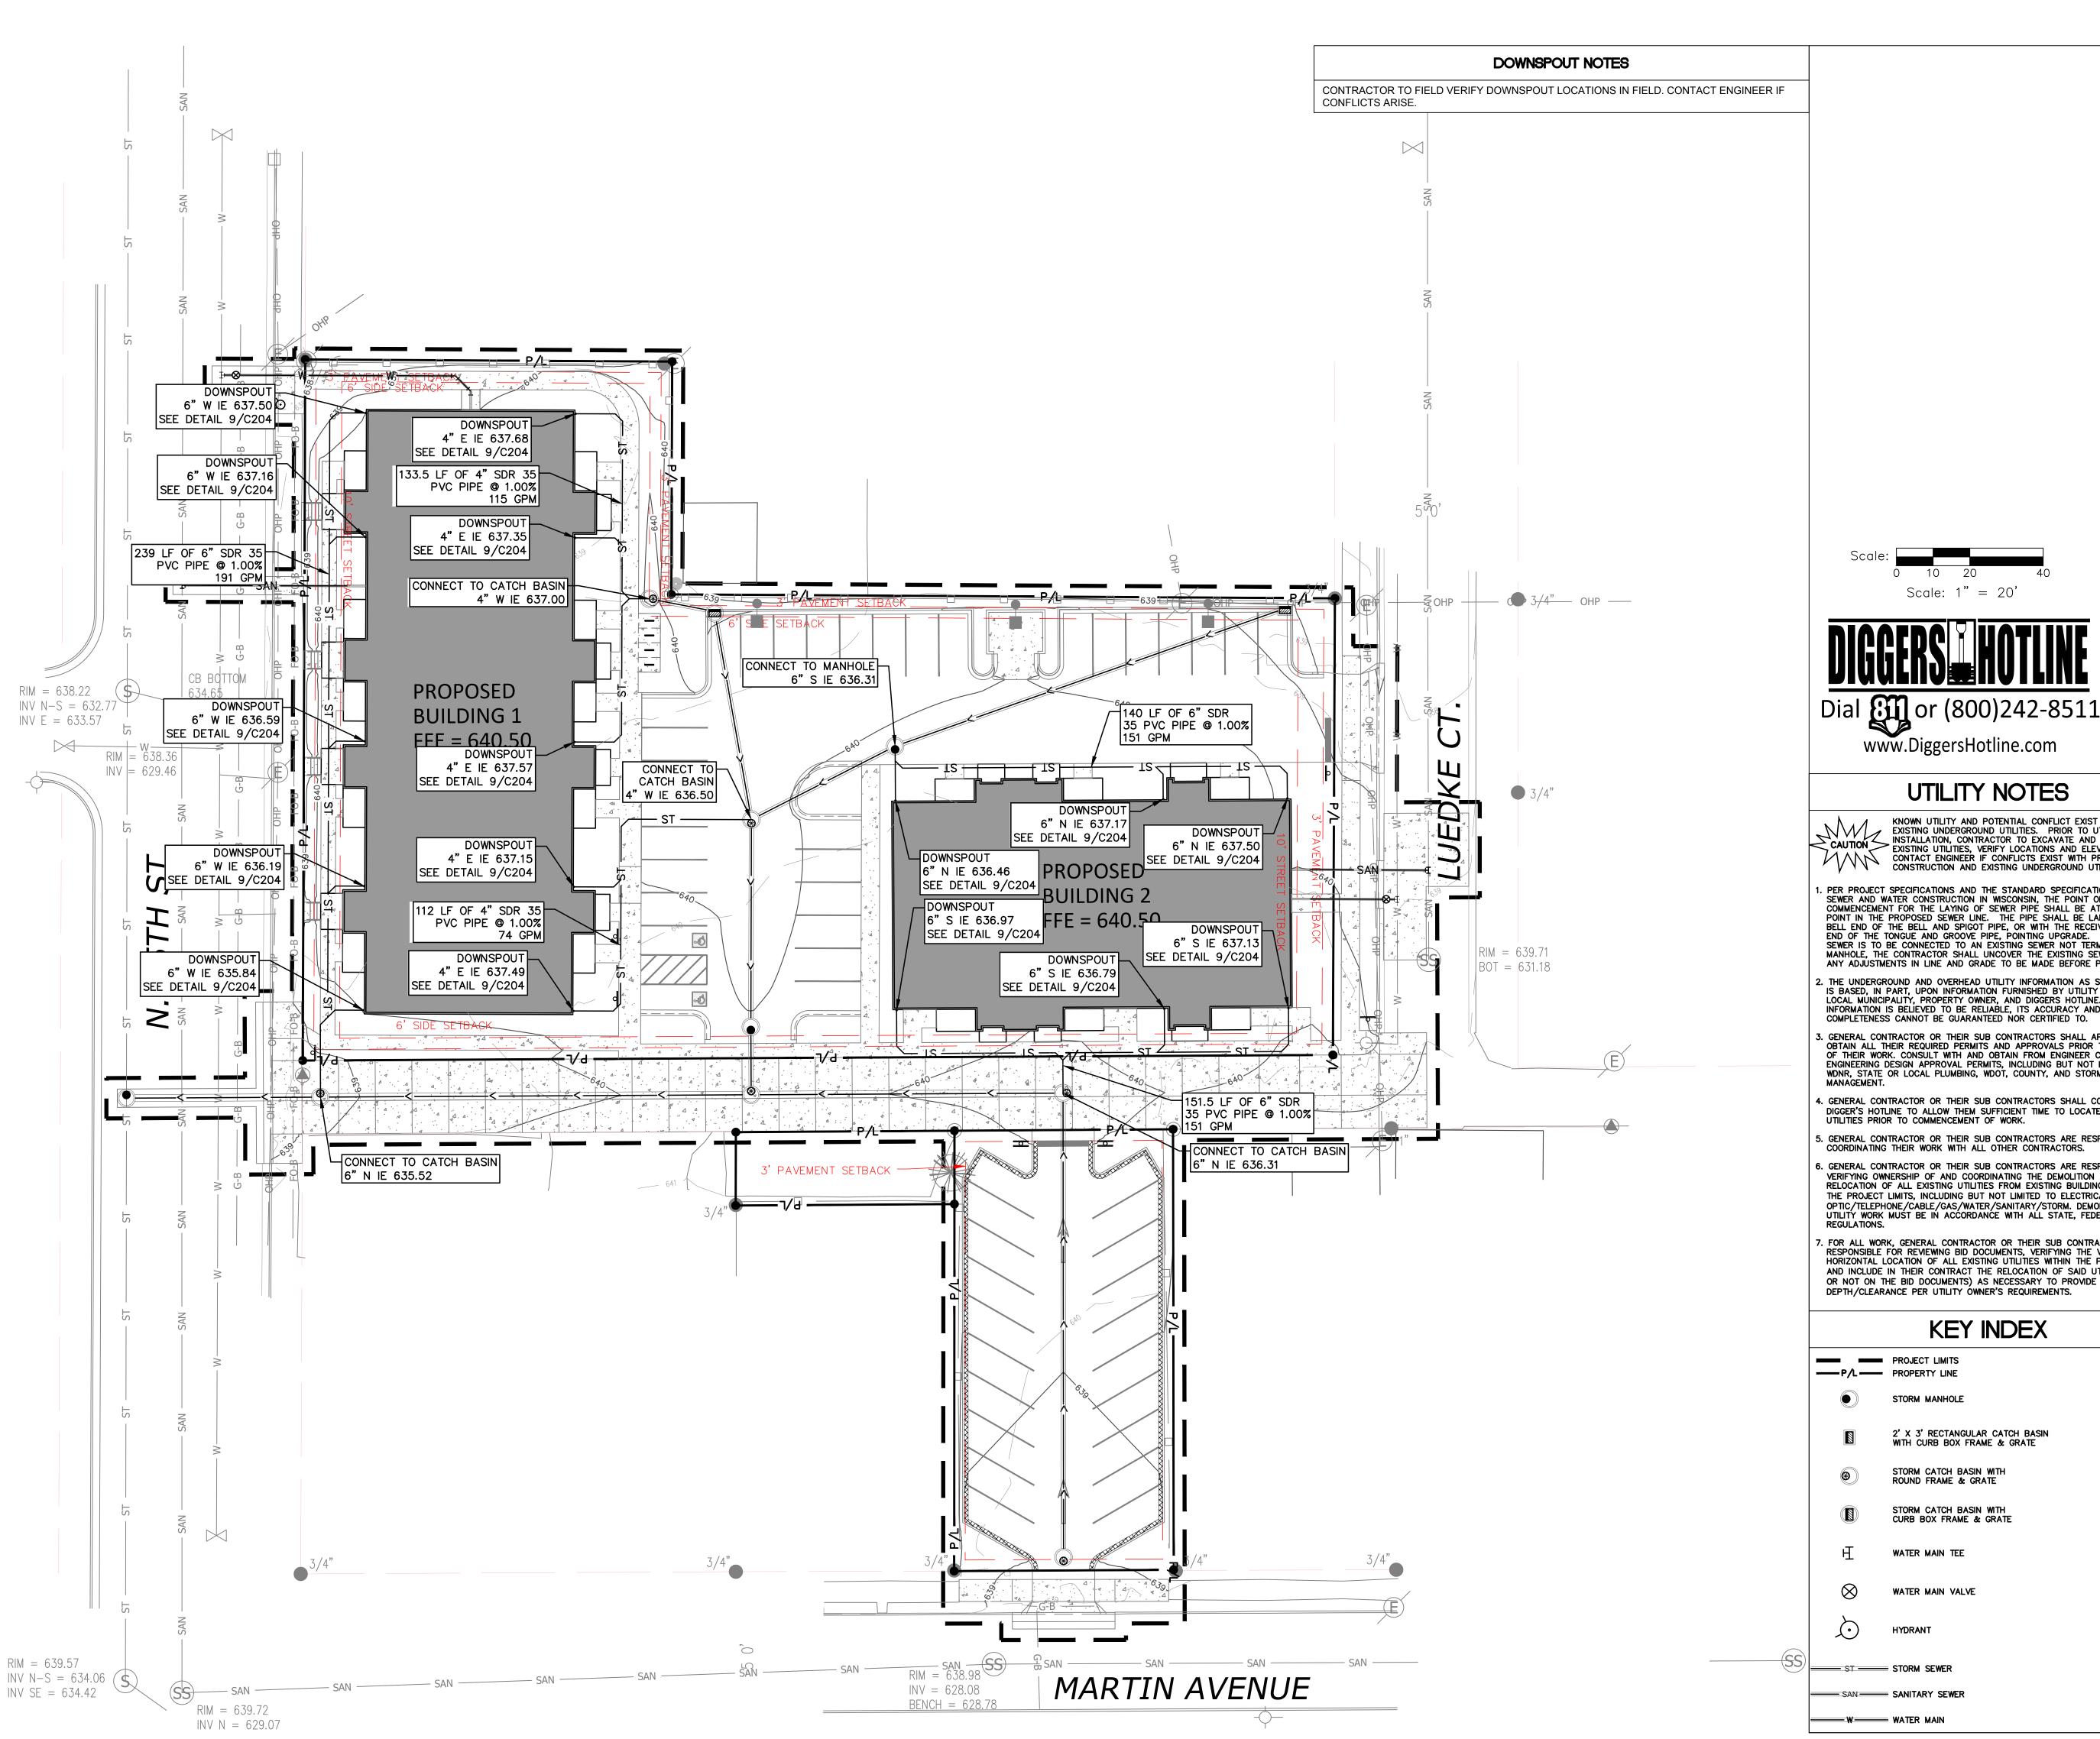
PROJECT TITLE Jakum Site Redevelopment


Red Earth Development

N. 15th St. & Luedke Ct. Sheboygan, Wisconsin
SHEET TITLE
SITE UTILITY **TABLES**

SHEET NUMBER

PROJECT NO.



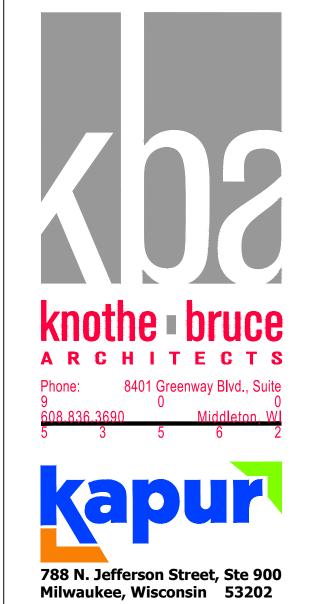

kapurinc.com

ISSUED Land Use Submittal - June 17, 2025

PROJECT TITLE

Jakum Site

Red Earth

Development

Redevelopment

UTILITY NOTES

KNOWN UTILITY AND POTENTIAL CONFLICT EXIST WITH EXISTING UNDERGROUND UTILITIES. PRIOR TO UTILITY INSTALLATION, CONTRACTOR TO EXCAVATE AND EXPOSE EXISTING UTILITIES, VERIFY LOCATIONS AND ELEVATIONS, AND CONTACT ENGINEER IF CONFLICTS EXIST WITH PROPOSED CONSTRUCTION AND EXISTING UNDERGROUND UTILITIES..

- . PER PROJECT SPECIFICATIONS AND THE STANDARD SPECIFICATIONS FOR SEWER AND WATER CONSTRUCTION IN WISCONSIN, THE POINT OF COMMENCEMENT FOR THE LAYING OF SEWER PIPE SHALL BE AT THE LOWEST POINT IN THE PROPOSED SEWER LINE. THE PIPE SHALL BE LAID WITH THE BELL END OF THE BELL AND SPIGOT PIPE, OR WITH THE RECEIVING GROOVE END OF THE TONGUE AND GROOVE PIPE, POINTING UPGRADE. WHEN A NEW SEWER IS TO BE CONNECTED TO AN EXISTING SEWER NOT TERMINATING IN A MANHOLE, THE CONTRACTOR SHALL UNCOVER THE EXISTING SEWER TO ALLOW ANY ADJUSTMENTS IN LINE AND GRADE TO BE MADE BEFORE PIPE IS LAID.
- 2. THE UNDERGROUND AND OVERHEAD UTILITY INFORMATION AS SHOWN HEREON IS BASED, IN PART, UPON INFORMATION FURNISHED BY UTILITY COMPANIES, LOCAL MUNICIPALITY, PROPERTY OWNER, AND DIGGERS HOTLINE. WHILE THIS INFORMATION IS BELIEVED TO BE RELIABLE, ITS ACCURACY AND COMPLETENESS CANNOT BE GUARANTEED NOR CERTIFIED TO.
- 3. GENERAL CONTRACTOR OR THEIR SUB CONTRACTORS SHALL APPLY FOR AND OBTAIN ALL THEIR REQUIRED PERMITS AND APPROVALS PRIOR TO THE START OF THEIR WORK. CONSULT WITH AND OBTAIN FROM ENGINEER COPIES OF ENGINEERING DESIGN APPROVAL PERMITS, INCLUDING BUT NOT LIMITED TO WDNR, STATE OR LOCAL PLUMBING, WDOT, COUNTY, AND STORM WATER
- 4. GENERAL CONTRACTOR OR THEIR SUB CONTRACTORS SHALL CONTACT DIGGER'S HOTLINE TO ALLOW THEM SUFFICIENT TIME TO LOCATE EXISTING UTILITIES PRIOR TO COMMENCEMENT OF WORK.
- 5. GENERAL CONTRACTOR OR THEIR SUB CONTRACTORS ARE RESPONSIBLE FOR COORDINATING THEIR WORK WITH ALL OTHER CONTRACTORS.
- 6. GENERAL CONTRACTOR OR THEIR SUB CONTRACTORS ARE RESPONSIBLE FOR VERIFYING OWNERSHIP OF AND COORDINATING THE DEMOLITION AND/OR RELOCATION OF ALL EXISTING UTILITIES FROM EXISTING BUILDINGS AND WITHIN THE PROJECT LIMITS, INCLUDING BUT NOT LIMITED TO ELECTRICAL/FIBER OPTIC/TELEPHONE/CABLE/GAS/WATER/SANITARY/STORM. DEMOLITION OF THIS UTILITY WORK MUST BE IN ACCORDANCE WITH ALL STATE, FEDERAL, & LOCAL
- 7. FOR ALL WORK, GENERAL CONTRACTOR OR THEIR SUB CONTRACTORS ARE RESPONSIBLE FOR REVIEWING BID DOCUMENTS, VERIFYING THE VERTICAL AND HORIZONTAL LOCATION OF ALL EXISTING UTILITIES WITHIN THE PROJECT LIMITS, AND INCLUDE IN THEIR CONTRACT THE RELOCATION OF SAID UTILITIES (NOTED OR NOT ON THE BID DOCUMENTS) AS NECESSARY TO PROVIDE PROPER DEPTH/CLEARANCE PER UTILITY OWNER'S REQUIREMENTS.

1 C204 4 C204 5 C204

7 C204 8 C204

N. 15th St. & Luedke Ct. Sheboygan, Wisconsin SHEET TITLE


SITE **DOWNSPOUT** PLAN

SHEET NUMBER

C105B

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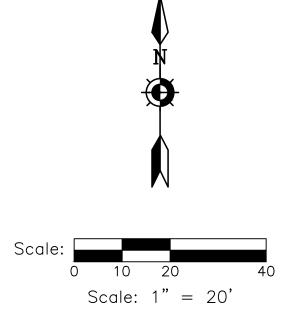
PROJECT NO.



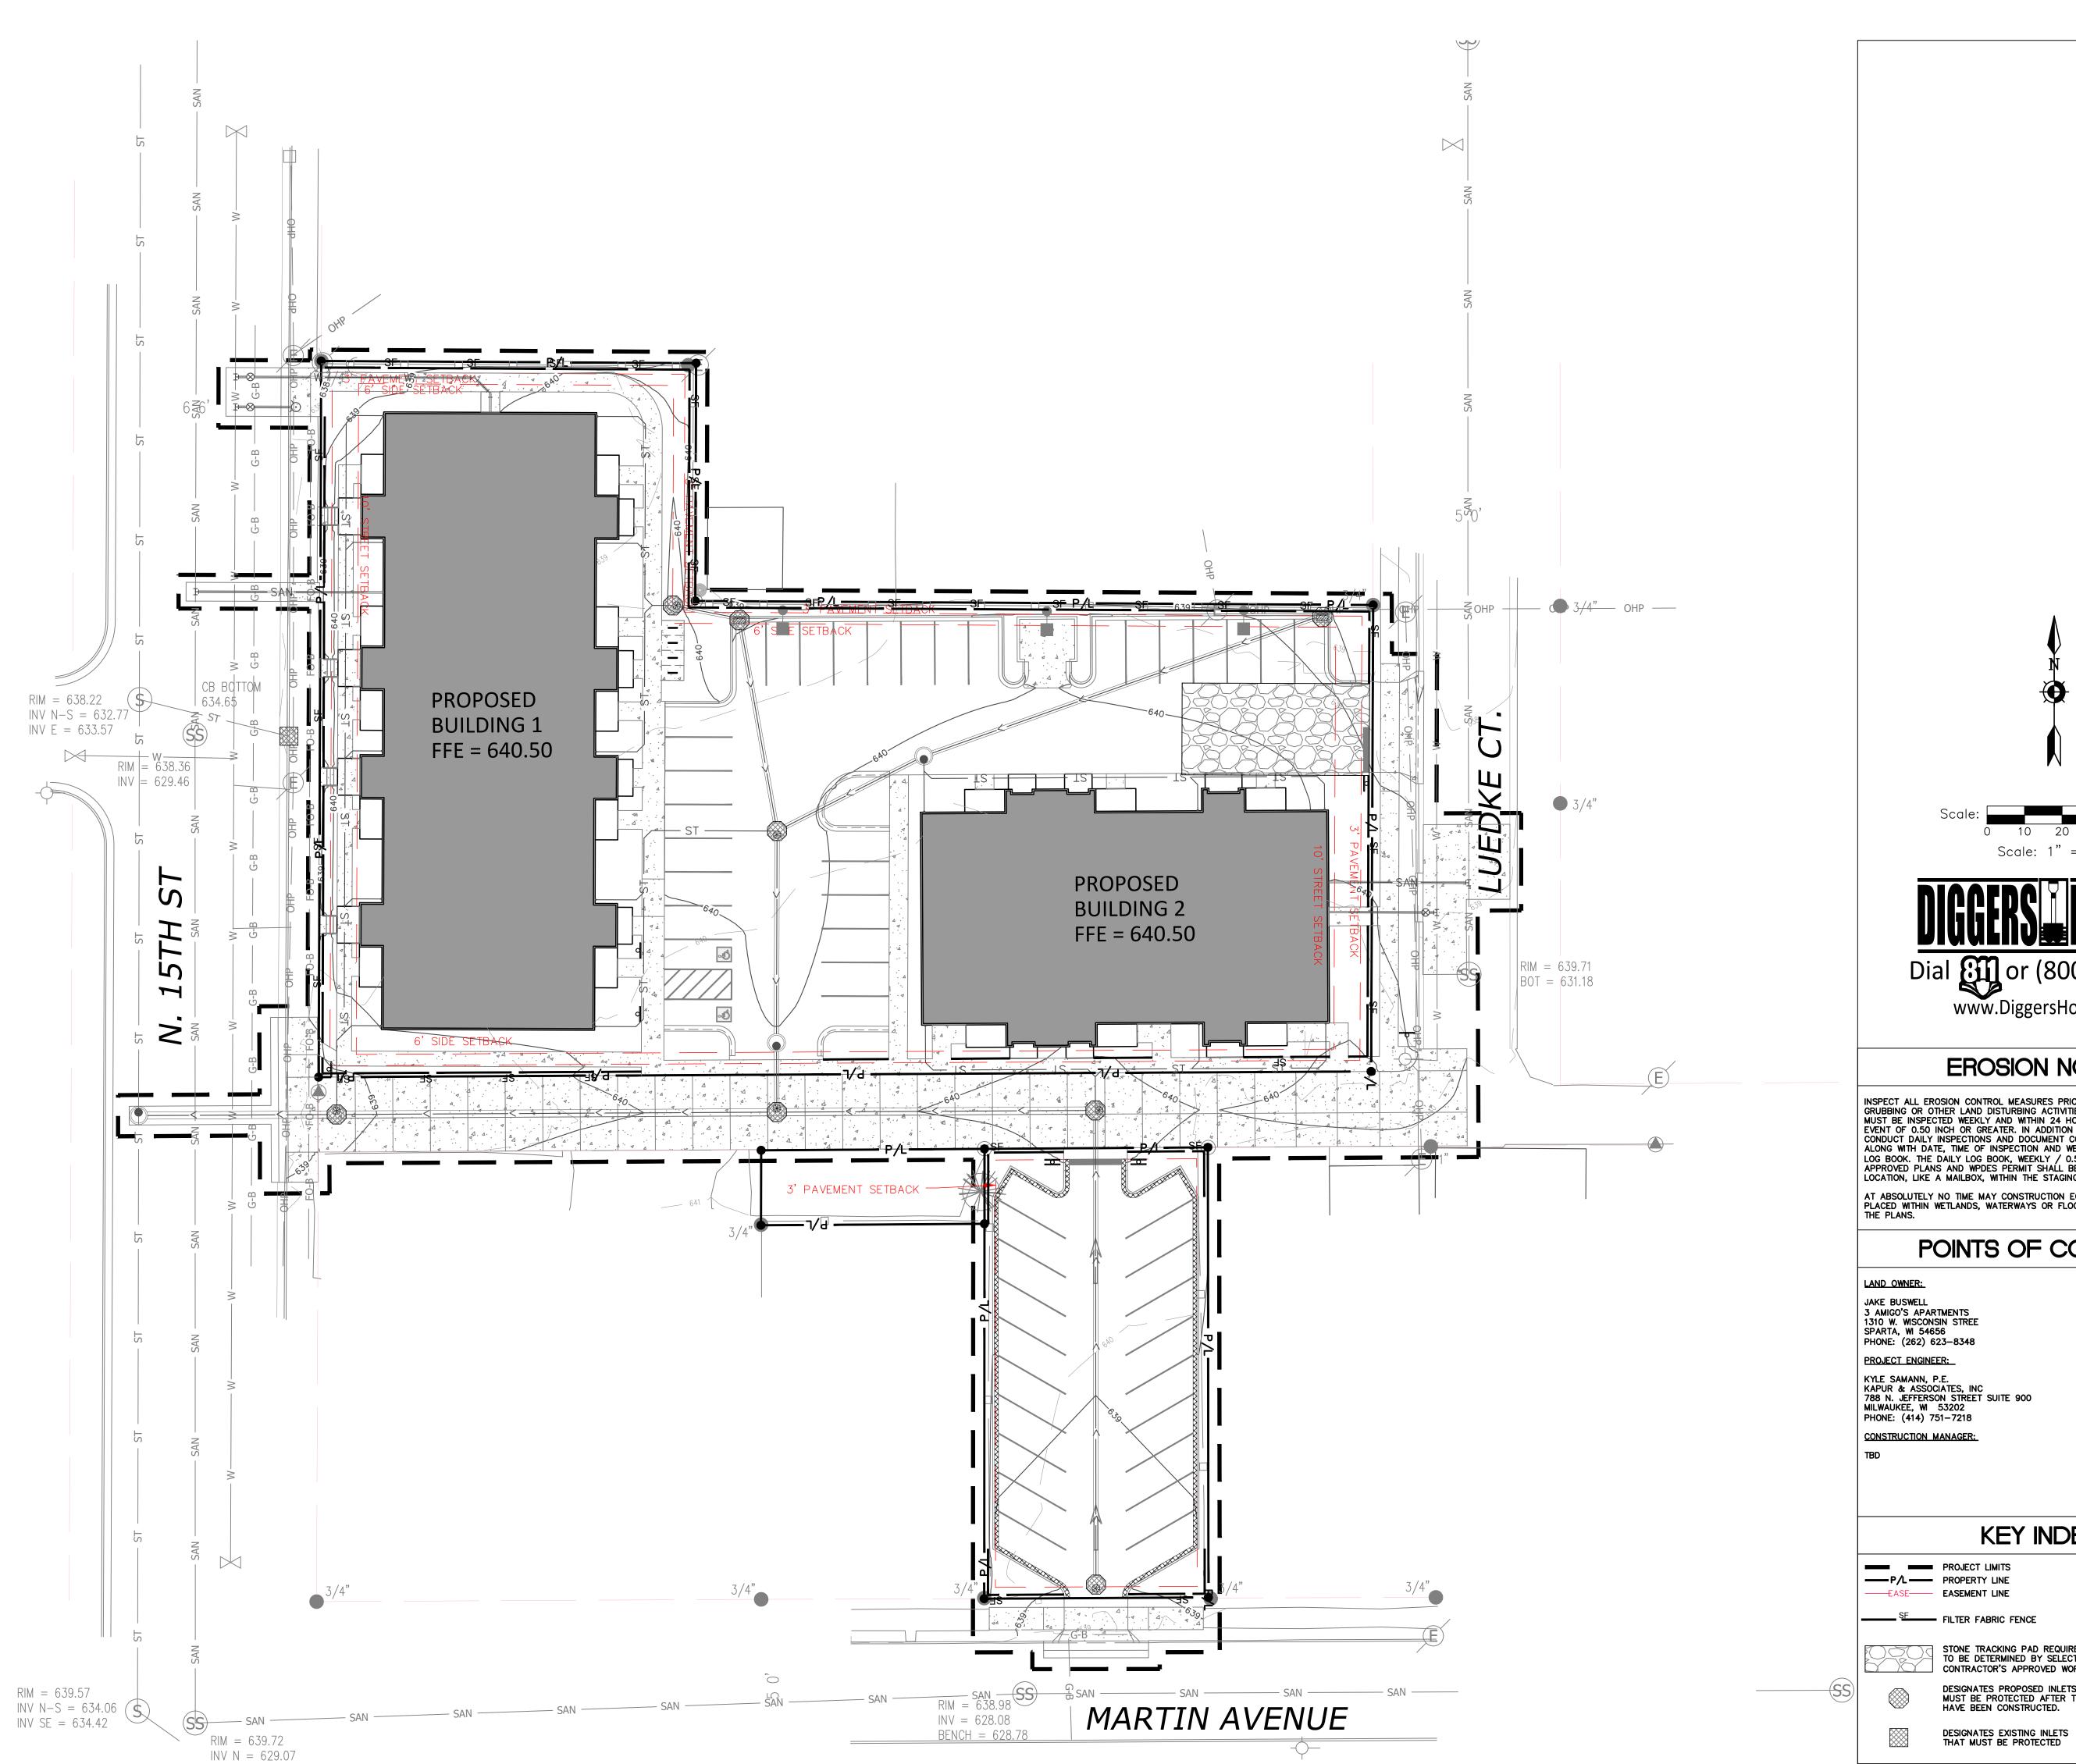

ISSUED

Land Use Submittal - June 17, 2025



DIGGERS HOTLINE Dial or (800)242-8511

www.DiggersHotline.com

EROSION NOTES

INSPECT ALL EROSION CONTROL MEASURES PRIOR TO COMMENCING GRADING, GRUBBING OR OTHER LAND DISTURBING ACTIVITIES. EROSION CONTROL MEASURES MUST BE INSPECTED WEEKLY AND WITHIN 24 HOURS OF EVERY PRECIPITATION EVENT OF 0.50 INCH OR GREATER. IN ADDITION THE CONTRACTOR SHALL CONDUCT DAILY INSPECTIONS AND DOCUMENT CONDITIONS AND REPAIRS MADE ALONG WITH DATE, TIME OF INSPECTION AND WEATHER CONDITIONS IN A DAILY LOG BOOK. THE DAILY LOG BOOK, WEEKLY / 0.50 INCH PRECIPITATION REPORTS, APPROVED PLANS AND WPDES PERMIT SHALL BE KEPT IN AN ACCESSIBLE LOCATION, LIKE A MAILBOX, WITHIN THE STAGING AREA.

AT ABSOLUTELY NO TIME MAY CONSTRUCTION EQUIPMENT, DEBRIS, FILL, ETC. BE PLACED WITHIN WETLANDS, WATERWAYS OR FLOOD PLAINS UNLESS IDENTIFIED IN THE PLANS.

POINTS OF CONTACT

JAKE BUSWELL
3 AMIGO'S APARTMENTS
1310 W. WISCONSIN STREE
SPARTA, WI 54656 PHONE: (262) 623-8348

KYLE SAMANN, P.E.
KAPUR & ASSOCIATES, INC
788 N. JEFFERSON STREET SUITE 900
MILWAUKEE, WI 53202

CONSTRUCTION MANAGER:


KEY INDEX

PROJECT LIMITS ——P/L —— PROPERTY LINE EASE EASEMENT LINE

— SF FILTER FABRIC FENCE

STONE TRACKING PAD REQUIRED. LOCATION TO BE DETERMINED BY SELECTED CONTRACTOR'S APPROVED WORK PLAN.

DESIGNATES PROPOSED INLETS THAT MUST BE PROTECTED AFTER THEY HAVE BEEN CONSTRUCTED.

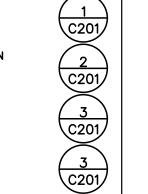

SITE EROSION CONTROL PLAN

SHEET TITLE

N. 15th St. & Luedke Ct. Sheboygan, Wisconsin

PROJECT TITLE

Jakum Site

Red Earth

Development

Redevelopment

SHEET NUMBER

C106

PROJECT NO.

EROSION CONTROL MEASURES

MEASURES AS INDICATED ON THIS PLAN AND PER THE LATEST WDNR TECHNICAL STANDARDS. TECHNICAL STANDARDS MAY BE VIEWED http://dnr.wl.gov/topic/stormwater/standards/const_standards.htmlTHE FLOW OF SEDIMENT-LADEN SHEET FLOW RUNOFF . INLETS AND CATCH BASINS SHALL BE PROTECTED WITH INLET FILTERS THAT ARE PHASED IN WITH CONSTRUCTION TO REDUCE SEDIMENT FROM ENTERING THESE AREAS PER WDNR TECHNICAL

CONTRACTOR TO INSTALL AND MAINTAIN EROSION CONTROL

STANDARD 1060 AS FOLLOWS:

- ALL FABRIC BARRIERS SELECTED FOR INLET/CATCH BASIN APPROVED FABRICS CERTIFIED FOR INLET PROTECTION, GEOTEXTILE PRODUCT ACCEPTABILITY LIST, TO OBTAIN THE PAL, PLEASE REFER TO THIS WEBSITE:
- http://wisconsindot.gov/Documents/doing-bus/eng-consultants/cnsit-rsrces/tools/pai/pai-7-14.pdf
- A. INLET PROTECTION SHALL BE AT A MINIMUM INSPECTED WEEKLY AND WITHIN 24 HOURS AFTER EVERY PRECIPITATION EVENT OF 1/2 INCH OR GREATER DURING A 24-HOUR PERIOD.
- B. PLACEMENT OF SPOIL MATERIAL, DEBRIS, SOILS, ETC. ON TOP OF INLETS/CATCH BASINS, EVEN IF TEMPORARY, IS STRICTLY DISCOURAGED AND PROHIBITED.
- C. SEDIMENT DEPOSITS SHALL BE REMOVED AND THE INLET PROTECTION DEVICE RESTORED TO ITS ORIGINAL DIMENSIO WHEN THE SEDIMENT HAS ACCUMULATED BETWEEN 1/3 TO 1/2 THE DESIGN DEPTH OF THE DEVICE FOR TYPES A-C, WHEN SEDIMENT IS WITHIN 6" OF THE BOTTOM OF THE OVERFLOW HOLE FOR TYPE D. OR WHEN THE DEVICE IS NO LONGER FUNCTIONING PER MANUFACTURER'S SPECIFICATIONS. SEDIMENT COLLECTED SHALL BE PROPERLY DISPOSED OF T
- PREVENT DISCHARGE INTO AREA WATERWAYS AND WETLANDS. D. DUE CARE SHALL BE TAKEN TO ENSURE SEDIMENT DOES NOT FALL INTO THE INLETS/CATCH BASINS AND IMPEDE THE INTENDED FUNCTION OF THE DEVICE. ANY MATERIAL FALLING

INTO THE INLET/CATCH BASIN SHALL BE REMOVED AND

- PROPERLY DISPOSED OF PER NOTE C ABOVE. E. INLET FILTERS MAY BE REMOVED AND PROPERLY DISPOSED O
 UPON COMPLETION OF CONSTRUCTION, HAULING OR MOVEMENT OF CONSTRUCTION EQUIPMENT THROUGHOUT THE SITE, AND ONCE THE SITE IS ADEQUATELY STABILIZED, UNLESS AS
- 3. A TRACKING PAD SHALL BE INSTALLED AS SHOWN ON THE PLAN OFF-SITE SEDIMENTATION BY ELIMINATING THE TRACKING OF SEDIMENT FROM THE SITE PER WDNR TECHNICAL STANDARD 1057 AS FOLLOWS:
- A. AGGREGATE USED FOR TRACKING PADS SHALL BE 3 TO 6 INCH CLEAR OR WASHED STONE. ALL MATERIAL TO BE RETAINED BY
- B. THE AGGREGATE SHALL BE PLACED IN A LAYER OF AT LEAST 12 INCHES THICK. ON SITES WITH A HIGH WATER TABLE, OR
- WILL BE UNDERLAIN WITH WISDOT TYPE R GEOTEXTILE FABRIC. C. THE TRACKING PAD SHALL BE THE FULL WIDTH OF THE EGRESS POINT (MIN. 15 FEET WIDE) AND BE AT LEAST 50 FEET LONG.
- D. VEHICLES TRAVELING ACROSS THE TRACKING PAD SHALL MAINTAIN A SLOW CONSTANT SPEED
- BEFORE THE END OF EACH WORKING DAY.

E. ANY SEDIMENT OR ROCK ACCUMULATION ONTO LOCAL ROADWAYS

- F. THE TRACKING PAD SHALL, AT A MINIMUM BE INSPECTED WEEKLY AND WITHIN 24 HOURS AFTER EVERY PRECIPITATION EVENT OF 1/2 INCH OF RAIN OR MORE DURING A 24-HOUR
- G. THE TRACKING PAD PERFORMANCE SHALL BE MAINTAINED AT A MINIMUM OF 12" BY SCRAPING OR TOP-DRESSING WITH

SHALL TAKE PLACE WITH ALL RELEVANT PARTIES IN ATTENDANCE.

THE TIMING AND SEQUENCE OF CONSTRUCTION IS SCHEDULED AS FOLLOWS:

SITE DEMOLITION IS COMPLETE IN THE BUILDING PAD AREA.

FENCES AND INLET FILTER PROTECTION SHALL BE REMOVED.

RESUBMITTED BY THE GENERAL CONTRACTOR TO THE CITY AND WDNR

LANDSCAPING. REMAINING STOCKPILES WILL BE REMOVED FROM THE SITE.

AND SIDEWALK BASE MATERIAL WILL BE APPLIED PER PROJECT SPECIFICATIONS.

AND WEATHER CONDITIONS IN A DAILY LOG BOOK.

SHOWN ON THE PLANS.

DEPTH OF 1/2 FENCE HEIGHT.

EROSION CONTROL OPERATION SEQUENCE + SCHEDULE

AFTER BIDS ARE RECEIVED AND A MASS GRADING CONTRACTOR IS SELECTED, A PRE-CONSTRUCTION MEETING

THE GENERAL CONTRACTOR IS RESPONSIBLE FOR INSTALLING AND MAINTAINING ALL SILT FENCES, SEEDING,

EROSION MATTING, AND OTHER EROSION CONTROL MEASURES. GENERAL CONTRACTOR SHALL INSPECT ALL EROSION CONTROL MEASURES PRIOR TO COMMENCING GRADING, GRUBBING, OR OTHER LAND DISTURBING ACTIVITIES. EROSION CONTROL MEASURES MUST BE INSPECTED WEEKLY AND WITHIN 24 HOURS OF EVERY PRECIPITATION EVENT OF 1/2 INCH OR GREATER. IN ADDITION, THE ACTIVE CONTRACTOR SHALL CONDUCT

DAILY INSPECTIONS AND DOCUMENT CONDITIONS AND REPAIRS MADE, ALONG WITH DATE, TIME OF INSPECTION,

CONTRACTORS ARE TO MAINTAIN THE CONSTRUCTION SITE IN A NEAT AND TIDY MANNER FOR THE DURATION OF

1. OBTAIN PLAN APPROVAL FROM THE CITY OF SHEBOYGAN, AND ALL APPLICABLE PERMITS, INCLUDING

3. A GRAVEL TRACKING PAD UNDERLAIN WITH WISDOT TYPE R GEOTEXTILE FABRIC SHALL BE INSTALLED AS

2. CONSTRUCTION IS SCHEDULED TO BEGIN IN SUMMER 2025, DEPENDING ON WEATHER & GROUND

4. SILT FENCE AND INLET FILTER PROTECTION SHALL BE INSTALLED AS SHOWN ON THE PLANS, AND

INSPECTED PRIOR TO COMMENCING OF ANY LAND DISTURBING ACTIVITIES PER PROJECT PLANS AND DETAILS. SEDIMENT DEPOSITS WILL BE REMOVED FROM BEHIND THE SILT FENCE WHEN THEY REACH A

5. SITE DEMOLITION OF PAVEMENT, ETC. WILL OCCUR AFTER ALL EROSION CONTROL MEASURES ARE IN PLACE

6. CONSTRUCTION OF THE BUILDING, STARTING WITH THE FOUNDATION, WILL BEGIN IMMEDIATELY AFTER THE

. TOPSOIL STRIPPING AND ROUGH GRADING WILL FOLLOW. TOPSOIL STOCKPILES WILL BE LOCATED AS SHOWN

ON THE PLANS AND BE STABILIZED WITHIN 7 DAYS OF LAY UP. STOCKPILES WILL BE USED FOR FINAL

9. AFTER ROUGH GRADING IS COMPLETE IN HARD SURFACE AREAS SUCH AS ROADWAYS, PARKING LOTS, AND

10. FINAL SITE STABILIZATION IS ANTICIPATED FOLLOWING THE COMPLETION OF GRADING ACTIVITIES PER WDNR TECHNICAL STANDARD 1059. IF SITE STABILIZATION CANNOT BE COMPLETED BY OCTOBER 15, THEN THE

ADDITION, ALL SLOPES OF GREATER THAN 20% MUST ADHERE TO THE SCHEDULE IN TABLE 1 BELOW.

12. THE GENERAL CONTRACTOR WILL REQUEST A FINAL INSPECTION BY THE CITY. UPON APPROVAL, ALL SILT

13. IF REQUIRED, FINAL "AS-BUILT" SURVEYS ARE TO BE CONDUCTED BY THE OWNER AND FINAL DOCUMENTS

14. BARE SOIL LEFT UNDISTURBED FOR 14 CALENDAR DAYS MUST BE TEMPORARILY STABILIZED PER WDNR

15. WE DO NOT ANTICIPATE THE NEED FOR WATERING WITH THIS CONSTRUCTION SCHEDULE, HOWEVER, IF

IF CONSTRUCTION SCHEDULES SHOULD CHANGE SIGNIFICANTLY, THIS PLAN NARRATIVE WILL BE UPDATED AND

TECHNICAL STANDARD 1059. BY OCTOBER 15, THE SITE SHALL BE STABILIZED PER NOTE 10 ABOVE.

ADEQUATE RAIN IS NOT EXPERIENCED WITHIN ONE WEEK AFTER INITIAL SEED GERMINATION AT ANY POINT DURING THE CONSTRUCTION PROCESS, WATER SHALL BE TRUCKED IN AND APPLIED ONCE PER WEEK.

11. AFTER ALL TOPSOIL HAS BEEN REAPPLIED AND STABILIZATION IS UNDERWAY, ROADWAY, PARKING LOT,

USE OF ANIONIC POLYACRYLAMIDE CONFORMING TO WDNR TECHNICAL STANDARD 1050 SHALL BE USED. IN

BUILDINGS, THE REQUIRED THICKNESS OF DENSE GRADED BASE COURSE, PER THE PROJECT PLANS AND DETAILS WILL BE APPLIED FOR STABILIZATION. AFTER ROUGH GRADING IS COMPLETE OUTSIDE OF HARD SURFACE AREAS, THE TOPSOIL WILL BE REAPPLIED AND THE LANDSCAPE CONTRACTOR WILL COMPLETE

SEEDING/SODDING/FERTILIZING/MULCHING AND INSTALL EROSION MATTING AS PER APPROVED PLANS AND

8. UTILITY INSTALLATION WILL OCCUR NEXT AND CONTINUE UNTIL ALL THE UTILITIES ARE INSTALLED.

ALL REGULATORY PERMITS, PROJECT PLANS, AND INSPECTION LOGS SHALL BE KEPT ON SITE IN AN

ACCESSIBLE LOCATION, SUCH AS A MAILBOX, AVAILABLE TO REGULATORY AGENCIES UPON REQUEST.

- 4. THE CONSTRUCTION SITE PERIMETER AND TOPSOIL STOCKPILE AREA SHALL BE PROTECTED WITH SILT FENCE AS SHOWN ON THE PLAN SHEET PRIOR TO TH START OF CONSTRUCTION TO INTERCEPT AND REDUCE FROM THE CONSTRUCTION SITE PER WDNR TECHNICAL
- A. SILT FENCE ENDS SHALL BE EXTENDED UPSLOPE TO PREVENT WATER FROM FLOWING AROUND THE ENDS OF THE FENCE AS SHOWN ON THE PLAN
- B. INSTALLED SILT FENCE SHALL BE A MINIMUM 14 INCHES HIGH AND SHALL NOT EXCEED 28 INCHES
- IN HEIGHT MEASURED FROM THE INSTALLED GROUND ELEVATION. C. SILT FENCE SHALL BE SUPPORTED BY EITHER
- STEEL OR WOOD SUPPORT POSTS. D. THE MAXIMUM SPACING OF POSTS FOR NONWOVEN SILT FENCE SHALL BE 3 FEET OR FOR WOVEN
- FABRIC 8 FEET. E. SILT FENCE SHALL HAVE A SUPPORT CORD AT THE TOP OF THE FENCE.
- F. WHERE JOINTS ARE NEEDED, EACH END OF THE FABRIC SHALL BE SECURELY FASTENED TO A
 POST. THE POSTS SHALL BE WRAPPED AROUND
 EACH OTHER TO PRODUCE A STABLE AND SECURE JOINT OR SHALL BE OVERLAPPED THE
- G. A MINIMUM OF 20 INCHES OF THE POSTS SHALL EXTEND INTO THE GROUND AFTER INSTALLATION.

DISTANCE BETWEEN TWO POSTS.

AT LEAST 8 INCHES OF THE FABRIC IN A 4 INCH WIDE BY 6 INCH DEEP TRENCH, OR 6 INCH DEEP -TRENCH ON THE UPSLOPE SIDE OF THE FENCE. THE TRENCH SHALL BE BACKFILLED AND COMPACTED. TRENCHES SHALL NOT BE EXCAVATED ANY WIDER OR DEEPER THA NECESSARY FOR PROPER INSTALLATION

H. SILT FENCE SHALL BE ANCHORED BY SPREADING

- I. ON THE TERMINAL ENDS OF THE SILT FENCE THE FABRIC SHALL BE WRAPPED AROUND THE POST SUCH THAT THE STAPLES ARE NOT VISIBLE. J. GEOTEXTILE FABRIC SPECIFICATIONS SHALL MEET
- VALUES ESTABLISHED IN TECHNICAL STANDARD K. SILT FENCE SHALL BE REMOVED ONCE THE SITE IS ADEQUATELY STABILIZED.
- L. WHEN PLACING SILT FENCE NEAR TREES, CARE SHALL BE TAKEN TO MINIMIZE DAMAGE TO THE ROOT SYSTEM BY AVOIDING COMPACTION AND MULTIPLIED BY THE INCH DIAMETER OF THE
- M. THE CONTRACTOR MAY FURTHER STRENGTHEN THE SILT FENCE BY USING HAY BALES ON THE
- DOWN SLOPE SIDE AS NEEDED. N. SILT FENCE SHALL AT A MINIMUM BE INSPECTED WEEKLY AND WITHIN 24 HOURS AFTER EVERY

PRECIPITATION EVENT THAT PRODUCES 1/2 INCH

- OF RAIN OR MORE DURING A 24 HOUR PERIOD. O. DAMAGED OR DECOMPOSED SILT FENCE, UNDERCUTTING, OR FLOW CHANNELS AROUND THE END OF BARRIERS SHALL BE REPAIRED OR
- P. SEDIMENT SHALL BE PROPERLY DISPOSED OF ONCE THE DEPOSITS REACH 1/2 THE HEIGHT OF THE FENCE TO PREVENT DISCHARGE INTO AREA WATERWAYS AND WETLANDS.

- 5. SEEDING AND MULCHING TECHNIQUES SHALL BE USED ON AREAS OF EXPOSED SOIL WHERE THE ESTABLISHMENT OF VEGETATION IS DESIRED. TEMPORARY SEEDING APPLIES TO DISTURBED AREAS THAT WILL NOT BE BROUGHT TO FINAL GRADE OR ON WHICH LAND-DISTURBING ACTIVITIES WILL NOT BE PERFORMED FOR A PERIOD GREATER THAN 14 CALENDAR DAYS, REQUIRING VEGETATIVE COVER FOR LESS THAN ONE YEAR. SEED AND MULCH SHALL BE UTILIZED THROUGHOUT THE DURATION OF CONSTRUCTION TO ESTABLISH TEMPORARY VEGETATION TO HELP STANDARD 1056 AS FOLLOWS:
 - A. TEMPORARY SEEDING REQUIRES A SEEDBED OF LOOSE SOIL TO A MINIMUM
 - B. FERTILIZER APPLICATION IS NOT GENERALLY REQUIRED FOR TEMPORARY SEEDING. HOWEVER, ANY APPLICATION OF FERTILIZER OR LIME SHALL BE BASED ON SOIL TESTING.
 - C. THE SOIL SHALL HAVE A PH RANGE OF 5.5 TO 8.0.
 - D. ALL SEED SHALL CONFORM TO THE REQUIREMENTS OF THE WISCONSIN STATE STATUTES AND OF THE ADMINISTRATIVE CODE CHAPTER ATCP 20.01
 - REGARDING NOXIOUS WEED SEED CONTENT AND LABELING. E. SEED SHALL NOT BE USED LATER THAN ONE YEAR AFTER THE TEST DATE
 - F. IN THE SUMMER-SPRING, CONTRACTOR SHALL USE OATS APPLIED AT 131 LBS/ACRE FOR TEMPORARY SEEDING PURPOSES. IN THE FALL THE CONTRACTOR SHALL USE ANNUAL RYEGRASS APPLIED AT 80 LBS/ACRE OR CONTRACTOR SHALL USE STRAW MULCH APPLIED AT 1.5 TONS/ACRE. DORMANT SEED SHALL BE USED WHEN SOIL TEMPERATURE IS CONSISTENTL BELOW 53 DEGREES FAHRENHEIT (TYPICALLY NOV. 1 UNTIL SNOW COVER ANNUALLY). NEVER PLACE SEED ON TOP OF SNOW. IF COVER IS NEEDED TYPE B SOIL STABILIZER PER MANUFACTURER'S SPECIFICATIONS AS REQUIRED
 - G. SEEDING SHALL NOT TAKE PLACE WHEN THE SOIL IS TOO WET.
 - H. CONTRACTOR MAY CONSIDER WATERING TO HELP ESTABLISH THE SEED. WATER APPLICATION RATES SHALL BE CONTROLLED TO HELP PREVENT
 - I. DURING CONSTRUCTION, AREAS THAT HAVE BEEN SEEDED AND MULCHED SHALL AT A MINIMUM BE INSPECTED WEEKLY AND WITHIN 24 HOURS AFTER EVERY PRECIPITATION EVENT THAT PRODUCES 1/2 INCH OF RAIN OR MORE DURING A 24 HOUR PERIOD. INSPECT WEEKLY DURING THE GROWING SEASON. UNTIL VEGETATION IS DENSELY ESTABLISHED OR THE SOD IS LAID. REPAIR AND RESEED AREAS THAT HAVE EROSION DAMAGE AS NECESSARY.
 - J. CONTRACTOR IS TO LIMIT VEHICLE TRAFFIC AND OTHER FORMS OF COMPACTION IN AREAS THAT ARE SEEDED AS MUCH AS POSSIBLE. RE-SEED DRIVEN OVER AREAS AS NEEDED.
 - K. MULCH SHOULD BE PLACED WITHIN 24 HOURS OF SEEDING.
 - L. MULCHING OPERATIONS SHALL NOT TAKE PLACE DURING PERIODS OF EXCESSIVELY HIGH WINDS THAT WOULD PRECLUDE THE PROPER PLACEMENT
 - M. MULCH THAT IS DISPLACED SHALL BE REAPPLIED AND PROPERLY ANCHORED. MAINTENANCE SHALL BE COMPLETED AS SOON AS POSSIBLE WITH CONSIDERATION TO SITE CONDITIONS.
 - N. WHEN CHANNEL EROSION MAT IS USED WITHIN CONSTRUCTION SITE DIVERSION AREAS, TECHNICAL STANDARDS 1053 AND 1066 SHALL BE FOLLOWED.
 - O. WHEN NON-CHANNEL EROSION MAT IS USED TECHNICAL STANDARD 1052 SHALL P. DEPENDING ON DURATION OF CONSTRUCTION, THE CONTRACTOR MAY NEED TO RE-SEED AND RE-STABILIZE THE TOPSOIL STOCKPILE AS NECESSARY TO
 - DISCOURAGE SEDIMENT AND EROSION. 6. A COPY OF EROSION CONTROL INSPECTION REPORTS AND THE APPROVED EROSION CONTROL PLANS SHALL BE KEPT ON SITE.
 - 7. CONTRACTOR SHALL MAINTAIN ALL EROSION CONTROL PRACTICES BY THE END OF EACH WORKDAY.
 - 8. LOCAL ROADS SHALL BE CLEAN BY THE END OF EACH WORKDAY. CONTRACTOR SHALL HAVE LOCAL ROADS SWEPT WHERE SEDIMENT ACCUMULATES.

DEWATERING PLAN

TO FACILITATE CONSTRUCTION AT THE PROJECT SITE, DEWATERING MAY TAKE PLACE BY THE SELECTED CONTRACTOR. CONTRACTOR TO FOLLOW THESE INSTRUCTIONS WHILE PERFORMING DEWATERING ACTIVITIES ON-SITE. IF DEWATERING IS TO TAKE PLACE AT THE SITE, IT WILL OCCUR BETWEEN STEPS 3 AND 12 OF

NOTE: THESE INSTRUCTIONS DO NOT APPLY TO WATER BEING DISCHARGED DIRECTLY TO GROUNDWATER OR KARST FEATURES OR WELL DEWATERING SYSTEMS. CONTRACTOR SHALL COORDINATE ACCORDINGLY FOR OTHER DEWATERING ACTIVITIES AS DEEMED NECESSARY WITH THE WDNR.

L THE CONTRACTOR SHALL ENSURE THAT THE DEWATERING PRACTICES CARRIED OUT MEET OR EXCEED WDNR TECHNICAL STANDARD NUMBER 1061.

2. A PAN OR OTHER CONTAINMENT DEVICE SHALL BE PLACED UNDERNEATH THE PUMP TO CAPTURE ANY

- SPILLS. OILS, GASOLINE, ETC. SHALL NOT BE STORED WITHIN WETLANDS, NEAR THE STORMWATER POND, OR OTHER ON-SITE WATER AREAS. 3. A TYPE 2 GEOTEXTILE BAG THAT IS NO SMALLER THAN 100 SQUARE FEET; HAS A MAXIMUM APPARENT OPENING SIZE OF 0.212 mm; HAS A GRAB TENSILE STRENGTH OF 300 LBS; MULLEN BURST OF 580 PSI; PERMEABILITY OF 0.2 CM/SEC; FABRIC WEIGHT OF 12 OZ SHALL BE USED. THE GEOTEXTILE BAG AREA AND DOWNGRADE FLOW AREA SHALL CONSIST OF VEGETATED AND UNDISTURBED SOILS.
- 4. POLYMER APPROVED BY THE WDNR MEETING WDNR TECHNICAL STANDARD 1051 MAY BE USED IN COMBINATION WITH THE DEWATERING BAG IF THE DEWATERING BAG IS NOT DOING AN ADEQUATE JOB ALONE OF FILTERING SEDIMENTS. THE CONTRACTOR SHALL SUPPLY TOXICITY TESTING DATA TO THE WDNR BEFORE USE ON-SITE FOR WDNR APPROVAL. POLYMER SHALL NOT BE DIRECTLY APPLIED T SURFACE WATER, CONTRACTOR SHALL OBTAIN THE MATERIAL SAFETY DATA SHEETS (MSDS) FOR THI ELECTED POLYMER, MANUFACTURER'S INFORMATION AND WDNR USE RESTRICTIONS (SEE TECHNICAL STANDARD 1051) AND KEEP ALL THIS INFORMATION ON-SITE. CONTRACTOR SHALL ADHERE TO MANUFACTURER AND WDNR'S APPLICATION RATES FOR THE POLYMER, WITH THE WDNR'S RATE TAKING PRECEDENCE. THE CONTRACTOR SHALL TAKE STEPS TO ENSURE THAT THE POLYMER IS NOT SPILLED.
- 5. A TARP MAY BE UTILIZED UNDERNEATH THE TYPE 2 GEOTEXTILE BAG AND JUST DOWN SLOPE OF THE
- 6. A FLOATING SUCTION HOSE OR OTHER FLOTATION METHOD SHALL BE UTILIZED WHEN PUMPING FROM AN

SPILL KITS SHALL BE KEPT ON SITE; THE MANUFACTURER'S RECOMMENDED CLEANUP PROCEDURES SHALL

- 7. IF TURBID WATER IS LEAVING THE GEOTEXTILE BAG, THE CONTRACTOR SHALL SHUT OFF THE PUMP TO ALLOW SEDIMENTS TO SETTLE INTO THE BAG. CONTRACTOR SHALL FOLLOW THE MANUFACTURER'S SPECIFICATIONS FOR DETERMINING THE SEDIMENT CAPACITY OF THE GEOTEXTILE BAG USING GOOD COMMON SENSE. SEDIMENT LEVELS CONTAINED IN THE BAG SHALL BE MONITORED TO MEASURE THE LOSS OF STORAGE CAPACITY OVER TIME. THE CONTRACTOR SHALL PROPERLY DISPOSE OF THE GEOTEXTILE BAG IN A WASTE RECEPTACLE ONCE IT IS NO LONGER USED.
- . DURING DEWATERING ACTIVITIES THE CONTRACTOR SHALL MONITOR DEWATERING PRACTICES AND KEEP A LOG OF THE FOLLOWING:
- A. DISCHARGE DURATION AND SPECIFIED PUMPING RATE.
- B. OBSERVED WATER TABLE AT TIME OF DEWATERING
- C. MAINTENANCE ACTIVITIES
- D. NAME AND QUANTITY OF POLYMER USED. PRODUCT TYPE. APPLICATION RATE OF POLYMER IN POUNDS/ACRE FEET OF WATER. DATE AND TIME APPLIED. WEATHER CONDITIONS DURING APPLICATION. METHOD OF APPLICATION.

AREA WITH STANDING WATER TO AVOID SUCKING SEDIMENT FROM GRADE.

THIS LOG NEEDS TO BE KEPT ON SITE FOR WDNR REGULATORY REVIEW. COPIES OF THIS DOCUMENTATION SHOULD BE KEPT IN THE CONTRACTOR'S MONITORING LOG AND MADE AVAILABLE UPON REQUEST. REVIEW THE FOLLOWING FOR MORE INFORMATION:


- WDNR TECHNICAL STANDARD 1061 FOR DEWATERING -
- http://dnr.wi.gov/topic/stormWater/documents/Dewatering_1061.pdf
- WDNR TECHNICAL STANDARD 1051 FOR POLYMER http://dnr.wi.gov/topic/stormWater/documents/dnr1051.pdf

TABLE 1 - MAXIMUM PERIOD OF BARE SOIL FOR SLOPES GREATER THAN 20%						
SLOPE AREA DRAINS TO SEDIMENT BASIN? LAND DISTURBANCE BETWEEN LAND DISTURBANCE BETWEEN MAY 2 AND SEPT. 15						
YES	90 DAYS	90 DAYS				
NO	60 DAYS 30 DAYS					
TABLE FROM WI DNR GUIDANCE DOC # 3800-2015-06						

INSPECT ALL EROSION CONTROL MEASURES PRIOR TO COMMENCING GRADING, GRUBBING OR OTHER LAND DISTURBING ACTIVITIES. EROSION CONTROL MEASURES MUST BE INSPECTED WEEKLY AND WITHIN 24 HOURS OF EVERY PRECIPITATION EVENT OF 0.50 INCH OR GREATER. IN ADDITION THE CONTRACTOR SHALL CONDUCT DAILY INSPECTIONS AND DOCUMENT CONDITIONS AND REPAIRS MADE, ALONG WITH DATE TIME OF INSPECTION AND WEATHER CONDITIONS IN A DAILY LOG BOOK. THE DAILY LOG BOOK, WEEKLY / 0.50 INCH PRECIPITATION REPORTS. APPROVED PLANS WPDES PERMIT & CHAPTER 30 PERMIT SHALL BE KEPT IN AN ACCESSIBLE LOCATION, LIKE A MAILBOX, WITHIN THE STAGING AREA

AT ABSOLUTELY NO TIME MAY CONSTRUCTION EQUIPMENT, DEBRIS, FILL, ETC. BE PLACED WITHIN WETLANDS, WATERWAYS OR FLOODPLAINS UNLESS IDENTIFIED IN THE PLANS & APPROVED BY DNR/

WOOD POSTS SHALL BE A MINIMUM SIZE OF 1 1/8" > 1 1/8" OF OAK OR HICKORY. 3 - 4 FEET IN ENGTH, BURIED 20-INCHES FENCE POST AND GEOTEXTILE -INTO THE GROUND. ANCHOR ☐ 3" MAX. SUPPORT CORD ---FLOW DIRECTION OR TENSION TAPE FENCE GEOTEXTILE FLOW DIRECTION ----TRENCH SHALL BE A -MIN. 4-INCHES WIDE AND 6-INCHES DEEP BURY AND ANCHOR FABRIC. FOLD - ANCHOR STAKE MATERIAL TO FIT BACKFILL & COMPACT MIN. 18" LONG TRENCH, BACKFILL AND TRENCH WITH EXCAVATED SOIL COMPACT WITH EXCAVATED SOIL. SILT FENCE TIE BACK TRENCH DETAIL (WHEN ADDITIONAL SUPPORT REQUIRED) FLOW DIRECTION FLOW DIRECTION <u>GENERAL NOTES:</u> ADDITIONAL POST DEPTH OR TIE BACKS GEOTEXTILE . MAY BE REQUIRED IN UNSTABLE SOILS. FABRIC 1'-0" MIN. (SEE DETAIL) ATTACH THE FABRIC TO THE POSTS WITH - WOOD (SEE DETAIL) WIRE STAPLES OR WOODEN LATH AND NAILS — GEOTEXTILE FABRIC 1'-0" MIN *8'-0" POST SPACING ALLOWED IF A WOVEN GEOTEXTILE FABRIC IS USED IF POSSIBLE, CONSTRUCT SILT FENCE FROM A CONTINUOUS ROLL TO AVOID JOINTS. IF A JOINT IS NECESSARY. USE ONE OF THE FOLLOWING METHODS: WOOD -(1)TWIST METHOD: OVERLAP END POSTS & TWIST AT LEAST 180 DEGREES. (2)HOOK METHOD: HOOK THE END OF EACH SILT FENCE LENGTH. HOOK METHOD **AXONIMETRIC VIEW** JOINING TWO LENGTHS OF SILT FENCE FILTER FABRIC SILT FENCE DETAIL C201

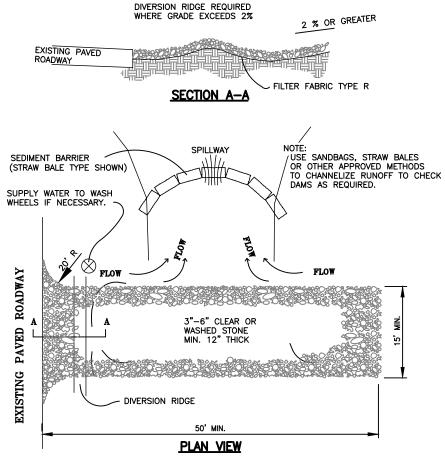

GENERAL NOTES:

THE AGGREGATE SIZE FOR CONSTRUCTION OF THE PAD SHALL BE 3- TO 6-INCH STONE. PLACE THE GRAVEL TO THE SPECIFIC GRADE & DIMENSIONS SHOWN ON THE PLANS & GRADE TO CREATE A SMOOTH SURFACE. THE THICKNESS OF THE PAD SHALL NOT BE LESS THAN 12 INCHES. USE GEOTEXTILE FABRICS, IF NECESSARY, TO IMPROVE STABILITY OF THE FOUNDATION IN LOCATIONS SUBJECT TO SEEPAGE OR HIGH WATER

THE WIDTH OF THE PAD SHALL NOT BE LESS THAN THE FULL WIDTH OF ALL POINTS OF INGRESS OR EGRESS & IN ANY CASE SHALL NOT BE LESS THAN 15 FEET WIDE. THE LENGTH OF THE PAD SHALL BE AS REQUIRED, BUT NOT LESS THAN 50 FEET.

LOCATE CONSTRUCTION ENTRANCES & EXITS TO LIMIT SEDIMENT LEAVING THE SITE & TO PROVIDE FOR MAXIMUM UTILITY BY ALL CONSTRUCTION VEHICLES. AVOID ENTRANCES WHICH HAVE STEEP GRADES & ENTRANCES AT CURVES IN PUBLIC ROADS.


THAT WILL PREVENT TRACKING OR FLOWING OF SEDIMENT ONTO PUBLIC RIGHTS-OF-WAY. THIS MAY REQUIRE PERIODIC TOP DRESSING WITH ADDITIONAL STONE & REPAIR AND/OR CLEANOUT OF ANY MEASURES USED TO

ALL SEDIMENT SPILLED, DROPPED, WASHED OR TRACKED ONTO PUBLIC RIGHTS-OF-WAY SHALL BE REMOVED BY THE END OF THE WORK DAY. PROVIDE DRAINAGE FOR A 2 YEAR — 24 HOUR EVENT O CARRY WATER TO A SEDIMENT TRAP OR OTHER

- INLET SPECIFICATIONS AS PER THE PLAN

WHEN NECESSARY, WHEELS SHALL BE CLEANED TO RIGHTS-OF-WAY. WHEN WASHING IS REQUIRED. DRAINS INTO AN APPROVED SEDIMENT TRAP OR

STONE TRACKING CONSTRUCTION ENTRANCE

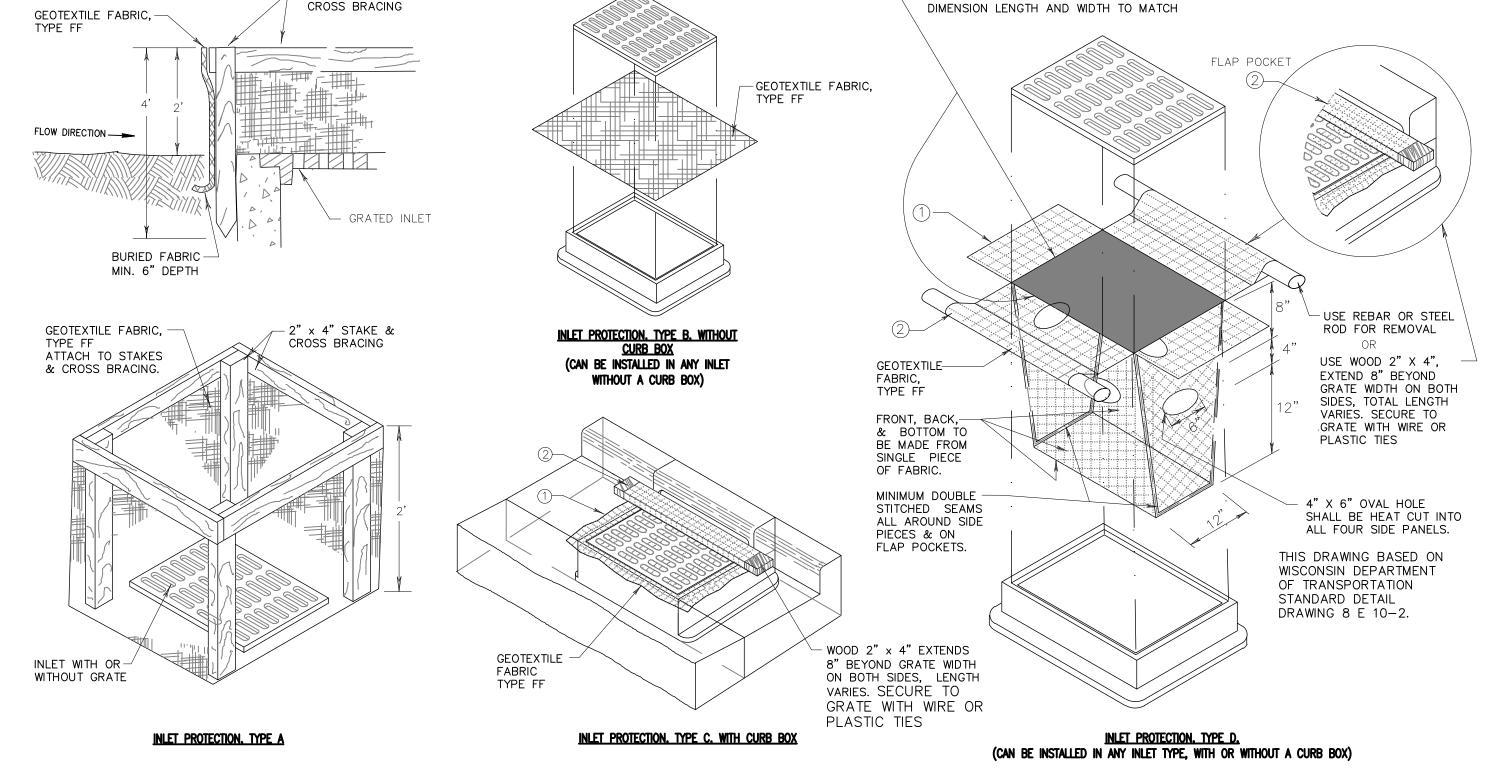

GENERAL NOTES

MANUFACTURED ALTERNATIVES APPROVED AND LISTED ON THE DEPARTMENT'S EROSION CONTROL PRODUCT ACCEPTABILITY LIST MAY BE

FABRIC DOES NOT FALL INTO THE INLET. ANY MATERIAL FALLING INTO THE INLET SHALL BE REMOVED IMMEDIATELY. TO FINISHED SIZE SHALL EXTEND A MINIMUM OF 10" AROUND THE PERIMETER TO FACILITATE MAINTENANCE OR REMOVAL. SIDE FLAPS, WHERE REQUIRED SHALL BE A MIN. OF TWO INCHES LONG. FOLD THE FABRIC OVER AND REINFORCE WITH MULTIPLE STITCHES.

WHEN REMOVING OR MAINTAINING INLET PROTECTION, CARE SHALL BE TAKEN SO THAT THE SEDIMENT TRAPPED ON THE GEOTEXTILE

⑤ FOR INLET PROTECTION, TYPE C (WITH CURB BOX), FLAP POCKETS SHALL BE LARGE ENOUGH TO ACCEPT WOOD 2"X4". THE REBAR, $^\prime$ STEEL PIPE, OR WOOD SHALL BE INSTALLED IN THE FLAP AND NOT BLOCK THE TOP HALF OF THE CURB BOX OPENING.


2" x 4" STAKE AND

INSTALLATION NOTES

TRIM EXCESS FABRIC A MINIMUM OF 10" AROUND GRATE FOR MAINTENANCE OR REMOVAL. THE CONTRACTOR SHALL DEMONSTRATE A METHOD OF MAINTENANCE, USING A SEWN FLAP, HAND HOLDS OR OTHER METHOD TO PREVENT ACCUMULATED SEDIMENT FROM ENTERING THE INLET.

UTILIZE INLET PROTECTION TYPE D IN INLETS DEEPER THAN 30", MEASURED FROM THE BOTTOM OF THE INLET TO THE TOP OF THE GRATE. THE INSTALLED BAG SHALL HAVE A MINIMUM SIDE CLEARANCE, BETWEEN THE INLET WALLS AND THE BAG, MEASURED AT THE BOTTOM OF THE OVERFLOW HOLES, OF 3". WHERE NECESSARY THE CONTRACTOR MAY CINCH THE BAG, USING PLASTIC ZIP TIES, TO FIT INLETS LESS THAN 30" DEPTH. THE TIES SHALL BE PLACED AT A MAXIMUM OF 4" FROM THE BOTTOM OF THE BAG.



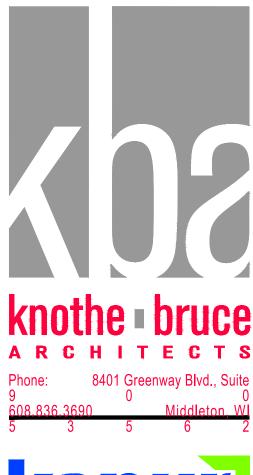



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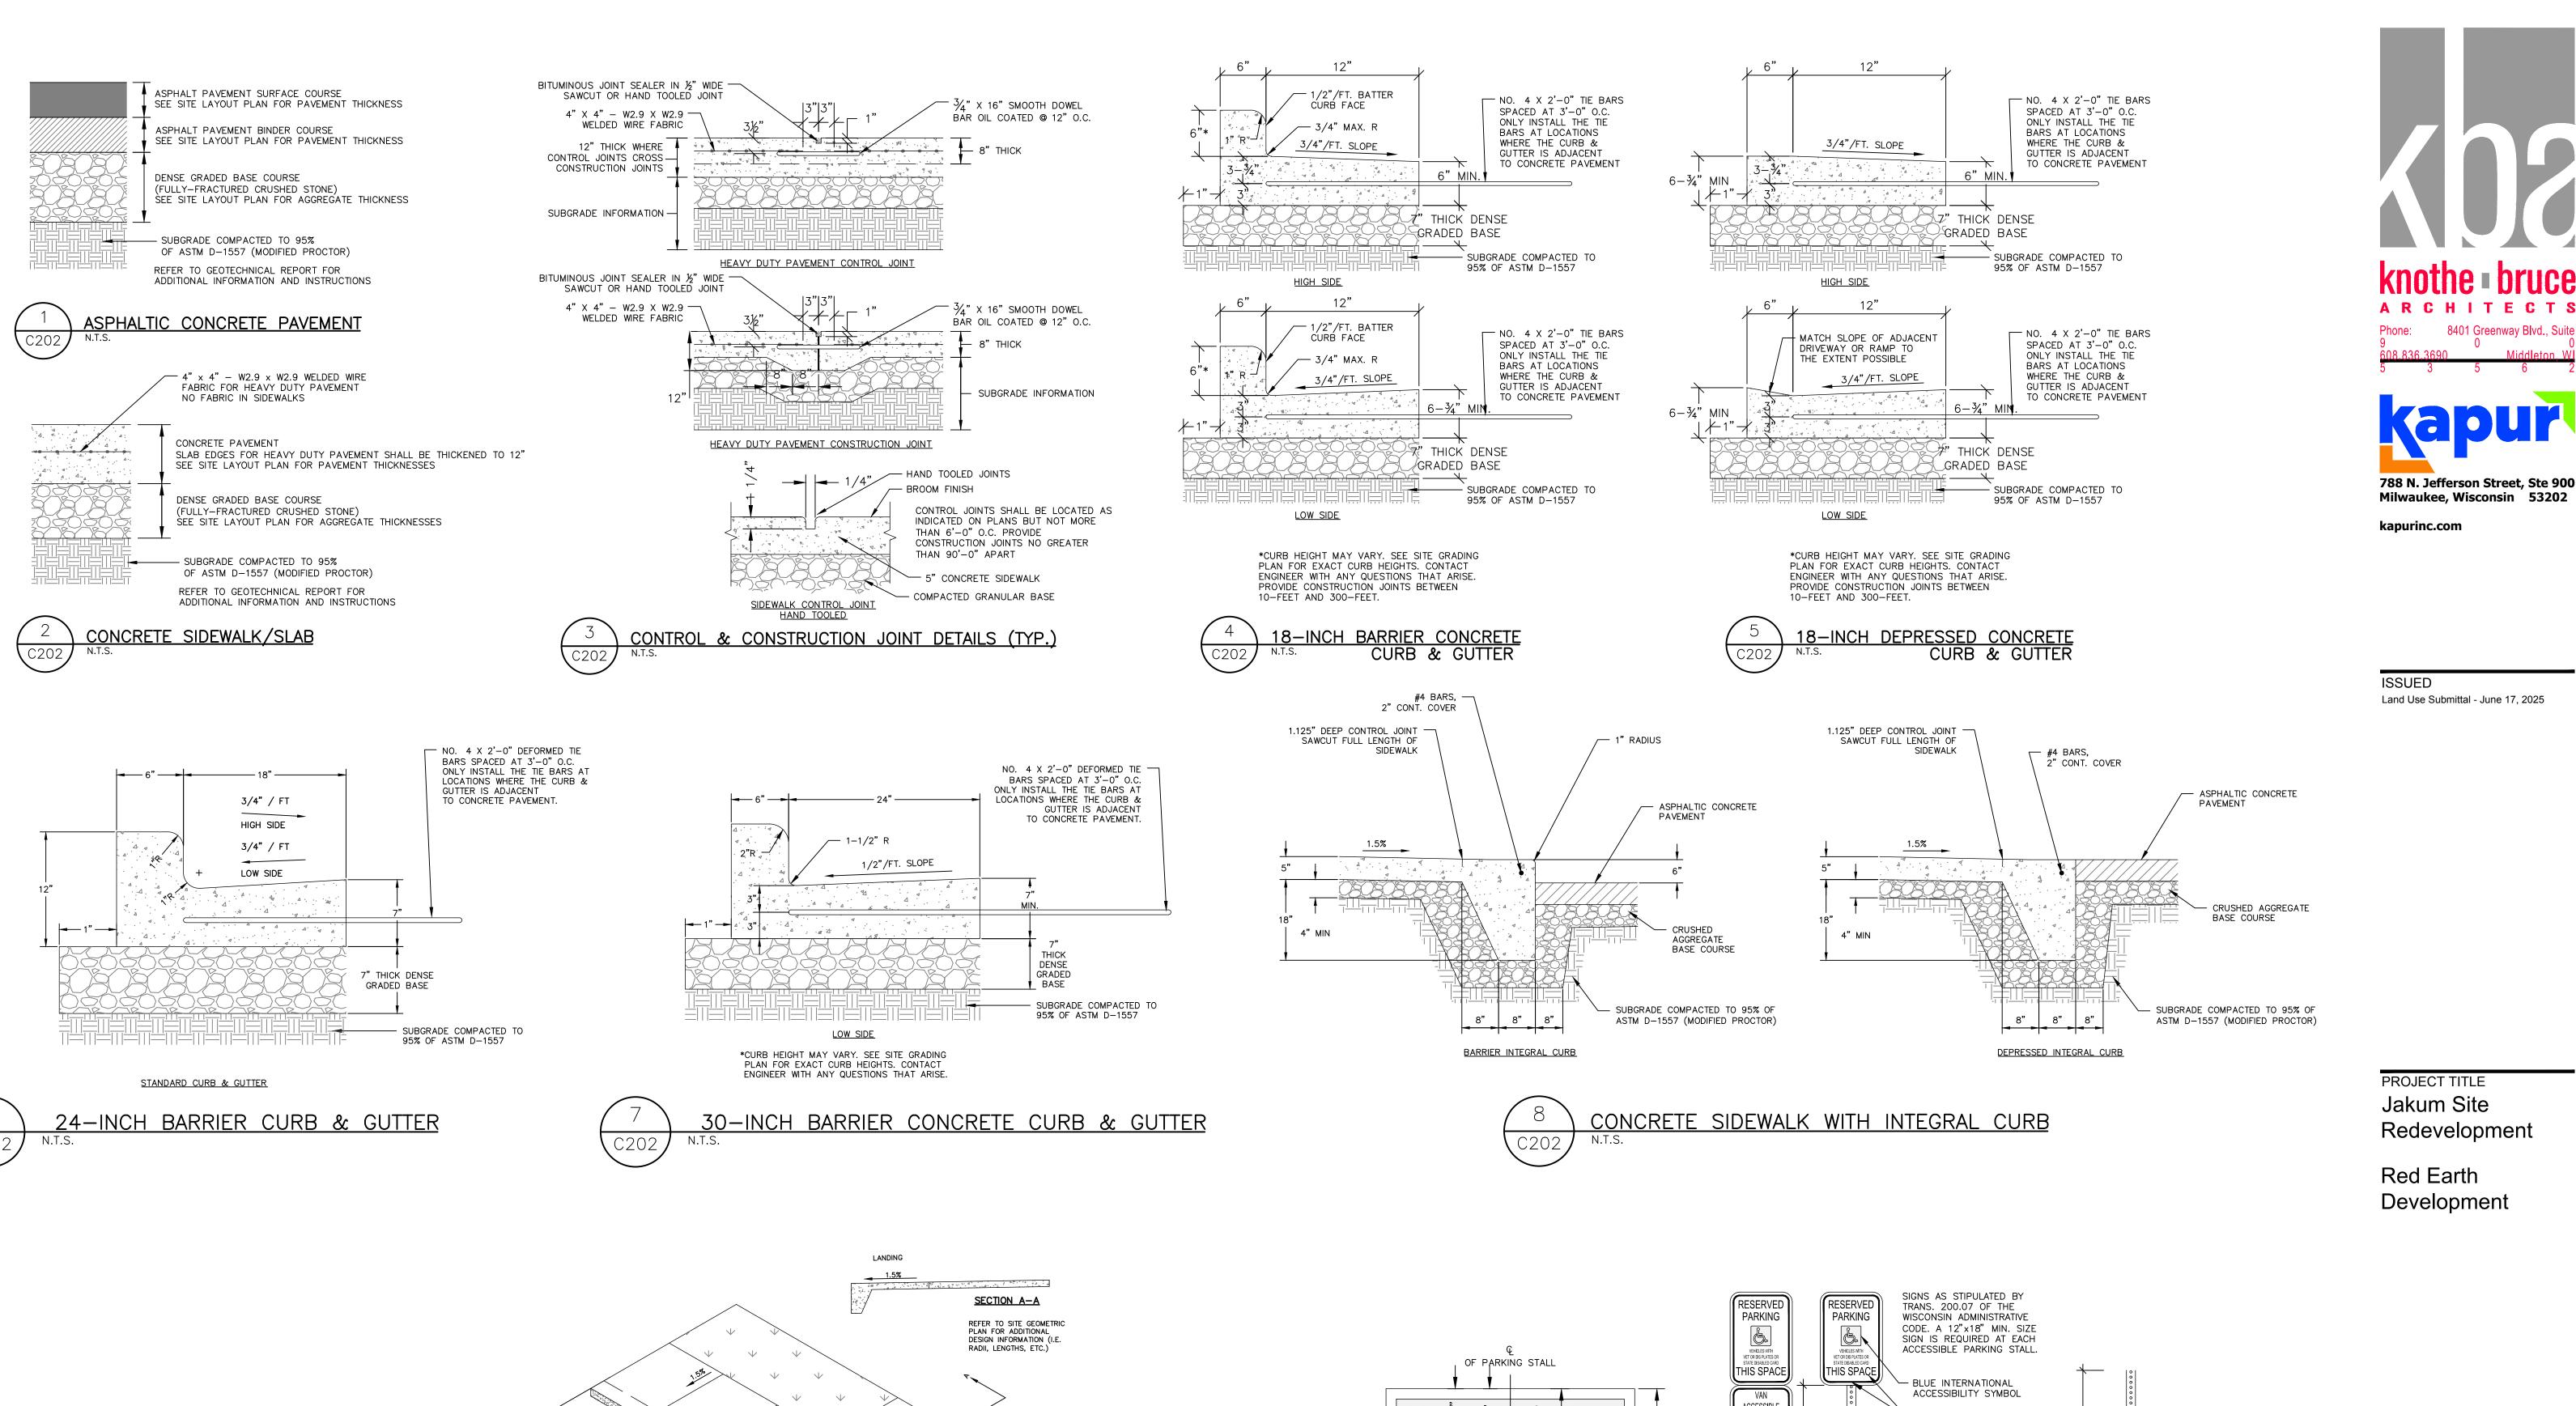
PROJECT TITLE Jakum Site Redevelopment


Red Earth Development


N. 15th St. & Luedke Ct. Sheboygan, Wisconsin SHEET TITLE SITE EROSION CONTROL **DETAILS**

SHEET NUMBER

PROJECT NO.



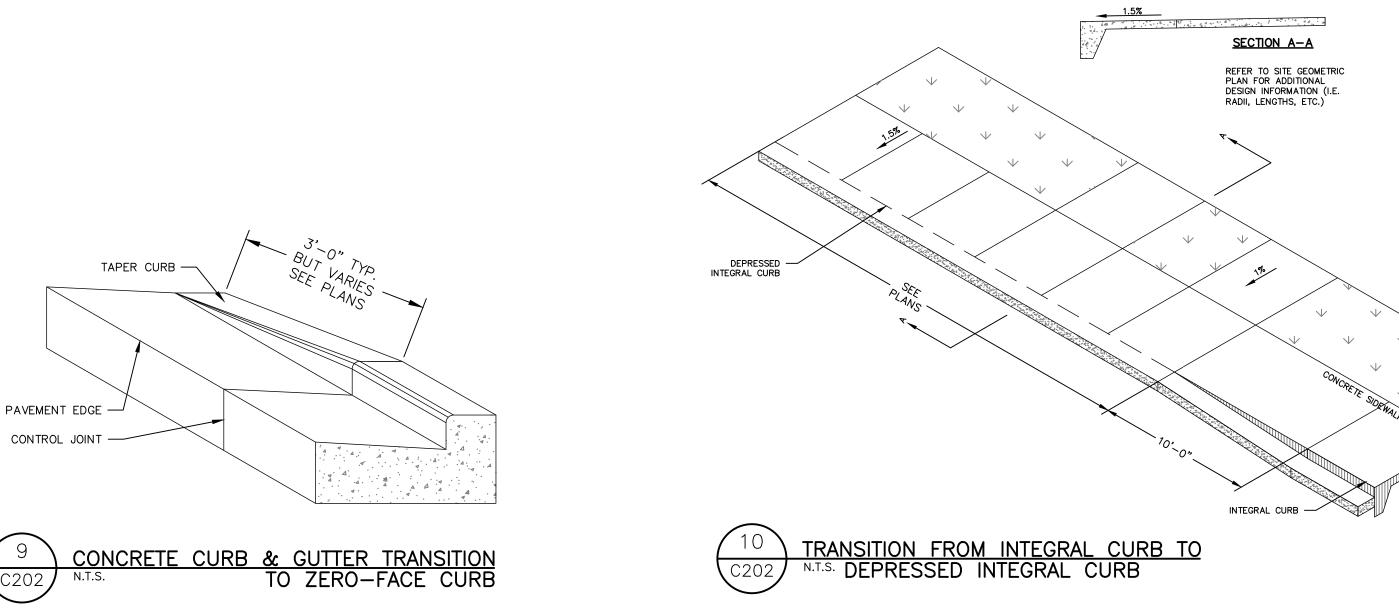

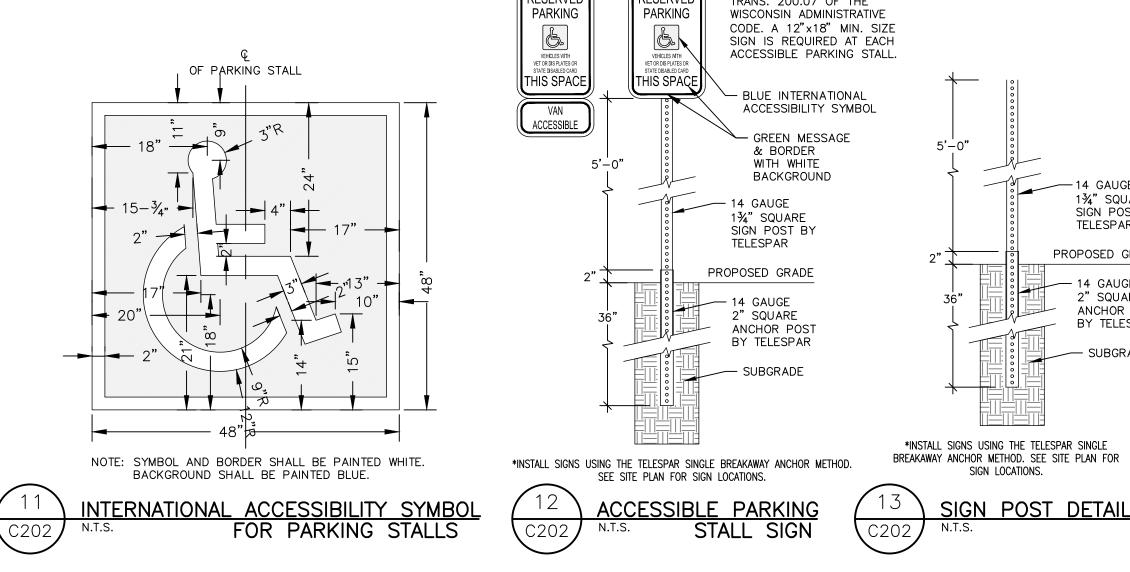

788 N. Jefferson Street, Ste 900 Milwaukee, Wisconsin 53202 kapurinc.com ISSUED Land Use Submittal - June 17, 2025 PROJECT TITLE Jakum Site Redevelopment Red Earth Development N. 15th St. & Luedke Ct. Sheboygan, Wisconsin SHEET TITLE SITE DETAILS

-14 GAUGE 1¾" SQUARE

TELESPAR

PROPOSED GRADE

— 14 GAUGE 2" SQUARE

SIGN LOCATIONS.

SIGN POST BY


ANCHOR POST

BY TELESPAR

- SUBGRADE

SHEET NUMBER

PROJECT NO.

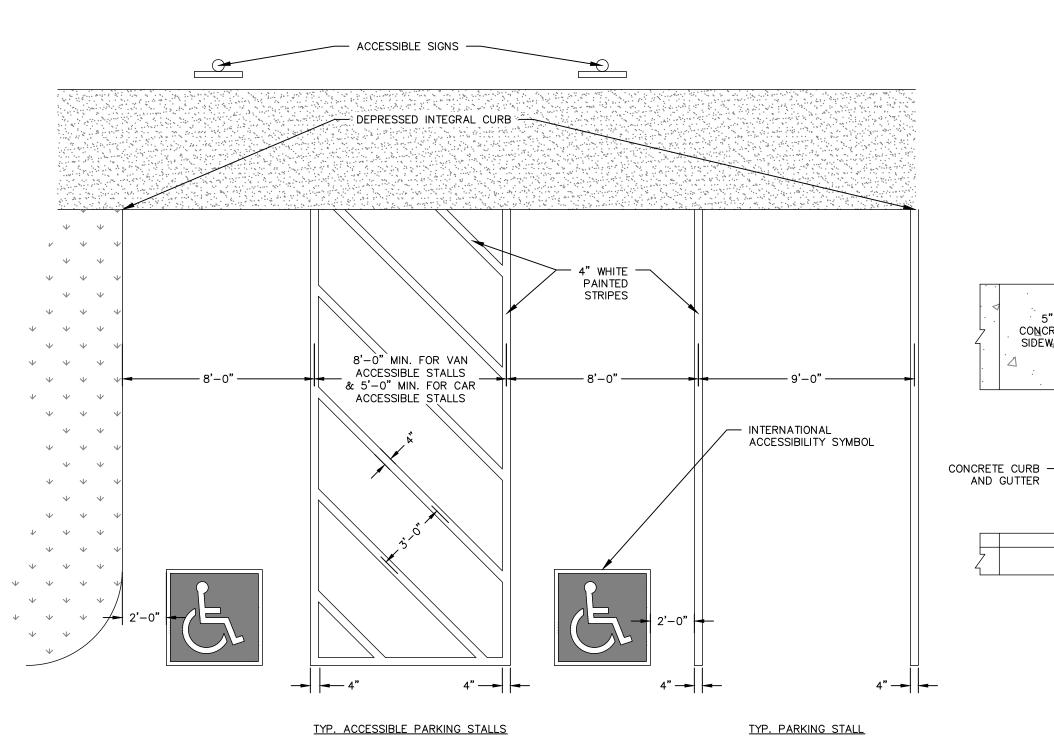


ACCESSIBLE PARKING STALL MARKING

PROPOSED


BUILDING

VARIES - SEE PLANS

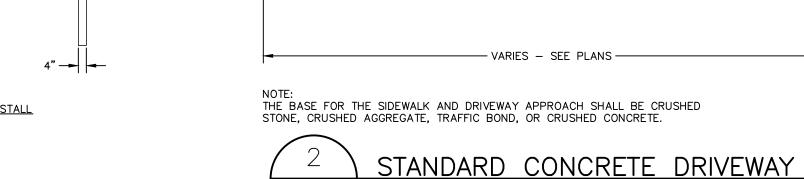

CONCRETE

SIDEWALK

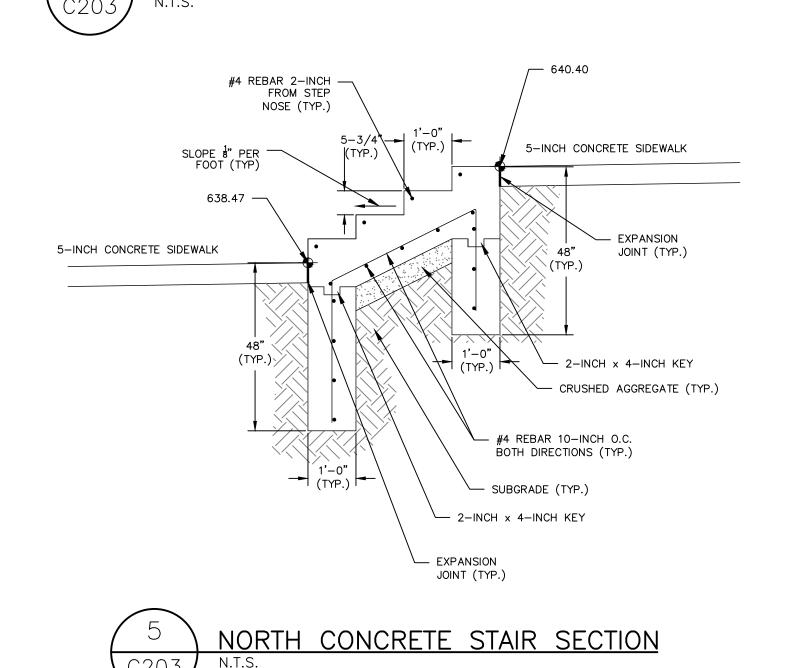

VARIES - SEE PLANS -

SIDEWALK THROUGH DRIVEWAY SHALL HAVE A MAXIMUM TRANSVERSE PITCH OF ONE QUARTER INCH PER FOOT DOWN

TOWARD STREET

2" FELT EXPANSION JOINT

DRIVEWAY FLARE

WITH CURB TRANSITION

SHALL EQUAL 6'-0"


– VARIES – SEE PLANS —

CONCRETE


, SIDEWALK

- CONCRETE DRIVEWAY APPROACH

CONCRETE SIDEWALK AND BASE TO MATCH APRON

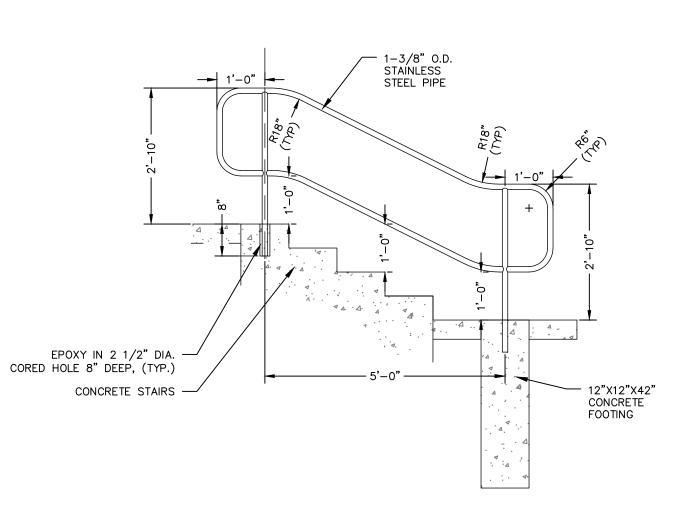




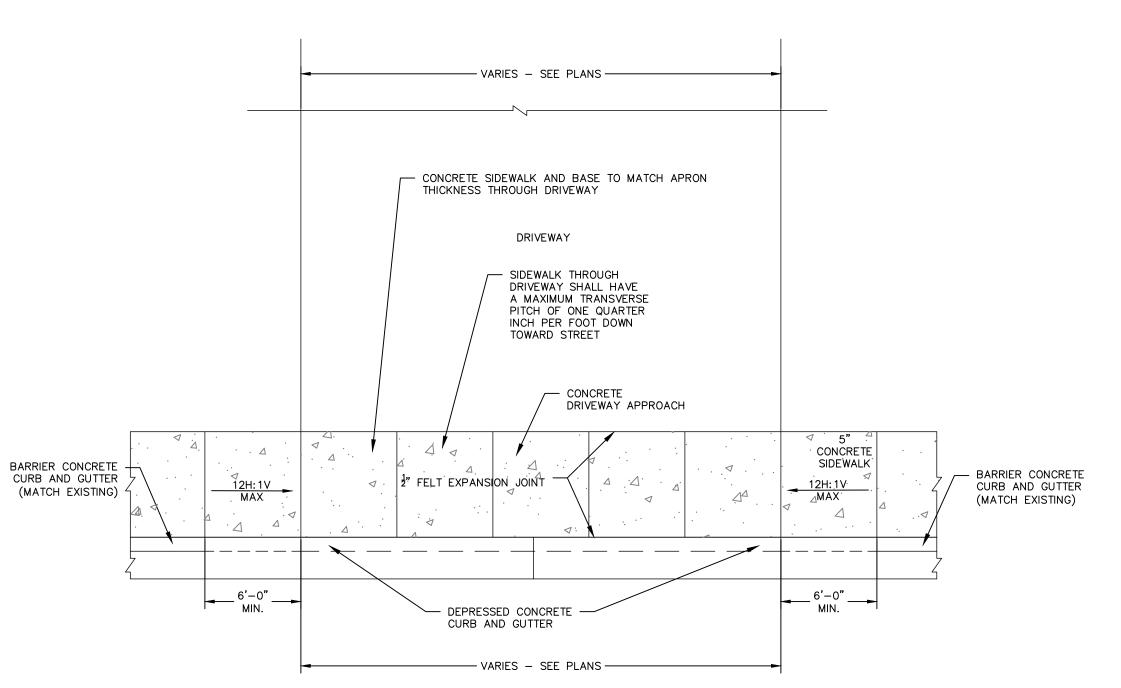


NOTE: THE BASE FOR THE SIDEWALK AND DRIVEWAY APPROACH SHALL BE CRUSHED STONE, CRUSHED AGGREGATE, TRAFFIC BOND, OR CRUSHED CONCRETE.



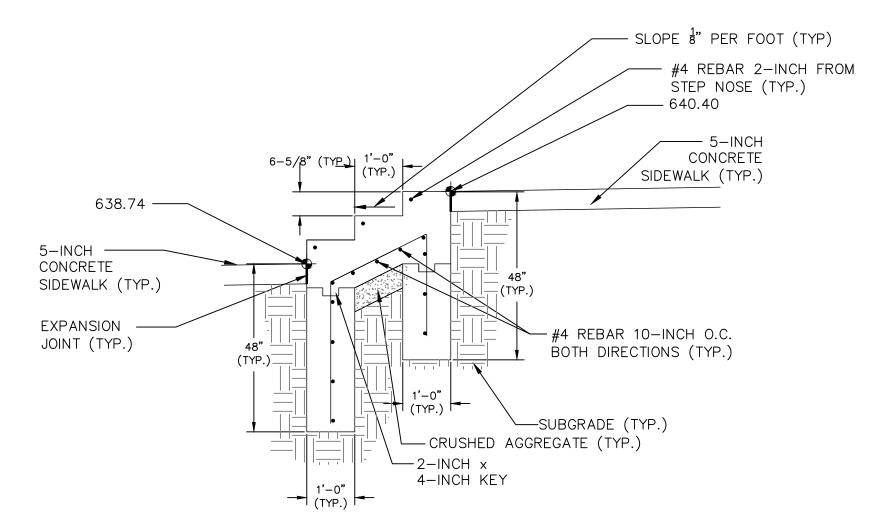



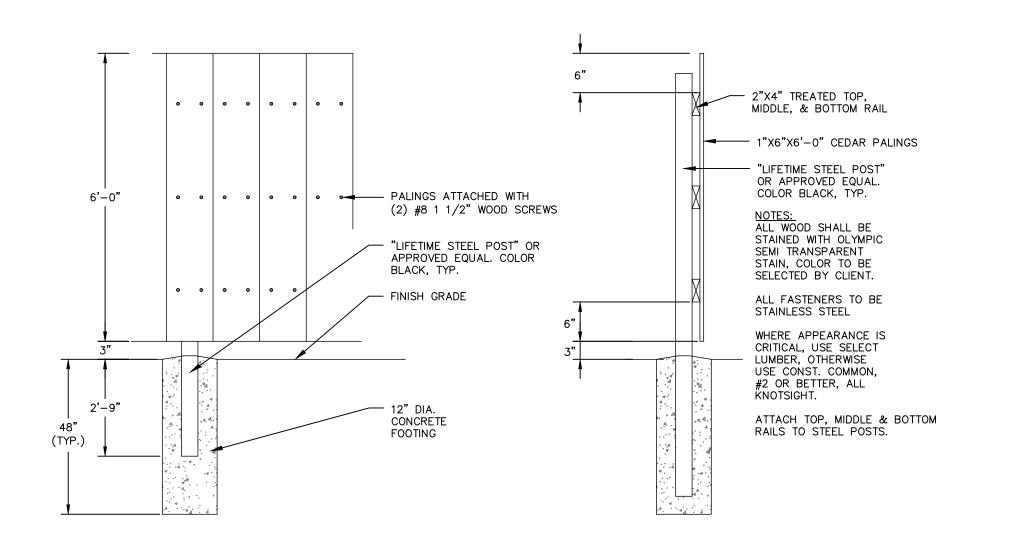

6'-0" HIGH CEDAR PALING PRIVACY FENCE



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Red Earth Development


N. 15th St. & Luedke Ct. Sheboygan, Wisconsin SHEET TITLE SITE DETAILS

SHEET NUMBER

C203


PROJECT NO.


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ASPHALTIC CONCRETE PAVEMENT

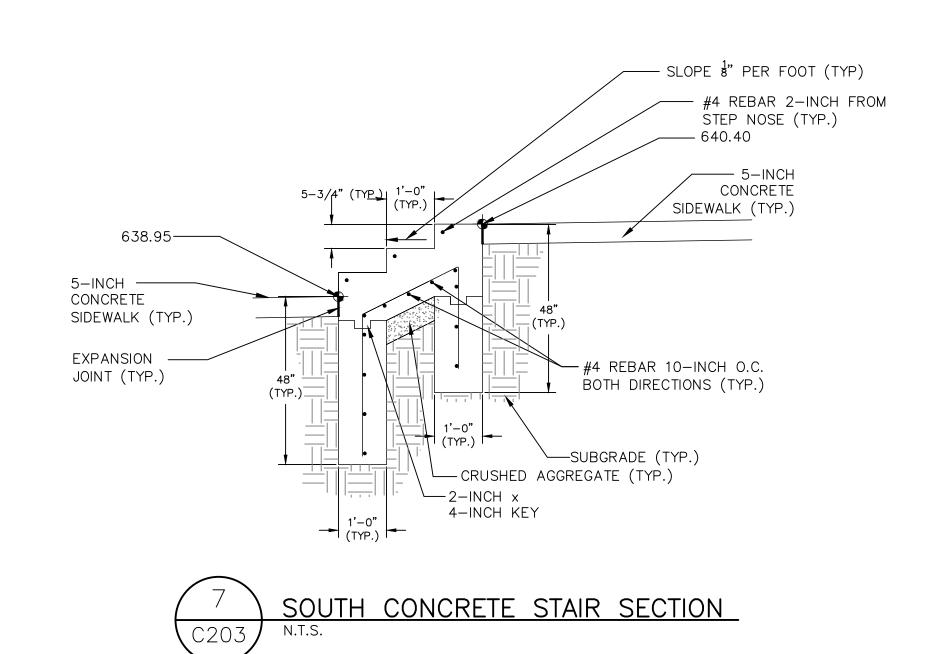RAISED CONCRETE STEP




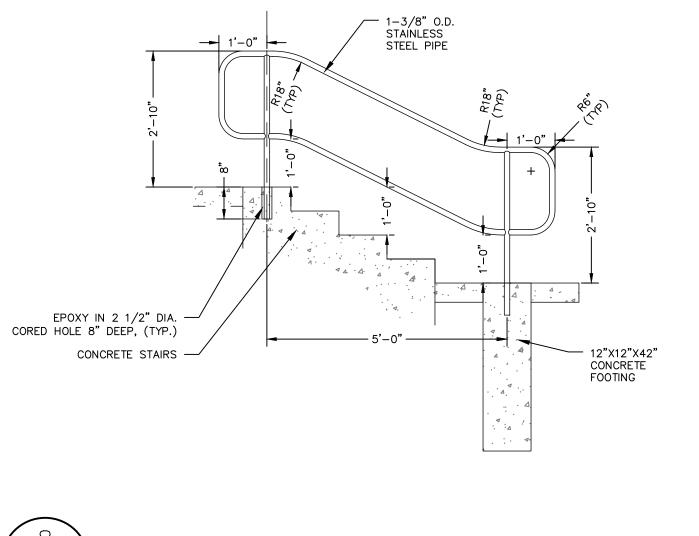

STORM MANHOLE NOTES:

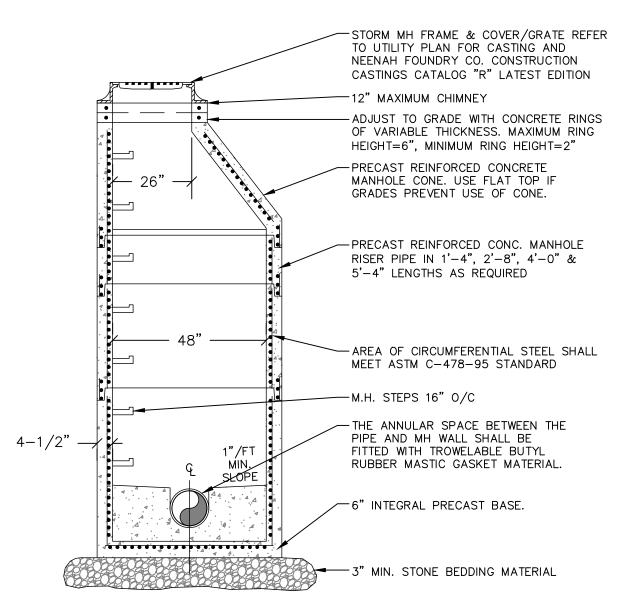
- PRECAST CONCRETE ADJUSTING RINGS TO BE REINFORCED WITH ONE HOOP OF STEEL CENTERED WITHIN THE RING. WHERE NECESSARY, RINGS SHALL BE GROOVED TO RECEIVE STEP.
- 2.) CONCRETE AND STEEL REINFORCEMENT SHALL CONFORM TO DESIGNATION C-478 REQUIREMENTS OF ASTM SPECIFICATIONS.
- 3.) JOINTS SHALL BE WATERTIGHT AND SHALL BE MADE USING RUBBER GASKETS OR BUTYL RUBBER MASTIC MATERIAL.
- 4.) 3" MIN. BEDDING MATERIAL REQUIRED UNDER MANHOLE BASE AND BACKFILLED STRUCTURE WITH GRANULAR BACKFILL MATERIAL.
- 5.) SEE STANDARD SPECIFICATIONS, FILE NO. 12 FOR PRECAST MANHOLE AND FILE NO. 13 FOR MANHOLE INVERTS, INCLUDING INVERTS OF LATERAL SEWERS THAT CONNECT DIRECTLY TO MANHOLES.



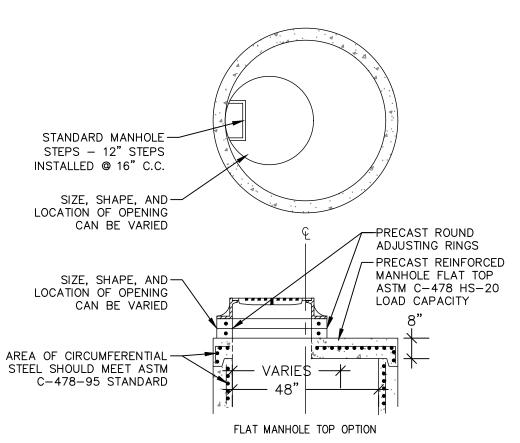


NOTE: USE ONLY WHEN LACK OF COVER PREVENTS USE OF CONE MANHOLE



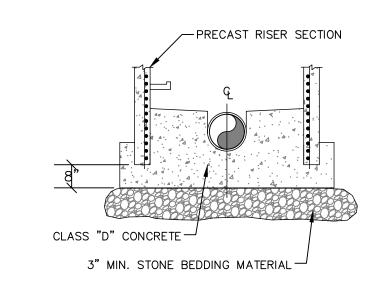




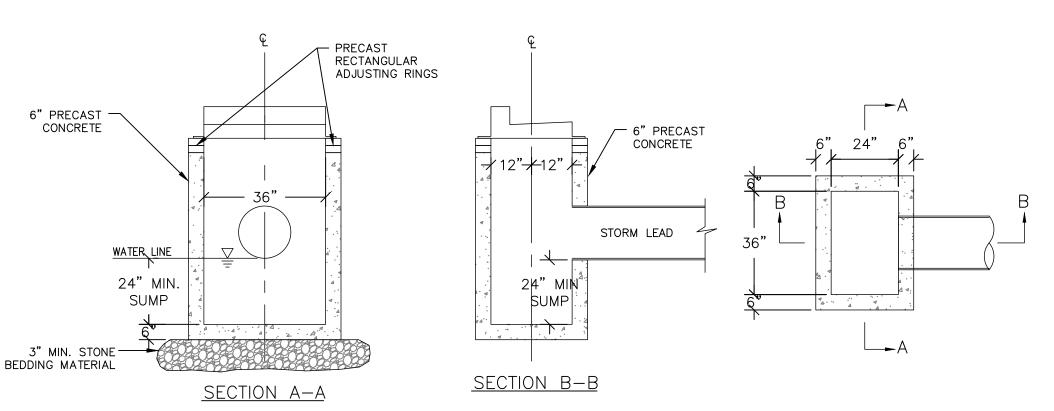


MANUFACTURED TO WISCONSIN DEPARTMENT OF TRANSPORTATION SPECIFICATIONS REFER TO SITE UTILITY PLAN FOR INFORMATION REGARDING PIPE LOCATIONS, PIPE DIAMETERS, PIPE INVERTS, RIM ELEVATIONS, AND FRAMES & GRATES.



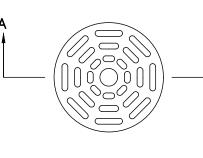

REFER TO UTILITY PLAN FOR GRATE CASTING AND NEENAH FOUNDRY CO. CONSTRUCTION CASTINGS CATALOG "R" LATEST


SECTION A-A

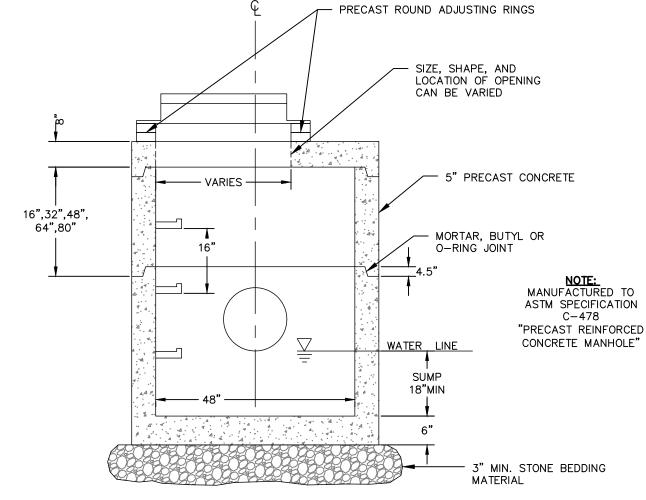

REFER TO SITE UTILITY PLAN FOR FRAME & GRATE & RIM ELEVATION.


48-INCH DIAMETER STORM CATCH BASIN

N.T.S. WITH ROUND FRAME & GRATE

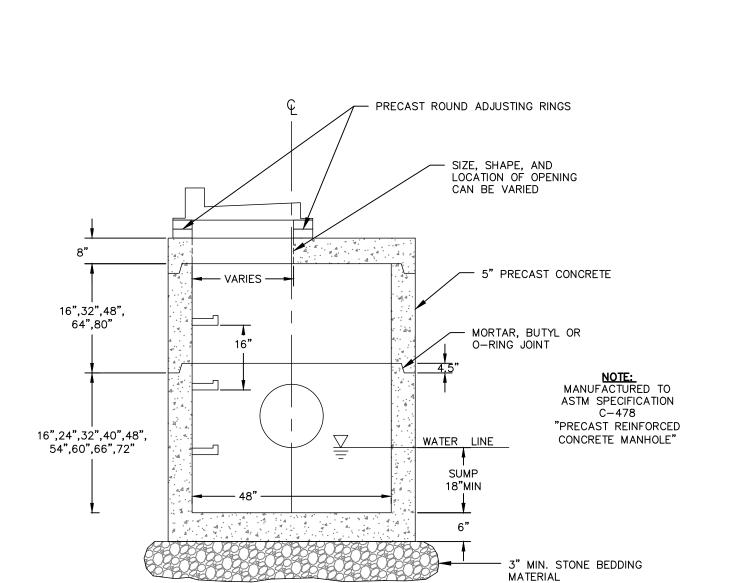


NOTE: REFER TO SITE UTILITY PLAN FOR FRAME & GRATE & RIM ELEVATION.



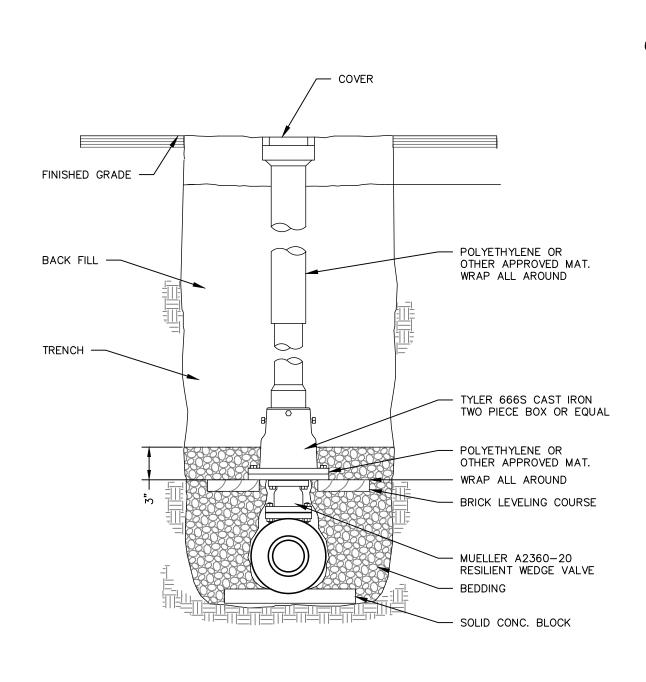




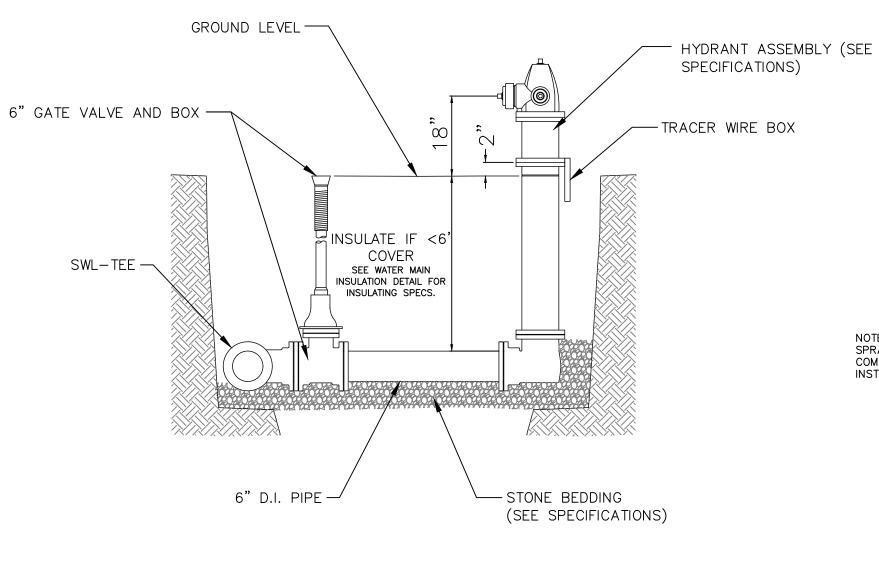

NOTE: 1. ALL JOINTS SHALL BE RESTRAINED. 2. ALL DUCTILE IRON PIPE AND HYDRANT ASSEMBLY SHALL BE POLYWRAPPED.



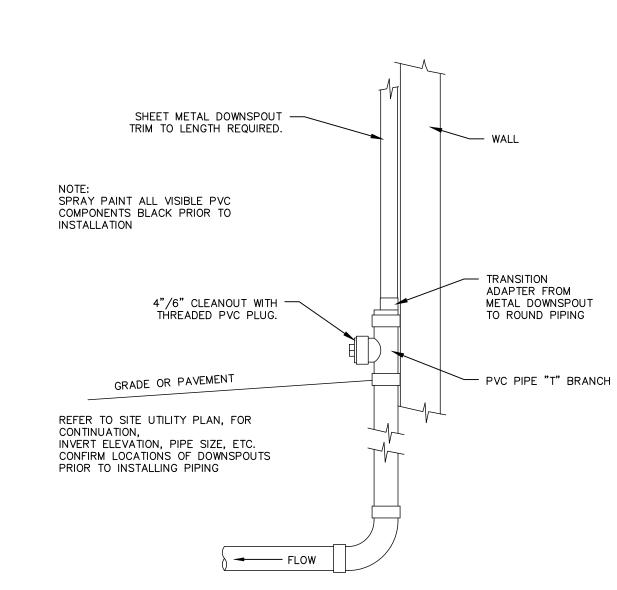

DOWNSPOUT CONNECTION

ARCHITECTS Phone: 8401 Greenway Blvd., Suite 788 N. Jefferson Street, Ste 900 Milwaukee, Wisconsin 53202

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PROJECT TITLE Jakum Site Redevelopment

Red Earth Development


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SHEET TITLE SITE DETAILS

SHEET NUMBER

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PROJECT TITLE

Jakum Site

Redevelopment

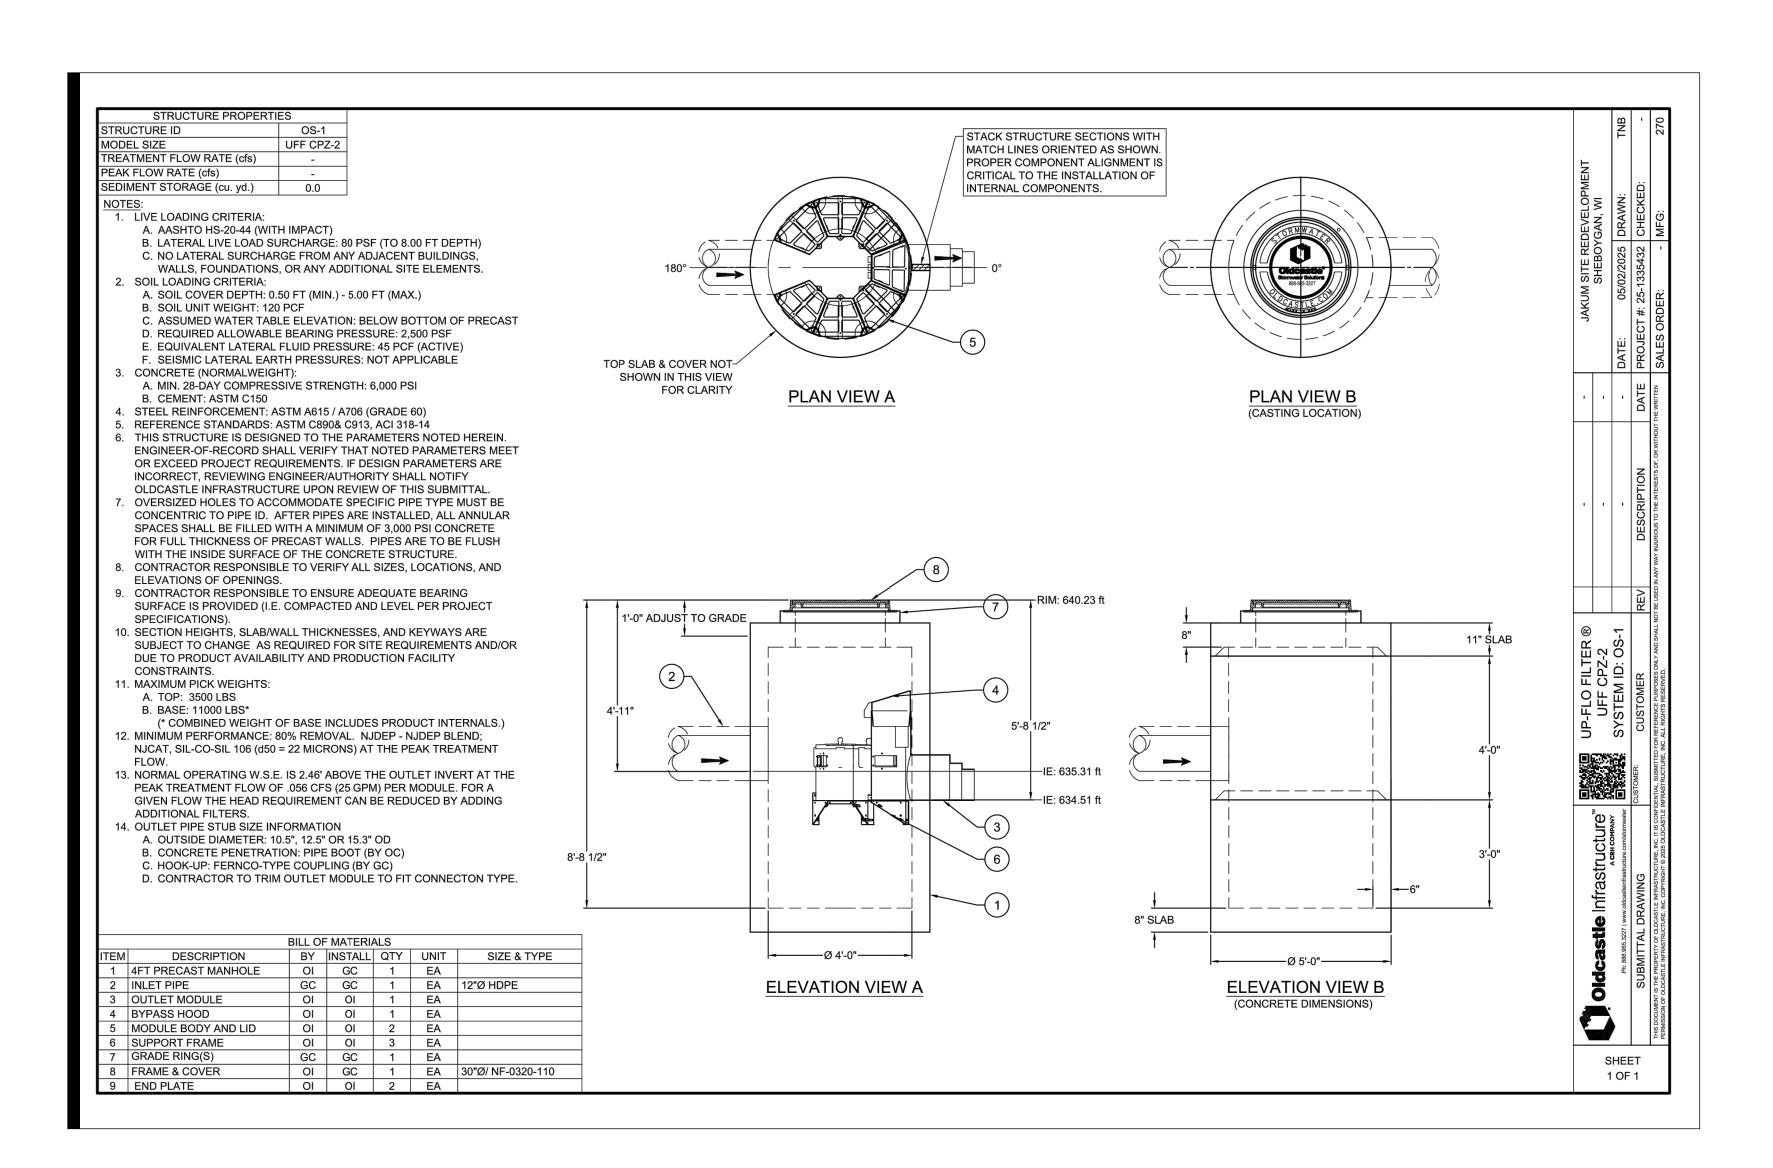Red Earth
Development

N. 15th St. & Luedke Ct.
Sheboygan, Wisconsin
SHEET TITLE
SITE DETAILS


SHEET NUMBER

C205

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PROJECT NO.

2427



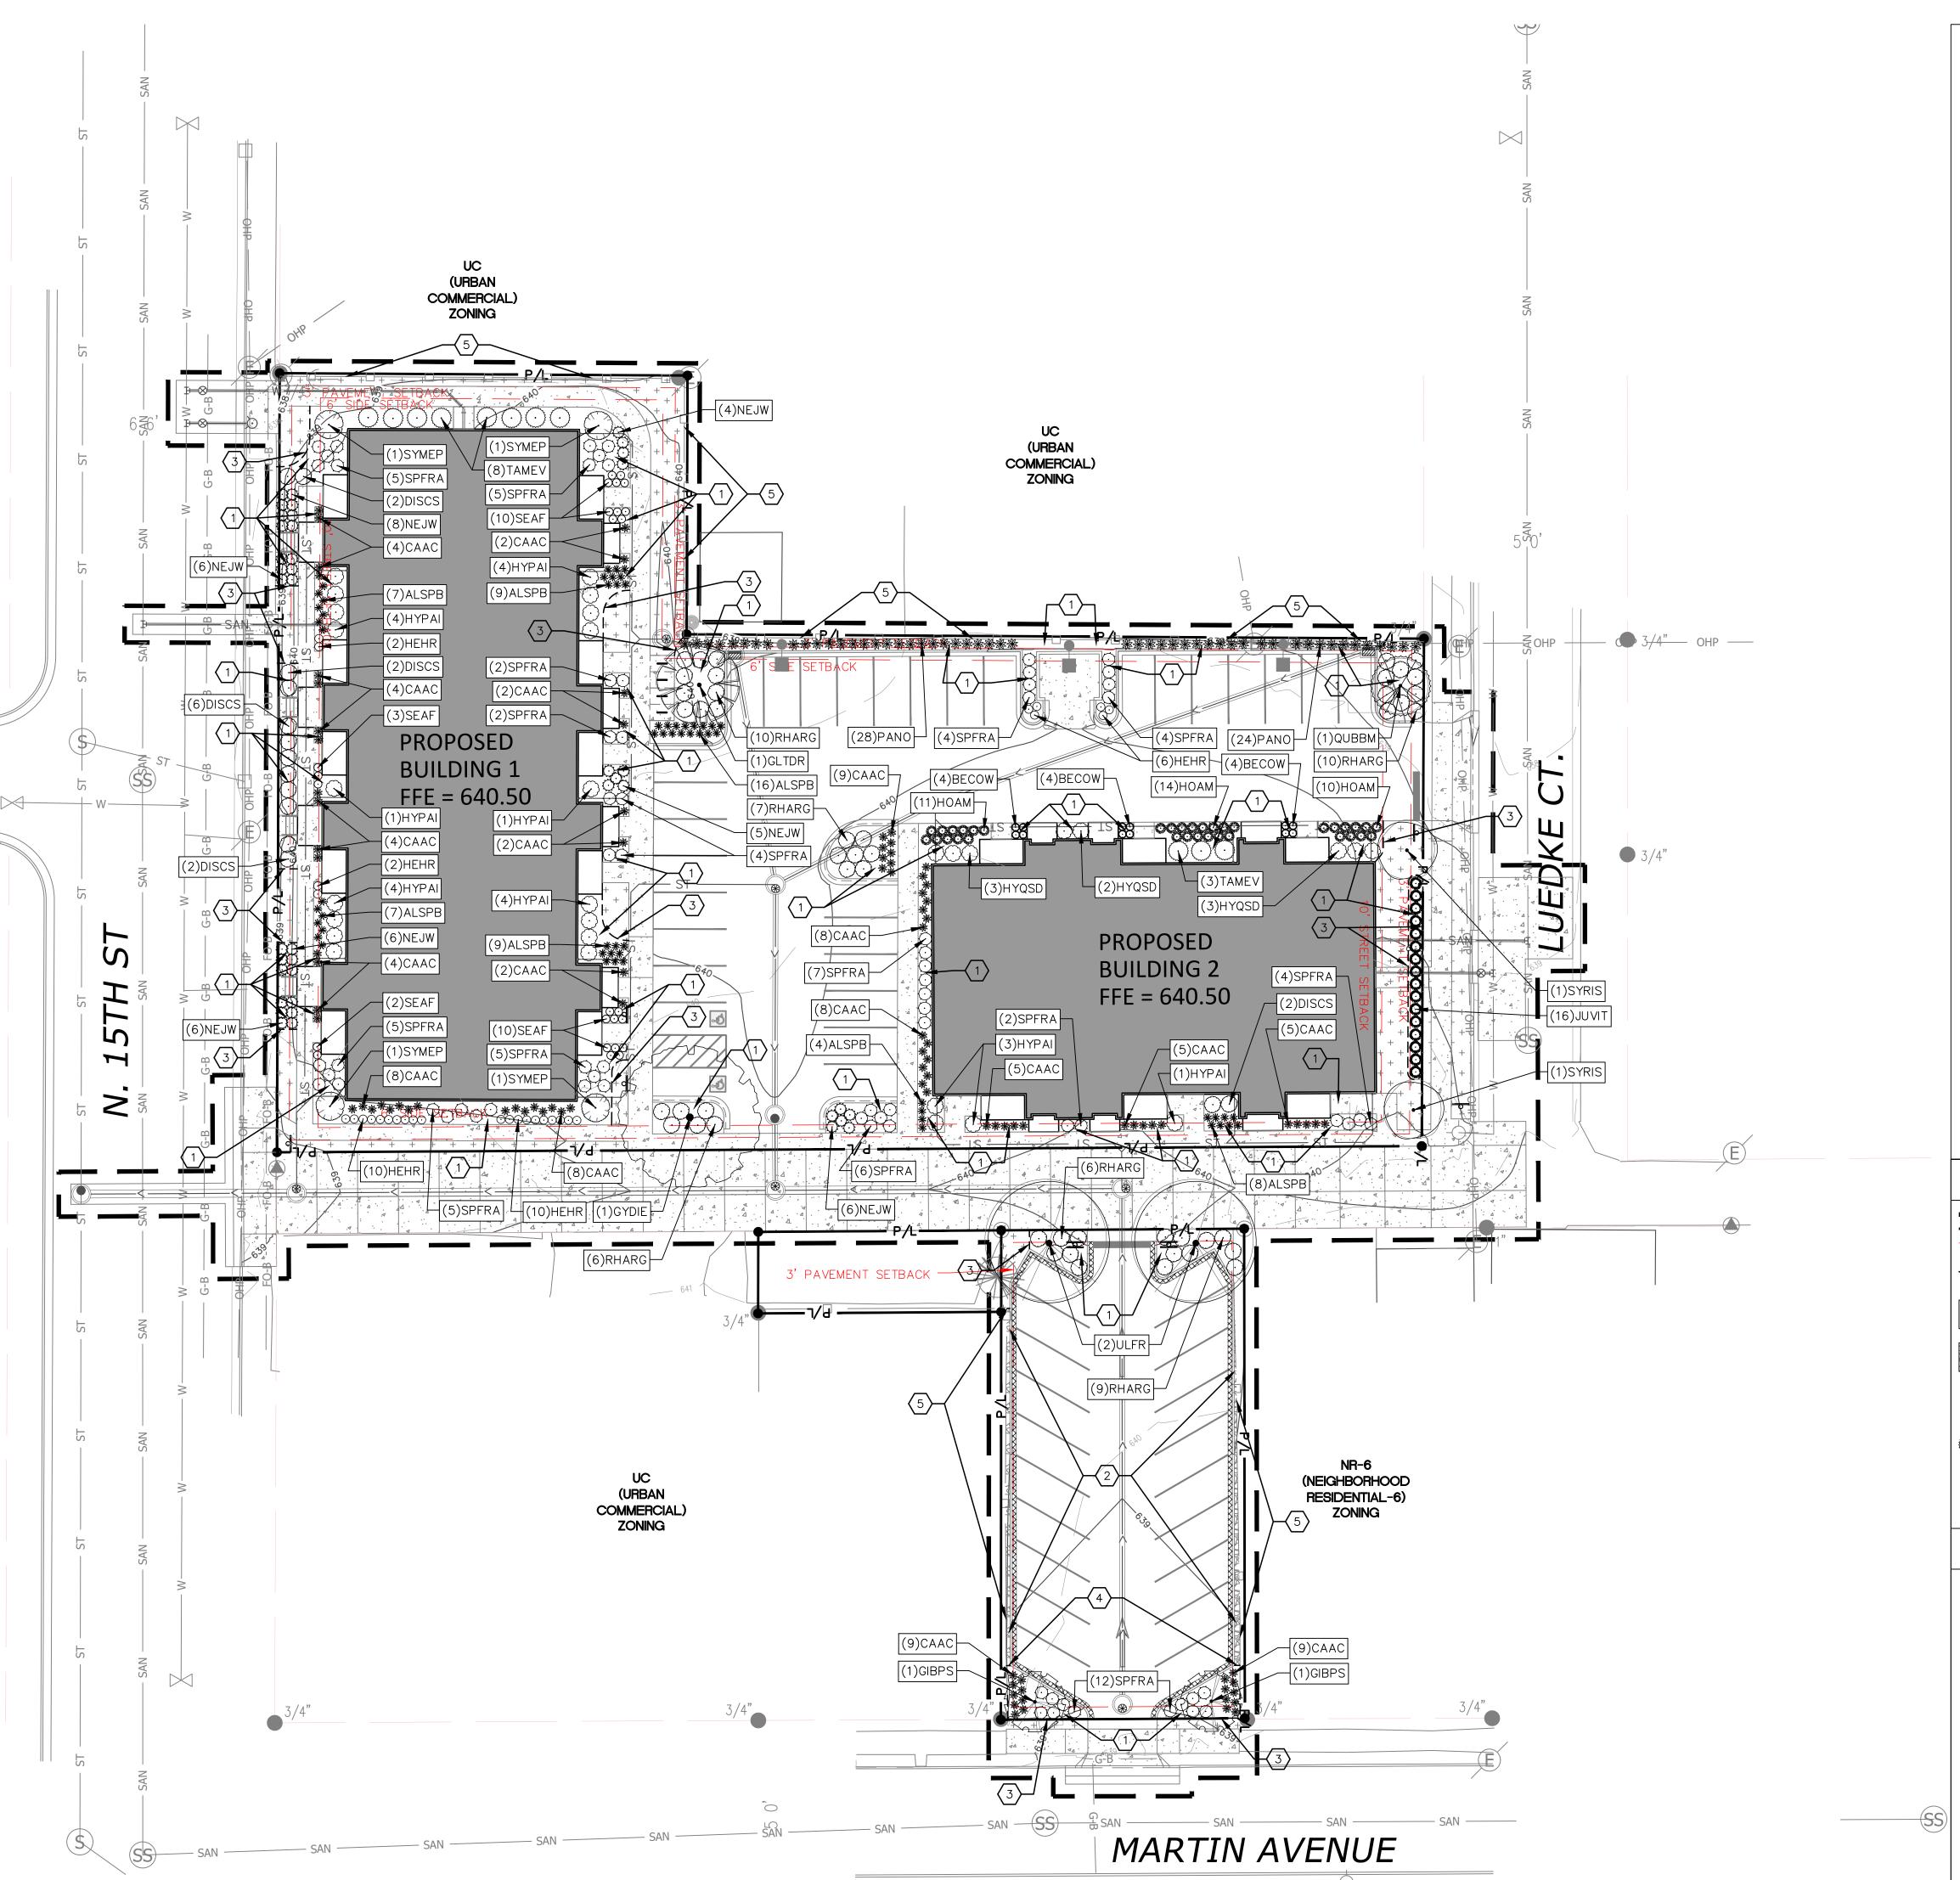

ISSUED

PROJECT TITLE


Jakum Site

Red Earth

Development


Redevelopment

Land Use Submittal - June 17, 2025

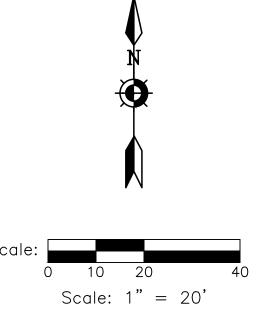

Dial [31] or (800)242-8511 www.DiggersHotline.com

HATCH LEGEND

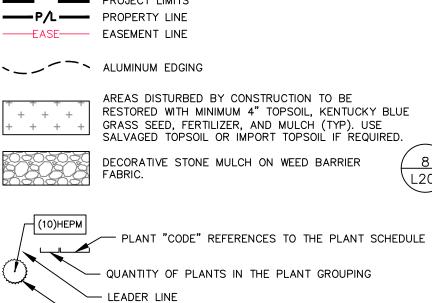

— PLANT SYMBOL (SYMBOL VARIES)

KEY INDEX

SHREDDED HARDWOOD MULCH DECORATIVE STONE MULCH ALUMINUM EDGING AT PLANTING BED ALUMINUM EDGING AT MULCH SEPERATION NEW FENCE (SEE CIVIL PLANS)

9 L201 10 L201 SHEET NUMBER

7 L201 8 L201

N. 15th St. & Luedke Ct.

Sheboygan, Wisconsin

LANDSCAPE

SHEET TITLE


SITE

PLAN

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PROJECT NO.

Plant S	Schedule					
Code	Scientific Name	Common Name	Quantity	Spacing	Install Size	Mature Size
						(Height/Spread
hade and T	all Trees: (Install in accordance with detail 3/L201)					
GIBPS	Ginkgo biloba 'Princeton Sentry'	Princeton Sentry Ginkgo (male)	2	Per Plan	2" caliper B&B	40'/15'
GLTDR	Gleditsia triacanthos 'Draves'	Street Keeper Honeylocust	1 1	Per Plan	2" caliper B&B	45'/20'
GYDIE	Gymnocladus dioicus 'Espresso'	Espresso Kentucky Coffee Tree	1	Per Plan	2" caliper B&B	50'/35'
QUBBM	Quercus bicolor 'Bonnie and Mlke'	Beacon Swamp White Oak	. 1	Per Plan	2" caliper B&B	35'/15'
ULFR	Ulmus 'Frontier'	Frontier Elm	2	Per Plan	2" caliper B&B	40'-50'/25-35'
ladium and	Low Trace: /Install in accordance with detail 2/1 20					
SYRIS	Low Trees: (Install in accordance with detail 3/L20 Syringa reticulata 'Ivory Silk'	lvory Silk Japanese Tree Lilac	2	Per Plan	1.5" caliper B&B	25'/15'
	rees: (Install in accordance with detail 4/L201)				<u></u>	T
JUVIT	Juniperus virginiana 'Taylor'	Taylor Juniper	16	Per Plan	4' tall B&B	25'/2'-3'
eciduous S	hrubs: (Install in accordance with detail 5/L201)				***************************************	
DISCS	Diervilla sessilifolia 'LPDC Podras' PP19,391	Cool Splash Dwarf Bush Honeysuckle	14	Per Plan	24" tall pot	30"/30"-54"
HYPAI	Hydrangea paniculata 'ILVOBO' PP22,782	Bobo Hydrangea	22	Per Plan	24" tall pot	3'/3'-4'
HYQSD	Hydrangea quercifolia 'Sikes Dwarf'	Sikes Dwarf Hydrangea	8	Per Plan	18" tall pot	2'-3'/4'
RHARG	Rhus aromatica 'Gro-Low'	Gro-Low Sumac	48	Per Plan	18" spread pot	2'-3'/6'-8'
SPFRA	Spiraea x fritschiana 'JN Select A'	Pink-a-licious Fritsch Spirea	72	Per Plan	18" tall pot	2'-3'/2'-3'
SYMEP	Syringa meyeri 'Palibin'	Meyer Lilac (Dwarf Korean Lilac)	4	Per Plan	36" tall pot	4'-5'/5'-7'
vergreen St	hrubs: (Install in accordance with detail 5/L201)					
TAMEV	Taxus x media 'Everlow'	Everlow Yew	11	Per Plan	18" spread pot	2'-3'/4'-5'
	Taxas x media Evenow	Evenow Tew	1,1,1,1,1,1,1,1,1,1		a sala sala sala sala sala sala sala sa	2-0/4-0
erennials:	(Install in accordance with detail 6/L201)					
ALSPB	Allium x 'Summer Peek-a-Boo'	Summer Peek-a-Boo Globe Lily	60	Per Plan	#1 cont.	8"-12"/18"-24"
BECOW	Bergenia cordifolia 'Winterglut'	Winter Glow Bergenia	12	Per Plan	#1 cont.	12"-18"/12"-18"
CAAC	Calamagrostis x acutiflora Karl Foerster	Karl Foerster Reed Grass	97	Per Plan	#1 cont.	5'-6'/18"-24"
HEHR	Hemerocallis 'Happy Returns'	Happy Returns Daylily	30	Per Plan	#1 cont.	12"-18"/16"-24"
HOAM	Hosta 'August Moon'	August Moon Hosta	35	Per Plan	#1 cont.	20"/24"-30"
NEJW	Nepeta x 'Junior Walker'	Junior Walker Catmint	41	Per Plan	#1 cont.	15"-18"/30"-36"
PANO	Panicum virgatum 'Northwinds'	Northwinds Switch Grass	52	Per Plan	#1 cont.	4'-5'/24"-30"
SEAF	Sedum x 'Autumn Fire'	Autumn Fire Sedum	25	Per Plan	#1 cont.	18"-24"/24"

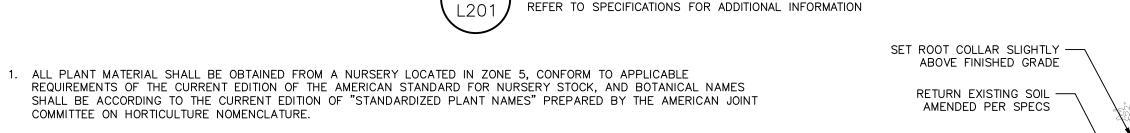

discrepancies between the plant schedule, labels and the landscape plan occur, the quantity drawn on the landscape plan shall be the official quantity.

NOTE: Plant quantities indicated in the plant schedule are for convenience only. Installation contractor is responsible for verifying plant count on the landscape plan. When

PERENNIAL PLANTING

AREAS)

SHREDDED HARDWOOD MULCH SECTION

PLANTING SOIL

- SPECIFIED TOPSOIL OR

STONE MULCH (SEE LANDSCAPE NOTES

FOR TYPE - DETAIL 3/L201)

- APPLY PRE-EMERGENT HERBICIDE

PER MANUFACTURER'S WRITTEN

REQUIREMENTS ON TOP OF SOIL.

WEED BARRIER FABRIC

- SPECIFIED TOPSOIL OR

PLANTING SOIL

1. FINAL GRADE OF STONE MULCH SHALL BE FLUSH WITH TOP OF PAVEMENT

STONE MULCH SECTION

OR TOP OF CURB WHEN ADJACENT TO PAVEMENT OR CURBS.


COVER WITH TYPAR PROFESSIONAL

- 2. CONTRACTOR TO PROVIDE TO THE LANDSCAPE ARCHITECT SAMPLES OF ALL WOOD AND MINERAL/STONE MULCHES OR OTHER GROUND COVER MATERIALS FOR APPROVAL PRIOR TO INSTALLATION.
- 3. SHREDDED HARDWOOD MULCH TO BE FRESHLY ACQUIRED SHREDDED HARDWOOD MULCH. DOUBLE MILLED, EXCESSIVE DIRT
- 4. LANDSCAPE EDGING TO BE ALUMINUM EDGING. REFER TO SPECIFICATION 32 93 00 PLANTS FOR ADDITIONAL INFORMATION.
- 5. ALL PLANTING AREAS TO RECEIVE A 2 TO 3-INCH THICK LAYER OF SHREDDED HARDWOOD MULCH OVER TYPAR PROFESSIONAL WEED BARRIER FABRIC WITH EDGING. EDGING TO BE INSTALLED BETWEEN DIFFERENT TYPES OF MULCHES, BETWEEN MULCHES AND TURF, AND/OR WHERE SPECIFICALLY NOTED ON THE PLAN. REFER TO SPECIFICATION 32 93 00 PLANTS FOR ADDITIONAL INFORMATION.
- 6. INSTALL SHOVEL CUT EDGE AROUND ALL INDIVIDUAL TREES AND SHRUBS IN LAWN AREAS AND ALONG PAVEMENT WHERE PLANTING AREAS ABUT TO PREVENT SHREDDED HARDWOOD MULCH FROM SPILLING OUT OF PLANTING AREA.
- 7. CONTRACTOR RESPONSIBLE FOR MAINTENANCE OF PLANT MATERIAL FOR 90 DAYS FROM INSTALLATION, INCLUDING WATERING, WEEDING, ETC. CONTRACTOR IS RESPONSIBLE FOR MAINTENANCE OF SEEDED AREAS FOR 60 DAYS FROM INSTALLATION, INCLUDING WATERING, WEEDING, ETC. CONTRACTOR TO PROVIDE AND REVIEW MAINTENANCE INSTRUCTIONS WITH THE OWNER PRIOR TO THE COMPLETION OF THESE MAINTENANCE PERIODS. REFER TO SPECIFICATIONS FOR
- 8. CLEANLY PRUNE AND REMOVE DAMAGED BRANCHES, DEAD WOOD, AND ROOTS IMMEDIATELY PRIOR TO PLANTING. DO NOT CUT LEADERS OR LEAVE "V" CROTCHES OR DOUBLE LEADERS UNLESS A MULTI-STEM TREE IS SPECIFIED.
- 9. REMOVE BURLAP, WIRE BASKET, ROPE, TWINE, AND ALL SYNTHETIC MATERIAL FROM THE ROOTS, TRUNK, OR CROWN OF
- 10. REMOVE EXCESS SOIL ABOVE ROOT COLLAR.

AND DUST LIKE MATERIAL OR OLD MATERIAL IS NOT ACCEPTABLE.

- 11. PLANT TREES AND SHRUBS SO THAT THE ROOT COLLAR IS 2" ABOVE FINISHED GRADE OR SEVERAL INCHES ABOVE GRADE IF PLANT IS INSTALLED IN POOR SOILS.
- 12. PLANT TREES AND SHRUBS WITH SAME ORIENTATION AS WHEN HARVESTED FROM THE NURSERY OR TO SHOWCASE THE MOST AESTHETIC VIEW.
- 13. PLANT ALL TREES WITH THREE SLOW RELEASE FERTILIZER PACKETS, SPACED EQUIDISTANT AROUND THE EDGE OF THE
- 14. PLANT ALL SHRUBS WITH ONE SLOW RELEASE FERTILIZER PACKET, PLACED BELOW THE ROOTING SYSTEM.
- 15. WATER AND TAMP BACKFILL AND ROOTS OF ALL NEWLY SET PLANT MATERIAL SO THE SOIL AND ROOTS ARE THOROUGHLY SOAKED AND AIR POCKETS ARE REMOVED.
- 16. FOR INDIVIDUAL TREES & SHRUBS PLANTED IN TURF AREAS, PROVIDE CONTINUOUS 3" SOIL SAUCER TO CONTAIN WATER & MULCH (TREES ON SLOPES SHALL BE SAUCERED ON THE DOWNHILL SIDE)
- 17. INSTALL 3" THICK SHREDDED HARDWOOD MULCH RING 3'-0" DIA. FOR DECIDUOUS TREES AND ALL INDIVIDUAL SHRUBS IN LAWN AREAS, 5'-0" DIA. FOR EVERGREEN TREES. KEEP MULCH 2" AWAY FROM TRUNKS.
- 18. STAKING ONLY STAKE EVERGREEN TREES 5'-0" OR GREATER IN HEIGHT OR TREES THAT ARE UNABLE TO REMAIN UPRIGHT AFTER PLANTING. TREES WILL BECOME STRONGER FASTER WHEN THE TOP 2/3 OF THE TREE IS FREE TO SWAY. DO NOT ATTACH WIRE DIRECTLY TO TREES OR THROUGH HOSES - UTILIZE GROMMETED, SYNTHETIC STRAPS AT LEAST 2" WIDE AROUND THE TREE, ATTACH STRAPPING TO STAKE WITH WIRE. STAKE ONLY WHEN NECESSARY. STAKES SHOULD BE DRIVEN DEEPLY INTO THE GROUND TO PREVENT DISLODGING. CHECK AT LEAST EVERY THREE MONTHS FOR BINDING OR OTHER PROBLEMS. STAKES AND TIES SHOULD BE REMOVED SIX MONTHS TO ONE YEAR AFTER PLANTING.
- 19. LAWN AREAS BEING CONVERTED TO PLANTING BEDS SHALL HAVE THE LAWN KILLED AND ENTIRELY REMOVED INCLUDING ROOTS. REPLACE THE REMOVED SOIL WITH IMPORTED TOPSOIL. DO NOT TILL THE EXISTING LAWN INTO THE SOIL.
- 20. PAVED AREAS BEING CONVERTED TO PLANTING BEDS SHALL HAVE ALL STONE AGGREGATE BASE DOWN TO SUBGRADE REMOVED AND REPLACED WITH PLANTING SOIL.
- 21. STONE MULCH TO BE 3/4-INCH TO 1-INCH RAVENS BLACK DECORATIVE STONE CHIP FROM HALQUIST STONE OR APPROVED EQUIVALENT. CONTRACTOR TO CONTACT HALQUIST STONE N51 W23563 LISBON ROAD SUSSEX, WI 53089 TELEPHONE (262)246-9000 EMAIL: INFO@HALQUISTSTONE.COM
- 22. REFER TO SPECIFICATIONS 32 93 00 PLANTS AND 32 92 00 TURF AND GRASSES FOR ADDITIONAL INFORMATION.



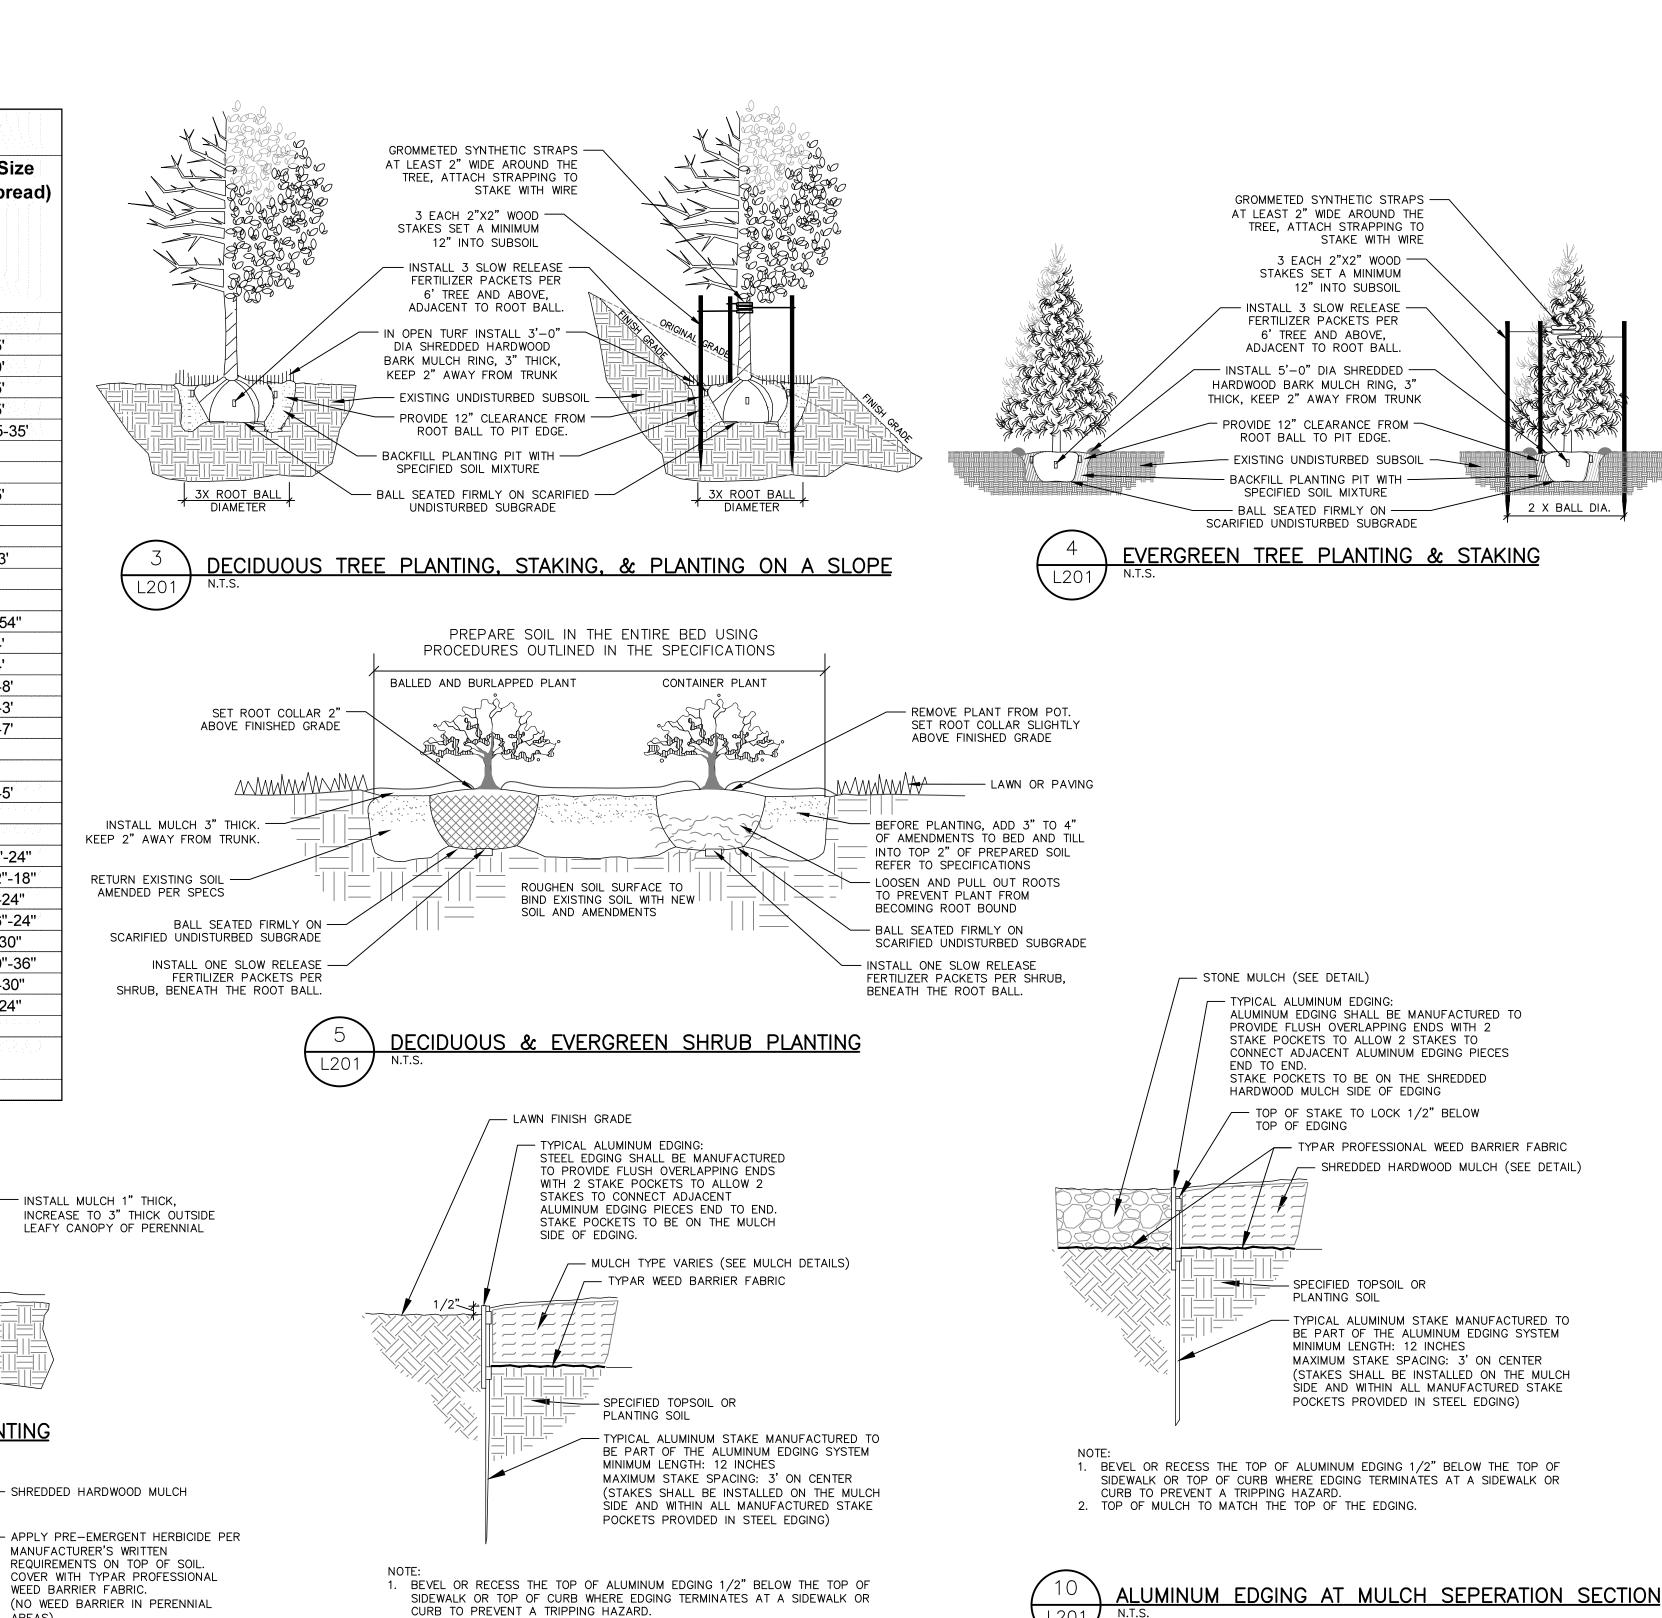

Jakum Site Redevelopment

PROJECT TITLE

ARCHITECTS

788 N. Jefferson Street, Ste 900 Milwaukee, Wisconsin 53202

Land Use Submittal - June 17, 2025

kapurinc.com

ISSUED

2 X BALL DIA.

8401 Greenway Blvd., Suite

Red Earth Development


<u>LUMINUM EDGING AT PLANTING BED SECTION</u>

N. 15th St. & Luedke Ct. Sheboygan, Wisconsin SHEET TITLE SITE LANDSCAPE


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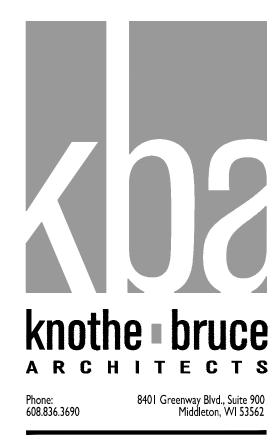
DETAILS

PROJECT NO.



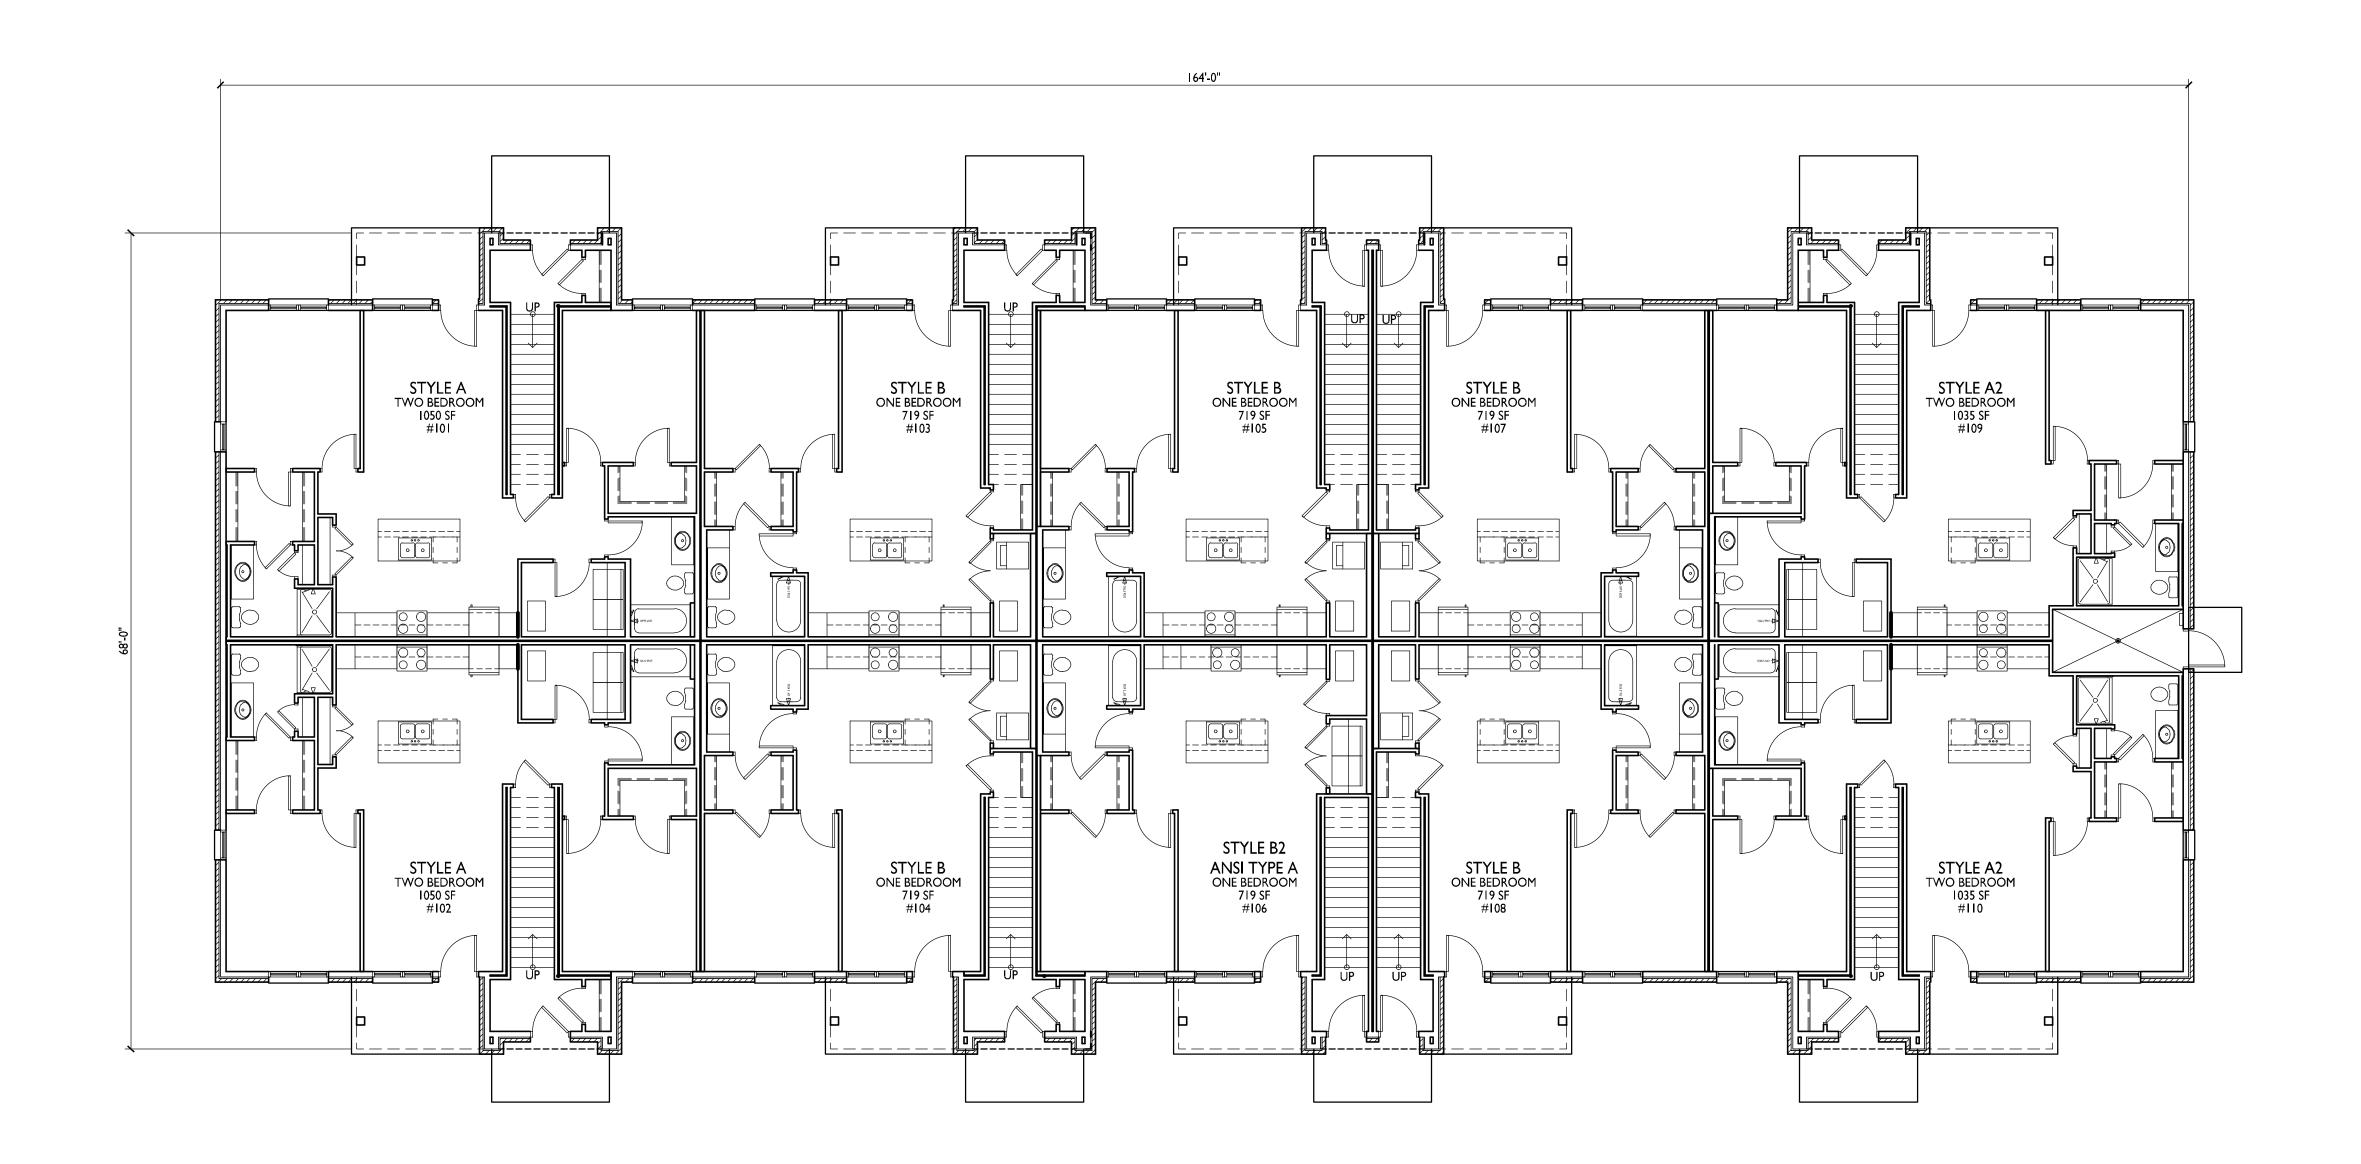



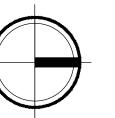

6/17/2025 Issued For Land Use Submittal

PROJECT TITLE

Red Earth Development

Jakum Site Redevelopment

Building I 20-Unit Townhouse


N 15th St & Luedke Ct Sheboygan, Wisconsin SHEET TITLE First Floor Plan

SHEET NUMBER


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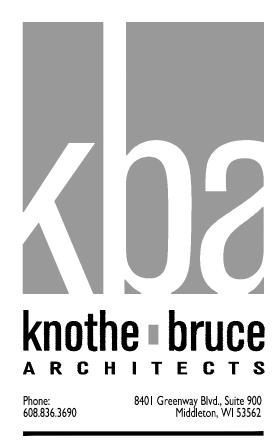
PROJECT NO.

2427



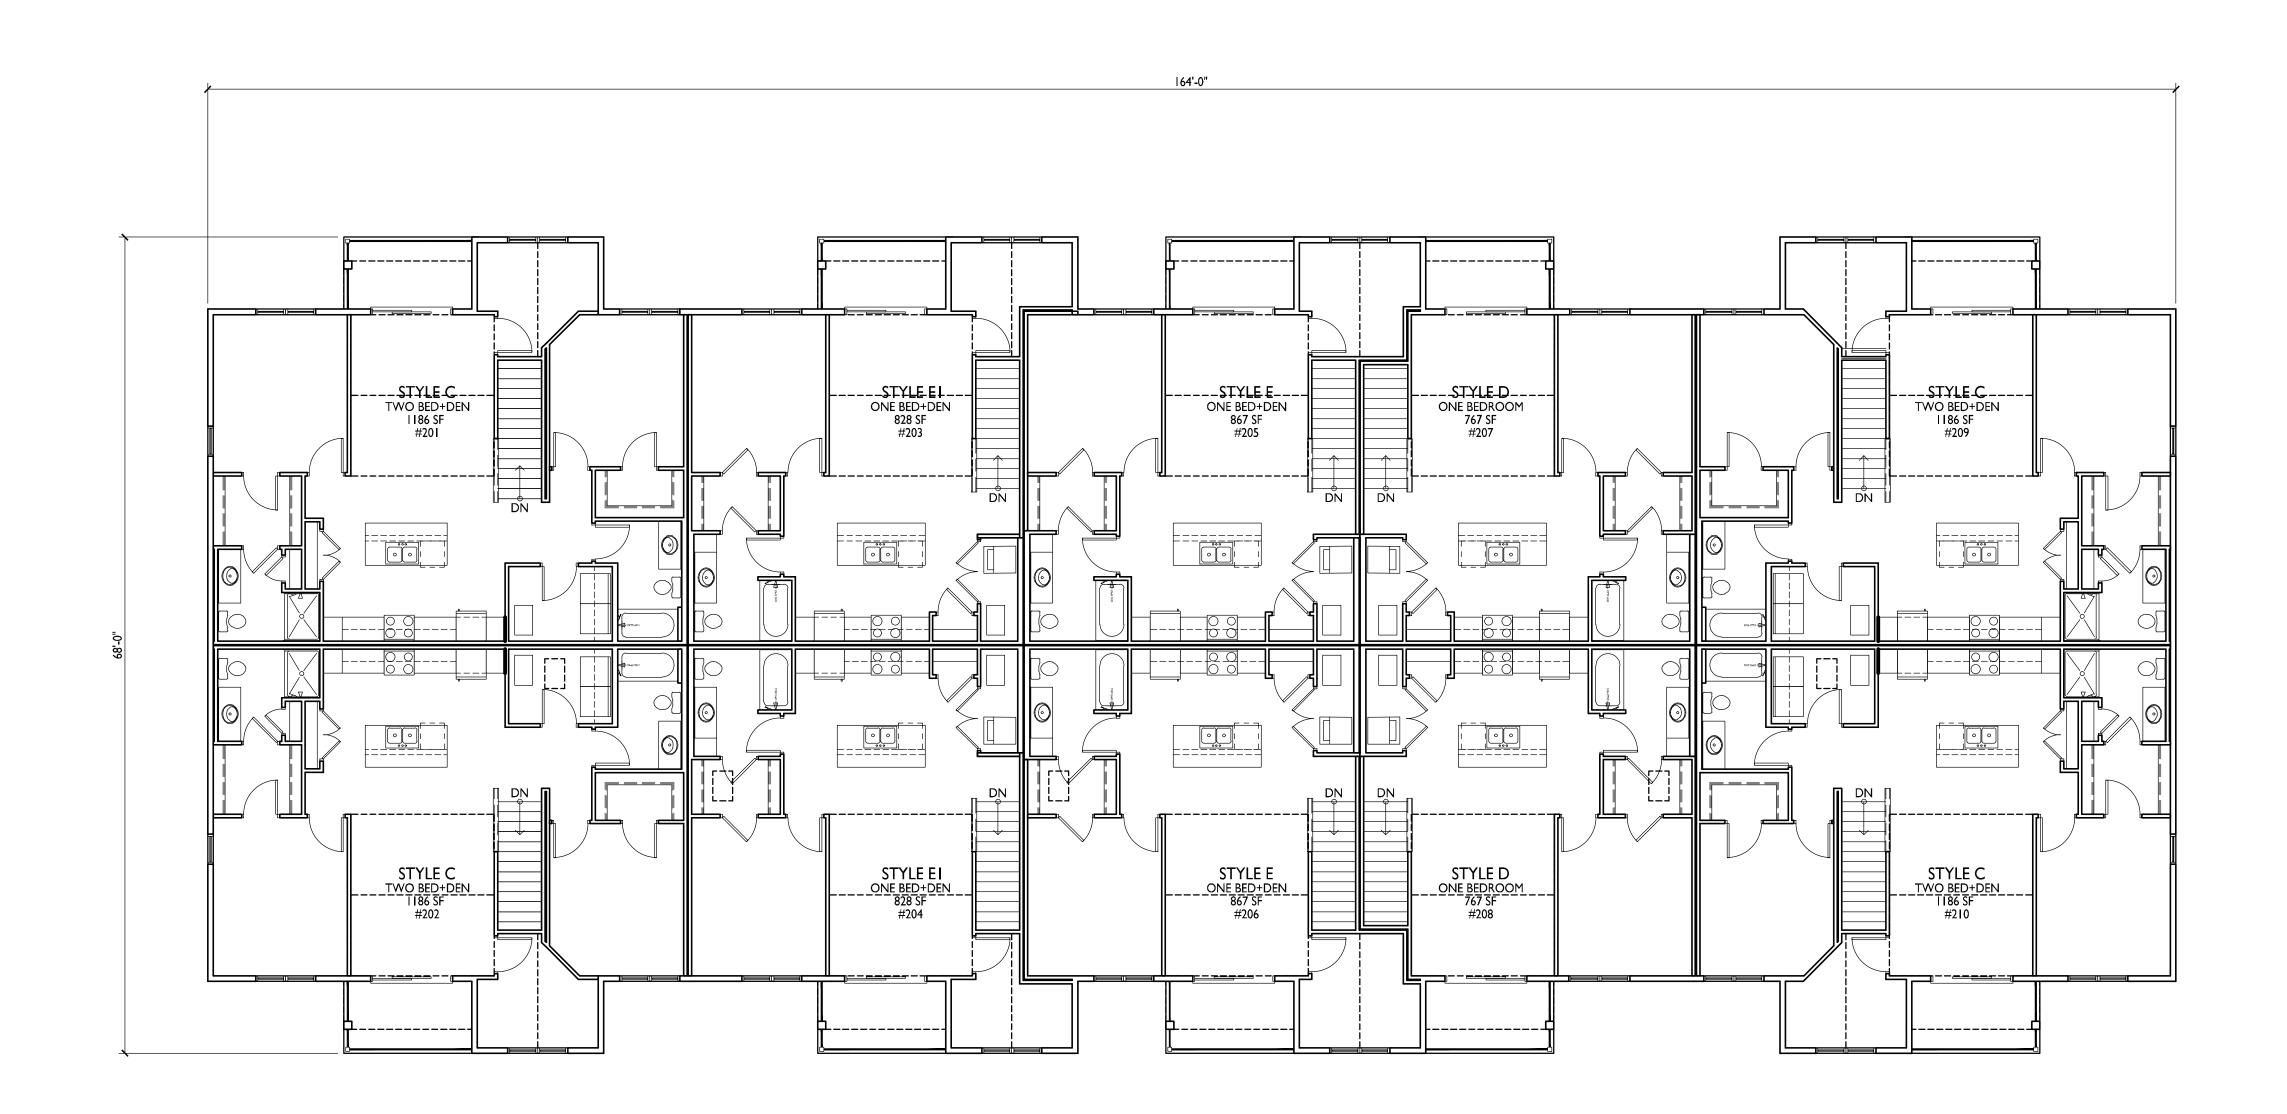



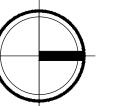

6/17/2025 Issued For Land Use Submittal

PROJECT TITLE Red Earth Development

Jakum Site Redevelopment

Building I 20-Unit Townhouse

N 15th St & Luedke Ct Sheboygan, Wisconsin SHEET TITLE Second Floor Plan

SHEET NUMBER

AC102.1

PROJECT NO.