
SUMMIT RIDGE COMMERCIAL

LOCATED IN THE CITY OF SANTAQUIN, UTAH 84655

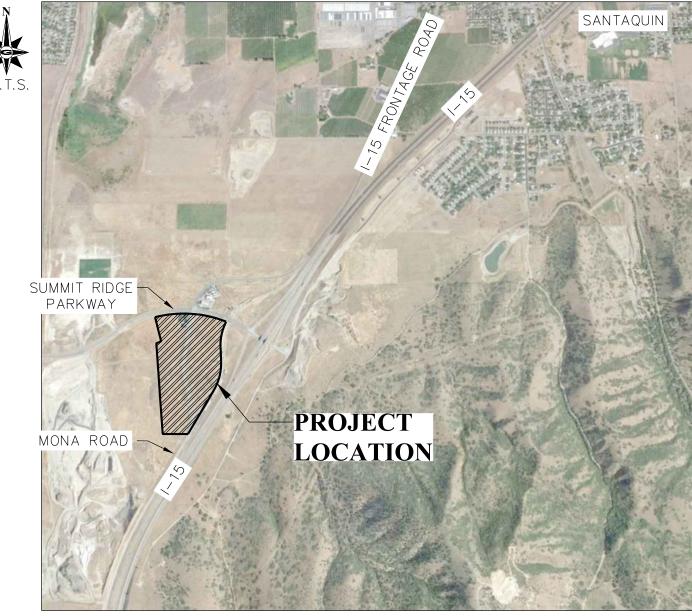

VICINITY	MAP	

DENSITY TABLE

ZONING CLASSIFICATION: C-1
TOTAL NUMBER OF LOTS: 8
TOTAL ACREAGE DEVELOPMENT: 49.25 AC
TOTAL LOT ACREAGE: 42.747 AC
TOTAL ROW ACREAGE: 5.936 AC
TOTAL OPEN SPACE ACREAGE: 0

<u>OWNER</u>

CONTACT: CHAD LILJENQUIST 6995 UNION PARK CENTER #440 MIDVALE, UT 84047 PHONE: (801) 566-6185

ENGINEER

GILSON ENGINEERING, INC. 12401 SOUTH 450 EAST, UNIT C2 DRAPER, UTAH 84020-7937

CONTACT: BRAD GILSON PHONE: (801) 571-9414

SHEET INDEX SHEET NO. COVER SHEET GENERAL NOTES EXISTING SITE PHASING PLAN OVERALL SITE PLAN OVERALL UTILITIES & GRADING PLAN UTILITIES & GRADING PLAN

NO

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DRAWING NAME:

DESIGNED/DRAWN BY:

BG/BP

CHECKED:

ADJUST FOR HALF SIZE SHEET

ADJUST FOR HALF SIZE SHEETS

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DESIGNED/DRAWN BY:

DESIGNED/DRAWN BY:

ADJUST FOR HALF SIZE SHEETS

COVER SHEET

LILJENQUIEST
AQUIN - SUMMIT RIDGE COMMEI
SANTAQUIN, UTAH 84655



ABBREVIATIONS

ADVANCE DRAINAGE SYSTEM ARV AIR RELEASE VALVE BAR AND CAP BC BOW **BACK OF WALK BVCE** BEGINNING VERTICAL CURVE ELEV. BEGINNING VERTICAL CURVE STATION **BVCS** CB CATCH BASIN CABLE CBL CH CHORD BEARING CENTERLINE CORRUGATED METAL PIPE CO **CLEAN OUT** CONC CONCRETE COR. SECTION CORNER DELTA ANGLE DET DETAIL DIAMETER DIA DIP DUCTILE IRON PIPE DWG DRAWING **EXISTING GRADE ELEV ELEVATION EDGE OF CONCRETE EDGE OF PAVEMENT EVCE** END VERTICAL CURVE ELEV. END VERTICAL CURVE STATION **EVCS** EW EACH WAY **EXISTING** FFE FINISHED FLOOR ELEVATION FINISHED GRADE FIRE HYDRANT FLOW LINE FO FIBER OPTICS FT FOOT **GRADE BREAK** GB HC HANDICAP HDPE HIGH DENSITY POLY ETHYLENE HP **HIGH POINT** INV. INVERT IRR **IRRIGATION** LINEAR FEET LIP OF CURB LIP LOW POINT LT. LEFT MAX. MAXIMUM **MANHOLE** MINIMUM MONUMENT NOT TO SCALE NTS OC ON CENTER OHP **OVER HEAD POWER** PC POINT OF CURVE POINT OF INTERSECTION PROPERTY LINE POWER POLE PRC POINT OF REVERSE CURVE PRV PRESSURE REDUCING VALVE POINT OF TANGENCY PUE PUBLIC UTILITY EASEMENT PVC POLYVINYL CHLORIDE PIPE RADIUS ROW RIGHT OF WAY SEWER SD STORM DRAIN SOUTH END RADIUS SER SSMH SEWER MANHOLE STA STATION STD STANDARD SW SECONDARY WATER TBC TOP BACK OF CURB TOA TOP OF ASPHALT TOE TOE OF SLOPE TOP TOP OF SLOPE TOW TOP OF WALL TYP TYPICAL **UNDER GROUND POWER** UG VPC VERTICAL POINT OF CURVE VERTICAL POINT OF INTERSECTION VPI VPT VERTICAL POINT OF TANGENCY

WATER

WV

WATER METER

WATER VALVE

GENERAL NOTES

PROCEEDING. FAILURE TO DO SO VOIDS THE DESIGN.

THEIR UNNECESSARY LOSS OR DISTURBANCE.

AND SANTAQUIN CITY CODES, ORDINANCES AND STANDARDS.

- 1. THIS DESIGN IS AN ORIGINAL UNPUBLISHED WORK AND MAY NOT BE DUPLICATED, PUBLISHED AND/OR USED WITHOUT THE WRITTEN CONSENT OF GILSON ENGINEERING, INC.
- 2. THESE SHEETS LISTED BY DRAWING INDEX, ALL ACCOMPANYING SPECIFICATIONS FOR MATERIALS, WORKMANSHIP QUALITY, AND NOTES HAVE BEEN PREPARED SOLELY FOR THE CONSTRUCTION AND FINISH OF PROJECT IMPROVEMENTS, COMPLETE AND READY
- 3. ALL WORK IS TO BE PERFORMED IN ACCORDANCE WITH PERTINENT JURISDICTIONAL CODES, RESTRICTIONS, COVENANTS, AND/OR ORDINANCES. ANY CONFLICT BETWEEN DESIGN AND REQUIREMENT SHALL BE REPORTED TO GILSON ENGINEERING, INC. BEFORE
- 4. ANY AND ALL PROPOSED CHANGE, MODIFICATIONS AND/OR SUBSTITUTION SHALL BE REPORTED TO GILSON ENGINEERING, INC. BEFORE PROCEEDING. ANY DEVIATION FROM THE CONTRACT DOCUMENTS, WITHOUT THE EXPRESS WRITTEN AUTHORIZATION OF GILSON ENGINEERING, INC. VOIDS THE DESIGN.
- 5. IN THE EVENT OF CONFLICT BETWEEN THE DESIGN DOCUMENTS AND/OR JURISDICTIONAL REQUIREMENTS, THE MORE RESTRICTIVE FROM THE STANDPOINT OF SAFETY AND PHYSICAL SECURITY SHALL APPLY.
- 6. ANY INSTALLATION OR WORK NECESSARY TO THE FUNCTIONING, SAFETY AND/OR PHYSICAL SECURITY OF DESIGN THAT IS TO BE ENCAPSULATED OR OTHERWISE PERMANENTLY OBSCURED FROM INSPECTION SHALL BE REPORTED TO GILSON ENGINEERING, INC. A MINIMUM OF TWO (2) WORKING DAYS BEFORE ENCLOSURE.
- 7. DESIGN IS GENERALLY PREDICATED UPON PROVISIONS OF THE CURRENT EDITION OF THE INTERNATIONAL BUILDING CODE AND/OR AMENDMENTS AS MAY HAVE BEEN LOCALLY ENACTED. THIS DESIGN AND ANY CONSEQUENT CONSTRUCTION SHALL ACCOMMODATE ALL REQUIREMENTS OF THE JURISDICTIONAL FIRE SAFETY/PREVENTION DISTRICT
- 8. ANY DAMAGE, DISRUPTION OR COMPROMISE OF AMBIENT RIGHTS-OF-WAY, UTILITIES, OR ENVIRONMENTAL QUALITY SHALL BE IMMEDIATELY RECTIFIED BY THE CONTRACTOR TO THE SATISFACTION OF GILSON ENGINEERING, INC. AT NO COST TO THE OWNER.
- 9. THIS DESIGN PURPORTS TO PERMIT FULL ACCESS TO HANDICAPPED PERSONS AS PROVIDED FOR BY PROVISIONS OF FEDERAL LAW. ANY DEVIATION OR COMPROMISE SHALL BE REPORTED TO GILSON ENGINEERING, INC. FOR RESOLUTION. 10. ALL WORK SHALL BE INSPECTED BY GOVERNING AGENCIES IN ACCORDANCE WITH THEIR REQUIREMENTS. JURISDICTIONAL
- APPROVAL SHALL BE SECURED BEFORE PROCEEDING WITH WORK 11. ANY WORK THAT IS OUTSIDE OF THE LIMIT OF WORK SHALL BE RESTORED TO ITS ORIGINAL CONDITION AT NO COST TO THE
- 12. CONSULT ALL DRAWINGS AND SPECIFICATIONS FOR COORDINATION REQUIREMENTS BEFORE COMMENCING CONSTRUCTION.
- 13. AT ALL LOCATIONS WHERE EXISTING PAVEMENT ABUTS NEW CONSTRUCTION, THE EDGE OF THE EXISTING PAVEMENT SHALL BE SAW CUT TO A CLEAN, SMOOTH EDGE.
- 14. ALL CONSTRUCTION AND MATERIALS SHALL BE IN ACCORDANCE WITH THE MOST RECENT, ADOPTED EDITION OF ADA
- 15. CONTRACTOR MUST VERIFY ALL EXISTING CONDITIONS BEFORE BIDDING AND BRING UP ANY QUESTIONS BEFORE HAND.
- 16. CONTRACTOR IS RESPONSIBLE FOR SCHEDULING AND NOTIFYING ENGINEER OR INSPECTING AUTHORITY 72 HOURS IN ADVANCE OF COVERING UP ANY PHASE OF CONSTRUCTION REQUIRING OBSERVATION.
- 17. ALL DIMENSIONS, GRADES, AND UTILITY DESIGNS SHOWN ON PLANS SHALL BE VERIFIED BY THE CONTRACTOR PRIOR TO CONSTRUCTION. CONTRACTOR SHALL NOTIFY ENGINEER OF ANY DISCREPANCIES PRIOR TO PROCEEDING WITH CONSTRUCTION FOR NECESSARY PLAN OR GRADE CHANGES.
- 18. CONTRACTOR IS RESPONSIBLE FOR ALL FLAGGING, CAUTION SIGNS, LIGHTS, BARRICADES, FLAG MEN, AND ALL OTHER DEVICES NECESSARY FOR PUBLIC SAFETY.
- 19. THE CONTRACTOR SHALL BE RESPONSIBLE TO PROVIDE ALL WATER, POWER, SANITARY FACILITIES, AND TELEPHONE SERVICES AS REQUIRED FOR THE CONTRACTORS USE DURING CONSTRUCTION.
- 20. THE CONTRACTOR SHALL BE HELD RESPONSIBLE FOR ANY FIELD CHANGES MADE WITHOUT WRITTEN AUTHORIZATION FROM THE OWNER OR ENGINEER.
- 21. THE CONTRACTOR SHALL EXERCISE DUE CAUTION AND SHALL CAREFULLY PRESERVE BENCHMARKS, CONTROL POINTS, REFERENCE POINTS, AND ALL SURVEY STAKES, AND SHALL BEAR ALL EXPENSES FOR REPLACEMENT AND/OR ERRORS CAUSE BY
- 22. THE CONTRACTOR SHALL ASSUME SOLE AND COMPLETE RESPONSIBILITY FOR THE JOBSITE CONDITIONS DURING THE COURSE OF CONSTRUCTION OF THE PROJECT, INCLUDING SAFELY OF ALL PERSONS ON THE PROPERTY. THIS REQUIREMENT SHALL APPLY CONTINUOUSLY AND NOT BE LIMITED TO WORKING HOURS. THE CONTRACTOR SHALL DEFEND, INDEMNIFY AND HOLD THE OWNER AND ENGINEER HARMLESS FROM ANY AND ALL LIABILITY, REAL OR ALLEGED, IN CONNECTION WITH THE PERFORMANCE OF THE
- 23. ALL WORK WITHIN THE SITE TO CONFORM TO THE CURRENT CITY STANDARDS AND SPECIFICATIONS.
- 24. THE CONTRACTOR SHALL BE RESPONSIBLE FOR MEETING ALL OF THE REQUIREMENTS ESTABLISHED FOR SAFE TRENCHING. (SEE OSHA AND UOSHA REQUIREMENTS, LATEST EDITIONS).
- 25. CONTRACTOR SHALL LOCATE ALL UNDERGROUND UTILITIES BEFORE LAYING PIPE WITHIN 200 FEET OF SAID UTILITIES WHICH MAY BE EXPOSED, DAMAGED OR CROSSED AS SHOWN ON THE DRAWINGS OR AS "BLUE STAKED". THE CONTRACTOR WILL MAKE ARRANGEMENTS WITH THE UTILITY COMPANY TO MOVE THE UTILITY IF NECESSARY OR OBTAIN PERMISSION FROM THE PROJECT ENGINEER TO MODIFY GRADES OF PROJECT LINES IN ORDER TO GO AROUND EXISTING UTILITIES.
- 26. SEWER MAINS, WATER MAINS, GAS MAINS AND OTHER UTILITIES ARE SHOWN ON THE PLANS IN A GENERAL SCHEMATIC WAY ACCORDING TO INFORMATION RECEIVED FROM OTHERS AND SOMETIMES FROM FIELD MEASUREMENTS. THE ACCURACY OR COMPLETENESS OF THE LOCATIONS SHOWN IS APPROXIMATE ONLY. THE CONTRACTOR SHALL DETERMINE THE ACTUAL LOCATION OF EXISTING SERVICE CONNECTIONS AND UTILITIES, VERIFY THE HORIZONTAL AND VERTICAL LOCATIONS AND TAKE THE NECESSARY STEPS TO AVOID THEM.
- 27. SPECIFIC INFORMATION PROVIDED IN THE CONTRACT DOCUMENTS SHALL SUPERSEDE ITEMS COVERED IN THESE DRAWINGS. 28. THE DEVELOPER AND THE CONTRACTOR UNDERSTAND THAT IS IS HIS/HER RESPONSIBILITY TO ENSURE THAT ALL IMPROVEMENTS INSTALLED WITHIN THIS DEVELOPMENT ARE CONSTRUCTED IN FULL COMPLIANCE WITH ALL STATE AND SANTAQUIN CITY CODES, ORDINANCES AND STANDARDS. THESE PLANS ARE NOT ALL INCLUSIVE OF ALL MINIMUM CODES, ORDINANCES AND STANDARDS. THIS FACT DOES NOT RELIEVE THE DEVELOPER OR GENERAL CONTRACTOR FROM FULL COMPLIANCE WITH ALL MINIMUM STATE

UTILITY NOTES


- 1. COORDINATE ALL UTILITY CONNECTIONS TO BUILDING WITH PLUMBING PLANS AND BUILDING CONTRACTOR.
- 2. VERIFY DEPTH AND LOCATION OF ALL EXISTING UTILITIES PRIOR TO CONSTRUCTING ANY NEW UTILITY LINES. NOTIFY CIVIL ENGINEER OF ANY DISCREPANCIES OR CONFLICTS PRIOR TO ANY CONNECTIONS BEING MADE.
- 3. WATER METERS ARE TO BE INSTALLED PER CURRENT CITY STANDARDS AND SPECIFICATIONS. IT WILL BE THE CONTRACTORS RESPONSIBILITY TO INSTALL ALL ITEMS REQUIRED.
- 4. WATER LINES, VALVES, FIRE HYDRANTS, FITTINGS ETC. ARE TO BE CONSTRUCTED AS SHOWN. CONTRACTOR IS RESPONSIBLE TO CONSTRUCT ANY VERTICAL ADJUSTMENTS NECESSARY TO CLEAR SEWER, STORM DRAIN OR OTHER UTILITIES AS NECESSARY INCLUDING VALVE BOXES AND HYDRANT SPOOLS TO PROPER GRADE.
- 5. FIELD VERIFY ALL EXISTING AND/OR PROPOSED ROOF DRAIN/ROOF DRAIN DOWN SPOUT CONNECTIONS TO STORM WATER SYSTEM
- WITH CIVIL, PLUMBING & ARCHITECTURAL PLANS, NOTIFY ENGINEER OF ANY DISCREPANCIES.
- 6. ALL CATCH BASINS AND INLET BOX GRATES ARE TO BE BICYCLE SAFE. 7. UNLESS OTHERWISE NOTED FOR EXISTING UTILITIES, ALL DRY UTILITIES ARE ASSUMED TO BE 3' BELOW EXISTING GRADE TO TOP OF CONDUIT. ALL WATER LINES ARE ASSUMED TO BE 4' BELOW EXISTING GRADE TO TOP OF PIPE. ALL STORM AND SANITARY LINES ARE BASED ON SURVEYED INVERT DATA. CONTRACTOR TO POTHOLE ALL UTILITY CROSSINGS, VERIFY ELEVATIONS AND
- CONTACT ENGINEER IF ELEVATIONS ARE DIFFERENT FROM THOSE SHOWN IN THESE PLANS. 8. ANY EXISTING VALVES AND MANHOLE COVERS SHALL BE RAISED OR LOWERED TO MEET FINISHED GRADE
- 9. IF CONTRACTOR LOCATES ANY UNIDENTIFIED UTILITIES, CONTRACTOR SHALL CONTACT THE ENGINEER FOR VERIFICATION OF LOCATION BOTH HORIZONTAL AND VERTICAL.



CAUTION NOTICE TO CONTRACTOR

THE CONTRACTOR IS SPECIFICALLY CAUTIONED THAT THE LOCATION AND/OR ELEVATION OF EXISTING UTILITIES AS SHOWN ON THESE PLANS ARE BASED ON RECORDS OF THE VARIOUS UTILITY COMPANIE: AND, WHERE POSSIBLE, MEASUREMENTS TAKEN IN THE FIELD. THE INFORMATION IS NOT TO BE RELIED ON AS BEING EXACT OR COMPLETE. THE CONTRACTOR MUST CALL THE APPROPRIATE UTILITY COMPANY AT LEAST 48 HOURS BEFORE ANY EXCAVATION TO REQUEST EXACT FIELD LOCATION OF UTILITIES. IT SHALL BE THE RESPONSIBILITY OF THE CONTRACTOR TO RELOCATE ALL EXISTING UTILITIES WHICH CONFLICT WITH THE PROPOSED IMPROVEMENTS SHOWN ON THE PLANS.

HE CONTRACTOR AGREES THAT HE SHALL ASSUME SOLE AND COMPLETE RESPONSIBILITY FOR JOB ITE CONDITIONS DURING THE COURSE OF CONSTRUCTION OF THIS PROJECT, INCLUDING SAFETY O ALL PERSONS AND PROPERTY: THAT THIS REQUIREMENT SHALL APPLY CONTINUOUSLY AND NOT BE LIMITED TO THE NORMAL WORKING HOURS: AND THE CONTRACTOR SHALL DEFEND, INDEMNIFY, AND HOLD THE OWNER AND THE ENGINEER HARMLESS FROM ANY AND ALL LIABILITY, REAL OR ALLEGED, IN ONNECTION WITH THE PERFORMANCE OF WORK ON THIS PROJECT, EXCEPTING FOR LIABILITY ARISING FROM SOLE NEGLIGENCE OF THE OWNER OR THE ENGINEER.

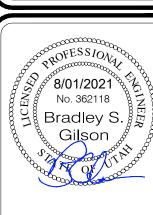


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APPROVED:	0-			1" SCALE MEASURES 1" ON FULL SIZE SHEET


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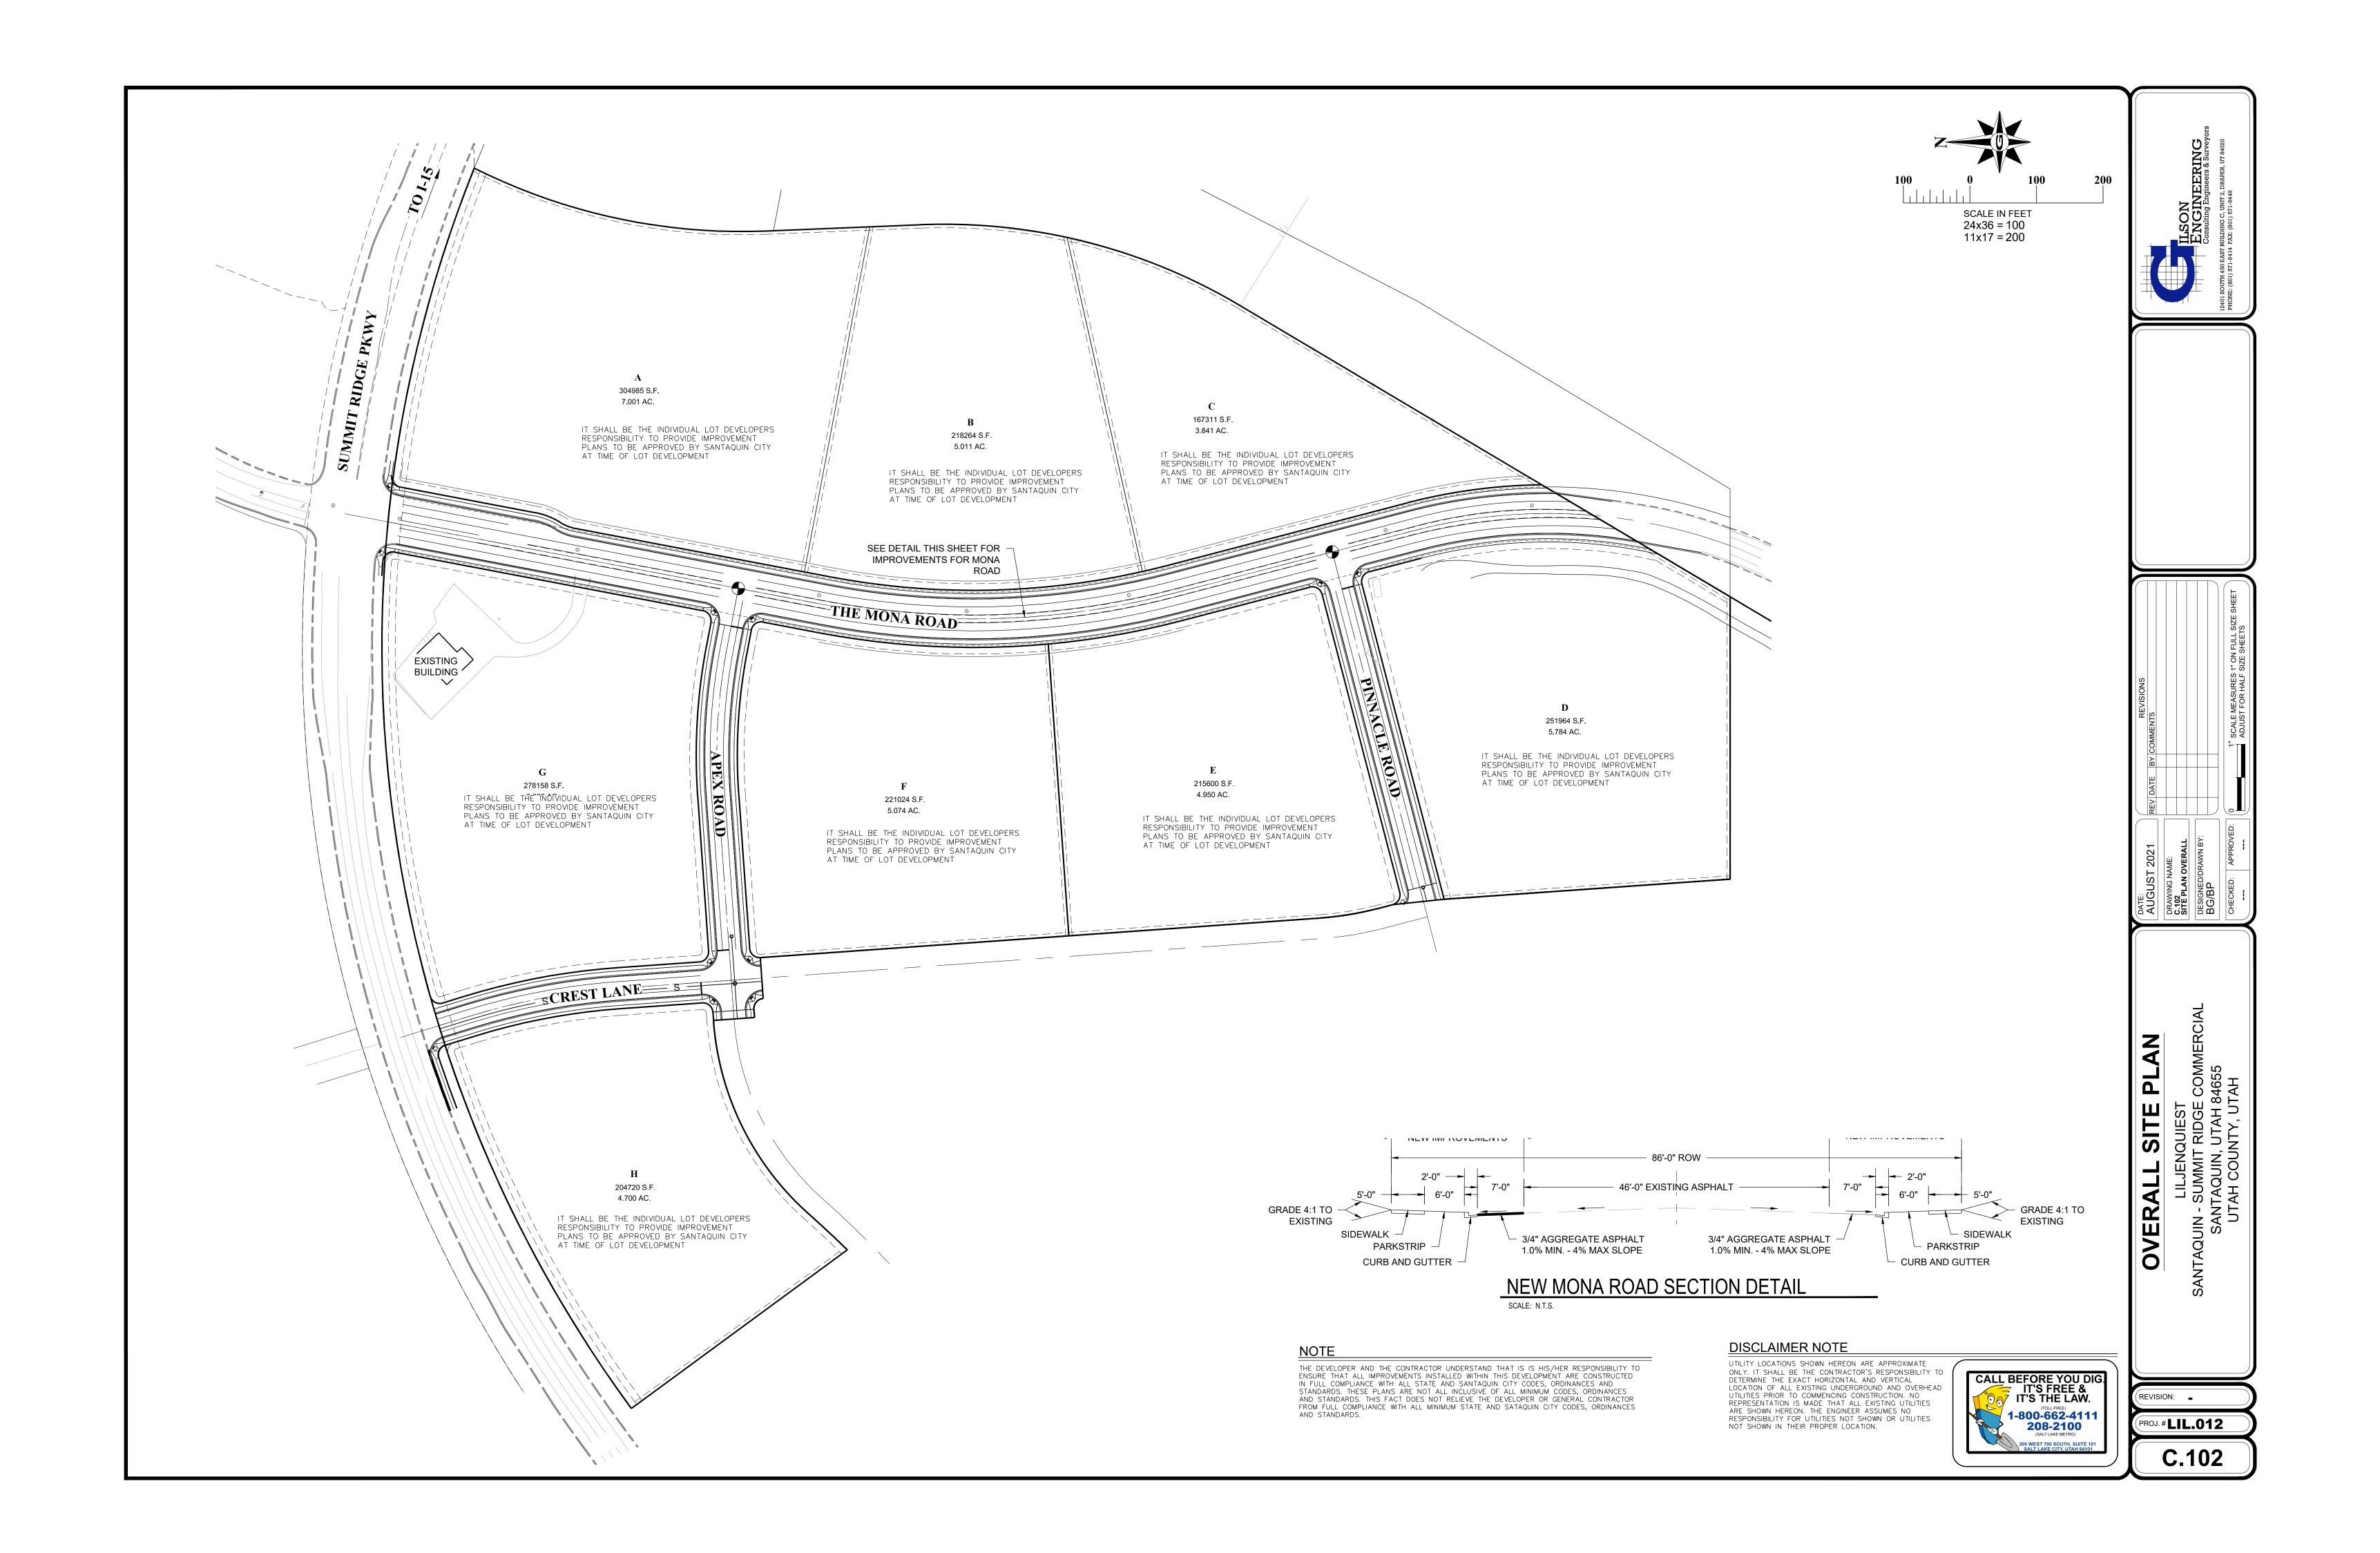
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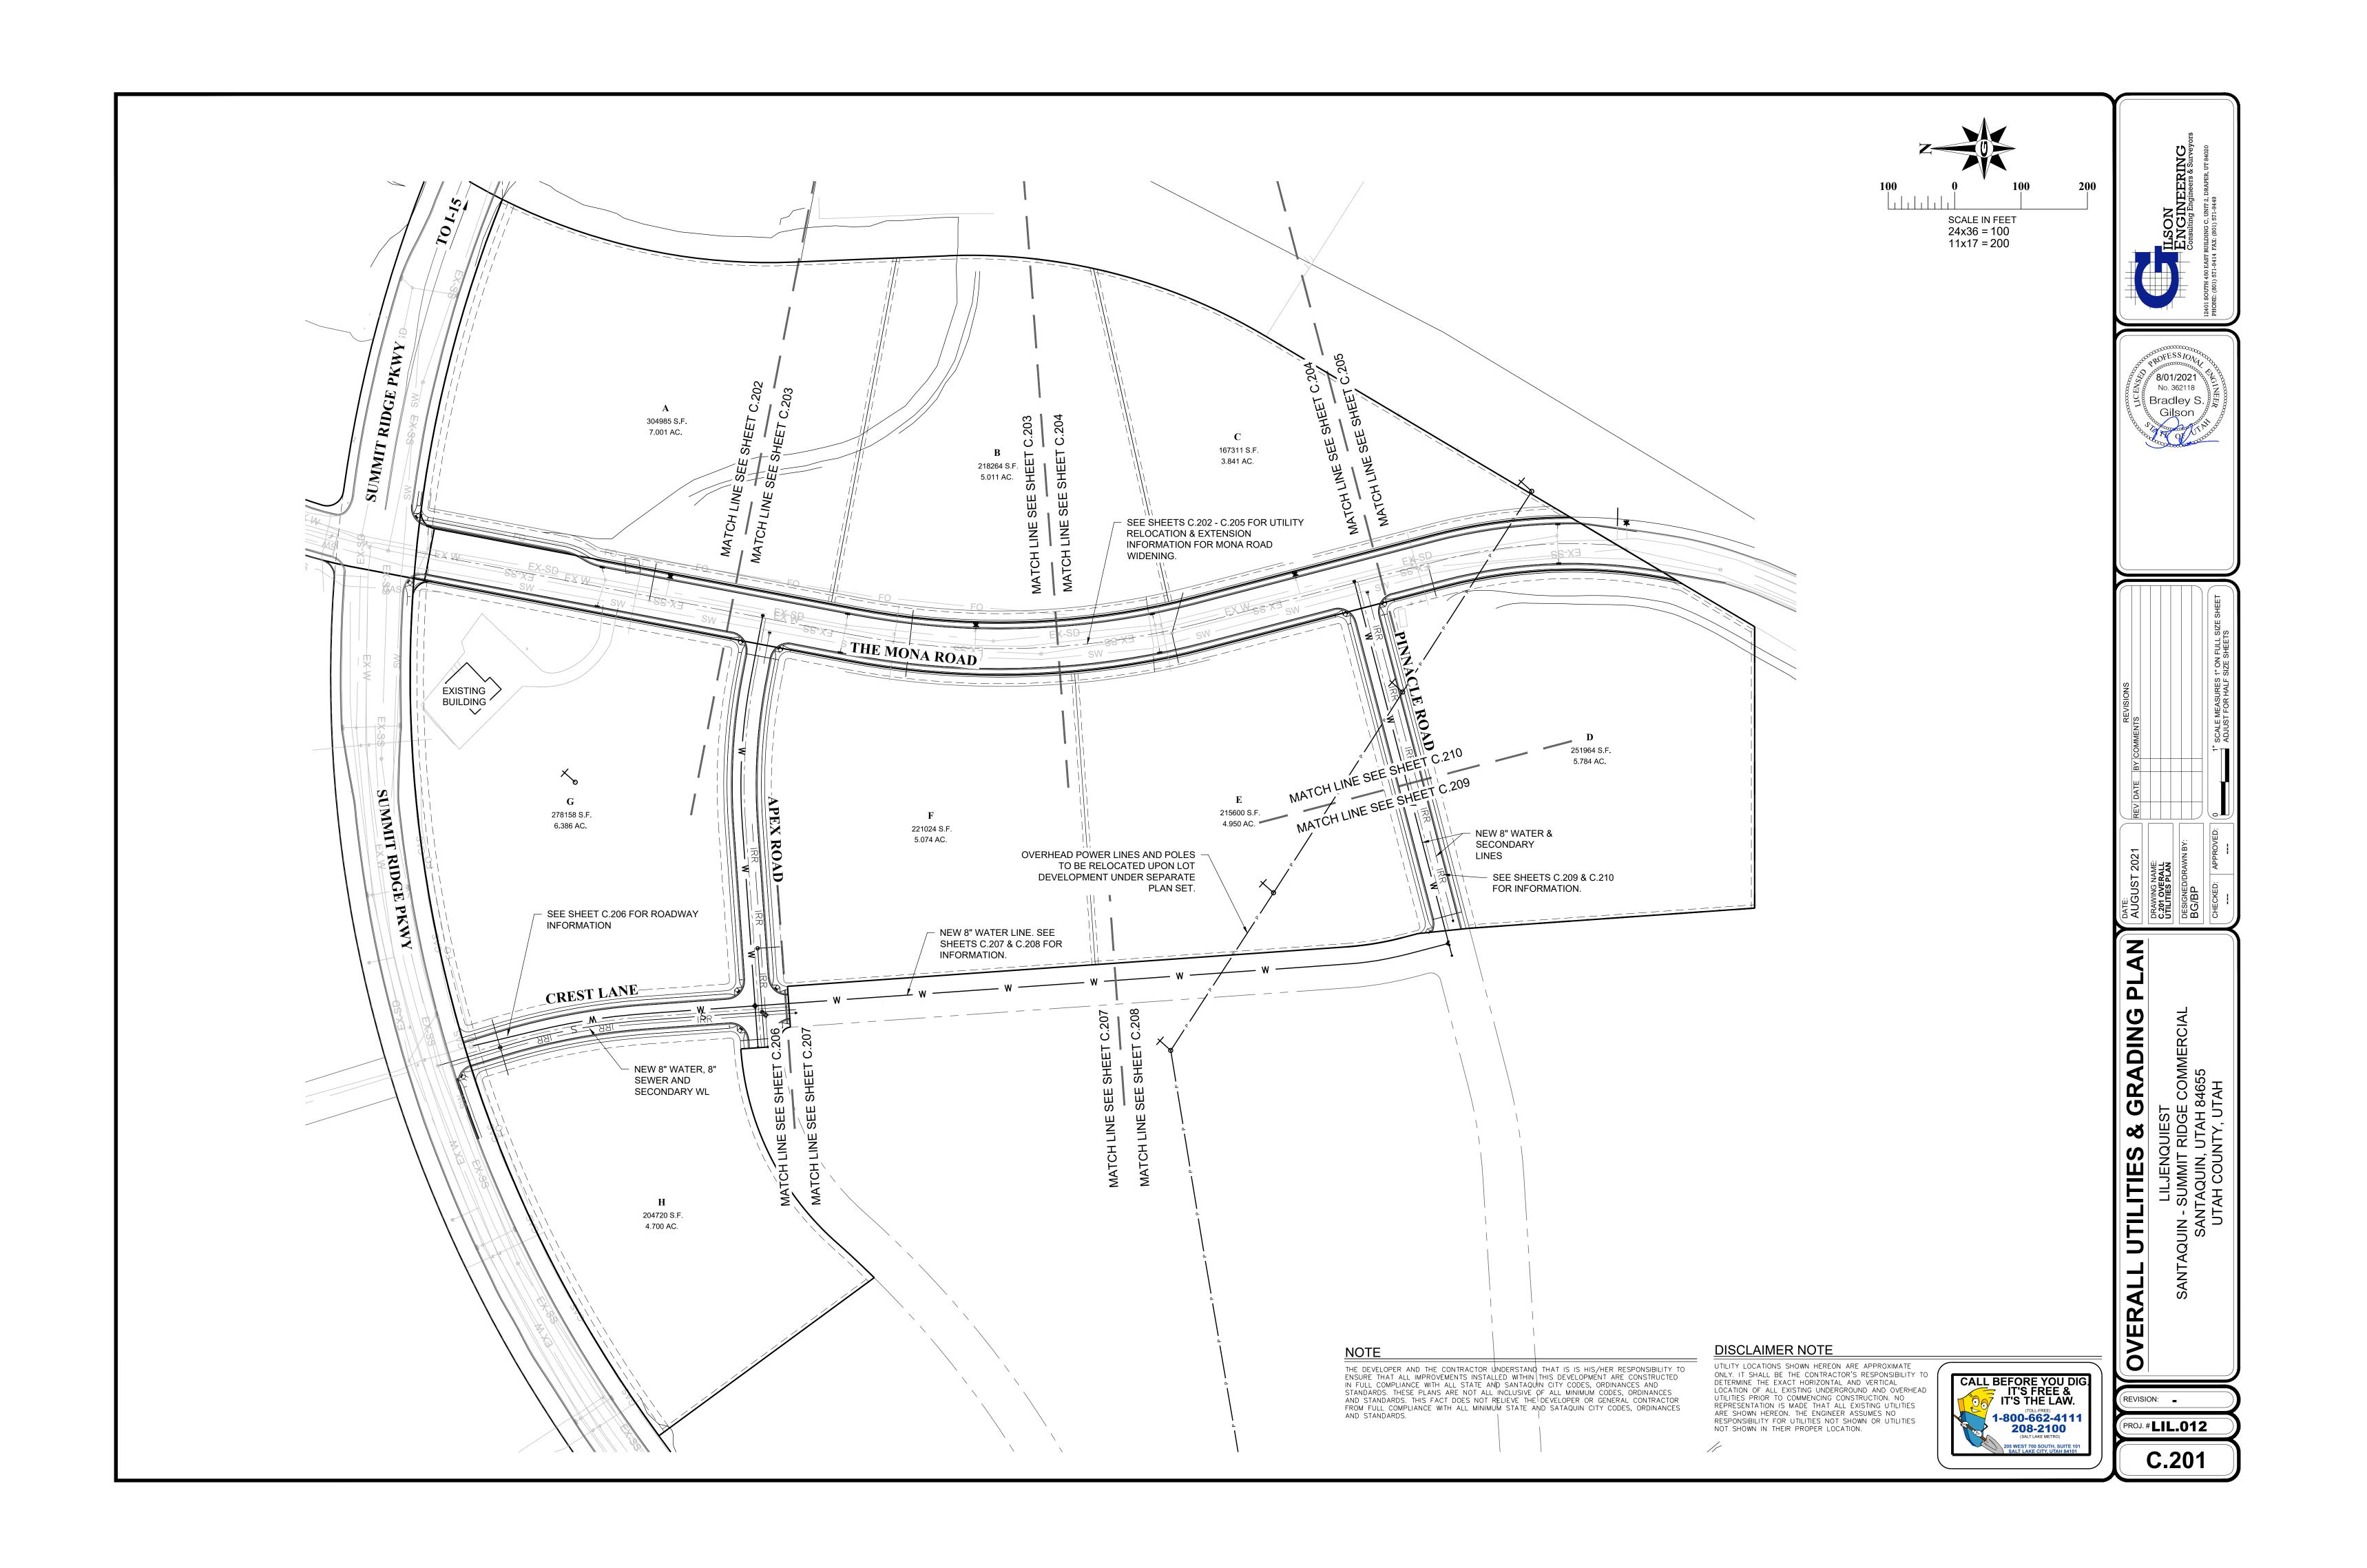
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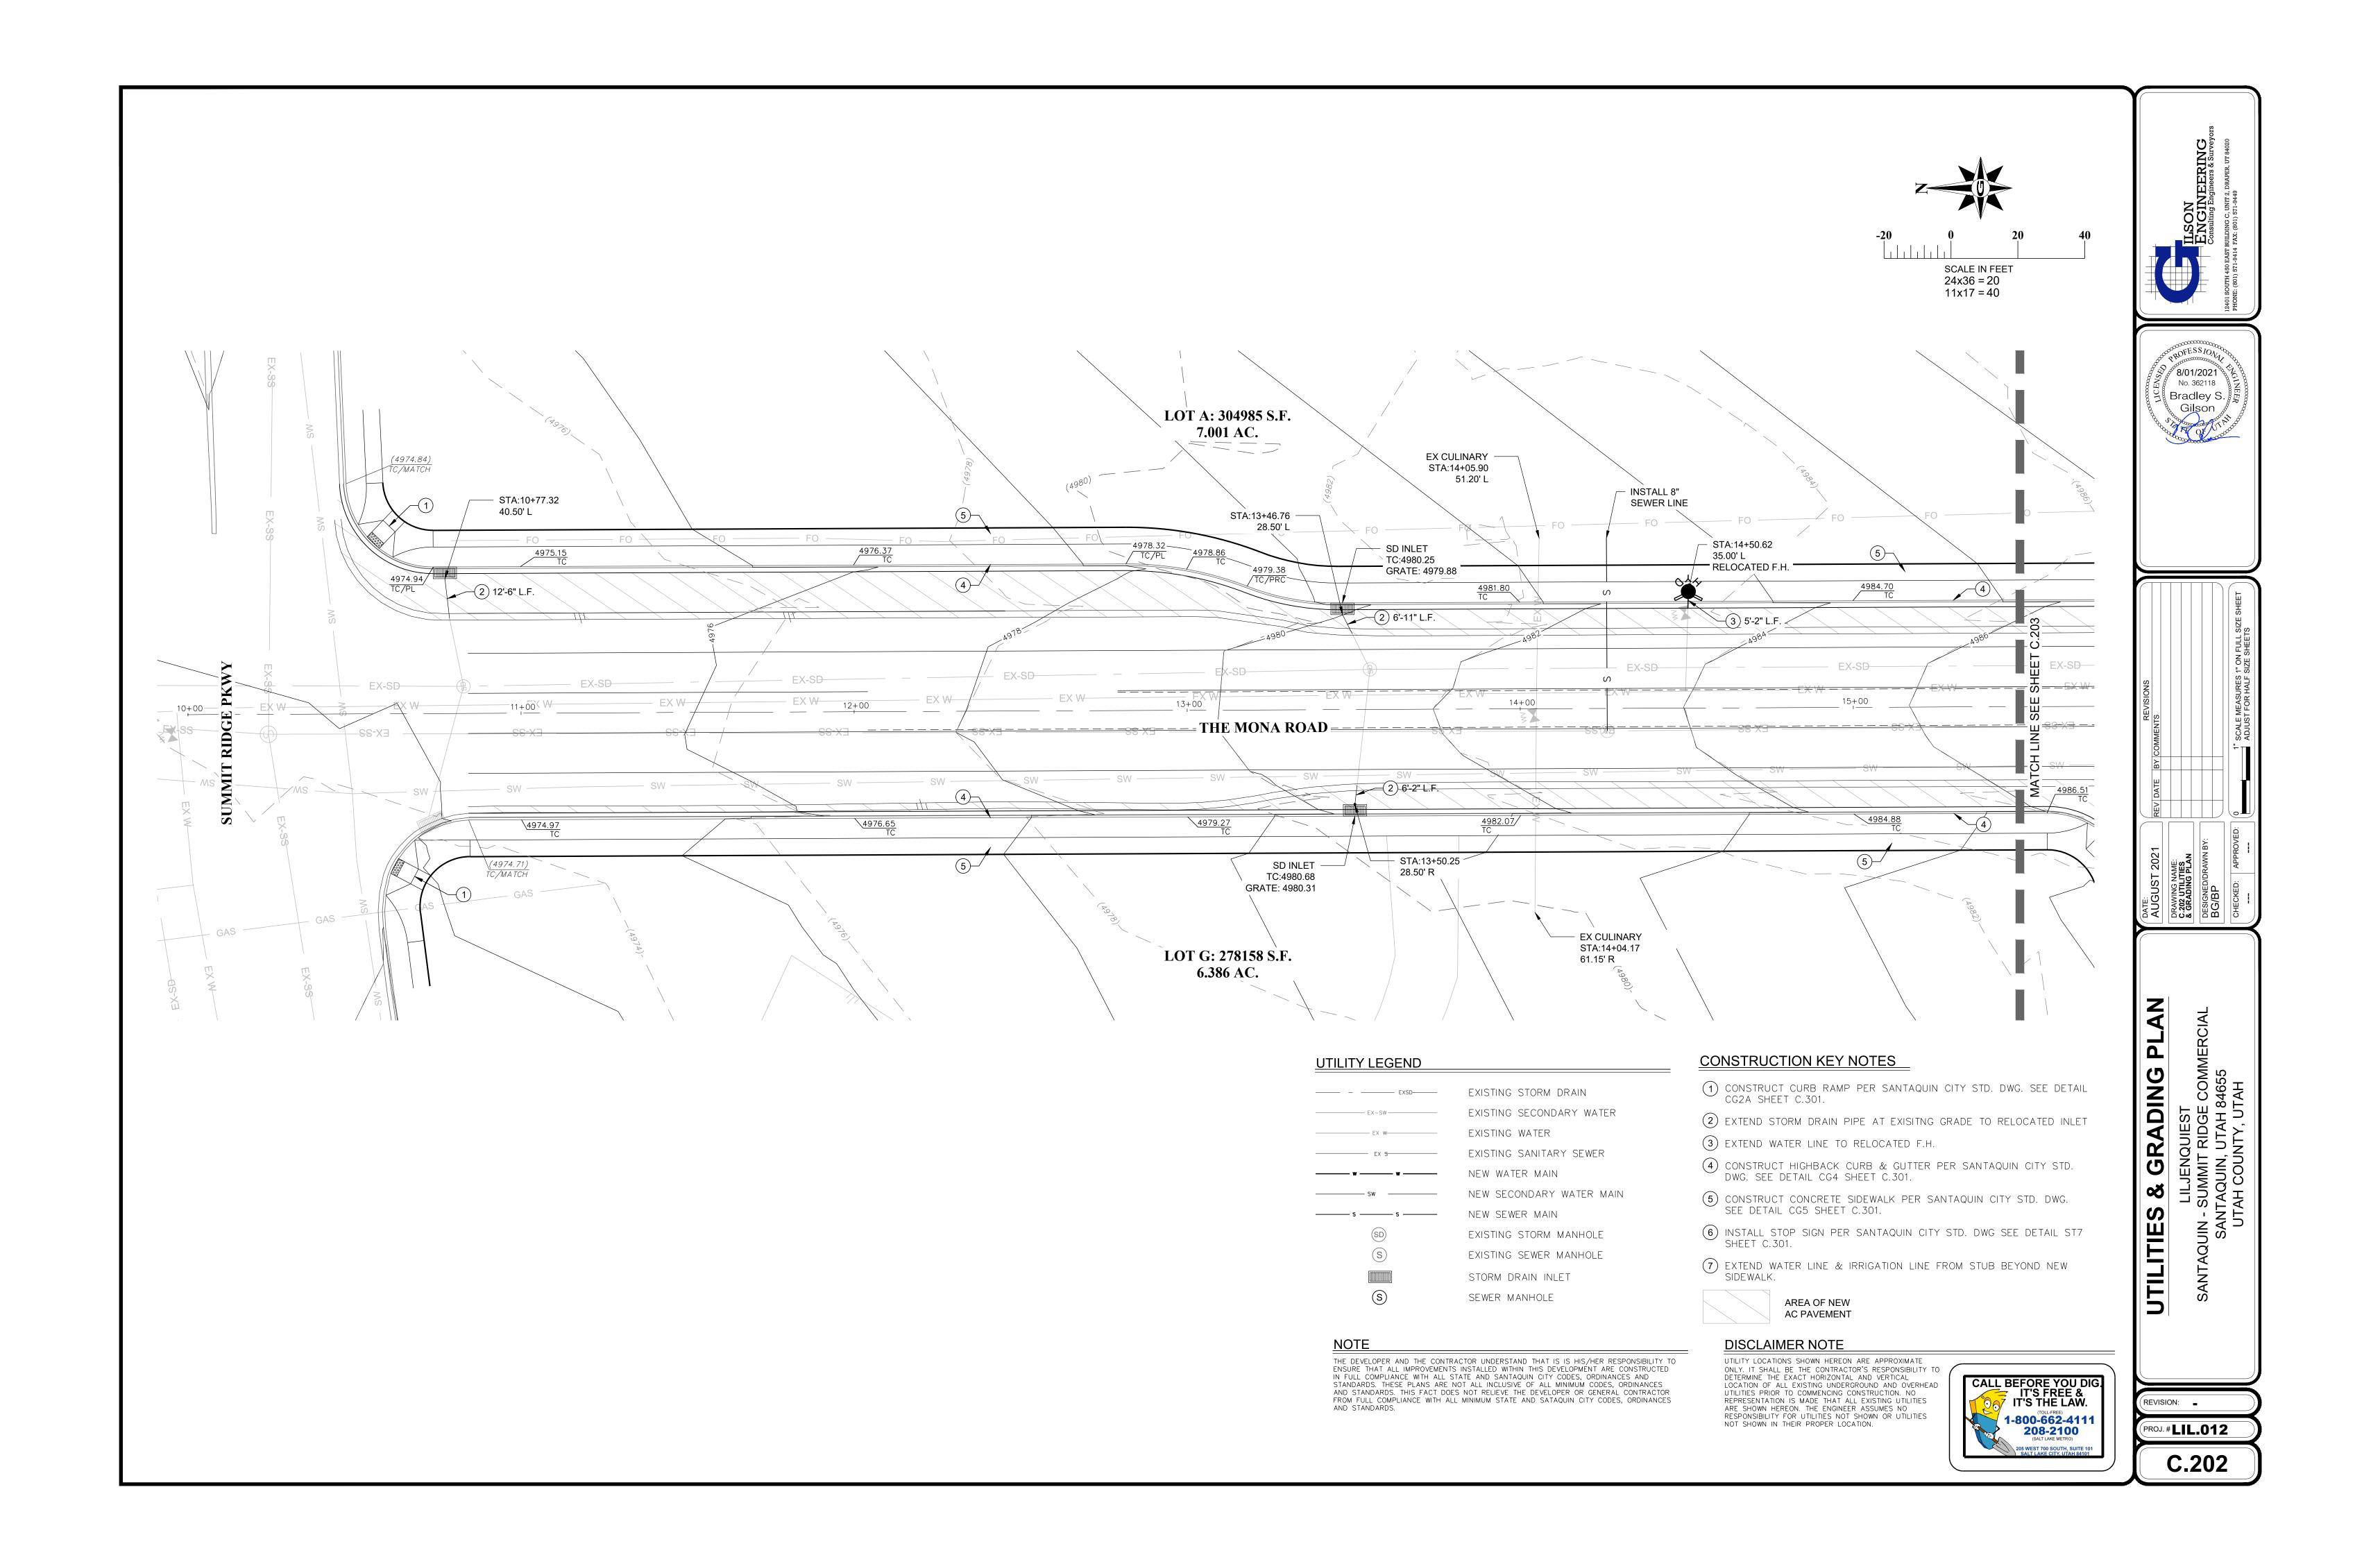
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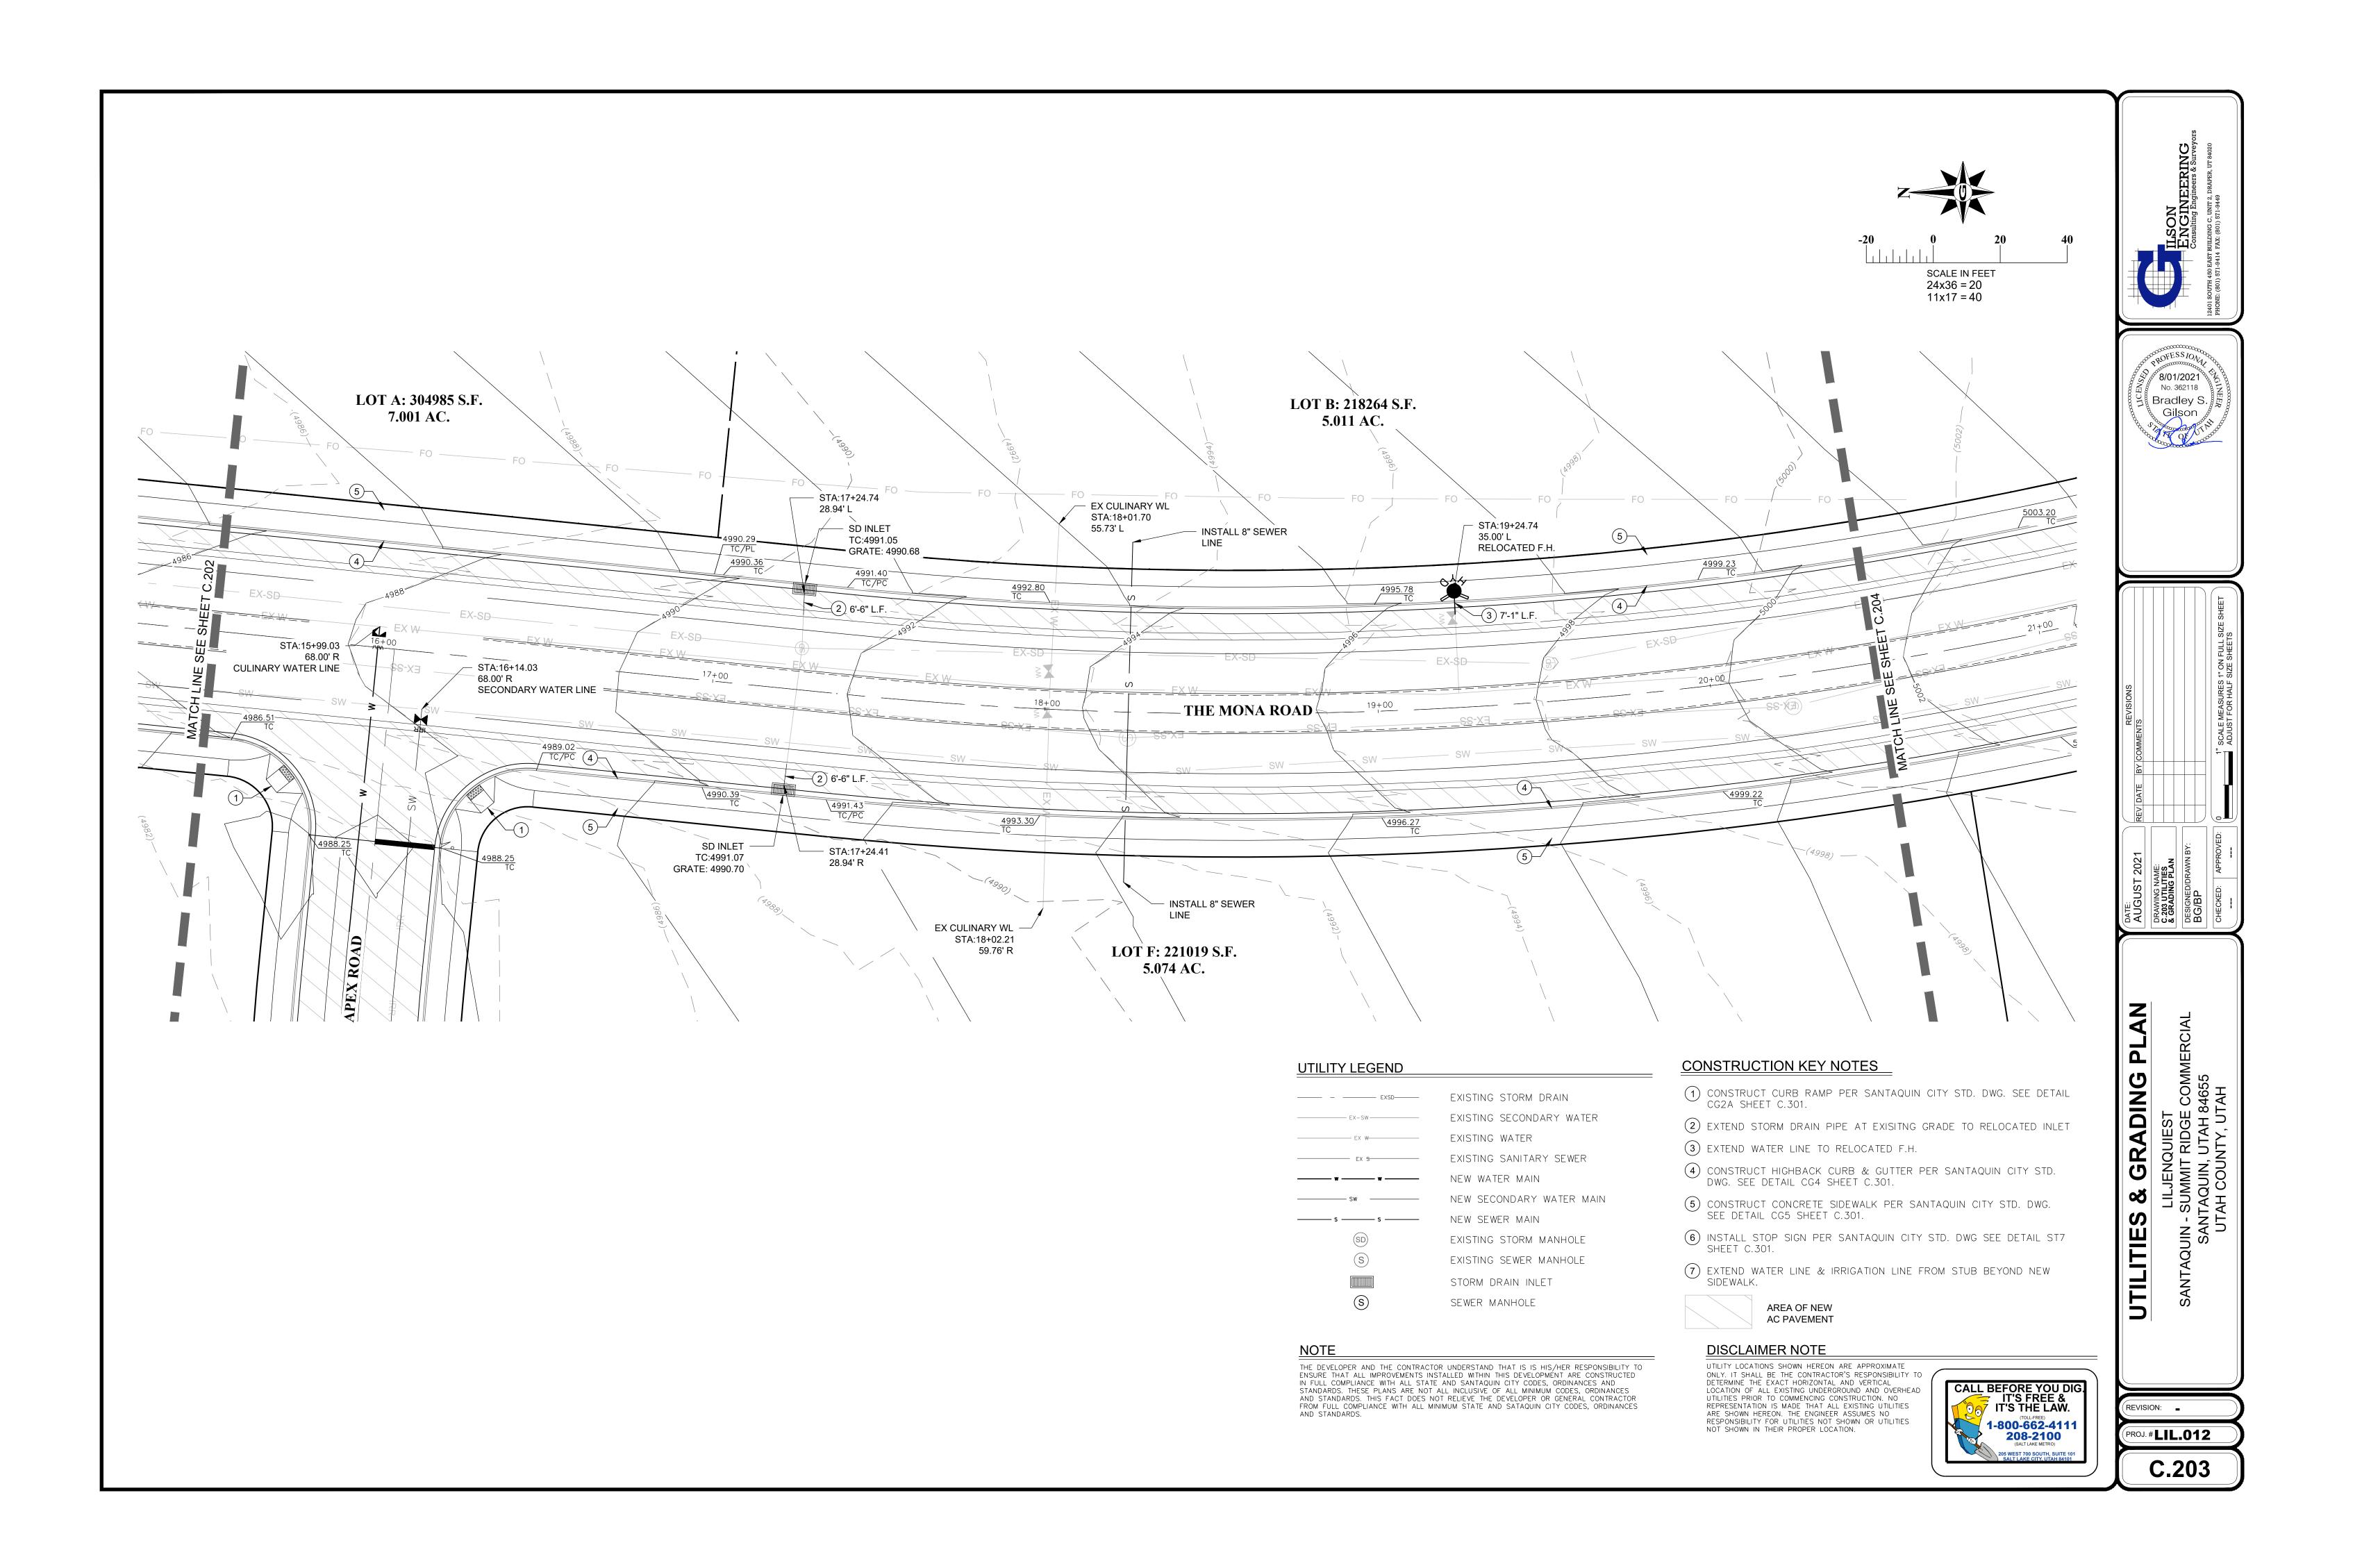











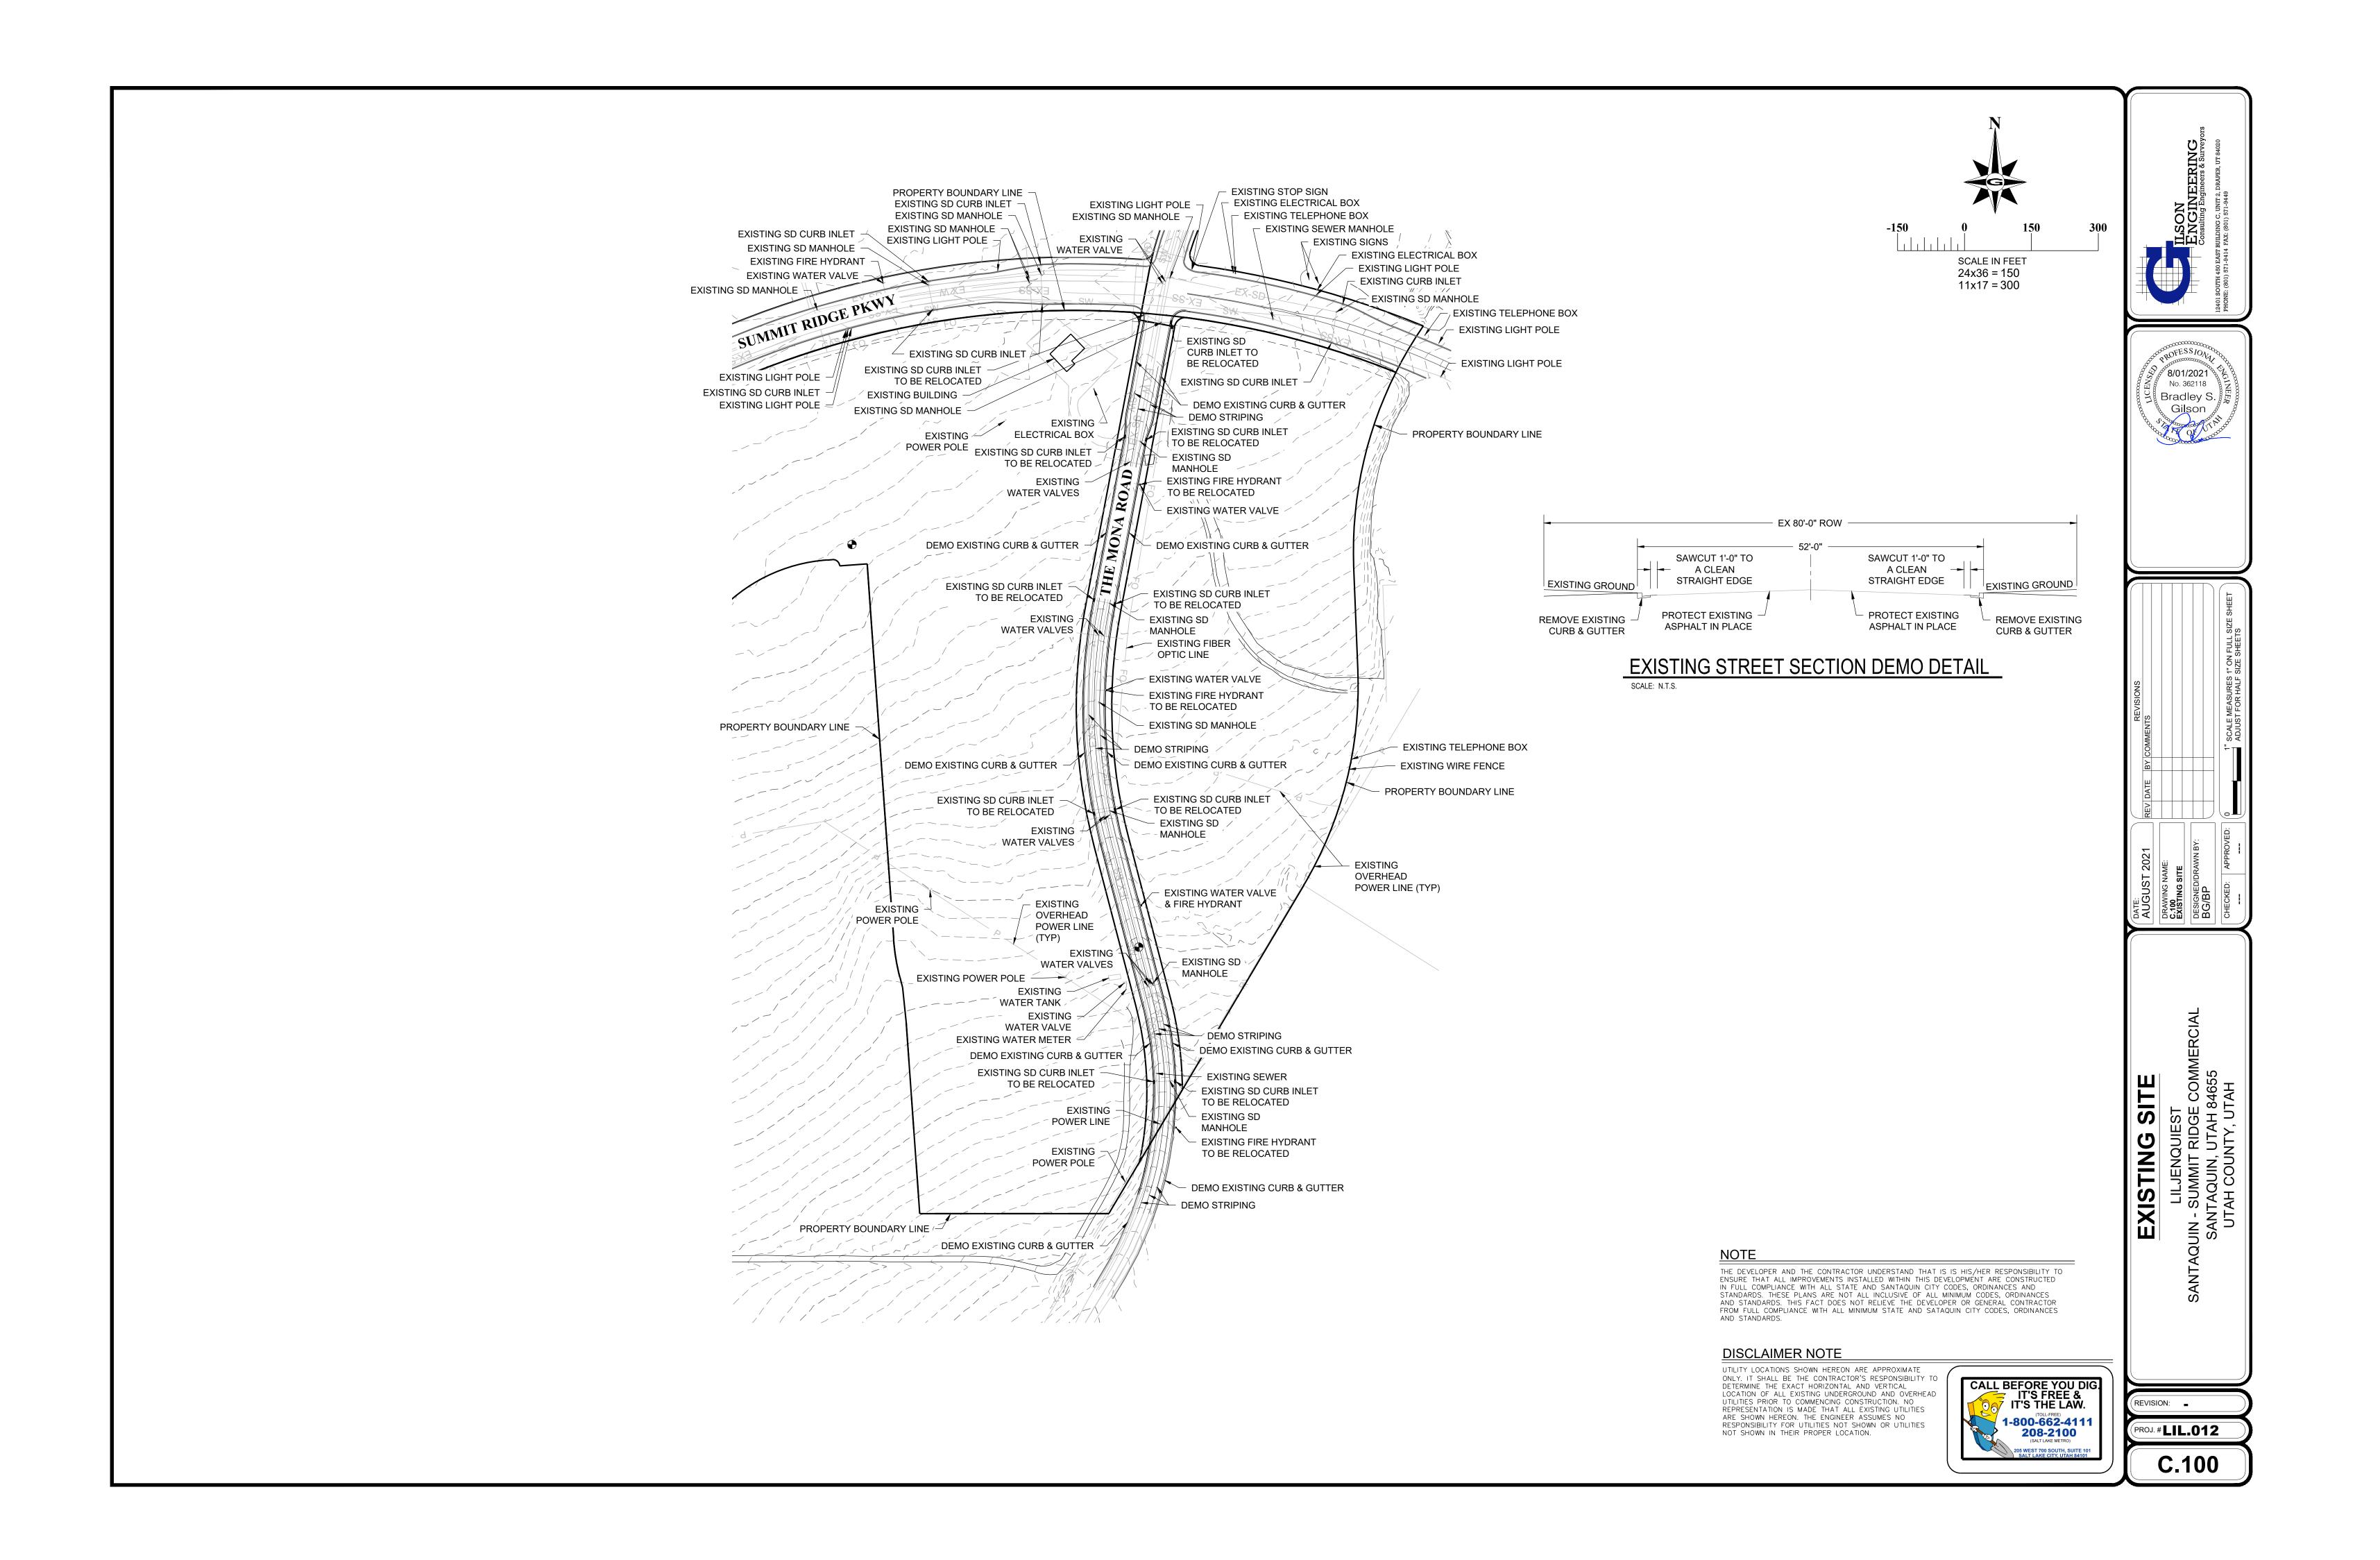


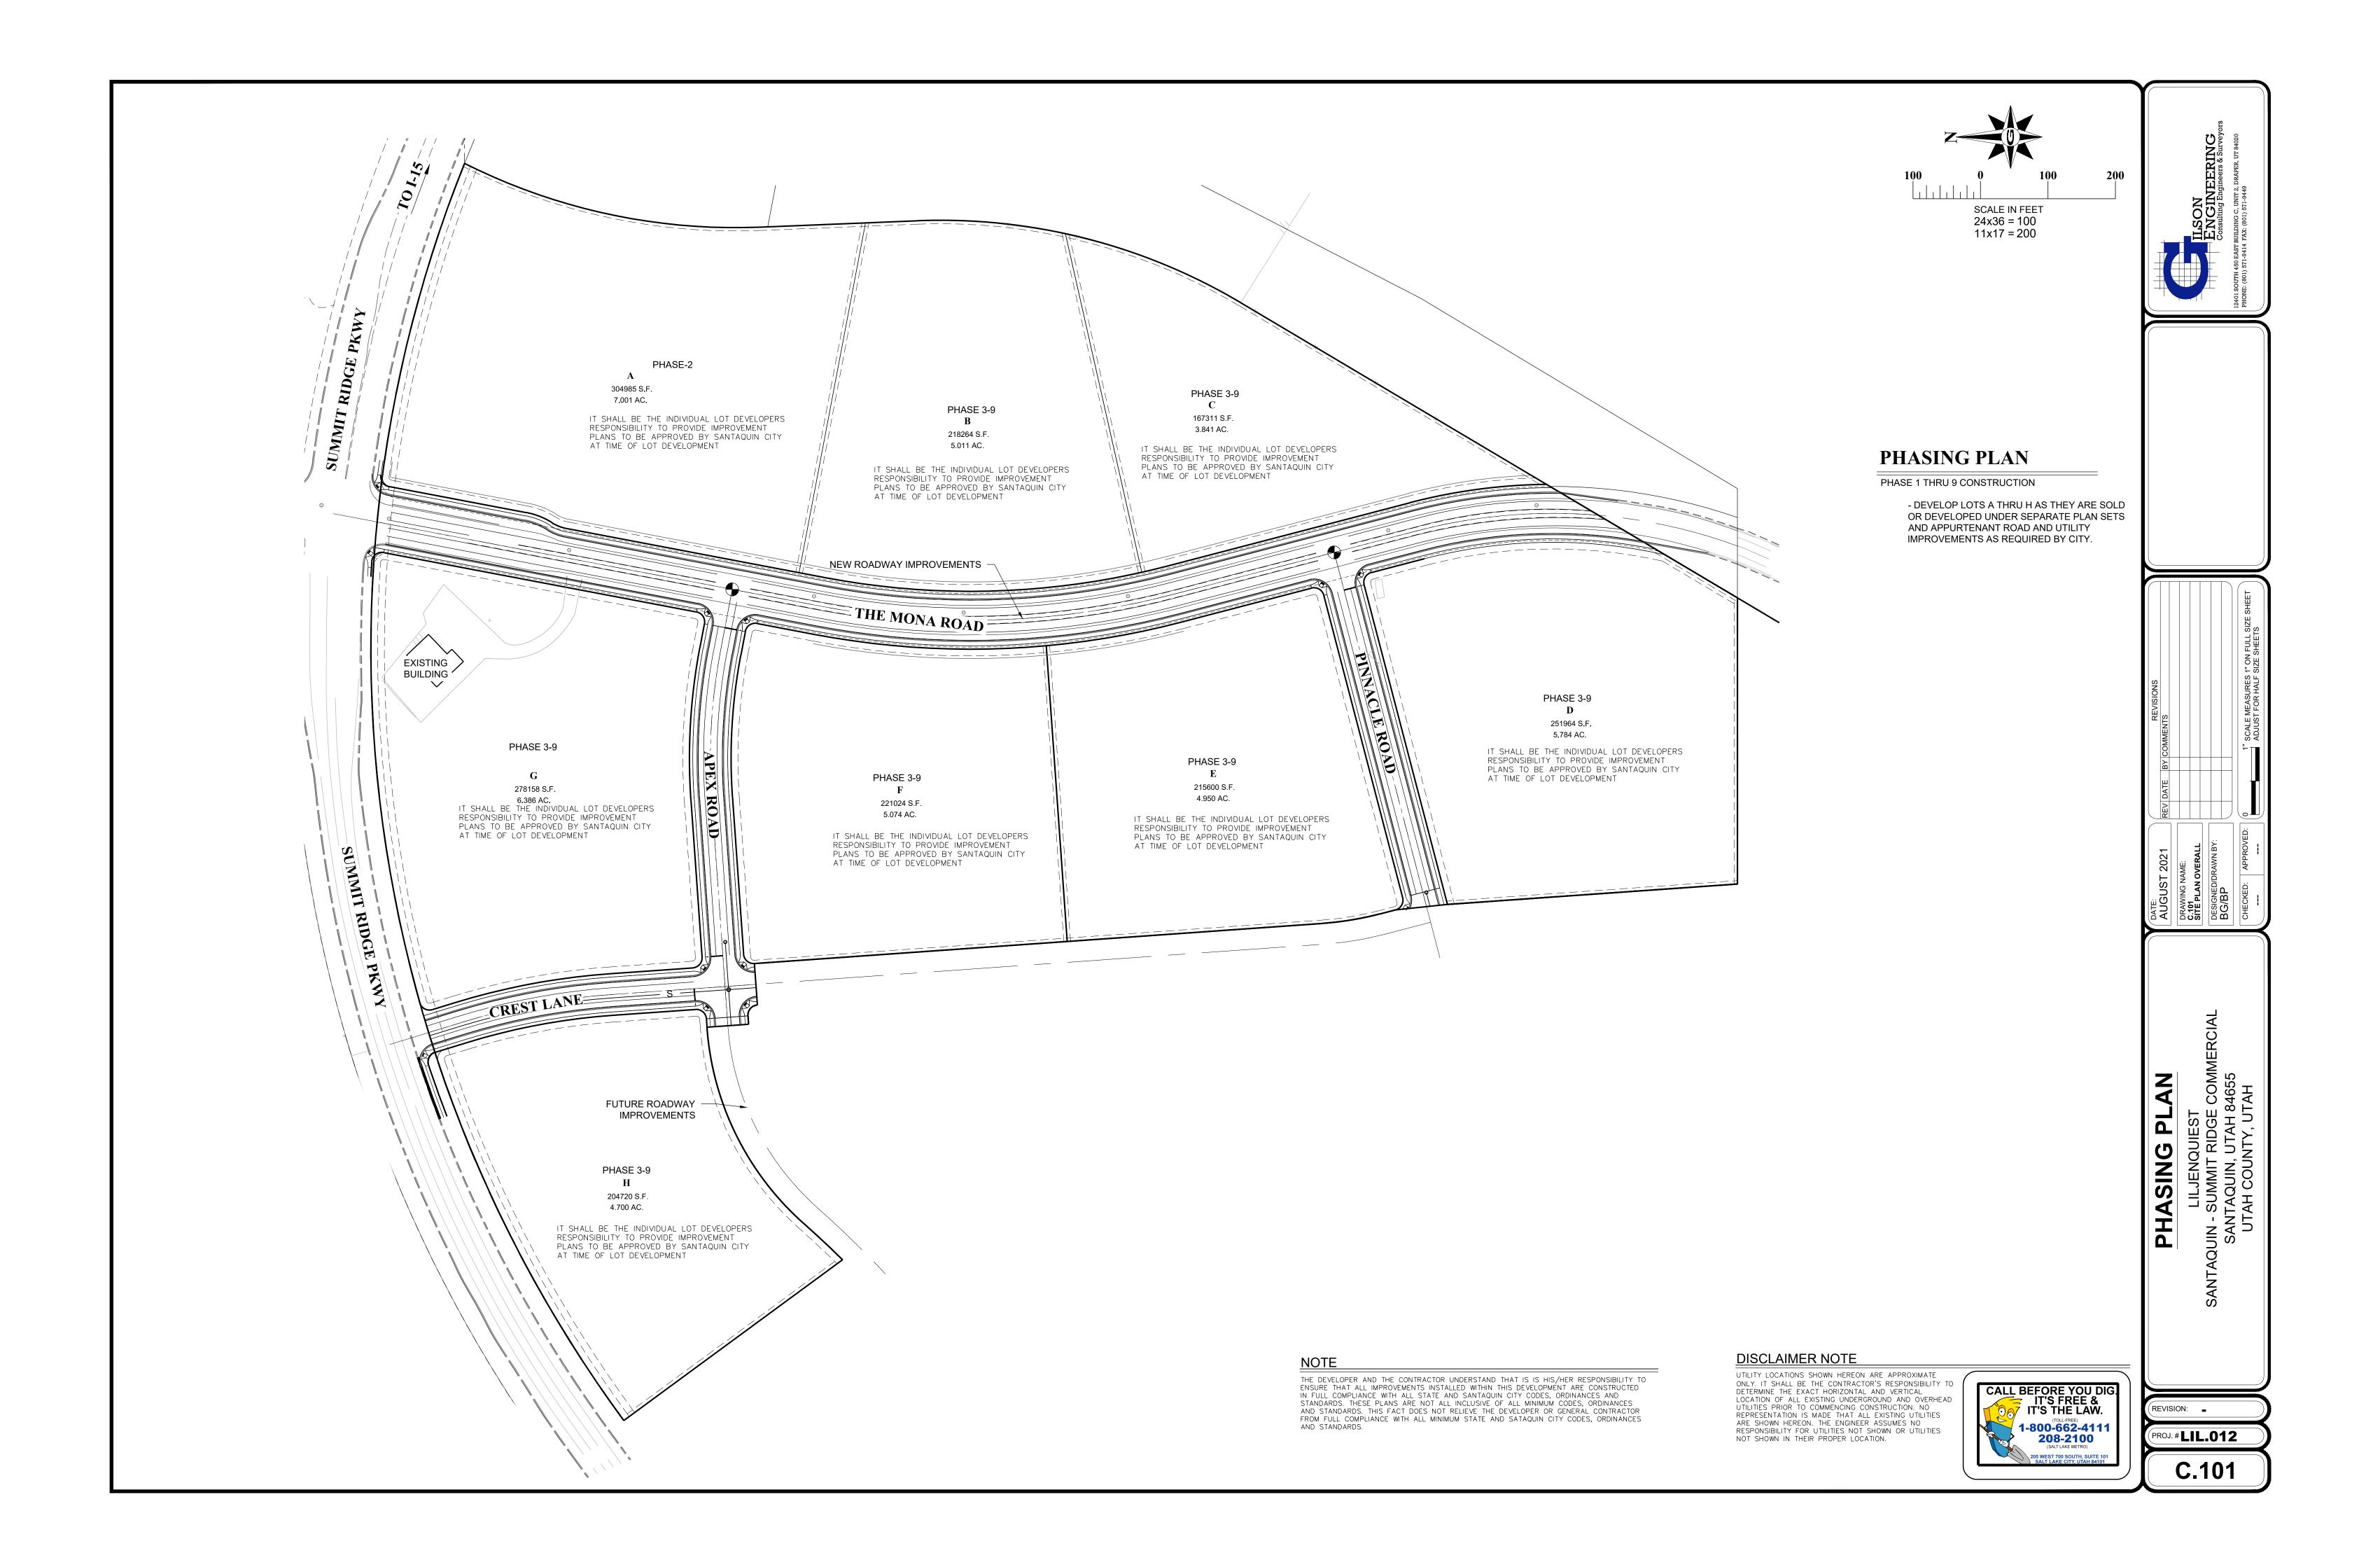


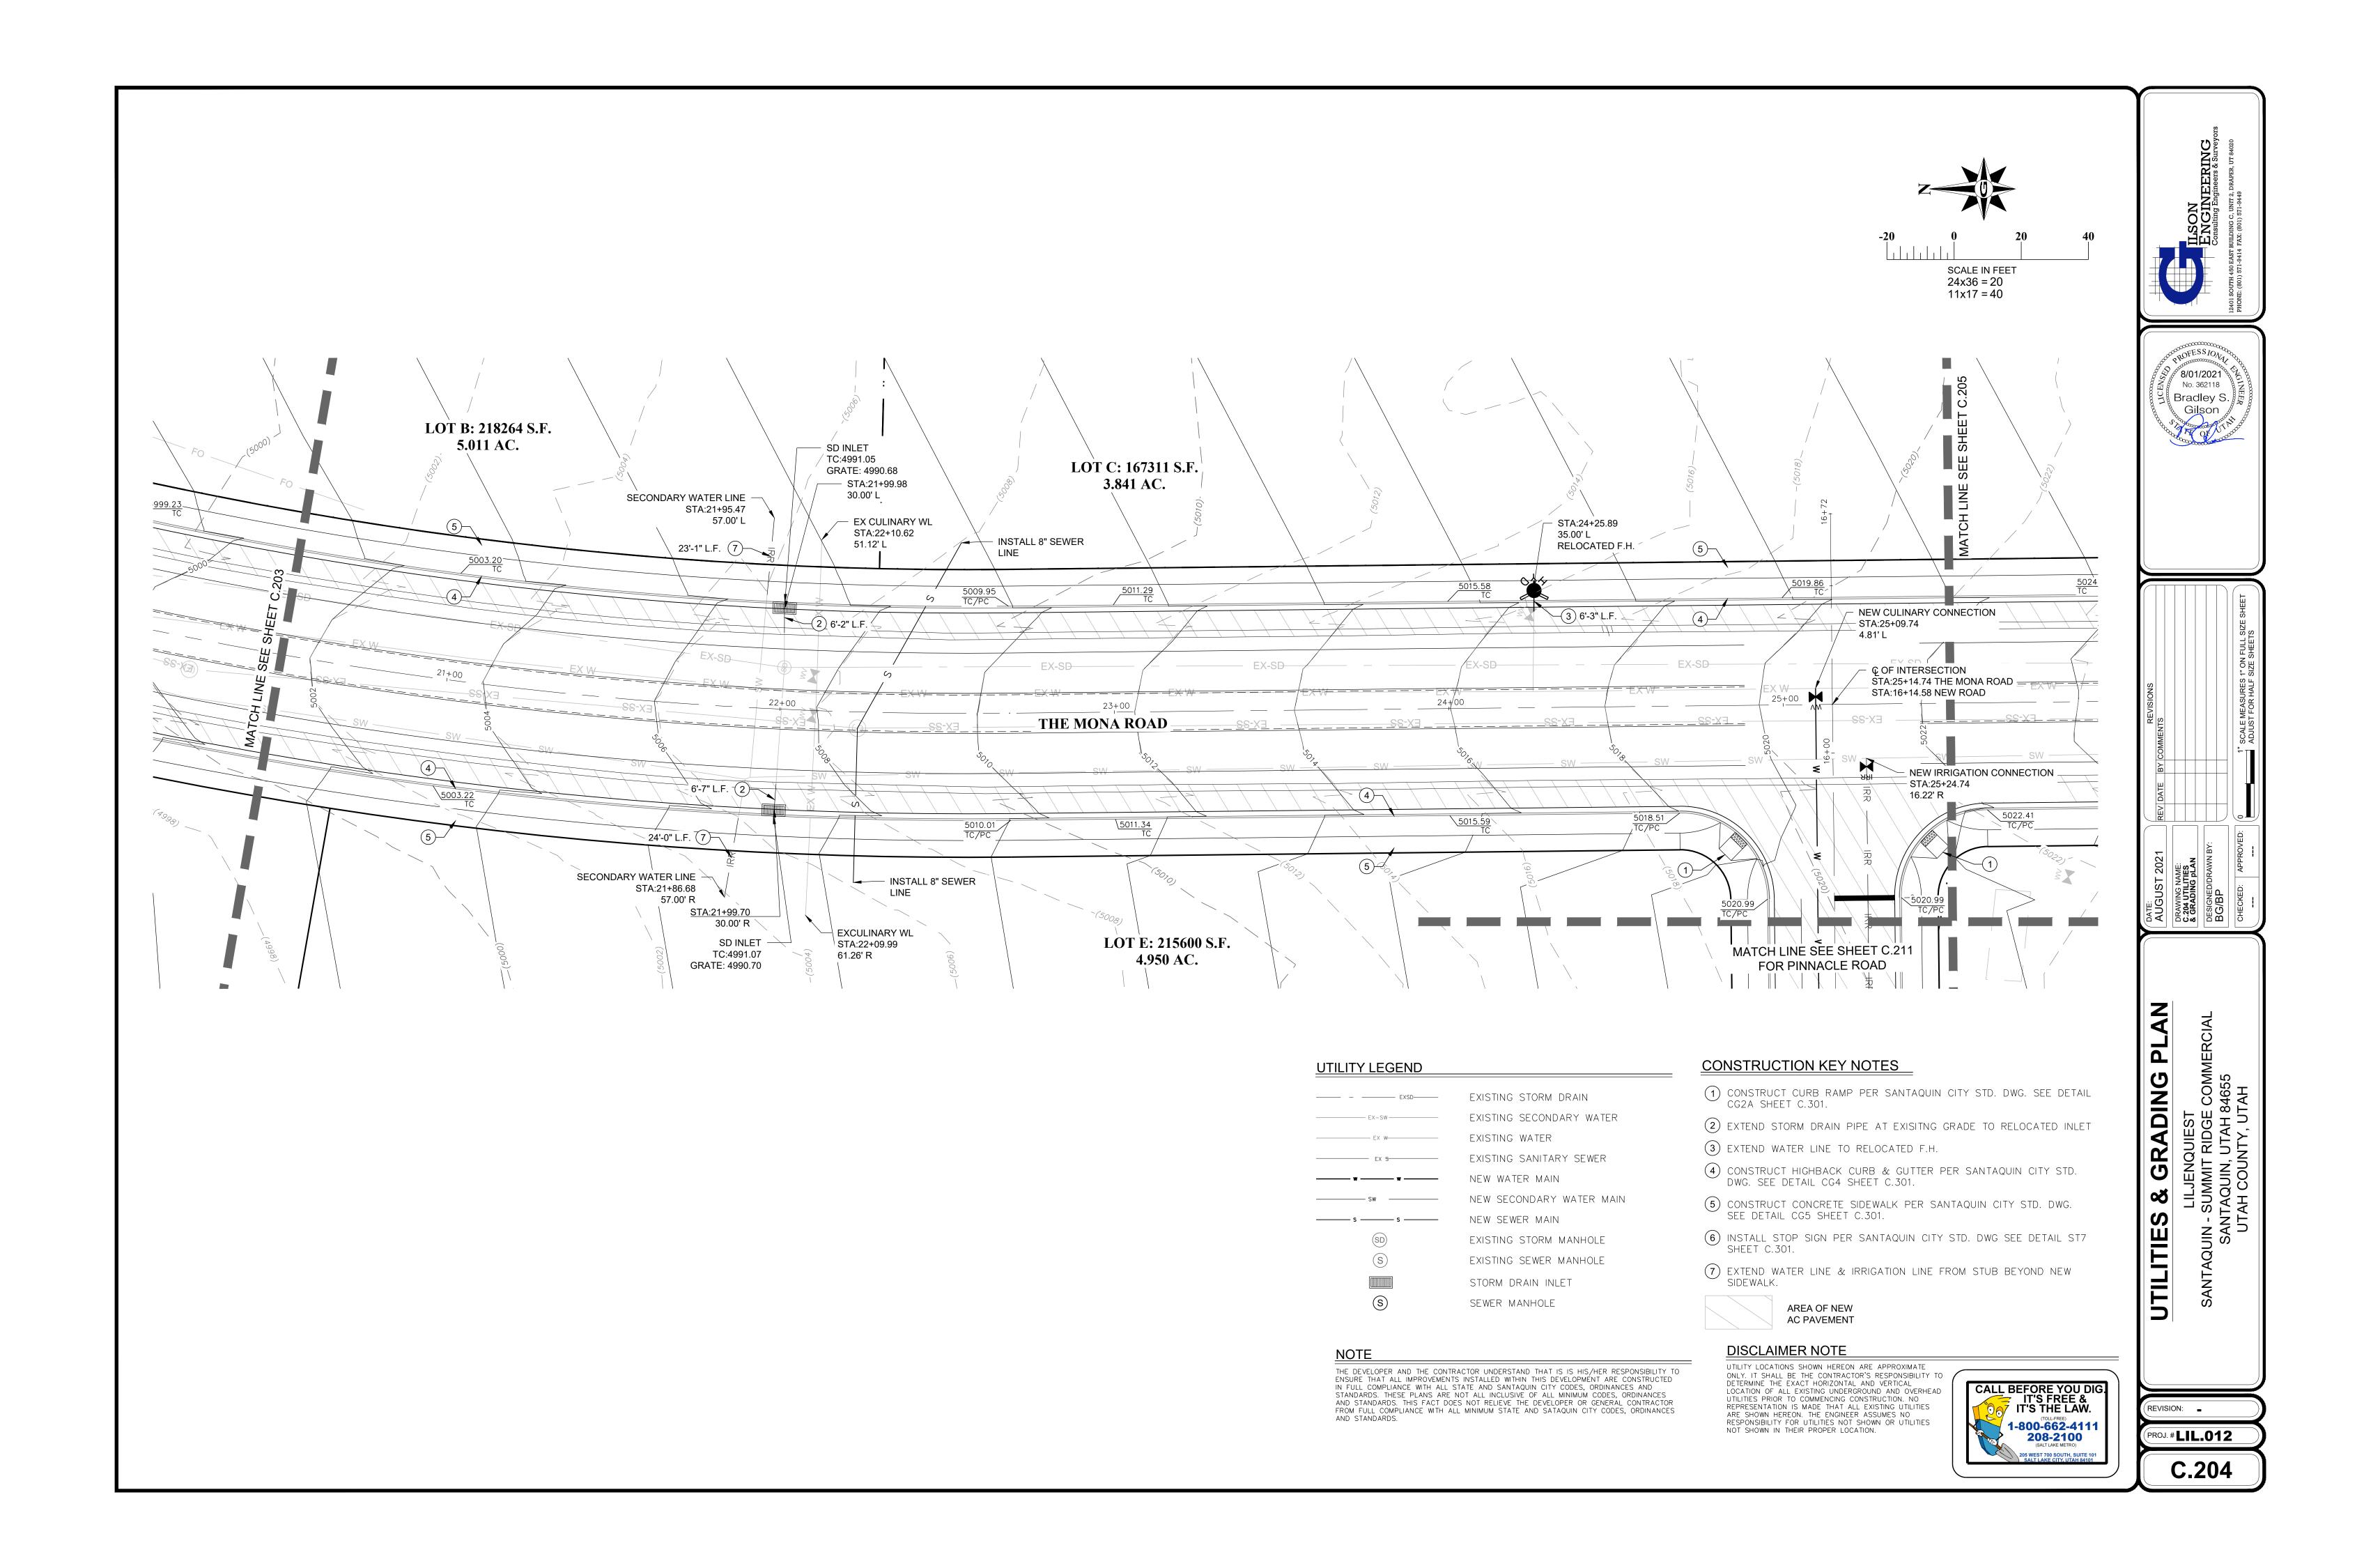


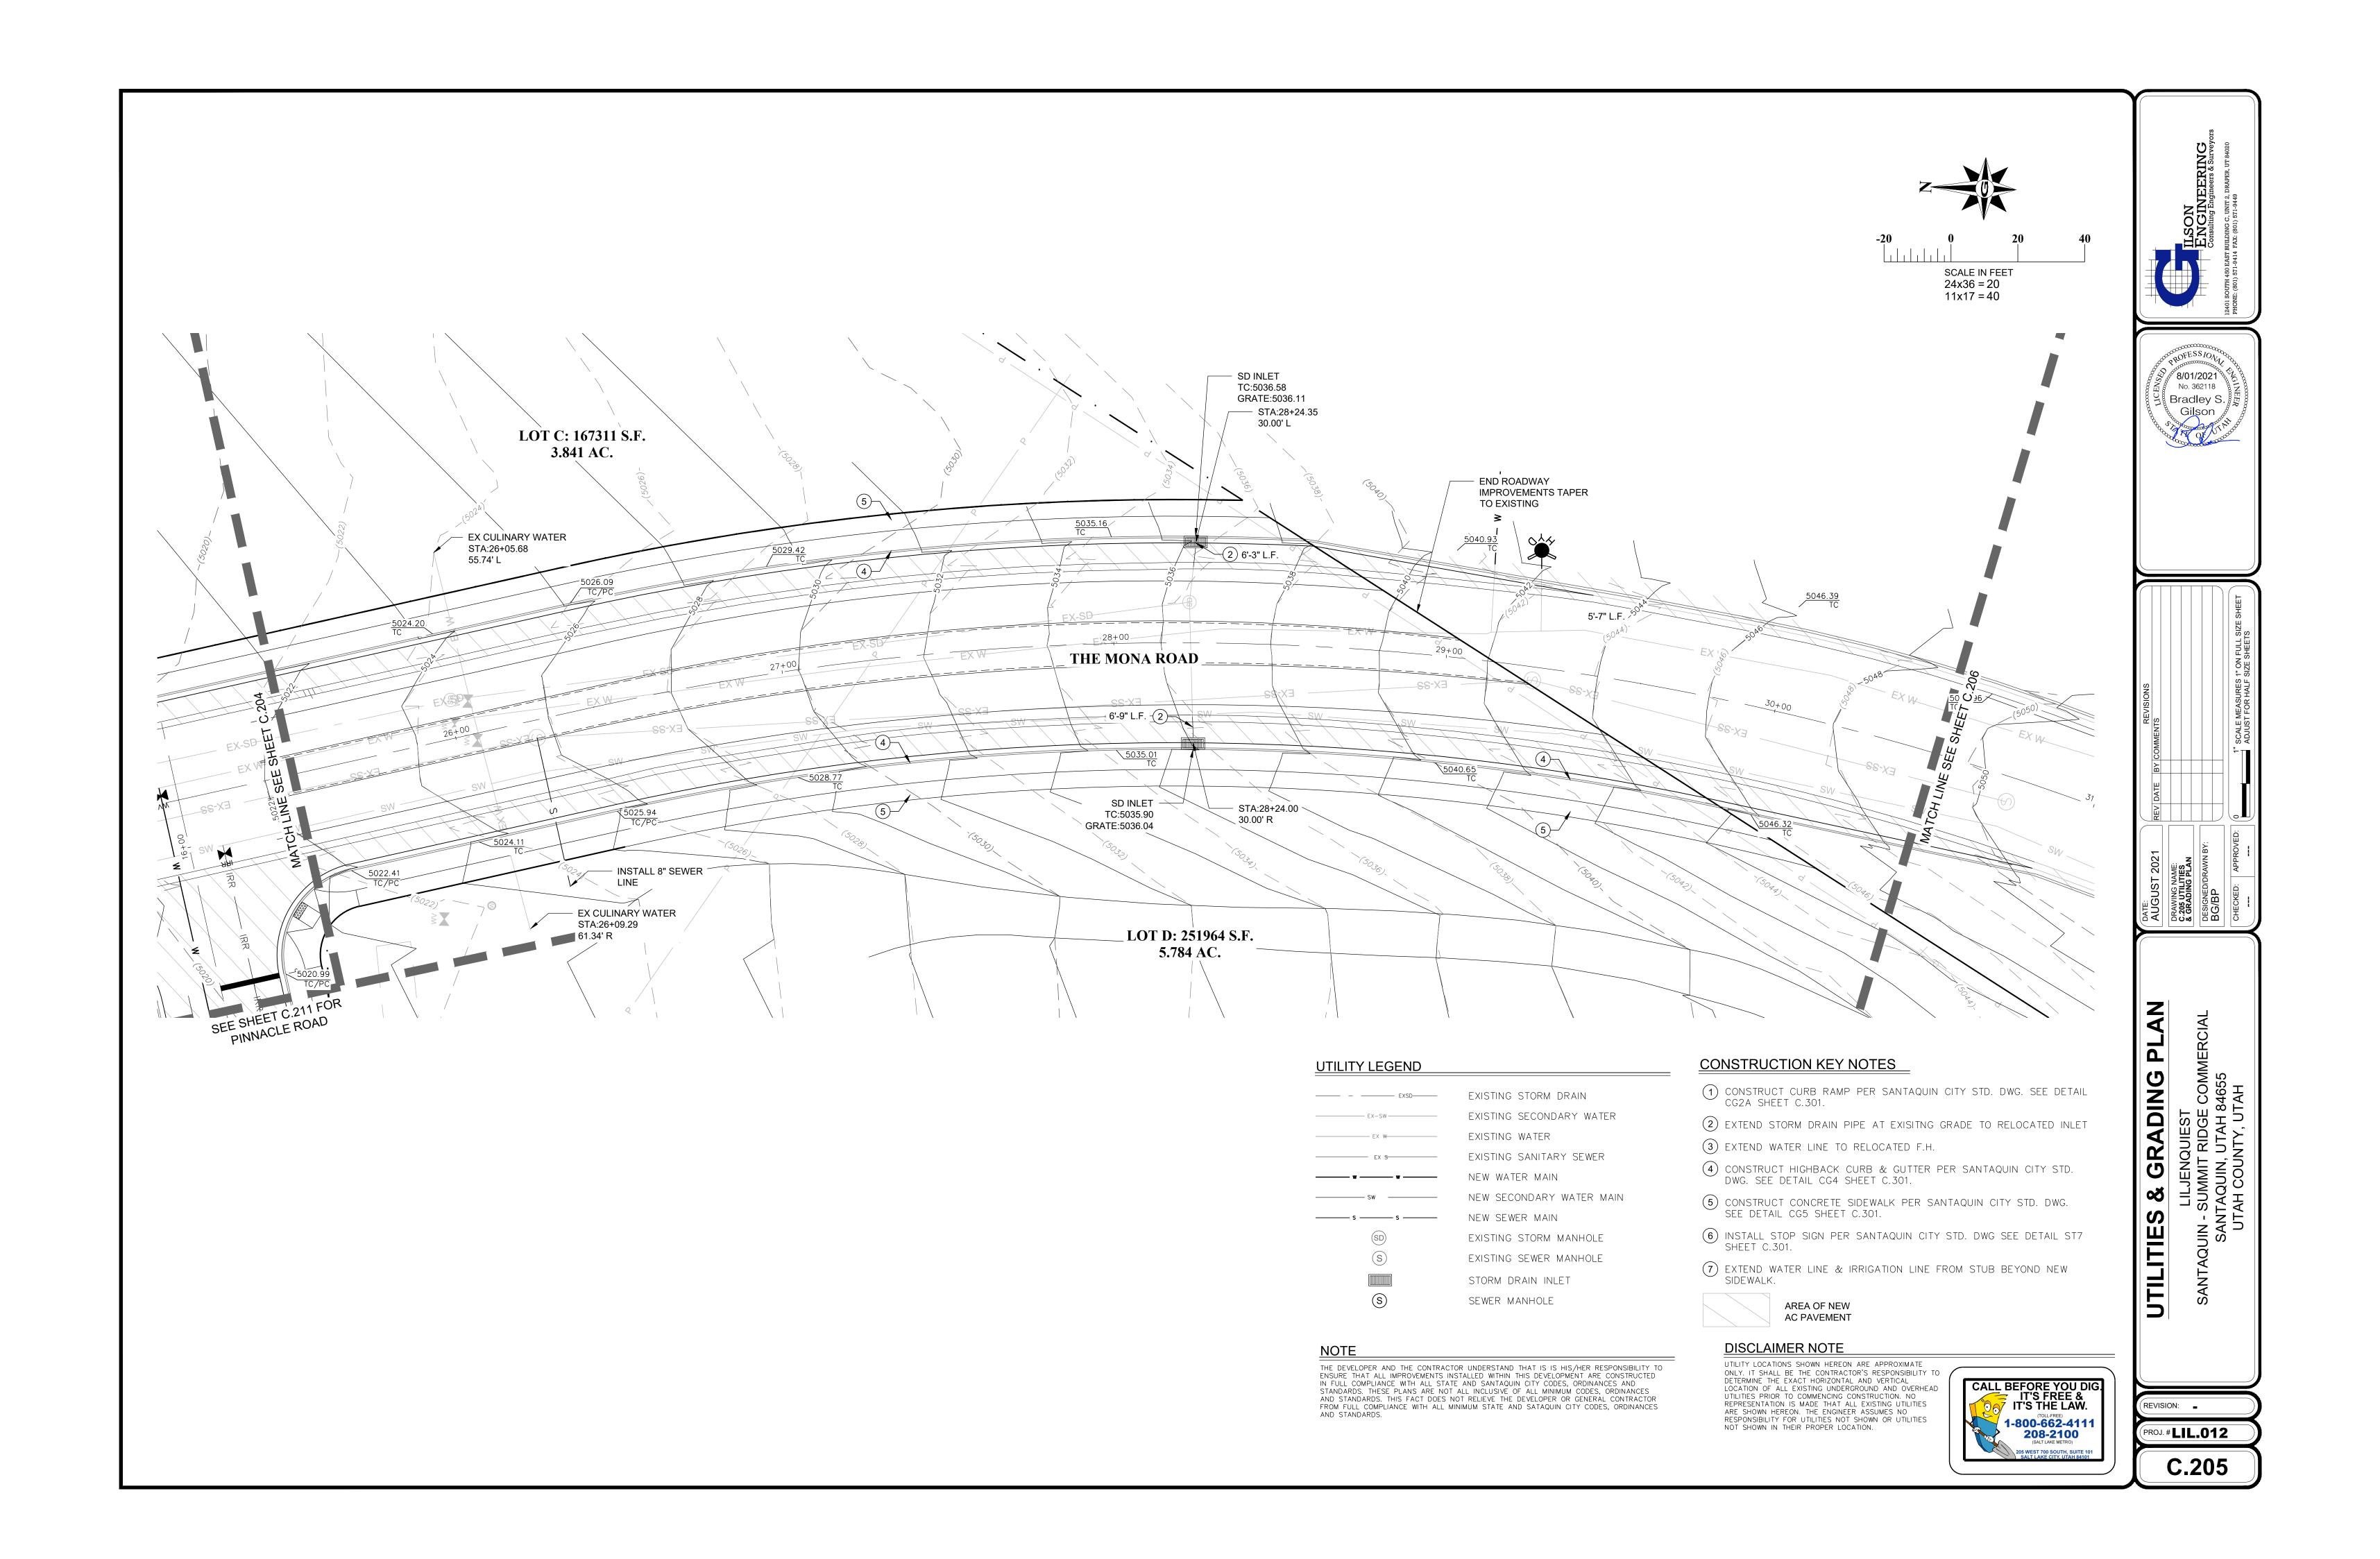


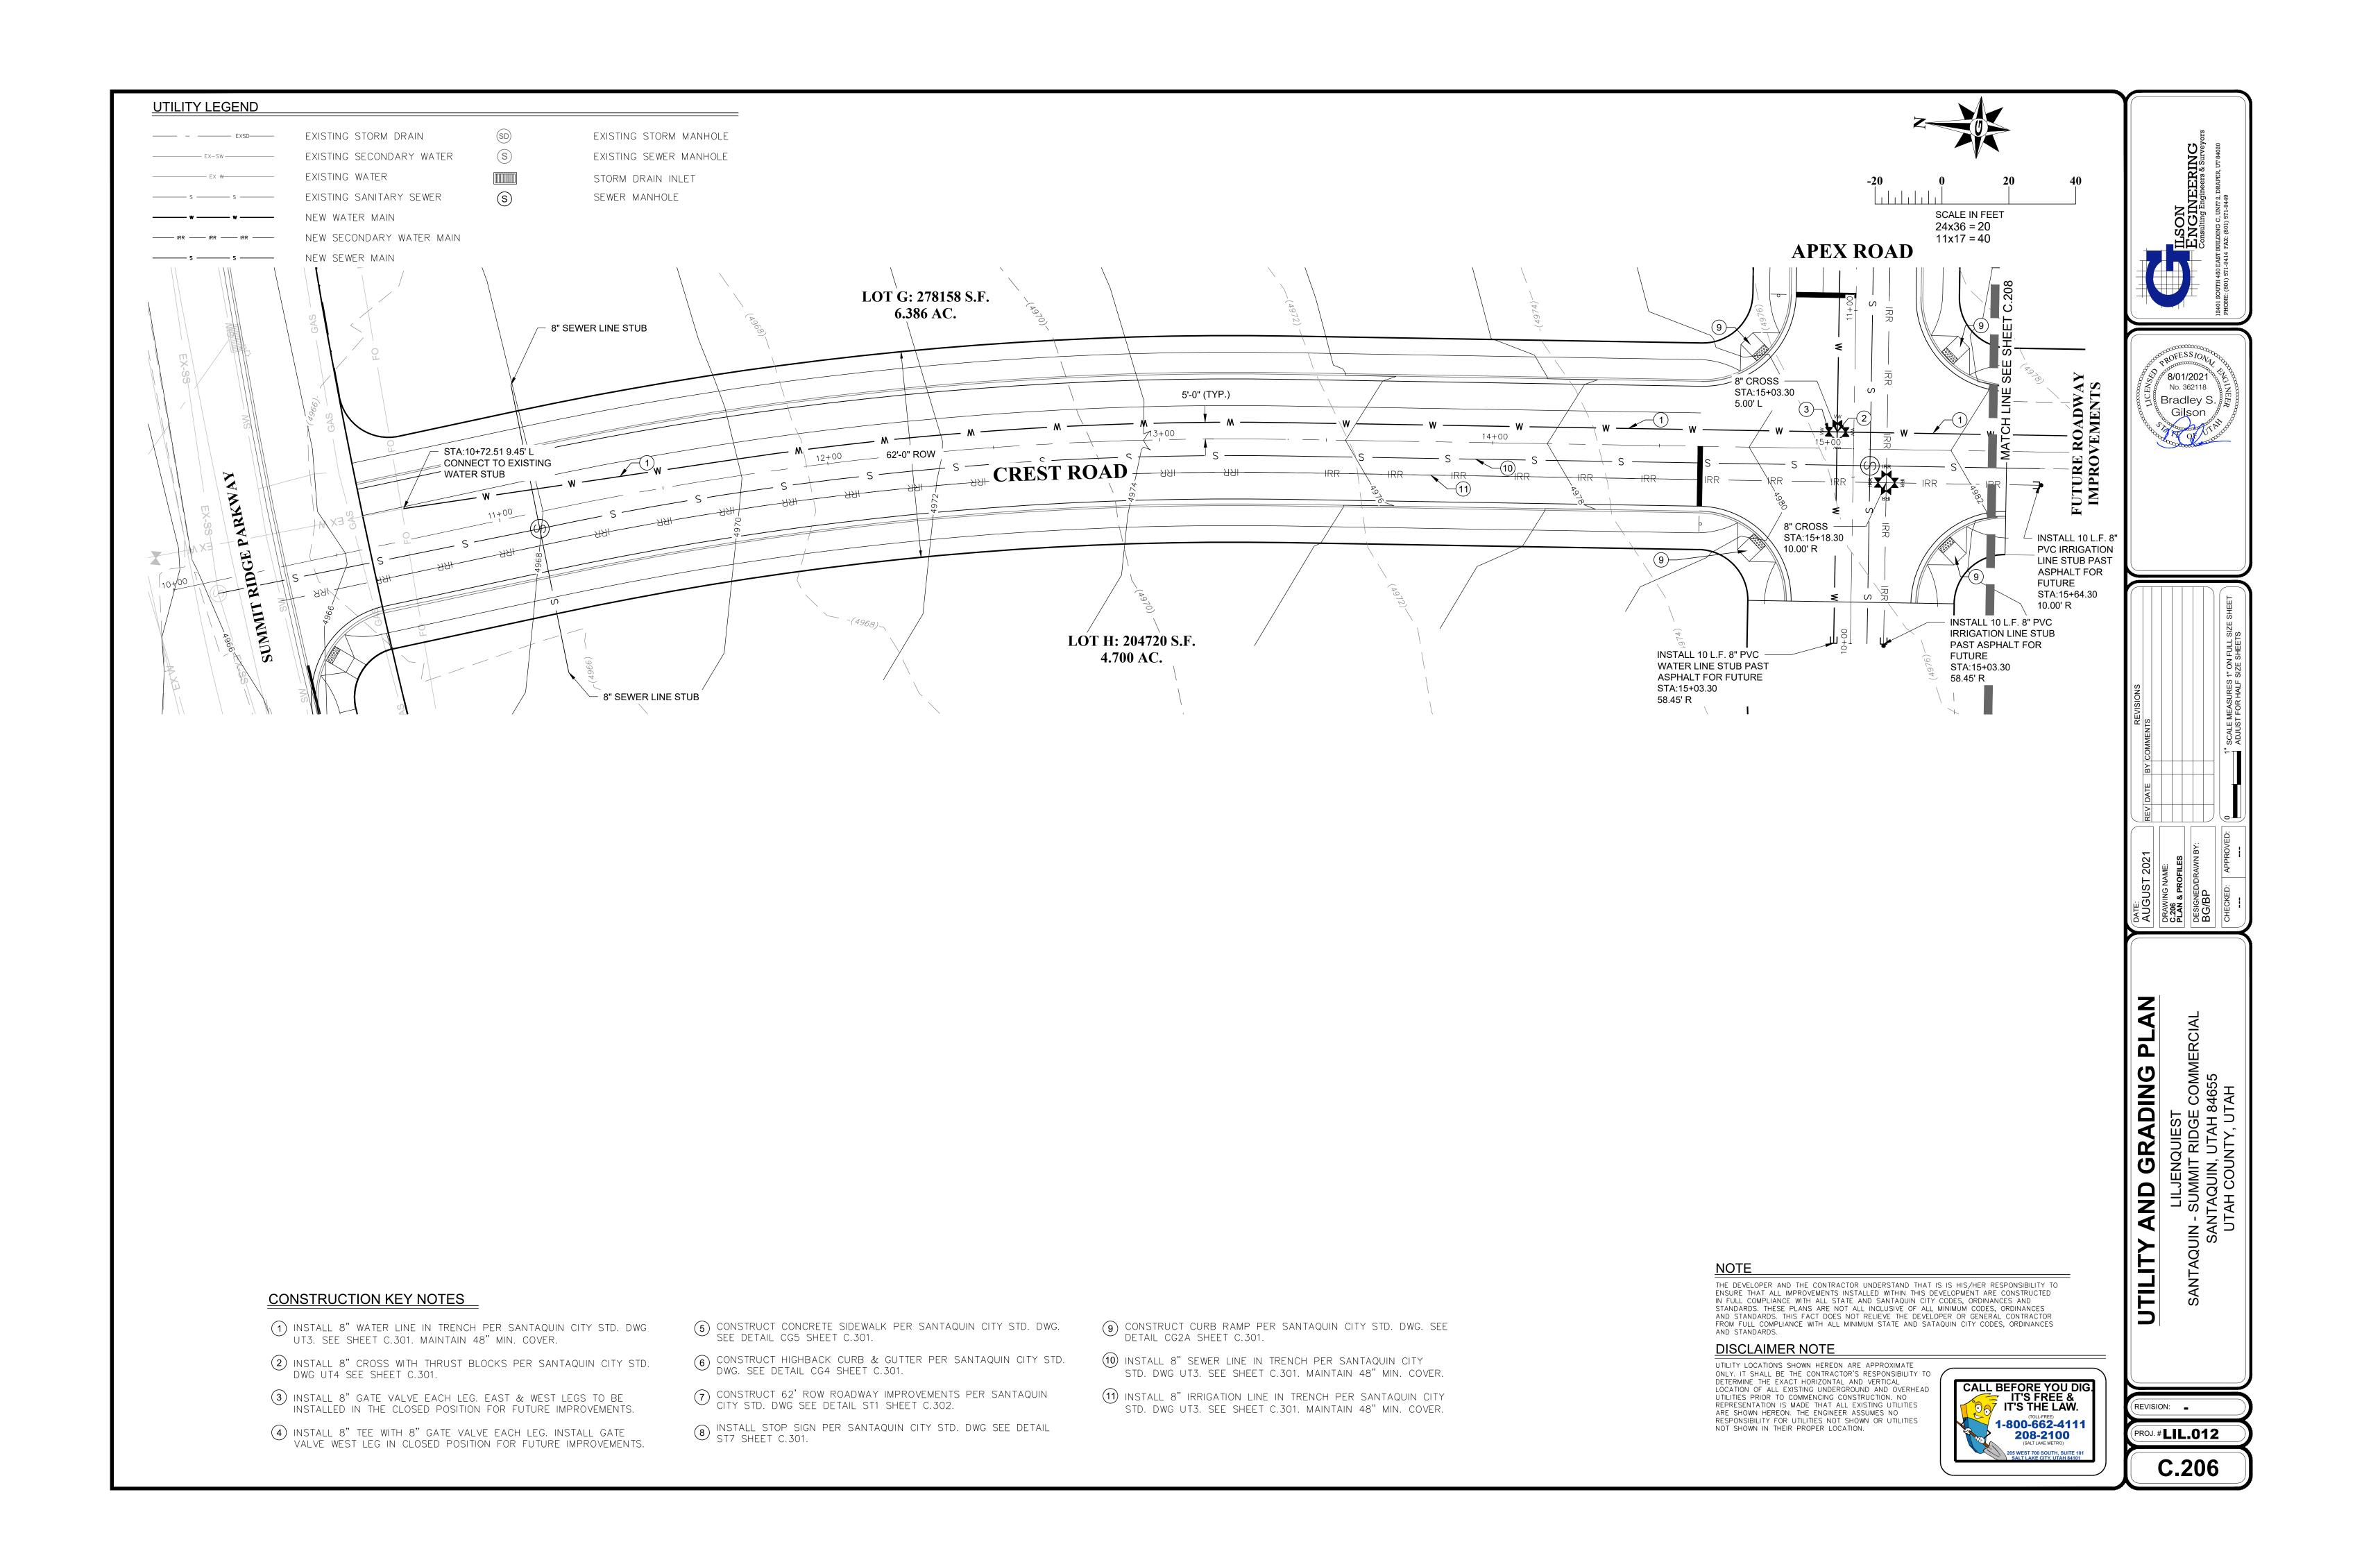

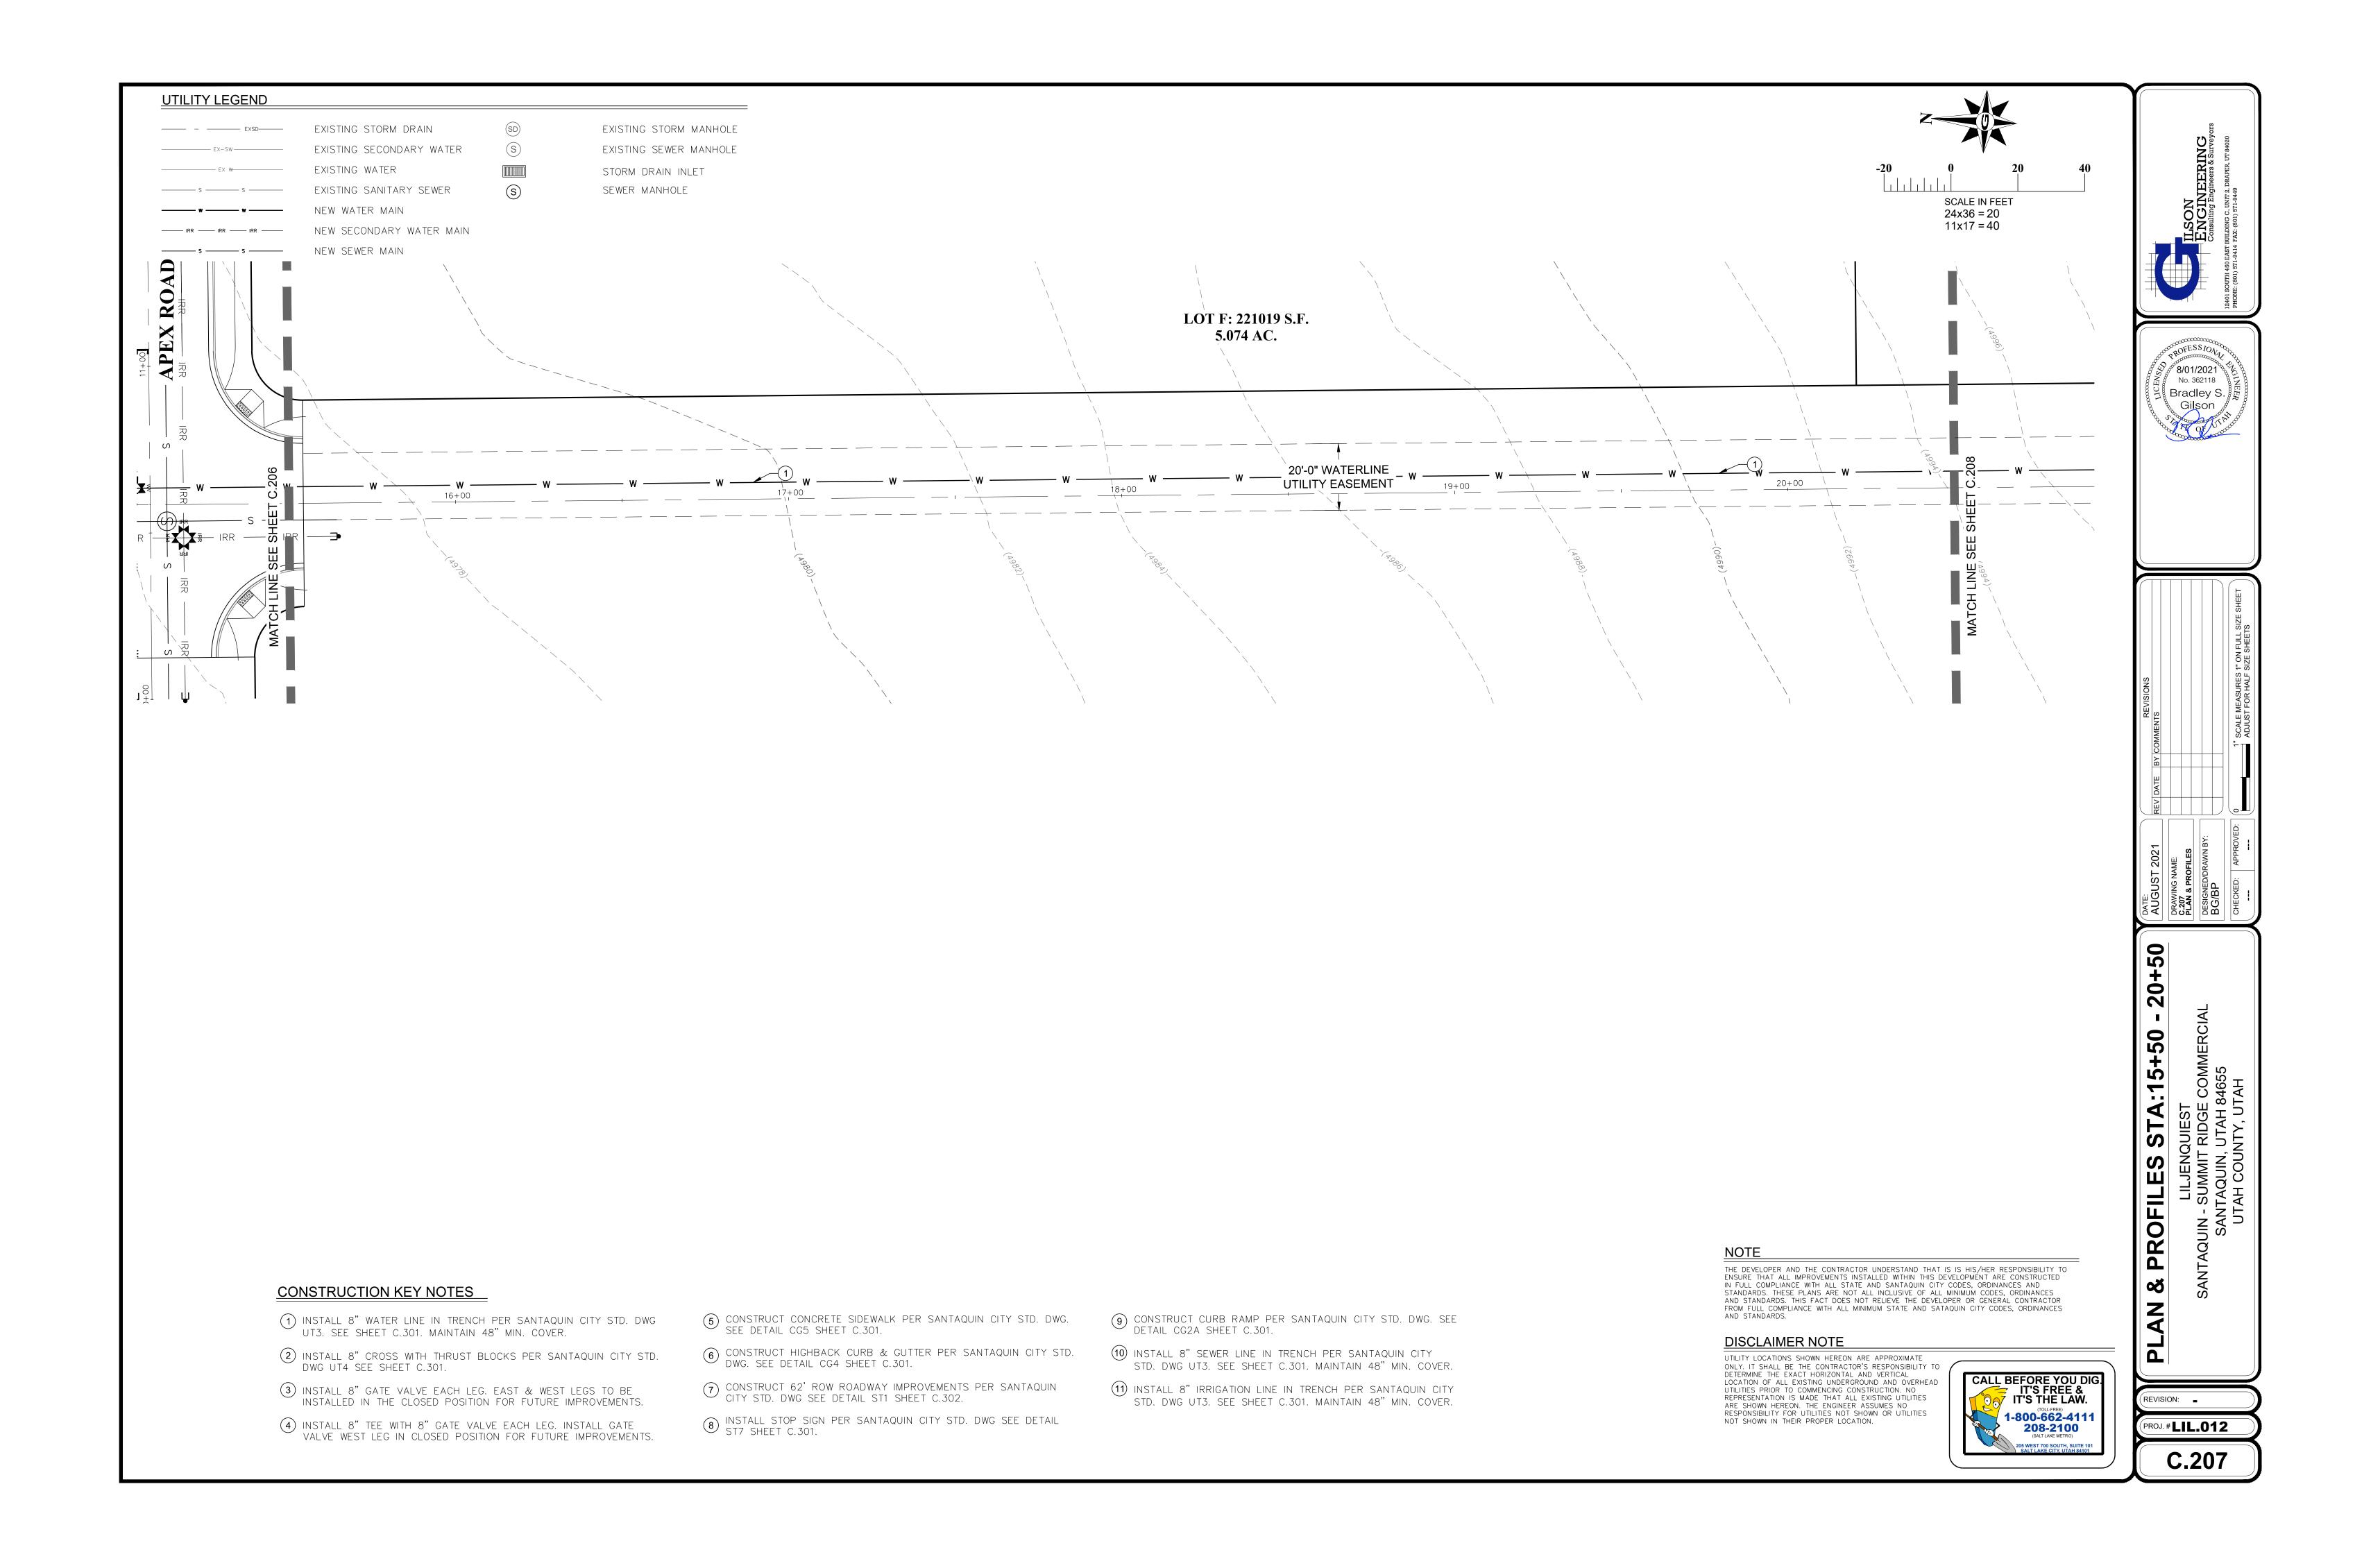

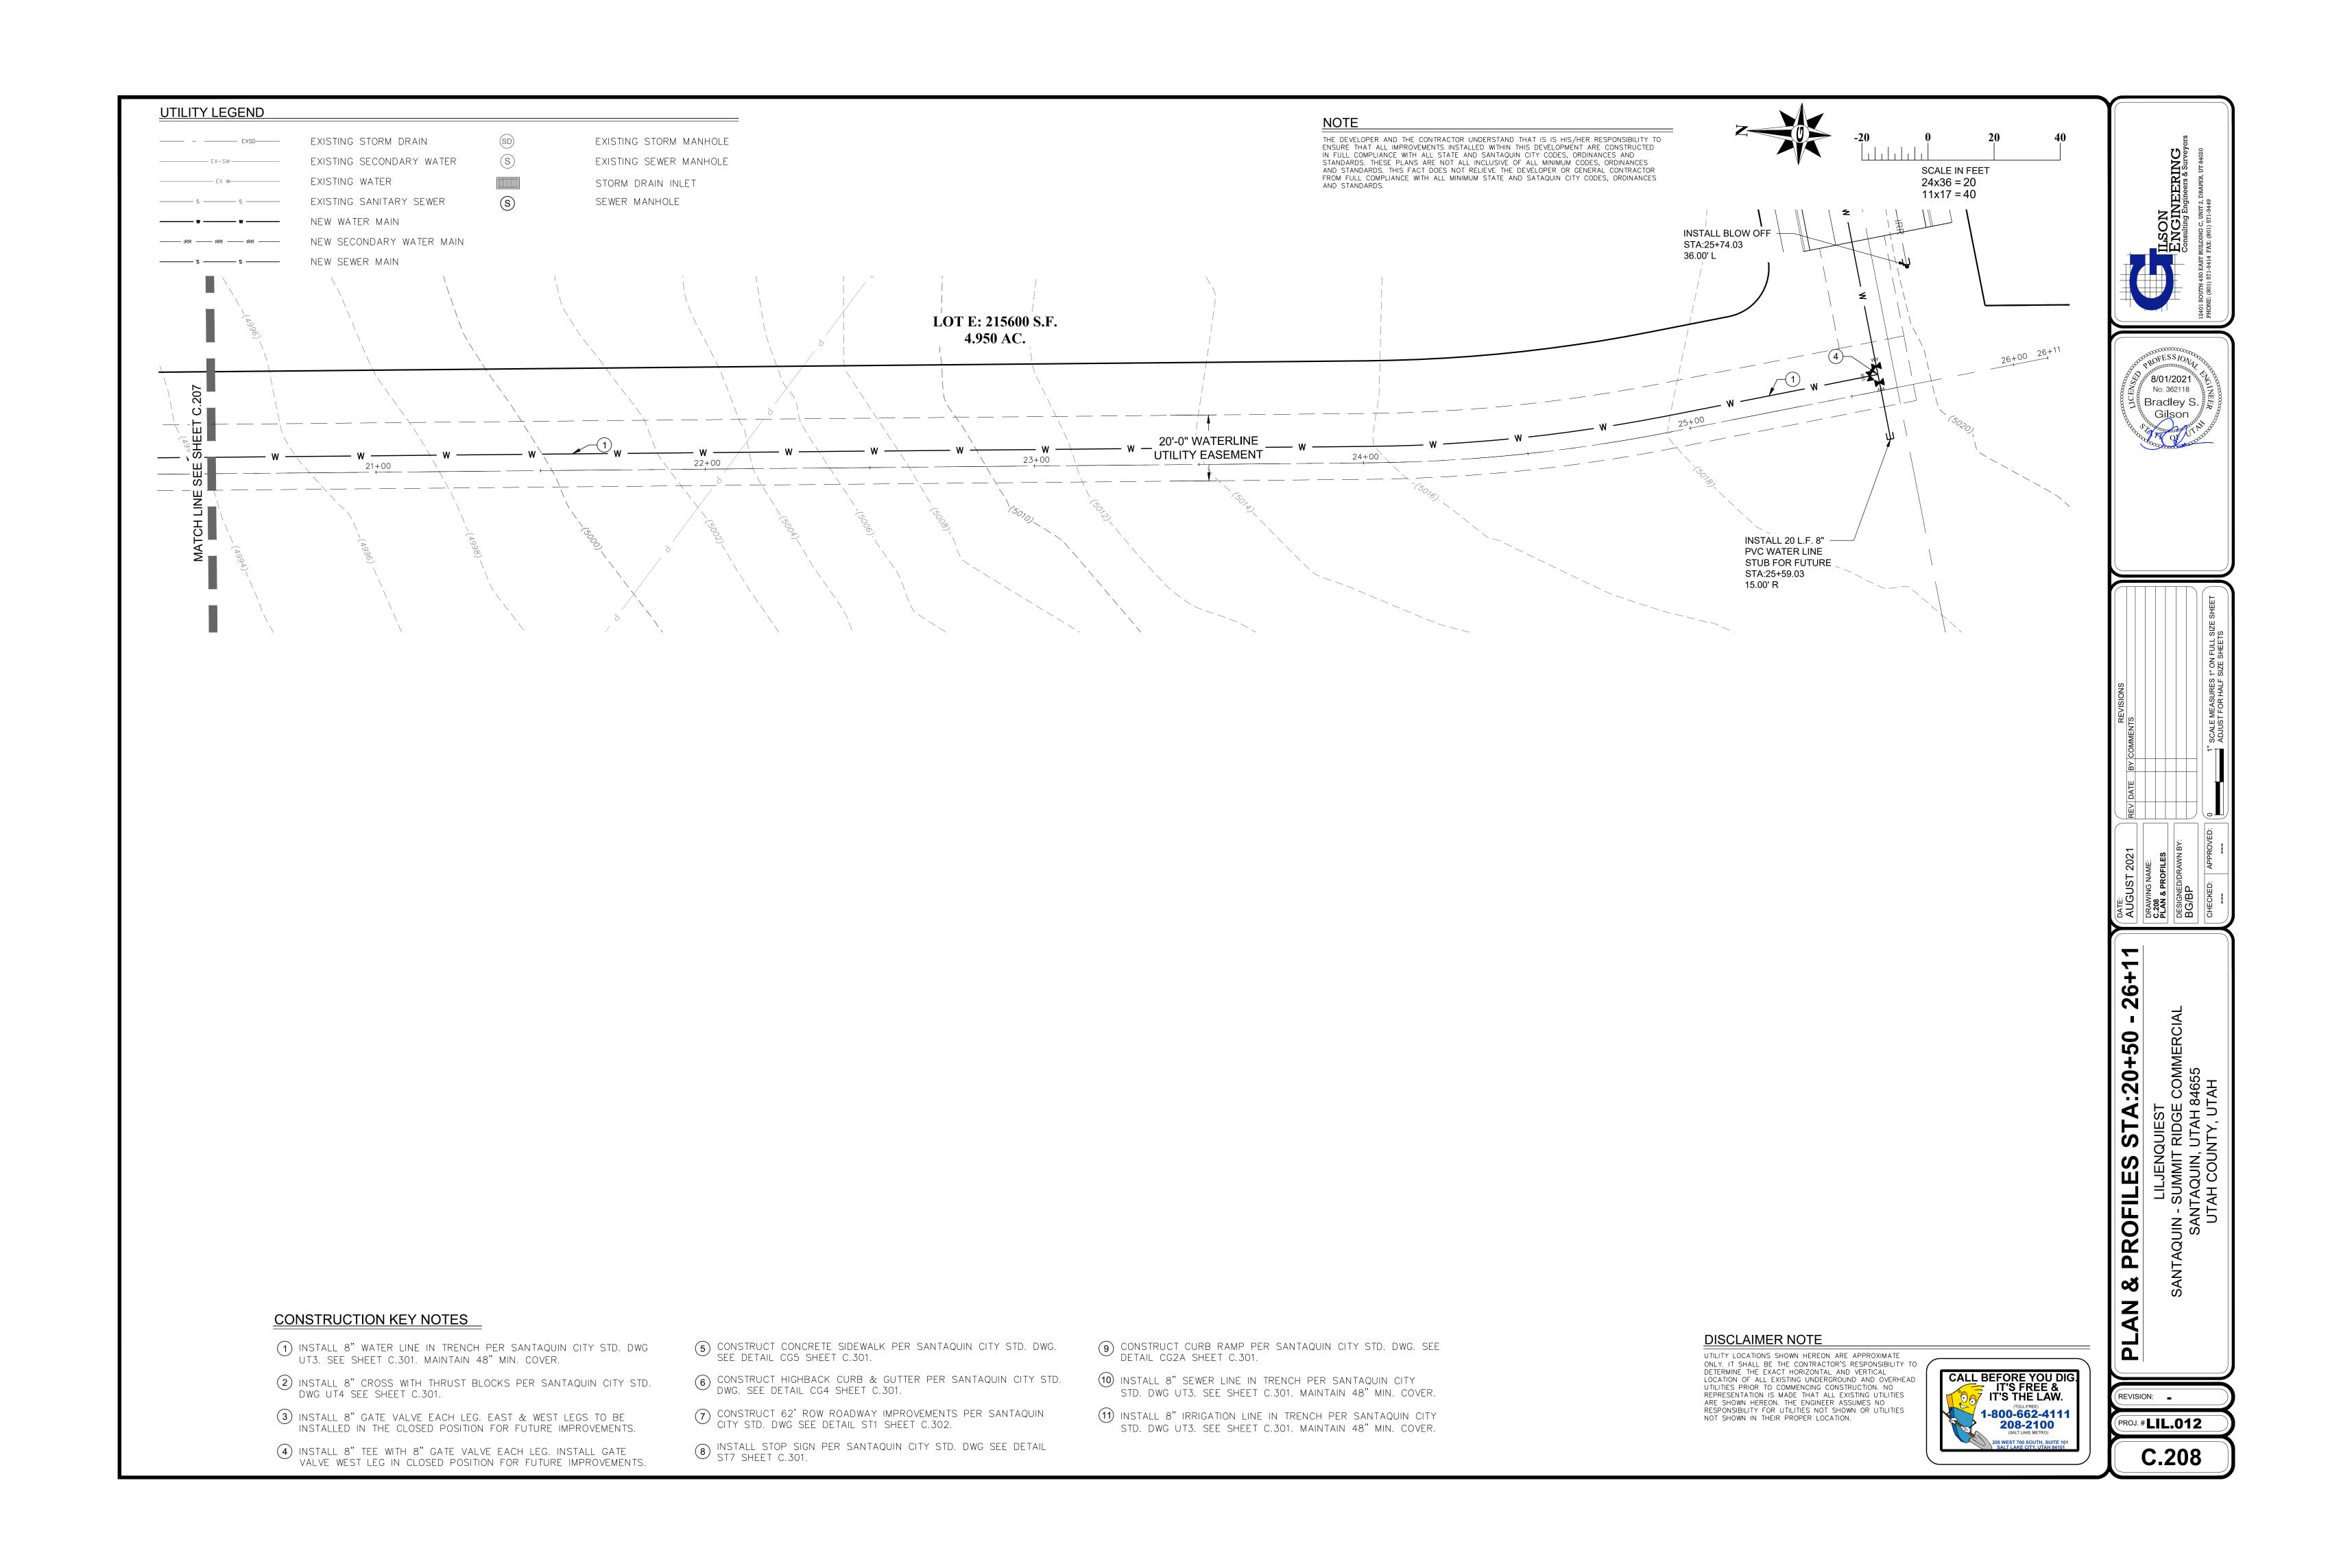

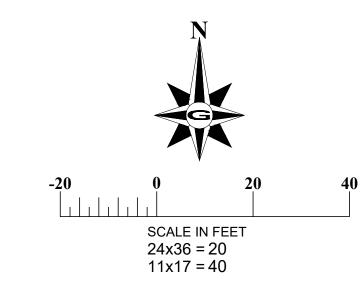

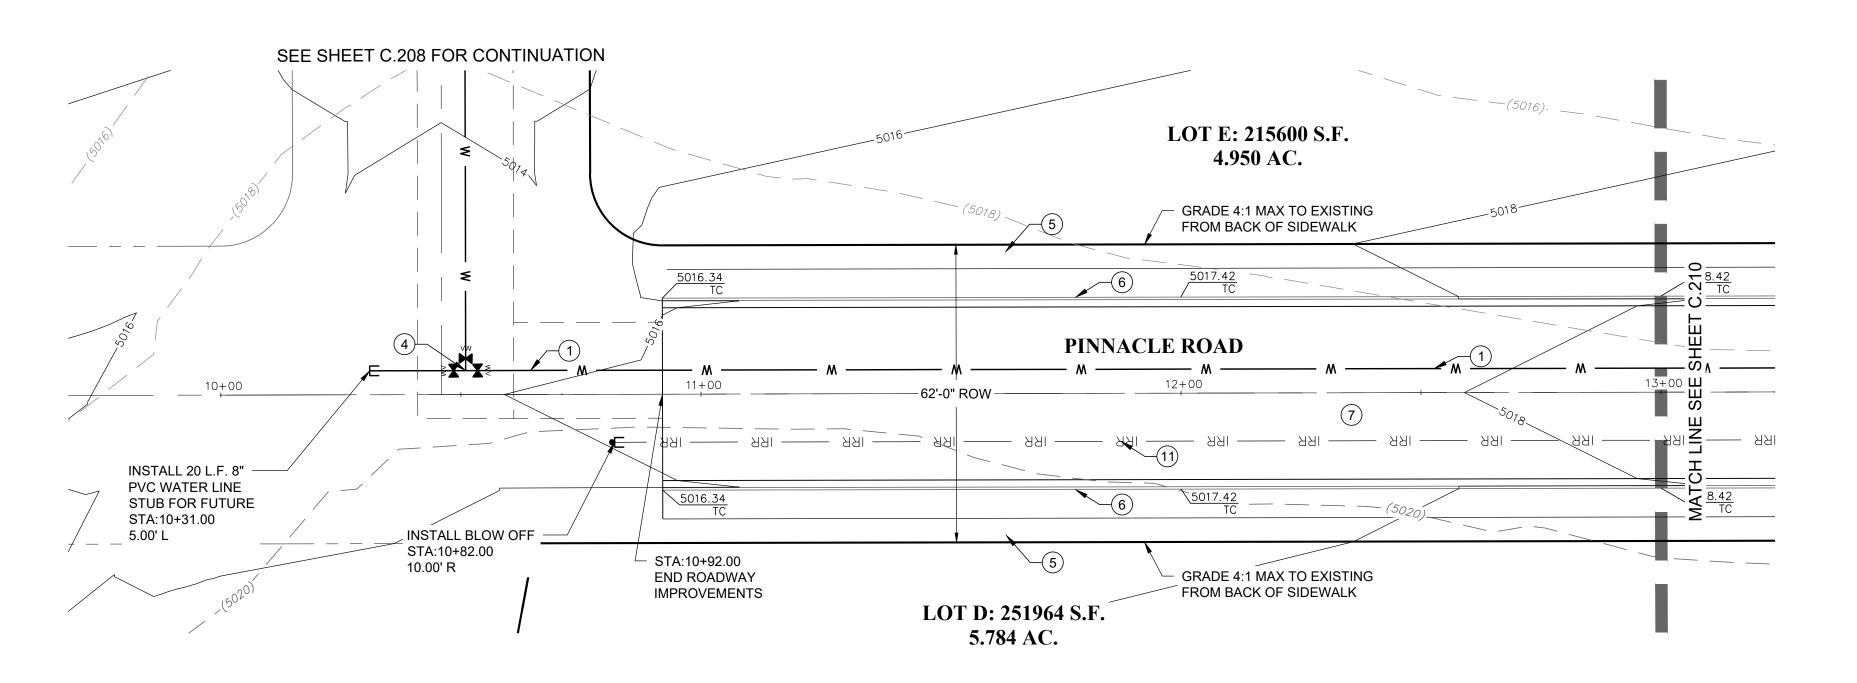



O I I LLOLIND	
EXSD	EXISTING STORM DRAIN
EX-SW	EXISTING SECONDARY WATER
EX W	EXISTING WATER
s ——— s ———	EXISTING SANITARY SEWER
w w	NEW WATER MAIN
IRR IRR	NEW SECONDARY WATER MAIN
s ——— s ———	NEW SEWER MAIN
SD	EXISTING STORM MANHOLE
S	EXISTING SEWER MANHOLE
	STORM DRAIN INLET
S	SEWER MANHOLE

<u>Note</u>

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LAN & PROFILES STA:10+00 - 13

8/01/2021 No. 362118

Bradley S.

PROJ. # LIL.012


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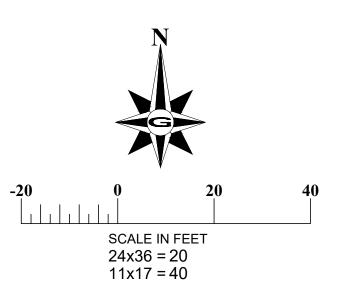
CONSTRUCTION KEY NOTES

- 1) INSTALL 8" WATER LINE IN TRENCH PER SANTAQUIN CITY STD. DWG UT3. SEE SHEET C.301. MAINTAIN 48" MIN. COVER.
- 2 INSTALL 8" CROSS WITH THRUST BLOCKS PER SANTAQUIN CITY STD. DWG UT4 SEE SHEET C.301.
- (3) INSTALL 8" GATE VALVE EACH LEG. EAST & WEST LEGS TO BE INSTALLED IN THE CLOSED POSITION FOR FUTURE IMPROVEMENTS.
- 4) INSTALL 8" TEE WITH 8" GATE VALVE EACH LEG. INSTALL GATE VALVE WEST LEG IN CLOSED POSITION FOR FUTURE IMPROVEMENTS.
- (5) CONSTRUCT CONCRETE SIDEWALK PER SANTAQUIN CITY STD. DWG. SEE DETAIL CG5 SHEET C.301.
- 6 CONSTRUCT HIGHBACK CURB & GUTTER PER SANTAQUIN CITY STD. DWG. SEE DETAIL CG4 SHEET C.301.
- 7 CONSTRUCT 62' ROW ROADWAY IMPROVEMENTS PER SANTAQUIN CITY STD. DWG SEE DETAIL ST1 SHEET C.302.

8 INSTALL STOP SIGN PER SANTAQUIN CITY STD. DWG SEE DETAIL ST7 SHEET C.301.


- 9 CONSTRUCT CURB RAMP PER SANTAQUIN CITY STD. DWG. SEE DETAIL CG2A SHEET C.301.
- (10) INSTALL 8" SEWER LINE IN TRENCH PER SANTAQUIN CITY STD. DWG UT3. SEE SHEET C.301. MAINTAIN 48" MIN. COVER.
- 11) INSTALL 8" IRRIGATION LINE IN TRENCH PER SANTAQUIN CITY STD. DWG UT3. SEE SHEET C.301. MAINTAIN 48" MIN. COVER.



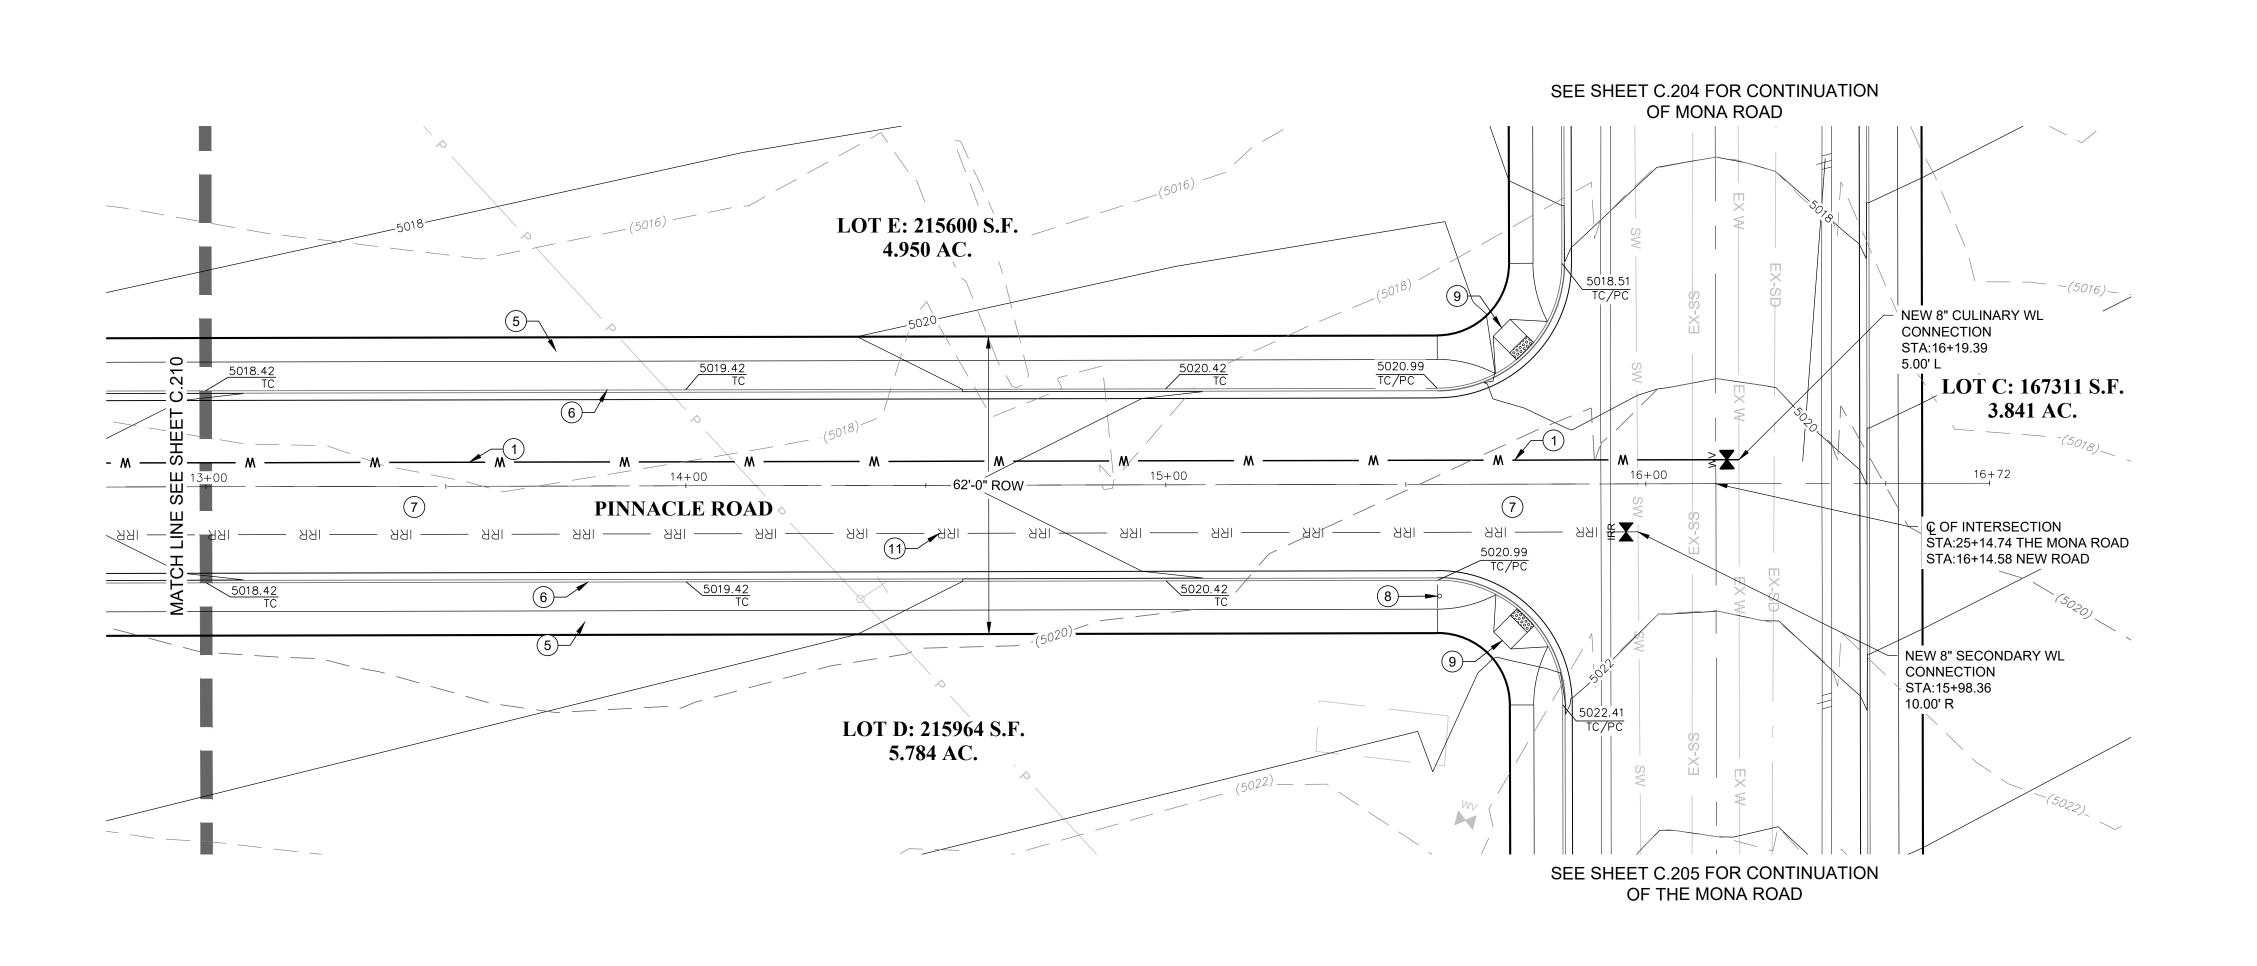





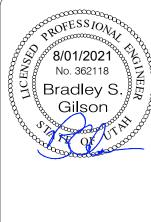

STA:13+00

PROFILES

UTILITY LEGEND

EXSD	EXISTING STORM DRAIN
EX-SW	EXISTING SECONDARY WATER
	EXISTING WATER
ss	EXISTING SANITARY SEWER
w w	NEW WATER MAIN
	NEW SECONDARY WATER MAIN
ss	NEW SEWER MAIN
SD	EXISTING STORM MANHOLE
S	EXISTING SEWER MANHOLE
	STORM DRAIN INLET

STORM DRAIN INLET SEWER MANHOLE

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CALL BEFORE YOU DIG.
IT'S FREE &
IT'S THE LAW.

REVISION: PROJ. #LIL.012 C.210