

MEMORANDUM



To: Planning Commission

From: Camille Moffat, Planner I

Date: January 6, 2023

RE: **Ridley's Phase 3 Commercial Subdivision Concept Review**

Zone: C-1
Size: 3.30
Lots: 2

The proposed Ridley's Phase 3 Subdivision is located at approximately 500 East and Main Street. The proposed commercial subdivision is in the C-1 zone and consists of 2 lots on approximately 3.30 acres. There are no minimum or maximum frontage or lot size requirements in the C-1 land use regulations.


This is a commercial subdivision concept review and this review is for the Planning Commission to give feedback to the developer. The review of the concept plan shall not constitute an approval of any kind.

Subdivisions with three lots or less have an expedited review process. After the concept review, the developer will need to submit preliminary/final subdivision plans. The preliminary/final plans will be reviewed by the Development Review Committee (DRC) and a recommendation will be forwarded to the Planning Commission. The Planning Commission will be the land use authority and will approve the subdivision.

Attachments:

1. Zoning and Location Map
2. Concept Plan

Attachment #1: Zoning and Location Map

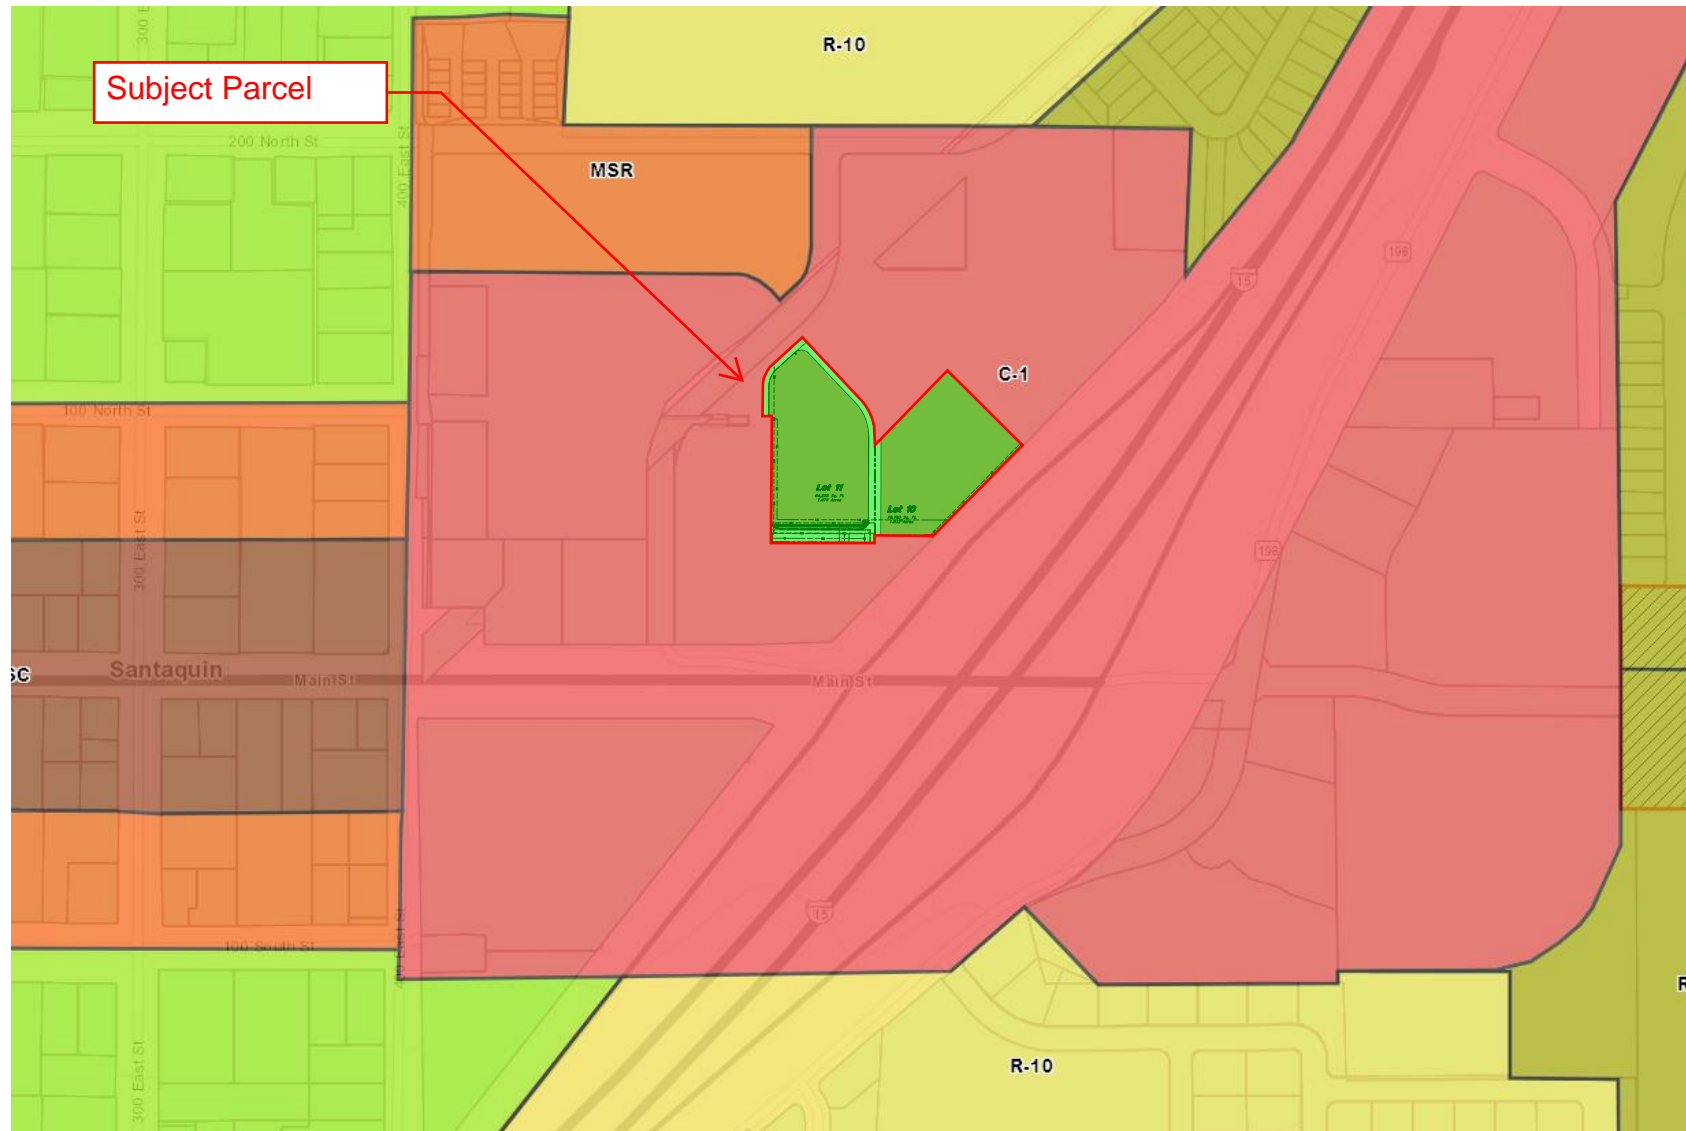

Ridley's Subdivision Phase 3

500 East Main Street
Santaquin, UT, 84655



Vicinity Map
Not to Scale

Civil Sheet Index

C0.0	Cover Sheet
C0.1	Subdivision Plat
C0.1	Demolition Plan
C1.0	Phasing Plan
C1.1	Site Plan
C2.1	Grading Plan
C3.0	Overall Utility Plan
C3.1	Sewer Main Plan and Profile
C3.2	Water Main Plan and Profile
C4.1	Details
C5.1	Erosion Control Plan

Santaquin City Notes

It is important for the developer and the general contractor to understand that it is his/her responsibility to ensure that all improvements installed within this development are constructed in full compliance with all state and Santaquin City codes, ordinances and standards. This fact does not relieve the developer or general contractor from full compliance with all minimum state and Santaquin City standards.

Santaquin City Note to Developers & General Contractors
All recommendations made in the provided geotechnical report/study shall be followed explicitly during construction of building and site improvements.

Abbreviations

BCR	Begin Curb Return	PT	Point of Tangency
BOL	Bollard	PVC	Polyvinyl Chloride
BRW	Finish Grade - Bottom of Retaining Wall	PVI	Point of Vertical Intersection
CATV	Cable Television Box	RCP	Reinforced Concrete Pipe
CB	Catch Basin	RD	Roof Drain
CMP	Corrugated Metal Pipe	SB	Signal Box
COB	Cleanout Box	SD	Storm Drain
COTG	Cleanout to Grade	SDMH	Storm Drain Manhole
EA	Edge of Asphalt	SMH	Sewer Manhole
EB	Electrical Box	SP	Signal Pole
EC	End of Curve	SS	Sanitary Sewer
ECR	End Curb Return	SVZ	Sight Visibility Zone
GB	Grade Break	SW	Secondary Water
GM	Gas Meter	TA	Top of Asphalt
HB	Hose Bib	TB	Telephone Box
HP	High Point	TBC	Top Back of Curb
I	Irrigation Line	TG	Top of Grate
ICB	Irrigation Control Box	TMH	Telephone Manhole
Lip	Lip of Gutter	TP	Top of Concrete
LP	Light Pole	TRW	Finish Grade - Top of Retaining Wall
MH	Manhole	TW	Top of Walk
Mon	Monument	VC	Vertical Curve
PC	Point of Curvature	VPC	Vertical Point of Curve
PCC	Point of Compound Curvature	VPT	Vertical Point of Tangency
PI	Point of Intersection	WL	Waterline
PM	Power Meter	WP	Working Point
PP	Power Pole	WV	Water Valve

Legend


Proposed Curb & Gutter	Existing Improvements	Existing Asphalt
Proposed Open Face C & G	Existing Concrete	Existing Concrete
Proposed Asphalt	Existing Inlet Box	Existing Catch Basin
Proposed Concrete	Existing Manhole	Existing Fire Hydrant
Proposed Truncated Domes	Existing Water Valve	Existing Overhead Power Line
Proposed Inlet Box	Existing Water	Existing Sewer
Proposed Catch Basin	Existing Secondary Water	Existing Storm Drain
Proposed Manhole	Existing Gas	Existing Power
Proposed Transformer	Existing Telephone	Existing Telephone
Proposed Meter Box	Existing Fence	Flowline
Proposed Water Meter	Existing Storm Drain	Centerline
Proposed Comba Box	Existing Gas	Existing Contour
Proposed Fire Hydrant	Existing Power	Existing Spot
Proposed Water Valve	Existing Telephone	Existing Light Pole
Proposed Water Line	Existing Fence	Existing Street Light
Proposed Sanitary Sewer	Flowline	Existing Building
Proposed Storm Drain	Centerline	Existing Telephone Box
Proposed Conduit Line	Existing Contour	Existing Power Meter
Proposed Power Line	Existing Spot	Existing Electrical Box
Proposed Gas Line	Existing Light Pole	Existing Electrical Cabinet
Proposed Fire Line	Existing Street Light	Existing Gas Meter
Proposed Secondary Water Line	Existing Building	Existing Water Meter
Proposed Roof Drain	Existing Telephone Box	Existing Iris Control Box
Proposed Fence	Existing Power Meter	Existing Bollard
Ridge line	Existing Electrical Box	Existing Hose Bib
Grade Break	Existing Electrical Cabinet	Working Point
Proposed Contour	Existing Gas Meter	Existing Deciduous Tree
Direction of Drainage	Existing Water Meter	Existing Coniferous Tree
Proposed Spot	Existing Iris Control Box	Detail Number
ADA Accessible Route	Existing Bollard	Sheet Number
Property Line	Existing Hose Bib	
Sawcut Line	Working Point	
Proposed Light Pole	Existing Deciduous Tree	
Proposed Street Light	Existing Coniferous Tree	
Proposed Building	Detail Number	
Existing Power Pole	Sheet Number	
Existing Power Pole w/ Guy		
Existing Utility Marker		
Existing Post		

Property Owner

CJM Limited
621 Washington Street South
Twin Falls, Idaho 83301-5519

ANDERSON WAHLEN & ASSOCIATES
2010 North Redwood Road, Salt Lake City, Utah 84116
(801) 521-8529 - AWahlen@engineering.net

Cover Sheet
Ridley's Subdivision Phase 3
500 East and Main Street
Santaquin, Utah County, Utah

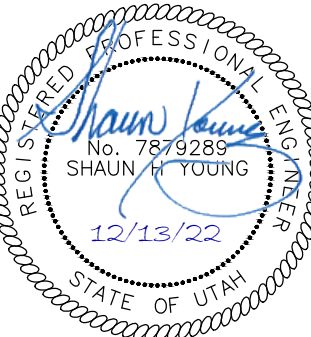

13 Dec, 2022


SHEET NO.
C0.0

Ridley's Subdivision, Plat C


A part of Parcel A, Ridley's Subdivision, of the Northeast Quarter of Section 1, Township 10 South, Range 1 East, Salt Lake Base and Meridian, U.S. Survey, City of Santaquin, Utah County, Utah
2023

Scale: 1" = 40'

40' 0 40' 80'

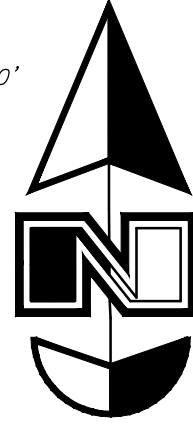

2654.61'
Northeast Corner Section 1,
T10S, R1E, SLB&M, U.S. Survey
(found brass cap monument)

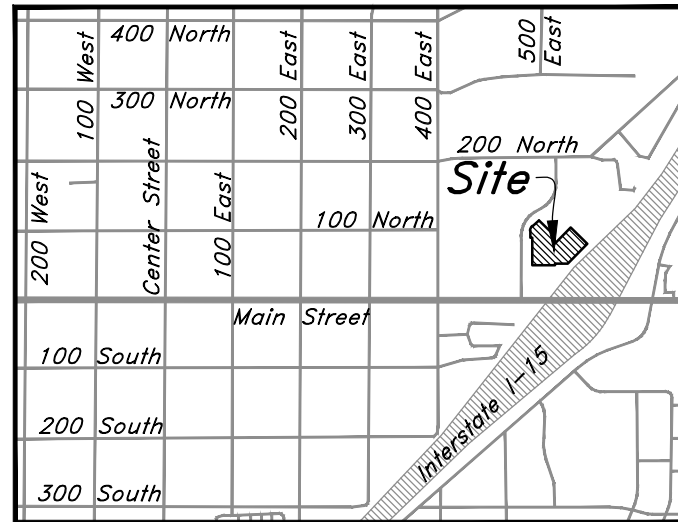

Vicinity Map (Not to Scale)

Legend

- Control Line
- Property Line
- Easement Line
- Adjoiner Line
- Section Corner
- Set 5/8 rebar with plastic cap or nail with brass tag stamped AWA
- P&UDE
- Public Utility and Drainage Easement in favor of Santaquin City

Note

This property is located in an agricultural community in which normal agricultural uses and activities are common and part of the identity of Santaquin City. It can be anticipated that such agricultural uses and activities may now or in the future be conducted near this property. Property Owners need to understand and acknowledge that they may experience annoyance or inconvenience which may result from such normal agricultural uses and activities. Additionally, property Owners must refrain from trespassing on private property which can negatively impact the integrity of agricultural lands and businesses.

Narrative

This Subdivision was requested by CJM Limited Liability Partnership in order to create 2 Lots.

A line between monuments found for North Quarter Corner and the Northeast Corner of Section 1 was assigned the UCS bearing of North 89°42'20" East as the Basis of Bearings.

This subdivision retraces and honors the underlying 2020 Ridleys Subdivision

Property corners will be set upon completion of site construction.

Surveyor's Certificate

I, Ken B. Hawkes, do hereby certify that I am a Licensed Professional Land Surveyor in the State of Utah and that I hold Certificate No. 8707113 in accordance with Title 58, Chapter 22, of the Professional Engineers and Land Surveyors Licensing Act; I further certify for, and on behalf of Anderson Wahlen & Associates that by authority of the owners I have completed a survey of the property described on this Subdivision Plat in accordance with Section 17-23-17 and have verified all measurements; that the reference monuments shown on this plat are located and are sufficient to retrace or reestablish this plat; and that the information shown herein is sufficient to accurately establish the lateral boundaries of the herein described tract of real property; hereafter known as

Ridley's Subdivision, Plat C

Description

A part of Parcel A, Ridley's Subdivision, recorded as Entry No. 111268:2020 and as Map No. 17189 in the Official Records of Utah County, being a part of the Northeast Quarter of Section 1, Township 10 South, Range 1 East, Salt Lake Base and Meridian, U.S. Survey, in Santaquin, Utah County, Utah:

Beginning at the Southeast corner of Lot 8 Ridley's Subdivision, Plat B, recorded as Entry No. 53861:2022 and as Map No. 18320 in the Official Records of Utah County, located 2,338.25 feet South 0°30'50" East along the Quarter Section Line; and 789.90 feet South 89°49'57" East from a Brass Cap Monument found marking the North Quarter Corner of said Section 1; and running thence North 0°10'03" East 261.96 feet along the Easterly line of said Lot 8 to the Northeast corner thereof; thence North 89°49'57" West 19.12 feet along the Northerly line of said Lot 8; thence North 0°10'03" East 61.71 feet to a point of curvature; thence Northeasterly along the arc of a 62.00 foot radius curve to the right a distance of 51.57 feet (Central Angle equals 47°39'17" and Long Chord bears North 23°59'42" East 50.09 feet) to a point of tangency; thence North 47°49'20" East 82.64 feet; thence South 45°25'49" East 166.02 feet to a point of curvature; thence Southeasterly along the arc of a 115.00 foot radius curve to the right a distance of 91.52 feet (Central Angle equals 45°35'52" and Long Chord bears South 22°37'53" East 89.12 feet) to a point of tangency; thence South 0°10'03" West 21.34 feet; thence North 44°34'11" East 213.10 feet; thence South 45°25'49" East 220.58 feet to the Northwestern line of Interstate Highway I-15; thence South 44°34'11" West 263.70 feet along said Northwestern line to the Northeasterly corner of Lot 9 of said Ridley's Subdivision Plat B; thence along the Northerly line of said Plat B the following three courses; North 89°49'57" West 122.19 feet; South 0°10'03" West 15.00 feet; and North 89°49'57" West 215.34 feet to said Southeast corner of Lot 8 and the point of beginning.

Contains 144,008 sq. ft.
Or 3.306 acres
2 Lots

Date:

Ken B. Hawkes
Utah PLS No. 8707113

Owner's Dedication and Consent to Record

Know all men by these presents that I, the undersigned owner of the hereon described tract of land, hereby set apart and subdivide the same into Lots as shown on this plat and name said plat

Ridley's Subdivision, Plat C

and do hereby dedicate, grant and convey to the City of Santaquin all those parts or portions of said tract of land designated as streets, the same to be used as public thoroughfares forever, and those certain public utility easements as shown hereon to be used for the installation, maintenance and operation of Public Utility service lines.

In witness whereby I have hereunto set my hand
This ____ Day of _____ AD, 20____.

CJM Limited Liability Limited Partnership

by: Donald Mark Ridley
its: Authorized Partner

Approval By Legislative Body

The City Council of the City of Santaquin, County of Utah, approves this subdivision subject to the conditions and restrictions stated hereon, and hereby accepts the Dedication of all streets, easements, and other parcels of land intended for the public purpose of the perpetual use of the public.


This _____, day of _____, A.D. 20____.

City Mayor _____ Attest _____
City Recorder (See Seal Below) _____

Ridley's Subdivision, Plat C

A part Parcel A, Ridley's Subdivision, located in the Northeast Quarter of Section 1, Township 10 South, Range 1 East, Salt Lake Base and Meridian, U.S. Survey, City of Santaquin, Utah County, Utah

Surveyors Seal

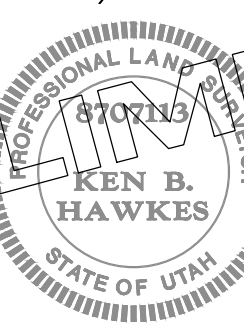

City Engineer Seal

Clerk-Recorder Seal

Rocky Mountain Power

- Pursuant to Utah Code Ann. 54-3-27 this plat conveys to the Owner(s) or operators of utility facilities a public utility easement along with all the rights and duties described therein.
- Pursuant to Utah Code Ann. 17-27A-603(4)(c)(ii) Rocky Mountain Power accepts delivery of the PUE as described in this plat and approves this plat solely for the purpose of confirming that the plat contains Public Utility Easements and approximates the location of the Public Utility Easements, but does not warrant their precise location. Rocky Mountain Power may require other easements in order to serve this development. This approval does not effect any right that Rocky Mountain Power has under:

- A recorded easement or Right-of-Way
- The law applicable to prescriptive rights
- Title 54, Chapter 8a, damage to underground utility facilities or
- Any other provision of law

Approved this ____ day
of _____, 20____.

Rocky Mountain Power Company

By: _____

Title: _____

Dominion Energy

a Questar Corporation

Questar Gas Company, aka Dominion Energy Utah, hereby approves this plat solely for the purpose of confirming that the plat contains public utility easements. Dominion Energy Utah may require additional easements in order to serve this development. This approval does not constitute abrogation or waiver of any other existing rights, obligations or liabilities including prescriptive rights and other rights, obligations of liabilities provided by law or equity. This approval does not constitute acceptance, approval or acknowledgement of any terms contained in the plat, including those set forth in the owner Dedication or in the Notes, and does not constitute a guarantee of particular terms or conditions of natural gas service. For further information please contact Dominion Energy Utah's Right-of-Way Department at 1-800-366-8532.

Approved this ____ Day of _____

A.D. 20____

By: _____

Title: _____
DOMINION ENERGY, a Questar Corporation

LUMEN

Approved by Lumen this
____ Day of _____ A.D. 20____

Lumen

Acknowledgment

State of _____
County of _____

On this ____ day of _____, 20____, personally appeared before me, Donald Mark Ridley the signer of the foregoing instrument, who duly acknowledged to me that he is an Authorized Partner of CJM Limited Liability Limited Partnership, and is authorized to execute the foregoing Dedication in its behalf and that he executed it in such capacity.

Notary Public Full Name: _____

Commission Number: _____

My Commission Expires: _____

A Notary Public Commissioned in Idaho

A Notary Public



ANDERSON WAHLEN & ASSOCIATES

2010 North Redwood Road, Salt Lake City, Utah 84116
801 521-8529 - AWAengineering.net

Ridley's Subdivision

Parcel A

Entry No. 11268: 2020

CJM Limited Liability Limited Partnership

51-649-0008

Lot 10

64,225 sq. ft.
or 1.474 acre

Lot 11

79,783 sq. ft.
or 1.832 acre

Ridley's Subdivision, Plat B

Lot 7
CJM Limited Liability Limited Partnership
51-717-0007

Lot 9
CJM Limited Liability Limited Partnership
51-717-0009

North Quarter Corner Section 1,
T10S, R1E, SLB&M, U.S. Survey
(found brass cap monument)

Street

East

(Public Street)

S 0°30'42" E 5300.15' Mon. to Mon.

S 0°30'42" E 5300.15' Mon. to Mon.

South Quarter Corner Section 1,
T10S, R1E, SLB&M, U.S. Survey
(found brass cap monument)

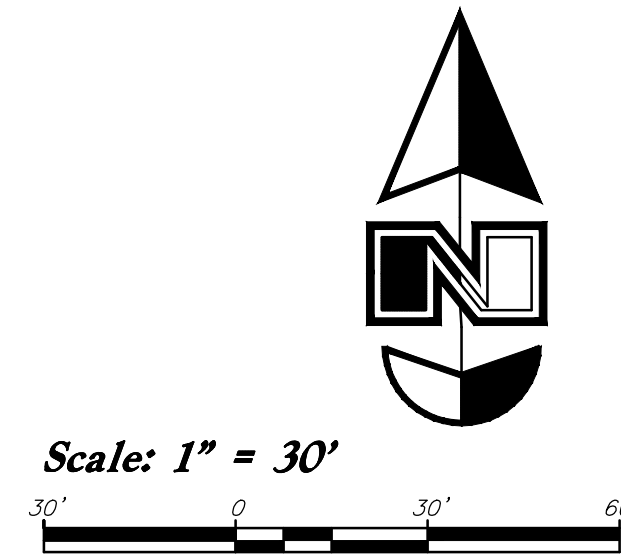

1. Demolition and site clearing for this contract are to include all areas shown within demolition limits or by note.
2. Refer to site improvement plans for more details on limits of removal.
3. All curbs, gutters, walks, slabs, walls, fences, flatwork, asphalt, waterlines and meters, gas lines, sewer lines, light poles, buried cables, storm drain piping and structures to be cleared from site unless otherwise shown.
4. All utilities, sewer, water, gas, telephone and electrical services to be disconnected and capped according to city, county and utility company requirements, unless otherwise shown.
5. Excavated areas to be backfilled with clean granular material compacted to 95% of maximum lab density as determined by ASTM D 1557-78. (Test results to be given to owner) Excavated areas should be project backfilled to the geotechnical report prepared for the project.
6. Clear and grub trees, shrubs, and vegetation within construction limits, disposal to be off-site except where noted otherwise.
7. DO NOT interrupt any services or disrupt the operation of any businesses shown outside the demolition limits.
8. Remove debris, rubbish, and other materials resulting from the demolition and site clearing operations from the site and dispose of in a legal manner.
9. The location and/or elevation of existing utilities as shown on these plans is based on records of the various utility companies and, where possible, measurements taken in the field. The information is not to be relied upon as being exact or complete. Contractor shall contact the appropriate having jurisdiction for field locations. Contractor shall be responsible for protection of in place and relocated utilities during construction.
10. Stockpiles shall be graded to maintain slopes not greater than 3 horizontal to 1 vertical. Provide erosion control as needed to prevent sediment transport to adjacent drainage ways.
11. Contractor shall be responsible for disposal of all waste material. Disposal shall be at an approved site for such material. Burning onsite is not permitted.
12. Contractor shall verify with city any street removal, curb cuts, and any restoration required for utility line removal.
13. Install traffic warning devices as needed in accordance with local standards.
14. Contractor shall obtain all permits necessary for demolition from City, County, State or Federal Agencies as required.
15. If Contractor observes evidence of hazardous materials or contaminated soil, he shall immediately contact the project engineer to provide notification and obtain direction before proceeding with disturbance of said materials or contaminated soil.
16. Limits of demolition/disturbed areas shown on the plans may not be at exact depiction. It is the contractor's responsibility to determine the means and methods of how the work will be completed. The contractor shall determine the area of construction impact. The contractor is responsible to restore all impacted areas and all restoration shall be part of the contract bid.

Know what's below.  **Call 811 before you dig.**


 **BLUE STAKES OF UTAH**
UTILITY NOTIFICATION CENTER, INC.
www.bluestakes.org
1-800-662-4111


[illegible]

Demolition Plan

Ridley's Subdivision Phase 3

*500 East and Main Street
Santaquin, Utah County, Utah*

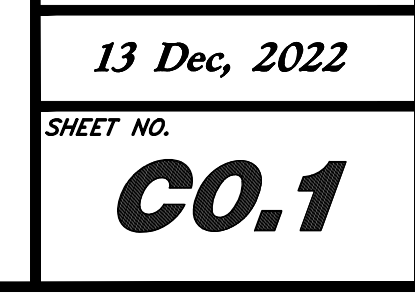

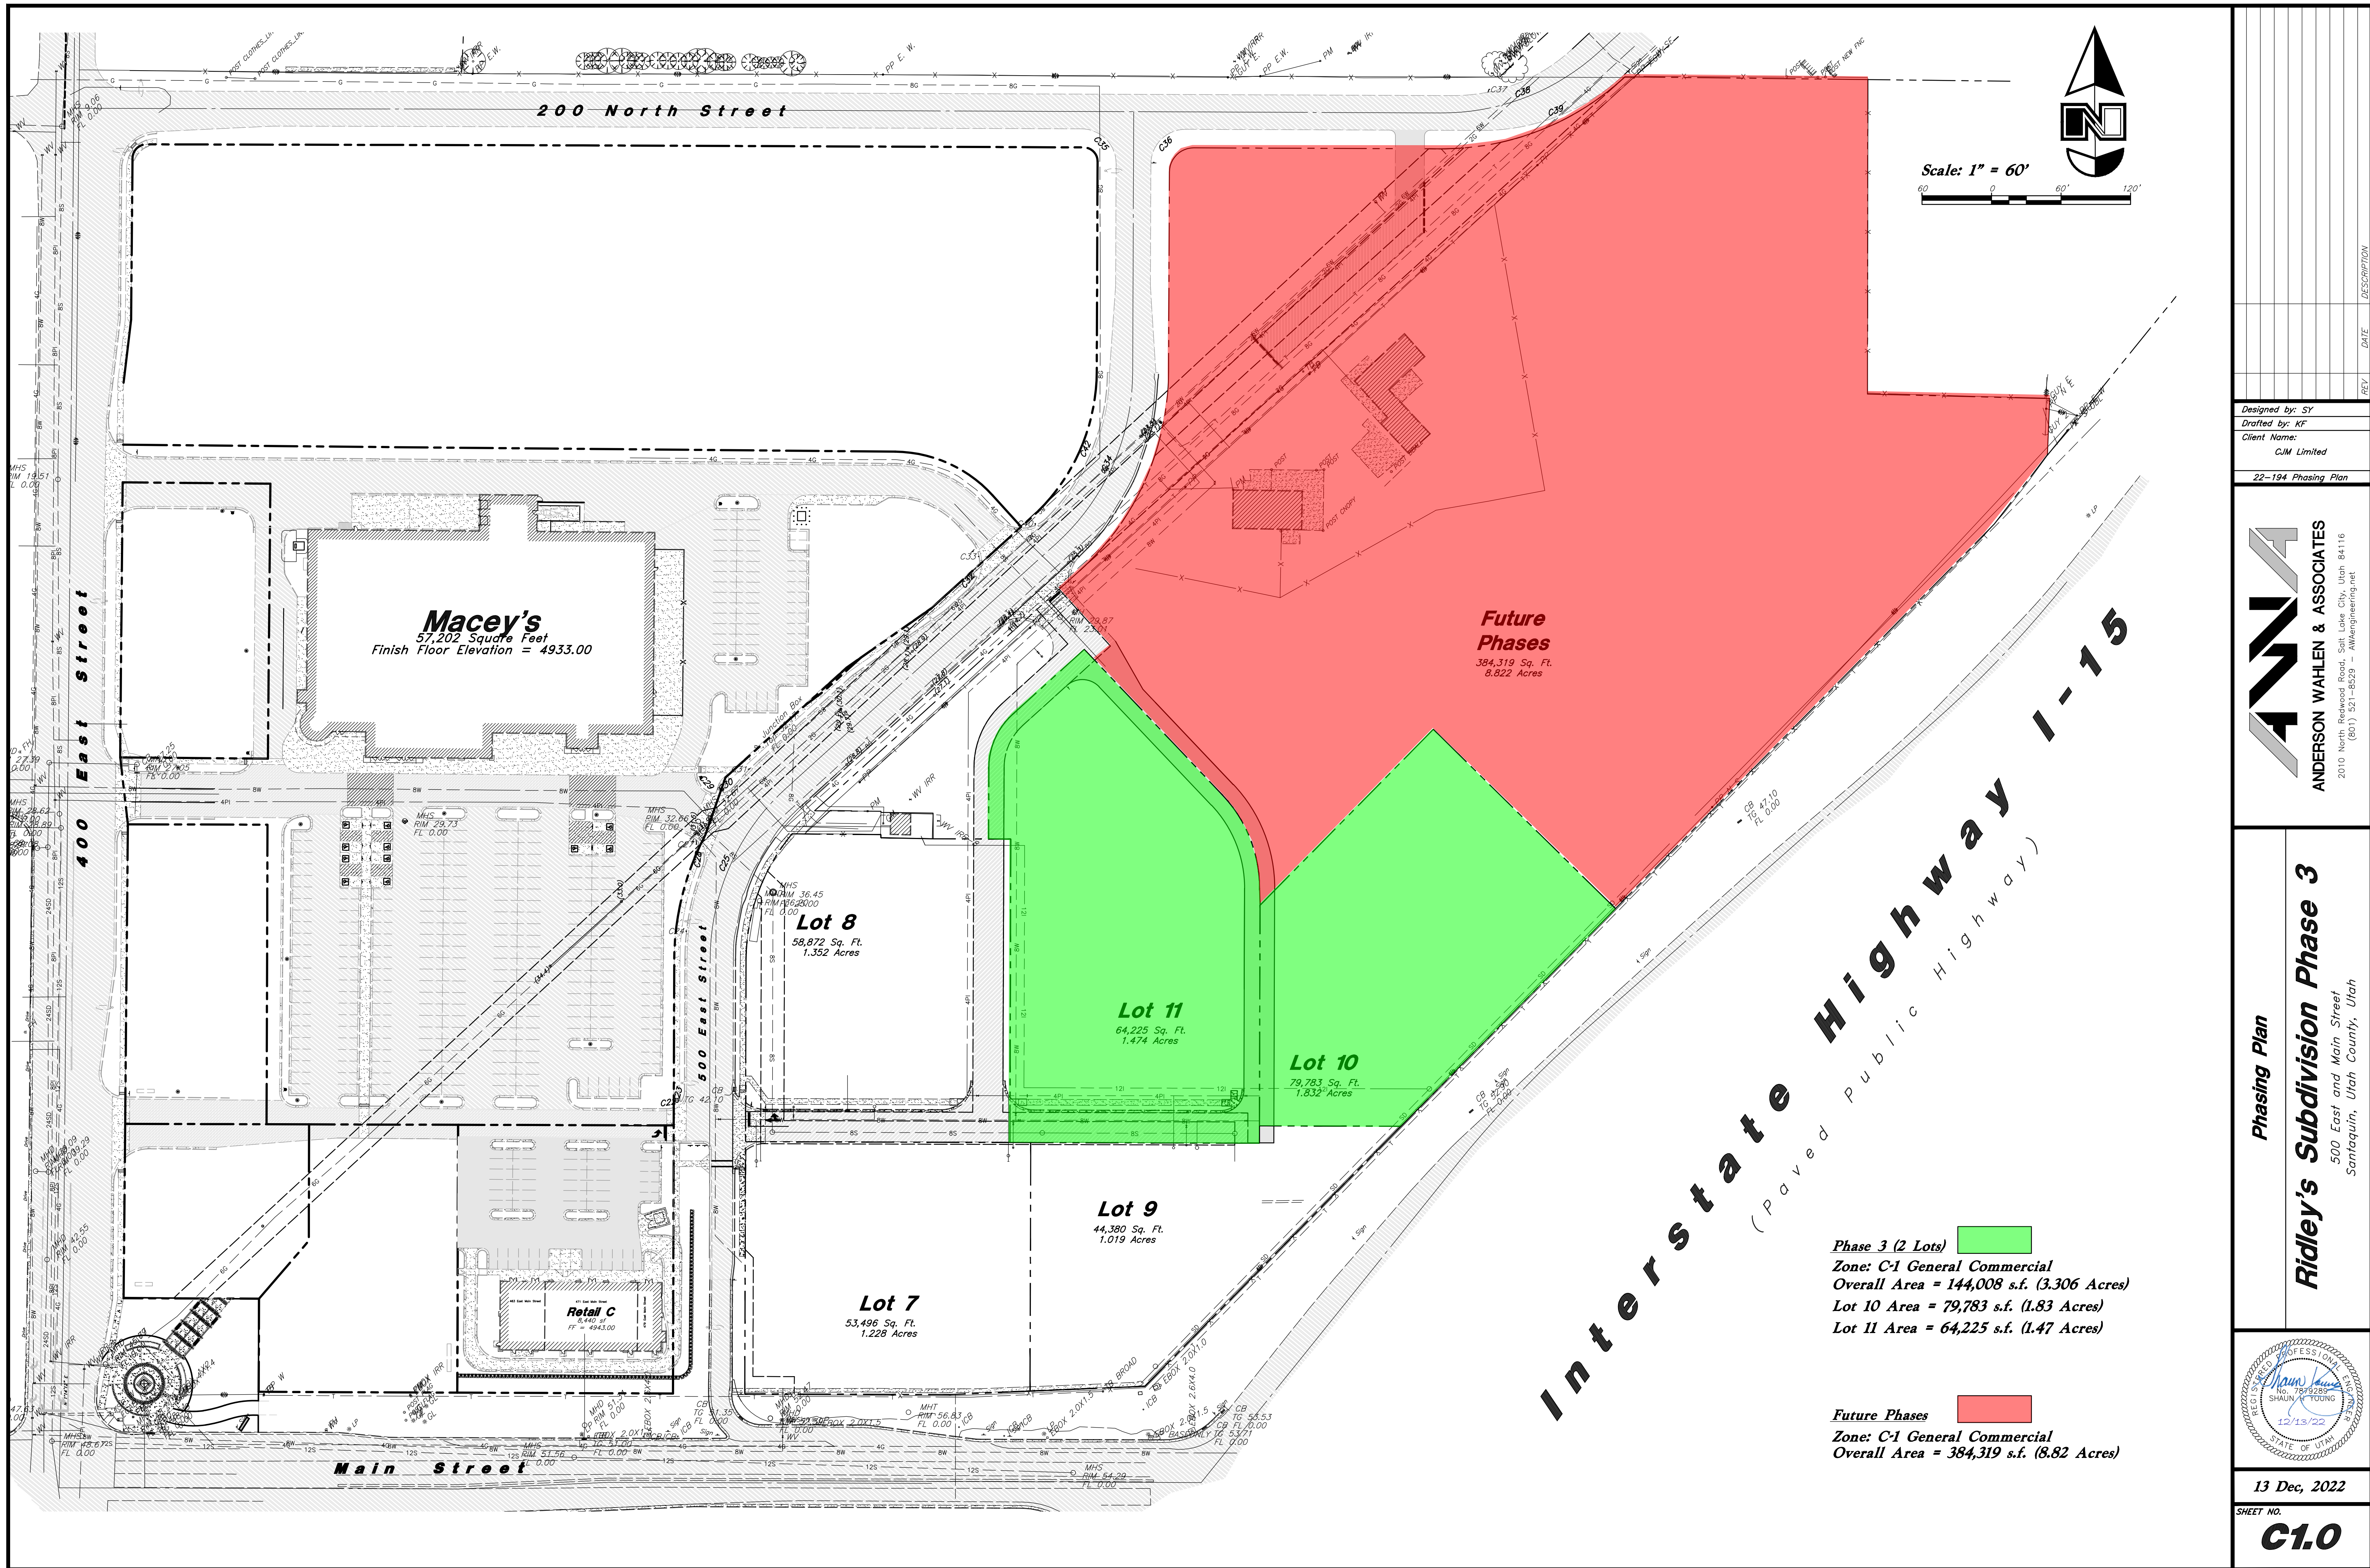

Designed by: SY
Drafted by: KF
Client Name:
CJM Limited


22-194 Phasing Plan


ANDERSON WAHLEN & ASSOCIATES
2010 North Redwood Road, Salt Lake City, Utah 84116
(801) 321-8529 - awhengineering.net

Phasing Plan
Ridley's Subdivision Phase 3
500 East and Main Street
Saratoga, Utah County, Utah

REGISTERED PROFESSIONAL ENGINEER
No. 7959888
SHAUN A. YOUNG
12/13/22
STATE OF UTAH

13 Dec, 2022
SHEET NO.
C1.0

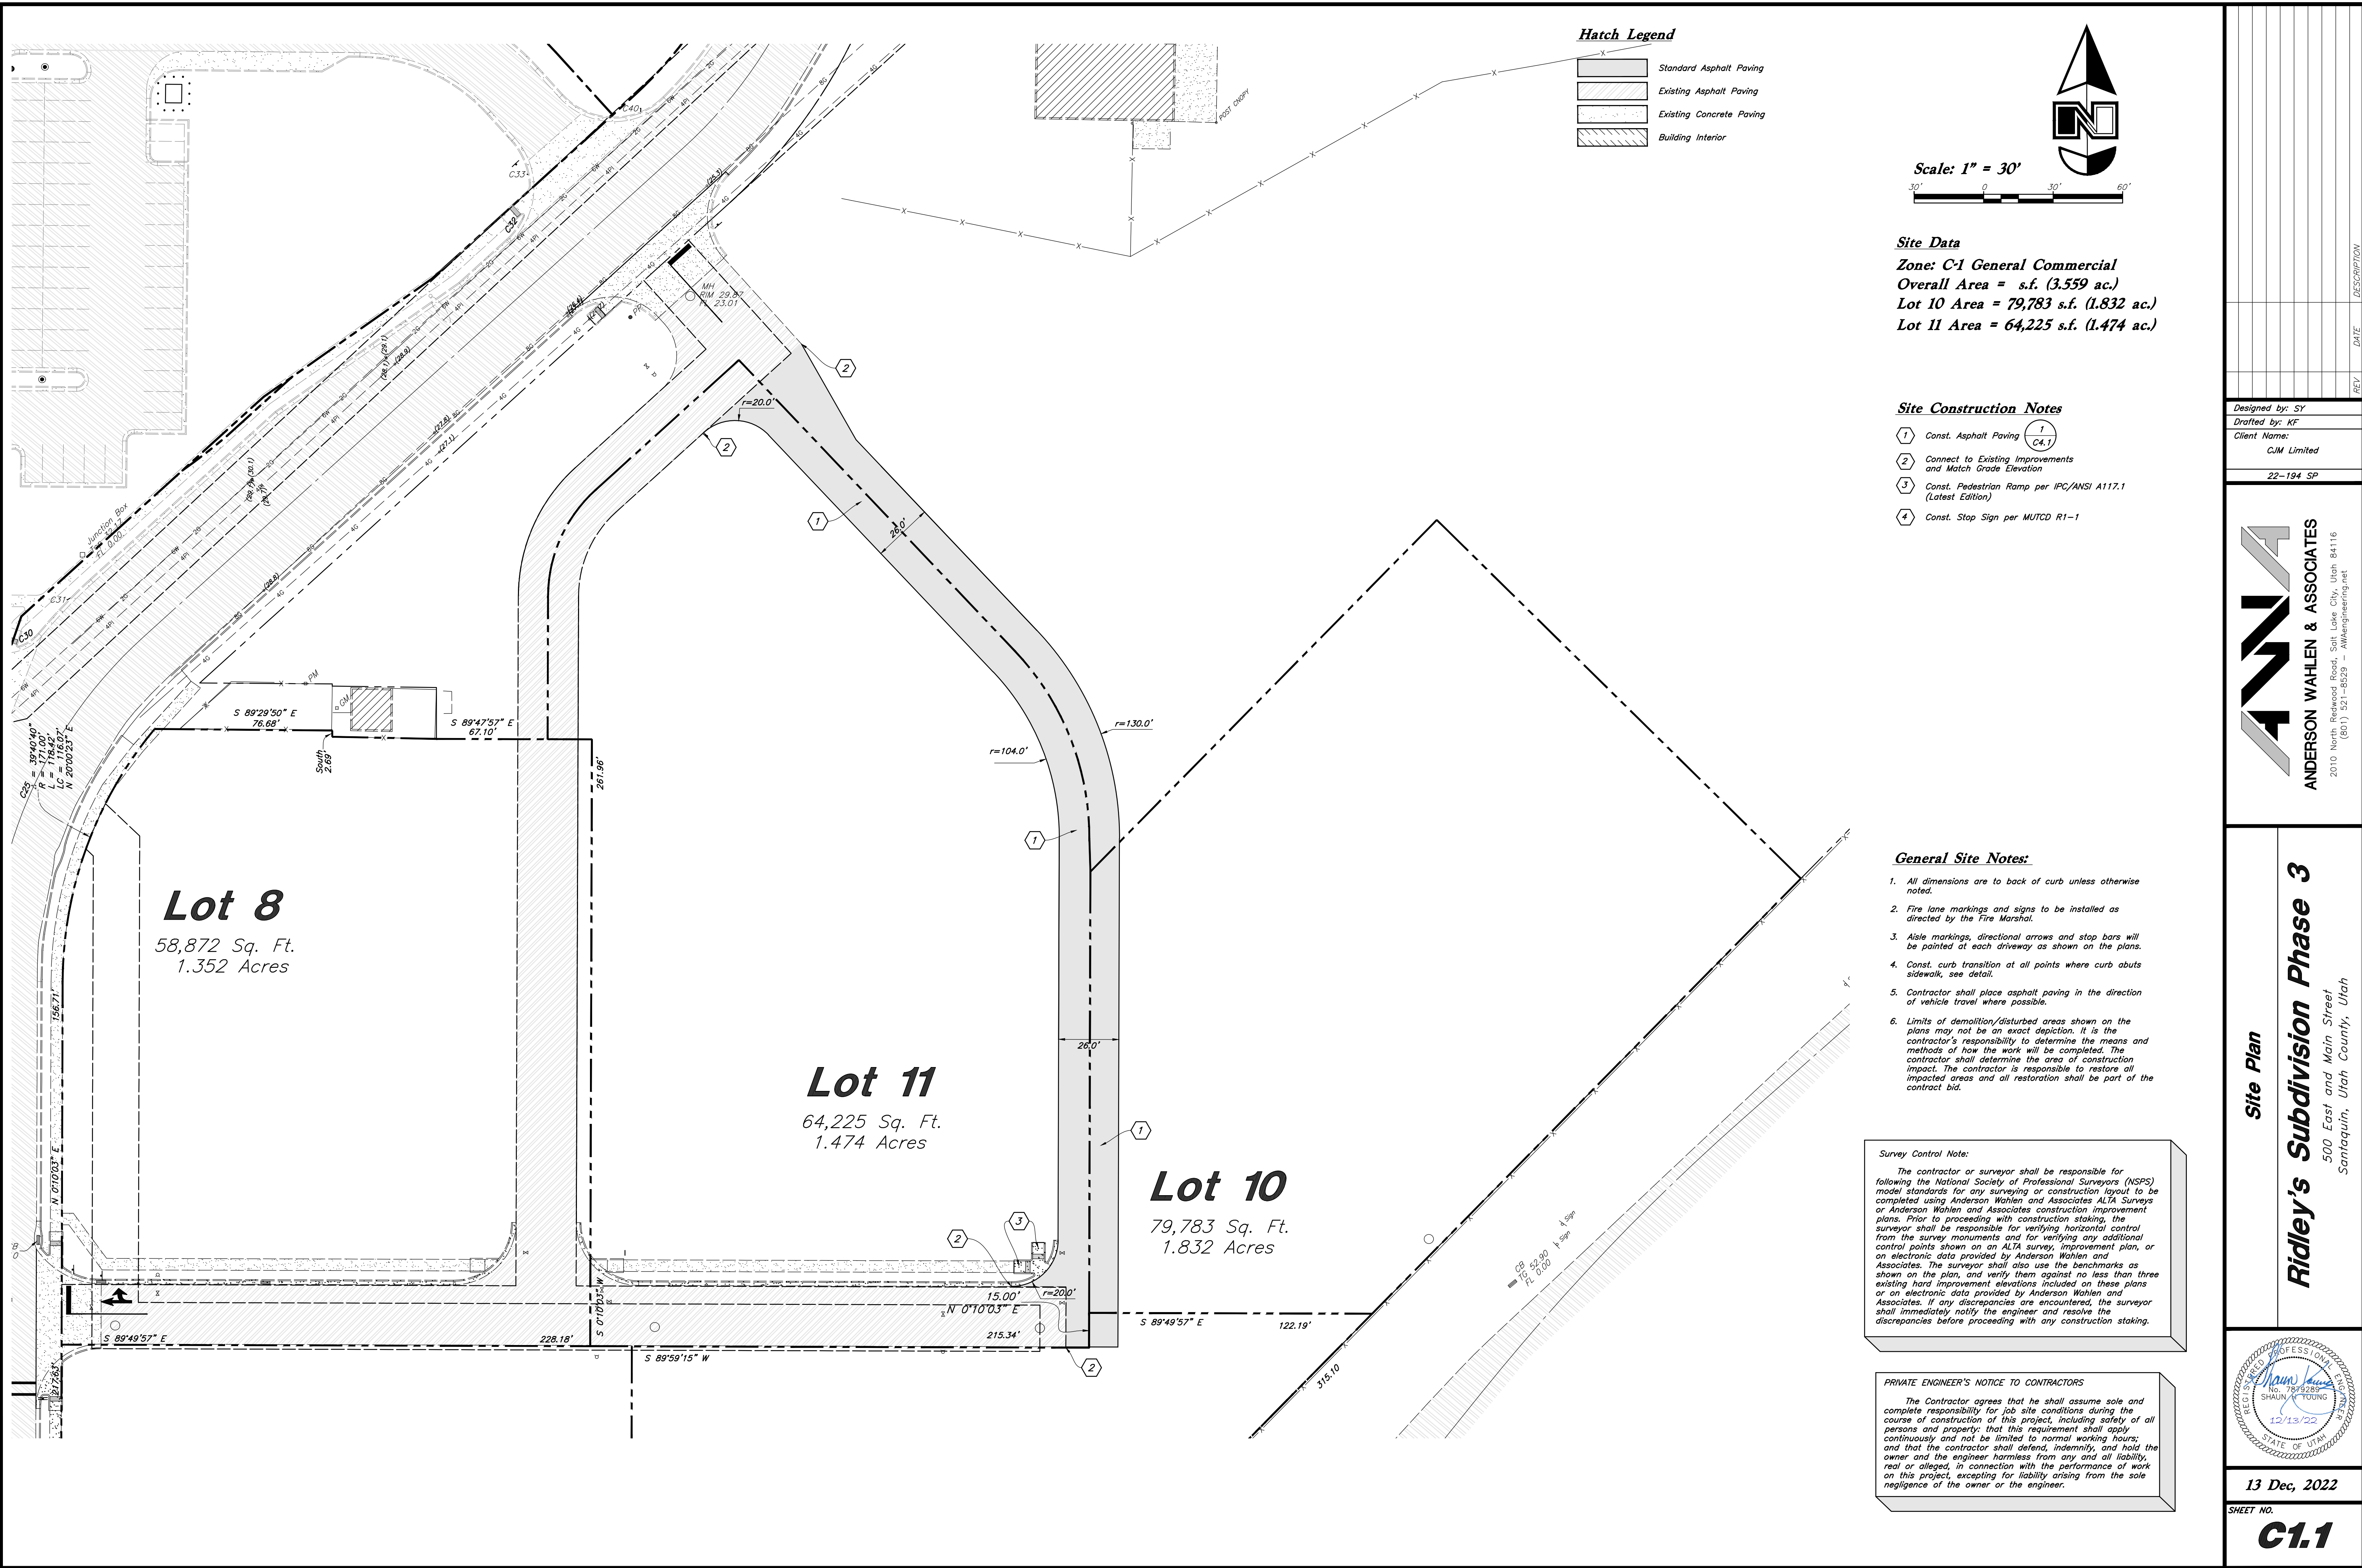


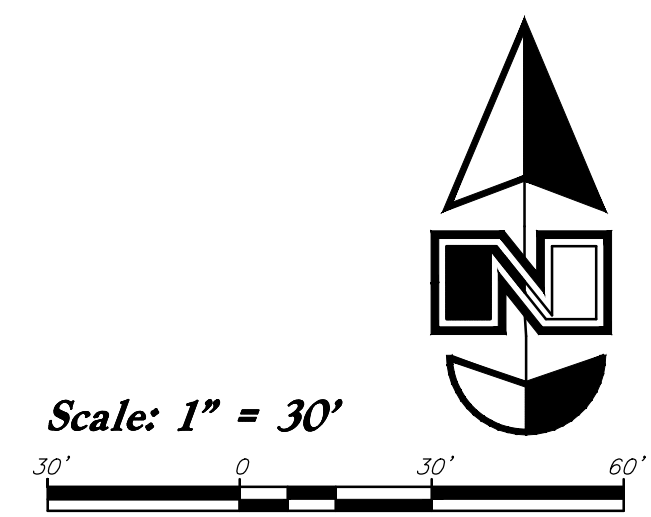


1. All grading shall be in accordance with the project geotechnical study.
2. Cut slopes shall be no steeper than 3 horizontal to 1 vertical.
3. Fill slopes shall be no steeper than 3 horizontal to 1 vertical.
4. Fills shall be compacted per the recommendations of the geotechnical report prepared for the project and shall be certified by a Geotechnical Engineer.
5. Areas to receive fill shall be properly prepared and approved by a Geotechnical Engineer prior to placing fill.
6. Fills shall be banded into competent material as per specifications and geotechnical report.
7. All trench backfill shall be tested and certified by a Geotechnical Engineer.
8. A geotechnical engineer shall perform periodic inspections and submit a complete report and map upon completion of the rough grading.
9. The final compaction report and certification from a Geotechnical Engineer shall contain the type of field testing performed. Each test shall be identified with the location of obtaining the in-place density, whether sand cone or drive ring and shall be so noted for each test. Sufficient maximum density determinations shall be performed to verify the accuracy of the maximum density curves used by the field technician.
10. Dust shall be controlled by watering.
11. The location and protection of all utilities is the responsibility of the permittee.
12. Approved protective measures and temporary drainage provisions must be used to protect adjoining properties during the grading process.
13. All public roadways must be cleared daily of all dirt, mud and debris deposited on them as a result of the grading operation. Cleaning is to be done to the satisfaction of the City Engineer.
14. The site shall be cleared and grubbed of all vegetation and deleterious matter prior to grading.
15. The contractor shall provide shoring in accordance with OSHA requirements for trench walls.
16. Aggregate base shall be compacted per the geotechnical report prepared for the project.
17. As part of the construction documents, owner has provided contractor with topographic survey performed by manual or aerial means. Such survey was prepared for project design purposes and is provided to the contractor as a courtesy. It is expressly understood that such survey may not accurately reflect existing topographic conditions.
18. If Contractor observes evidence of hazardous materials or contaminated soils he shall immediately contact the project engineer to provide notification and obtain direction before proceeding with disturbance of said materials or contaminated soil.



ANDERSON WAHLEN & ASSOCIATES
 2010 North Redwood Road, Salt Lake City, Utah 84116
 (801) 521-8529 — AWengineering.net

C2.1

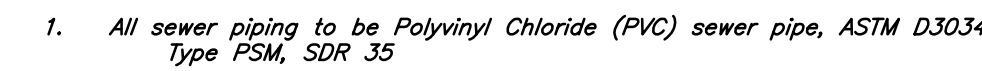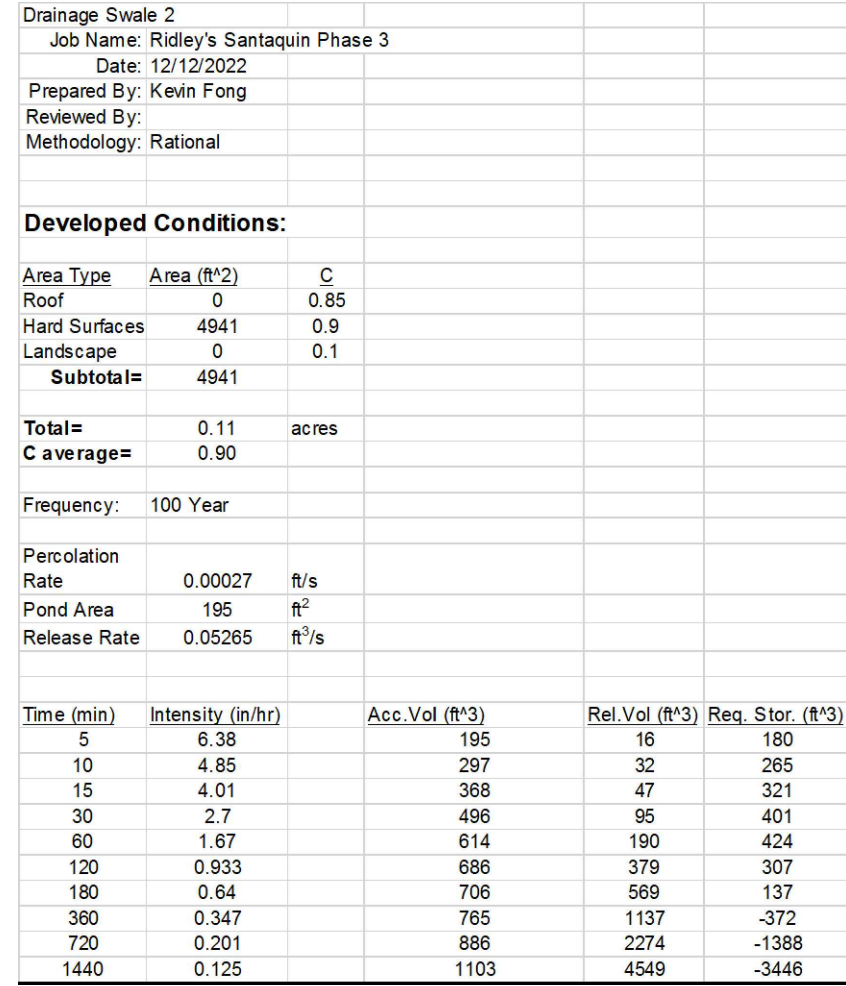

Onsite Utility Connection Notes:

1. Contractor shall field verify all utility connection elevations prior to any utility construction has begun.
2. Contractor shall construct utility lines into site prior to any onsite utility construction. Gravity lines are to be constructed starting at the lowest point and be installed prior to any watertine installation
3. Construction of any onsite utilities prior to the offsite connection will be done at the contractors risk.

Know what's below.

Call 811 before you dig






BLUE STAKES OF UTAH
UTILITY NOTIFICATION CENTER, INC.
www.bluestakes.org
1-800-662-4111



13 Dec, 2022

SHEET NO.

C3.0

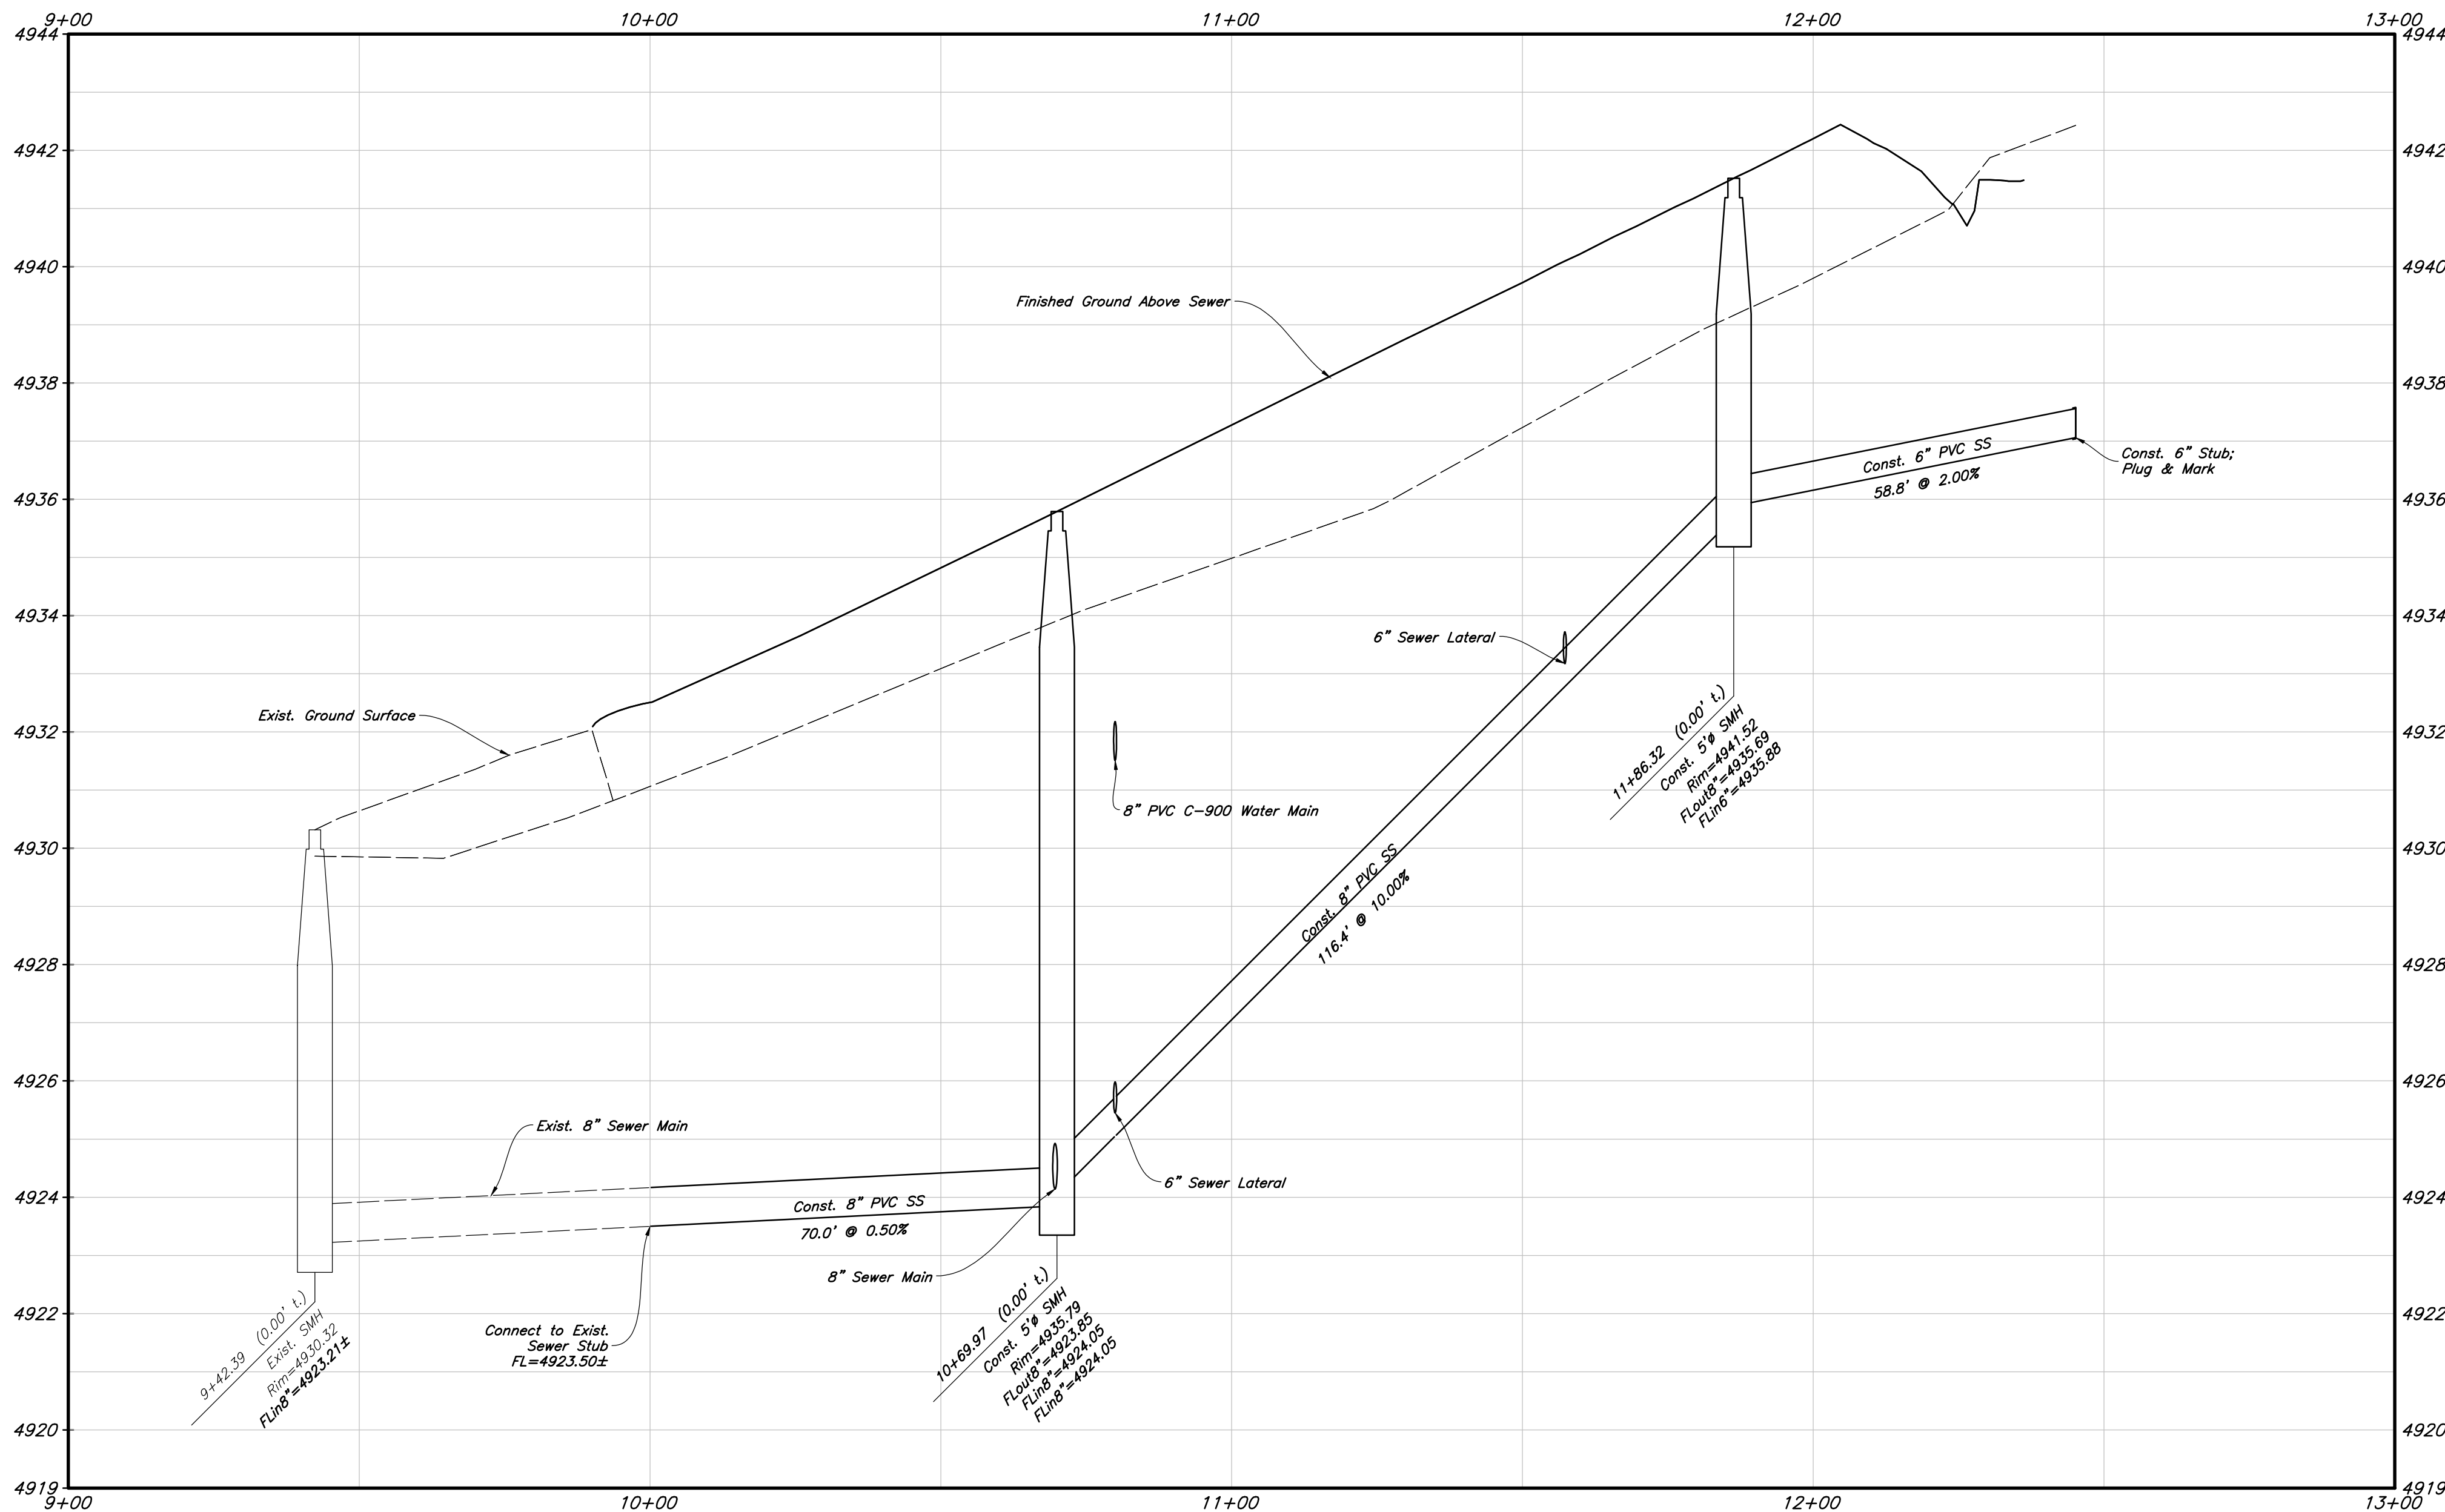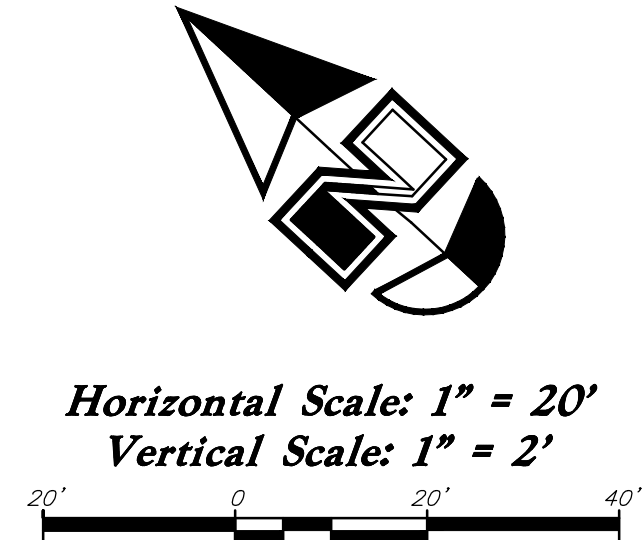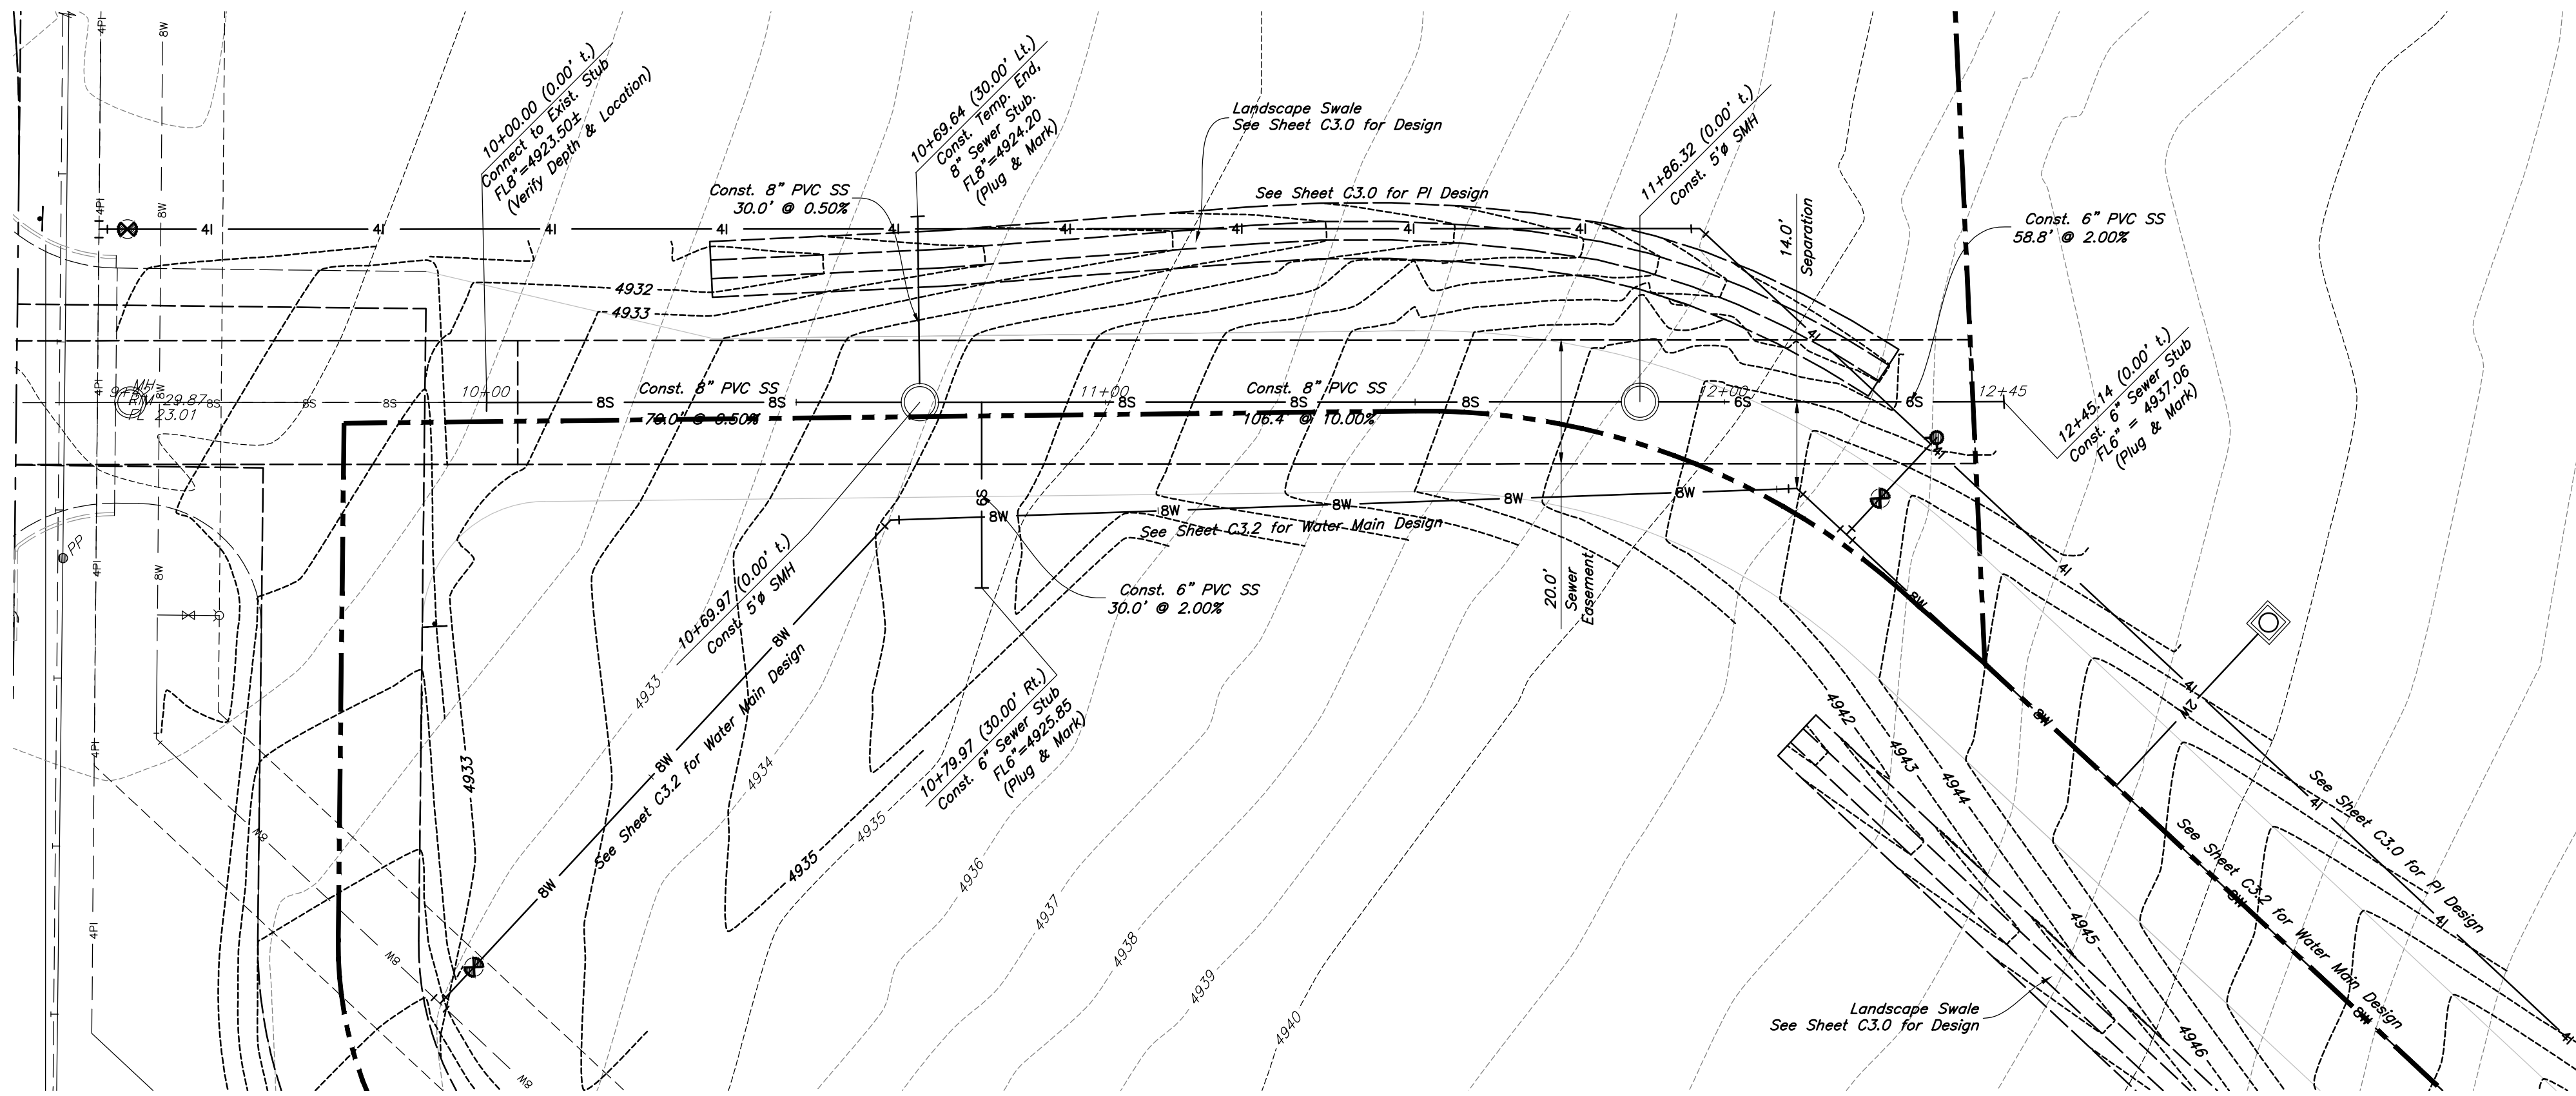

Designed by: SY
Drafted by: KF
Client Name:
CJM Limited
22-194 UT





ANDERSON WAHLEN & ASSOCIATES
2010 North Redwood Road, Salt Lake City, Utah 84116
(801) 521-8529 - AWAengineering.net

Sewer Main Plan & Profile


Ridley's Subdivision Phase 3

500 East and Main Street
Santaquin, Utah County, Utah

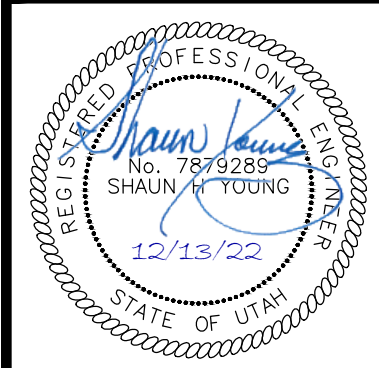


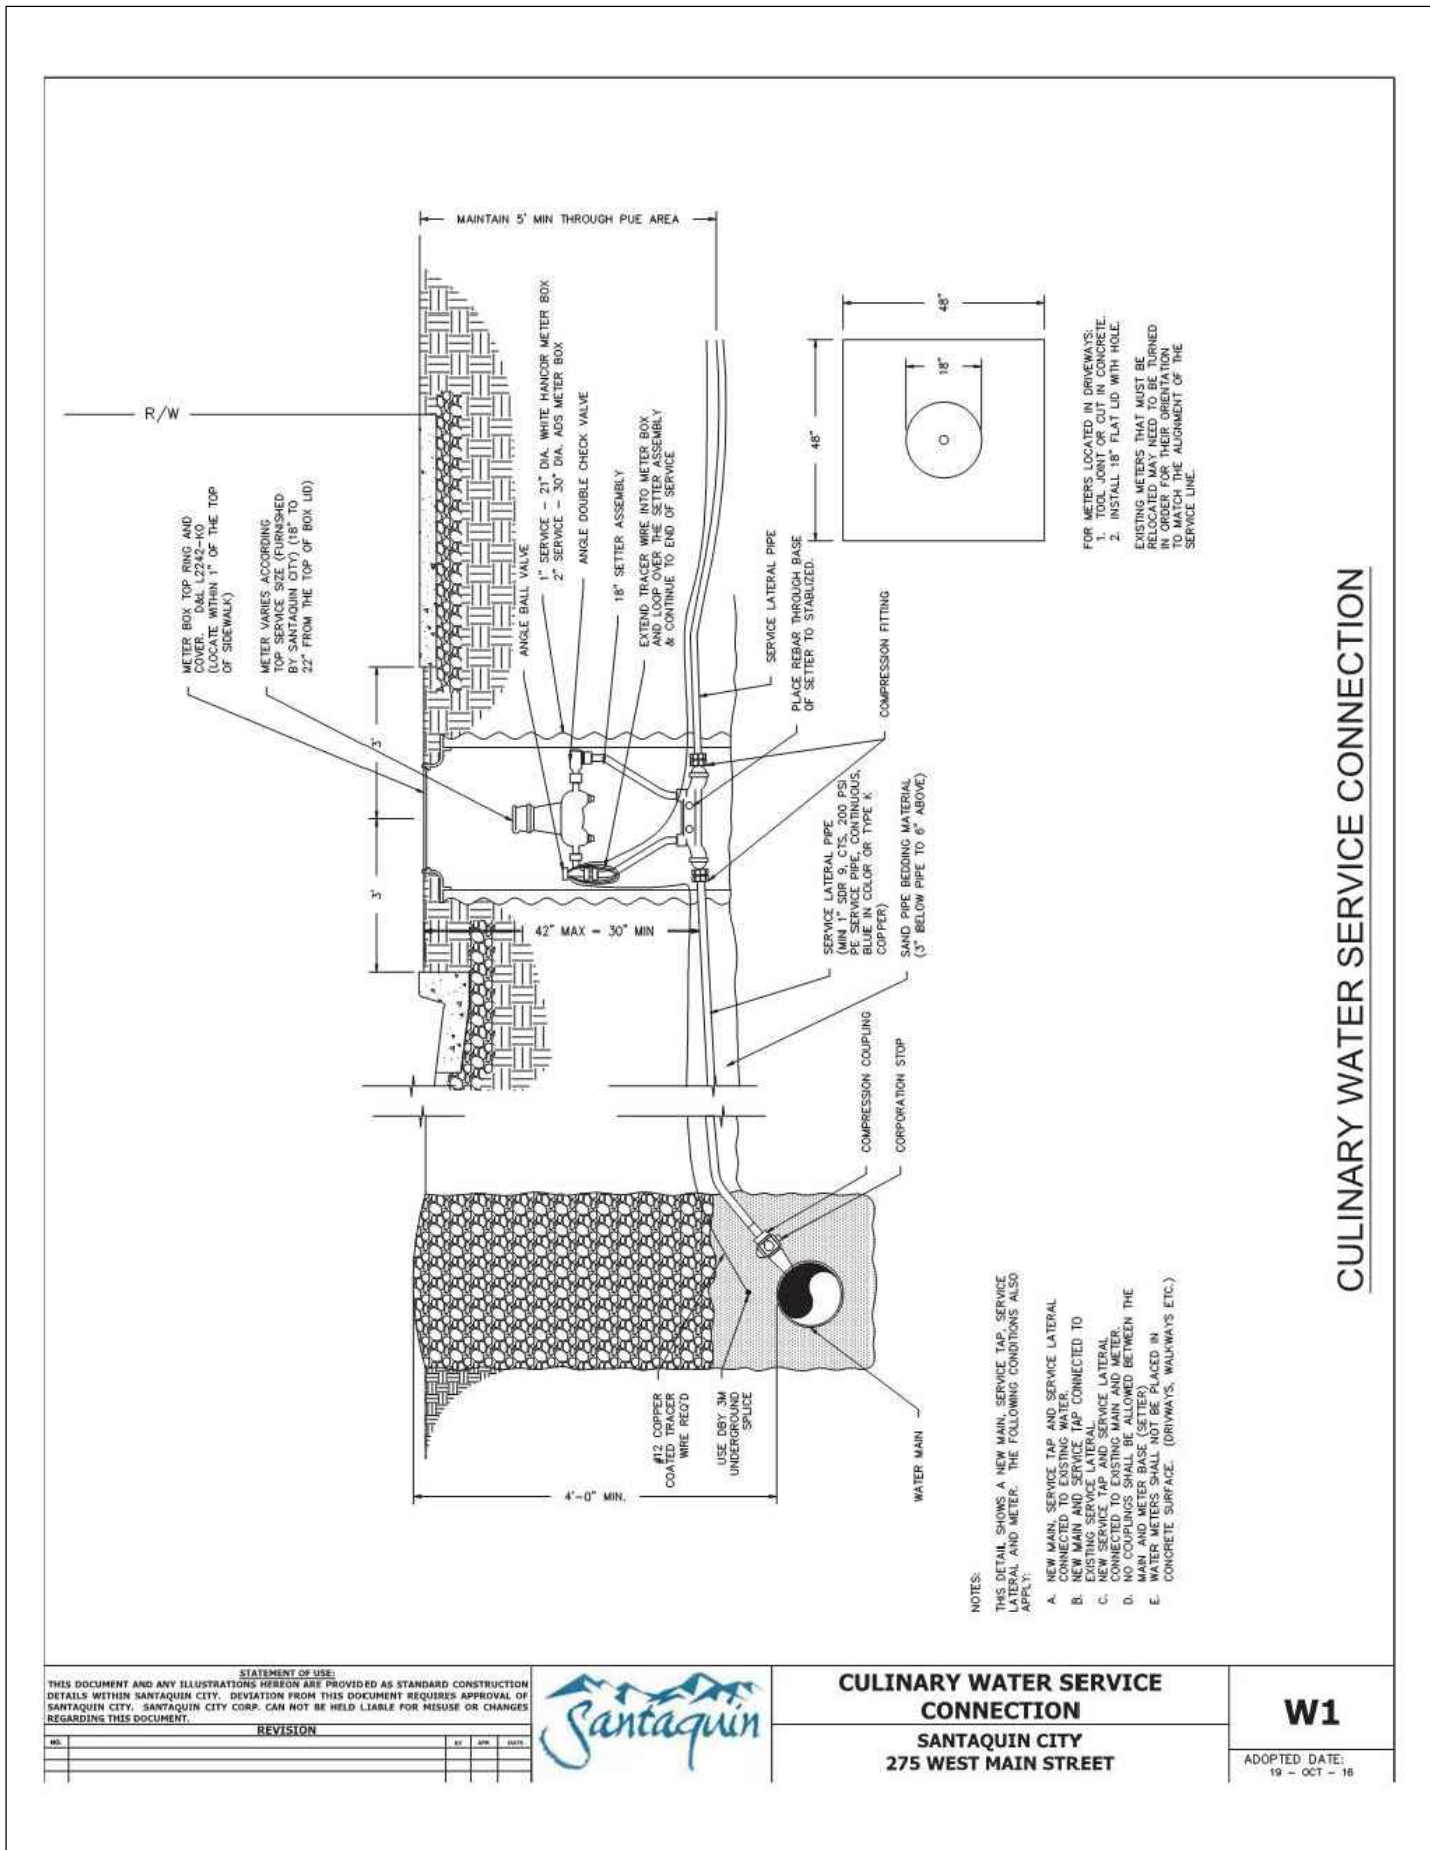


7 Santaquin City Std. Dwg. W1
Culinary Water Service Connection
Not to Scale

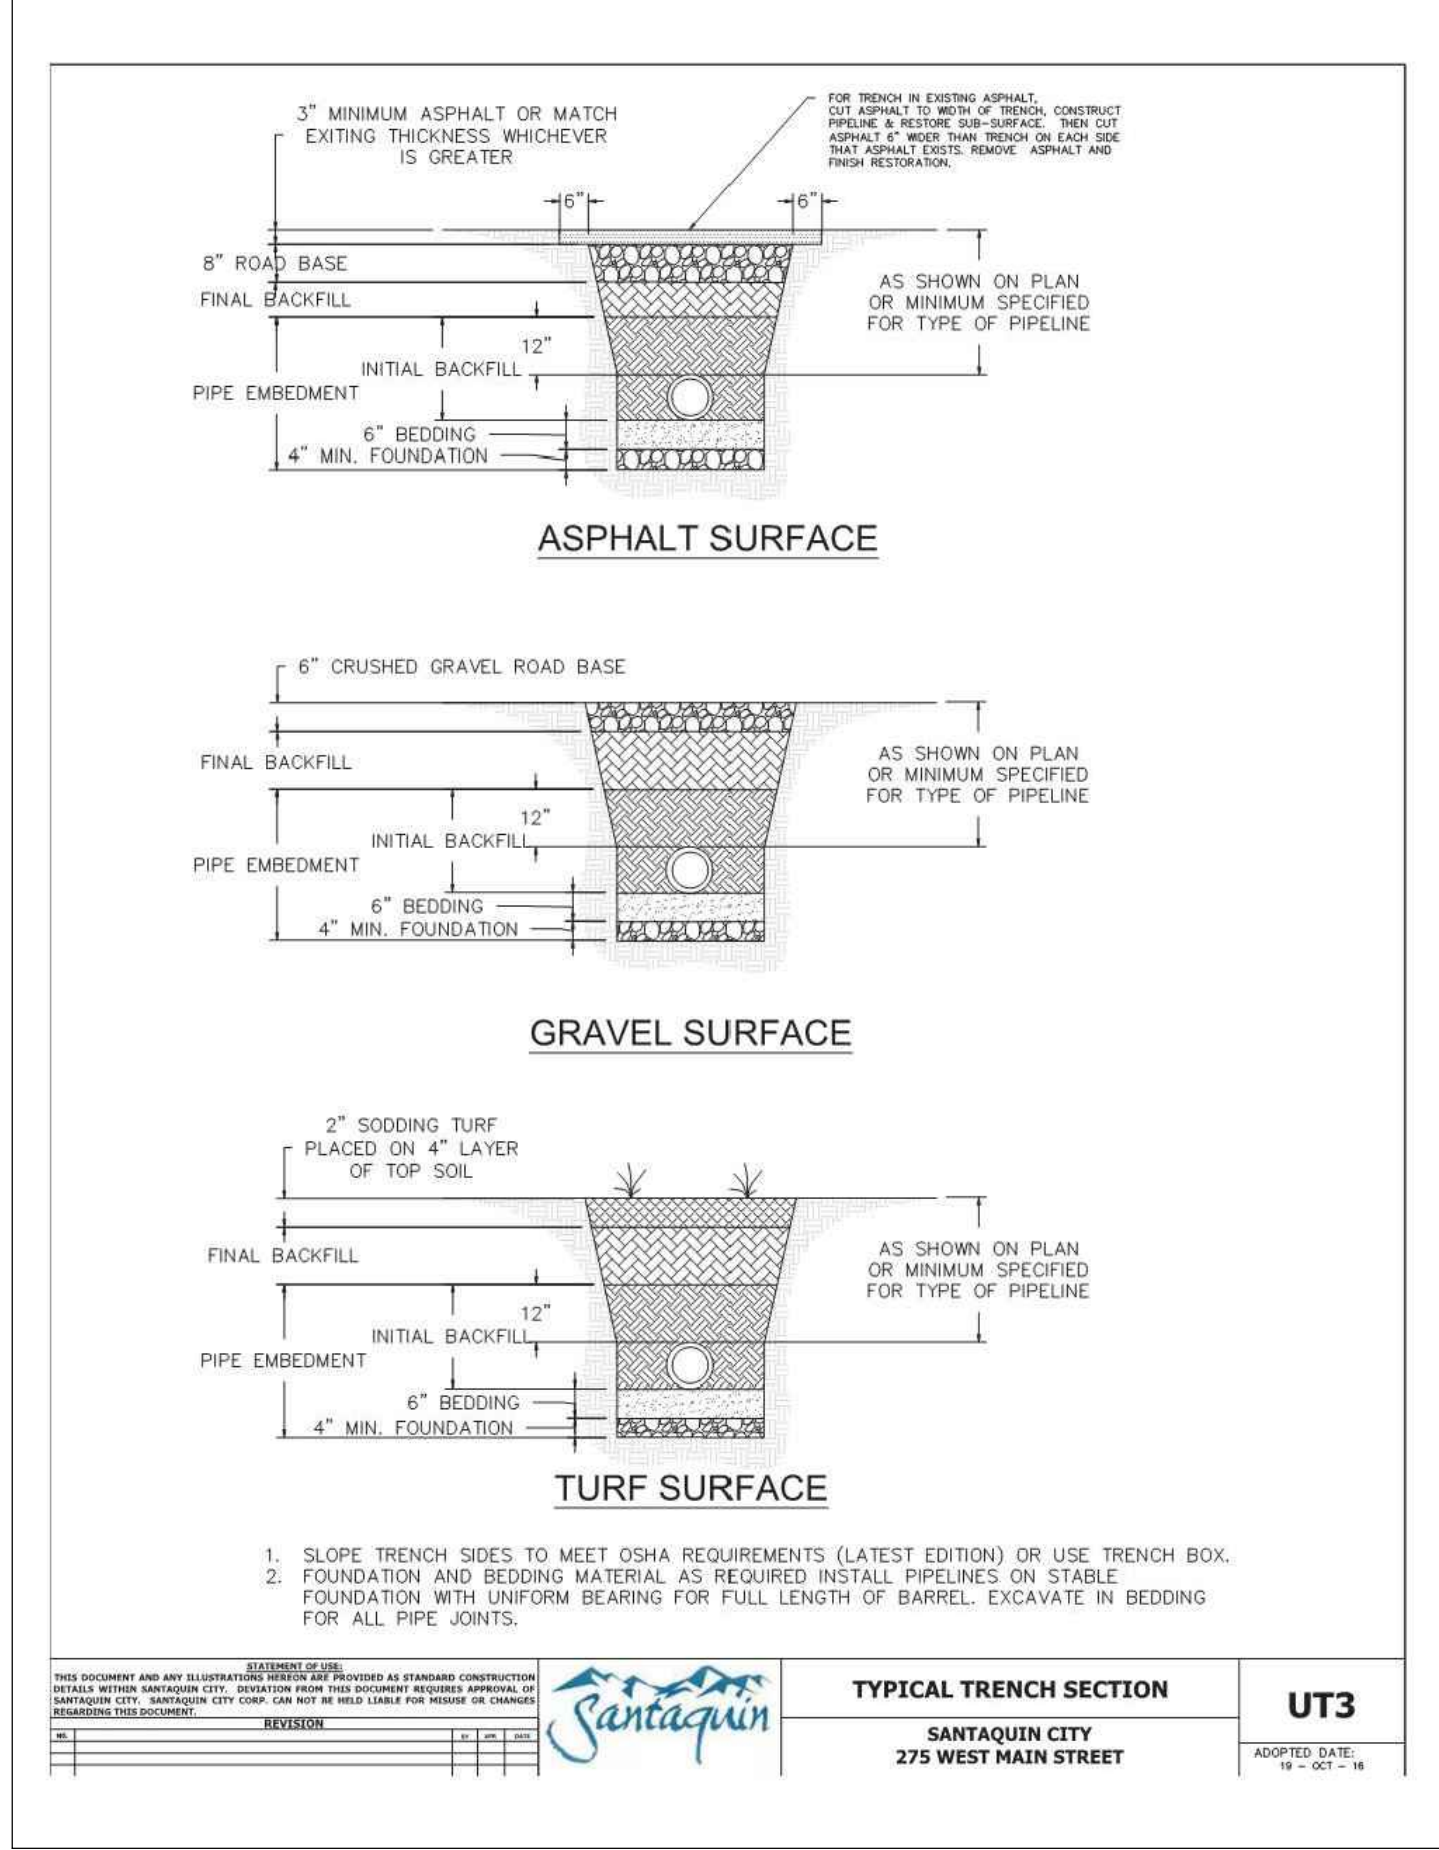

5 Santaquin City Std. Dwg. UT3
Typical Trench Section
Not to Scale

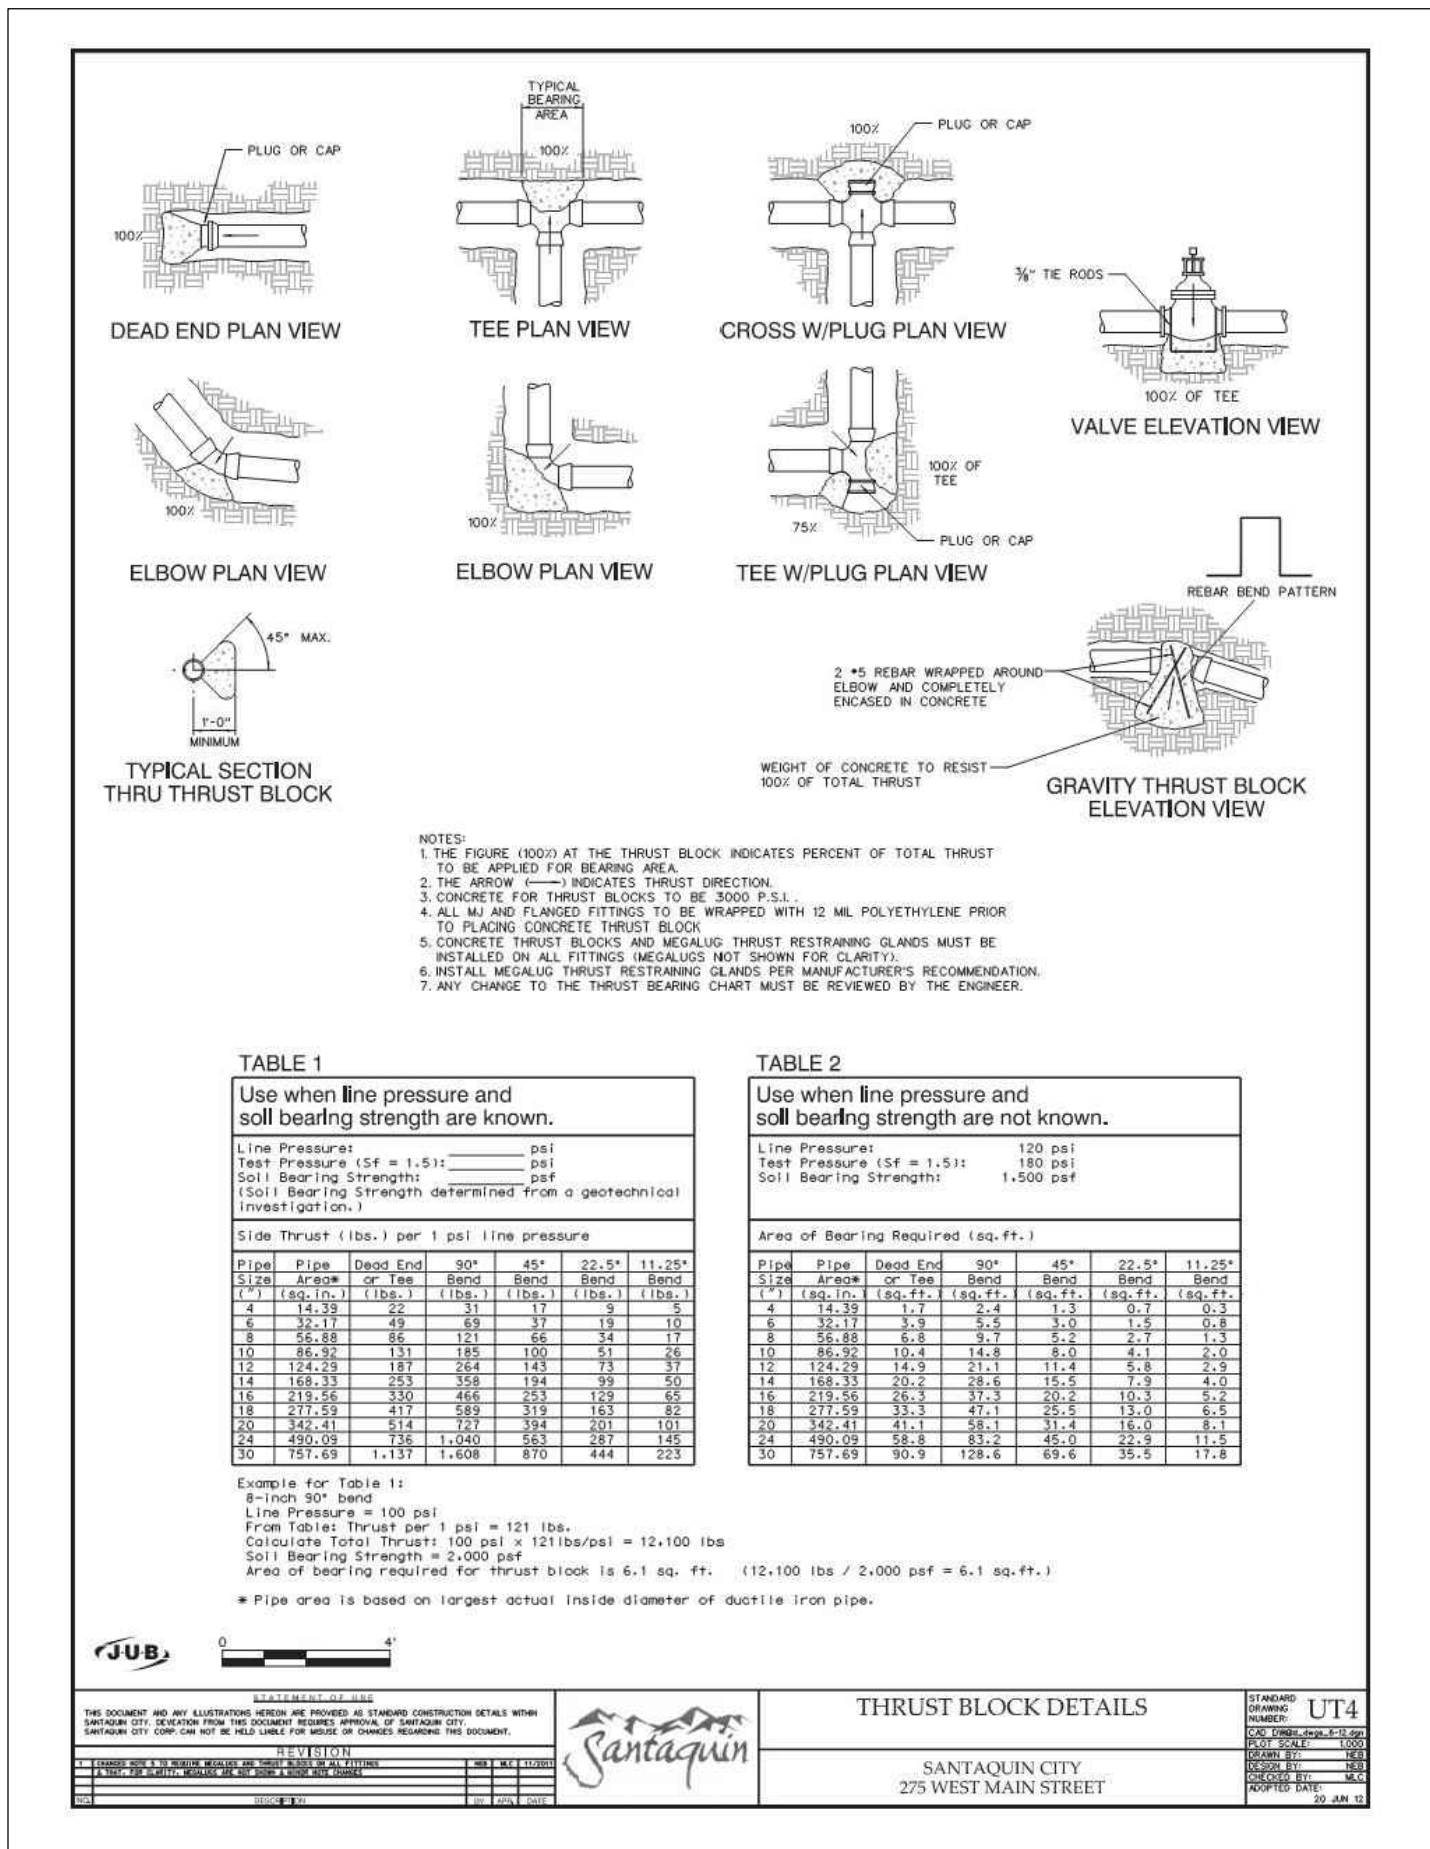


6 Santaquin City Std. Dwg. UT4
Thrust Block Details
Not to Scale

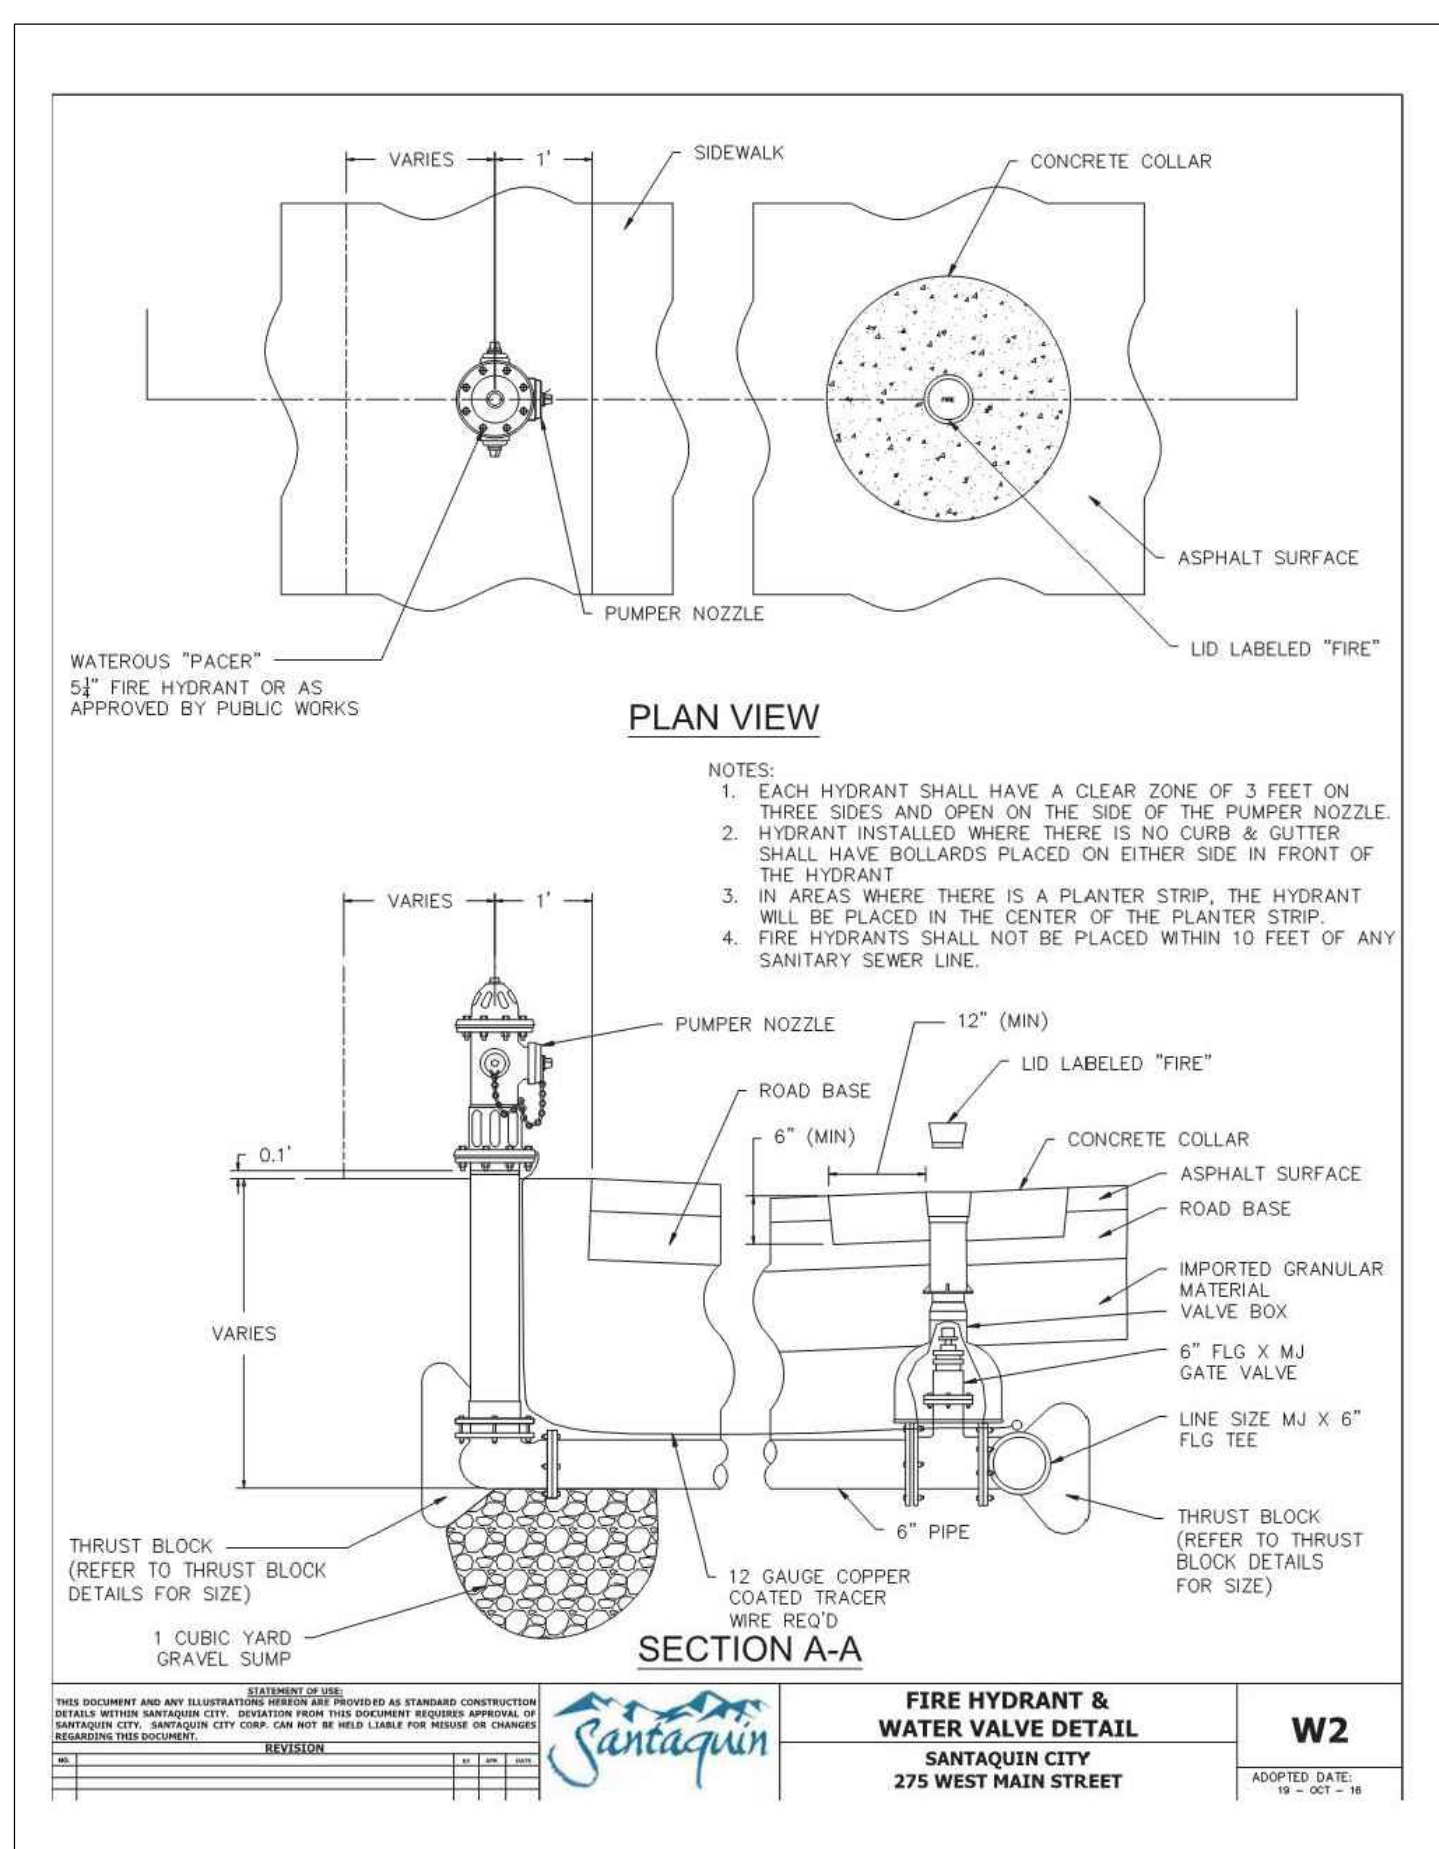


4 Santaquin City Std. Dwg. W2
Fire Hydrant & Water Valve
Not to Scale

3 Not Used
Not to Scale

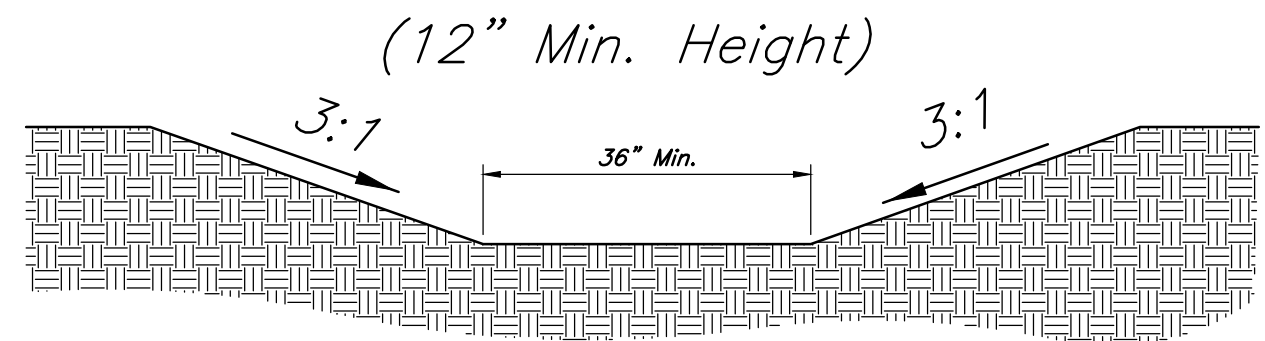

2 36 inch Landscape Swale
Not to Scale

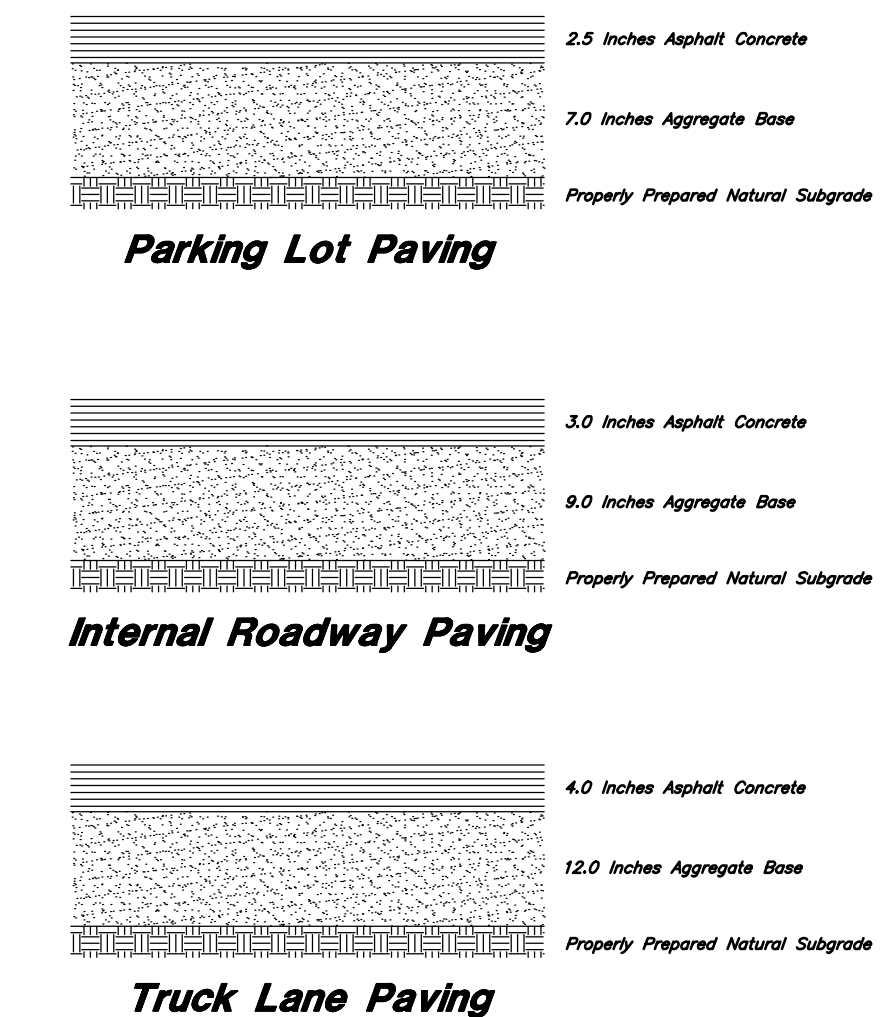



1 (Private)
Asphalt Sections
Not to Scale

Designed by: SY
Drafted by: KF
Client Name:
CJM Limited
22-194 DT

ANDERSON WAHLEN & ASSOCIATES
2010 North Redwood Road, Salt Lake City, Utah 84116
(801) 321-8529 - wwwengineering.net

Ridley's Subdivision Phase 3
500 East and Main Street
Santaquin, Utah County, Utah

13 Dec, 2022
SHEET NO.
C4.1

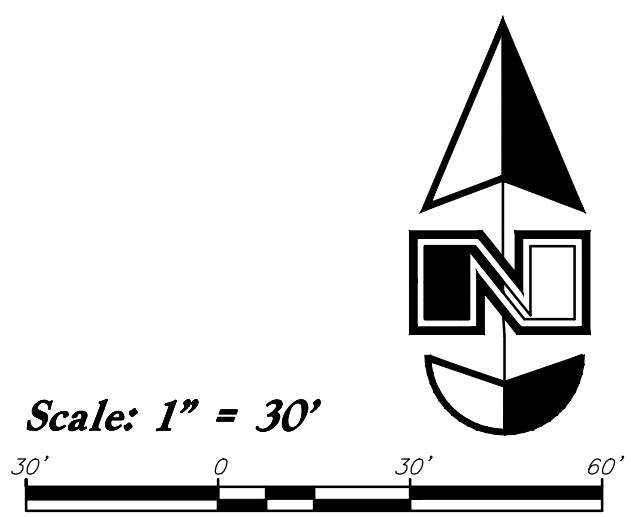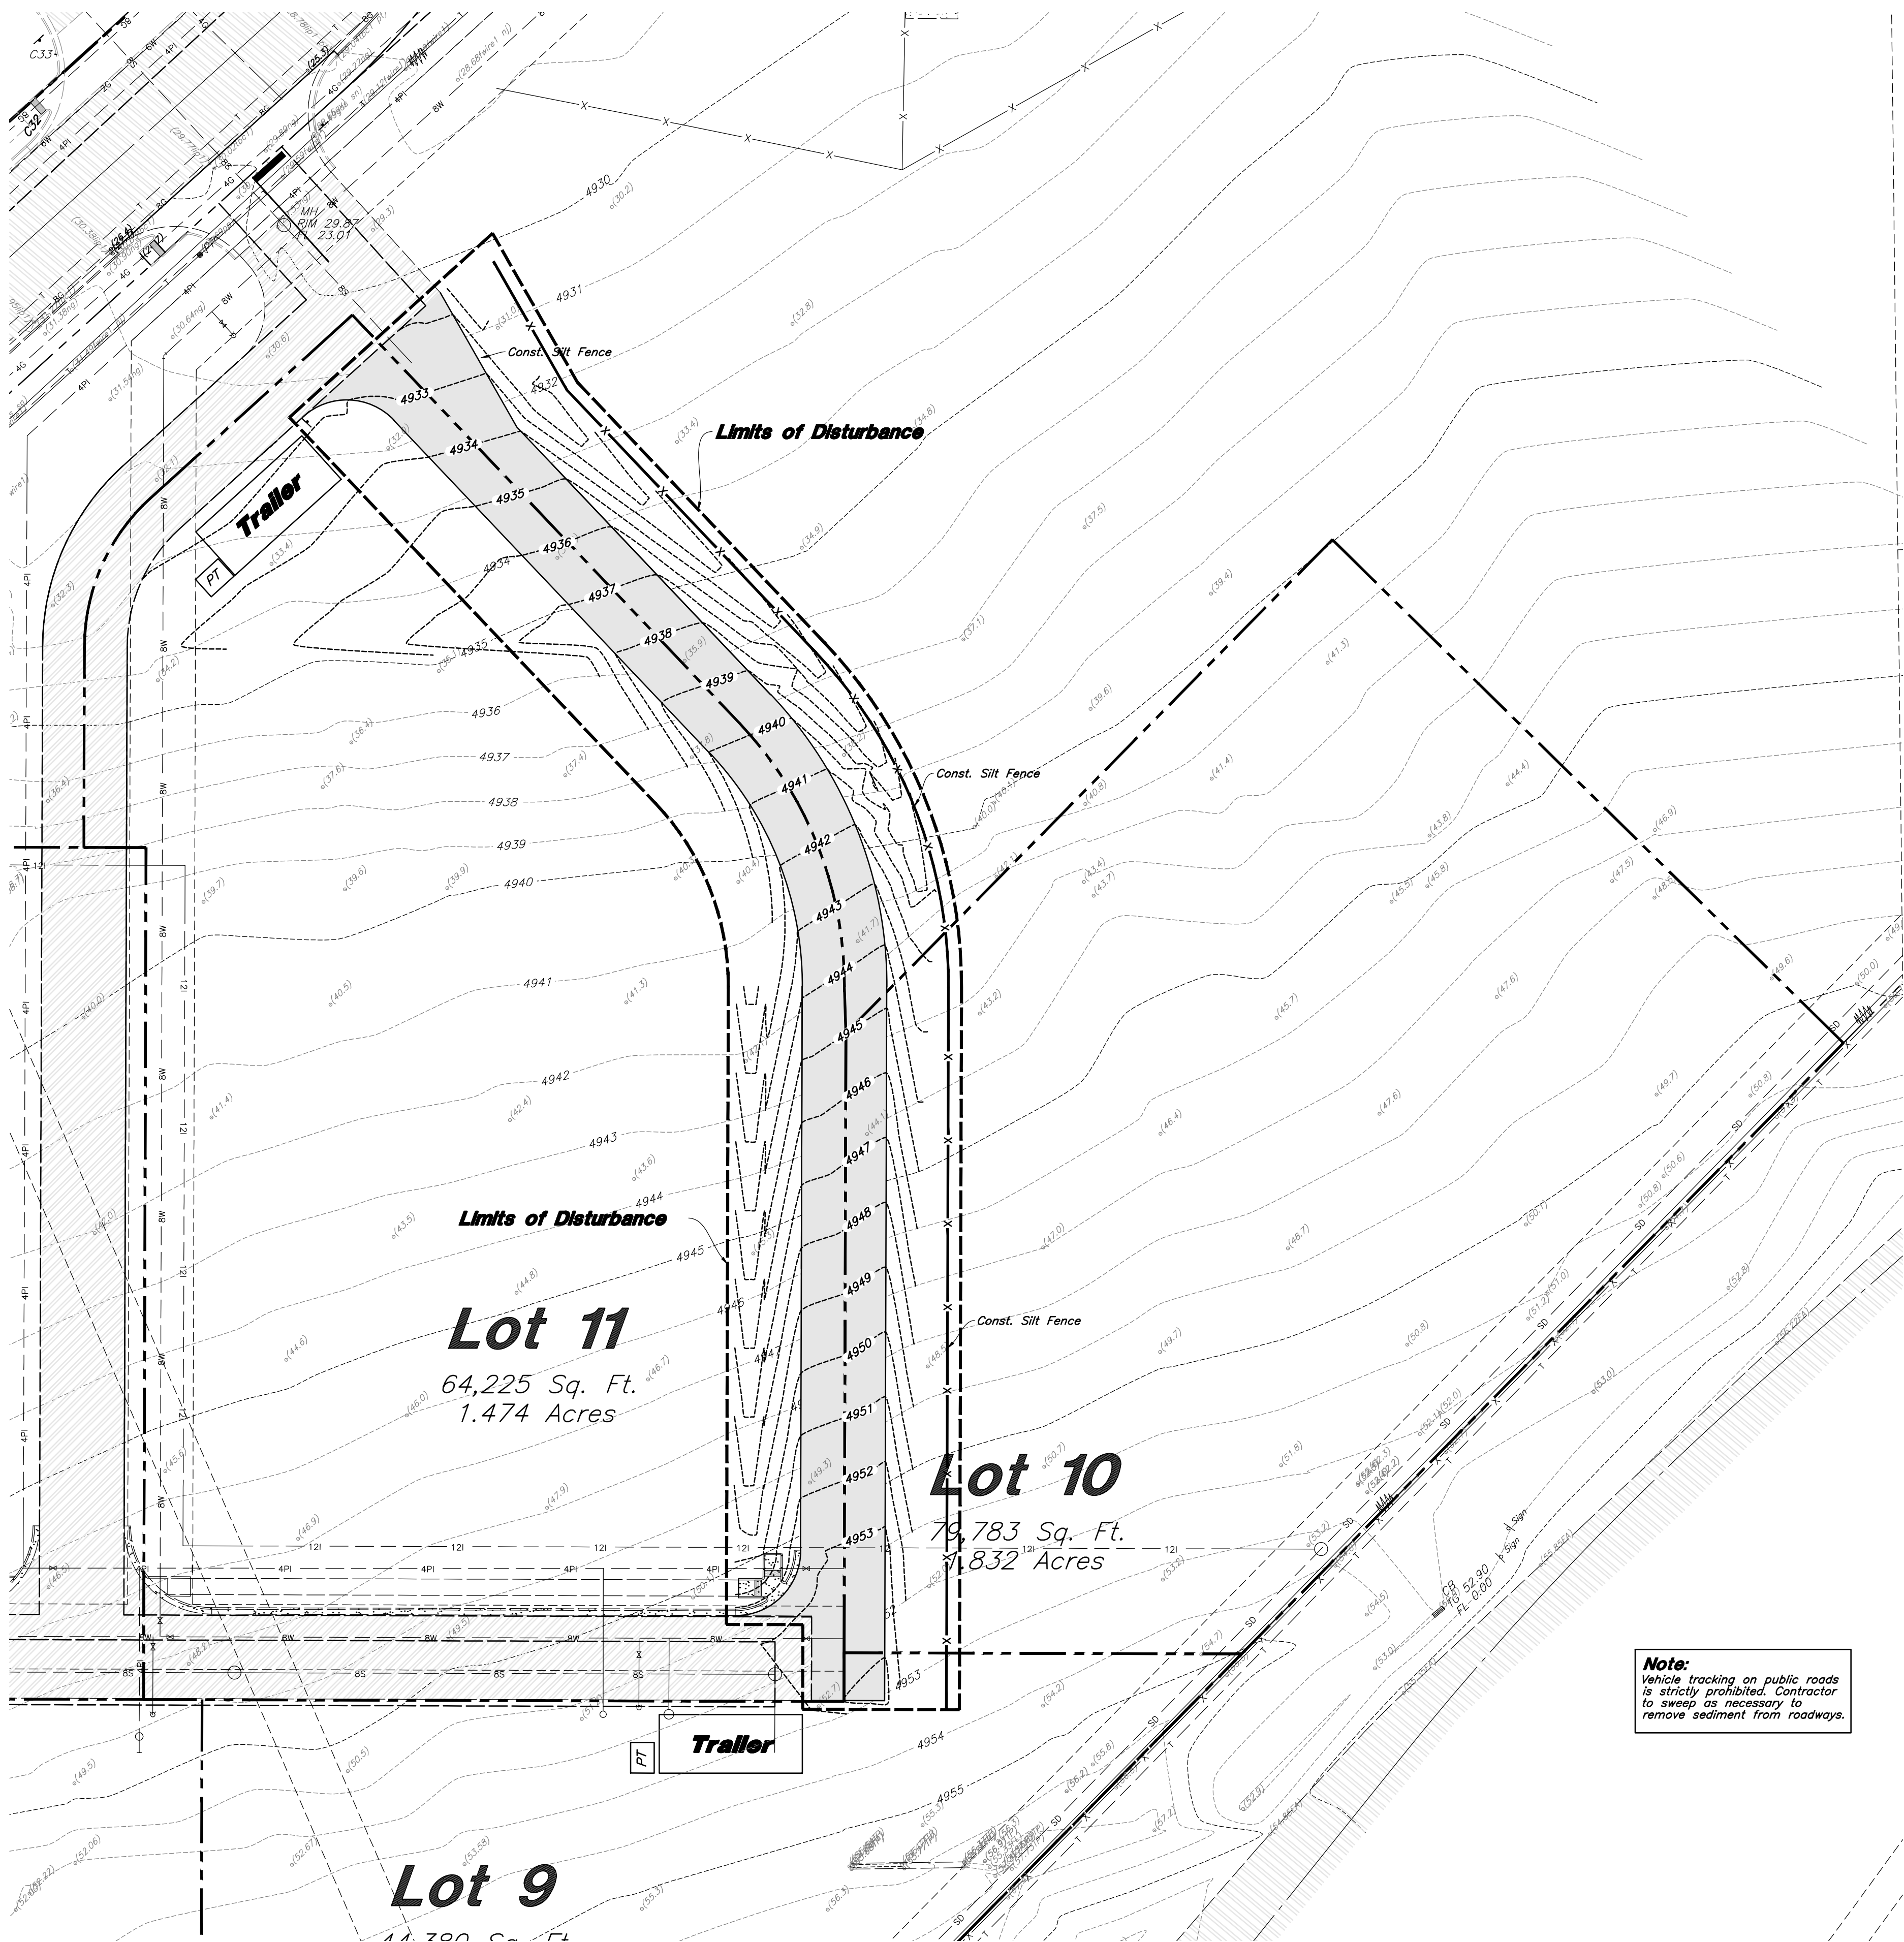

Legend

- Place Inlet Protection at all Inlet Locations to prevent boxes from silting.
- Silt Fence
- Limit of Disturbance
- Construction Entrance / Truck Wash (50'x24' Min.)
- Concrete Washout Area
- Portable Toilet
- Gravel Sock
- Existing Contour
- Existing Spot
- Proposed Contour




Designed by: SY
Drafted by: KF
Client Name:
CJM Limited
22-194 EC

Limits of Disturbance = 103,415 s.f. or 2.374 acres

Erosion Control Notes

- Storm water will be discharged into an existing drainage system. Existing Lines shall be inspected prior to Certificate of Occupancy and cleaned if necessary.
- The Storm Water Prevention Plan shall conform to all State Division of Environmental Protection Regulations.
- All Construction equipment will enter thru Designated Construction Entrances.
- Coordinate Entrance locations with the local jurisdiction.
- Inlet Protection Devices and Barriers shall be Repaired or Replaced if they Show Signs of Undermining or Deterioration.
- Silt Fences shall be Repaired to their Original Conditions if Damaged. Sediment shall be Removed from Silt Fences when it Reaches one-half the Height of the Silt Fence.
- The Construction Entrances shall be Maintained in a Condition which will Prevent Tracking or Flow of Mud onto Public Right-of-Way. This may Require Periodic Top Dressing of the Construction Entrances as Conditions Demand.
- All Materials Spilled, Dropped, Washed or Tracked from Vehicles onto Roadways or into Storm Drains must be Removed Immediately.
- Due to the Grade Changes During the Development of the Project, the Contractor shall be Responsible for Adjusting the Erosion Control Measures (Silt Fences, Inlet Protection, Etc...) to Prevent Erosion.
- Contractor shall use Vehicle Tracking Control at all Locations where Vehicles will Enter or Exit the Site. Control Facilities will be Maintained while Construction is in Progress, Moved when Necessary and Removed when the Site is Paved.
- Inlet Protection Devices shall be Installed Immediately upon Individual Inlets becoming Functional.
- This Document is Fluid Allowing for Changes, Modifications, Updates and Alternatives. It is the Responsibility of the Contractor to Keep a Record of all Alterations made to the Erosion Control Measures Implemented for the Project on this Plan and in the Storm Water Pollution Prevention Plan.
- Cover Exposed stockpiles of soils, construction and landscaping materials with heavy plastic sheeting.
- Re-vegetate areas where landscaping has died or not taken hold.
- Divert storm water runoff around disturbed soils with berms or dirt swales.
- Contractor to provide permanent stabilization to any areas disturbed by construction by hydroseeding native vegetation (if not otherwise stabilized).
- Contractor is responsible for obtaining a fugitive dust control permit through the Division of Air Quality. All responsibilities relating to the production of the dust control plan shall be the responsibility of the Contractor.

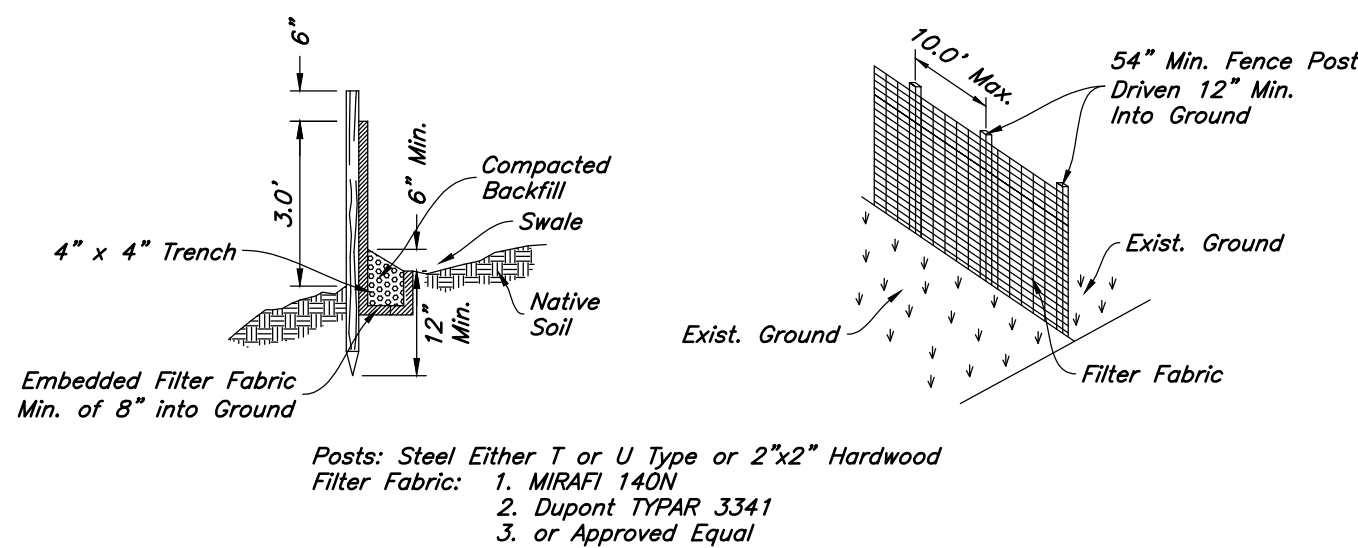


Notes:

- Filter cloth to be fastened securely to fence posts with wire ties or staples.
- When two sections of filter cloth adjoin each other they shall be overlapped by six inches and folded.
- Collected material shall be removed when "bulges" develop in the silt fence.

Silt Fence Section
Not to Scale

ANDERSON WAHLEN & ASSOCIATES
2010 North Redwood Road, Salt Lake City, Utah 84116
(801) 521-8529 - AWahlen@engineering.net

Erosion Control Plan
Ridley's Subdivision Phase 3
500 East and Main Street
Saratoga, Utah County, Utah

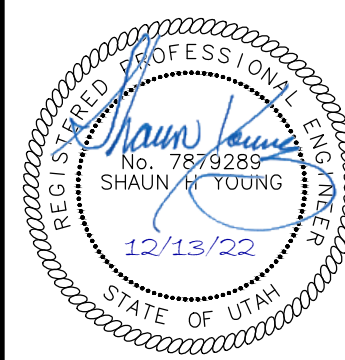

13 Dec, 2022
SHEET NO.
C5.1