
VICINITY MAP SANTAQUIN CITY

ALL IMPROVEMENTS AND DETAILS PER SANTAQUIN CITY CONSTRUCTION STANDARDS

MAILBOX (2 x CBU) LOCATION FOR PHASE N TO BE LOCATED ALONG WESTWOOD WAY IN PHASE P

PHASES M & N TO BE CONSTRUCTED OCNCURRENTLY

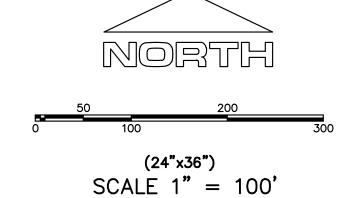

(11"x17") SCALE 1" = 200'

NOTES:


- 1. THE DEVELOPER AND THE GENERAL CONTRACTOR UNDERSTAND THAT IT IS HIS/HER RESPONSIBILITY TO ENSURE THAT ALL IMPROVEMENTS INSTALLED WITHIN THIS DEVELOPMENT ARE CONSTRUCTED IN FULL COMPLIANCE WITH ALL STATE AND SANTAQUIN CITY CODES, ORDINANCES AND STANDARDS. THESE PLANS ARE NOT ALL INCLUSIVE OF ALL MINIMUM CODES, ORDINANCES AND STANDARDS. THIS FACT DOES NOT RELIEVE THE DEVELOPER OR GENERAL CONTRACTOR FROM FULL COMPLIANCE WITH ALL MINIMUM STATE AND SANTAQUIN CITY CODES, ORDINANCES AND STANDARDS."
- 2. ALL SPEED & TRAFFIC REGULATION SIGNS TO BE DETERMINED AND INSTALLED BY SANTAQUIN CITY. DEVELOPER TO PAY SIGN EXPENSES WITH DEVELOPMENT
- 3. ALL SERVICE LATERALS SHALL BE INSTALLED PER SANTAQUIN STANDARDS AND DETAIL ON SHEET DT-01,
- UNLESS OTHERWISE NOTED. 4. 18" MIN. VERTICAL SEPARATION BETWEEN CULINARY WATER AND PI, STORM DRAIN, OR SANITARY SEWER AT ALL CROSSINGS. CULINARY WATER TO HAVE 4' MIN. COVER AS PER CITY STANDARD.
- 5. SHALLOW SEWER MAY EXIST THROUGHOUT THIS PHASE. INJECTOR PUMPS MAY BE NEEDED IF BASEMENTS ARE
- 6. ALL RECOMMENDATIONS MADE IN A PERTINENT GEOTECHNICAL REPORT/STUDY SHALL BE FOLLOWED EXPLICITLY DURING CONSTRUCTION OF BUILDING AND SITE
- 7. ALL CURB INLET BOX INVERTS MUST BE A MINIMUM OF 36" OR 2.5 TIMES THE PIPE DIAMETER ABOVE THE BOTTOM OF

ACCEPTANCE		
IIGNATURE: DEVELOPER	DATE:	
IIGNATURE:	DATE:	
SIGNATURE: COMMUNITY DEV. DIRECTOR	DATE:	
SIGNATURE: PUBLIC WORKS	DATE:	
SIGNATURE: EUILDING DEPARTMENT	DATE:	
EIGNATURE: POLICE DEPARTMENT	DATE:	
SIGNATURE: FIRE DEPARTMENT	DATE:	

FOOTHILL VILLAGE SUBDIVISION PLAT 'M'

LOCATED IN THE SOUTHERN PORTION OF SECTION 11, TOWNSHIP 10 SOUTH

RANGE 1 EAST, SALT LAKE BASE AND MERIDIAN

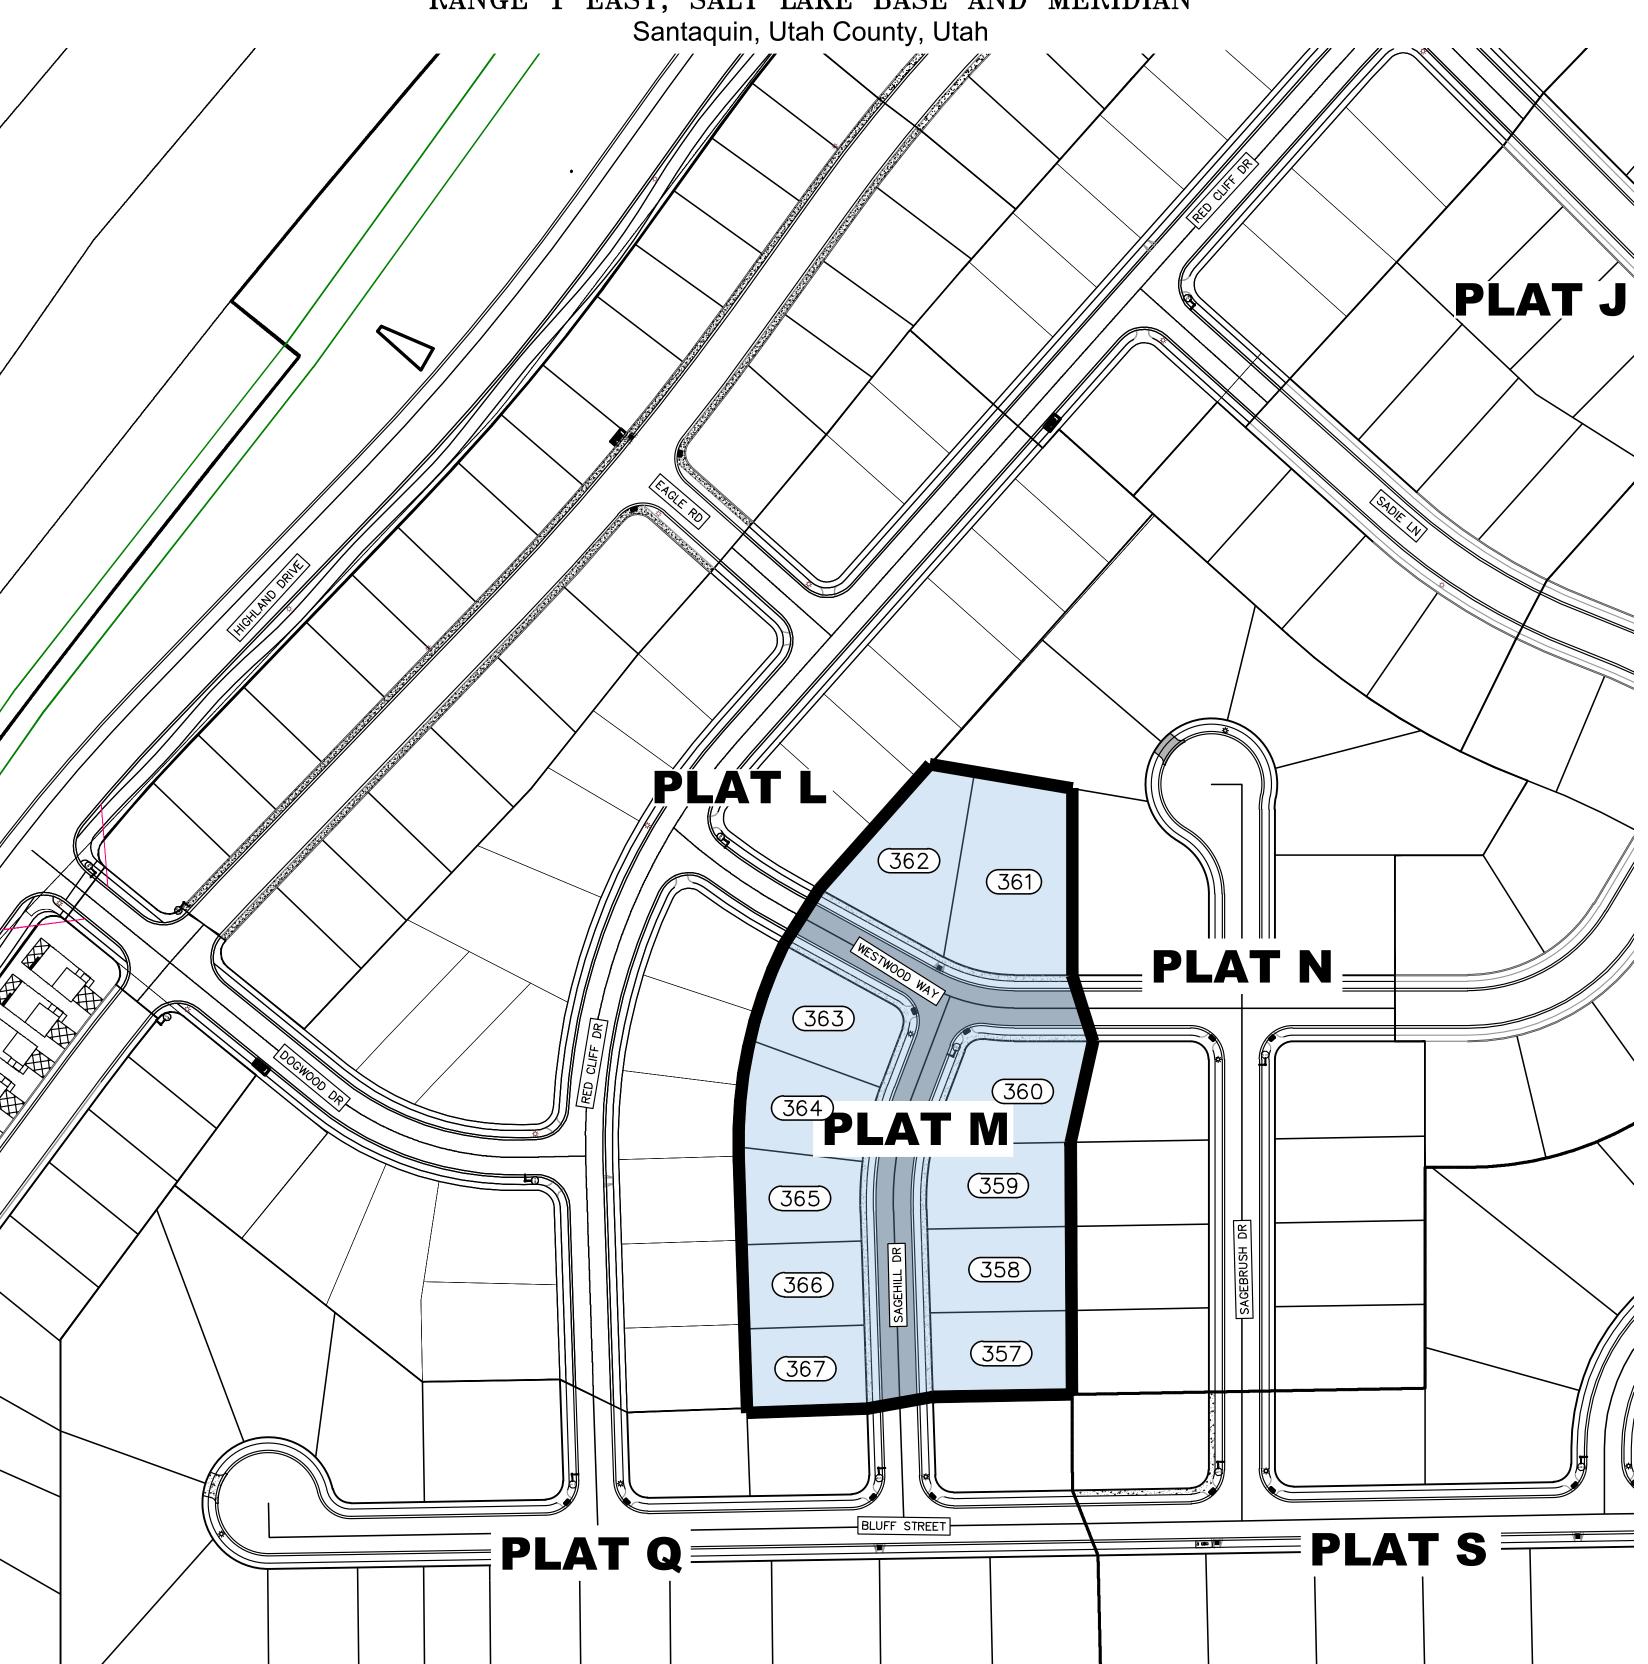

PROJECT STATISTICS

TOTAL ACREAGE 3.00 ACRES TOTAL ACREAGE IN LOTS 2.28 ACRES TOTAL ACREAGE IN STREETS 0.72 ACRES

> PROJECT ENGINEER & SURVEYOR REGION ENGINEERING & SURVEYING 1776 NORTH STATE STREET #110 OREM, UTAH 84057 PH - 801.376.2245

> > DR HORTON 12351 So. Gateway Park Place Suite D-100 Draper UT 84020 Office: (801) 571-7101

INDEX OF PLAN SHEETS				
SHEET	DESCRIPTION			
CS-01	COVER SHEET & NOTES			
PLAT	FINAL PLAT			
SP-01	SITE & UTILITY PLAN			
GR-01	GRADING PLAN			
PP-01-02	PLAN & PROFILE			
EC-01	EROSION CONTROL PLAN			
EC-02	EROSION CONTROL DETAILS			
DT-01	TYPICAL DETAILS			

DENSITY 3.67 UNITS/ac ZONE R15 PUD

PROJECT DEVELOPER

CKLeavitt1@drhorton.com


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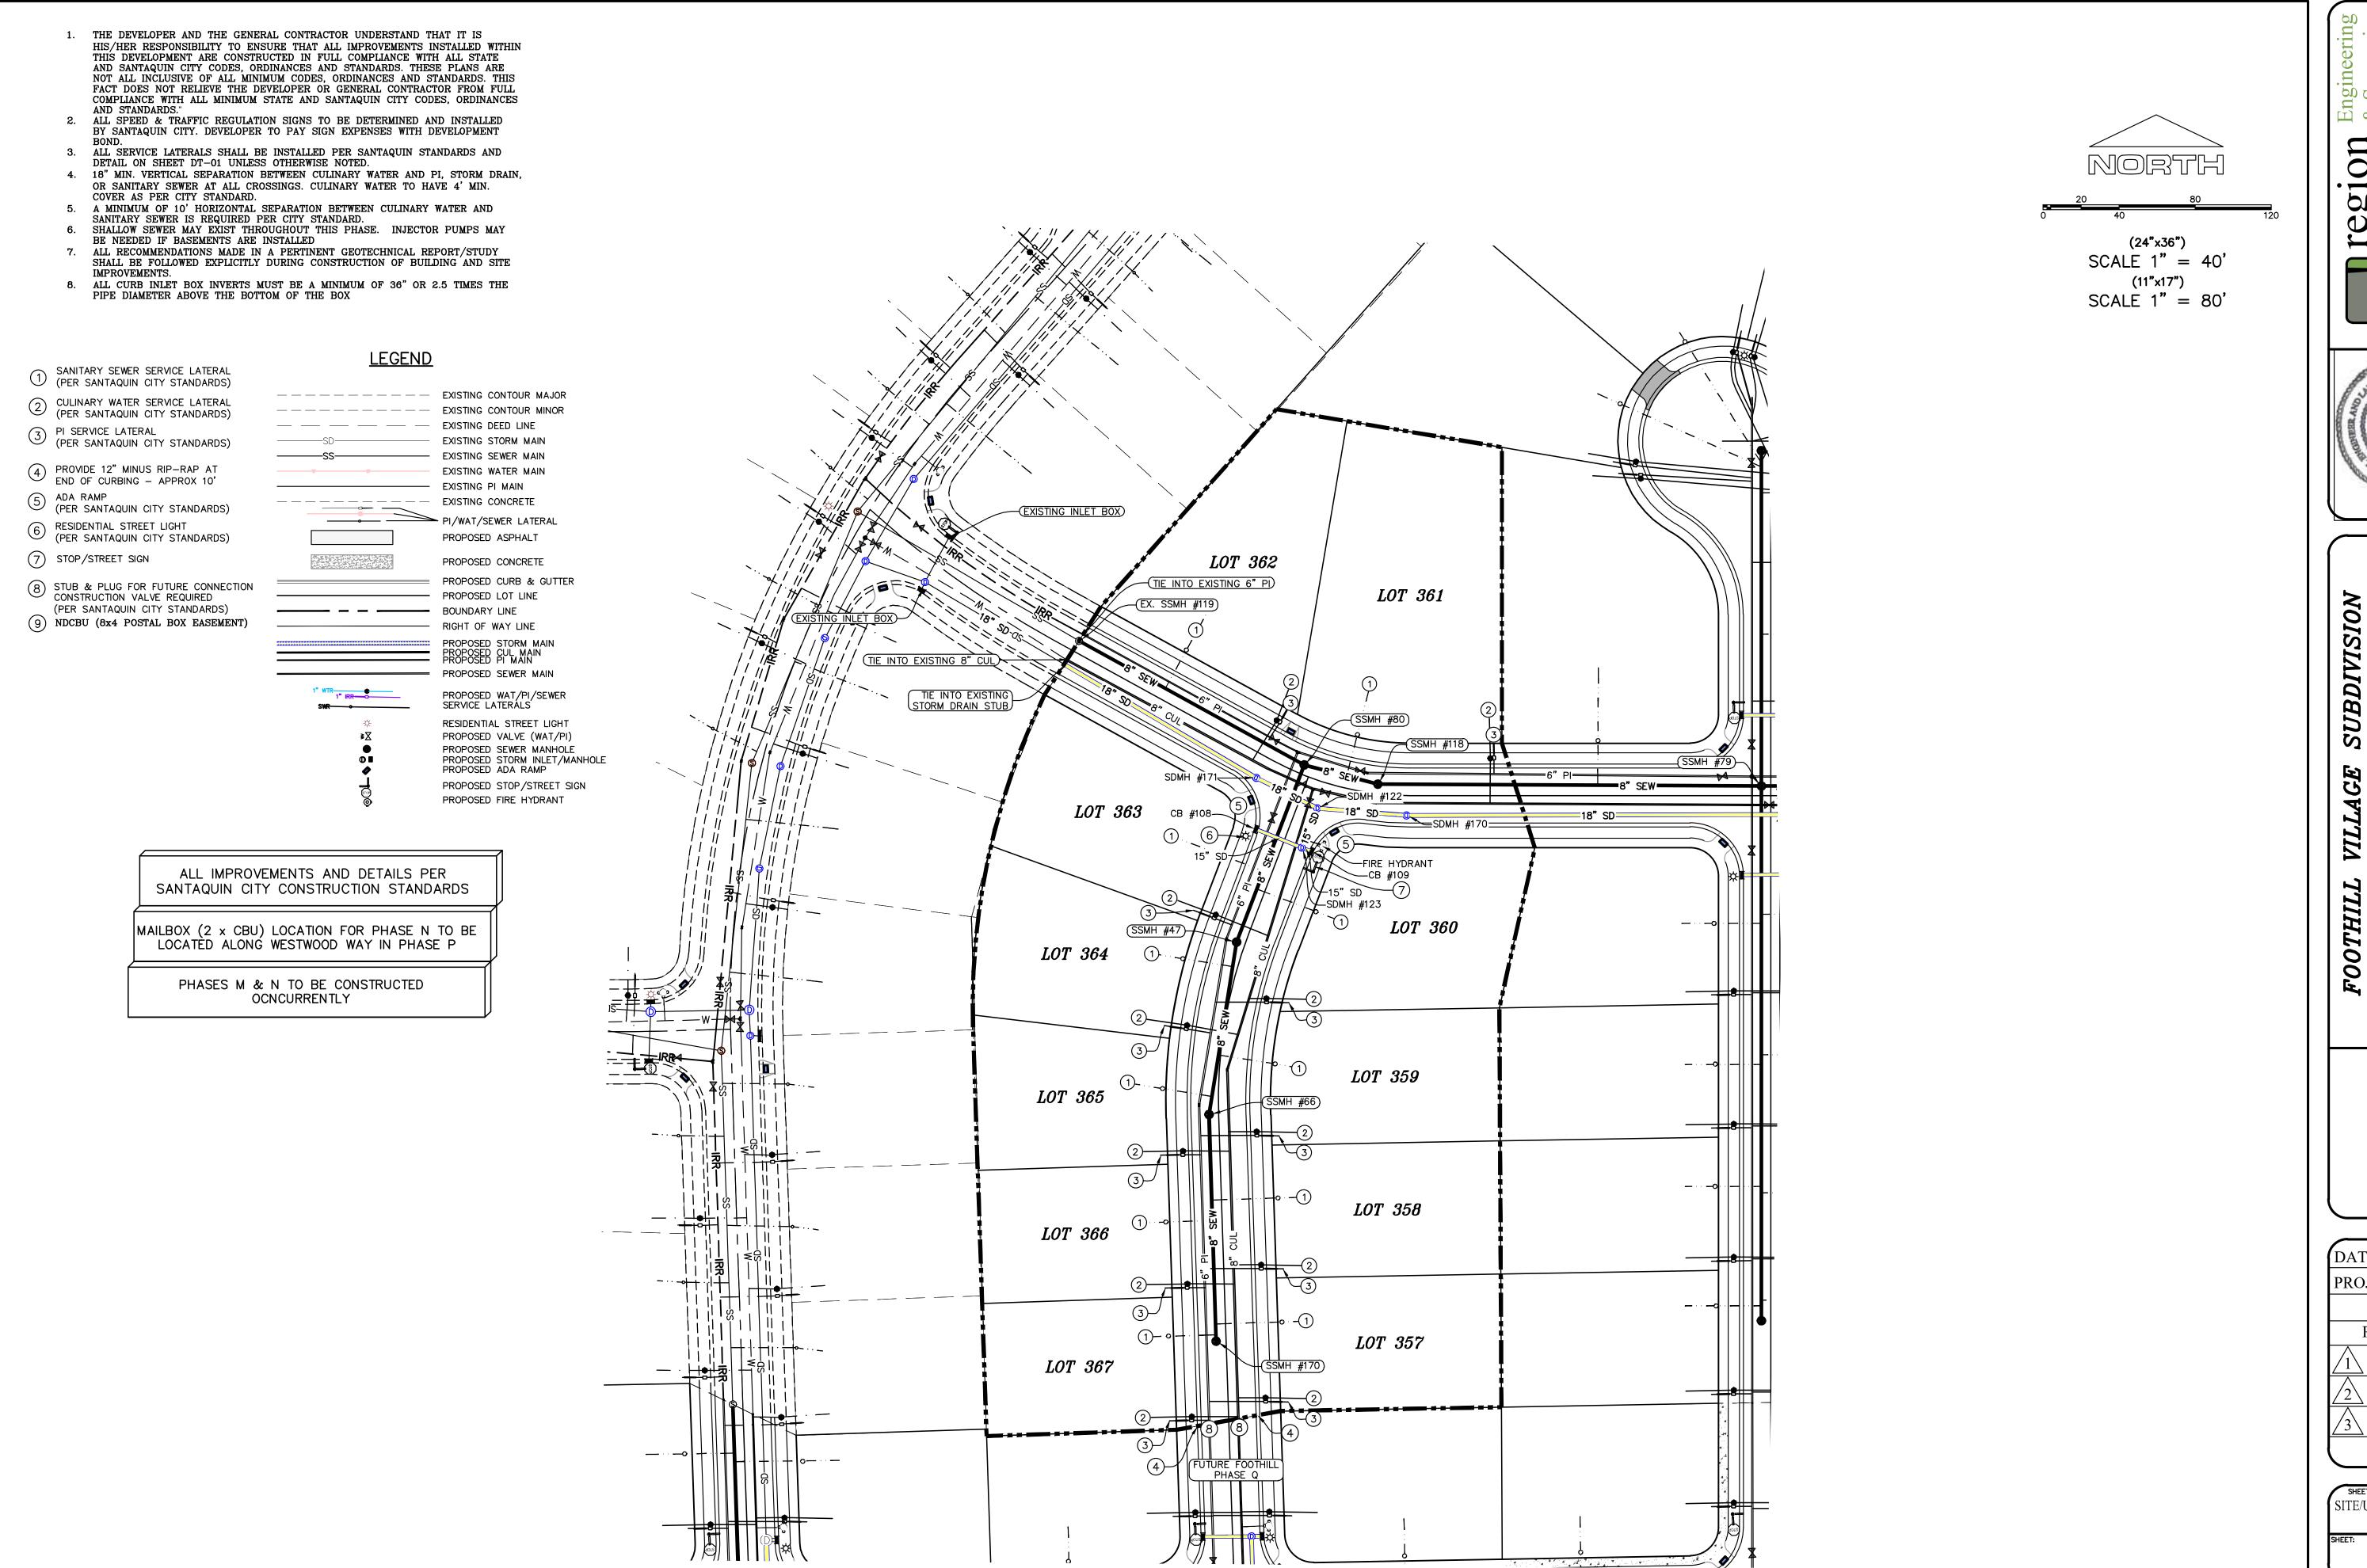
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PRO.	PROJECT #				
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2					
3					

COVER SHEET & NOTES

CS-01

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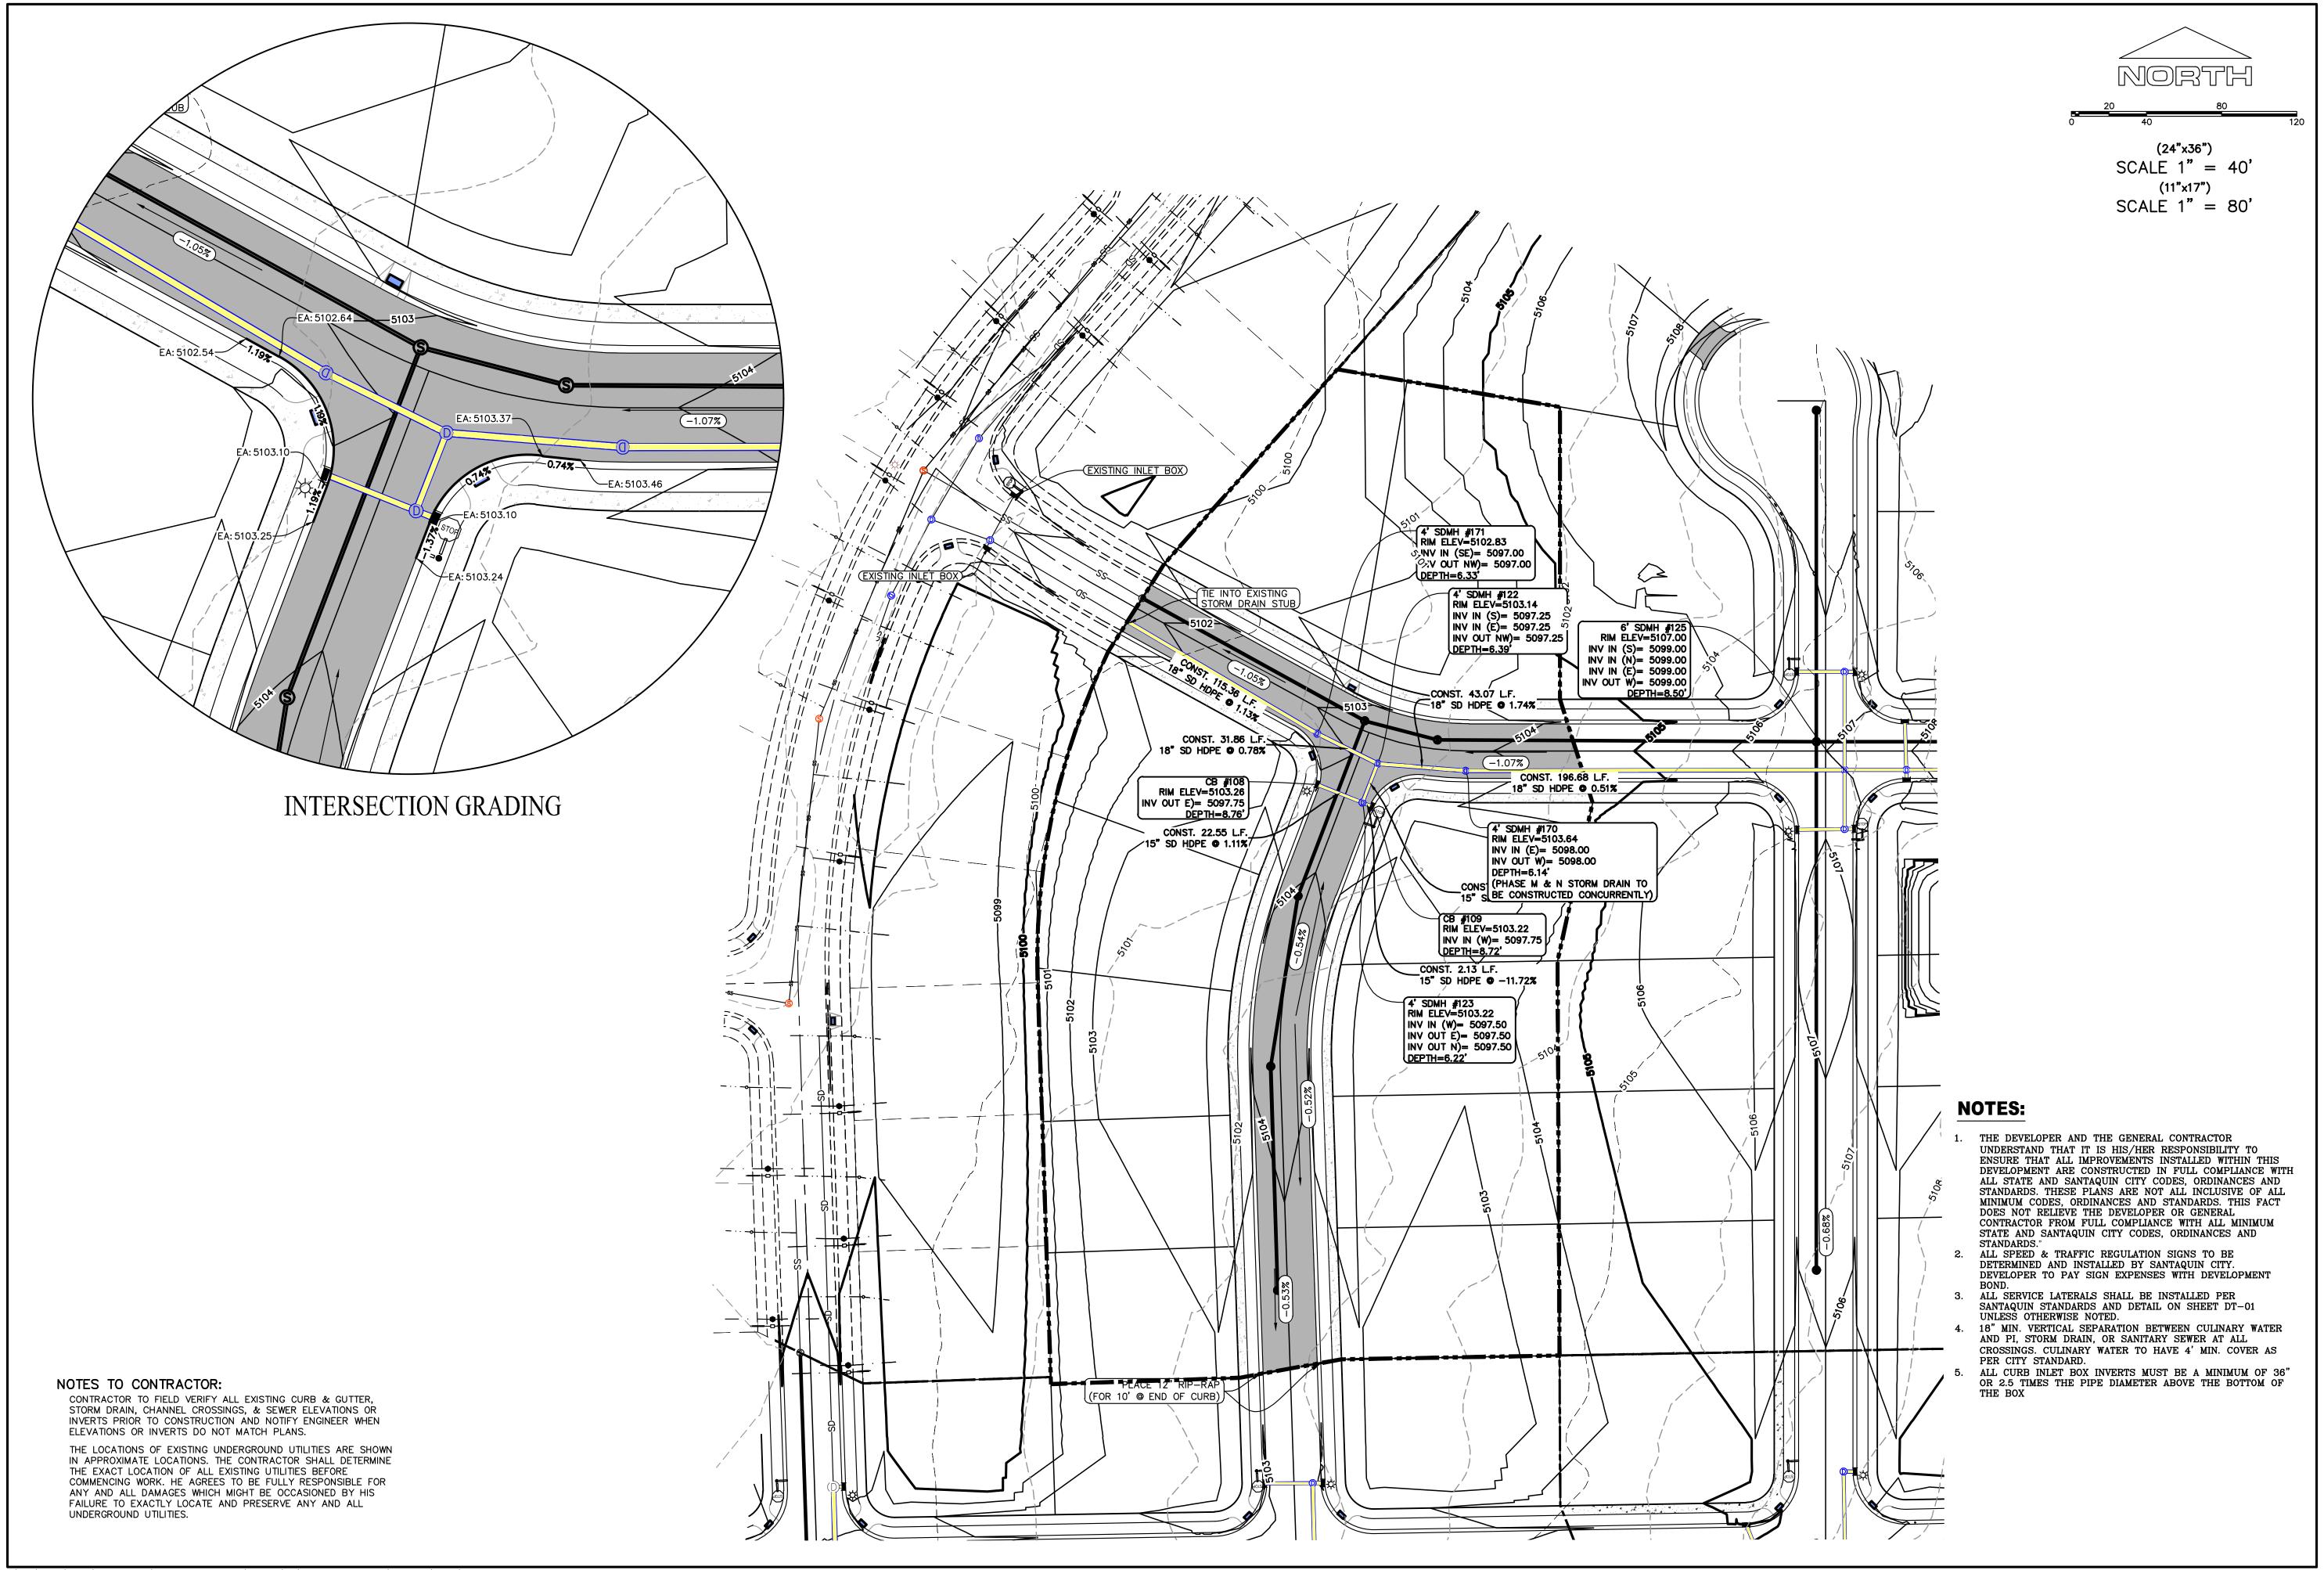


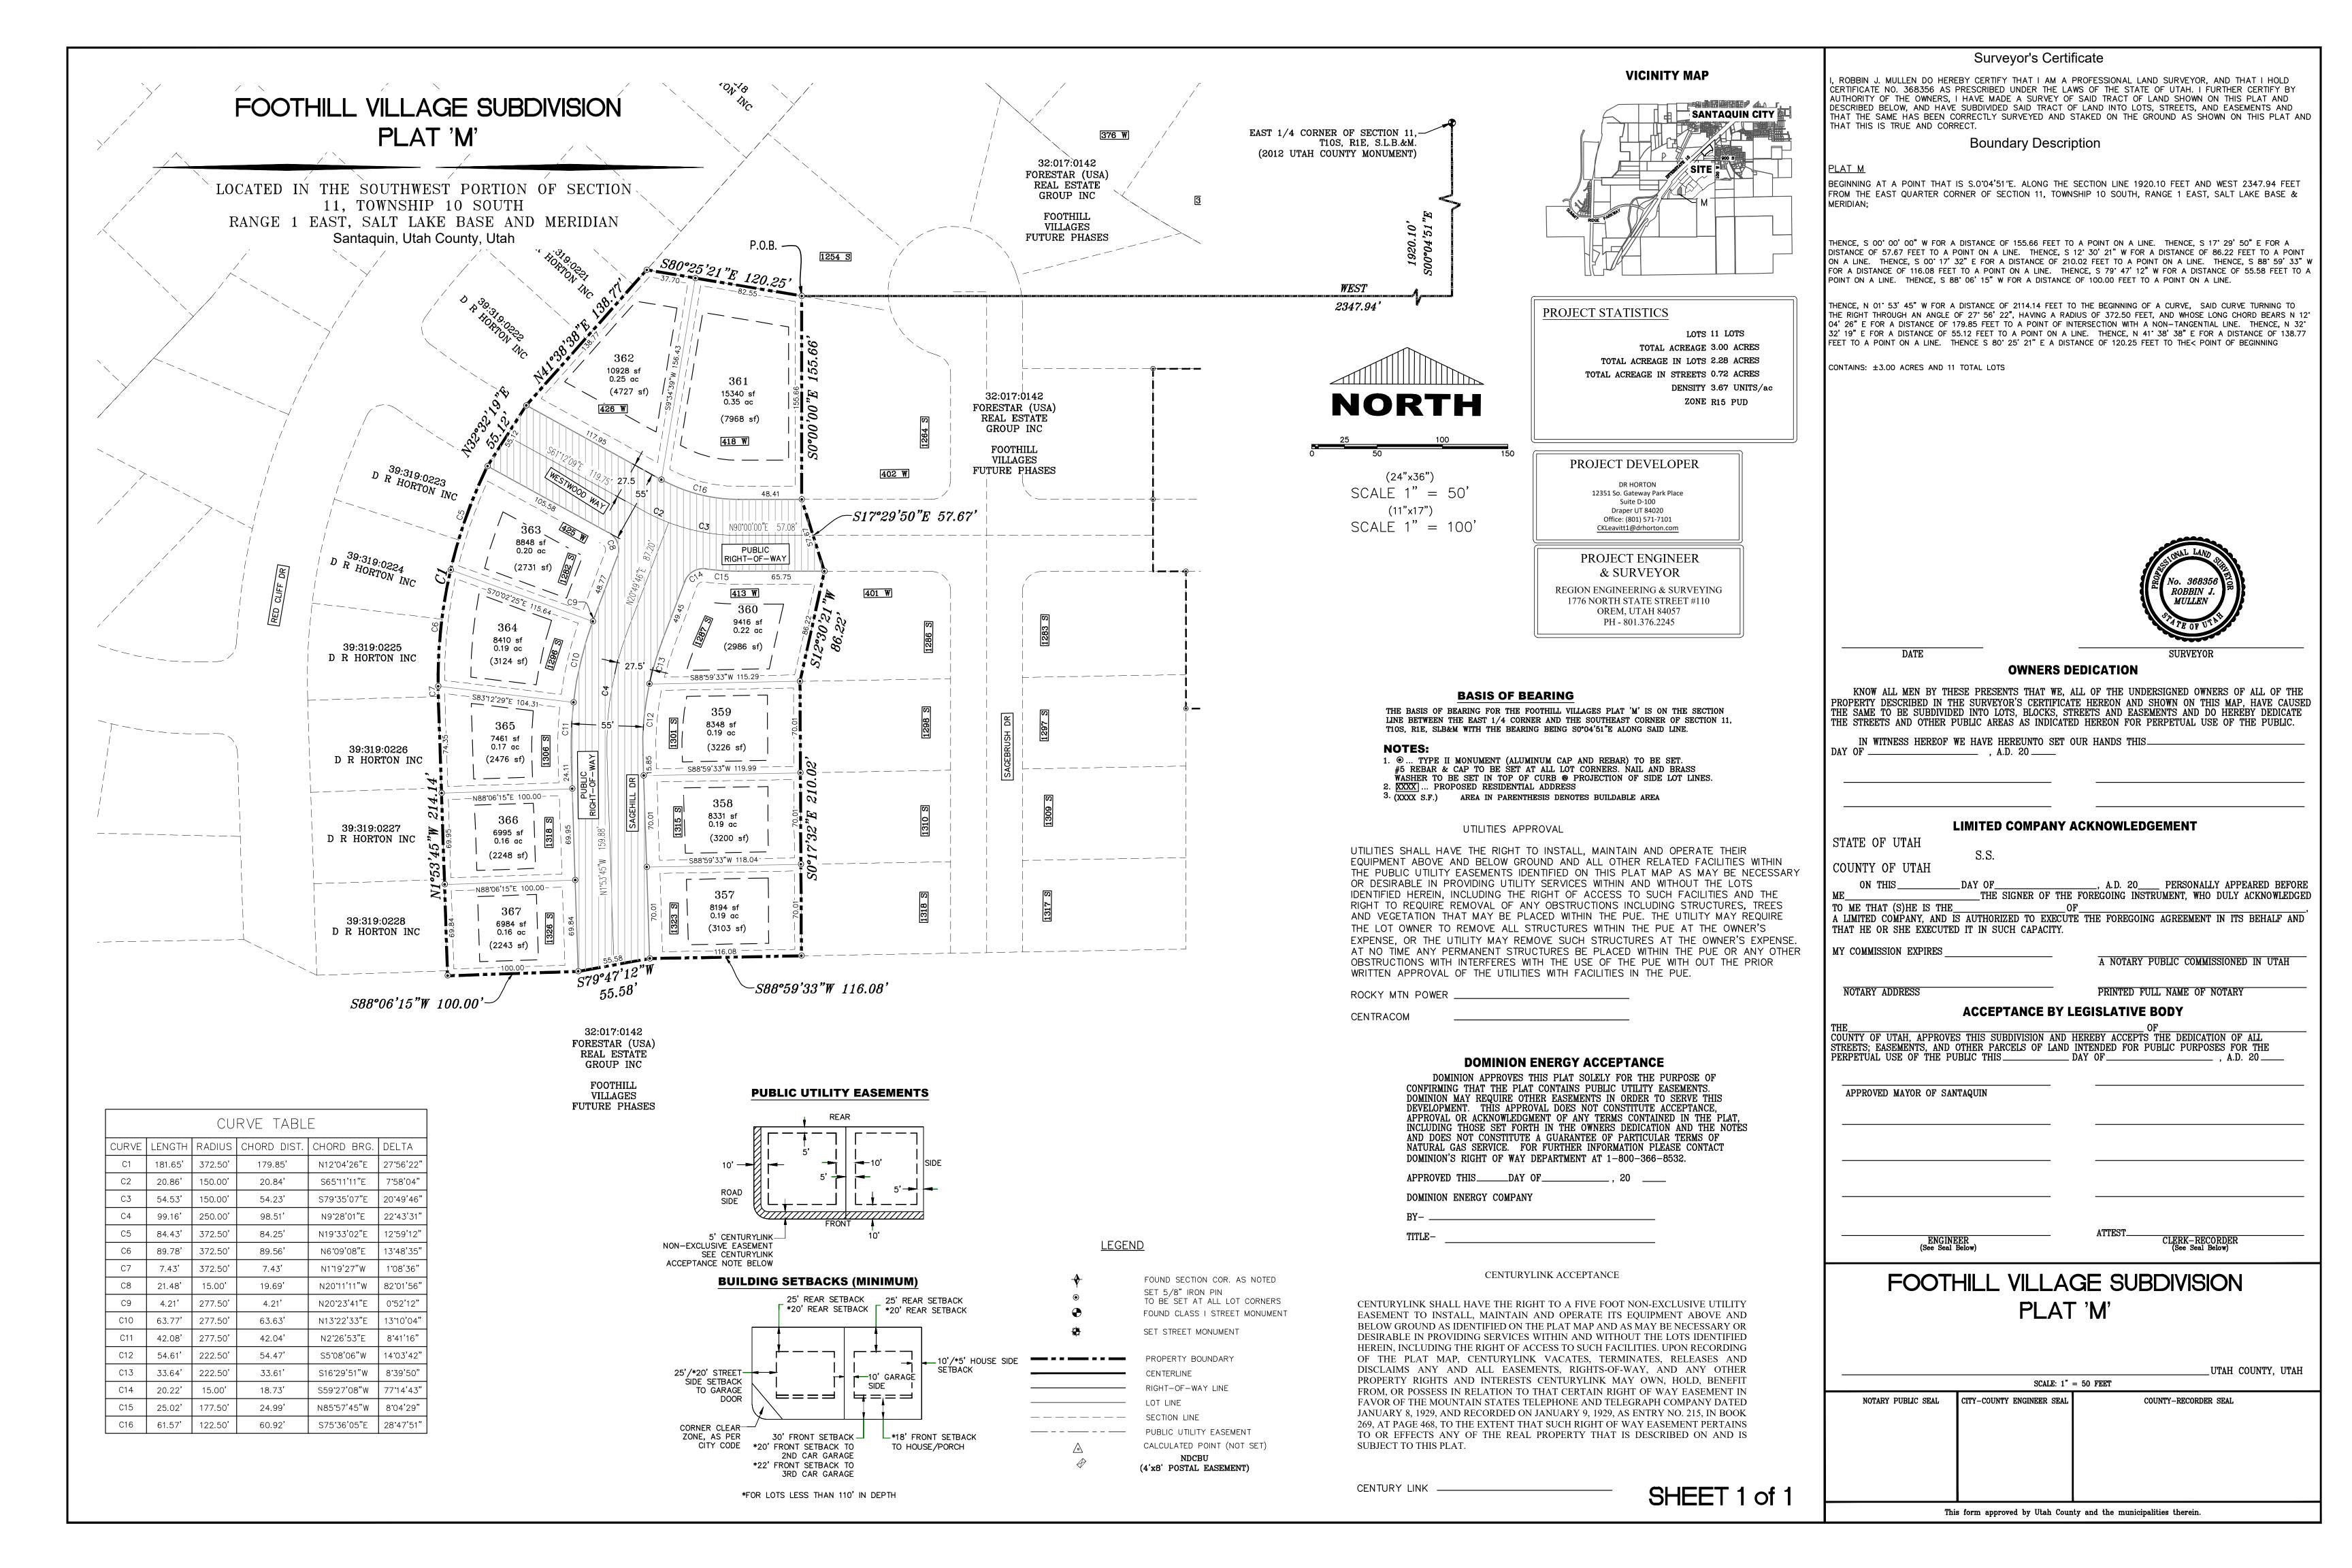

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DATE:2.12.2021 PROJECT # **REVISIONS:**

SITE/UTILITY PLAN SP-01








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DATE:2.12.2021 PROJECT # **REVISIONS:**

SHEET NAME: GRADING PLAN

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LOIN Engineering & Surveying N. State St. #110 rem, UT 84057 801.376.2245





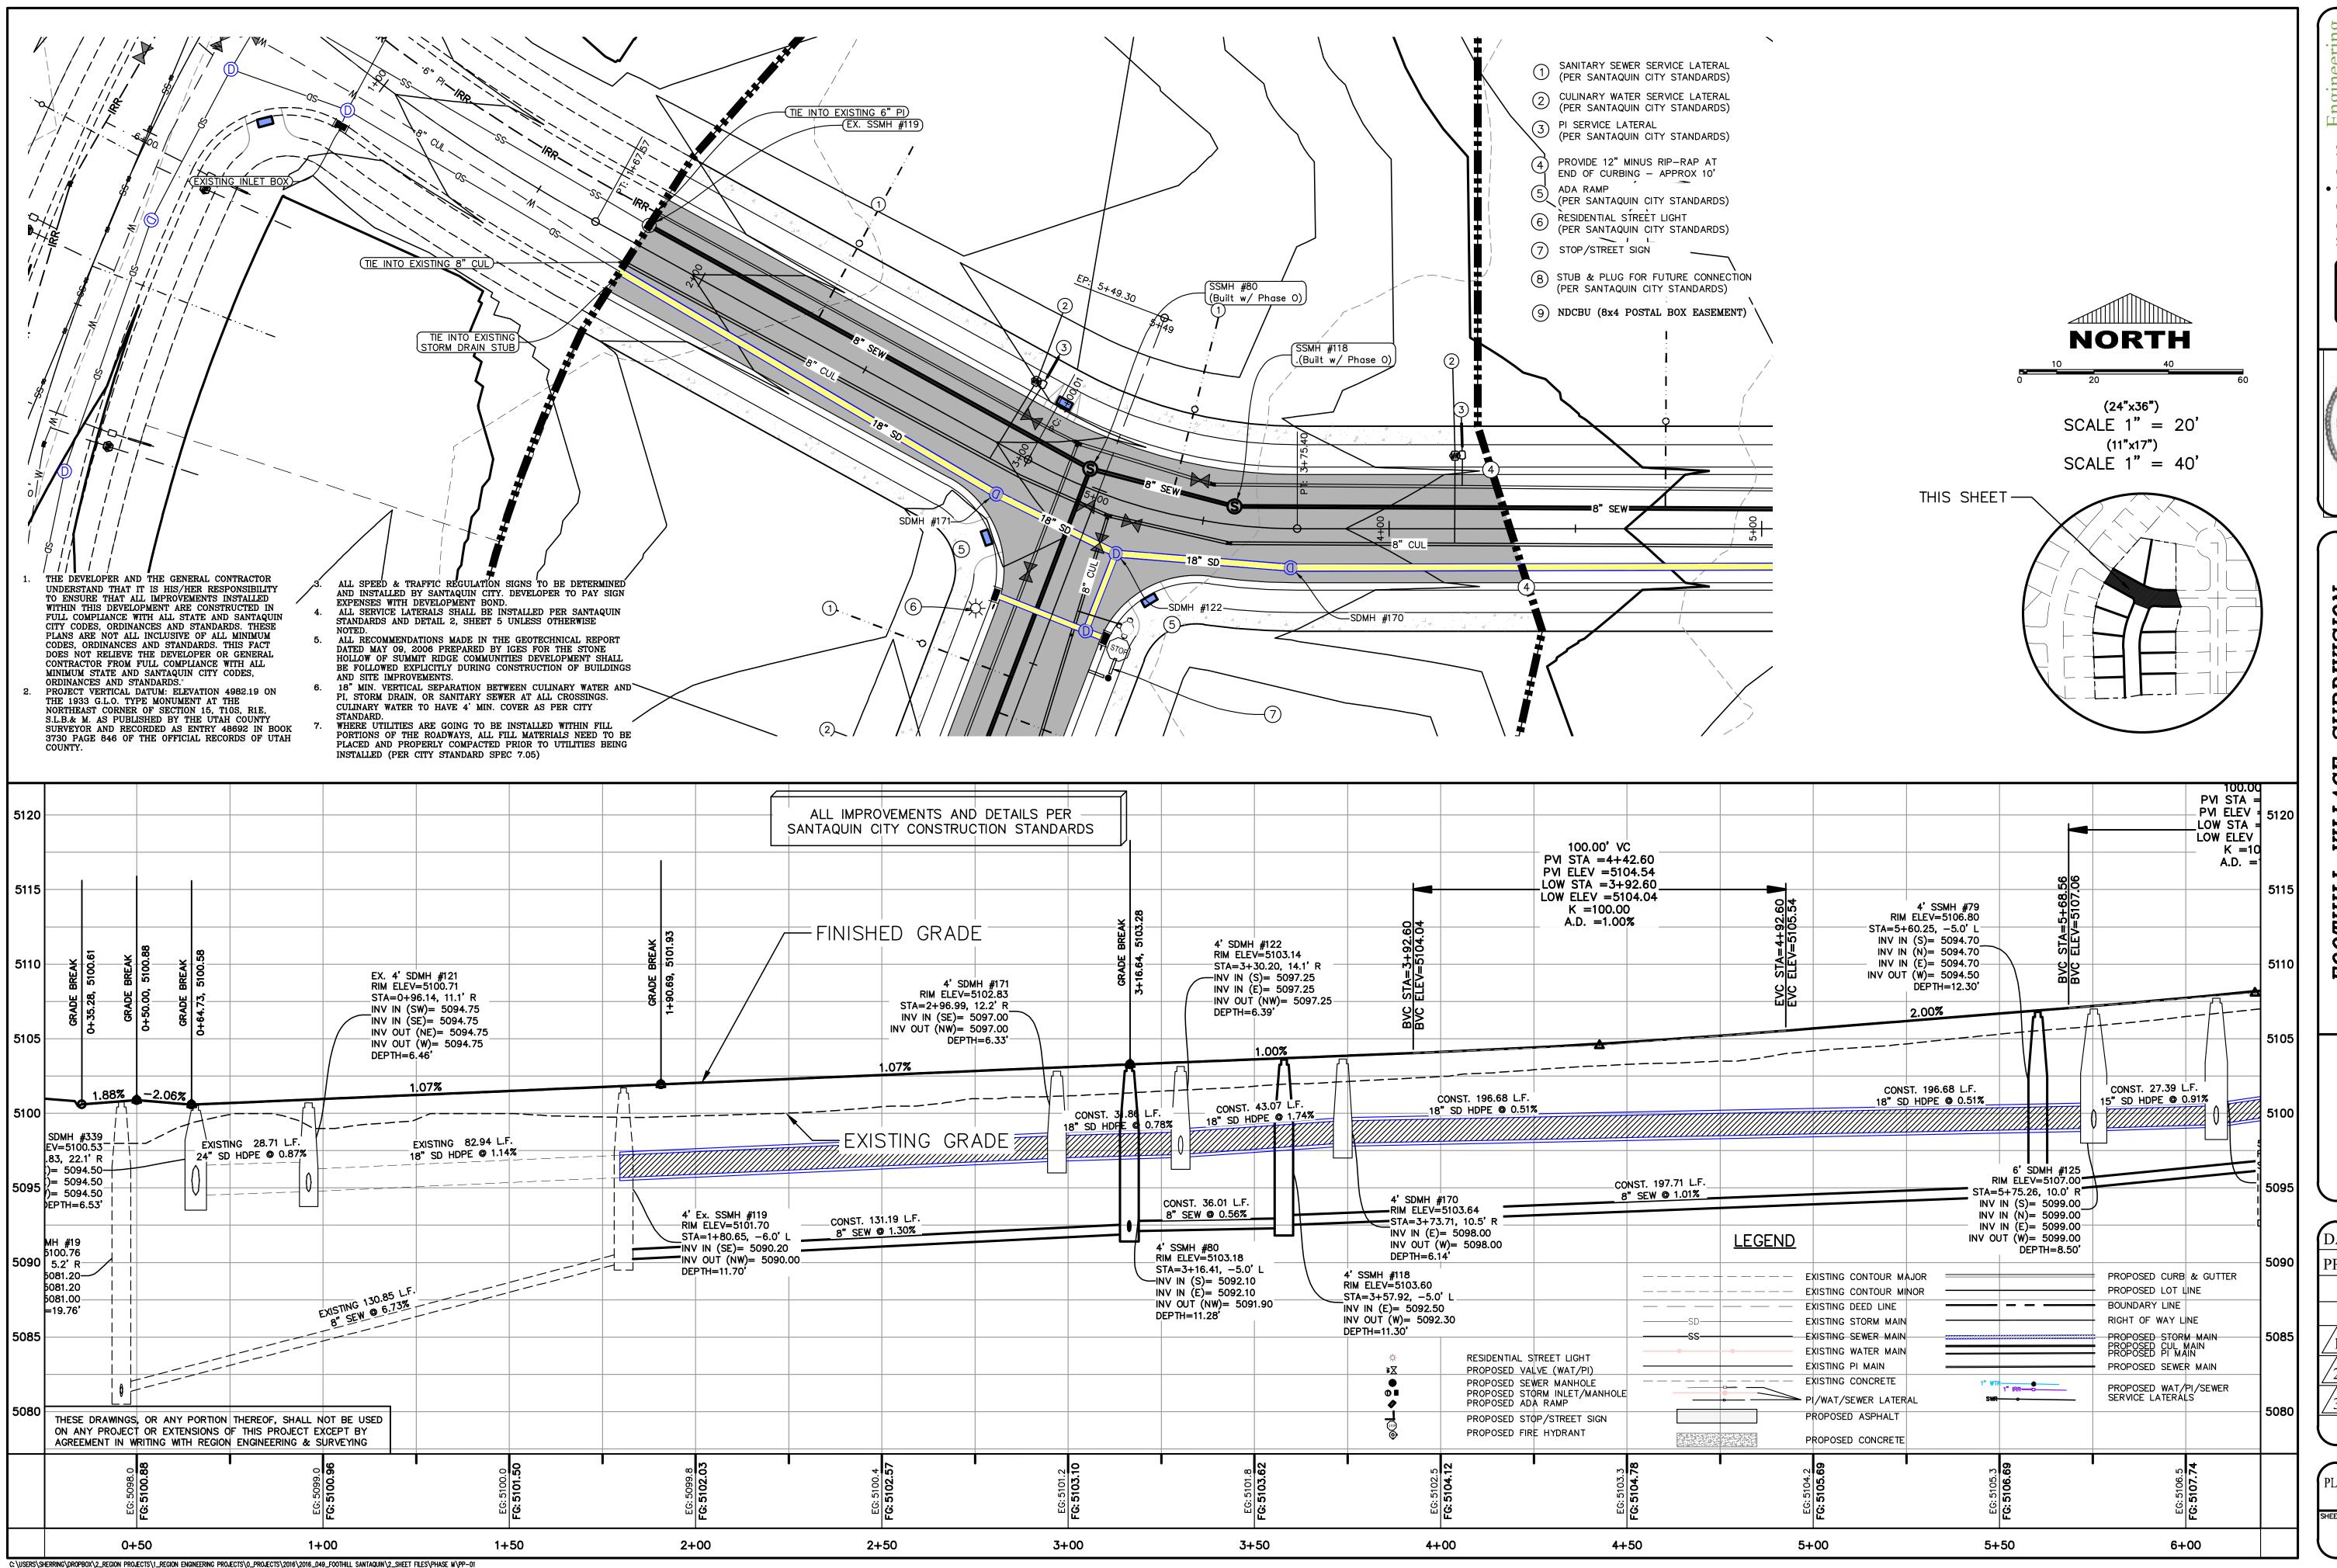

FOOTHILL VILLAGE SUBDIVISION
PLAT 'M'

LOCATED IN THE SOUTHWEST CORNER OF SECTION
11, TOWNSHIP 10 SOUTH

RANGE 1 EAST, SALT LAKE BASE AND MERIDIAN

DATE:2.12.2021
PROJECT #


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SHEET NAME:
PLAN & PROFILE

SHEET:

PP-01



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DATE:2.12.2021 PROJECT # **REVISIONS:**

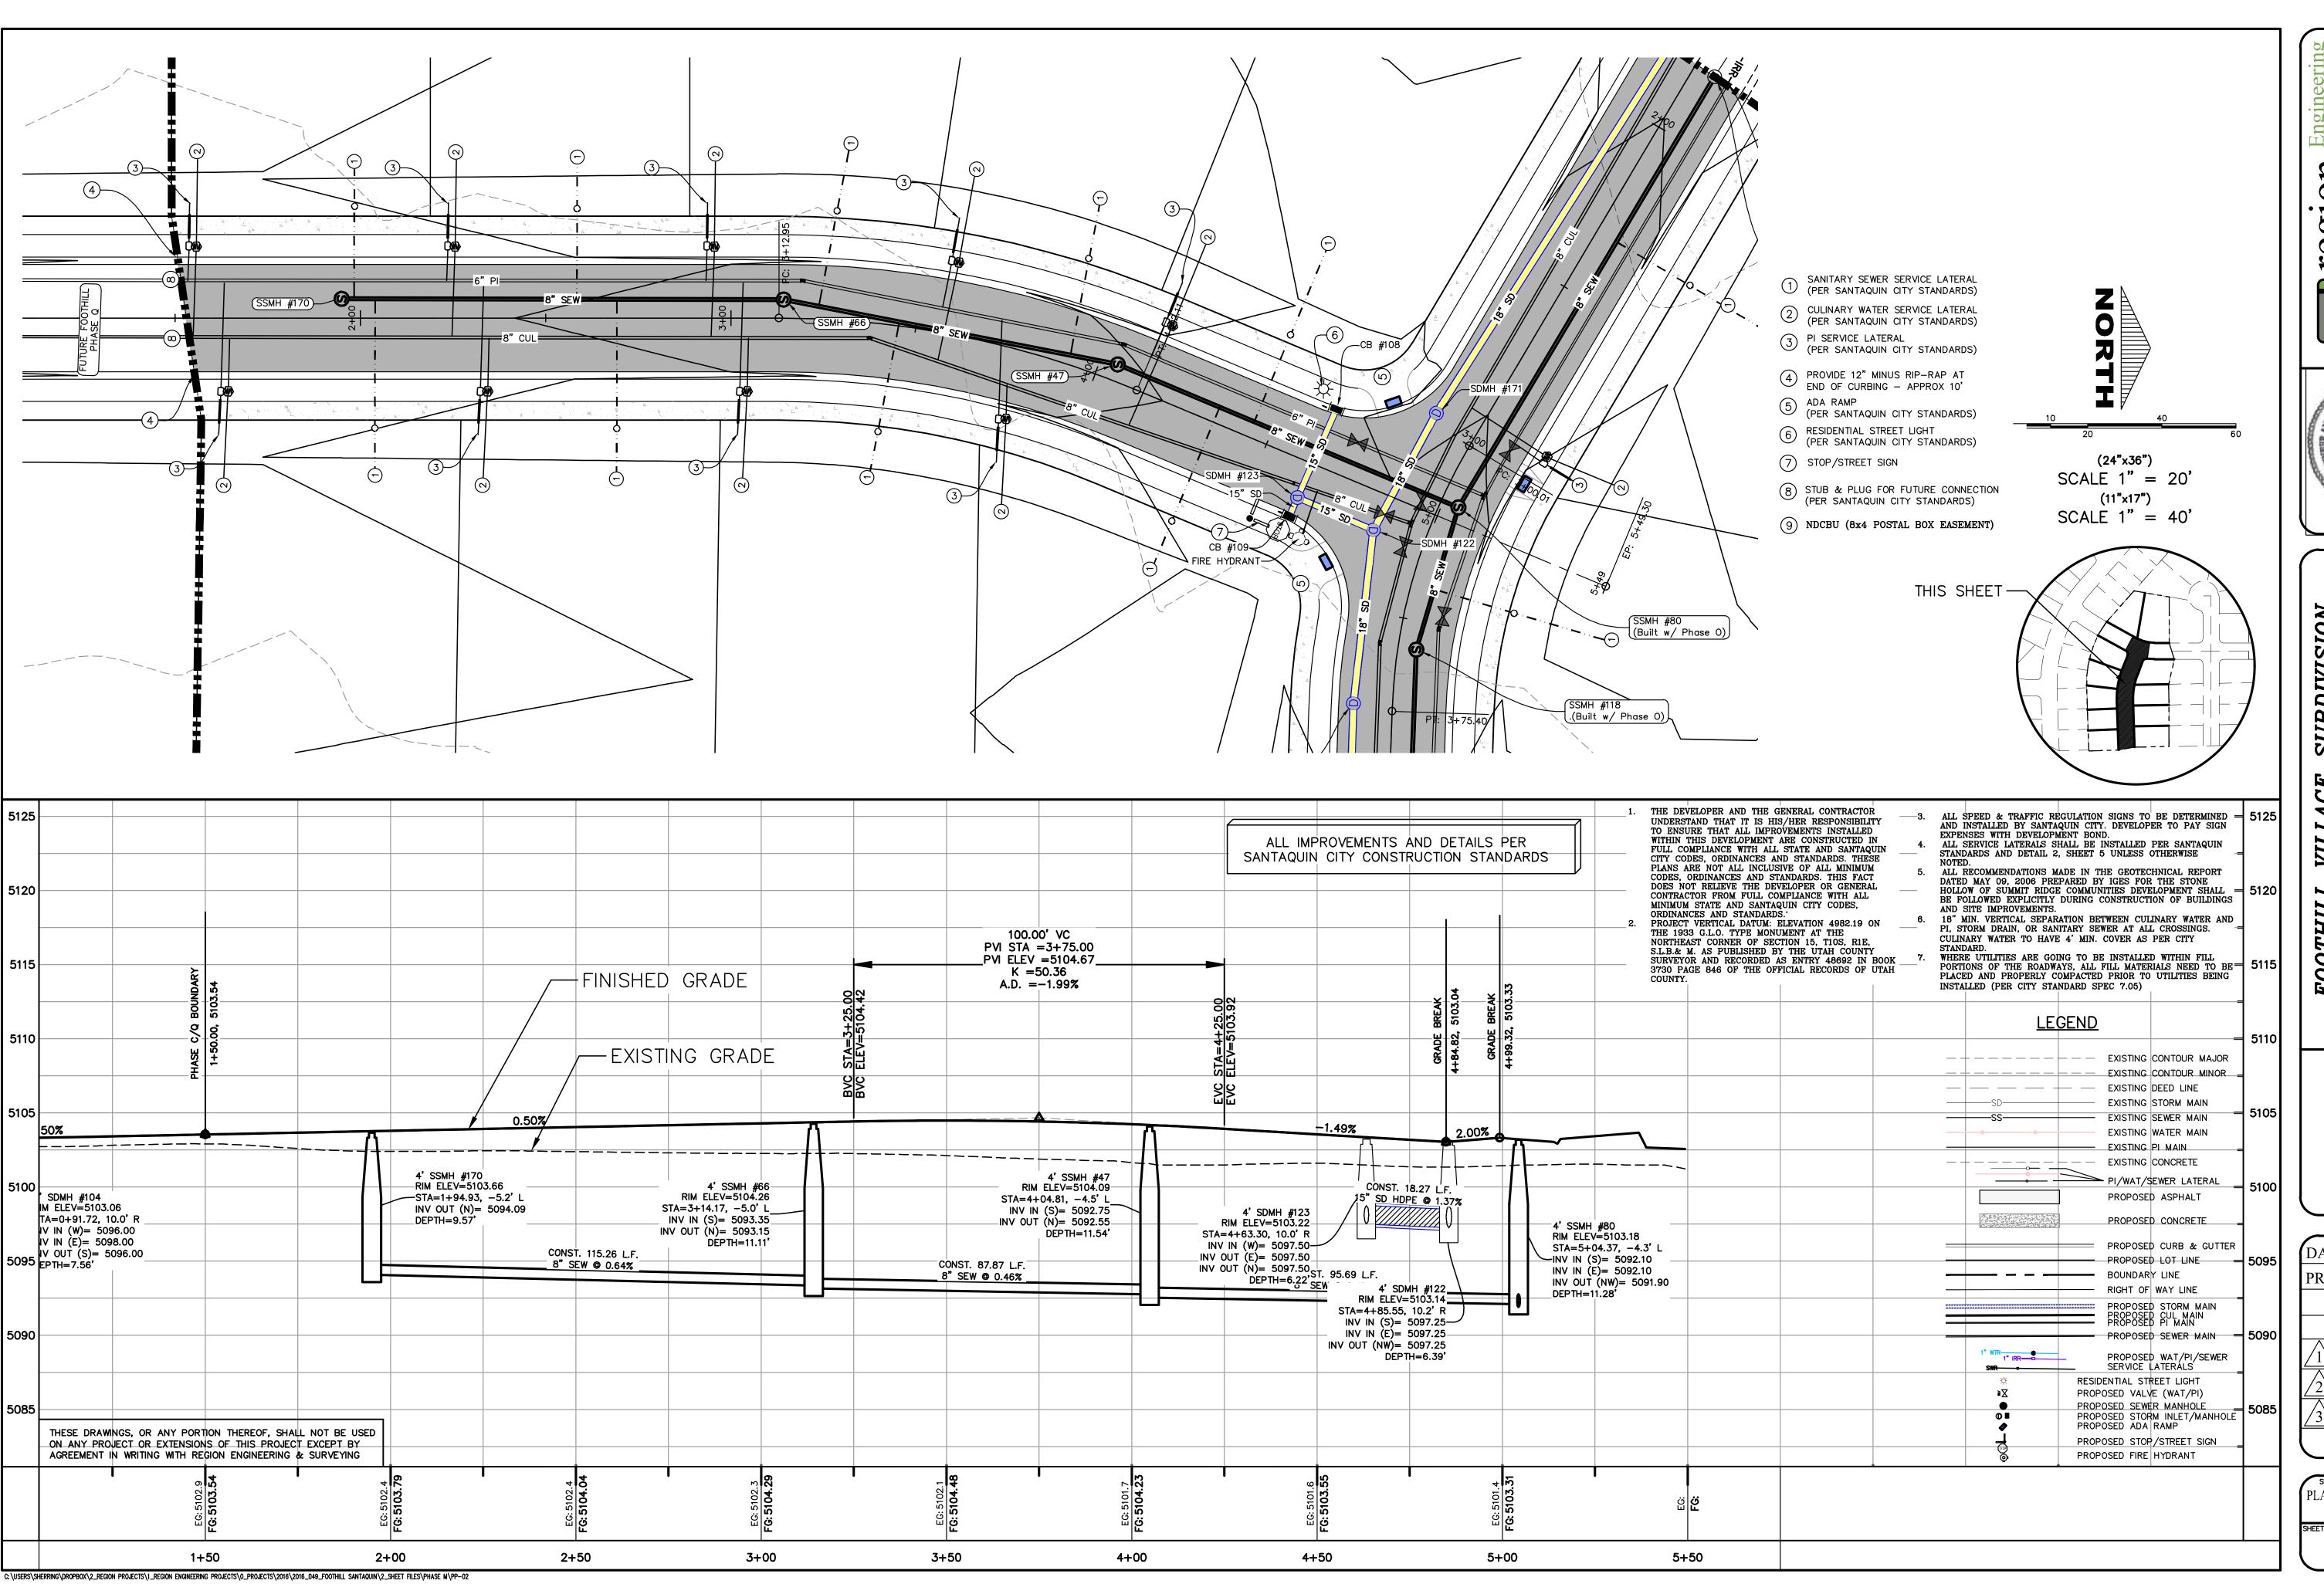PLAN & PROFILE PP-02 PROPOSED SILT FENCE (SEE SHEET EC-02)

FLOW ARROW

PROPOSED VEHICLE TRACKING CONTROL

(SEE SHEET EC-02)

PROPOSED CURB INLET PROTECTION (SEE SHEET EC-02)

PORTABLE TOILETS

NOTES:

- 1. IN THE EVENT THAT ANY UNFORESEEN CONDITIONS NOT COVERED BY THESE NOTES ARE ENCOUNTERED DURING GRADING OPERATIONS, THE OWNER/ENGINEER IS TO BE IMMEDIATELY
- NOTIFIED FOR DIRECTION. 2. IT IS THE RESPONSIBILITY OF THE CONTRACTOR TO PERFORM ALL NECESSARY CUTS AND FILLS WITHIN THE LIMITS OF THIS PROJECT AND THE RELATED OFF-SITE WORK, SO AS TO GENERATE THE DESIRED SUBGRADE, FINISH GRADES AND SLOPES SHOWN.
- 3. CONTRACTOR IS TO TAKE FULL RESPONSIBILITY FOR ALL EXCAVATION. ADEQUATE SHORING IS TO BE DESIGNED AND PROVIDED BY THE CONTRACTOR TO PREVENT UNDERMINING OF ANY ADJACENT FEATURES OR FACILITIES AND/OR CAVING OF THE
- 4. THE CONTRACTOR IS WARNED THAT AN EARTHWORK BALANCE WAS NOT NECESSARILY THE INTENT OF THIS PROJECT. ANY ADDITIONAL MATERIAL REQUIRED OR LEFTOVER MATERIAL FOLLOWING EARTHWORK OPERATIONS BECOMES THE RESPONSIBILITY OF THE CONTRACTOR
- 5. THE GRADING CONTRACTOR IS RESPONSIBLE TO COORDINATE WITH THE OWNER TO PROVIDE FOR THE REQUIREMENTS OF THE PROJECT STORM WATER POLLUTION PREVENTION PLAN (SWPPP)
- AND ASSOCIATED PERMIT. 6. ALL CUT AND FILL SLOPES ARE TO BE PROTECTED UNTIL
- EFFECTIVE EROSION CONTROL HAS BEEN ESTABLISHED. 7. THE USE OF POTABLE WATER WITHOUT A SPECIAL PERMIT FOR BUILDING OR CONSTRUCTION PURPOSED INCLUDING CONSOLIDATION OF BACKFILL OR DUST CONTROL IS PROHIBITED. THE CONTRACTOR
- IS TO OBTAIN ALL NECESSARY PERMITS FOR CONSTRUCTION WATER. 8. THE CONTRACTOR IS TO MAINTAIN THE STREETS, SIDEWALKS, AND ALL OTHER PUBLIC RIGHT-OF-WAY IN A CLEAN, SAFE AND USABLE CONDITION. ALL SPILLS OF SOIL, ROCK OR CONSTRUCTION DEBRIS IS TO BE PROMPTLY REMOVED FROM THE PUBLICLY OWNED PROPERTY DURING CONSTRUCTION AND UPON COMPLETION OF THE PROJECT. ALL ADJACENT PROPERTY, PRIVATE OR PUBLIC IS TO BE
- MAINTAINED IN A CLEAN, SAFE AND USABLE CONDITION. 9. IN THE EVENT THAT ANY TEMPORARY CONSTRUCTION ITEM IS REQUIRED THAT IS NOT SHOWN ON THESE DRAWINGS, THE OWNER AGREES TO PROVIDE AND INSTALL SUCH ITEM AT HIS OWN EXPENSE AND AT THE DIRECTION OF THE ENGINEERING DEPARTMENT. TEMPORARY CONSTRUCTION INCLUDES DITCHES. BERMS, ROAD SIGNS AND BARRICADES, ETC.

PROJECT INFORMATION SIGN

AND MAINTAIN A PROJECT INFORMATION SIGN IN ACCORDANCE WITH THE FOLLOWING REQUIREMENTS:

- 1. THE SIGN SHALL BE INSTALLED PRIOR TO BEGINNING ACTUAL CONSTRUCTION ACTIVITIES OR INITIATING ANY TYPE OF EARTH-MOVING OPERATIONS.
- 2. THE SIGN SHALL BE INSTALLED AT A PROMINENT LOCATION ON THE PROPERTY NEAR THE MAIN ENTRANCE OF THE CONSTRUCTION SITE. TRAFFIC VISIBILITY SHALL BE MAINTAINED BY PLACING THE SIGN BACK FROM THE MAIN INGRESS/ EGRESS LOCATION AND AT ANY APPLICABLE INTERSECTION FOR
- 3. 3. THE SIGN MAY BE REMOVED ONCE FINAL STABILIZATION HAS BEEN ACHIEVED ON ALL PORTIONS OF THE SITE FOR WHICH THE PERSON IS RESPONSIBLE AND IS APPROVED BY THE CITY.
- 4. THE SIGN SHALL BE A MINIMUM OF 48" x 48" AND THE FOLLOWING INFORMATION SHALL BE DISPLAYED ON THE SIGN WITH THE DESIGNATED ALPHA AND NUMERIC DIMENSIONS. SIGN BOARDS WRITTEN IN LONGHAND ARE UNACCEPTABLE. DEVELOPERS NAME

PROJECT NAME (4" Uppercase Bold Letters) PERMIT NUMBER

(4" Uppercase Bold Letters)

FOR PROJECT SITE CONCERNS CONTACT

Office Phone Contact ###-###-#### Cell Phone Contact ###-###-####

IF NO RESPONSE PLEASE CONTACT CITY OFFICE AT (3" Uppercase Bold Letters and 3" Bold Numbers)

- 5. THE TEXT HEIGHT SHALL BE A MINIMUM AS SHOWN ON THE TEMPLATE ABOVE, AND MUST CONTRAST WITH LETTERING, TYPICALLY BLACK TEXT WITH WHITE BACKGROUND.
- THE LOWER EDGE OF THE SIGN BOARD MUST BE A MINIMUM OF THREE (3) FEET AND A MAXIMUM OF FIVE (5) FEET ABOVE GRADE. SIGN MAY BE POSTED ON A TRAILER OF IT MEETS THESE REQUIREMENTS..



CONSTRUCTION PHASE STORM WATER POLLUTION PROTECTION PLAN BEST MANAGEMENT PRACTICES (BMP)

ВМР#	BMP SYMBOL	TITLE	LOCATION	DURATION
C101	101	PRESERVING NATURAL VEGETATION	PER CONTRACTOR	BEGINNING OF CONSTRUCTION THROUGH COMPLETION OF SITE IMPROVEMENTS
C105	105	STABILIZED CONSTRUCTION ENTRANCE	AS SHOWN	BEGINNING OF CONSTRUCTION THROUGH COMPLETION OF ASPHALT IMPROVEMENTS
C106	106	WHEEL WASH	AS SHOWN	AS NECESSARY
C151	151	CONCRETE WASTE MANAGEMENT	PER CONTRACTOR/ AS SHOWN	BEGINNING OF CONSTRUCTION THROUGH COMPLETION OF SITE IMPROVEMENTS
C190	190	PORTABLE TOILETS	PER CONTRACTOR/ AS SHOWN	BEGINNING OF CONSTRUCTION THROUGH COMPLETION OF SITE IMPROVEMENTS
CSS0	(SSO)	STORM DRAIN INLET PROTECTION	AS SHOWN	COMMENCEMENT OF GRADING THROUGH COMPLETION OF SITE IMPROVEMENTS
C233	233	SILT FENCE	AS SHOWN	COMMENCEMENT OF GRADING THROUGH COMPLETION OF SITE IMPROVEMENTS
C233	240	SEDIMENT TRAP	AS SHOWN	BEGINING OF CONSTRUCTION TO PLACEMENT OF ASPHALT

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DATE:2.12.2021 PROJECT # **REVISIONS:**


EROSION CONTROL PLA EC-01


C: \USERS\SHERRING\DROPBOX\2_REGION PROJECTS\1_REGION ENGINEERING PROJECTS\0_PROJECTS\2016\2016_049_FOOTHILL SANTAQUIN\2_SHEET FILES\PHASE M\EC-01

(24"x36")

SCALE 1" = 60'

SCALE 1" = 120

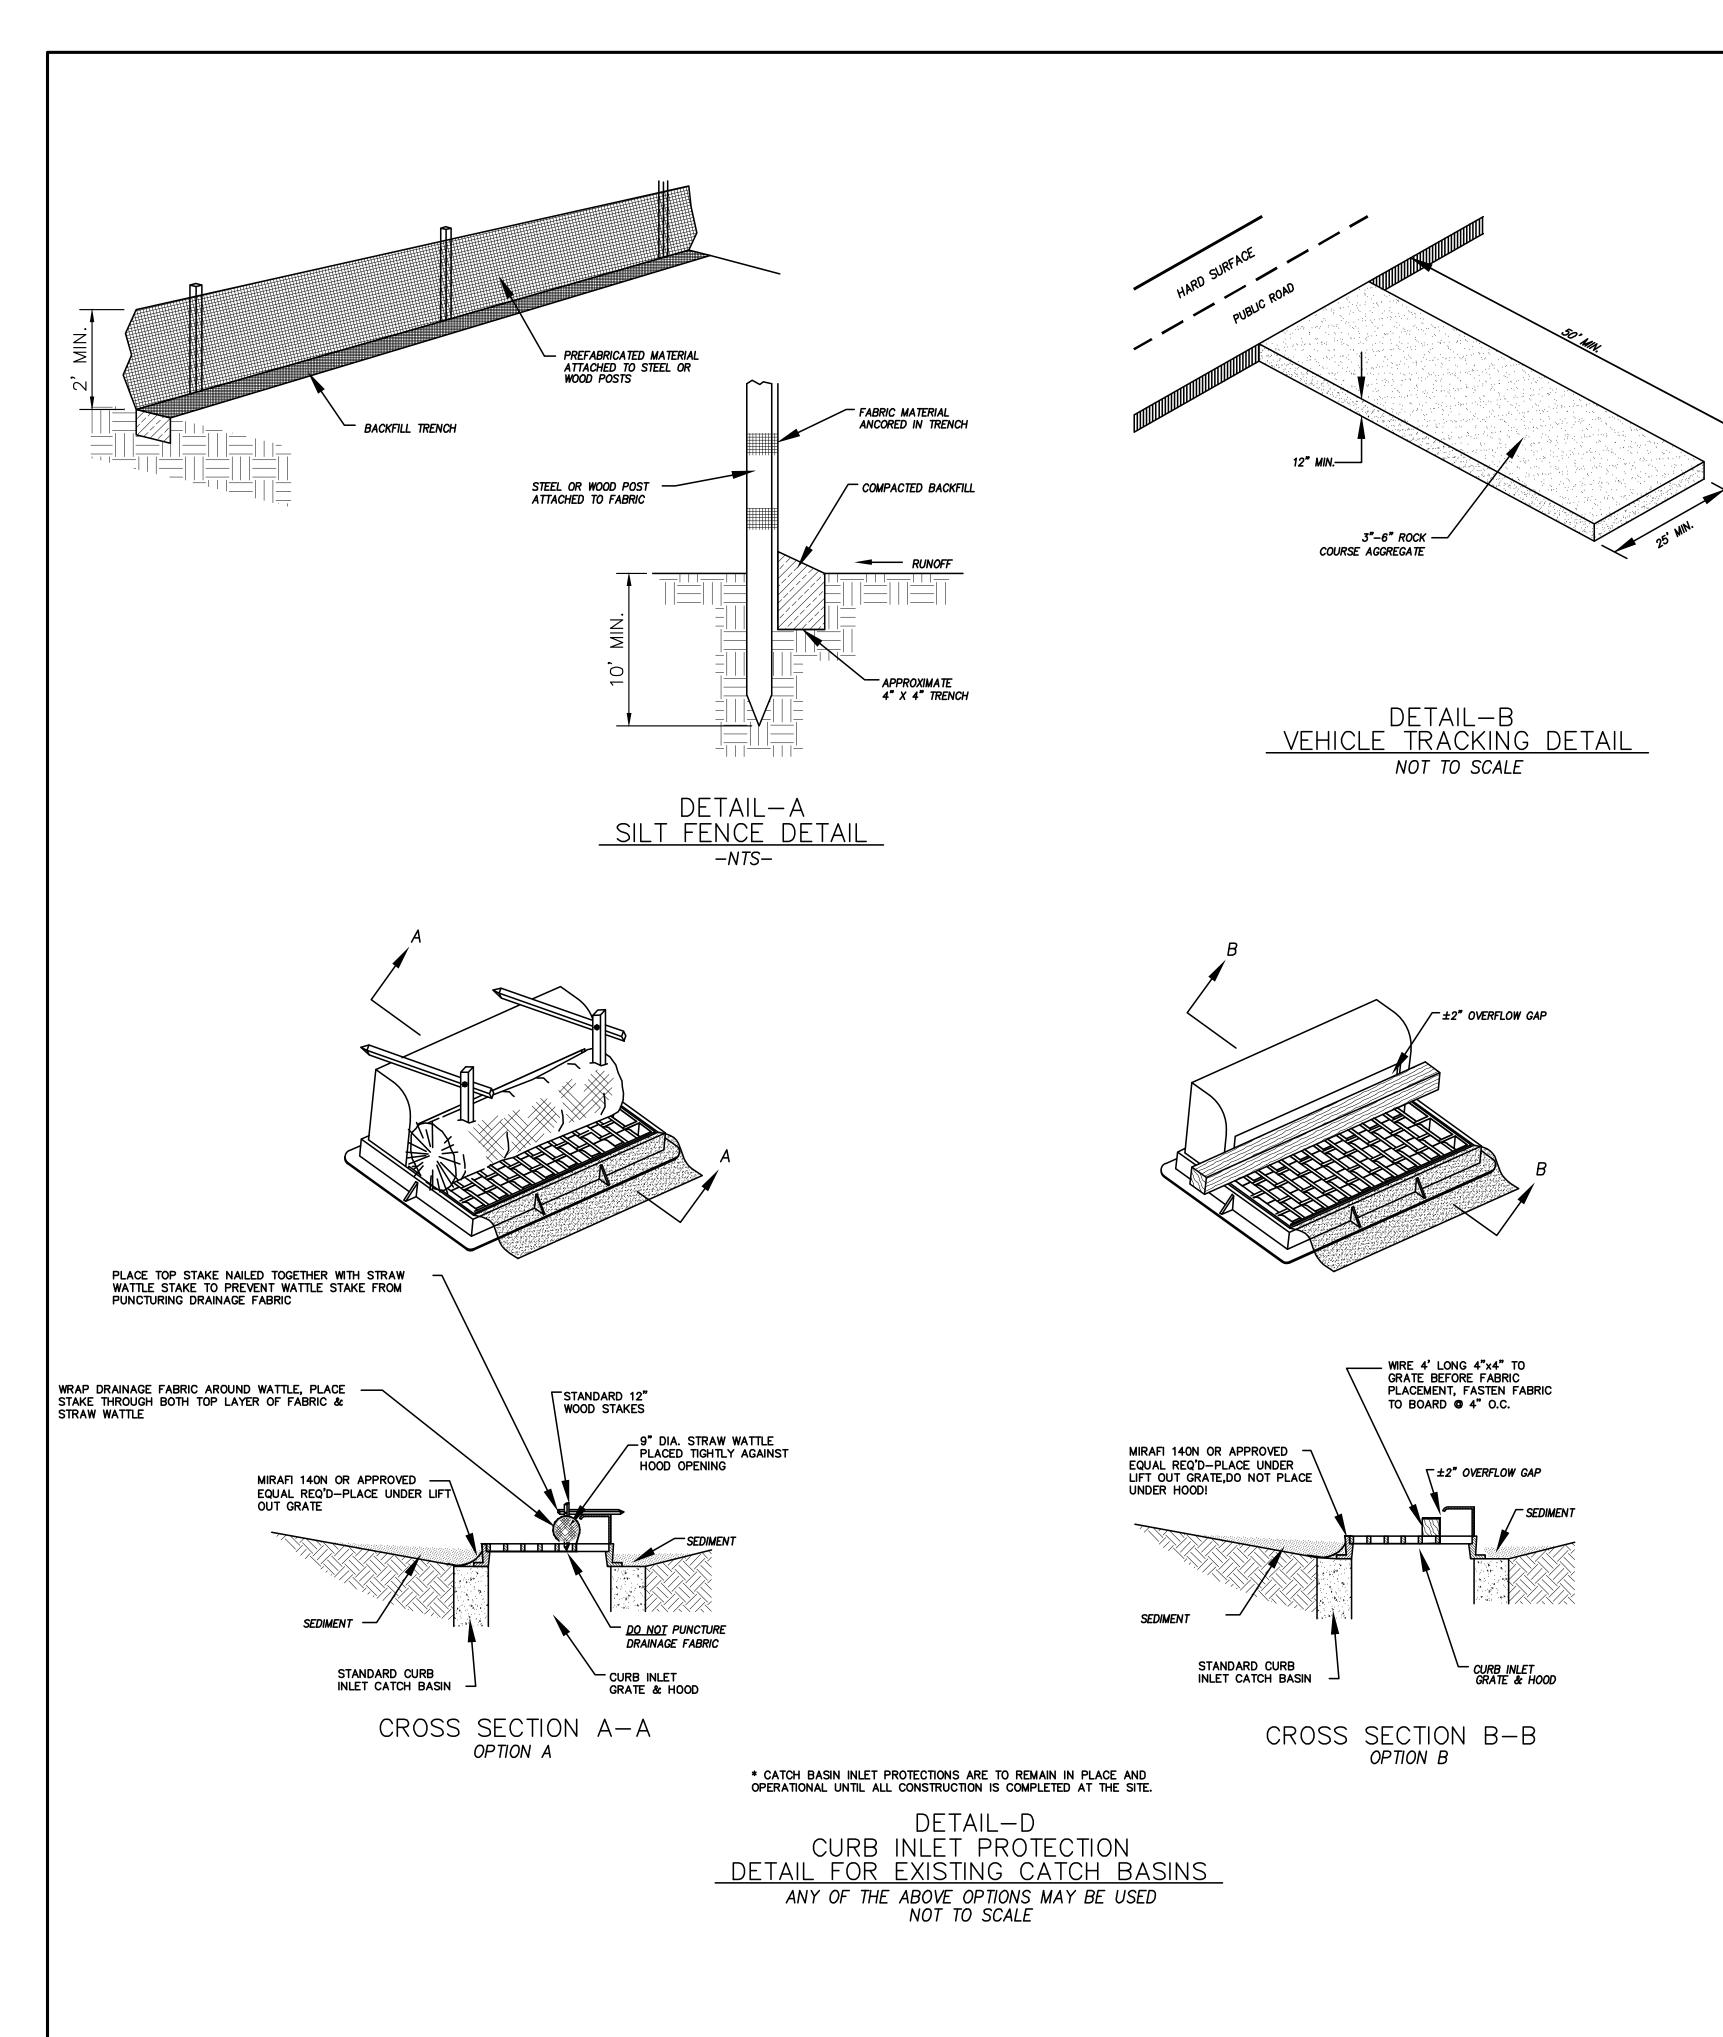

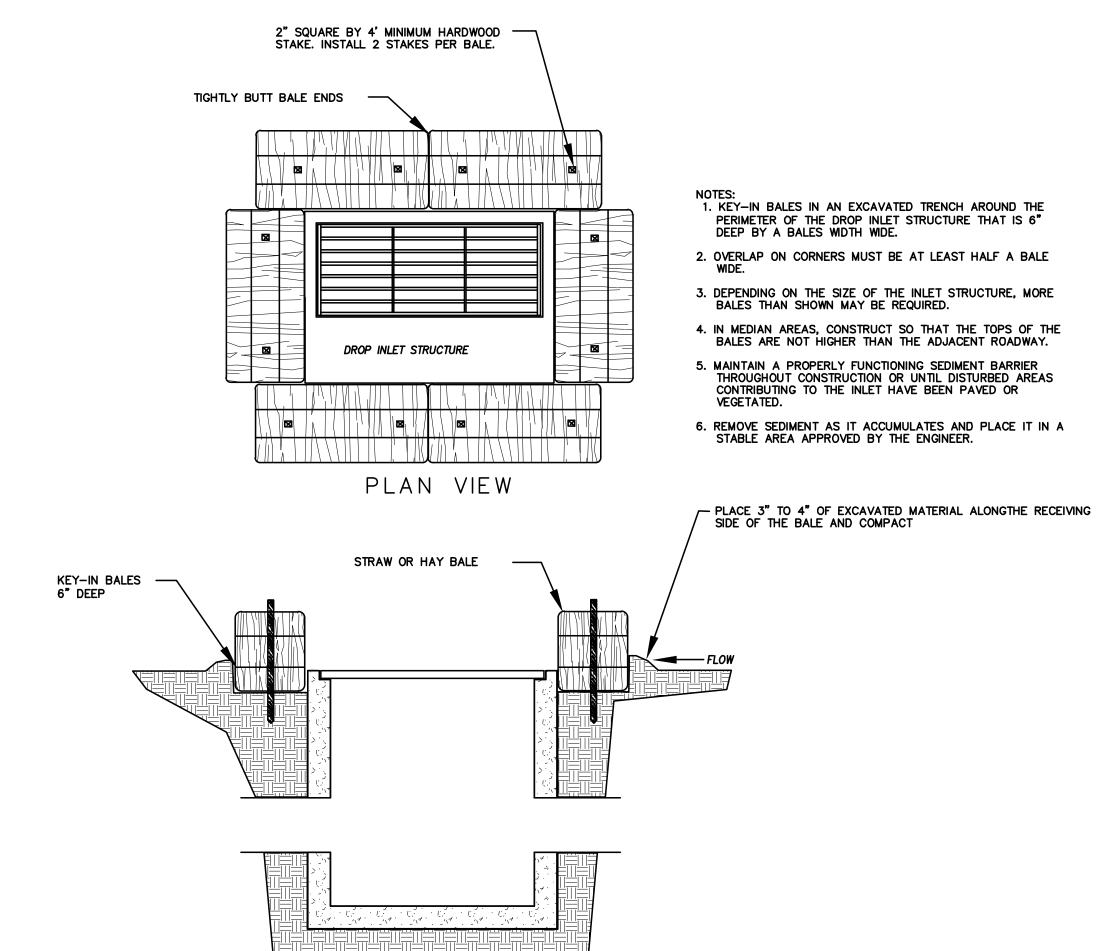

DETAIL-C STRAW BALE DROP INLET PROTECTION DETAIL

EROSION CONTROL NOTES


- 1. CONTROLLING SEDIMENT TRANSPORT AND PREVENTING AND/OR CORRECTING PROBLEMS ASSOCIATED WITH EROSION AND RUNOFF PROCESSES THAT COULD OCCUR BOTH DURING AND AFTER PROJECT CONSTRUCTION WILL BE CLOSELY MONITORED. PERIODIC MAINTENANCE AND INSPECTION OF SEDIMENT CONTROL DEVICES WILL BE SCHEDULED. PARTICULAR ATTENTION SHALL BE GIVEN TO EXISTING DRAINAGE PATTERNS THAT RUN THROUGH DISTURBED AREAS AND OVER EXTREME SLOPES. THESE PATTERNS WILL BE IDENTIFIED TO ISOLATE PROBLEM AREAS WHERE WATER WILL CONCENTRATE. PROVISIONS SHALL BE MADE TO CHANNEL RUNOFF AWAY FROM NEW OR EXISTING IMPROVEMENTS TO PREVENT UNDERMINING AND GENERAL SITE EROSION. THESE PROVISIONS SHALL BE STABILIZED AND SHALL REMAIN IN PLACE UNTIL THE PERMANENT STORM DRAINAGE FACILITIES ARE INSTALLED AND FUNCTIONAL.
- 2. EROSION CONTROL A STORMWATER POLLUTION PREVENTION PLAN (SWPPP) WILL BE PREPARED IN ACCORDANCE WITH THE UTAH POLLUTANT DISCHARGE ELIMINATION SYSTEM (UPDES) PERMIT FOR CONSTRUCTION, OUTLINING HOW EROSION AND SILTATION WILL BE CONTROLLED. A NOTICE OF INTENT (NOI) WILL BE SUBMITTED TO OBTAIN THE UPDES CONSTRUCTION PERMIT. A COPY OF THE PLAN MUST BE ON SITE AT ALL TIMES. THE CONTRACTOR SHALL BE RESPONSIBLE FOR IMPLEMENTING THE PLAN AND INSTALLING AND MAINTAINING THE EROSION CONTROL FACILITIES WITH EACH PHASE OF WORK. SHOULD SILT LEAVE THE SITE OR EROSION OCCURS, IT WILL BE THE CONTRACTORS RESPONSIBILITY TO TAKE CORRECTIVE ACTION AND REPAIR ANY DAMAGE CAUSED BY THE SILT OR EROSION IMMEDIATELY. ALL COSTS ASSOCIATED WITH THE MODIFICATION AND APPROVAL OF THE PLAN WILL BE THE RESPONSIBILITY OF THE CONTRACTOR.
- 3. BEFORE CONSTRUCTION BEGINS, THE LIMITS OF DISTURBANCE (LOD) BOUNDARY SHALL BE STAKED ON SITE AND APPROVED BY THE OWNER'S REPRESENTATIVE AND THE
- 4. EXCAVATION AND EMBANKMENT OPERATIONS SHALL PROCEED IN SUCH A MANNER SO THAT FINISHING OF SLOPES, INCLUDING REVEGETATION SHALL BE ACCOMPLISHED AS SOON AS POSSIBLE AFTER ROUGH GRADING. ALL SLOPES 2:1 OR FLATTER SHALL BE SCARIFIED WITH HEAVY EQUIPMENT, LEAVING TRACKS PERPENDICULAR TO THE SLOPES. SLOPES OVER 1:1 SHALL UTILIZE EROSION CONTROL/REVEGETATION MATTING.
- 5. CUT AND FILL SLOPES SHALL BE CONDUCTED PER THE GEOTECHNICAL REPORT. THE TOPS OF ALL CUT SLOPES IN SOIL SHALL BE ROUNDED FOR A HORIZONTAL DISTANCE OF THREE (3) FEET BEYOND THE CATCH POINT. SLOPE ROUNDING SHALL OCCUR AS THE SLOPE IS BEING BROUGHT DOWN. THE OVERALL SHAPE, HEIGHT AND GRADE OF ANY CUT AND/OR FILL SLOPE SHALL BE DEVELOPED IN CONCERT WITH EXISTING NATURAL CONTOURS, SCALE AND VEGETATION OF NATURAL TERRAIN.
- 6. EXISTING VEGETATION SHOULD BE PRESERVED WHEREVER POSSIBLE AND DISTURBED PORTIONS OF THE SITE SHALL BE STABILIZED. STABILIZATION PRACTICES MAY INCLUDE, BUT NOT LIMITED TO, TEMPORARY SEEDING, PERMANENT SEEDING, MULCHING, GEOTEXTILES, SOD STABILIZATION, VEGETATION BUFFER STRIPS, PROTECTION OF TREES, PRESERVATION OF NATURAL VEGETATION AND OTHER APPROPRIATE MEASURES. USE OF IMPERVIOUS SURFACES FOR STABILIZATION SHALL BE AVOIDED. STABILIZATION MEASURES SHALL BE INITIATED AS SOON AS POSSIBLE IN PORTIONS OF THE SITE WHERE CONSTRUCTION ACTIVITIES HAVE PERMANENTLY CEASED. FOR MORE INFORMATION,
- SPECIFICALLY OUTLINED DISTURBED AREAS, BOTH ON AND OFF-SITE SHALL BE REVEGETATED. THESE AREAS SHALL BE INCLUDE, BUT NOT BE LIMITED TO, ALL UNSURFACED AREAS WITHIN THE STAKED LOD, STAGING AND STORAGE AREAS, MATERIAL WASTE AREAS, UNDERGROUND UTILITY CONSTRUCTION AREAS, BENCHED AREAS, INCLUDING RETAINING WALL BENCHES, AND TEMPORARY OR EXISTING ACCESS ROADS USED FOR CONSTRUCTION ACTIVITIES.
- 8. CONTROLLED OUTLETS SHALL DIRECT COLLECTED RUNOFF THROUGH SILT FENCES, STRAW BALES, OR WATTLE.
- TYPICAL FUGITIVE DUST SHALL BE CONTROLLED BY WATERING AND/OR CHEMICAL STABILIZATION, PROVIDING VEGETATIVE OR SYNTHETIC COVER AND WIND BREAKS CONSISTENT WITH UTAH STATE DIVISION OF AIR QUALITY STANDARDS.
- 10. ANY SEDIMENT TRACKED OFF-SITE SHALL BE REMOVED PRIOR TO THE END OF THE WORK SHIFT OR PRIOR TO SUNSET, WHICHEVER COMES FIRST.
- 11. CONTRACTOR MAY ADJUST THE LOCATIONS OF THE CONSTRUCTION FENCE, CONSTRUCTION TRAILERS, AND CONSTRUCTION MATERIALS RECEIVING AND STORAGE AREAS, AS NEEDED TO ACCOMPLISH THE CONSTRUCTION. ALL CHANGES SHALL BE NOTATED ON THE EROSION CONTROL PLAN.
- 12. THE CONTRACTOR SHALL CONDUCT PERIODIC INSPECTIONS OF THE EROSION CONTROL MEASURES, AS REQUIRED AND NOTATED IN THE SWPPP. THE CONTRACTOR WILL
- MAINTAIN A LOG ON-SITE OF ALL INSPECTIONS WITH THE SWPPP.
- 13. ALL DITCHES AND SWALES GREATER THAN 5% SHALL BE ARMORED WITH AN APPROPRIATE EROSION CONTROL/REVEGETATION STABILIZATION MAT TO PROMOTE
- 14. CONTRACTOR MAY ADJUST THE LOCATION OF CONCRETE WASHOUT AREAS AS NEEDED TO ACCOMPLISH THE CONSTRUCTION.


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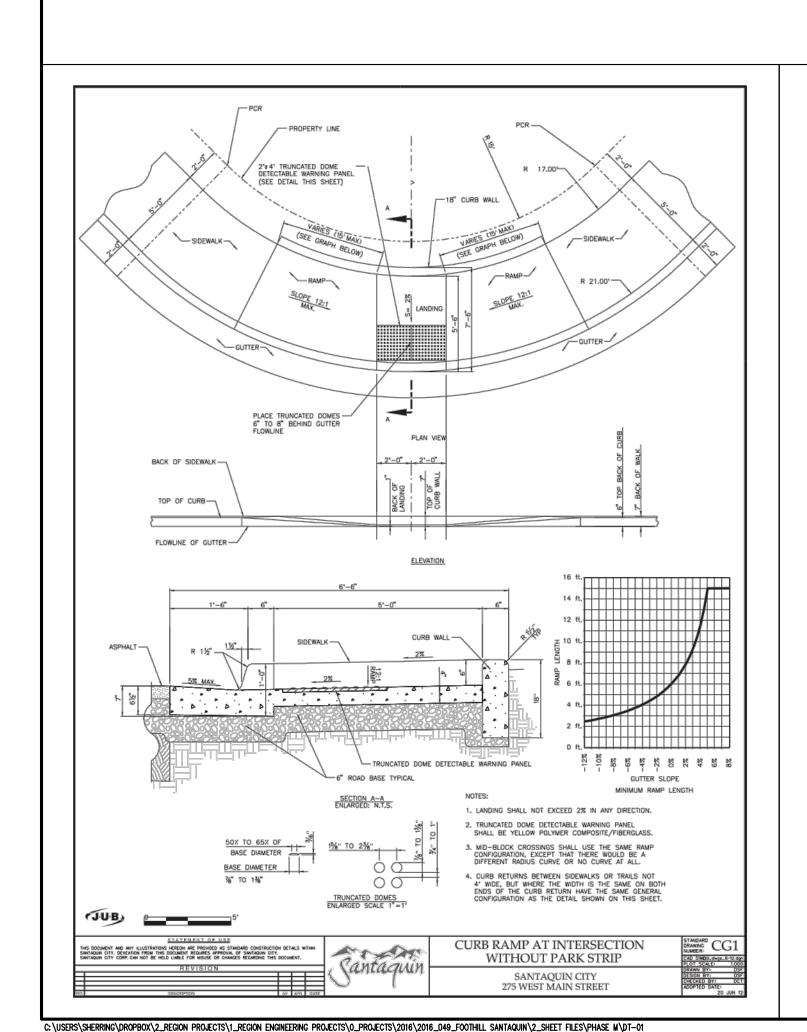
SUBDIVISION


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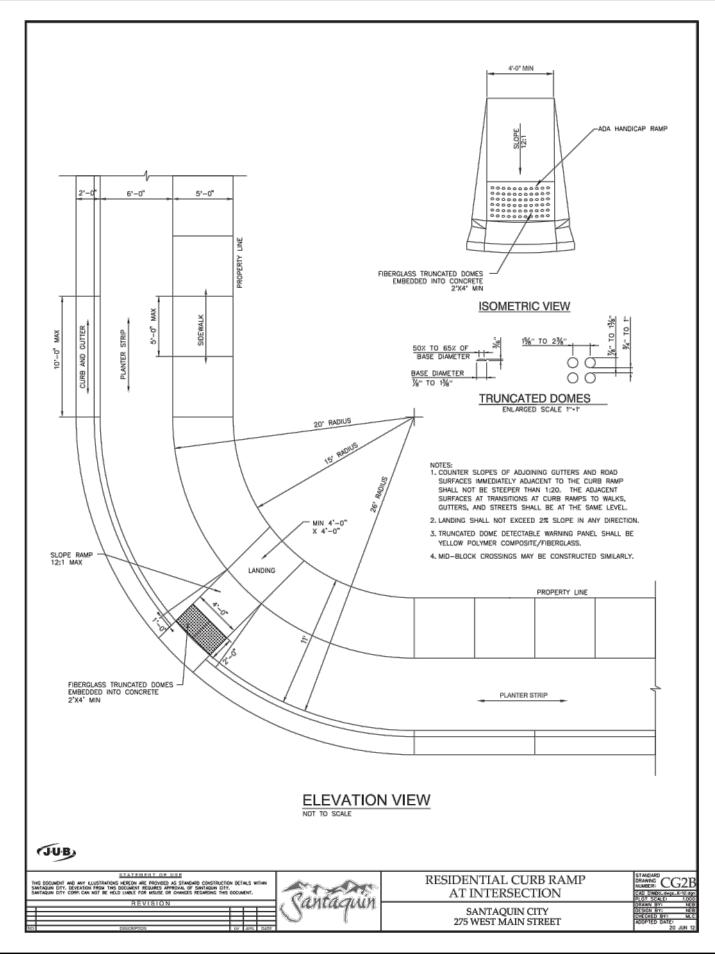
EROSION CONTROL DETAIL







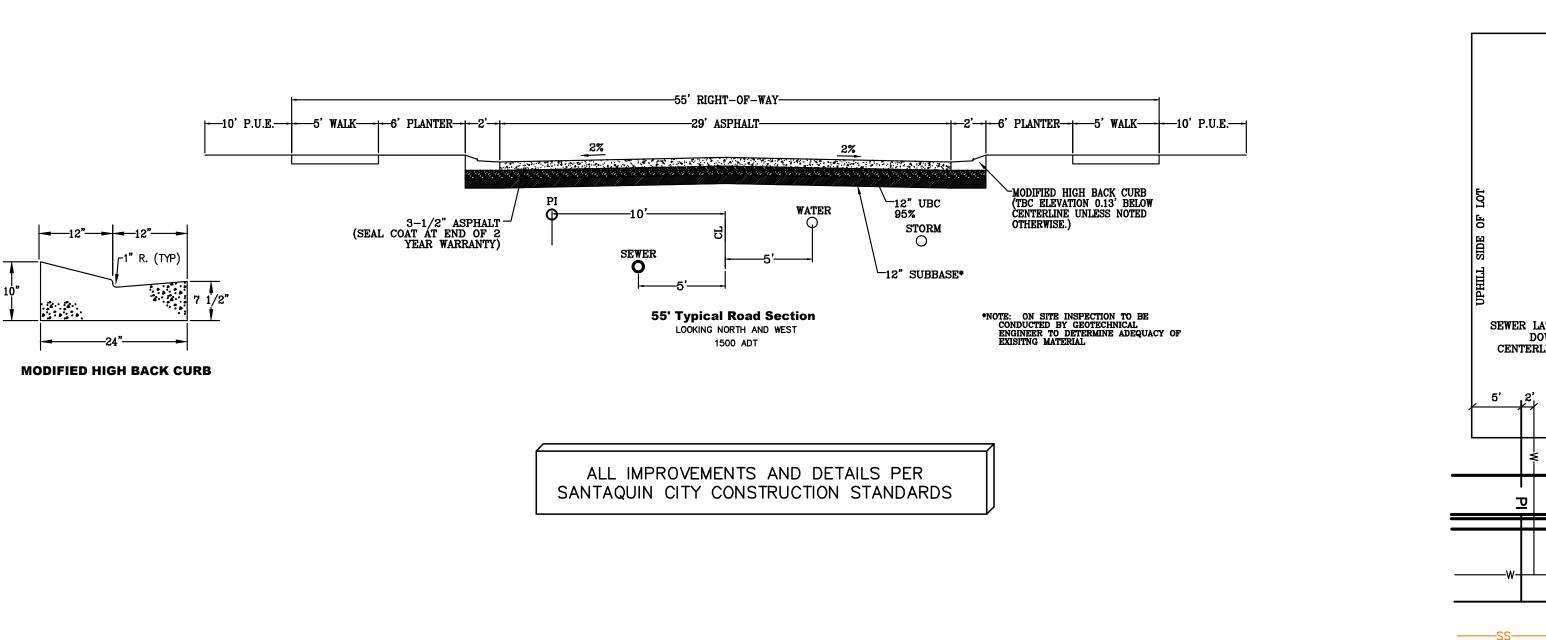


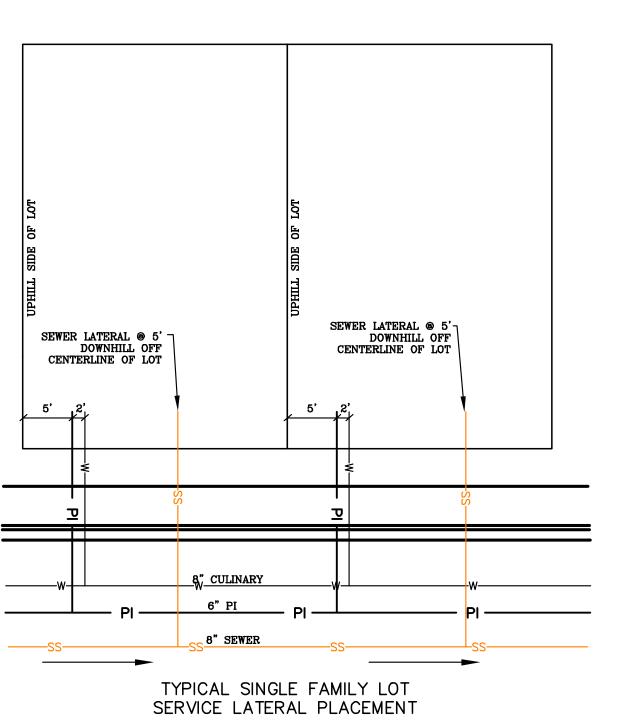

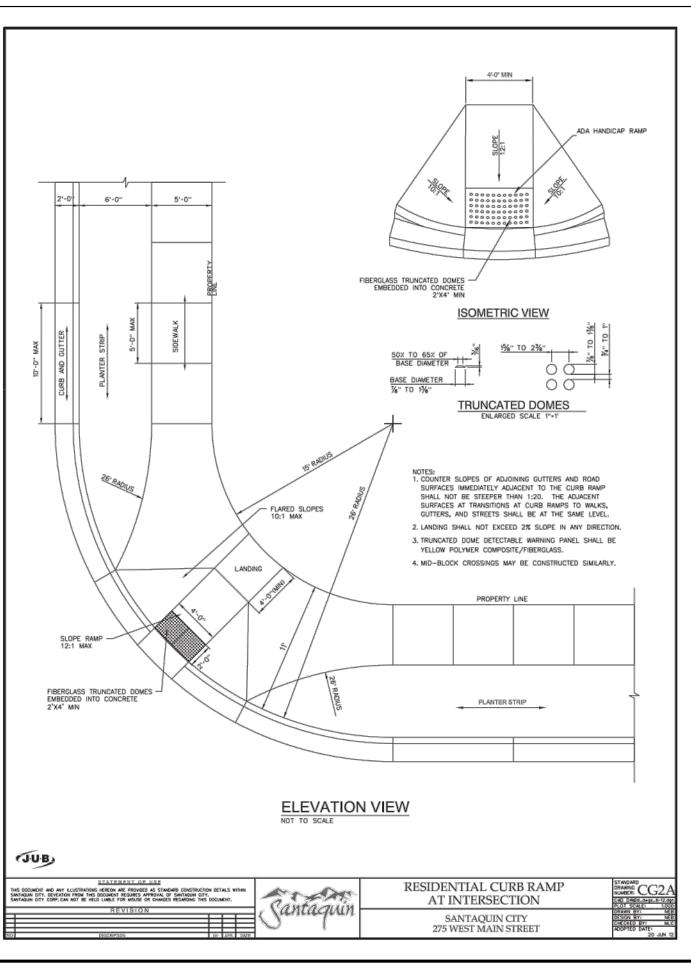

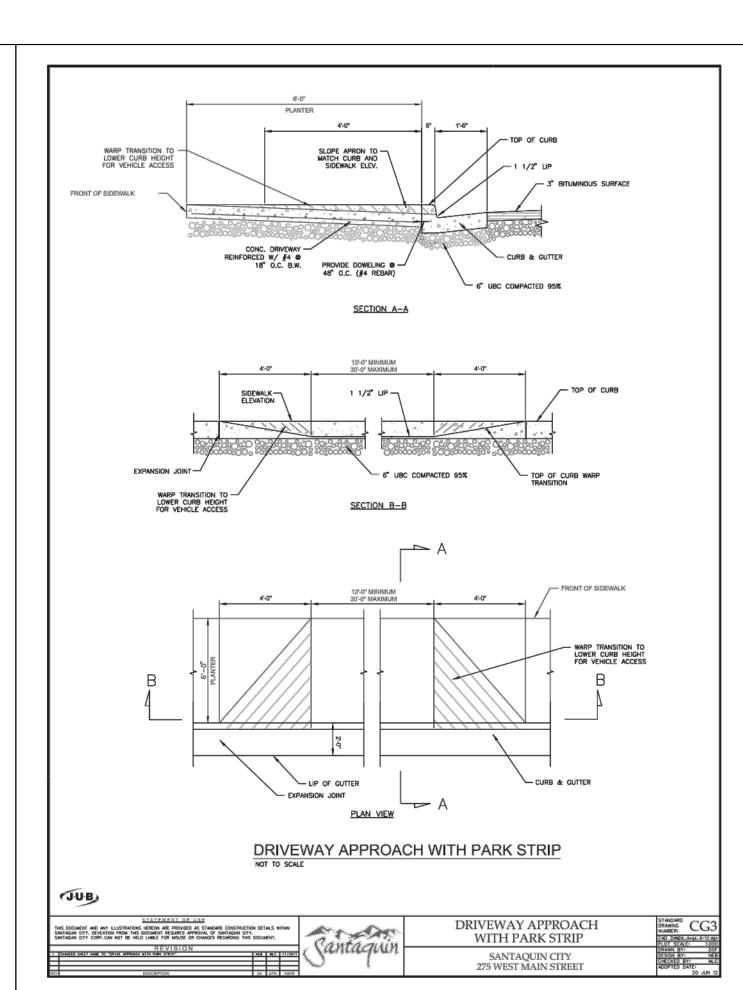

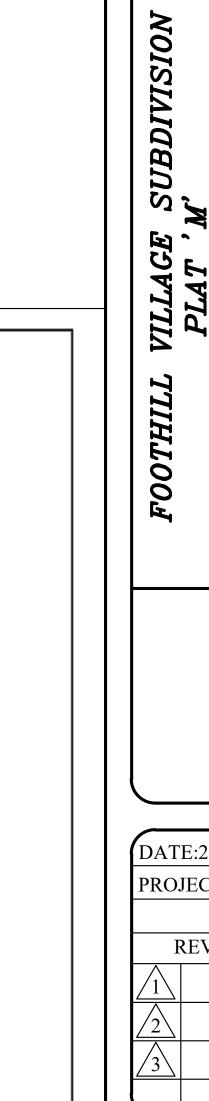

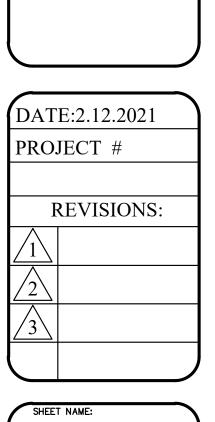

SECTION

SHEET NAME:

TYPICAL DETAILS

SHEET:

DT-01