

November 27, 2024 AVO 37449.004

Ms. Ramie Hammonds Development Services Director/Building Official City of Sanger 201 Bolivar Street P.O. Box 1729 Sanger, Texas 76266

#### Re: Sanger Town Center South Preliminary Plat - Review #1

Dear Ms. Hammonds,

Halff Associates, Inc. was requested by the City of Sanger to review the <u>Preliminary Plat</u> for Sanger Town Center South. This submittal was prepared by KJE Inc. and was received on November 13<sup>th</sup>, 2024.

#### **General Comments**

- 1. Please address comments on attached markups and provide annotated responses on markups. Please note, not all comments are written on letter since some comments are easier to show and explain on the markups. Please annotate markup with responses.
- 2. Please note additional comments may be provided in subsequent reviews once additional data/responses is received.

#### **Preliminary Plat**

- 1. Please reconcile discrepancies in acreage for Tract 2.
- 2. Please ensure that easements called out in the Civil set match those called out in the preliminary plat

#### **Paving Plan**

- 1. Commercial/Industrial streets shall be constructed with an eight-inch thickness of 4,000 psi reinforced concrete pavement on a compacted sub-base per Ordinance § 10.106(b)(2)(B)(ii)
- Driveway returns onto commercial and industrial property shall be a minimum of fifteen feet (15') and a maximum of twenty-five feet (25') except in special cases per ordinance § 10.106(b)(3)(C)

#### **Drainage Calculation Comments**

- 1. Please revise time of concentration for existing drainage areas to 15 minutes per Ordinance § 10.106(d)(2)(D)(iii)b
- 2. Please update rainfall intensities based on Appendix A. Intensity-Duration-Frequency Curve per Ordinance § 10.106(d)(2)(D)(i)
- 3. Please use runoff coefficients from the City of Sanger Ordinance § 10.106(d)(2)(D)(i) for proposed drainage area calculations

Ms. Ramie Hammonds November 27, 2024 Page 2 of 2

4. Please provide more information on how the drainage crossing into Sable Creek Boulevard is being handled.

### **Storm Drain Profile Comments**

- 1. Please verify that pipe sizes called out in the hydraulic calculations match those in the profiles.
- 2. Please provide more information to back up the basis of the starting HGL for the outflow pipe from the detention pond.

#### Grading

- 1. Please show proposed storm drain and sanitary layout in the grading plan
- Verify there is no lot to lot drainage along fence line. Where lot to lot drainage occurs, the lot lines shall be aligned, and a dedicated private drainage easement shall be provided per Ordinance § 10.106(d)(12)
- 3. Please show more contour labels on grading plan sheets
- 4. Detention pond slopes look very steep and would impede maintenance to control weeds and discourage woody growth to observe ordinance § 10.106(d)(10)(H)

#### Water Line

- 1. Please revise and ensure fire hydrant spacing follows City of Sanger Ordinance § 5.701 requiring 300 ft spacing for all commercial structures and a maximum of 500 ft along fire apparatus access roadways
- 2. Please specify water line size and material

#### **Sanitary Sewer**

1. Please revise sanitary sewer line stations and flow lines in the plan and profiles


#### **Standard Details**


1. Please reference latest NCTCOG standard specifications for public works construction for all improvements under the jurisdictions of the City of Sanger ordinance § 10.106(a)

If you have any questions or need additional information, please do not hesitate to call me at (817) 764-7498.

Sincerely,

Samson Lotigo, PE HALFF Firm No. 0312 Attachments: Preliminary Civil Construction Plans markups

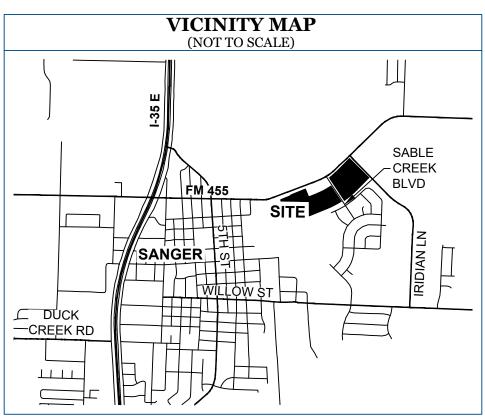

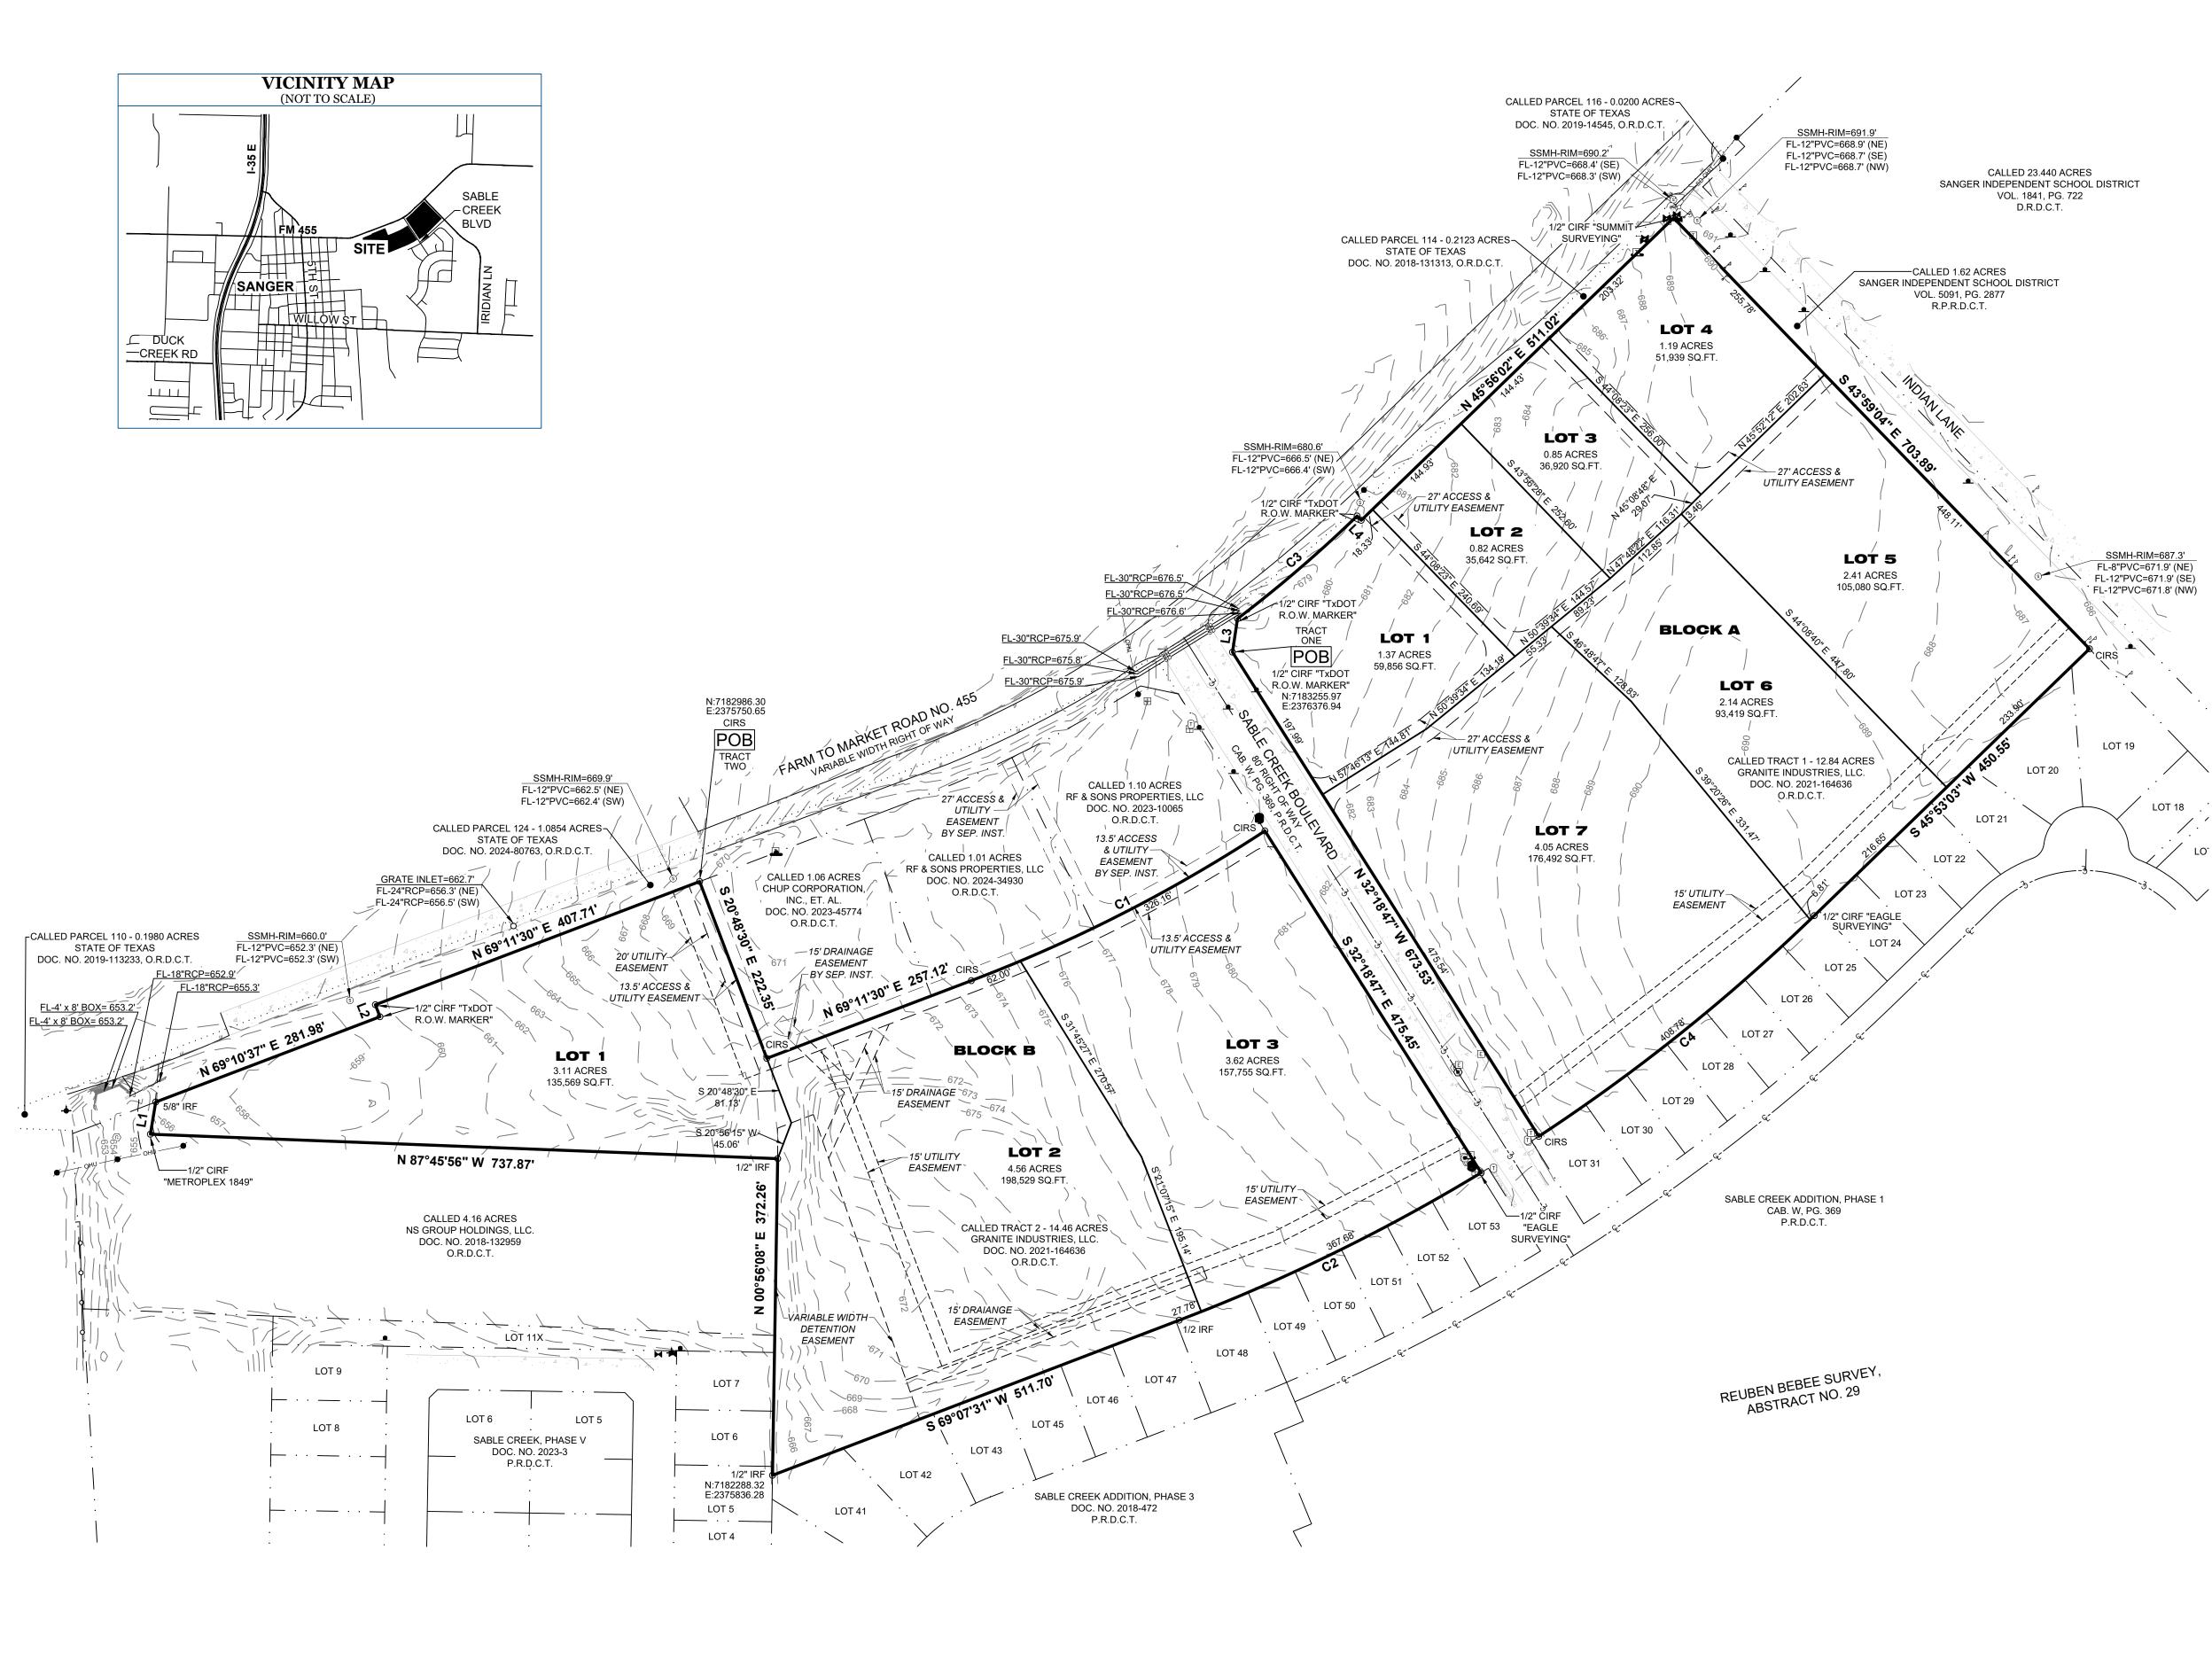

JOB NUMBER 1802.021-17 DATE 11/12/2024 REVISION

-

DRAWN BY

TAR

SURVEYING

Eagle Surveying, LLC 222 South Elm Street Suite: 200 Denton, TX 76201 940.222.3009 www.eaglesurveying.com TX Firm # 10194177

Electric Box Electric Meter E E Electric Vault  $\blacksquare$ Electric Transforme C Guy Wire Power Pole ⊶✓ Light Pole \_\_\_\_\_Sign

Cable Ris Buried Cable Si **\_** Gas Meter Gas Utility Mark Tree Sanitary Manhole X Grate Inlet

Buried Gas Utility Sign

H

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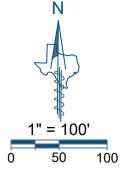
lecommunications Vau Fiber Optic Utility Sign Felecommunications Utility Mark Water Meter Water Valve Fire Hydran

LEGEND					
—— они ——	Overhead Utilities	4	Concrete	VOL.	Volume
SD	Storm Drain Line	<u>1997</u>	Stone	PG.	Page
	Edge of Asphalt	( )	Record Call	DOC. NO.	Document Number
	Edge of Gravel	CIRS	1/2" Capped Iron Rod Set Stamped "Eagle Surveying"	D.R.D.C.T.	Deed Records, Denton County, Texas
		CIRF	Capped Iron Rod Found	O.R.D.C.T.	Official Records, Denton County, Texas
		IRF	Iron Rod Found	P.R.D.C.T.	Plat Records, Denton County, Texas
		R.O.W.	Right-of-way	R.P.R.D.C.T.	Real Property Records, Denton County, Texas
0	Boundary Monumentation	CAB.	Cabinet		

SURVEYOR Eagle Surveying, LLC 222 S. Elm Street, Suite: 200 Denton, TX 76201 (940) 222-3009

ENGINEER KJE Contact: Ian Norfolk 500 Moseley Road Cross Roads, TX 76227

(940) 387-0805



LINE TABLE					
LINE	BEARING	DISTANCE			
L1	N 09°25'57" E	38.34'			
L2	N 20°46'45" W	15.08'			
L3	N 08°36'41" E	39.69'			
L4	S 43°51'44" E	6.98'			

			CURVE TABLE		
CURVE	ARC LENGTH	RADIUS	DELTA ANGLE	CHORD BEARING	CHORD LENGTH
C1	388.16'	1787.35'	12°26'35"	N 62°58'21" E	387.40'
C2	395.46'	2196.52'	10°18'55"	S 63°57'43" W	394.92'
C3	185.39'	1565.00'	6°47'15"	N 49°20'03" E	185.29'
C4	415.59'	2196.52'	10°50'26"	S 51°17'41" W	414.97'



- **1.)** The purpose of this plat is to create ten lots of record from unplatted land.
- 2.) This property is located in Non-Shaded Zone "X" as scaled from the F.E.M.A. Flood Insurance Rate Map dated April 18, 2011 and is located in Community Number 480786 as shown on Map Number 48121C0210G. The location of the Flood Zone is approximate, no vertical datum was collected at the time of the survey. For the exact Flood Zone designation, please contact 1-(877) FEMA MAP.
- 3.) The grid coordinates shown on this plat are based on GPS observations utilizing the AllTerra RTK Network. North American Datum of 1983 (Adjustment Realization 2011).
- 4.) Selling a portion of this addition by metes and bounds is a violation of City Ordinance and State Law, and is subject to fines and/or withholding of utilities and building permits.
- 5.) All interior property corners are marked with a 1/2-inch iron rod with a green plastic cap stamped "EAGLE SURVEYING" unless noted otherwise.
- 6.) The bearings shown on this plat are based on GPS observations utilizing the AllTerra RTK Network. North American Datum of 1983 (Adjustment Realization 2011).
- 7.) The elevations shown on this plat are based on GPS observations utilizing the AllTerra RTK Network. North American Vertical Datum of 1988, (Geoid 12A).
- 9.) Lot to lot drainage shall not be allowed.
- 10.) All lots comply with the minimum size requirements of the zoning district.
- 11.) This property may be subject to charges related to impact fees and the applicant should contact the city regarding any applicable fees due.
- **12.)** All common areas, drainage easements, and detention facilities will be owned and maintained by the HOA/property owner. Any common area within the city's right-of-way will require a facilities agreement, to be reviewed and approved by the city.
- **13.)** This plat does not alter or remove existing deed restriction, if any, on this property.


PRELIMINARY PLAT **SANGER TOWN CENTER SOUTH** LOTS 1-7, BLOCK A LOTS 1-3, BLOCK B 24.13 ACRES

PAGE 1 OF 2

PRELIMINARY PLAT FOR REVIEW **PURPOSES ONLY** 

REUBEN BEBEE SURVEY, ABSTRACT NUMBER 29 CITY OF SANGER, DENTON COUNTY, TEXAS

OWNER Granite Industries, LLC 161 W 3rd Street, Suite 110 Prosper, TX 75078

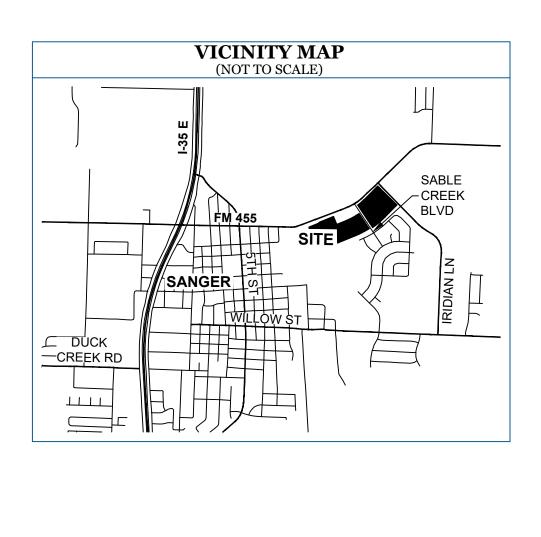

COUNTY OF DENTON	Ę
I, MATTHEW RAABE, Registe	re

STATE OF TEXAS §

ed Professional Land Surveyor, do hereby certify that this plat is true and correct and was prepared from an actual survey made on the ground and that the monuments shown hereon were found or placed with 1/2-inch iron rods with green plastic caps stamped "EAGLE SURVEYING" under my direction and supervision in accordance with the current provisions of the Texas Administrative Code and the Ordinances of the City of Sanger, Denton County, Texas.

PRELIMINARY this document shall not be recorded for any purpose and shall not be used or viewed or relied upon as a final survey document Matthew Raabe, R.P.L.S. # 6402 Date

STATE OF TEXAS COUNTY OF DENTON

BEFORE ME, the undersigned authority, on this day personally appeared **MATTHEW RAABE**, known to me to be the person whose name is subscribed to the foregoing instrument, and acknowledged to me that he executed the same for the purposes and considerations therein expressed and in the capacity therein stated.

GIVEN UNDER MY HAND AND SEAL OF THE OFFICE this \_\_\_\_\_ day of \_, 2024.

Notary Public in and for the State of Texas

WHEREAS, GRANITE INDUSTRIES, LLC is the owner of two (2) tracts of land out of the Reuben Bebee Survey, Abstract Number 29, situated in Denton County, Texas, Tract One being all of a called Tract 1 - 12.84 acre tract of land conveyed by General Warranty Deed of record in Document Number 2021-164636 of the Official Records of Denton County, Texas, Tract Two being a portion of a called Tract 2 - 14.46 acre tract of tand conveyed by said General Warranty Deed and being more particularly described by metes and bounds as follows: discrepancy in Tract

TRACT ONE - 12.84 ACRE TRACT

4. N45°56'02"E, a distance of 511.02 feet to a 1/2 inch iron rod with yellow plastic cap stamped "SUMMIT SURVEXING" found in the West line of a called 1.62 acre tract of land conveyed to Sanger Independent School District by deed of record in Volume 5091, Page 2877 of the Real Property Records of Denton County, Texas, being the Southeast corner of said Parcel 114, also being the Northeast corner of said 12.84 acre tract; THENCE, S43°59'04"E, along the West right-of-way line of Indian Lane, being the common East line of said 12.84 acre tract, a distance of 703.89 feet to a 1/2 inch iron rod with green plastic cap stamped "EAGLE SURVEYING" set at the North corner of Lot 19, Block N of Sabel Creek Addition, Phase I, a subdivision of record in

THENCE, N32°18'47"W, leaving the North line of said Lot 31, along the East right-of-way line of Sable Creek Boulevard, being the common West line of 673.53 feet to the POINT OF BEGINNING and containing an area of 12.84 Acres, or (559347 Square Feet) of land, more or less.

TRACT TWO - 11.29 ACRE TRACT BEGINNING, at a 1/2 inch iron rod with green plastic cap stamped "EAGLE SURVEYING" set in the Southeast right-of-way), being in the South line of a called Parcel 124 - 1.0854 acre tract of land conveyed to the State of Texas by Agreed Final Judgement of record in Document Number 2024-80763 of said Official Records, being the Northwest corner of a called 1.06 acre tract of land conveyed to Chup Corporation, Inc. et. al. by deed of record in Document Number 2023-457774 of said Official Records; THENCE, S20°48'30"E, leaving the Southeast right-of-way line of Farm to Market Road Number 455, along the West line of said 1.06 acre tract, a distance of 222.35 feet to a 1/2 inch iron rod with green plastic cap stamped "EAGLE SURVEYING" set at the Southwest corner of said 1.06 acre tract; THENCE, in part, along the South line of said 1.06 acre tract, in part, along the South line of a called 1.01 acre tract of land conveyed to RF & Sons Roperties, LLC by deed of record in Document Number 2024-34930 of said Official Records and in part, along the South line of a called 1.10 acre tract of land conveyed to RF & Sons Roperties, LLC by deed of record in Document Number 2024-34930 of said Official Records and in part, along the South line of a called 1.10 acre tract of land conveyed to RF & Sons Roperties, LLC by deed of record in Document Number 2024-34930 of said Official Records and in part, along the South line of a called 1.10 acre tract of land conveyed to RF & Sons Roperties, LLC by deed of record in Document Number 2024-34930 of said Official Records and in part, along the South line of a called 1.10 acre tract of land conveyed to RF & Sons Roperties, LLC by deed of record in Document Number 2024-34930 of said Official Records and in part, along the South line of a called 1.10 acre tract of land conveyed to RF & Sons Roperties, LLC by deed of record in Document Number 2024-34930 of said Official Records and in part, along the South line of a called 1.10 acre tract of land conveyed to RF & Sons Roperties, LLC by deed of record in Document Number 2024-34930 of said Official Records and in part, along the South line of a called 1.10 acre tract of land conveyed to RF & Sons Roperties, LLC by deed of records and line of a called 1.10 acre tract of land conveyed to RF & Sons Roperties, LLC by deed of records and line of a called 1.10 acre tract of land conveyed to RF & Sons Roperties, LLC by deed of records and line of a called 1.10 acre tract of land conveyed to RF & Sons Roperties, LLC by deed of records and line of a called 1.10 acre tract of land conveyed to RF & Sons Roperties, LLC by deed of records and line of a called 1.10 acre tract of land conveyed to RF & Sons Roperties, LLC by deed of records and line of a called 1.10 acre tract of land conveyed to RF & Sons Roperties, LLC by deed of rec Properties, LLC by deed of record in Document Number 2023-10065 of said Official Records, the following two (2) courses and distances:

1. N69°11'30"E, a distance of 257.12 feet to a 1/2 inch iron rod with green plastic cap stamped "EAGLE SURVEYING" set at the point of curvature of a tangent curve to the left; 2. Along said tangent curve to the left, having a radius of 1787.35 feet, a chord bearing of N62°58'21"E, a chord length of 387.40 feet to a 1/2 inch iron rod with green plastic cap stamped "EAGLE SURVEYING" set at the end of said curve, being in the West right-of-way line of Sable Creek Boulevard (80' Right-of-way, Cab. W, Pg 369 of the Plat Records of Denton County, Texas), being the Southeast corner of said 1.10 acre tract, for the Northeast corner hereof;

STATE OF TEXAS COUNTY OF DENTON

NOW THEREFORE KNOW ALL MEN BY THESE PRESENTS: THAT, GRANITE INDUSTRIES, LLC, acting herein by and through it duly authorized office, does hereby adopt this plat designating the hereinabove described property as SANGER TOWN CENTER SOUTH, an addition to the City of Sanger, Texas, and does hereby dedicate to the public use foreverby fee simple title, free and clear of all liens and encumbrances, all streets, thoroughfares, alleys, fire lanes, drive aisles, parks, and watercourses, and to the public use forever easements for sidewalks, storm drainage facilities, utilities, and other City codes and do hereby bind ourselves, our heirs, successors and assigns to warrant and to forever defend the title on the land so dedicated. Further, the undersigned covenants and agrees that he/she shall maintain all easements and facilities in a state of good repair and functional condition at all times in accordance with City codes and regulations. No buildings, fences, trees, shrubs, or other improvements or growths shall be constructed or placed upon, over, or across the easements may be installed, if approved by the City of Sanger. The City of Sanger and public entities shall have the right to access and maintain all respective easements without the necessity at any time of procuring permission from anyone.

OWNER: GRANITE INDUSTRIES, LLC

STATE OF TEXAS COUNTY OF \_\_\_\_\_

stated

JOB NUMBER 1802.021-17 DATE 11/12/2024 REVISION

DRAWN BY TAR



Eagle Surveying, LLC 222 South Elm Street Suite: 200 Denton, TX 76201 940.222.3009 www.eaglesurveying.com TX Firm # 10194177

# **OWNER'S CERTIFICATE & DEDICATION**

BEGINNING, at a 1/2 inch iron rod with pink plastic cap stamped "TXDOT RIGHT OF WAY MARKER" found at the South and of a cutback line at the intersection of the Southeast right-of-way line of Farm to Market Road Number 455 (variable width right-of-way) and the East right-of-way line of Sable Creek Boulevard (80' Right-of-way, Cab. W, Pg 369 of the Plat Records of Denton County, Texas), being the Southwest corner of a called Parcel 114 - 0.2123 acre tract of land conveyed to the State of Texas by deed of record in Document Number 2018-131313 of said Official Records, being the Northwest corner of said 12.84 acre tract; THENCE, along the Southeast right-of-way line of Farm to Market Road Number 455, being the South line of said Parcel 114, also being the common North line of said 12.84 acre tract, the following four (4) courses and distances: 1. N08°36'41"E, a distance of 39.69 feet to a 1/2 inch iron rod with green plastic cap stamped "EAGLE SURVEYING" set at the North end of said cutback line;

2. Along a non-tangent curve to the left, having a radius of 1565 teet, a chord bearing of N49°20'03 E, a chord length of 185.29 feet, a delta angle of 06°47'15", an arc length of 185.39 feet to a 1/2 inch iron rod with green plastic cap stamped "EAGLE SURVEYING" set at the end of said curve; 3. S43°51'44"E, a distance of 6.98 feet to a 1/2 inch iron rod with pink plastic cap stamped "TXDOT RIGHT OF WAY MARKER" found;

Cabinet W. Page 369 of said Plat Records, being the Southeast corner of said 12.84 acre tract ;

THENCE, leaving the West right-of-way line of Indian Lane, along the North lines of Lots 19-31 of said Block N of Sabel Creek Addition, Phase I, the following two (2) courses and distances:

1. S45°53'03"W, a distance of 450,55 feet to a 1/2 inch iron rod with green plastic cap stamped "EAGLE SURVEYING" set at the point of curvature of a non-tangent curve to the right;

2. Along said non-tangent curve to the right, having a radius of 2196.52 feet, a chord bearing of S51°17'41"W, a chord length of 414.97 feet, a delta angle of 10°50'26", an arc length of 415.59 feet to a 1/2 inch iron rod with green plastic cap stamped "EAGLE SURVEYING" set at the end of said curve, being in the East right-of-way line of Sable Greek Boulevard, also being the Southwest corner of said 12.84 acre tract;

THENCE, S32°18'47"E, along the West right-of-way line of Sable Creek Boulevard, a distance of 475.45 feet to a 1/2 inch iron rod with green plastic cap stamped "EAGLE SURVEYING" set in the curving North line of Lot 53, Block E of Sable Creek Addition, Phase 3, a subdivision of record in Document Number 2018-472 of said Plat Records, being the common South line of said 14.46 acre tract, for the Southeast corner hereof;

THENCE, leaving the West right-of-way line of Sable Creek Boulevard, along the North lines of Lots 53-41 of said Sable Creek Addition, Phase 3, being the common South line of said 14.46 acre tract, the following two (2) courses and distances: 1. Along a non-tangent curve to the right, having a radius of 2196.52 feet, a chord bearing of S63°57'43"W, a chord length of 394.92 feet, a delta angle of 10°18'55", an arc length of 395.46 feet to a 1/2 inch iron rod found at the point of tangency of said curve; 2. S69°07'31"W, a distance of 511.70 feet to a 1/2 inch iron rod found the East line of Lot 5, Block L of Sable Creek Addition, Phase V, a subdivision of record in Document Number 2023-3 of said Plat Records, being the most Southerly Southwest corner of said 14.46 acre tract; THENCE, N00°56'08"E, along the irregular West line of said 14.46 acre tract, being in part, the common East line of Lots 5-7 of said Block L, in part, the common East lines of Lots 5-7 of said Block L, in part, the common East line of a called 4.16 acre tract of land conveyed to NS Group Holdings, LLC by deed of record in Document Number 2018-132959 of said Official Records, a distance of 372.26 feet to a 1/2 inch iron rod found at the Northeast corner of said 4.16 acre tract;

THENCE, along the irregular North line of said 4.16 acre tract, being the common Irregular West line of said 14.46 acre tract, the following two (2) courses and distances:

1. N87°45'56"W, a distance of 737.87 feet to a 1/2 inch iron rod with yellow plastic cap stamped "METROPLEX 1849" found at the most Westerly Southwest corner of said 14.46 acre tract;

2. N09°25'57"E, a distance of 38.34 feet to a 5/8" iron rod found in the Southeast right-of-way line of Farm to Market Road Number 455, being the Southeast corner of a called Parcel 110 - 0.1980 acre tract of land conveyed to the State of Texas by Deed of record in Document Number 2019-113233 of said Official Records, being the Southwest corner of said Parcel 124;

THENCE, along the Southeast right-of-way line of Farm to Market Road Number 455, being the South line of said Parcel 124, the following three (3) courses and distances:

1. N69°10'37"E, a distance of 281.98 feet to a 1/2 inch iron rod with pink plastic cap stamped "TXDOT RIGHT OF WAY MARKER" found;

2. N20°46'45"W, a distance of 15.08 feet to a 1/2 inch iron rod with pink plastic cap stamped "TXDOT RIGHT OF WAY MARKER" found;

3. N69°11'30"E, a distance of 407.71 feet to the POINT OF BEGINNING and containing an area of 11.29 Acres, or (491,853 Square Feet) of land, more or less.

BEFORE ME, the undersigned authority, on this day personally appeared \_\_\_\_

GIVEN UNDER MY HAND AND SEAL OF THE OFFICE this \_\_\_\_\_ day of \_\_\_\_\_ , 2024.

Notary Public in and for the State of Texas

# **APPROVED AND ACCEPTED**

Approved for preparation of Final Plat

City of Sanger, TX Planing and Zoning Commission

Date

\_\_\_, known to me to be the person whose name is subscribed to the foregoing instrument, and acknowledged to me that he executed the same for the purposes and considerations therein expressed and in the capacity therein

SURVEYOR Eagle Surveying, LLC 222 S. Elm Street, Suite: 200 Denton, TX 76201 (940) 222-3009

**ENGINEER** KJE Contact: Ian Norfolk 500 Moseley Road Cross Roads, TX 76227 (940) 387-0805

PRELIMINARY PLAT **SANGER TOWN CENTER SOUTH** LOTS 1-7, BLOCK A LOTS 1-3, BLOCK B 24.13 ACRES

PAGE 2 OF 2

PRELIMINARY PLAT FOR REVIEW **PURPOSES ONLY** 

**REUBEN BEBEE SURVEY. ABSTRACT NUMBER 29** CITY OF SANGER. DENTON COUNTY. TEXAS

**OWNER** Granite Industries, LLC 161 W 3rd Street, Suite 110 Prosper, TX 75078


# CIVIL ENGINEERING PLANS FOR SANGER TOWN CENTER SOUTH DEVELOPMENT


PLOTTED BY: MARIA PAZ DATE: 11/13/2024 2:56 PM DWG NAME: P:/2024/240117 SABLE CROSSING - SANGER TOWN CENTER SOUTH/CAD/CIVIL/04\_SHEETS/C0.00 COVER SHEET.DWG LAST SAVED BY: BRANSONBURGER DATE: 11/13/2024 2:18 PM


# SANGER, TEXAS

# NOVEMBER 2024

KJE PROJECT #: 240117

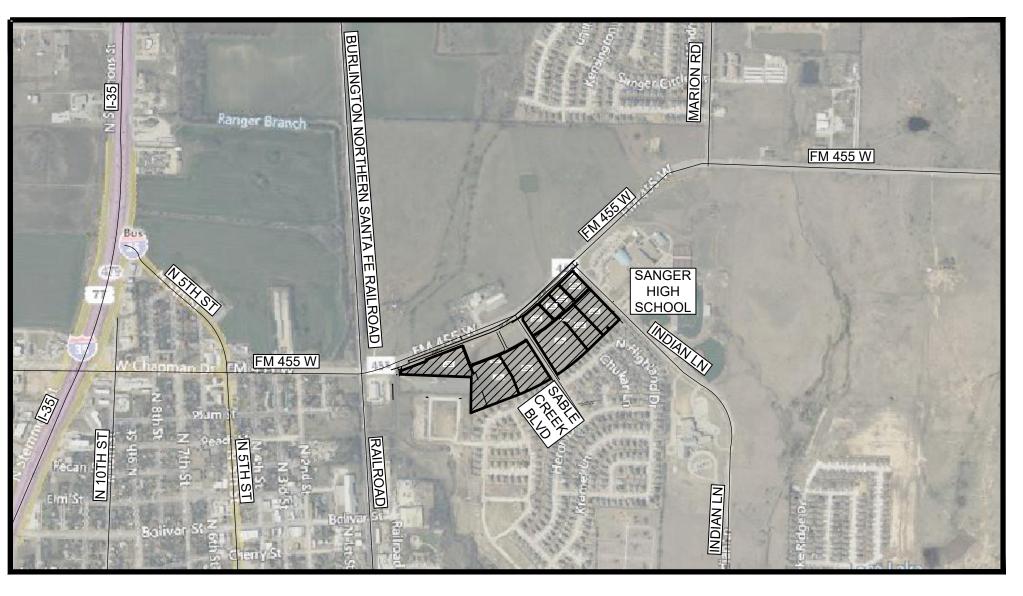

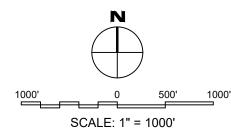

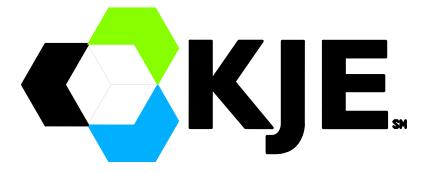

KJE WWW.KJE-US.COM CROSSROADS, TEXAS/ PLANO, TEXAS

> **DEVELOPER/OWNER** GRANITE INDUSTRIES, LLC 161 W 3RD STREET # 110 PROSPER, TX 75078 310-962-3931 Mike@justlanddevelopment.com





Phone 940-387-0805 Fax 940-387-0830

PRELIMINAR THIS DOCUMENT IS RELE REVIEW UNDER TH UTHORITY OF IAN NORFO P.E. 93550 ON 11/13/2024. IT I NOT TO BE USED FOR CONSTRUCTION, BIDDING, C PERMIT PURPOSES





	ued Date: ject No:	11/12/2024 240117
	awn By: ecked By:	RP IN
	signed By:	IN
	Issue Rec	ord
#	Description	Date

COVER SHEET

BENCHMARKS

TBM X-CUT N:7182983.6 E:2376464.4 ELEV:682.2'

TBM X-CUT N:7182732.0 ELEV:683.2' ELEV:682.2'

TBM X-CUT N:7182983.6 E:2376692.0 E:2376464.4

C0.00

### **GENERAL NOTES**

- 1. SITE TOPOGRAPHIC INFORMATION WAS TAKEN FROM A SURVEY PREPARED BY EAGLE SURVEYING, DATED 10/11/2024.
- 2. THE PLANS SHOW SUBSURFACE STRUCTURES, ABOVE GROUND STRUCTURES AND/OR UTILITIES FROM FIELD LOCATION AND RECORD MAPPING, EXACT LOCATION OF WHICH MAY VARY FROM THE LOCATIONS INDICATED. IN PARTICULAR, THE CONTRACTOR IS WARNED THAT THE EXACT OR EVEN APPROXIMATE LOCATION OF SUCH PIPELINES, SUBSURFACE STRUCTURES AND/OR UTILITIES IN THE AREA MAY BE DIFFERENT FROM THAT SHOWN OR MAY NOT BE SHOWN, AND IT SHALL BE HIS RESPONSIBILITY TO PROCEED WITH GREAT CARE IN EXECUTING ANY WORK. 48 HOURS BEFORE YOU DIG, DRILL, OR BLAST, CALL TEXAS 811.
- 3. THE ENGINEER SHALL BE NOTIFIED IN WRITING OF ANY CONDITIONS THAT VARY FROM THOSE SHOWN ON THE PLANS. THE CONTRACTOR'S WORK SHALL NOT VARY FROM THE PLANS WITHOUT THE EXPRESSED APPROVAL OF THE ENGINEER.
- 4. THE CONTRACTOR IS INSTRUCTED TO COOPERATE WITH ANY AND ALL OTHER CONTRACTORS PERFORMING WORK ON THIS JOB SITE DURING THE PERFORMANCE OF THIS CONTRACT.
- 5. THE CONTRACTOR SHALL RESTORE LAWNS, DRIVEWAYS, CULVERTS, SIGNS AND OTHER PUBLIC OR PRIVATE PROPERTY DAMAGED OR REMOVED TO AT LEAST AS GOOD A CONDITION AS BEFORE BEING DISTURBED AS DETERMINED BY THE ENGINEER. ANY DAMAGED TREES, SHRUBS, AND/OR HEDGES SHALL BE REPLACED AT THE CONTRACTOR'S EXPENSE.
- 6. PRIOR TO COMMENCEMENT OF STORM AND/OR SANITARY SEWER CONSTRUCTION, CONTRACTOR IS TO VERIFY BOTH HORIZONTAL AND VERTICAL POSITION OF EXISTING SEWER AT CONNECTION POINT. CONTRACTOR IS TO CONSTRUCT GRAVITY LINES PROGRESSIVELY FROM DOWNSTREAM TO UPSTREAM; ANY EXCEPTIONS TO THIS MUST BE APPROVED BY THE ENGINEER. ANY GRADE DISCREPANCIES MUST BE BROUGHT TO THE ENGINEERS ATTENTION IMMEDIATELY.
- THE CONTRACTOR SHALL BE RESPONSIBLE FOR OBTAINING AND INCURRING THE COST OF ALL REQUIRED PERMITS, INSPECTIONS, CERTIFICATES, ETC. AND SHALL COMPLY WITH ALL REQUIRED PERMITS.
- 8. ALL WORK SHALL BE DONE IN STRICT COMPLIANCE WITH ALL APPLICABLE NATIONAL, STATE, AND LOCAL CODES, STANDARDS, ORDINANCES, RULES, AND REGULATIONS.
- 9. ALL PROPOSED UTILITIES AND APPURTENANCES TO BE CONSTRUCTED IN COMPLIANCE WITH THE LOCAL MUNICIPALITIES' CODES AND REGULATIONS GOVERNING THE INSTALLATION OF SUCH UTILITIES.
- 10. ALL PLANS SHALL COMPLY WITH LOCAL AND/OR NCTCOG STANDARD SPECIFICATIONS FOR PUBLIC WORKS CONSTRUCTION (LATEST EDITION). OR BEST PRACTICES.
- 11. FIELD VERIFICATION AND ADJUSTMENTS ARE PERMISSIBLE WITH THE ENGINEER'S WRITTEN APPROVAL
- 12. THE ENGINEER RESERVES THE RIGHT TO EXAMINE ANY WORK DONE ON THIS PROJECT AT ANY TIME TO DETERMINE THE CONFORMANCE WITH THE REQUIREMENTS OF THE CONTRACT DOCUMENTS OF THIS PROJECT, AS INTENDED AND INTERPRETED BY THE ENGINEER.
- 13. MISCELLANEOUS WORK NOT SPECIFICALLY SHOWN ON THE CONTRACT DRAWINGS SUCH AS PATCHING, BLOCKING, TRIMMING, ETC., SHALL BE PERFORMED AS REQUIRED TO MAKE THE WORK COMPLETE.
- 14. THE CONTRACTOR SHALL PROTECT EXISTING PROPERTY LINE MONUMENTATION. ANY MONUMENTATION DISTURBED OR DESTROYED, AS JUDGED BY THE ENGINEER OR OWNER, SHALL BE REPLACED AT THE CONTRACTOR'S EXPENSE UNDER THE SUPERVISION OF A TEXAS LICENSED LAND SURVEYOR.
- 15. IT IS THE CONTRACTOR'S RESPONSIBILITY TO EXAMINE ALL PLAN SHEETS AND COORDINATE WORK WITH ALL OTHER CONTRACTS FOR THE SITE.
- 16. THE CONTRACTOR SHALL:
- A. VERIFY ALL CONDITIONS IN THE FIELD PRIOR TO COMMENCEMENT OF WORK AND NOTIFY THE ENGINEER OF ANY DISCREPANCIES.
- R EXAMINE THE SITE AND INCLUDE IN HIS WORK THE EFFECT OF ALL EXISTING CONDITIONS ON THE WORK.
- PROVIDE AND INSTALL ALL MATERIALS AND PERFORM ALL C. WORK IN ACCORDANCE WITH RECOGNIZED GOOD STANDARD PRACTICE.
- D. HOLD THE OWNER HARMLESS AGAINST ANY AND ALL CLAIMS ARISING FROM WORK DONE BY THE CONTRACTOR ON THE SITE.
- 15. ALL TRENCH EXCAVATION AND ANY REQUIRED SHEETING AND SHORING SHALL BE DONE IN ACCORDANCE WITH THE LATEST **REVISIONS OF OSHA REGULATIONS FOR CONSTRUCTION. SHEET** PILING SHALL BE DESIGNED AND SEALED BY A LICENSED TEXAS PROFESSIONAL ENGINEER.
- 16. CONTRACTOR SHALL BE RESPONSIBLE FOR DEWATERING AND THE MAINTENANCE OF SURFACE DRAINAGE DURING THE COURSE OF WORK AND SHALL SUBMIT A DEWATERING PLAN DESIGNED AND SEALED BY A LICENSED TEXAS PROFESSIONAL ENGINEER CONTRACTOR SHALL MAINTAIN EXISTING SITE DRAINAGE PATTERNS THROUGHOUT CONSTRUCTION UNLESS OTHERWISE SHOWN ON THE PLANS.
- 17. ALL UTILITY WORK INVOLVING CONNECTIONS TO EXISTING SYSTEMS SHALL BE COORDINATED WITH THE UTILITY OWNER. NOTIFY THE UTILITY OWNER 72 HOURS BEFORE EACH AND EVERY CONNECTION TO EXISTING SYSTEMS IS MADE.

- 18. CONSTRUCTION OF ALL PROPOSED UTILITIES MUST BE POINT OF CONNECTION TO THE EXISTING UTILITY OR A LOWEST POINT IN THE SYSTEM. RIMS, GRATES, INVERT CLEARANCES, AND LOCATION AT CROSSINGS MUST BE PRIOR TO THE BEGINNING OF CONSTRUCTION.
- 19. MAINTAIN FLOW FOR ALL EXISTING UTILITIES.
- 20. ALL FRAMES/COVERS WITHIN PAVED AREAS SHALL HAVE SET FLUSH WITH THE EXISTING PAVEMENT GRADE. IN LANDSCAPED AREAS, ALL FRAMES SHALL BE 0.1' ABOVE
- 21. THE CONTRACTOR SHALL BE RESPONSIBLE FOR PROVI FIELD LAYOUT. THE CONTRACTOR SHALL TAKE TIES TO UTILITY CONNECTIONS AND PROVIDE MARKED-UP AS-B FOR ALL UTILITIES SHOWING TIES TO CONNECTIONS, BE VALVES, LENGTHS OF LINES, AND INVERTS. AS-BUILT F SHOWING ALL UNDERGROUND UTILITIES INSTALLED OR ENCOUNTERED SHALL BE REVIEWED BY THE OWNER AN REPRESENTATIVES. THE CONTRACTOR SHALL PROVIDE CORRECTION OR ADMISSIONS TO THE SATISFACTION O OWNER AND HIS REPRESENTATIVES BEFORE UTILITIES ACCEPTED.
- 22. TEMPORARY PAVEMENT SHALL BE PLACED WITHIN 48 H COMPLETION OF EXCAVATION AND BACKFILL OPERATION THE EXISTING PAVEMENT LIMITS.
- 23. CONTRACTOR SHALL MAINTAIN ALL TRAFFIC IN ALL ARE ACCORDANCE WITH THE TEXAS MANUAL OF UNIFORM T CONTROL DEVICES.
- 24. ALL EXCAVATIONS SHALL BE BACKFILLED TO EXISTING THE END OF EACH WORK DAY.
- 25. CONTRACTOR SHALL TAKE CARE TO PREVENT DAMAGE EXISTING UTILITIES. DAMAGED UTILITIES SHALL BE IMME REPAIRED BY CONTRACTOR AT THE CONTRACTOR'S EXP CONSTRUCTION NOTES
- 1. BUILDING SILL ELEVATIONS AND SEWER INVERTS ARE APPROXIMATE AND SHOULD BE CONFIRMED BY THE CON PRIOR TO THE COMMENCEMENT OF WORK.
- 2. THE MINIMUM SLOPE FOR SANITARY SEWER LATERALS 0.010 FT/FT.
- 3. PROGRESSION OF WORK: IN GENERAL WORK SHALL PRO FROM THE DOWNSTREAM END OF A SEWER LINE SEGME UPSTREAM END OF THE SEGMENT.
- 4. THE MAXIMUM LENGTH OF OPEN TRENCH SHALL BE LIM MORE THAN THREE PIPE LENGTHS IN A SEWER SEGMEN
- 5. THE MINIMUM TRENCH WIDTH SHOULD BE NO LESS THA INCHES OR ONE FOOT GREATER THAN OUTSIDE DIAMET PIPE, WHICHEVER IS GREATER.
- 6. THE MINIMUM DEPTH OF COVER ABOVE THE TOP OF PIP WATER LINE INSTALLATIONS SHALL BE 4 FEET.
- 7. WATER MAINS AND SERVICES: LOCATIONS SHOWN ARE APPROXIMATE AND ARE INDICATED FOR GENERAL REFI ONLY UNLESS OTHERWISE NOTED.
- 8. ALL EXISTING UNDERGROUND FEATURES SUCH AS SEP LEACH FIELDS, SANITARY SEWERS, ETC, ARE APPROXIN AND ARE INDICATED FOR GENERAL REFERENCE AND DE UNLESS OTHERWISE NOTED.
- 9. WORK IN PRIVATE PROPERTY: THE CONTRACTOR SHAL WRITTEN AUTHORIZATION FROM THE OWNER PRIOR TO WORK IN ANY PRIVATELY OWNED AREAS WHICH WILL RI EASEMENTS FOR CONSTRUCTION. SOIL PREPARATION AND GRADING NOTES
- 1. THE SOIL BENEATH THE PAVEMENT SHALL BE TREATED FOLLOWS:
- REMOVE ALL VEGETATION, ORGANIC MATERIAL OF Α. DELETERIOUS MATERIALS.
- PERFORM ANY CUT OPERATIONS AS NEEDED AND ROLL THE PAVEMENT AREAS WITH A FULLY LOADE AXLE DUMP TRUCK. ANY AREAS WHICH RUT EXCE OR PUMP SHALL BE UNDERCUT AND REPLACED WI COMPACTED FILL
- PERFORM ALL FILL OPERATIONS. ALL FILL SHALL **INSTALLED IN MAXIMUM 8 INCH LIFTS AND COMPA** LEAST 93% OF THE MAXIMUM DENSITY AS DETERM ASTM D 698 (STANDARD PROCTOR), AND TO AT LE PERCENTAGE POINTS OF ITS OPTIMUM MOISTURE
- D DO NOT USE ANY SAND AS FILL UNDER THE PAVE ANY IMPORTED FILL SHALL BE SIMILAR TO THE ON AND APPROVED BY EIKON CONSULTING GROUP.
- 2. SITE SHALL BE GRADED TO ASSURE DRAINAGE OF SURF WATER FROM BUILDINGS.
- 3. REMOVE EXCESS SOILS FROM THE SITE AND LEGALLY D THE SOILS.
- 4. GRADES NOT OTHERWISE INDICATED ON THE PLANS SH UNIFORM LEVELS OR SLOPES BETWEEN POINTS WHERE ELEVATIONS ARE GIVEN. ABRUPT CHANGES IN SLOPES WELL ROUNDED. THE CONTRACTOR IS RESPONSIBLE F POSITIVE SITE DRAINAGE.
- 5. ALL SITE EXCAVATION SHALL BE CONSIDERED UNCLASS EXCAVATION.
- 6. THE EXISTING GRADES AND CONTOURS SHOWN IN THES REPRESENT THE ELEVATIONS AS INDICATED ON THE TOPOGRAPHIC SURVEY BY EAGLE SURVEYING ON 10/1 TO MANY FACTORS INCLUDING POSSIBLE DISTURBANCE SOIL OR BENCH MARKS BY OTHER PARTIES AND THE EXPANSIVE/SHRINKAGE NATURE OF THE SOIL, THE ELEY MAY BE SIGNIFICANTLY DIFFERENT IN THE FUTURE (INC THE BENCH MARKS). NORMAL EQUIPMENT AND MEASUF ACCURACIES SHOULD BE TAKEN INTO ACCOUNT WHEN USING THESE ELEVATIONS. REFER TO THE GEOTECHNICAL INVESTIGATION FOR THE GEOTECHNICAL RAMIFICATIONS.

PLOTTED BY: MARIA PAZ DATE: 11/13/2024 2:56 PM DWG NAME: P:\2024\240117 SABLE CROSSING - SANGER TOWN CENTER SOUTH\CAD\CIVIL\04\_SHEETS\C0.00 COVER SHEET.DWG LAST SAVED BY: BRANSONBURGER DATE: 11/13/2024 2:18 PM

EGIN AT ITS AT THE	7.	ALL SLOPES IN UNPAVED AREAS SHALL BE 3:1 OR FLATTER UNLES OTHERWISE NOTED.	ss <u>SI</u>	TE UTILITY NOTES
TS, E VERIFIED	-	REFER TO THE GEOTECHNICAL REPORT FOR COMPLETE INFORMATION ON SOIL CHARACTERISTICS AND ANY OTHER RECOMMENDATIONS NOT CONTAINED HEREIN. VING NOTES	1.	THE CONTRACTOR SHALL BE RESPONSIBLE FOR UTILITIES, WHETHER PRIVATE OR PUBLIC, PRIOR THE INFORMATION AND DATA SHOWN WITH RESF UNDERGROUND FACILITES AT OR CONTIGUOUS T APPROXIMATE AND BASED ON THE INFORMATION
AVE THE TOPS		REFER TO GRADING PLAN FOR SOIL PREPARATION SPECIFICATIONS UNDER PAVEMENT		FURNISHED BY THE OWNERS OF SUCH UNDERGR OR ON PHYSICAL APPEARANCES OBSERVED IN T OWNER AND ENGINEER SHALL NOT BE RESPONS
/E GRADE. /IDING ALL O ALL BUILT PLANS BENDS, PLANS PR	2.	CONCRETE FOR THE CONCRETE PAVEMENT SHALL HAVE A 28 DAY DESIGN COMPRESSIVE STRENGTH OF 3,500 PSI, 7 MINIMUM OF 5.5 SACKS OF PORTLAND CEMENT PER CUBIC YARD, 20% CLASS C FLYASH, 4% TO 6% AIR CONTENT USING AIR ENTRAINING AGENT A REQUIRED, MID RANGE WATER REDUCING AGENT AND A 5-6" SLUMP.	5	ACCURACY OR COMPLETENESS OF ANY SUCH IN DATA; AND THE CONTRACTOR SHALL HAVE FULL FOR REVIEWING AND CHECKING ALL SUCH INFOR DATA, FOR LOCATING ALL UNDERGROUND FACILI COORDINATION OF THE WORK WITH THE OWNER UNDERGROUND FACILITIES DURING CONSTRUCT SAFETY AND PROTECTION THEREOF, AND REPAIR
AND HIS DE ANY OF THE S WILL BE	3.	CONCRETE FOR PRIVATE SIDEWALKS, CURBS, GUTTERS AND DRAINAGE STRUCTURES SHALL HAVE A 28 DAY DESIGN COMPRESSIVE STRENGTH OF 3,000 PSI, A MINIMUM OF 5 SACKS C CEMENT PER CUBIC YARD, 4% TO 6% AIR CONTENT USING AIR ENTRAINING AGENT AS REQUIRED, 20% CLASS C FLYASH A 5-6 IN SLUMP. REFER TO CITY OF LINDSAY AND/OR NCTCOG CONSTRUCTION SPECIFICATIONS FOR ALL PUBLIC IMPROVEMENT		THERETO RESULTING FROM THE WORK, THE COS WHICH WILL BE CONSIDERED AS HAVING BEEN IN CONTRACT PRICE. CONTRACTOR SHALL VERIFY I ELEVATIONS OF EXISTING UTILITIES PRIOR TO CO CONTRACTOR SHALL NOTIFY ANY AFFECTED UTIL TRACTOR SHALL NOTIFY ANY AFFECTED UTIL TRACTOR SHALL NOTIFY ANY AFFECTED UTIL CONTRACTOR SHALL NOTIFY ANY AFFECTED UTIL
HOURS OF IONS WITHIN	4.	THE MID RANGE WATER REDUCING AGENT ADMIXTURE	of 4,000 psi reinfoi on a compacted si	CEC CONCRETE PAYEMENTE CONSTRUCTED IN ACCOUNT OF THE CONSTRUCTED INTO ACCOUNT OF THE CONSTRUCTED INTO ACCOUNT OF THE CONSTRUCTED INTO ACCOUNT OF THE CONSTRU
REAS IN I TRAFFIC G GRADE AT		FROM ONE OF THE FOLLOWING (OR APPROVED EQUAL): EUCON X-20 OR EUCON MR BY EUCLID SIKAMENT NL BY SIKA PLASTIMIX MR BY PROMIX TECHNOLOGIES MIRA 85 BY W.R.GRACE AND CO. POLYHEED 1020 BY DEGUSSA ADMIXTURES		NCTCOG STANDARDS. THE SITE UTILITY CONTRACTOR SHALL PROVIDE MATERIALS AND APPURTENANCES NECESSARY F COMPLETE INSTALLATION OF THE UTILITIES. ALL FITTINGS SHALL BE INSPECTED BY THE CITY INSF REINC COVERED
GE TO MEDIATELY		THE AMOUNT OF MID RANGE WATER REDUCER SHALL BE AS RECOMMENDED BY THE ADMIXTURE SUPPLIER TO INCREASE THE		BEING COVERED. ALL WORK SHALL COMPLY WITH ALL APPLICABLE REGULATIONS, AND/OR LOCAL STANDARDS AND
XPENSE.		SLUMP OF THE CONCRETE BY 50 PERCENT OVER THE SLUMP WITHOUT THE ADMIXTURE. THE SLUMP GIVEN IN THE CONCRETE NOTES ARE AT THE POINT OF DISCHARGE.		THE SITE UTILITY CONTRACTOR SHALL MAKE ARE WITH THE <utility owner=""> FOR THE CONNECTI EXISTING WATER MAIN.</utility>
ONTRACTOR S SHALL BE	5.	IF THE AIR TEMPERATURE IS GREATER THAN 90 DEGREES WITHIN 24 HOURS AFTER PLACEMENT, HOT WEATHER CONCRETE PROCEDURES SHALL BE USED. THE CONTRACTOR SHALL SUBMIT A PROCEDURE TO THE ENGINEER FOR APPROVAL. THESE	6.	THE CONTRACTOR SHALL ADJUST THE LOCATION PROPOSED WATER LINES AS REQUIRED TO AVOID THE OTHER UTILITIES.
ROCEED MENT TO THE		<ul> <li>PROCEDURES MAY INCLUDE THE FOLLOWING:</li> <li>A. PLACING THE CONCRETE IN THE EARLY MORNING HOURS</li> <li>B. THE USE OF EVAPORATION REDUCER (SEE BELOW)</li> <li>C. THE USE OF MISTING AS A CURING METHOD</li> </ul>	7.	THRUST BLOCKS SHALL BE PROVIDED AT ALL TER BENDS, AND WILL BE OF SUFFICIENT SIZE TO CON STANDARDS FOR EXISTING SOIL CONDITIONS.
MITED TO NO ENT.	6.	<ul><li>D. THE USE OF WET BLANKETS AS A CURING METHOD</li><li>E. THE USE OF A RETARDING ADMIXTURE (NOT PREFERABLE)</li><li>ANY CONCRETE TO BE PLACED FURTHER THAN 16 FEET FROM THE</li></ul>		ALL FIRE PROTECTIONS MATERIAL SHALL BE U.L. MUTUAL APPROVED, AND NFPA STANDARDS, UNL DIRECTED BY THE PROJECT MANAGER.
IAN 24 ETER OF THE		END OF A CONCRETE TRUCK SHALL BE PUMPED WITH A COMMERCIAL CONCRETE PUMPING TRUCK OR OTHER PLACEMEN METHOD APPROVED BY THE ENGINEER. THE CONCRETE TRUCK SHALL NOT BE ALLOWED TO DRIVE OVER THE SUBGRADE OR THE		THE LOCATION (HORIZONTAL & VERTICAL) OF ALL TO THE BUILDING SHALL BE VERIFIED WITH THE E MECHANICAL PLANS.
PIPE FOR		PAVEMENT REINFORCEMENT UNLESS APPROVED BY THE ENGINEER.	-	MATCH ALL MANHOLES AND VAULTS WITH PROPO ELEVATIONS.
E FERENCE		REINFORCING STEEL SHALL BE NEW DOMESTIC DEFORMED BILLE STEEL CONFORMING TO A.S.T.M. A-615 GRADE 60.		UNDERGROUND TELEPHONE LINE SHALL BE WITH BURIED A MINIMUM OF 24", AND TERMINATING AT
EPTIC TANKS, IMATE ONLY DESIGN	8.	REINFORCING BARS, BAR SUPPORTS, AND SPACERS SHALL BE DETAILED AND PROVIDED IN ACCORDANCE WITH THE A.C.I. DETAILING MANUAL. CHAIRS SHALL NOT BE PLACED FURTHER THAN 4 FEET APART. BAR SUPPORTS SHALL BE THE FOLLOWING DAYTON/RICHMOND PRODUCTS (800-745-3703) OR EQUAL:	12.	WITH PULL STRING AND FLAG. CONTRACTOR SHALL NOTIFY THE UTILITY AUTHO INSPECTORS 72 HOURS BEFORE CONNECTING TO LINE.
LL OBTAIN		A. AT CONCRETE PAVEMENT: (CONCRETE THICKNESS MINUS 1 1/2 INCHES) HIGH, TYPE R21, OR TYPE BBP	13.	ALL FILL MATERIAL IS TO BE IN PLACE AND COMP INSTALLATION OF PROPOSED UTILITIES.
O BEGINNING REQUIRE	9.	MASTER BUILDERS CONFILM OR EUCOBAR EVAPORATION REDUCERS SHALL BE USED AFTER EACH FINISHING OPERATION O THE CAST-IN-PLACE CONCRETE PAVEMENT UNLESS PRIOR APPROVAL FROM THE ENGINEER HAS BEEN OBTAINED TO NOT US	DN	WATER & SANITARY SEWER UTILITIES SHALL BE A (10') APART (PARALLEL) OR WHEN CROSSING 24" CLEARANCE (OUTSIDE EDGE OF PIPE TO OUTSIDE UNLESS OTHERWISE NOTED.)
ED AS	10.	THIS PRODUCT. SAWCUTS IN CONCRETE PAVEMENT SHALL BE MADE AS SOON AS	15.	LINES UNDERGROUND SHALL BE INSTALLED, INSP APPROVED BEFORE BACKFILLING.
OR OTHER ND PROOF DED TANDEM		THE CONCRETE IS OF SUFFICIENT STRENGTH TO SAW WITHOUT RAVELING THE AGGREGATE. ANY TIME LAPSE GREATER THAN 8 HOURS AFTER PLACING THE CONCRETE SHALL BE PERMITTED ONLY IF APPROVED BY THE ENGINEER.	16.	TOPS OF EXISTING MANHOLES SHALL BE RAISED TO BE FLUSH WITH PROPOSED PAVEMENT ELEVA ONE FOOT ABOVE FINISHED GROUND ELEVATION TIGHT LIDS.
CESSIVELY WITH	11.	NO PIPING OR CONDUITS SHALL BE INSTALLED IN ANY CONCRETE WITHOUT THE APPROVAL OF THE ENGINEER.		ALL CONCRETE FOR ENCASEMENT SHALL HAVE A COMPRESSION STRENGTH AT 3000 P.S.I.
L BE ACTED TO AT RMINED BY LEAST +3	12.	PAVING CONTRACTOR IS RESPONSIBLE FOR ALL LAY DOWN CURB AT INTERSECTIONS WHERE BARRIER FREE RAMPS ARE TO BE CONSTRUCTED.		CONTRACTOR SHALL MAINTAIN A MINIMUM OF 48 FINISHED GRADE ON ALL WATERLINES.
RE CONTENT. EMENT. DN SITE SOILS	13.	THE CONTRACTOR SHALL PROVIDE, CONSTRUCT AND MAINTAIN BARRICADES AND SIGNS IN ACCORDANCE WITH THE TEXAS MANUAL OF UNIFORM TRAFFIC CONTROL DEVICES.	19.	ALL NECESSARY INSPECTIONS AND/OR CERTIFIC BY CODES AND/OR UTILITY SERVICE COMPANIES POSSESSION BEFORE THE FINAL CONNECTION O
RFACE		SAWCUTS SHALL HAVE A MAXIMUM SPACING OF 15' EACH WAY.	20	. CONTRACTOR SHALL COORDINATE WITH ALL UTIL FOR INSTALLATION REQUIREMENTS AND SPECIFI
' DISPOSE OF SHALL BE RE S SHALL BE	15.	EXPANSION JOINTS SHALL BE SMOOTH DOWEL JOINTS WITH THE PAVEMENT THICKNESS INCREASED BY 25%. ONE END OF DOWELS TO BE GREASED AND CAPPED AND USE 1" EXPANSION JOINT MATERIAL IN THE JOINT. REDWOOD OR OTHER RIGID MATERIAL SHOULD BE AVOIDED. SPACE EXPANSION JOINTS BETWEEN 80' AND 100' APART AND AT ALL LOCATIONS IN WHICH LARGE PAVEMENT SECTIONS INTERSECT SMALLER SECTIONS.		IN THE EVENT OF VERTICAL CONFLICT BETWEEN SANITARY LINES, STORM LINES AND GAS LINES (E PROPOSED), THE SANITARY LINE SHALL BE DUCT WITH MECHANICAL JOIST AT LEAST 10 FEET ON B CROSSING. THE WATERLINE SHALL HAVE MECHA
FOR	16.	ALL JOINTS & SAWCUTS MUST BE SEALED WITH A BITUMINOUS JOINT SEALANT OR APPROVED EQUAL.		WITH APPROPRIATE THRUST BLOCKING AS REQU A MINIMUM OF 24" CLEARANCE. MEETING REQUIR A21.10 OR A21.11 (AWWA C-151) (CLASS 50).
SSIFIED	17.	IT WILL BE THE CONTRACTOR'S RESPONSIBILITY TO ACQUIRE ALL NECESSARY PERMITS FROM THE CITY OF SANGER AND TXDOT	22.	. OWNER/CONTRACTOR SHALL COORDINATE WITH MARSHALL TO PROVIDE ANY ADDITIONAL FIRE SA INCLUDING FIRE HYDRANTS, NOT SHOWN AND NO
IESE PLANS 11/2024. DUE	18.	BEFORE CONSTRUCTION WITHIN CITY RIGHT-OF-WAY. ALL DIMENSIONS ARE TO BACK OF CURB, UNLESS OTHERWISE NOTED.		INCLUDING FIRE HYDRANTS, NOT SHOWN AND NO OF CHANGES.
CE OF THE EVATIONS ICLUDING UREMENT N USING	19.	GREASE TRAPS, MANHOLES, AND VALVE COVERS IN PAVED AREAS SHALL BE TRAFFIC BEARING AND RIM ELEVATIONS SHALL MATCH FINAL PAVING ELEVATION.	s —	ROSION CONTROL NOTES THE CONTRACTOR SHALL BE RESPONSIBLE FOR UTILITIES, WHETHER PRIVATE OR PUBLIC, PRIOR THE INFORMATION AND DATA SHOWN WITH RESF UNDERGROUND FACILITIES AT OR CONTIGUOUS

R LOCATING ALL OR TO EXCAVATING. SPECT TO EXISTING S TO THE SITE IS ON AND DATA GROUND FACILITIES I THE FIELD. THE **NSIBLE FOR THE** INFORMATION OR L RESPONSIBILITY ORMATION AND ILITIES, FOR ERS OF SUCH CTION, FOR THE AIRING ANY DAMAGE OST OF ALL OF INCLUDED IN THE Y LOCATION AND CONSTRUCTION TILITY COMPANIES EGINNING

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A MINIMUM 28-DAY

48" COVER BELOW

FICATIONS REQUIRED ES SHALL BE IN OF SERVICE.

TILITY COMPANIES FICATIONS.

EN WATERLINES, (EXISTING AND CTILE IRON PIPE BOTH SIDES OF HANICAL JOINTS QUIRED TO PROVIDE JIREMENTS OF ANSI

TH THE CITY FIRE SAFETY FEATURES, NOTIFY ENGINEER

OR LOCATING ALL OR TO EXCAVATING. ESPECT TO EXISTING UNDERGROUND FACILITIES AT OR CONTIGUOUS TO THE SITE IS APPROXIMATE AND BASED ON THE INFORMATION AND DATA

FURNISHED BY THE OWNERS OF SUCH UNDERGROUND FACILITIES OR ON PHYSICAL APPEARANCES OBSERVED IN THE FIELD. THE OWNER AND ENGINEER SHALL NOT BE RESPONSIBLE FOR THE ACCURACY OR COMPLETENESS OF ANY SUCH INFORMATION OR DATA; AND THE CONTRACTOR SHALL HAVE FULL RESPONSIBILITY FOR REVIEWING AND CHECKING ALL SUCH INFORMATION AND DATA. FOR LOCATING ALL UNDERGROUND FACILITIES. FOR COORDINATION OF THE WORK WITH THE OWNERS OF SUCH UNDERGROUND FACILITIES DURING CONSTRUCTION, FOR THE SAFETY AND PROTECTION THEREOF, AND REPAIRING ANY DAMAGE THERETO RESULTING FROM THE WORK, THE COST OF ALL OF WHICH WILL BE CONSIDERED AS HAVING BEEN INCLUDED IN THE CONTRACT PRICE. CONTRACTOR SHALL VERIFY LOCATION AND ELEVATIONS OF EXISTING UTILITIES PRIOR TO CONSTRUCTION. CONTRACTOR SHALL NOTIFY ANY AFFECTED UTILITY COMPANIES OR AGENCIES AT LEAST 48 HOURS PRIOR TO BEGINNING CONSTRUCTION.

- 2. EROSION CONTROL MEASURES MAY ONLY BE PLACED IN FRONT OF INLETS, OR IN CHANNELS, DRAINAGEWAYS OR BORROW DITCHES AT RISK OF CONTRACTOR. CONTRACTOR SHALL REMAIN LIABLE FOR ANY DAMAGE CAUSED BY THE MEASURES, INCLUDING FLOODING DAMAGE, WHICH MAY OCCUR DUE TO BLOCKED DRAINAGE. AT THE CONCLUSION OF ANY PROJECT. ALL CHANNELS. DRAINAGEWAYS AND BORROW DITCHES IN THE WORK ZONE SHALL BE DREDGED OF ANY SEDIMENT GENERATED BY THE PROJECT OR DEPOSITED AS A RESULT OF EROSION CONTROL MEASURES.
- 3. LAND DISTURBING ACTIVITIES SHALL NOT COMMENCE UNTIL APPROVAL TO DO SO HAS BEEN RECEIVED BY GOVERNING AUTHORITIES (INCLUDING STORM WATER POLLUTION PREVENTION PLAN.) THE GENERAL CONTRACTOR SHALL STRICTLY ADHERE TO THE APPROVED TPDES SWPPP DRAWINGS DURING CONSTRUCTION OPERATIONS.
- 4. PRIOR TO COMMENCING ANY CONSTRUCTION, A CONSTRUCTION ENTRANCE AND PERIMETER SILT FENCE SHALL BE INSTALLED AT THE LOCATIONS SHOWN, OR AS DESCRIBED IN THE SWPPP.
- 5. THE CONTRACTOR IS RESPONSIBLE FOR COMPLYING WITH ALL EROSION CONTROL MEASURES SHOWN ON THE PLANS. THE EROSION CONTROL SYSTEM DESCRIBED WITHIN THE CONSTRUCTION DOCUMENTS SHOULD BE CONSIDERED TO REPRESENT THE MINIMUM ACCEPTABLE STANDARDS FOR THIS PROJECT. ADDITIONAL EROSION CONTROL MEASURES MAY BE REQUIRED DEPENDENT UPON THE STAGE OF CONSTRUCTION, THE SEVERITY OF THE RAINFALL EVENT AND/OR AS DEEMED NECESSARY AS A RESULT OF ON-SITE INSPECTIONS BY THE OWNER, THEIR REPRESENTATIVES OR THE JURISDICTIONAL AUTHORITIES. THESE ADDITIONAL MEASURES SHALL BE INSTALLED AT NO ADDITIONAL COST TO THE OWNER. IT IS THE CONTRACTOR'S ULTIMATE RESPONSIBILITY TO ASSURE THAT THE STORM WATER DISCHARGE FROM THE SITE DOES NOT EXCEED THE TOLERANCES ESTABLISHED BY ANY OF THE JURISDICTIONAL AUTHORITIES.
- 6. IF INSTALLATION OF STORM DRAINAGE SYSTEM SHOULD BE INTERRUPTED BY WEATHER OR NIGHTFALL, THE PIPE ENDS SHALL BE COVERED WITH FILTER FABRIC.
- 7. AS INLETS ARE COMPLETED, TEMPORARY SEDIMENT BARRIERS SHALL BE INSTALLED.
- 8. AT THE COMPLETION OF THE PAVING AND FINAL GRADING, THE DISTURBED AREA(S) SHALL BE RE-VEGETATED IN ACCORDANCE WITH THE SWPPP.
- 9. THE SPECIFIC PLANT MATERIALS PROPOSED TO PROTECT FILL AND EXCAVATED SLOPES SHALL BE AS INDICATED WITHIN THE SWPPP. PLANT MATERIALS MUST BE SUITABLE FOR USE UNDER LOCAL CLIMATE AND SOIL CONDITIONS. IN GENERAL, HYDROSEEDING OR SODDING BERMUDA GRASS IS ACCEPTABLE DURING THE SUMMER MONTHS (MAY 1 TO AUGUST 30). WINTER RYE OR FESCUE GRASS MAY BE PLANTED DURING TIMES OTHER THAN THE SUMMER MONTHS AS A TEMPORARY MEASURE UNTIL SUCHTIME AS THE PERMANENT PLANTING CAN BE MADE.
- 10. SILT FENCE AND INLET SEDIMENT BARRIERS SHALL REMAIN IN PLACE UNTIL RE-VEGETATION HAS BEEN COMPLETED.
- 11. DISTURBED AREAS THAT ARE SEEDED OR SODDED SHALL BE CHECKED PERIODICALLY TO SEE THAT GRASS COVERAGE IS PROPERLY MAINTAINED. DISTURBED AREAS SHALL BE WATERED. FERTILIZED, AND RESEEDED OR RESODDED, IF NECESSARY. GENERAL CONTRACTOR SHALL BE RESPONSIBLE TO TAKE WHATEVER MEANS NECESSARY TO ESTABLISH PERMANENT SOIL STABILIZATION.
- 12. SEDIMENT SHALL BE REMOVED FROM THE SEDIMENT BASIN BEFORE IT IS 50% FULL, IF IMPLEMENTED BY THE SWPPP.
- 13. FREQUENT INSPECTIONS OF THE SILT FENCE SHALL BE MADE, ALL REPAIRS OR REPLACEMENTS SHALL BE MADE IMMEDIATELY.
- 14. THE CONTRACTOR SHALL INSPECT HIS STABILIZATION AND **EROSION CONTROL MEASURES AT MINIMUM OF ONCE EVERY 14** DAYS, AND WITHIN 24 HOURS OF ANY STORM EVENT GREATER THAN 0.5 INCHES. THE CONTRACTOR SHALL REPAIR INADEQUACIES REVEALED BY THE INSPECTION BEFORE THE NEXT STORM EVENT AND SHALL MODIFY HIS SWP3 WITHIN 7 DAYS OF THE INSPECTION. ACCUMULATED SILT SHALL BE REMOVED AND DISPOSED OF WHEN IT REACHES A DEPTH OF SIX (6) INCHES.
- 15. CONTRACTOR SHOULD ATTAIN A 75% BERMUDA COVERING BY SEEDING OR SODDING OVER ALL AFFECTED CONSTRUCTION AREAS BEFORE EROSION CONTROL CAN BE REMOVED.
- 16. CONTRACTOR IS RESPONSIBLE FOR PREPARING, FILING, & MAINTAINING THE SWPPP & THE NOI.
- 17. WHERE SILT FENCE CAN NOT BE USED, THE CONTRACTOR MAY SUBSTITUTE WITH THE FOLLOWING: -TRIANGULAR SEDIMENT FILTER DIKE PER NCTCOG SPEC 1050A -"TEXAS POWER MULCH" MULCH FILLED FILTER SOCK
- 18. THE CONTRACTOR SHALL REFER TO EROSION CONTROL NARRATIVE AND SWPPP COORDINATION/INVESTIGATION DOCUMENTATION PROVIDED BY OTHERS FOR APPROPRIATE EROSION CONTROL MEASURES AND PROCEDURES FOR THIS BENCHMARKS: PROJECT.



500 Moseley Rd Cross Roads, TX 76277 Phone 940-387-0805 Fax 940-387-0830

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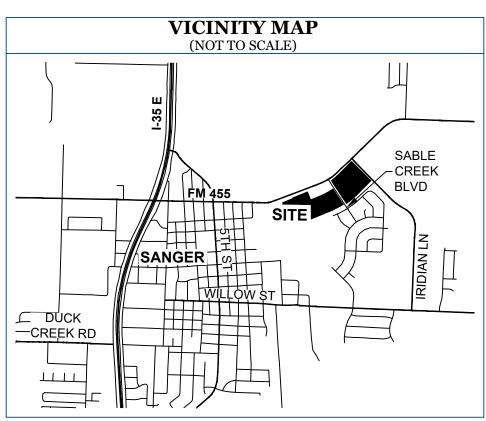



Issued Date:	11/12/2024
Project No:	240117
Drawn By:	RP
Checked By:	IN
Designed By:	IN
Issue Re	cord
# Description	Date

**GENERAL NOTES** 

TBM X-CUT N:7182983.6 E:2376464.4 ELEV:682.2'

TBM X-CUT TBM X-CUT N:7182732.0 N:7182983.6 E:2376692.0 E:2376464.4 ELEV:683.2' ELEV:682.2'



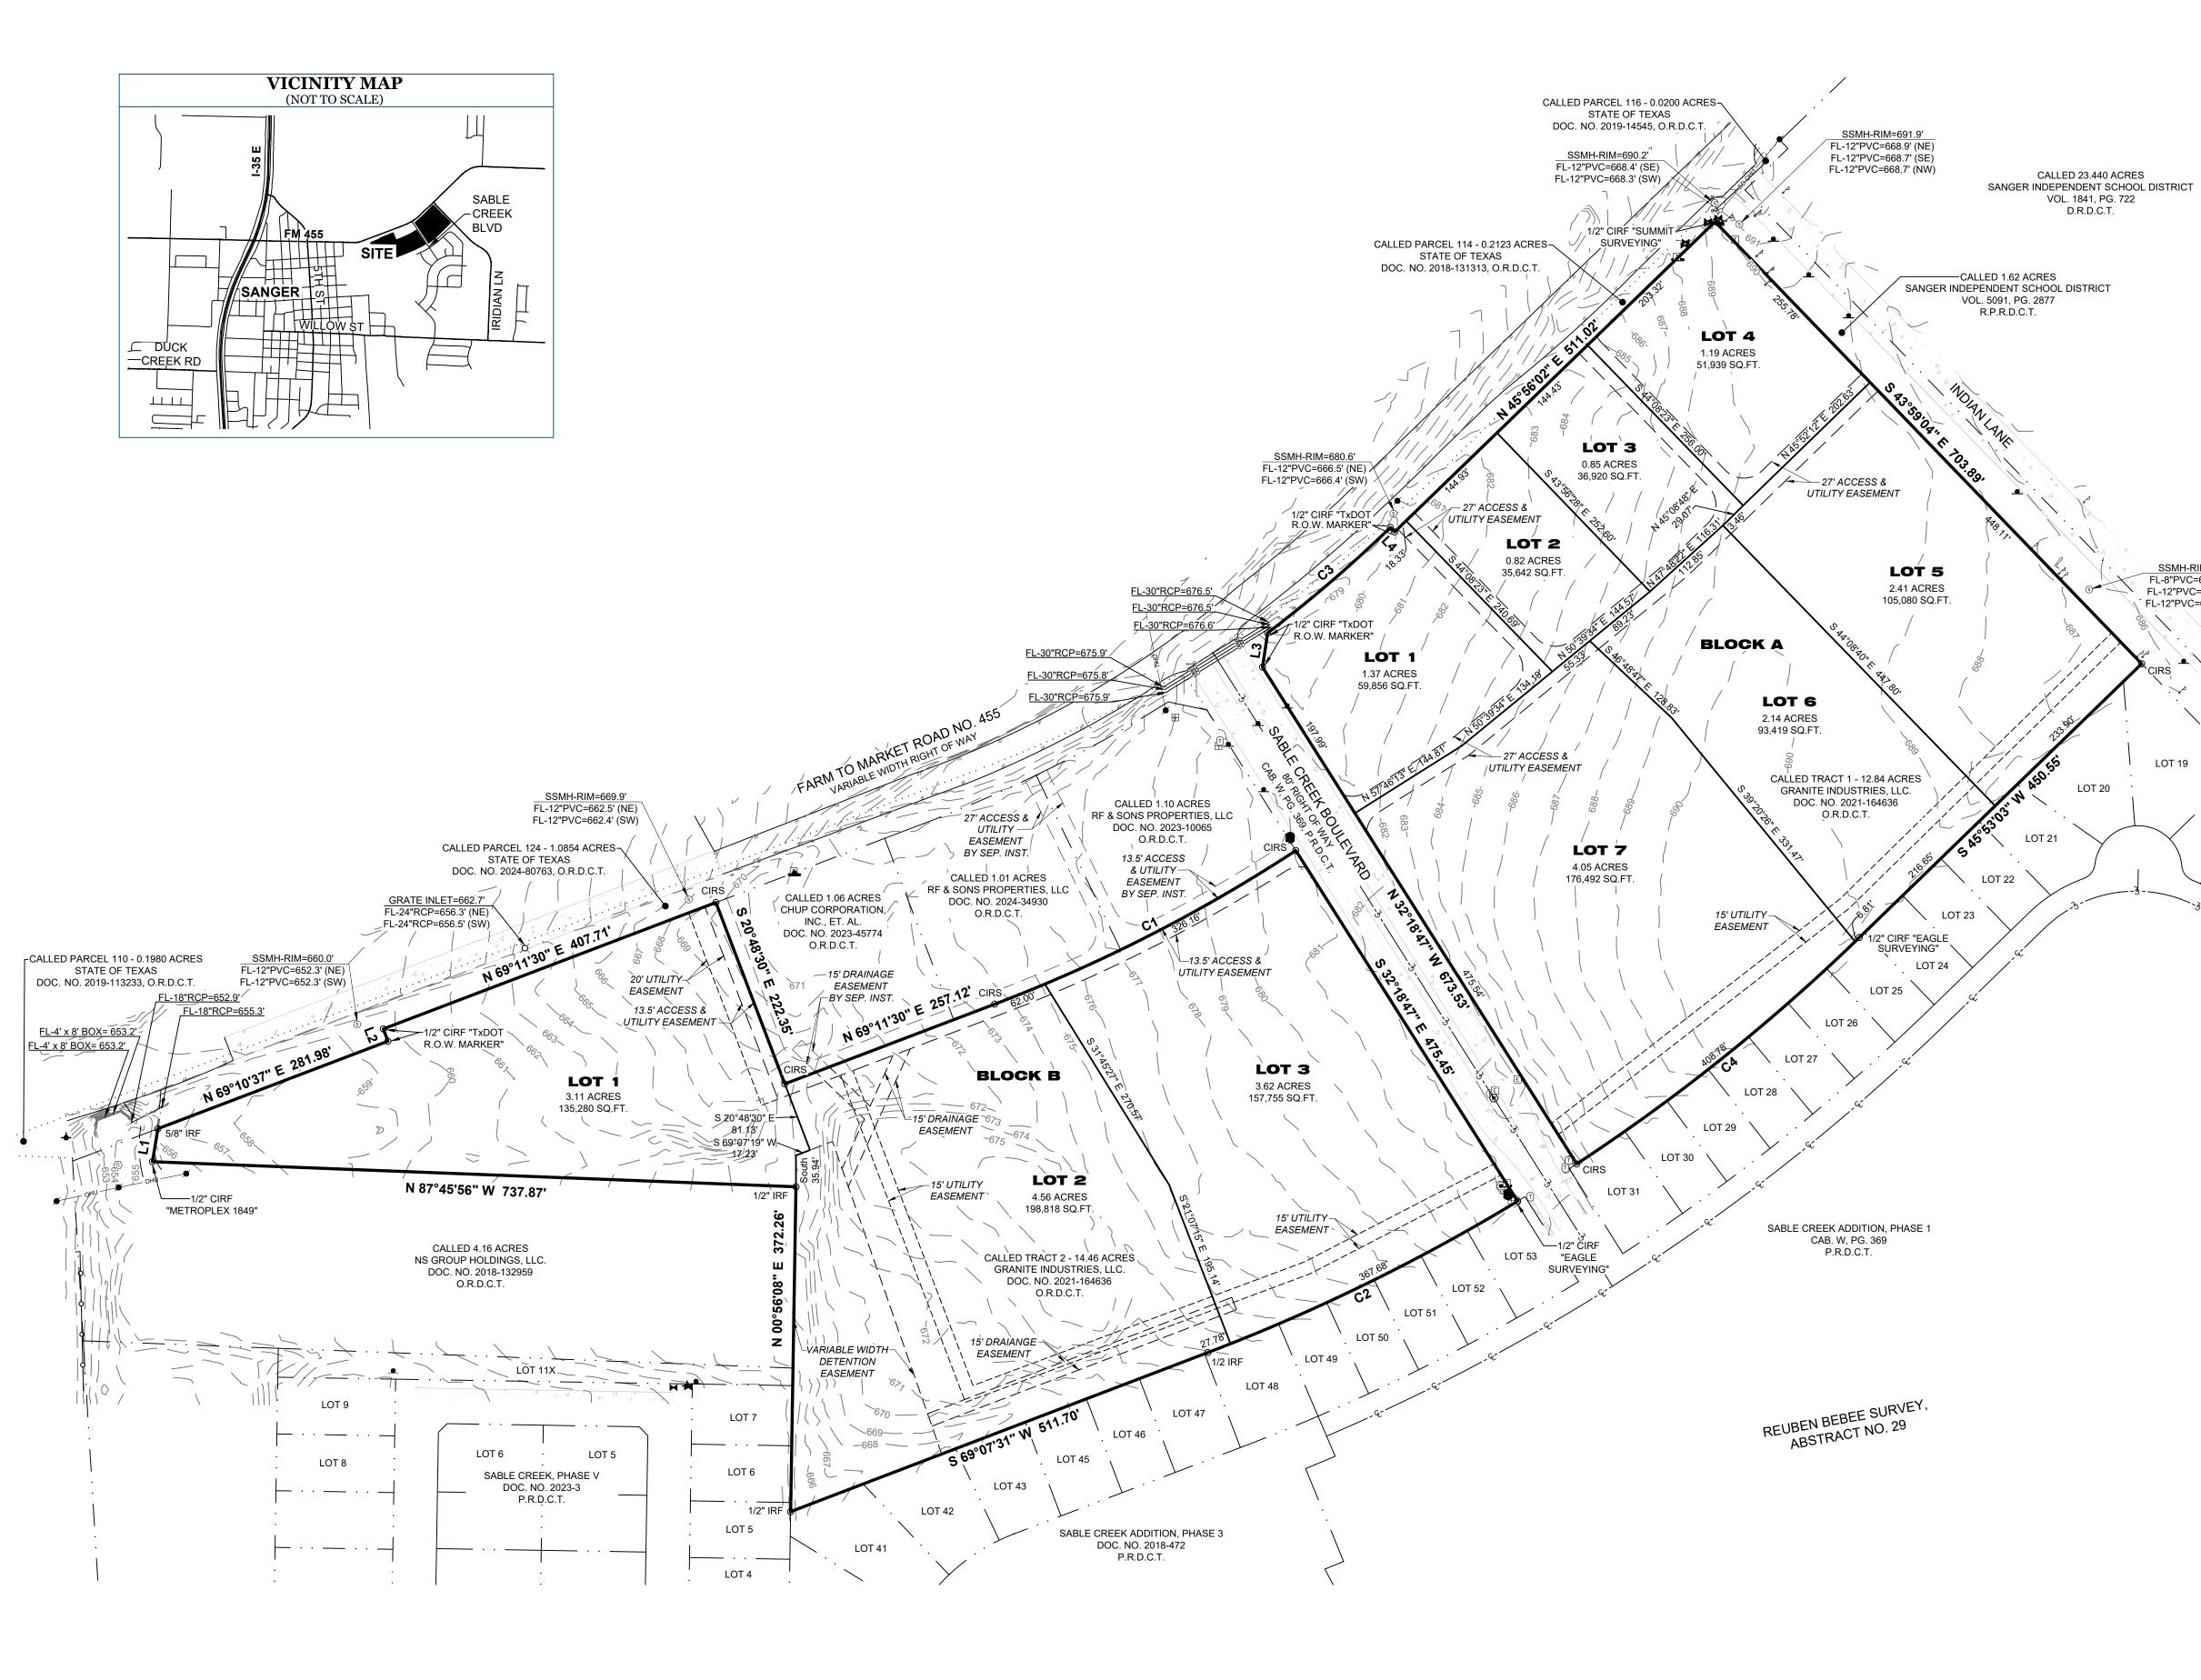

Eagle Surveying, LLC JOB NUMBER 222 South Elm Street 1802.021-xx Electric Bo Cable Ris Electric Mete DATE Suite: 200 E Buried Cable Si lecommunications Vau E Electric Vault Fiber Optic Utility Sign Gas Meter 11/12/2024 Denton, TX 76201  $\blacksquare$ Electric Transforme Felecommunications Utility Mark Buried Gas Utility Sign REVISION C 940.222.3009 Guy Wire Gas Utility Mark Water Meter Power Pole Water Valve H www.eaglesurveying.com ъ Light Pole Sanitary Manhole - **•**-Fire Hydrant SURVEYING DRAWN BY \_\_\_\_\_Sign Ø Grate Inlet TX Firm # 10194177 TAR

-


LEGEND					
—— они ——	Overhead Utilities	4	Concrete	VOL.	Volume
SD	Storm Drain Line	<u>1697</u>	Stone	PG.	Page
	Edge of Asphalt	()	Record Call	DOC. NO.	Document Number
<u> </u>	Edge of Gravel	CIRS	1/2" Capped Iron Rod Set Stamped "Eagle Surveying"	D.R.D.C.T.	Deed Records, Denton County, Texas
		CIRF	Capped Iron Rod Found	O.R.D.C.T.	Official Records, Denton County, Texas
		IRF	Iron Rod Found	P.R.D.C.T.	Plat Records, Denton County, Texas
		R.O.W.	Right-of-way	R.P.R.D.C.T.	Real Property Records, Denton County, Texas
0	Boundary Monumentation	CAB.	Cabinet		


SURVEYOR Eagle Surveying, LLC 222 S. Elm Street, Suite: 200 Denton, TX 76201 (940) 222-3009

ENGINEER KJE Contact: Ian Norfolk 500 Moseley Road


Cross Roads, TX 76227

(940) 387-0805

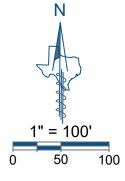

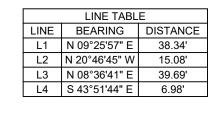


			CURVE TABLE		
CURVE	ARC LENGTH	RADIUS	DELTA ANGLE	CHORD BEARING	CHORD LENGTH
C1	388.16'	1787.35'	12°26'35"	N 62°58'21" E	387.40'
C2	395.46'	2196.52'	10°18'55"	S 63°57'43" W	394.92'
C3	185.39'	1565.00'	6°47'15"	N 49°20'03" E	185.29'
C4	415.59'	2196.52'	10°50'26"	S 51°17'41" W	414.97'

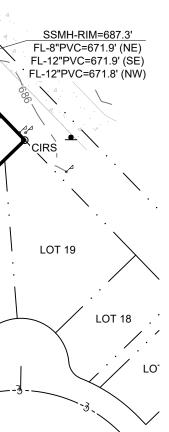

## **GENERAL NOTES**

**1.)** The purpose of this plat is to create ten lots of record from unplatted land.

- 2.) This property is located in Non-Shaded Zone "X" as scaled from the F.E.M.A. Flood Insurance Rate Map dated April 18, 2011 and is located in Community Number 480786 as shown on Map Number 48121C0210G. The location of the Flood Zone is approximate, no vertical datum was collected at the time of the survey. For the exact Flood Zone designation, please contact 1-(877) FEMA MAP.
- 3.) The grid coordinates shown on this plat are based on GPS observations utilizing the AllTerra RTK Network. North American Datum of 1983 (Adjustment Realization 2011).
- 4.) Selling a portion of this addition by metes and bounds is a violation of City Ordinance and State Law, and is subject to fines and/or withholding of utilities and building permits.
- 5.) All interior property corners are marked with a 1/2-inch iron rod with a green plastic cap stamped "EAGLE SURVEYING" unless noted otherwise.
- 6.) The bearings shown on this plat are based on GPS observations utilizing the AllTerra RTK Network. North American Datum of 1983 (Adjustment Realization 2011).
- 7.) The elevations shown on this plat are based on GPS observations utilizing the AllTerra RTK Network. North American Vertical Datum of 1988, (Geoid 12A).
- 9.) Lot to lot drainage shall not be allowed.
- 10.) All lots comply with the minimum size requirements of the zoning district.
- **11.)** This property may be subject to charges related to impact fees and the applicant should contact the city regarding any applicable fees due.
- **12.)** All common areas, drainage easements, and detention facilities will be owned and maintained by the HOA/property owner. Any common area within the city's right-of-way will require a facilities agreement, to be reviewed and approved by the city.
- **13.)** This plat does not alter or remove existing deed restriction, if any, on this property.

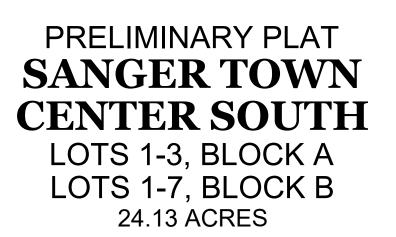

PAGE 1 OF 2

OWNER Granite Industries, LLC 161 W 3rd Street, Suite 110 Prosper, TX 75078


REUBEN BEBEE SURVEY, ABSTRACT NUMBER 29 CITY OF SANGER, DENTON COUNTY, TEXAS

í — —	LINE TABL	F
		_
LINE	BEARING	DISTANCE
L1	N 09°25'57" E	38.34'
L2	N 20°46'45" W	15.08'
L3	N 08°36'41" E	39.69'
L4	S 43°51'44" E	6.98'

	CURVE TABLE						
CURVE	ARC LENGTH	RADIUS	DELTA ANGLE	CHORD BEARING	CHORD LENGTH		
C1	388.16'	1787.35'	12°26'35"	N 62°58'21" E	387.40'		
C2	395.46'	2196.52'	10°18'55"	S 63°57'43" W	394.92'		
C3	185.39'	1565.00'	6°47'15"	N 49°20'03" E	185.29'		
C4	415.59'	2196.52'	10°50'26"	S 51°17'41" W	414.97'		

	TREE TABL	E		TREE TABL	E	TREE TABLE			TREE TABLE		
I.D.	COMMON NAME	DBH (INCHES)	I.D.	COMMON NAME	DBH (INCHES)	I.D.	COMMON NAME	DBH (INCHES)	I.D.	COMMON NAME	DBH
2175	HACKBERRY	8	2203	OAK	6	2230	HACKBERRY	8	2257	HACKBERRY	
2176	HACKBERRY	14	2204	PINE	14	2231	HACKBERRY	6	2258	HACKBERRY	
2177	HACKBERRY	8	2205	PINE	16	2232	HACKBERRY	12	2259	HACKBERRY	
2178	HACKBERRY	10	2206	PINE	14	2233	HACKBERRY	28	2260	HACKBERRY	
2179	HACKBERRY	8	2207	PINE	14	2234	HACKBERRY	26	2261	HACKBERRY	
2180	HACKBERRY	14	2208	LIVE OAK	8	2235	HACKBERRY	6	2262	HACKBERRY	
2181	HACKBERRY	14	2209	OAK	6	2236	HACKBERRY	6	2263	HACKBERRY	
2182	HACKBERRY	8	2210	OAK	6	2237	HACKBERRY	6	2264	HACKBERRY	
2183	HACKBERRY	6	2211	LIVE OAK	8	2238	HACKBERRY	6	2265	HACKBERRY	
2184	HACKBERRY	8	2212	LIVE OAK	6	2239	HACKBERRY	24	2266	HACKBERRY	
2185	HACKBERRY	10	2213	HACKBERRY	26	2240	HACKBERRY	16	2267	HACKBERRY	
2186	HACKBERRY	6	2214	HACKBERRY	10	2241	HACKBERRY	26	2268	HACKBERRY	
2187	HACKBERRY	6	2215	HACKBERRY	14	2242	HACKBERRY	28	2269	HACKBERRY	
2188	HACKBERRY	22	2216	HACKBERRY	6	2243	CEDAR	6	2270	HACKBERRY	
2189	HACKBERRY	8	2217	HACKBERRY	10	2244	HACKBERRY	12	2271	HACKBERRY	
2190	HACKBERRY	12	2218	HACKBERRY	6	2245	HACKBERRY	16	2272	HACKBERRY	
2191	HACKBERRY	14	2219	HACKBERRY	8	2246	HACKBERRY	14	2273	HACKBERRY	
2192	HACKBERRY	24	2220	HACKBERRY	10	2247	HACKBERRY	10	2274	HACKBERRY	
2193	HACKBERRY	6	2221	HACKBERRY	14	2248	HACKBERRY	10	2275	HACKBERRY	
2194	HACKBERRY	6	2222	HACKBERRY	6	2249	HACKBERRY	12	2276	HACKBERRY	
2195	HACKBERRY	8	2223	HACKBERRY	28	2250	HACKBERRY	12	2277	HACKBERRY	
2196	WILLOW	26	2224	HACKBERRY	20	2251	HACKBERRY	12	2278	HACKBERRY	
2197	PINE	18	2225	HACKBERRY	6	2252	HACKBERRY	10	2279	ELM	
2198	PINE	18	2226	HACKBERRY	6	2253	HACKBERRY	8	2280	ELM	
2199	PINE	16	2227	HACKBERRY	36	2254	HACKBERRY	10	2281	HACKBERRY	
2200	PINE	14	2228	HACKBERRY	12	2255	HACKBERRY	6	2282	HACKBERRY	
2201	PINE	12	2229	HACKBERRY	6	2256	HACKBERRY	10	2283	HACKBERRY	
2202	OAK	6									

PLOTTED BY: MARIA PAZ DATE: 11/13/2024 2:56 PM DWG NAME: P:\2024\240117 SABLE CROSSING - SANGER TOWN CENTER SOUTH\CAD\CIVIL\04\_SHEETS\C1.01 EXISTING CONDITIONS.DWG LAST SAVED BY: BRANSONBURGER DATE: 11/13/2024 11:36 AM

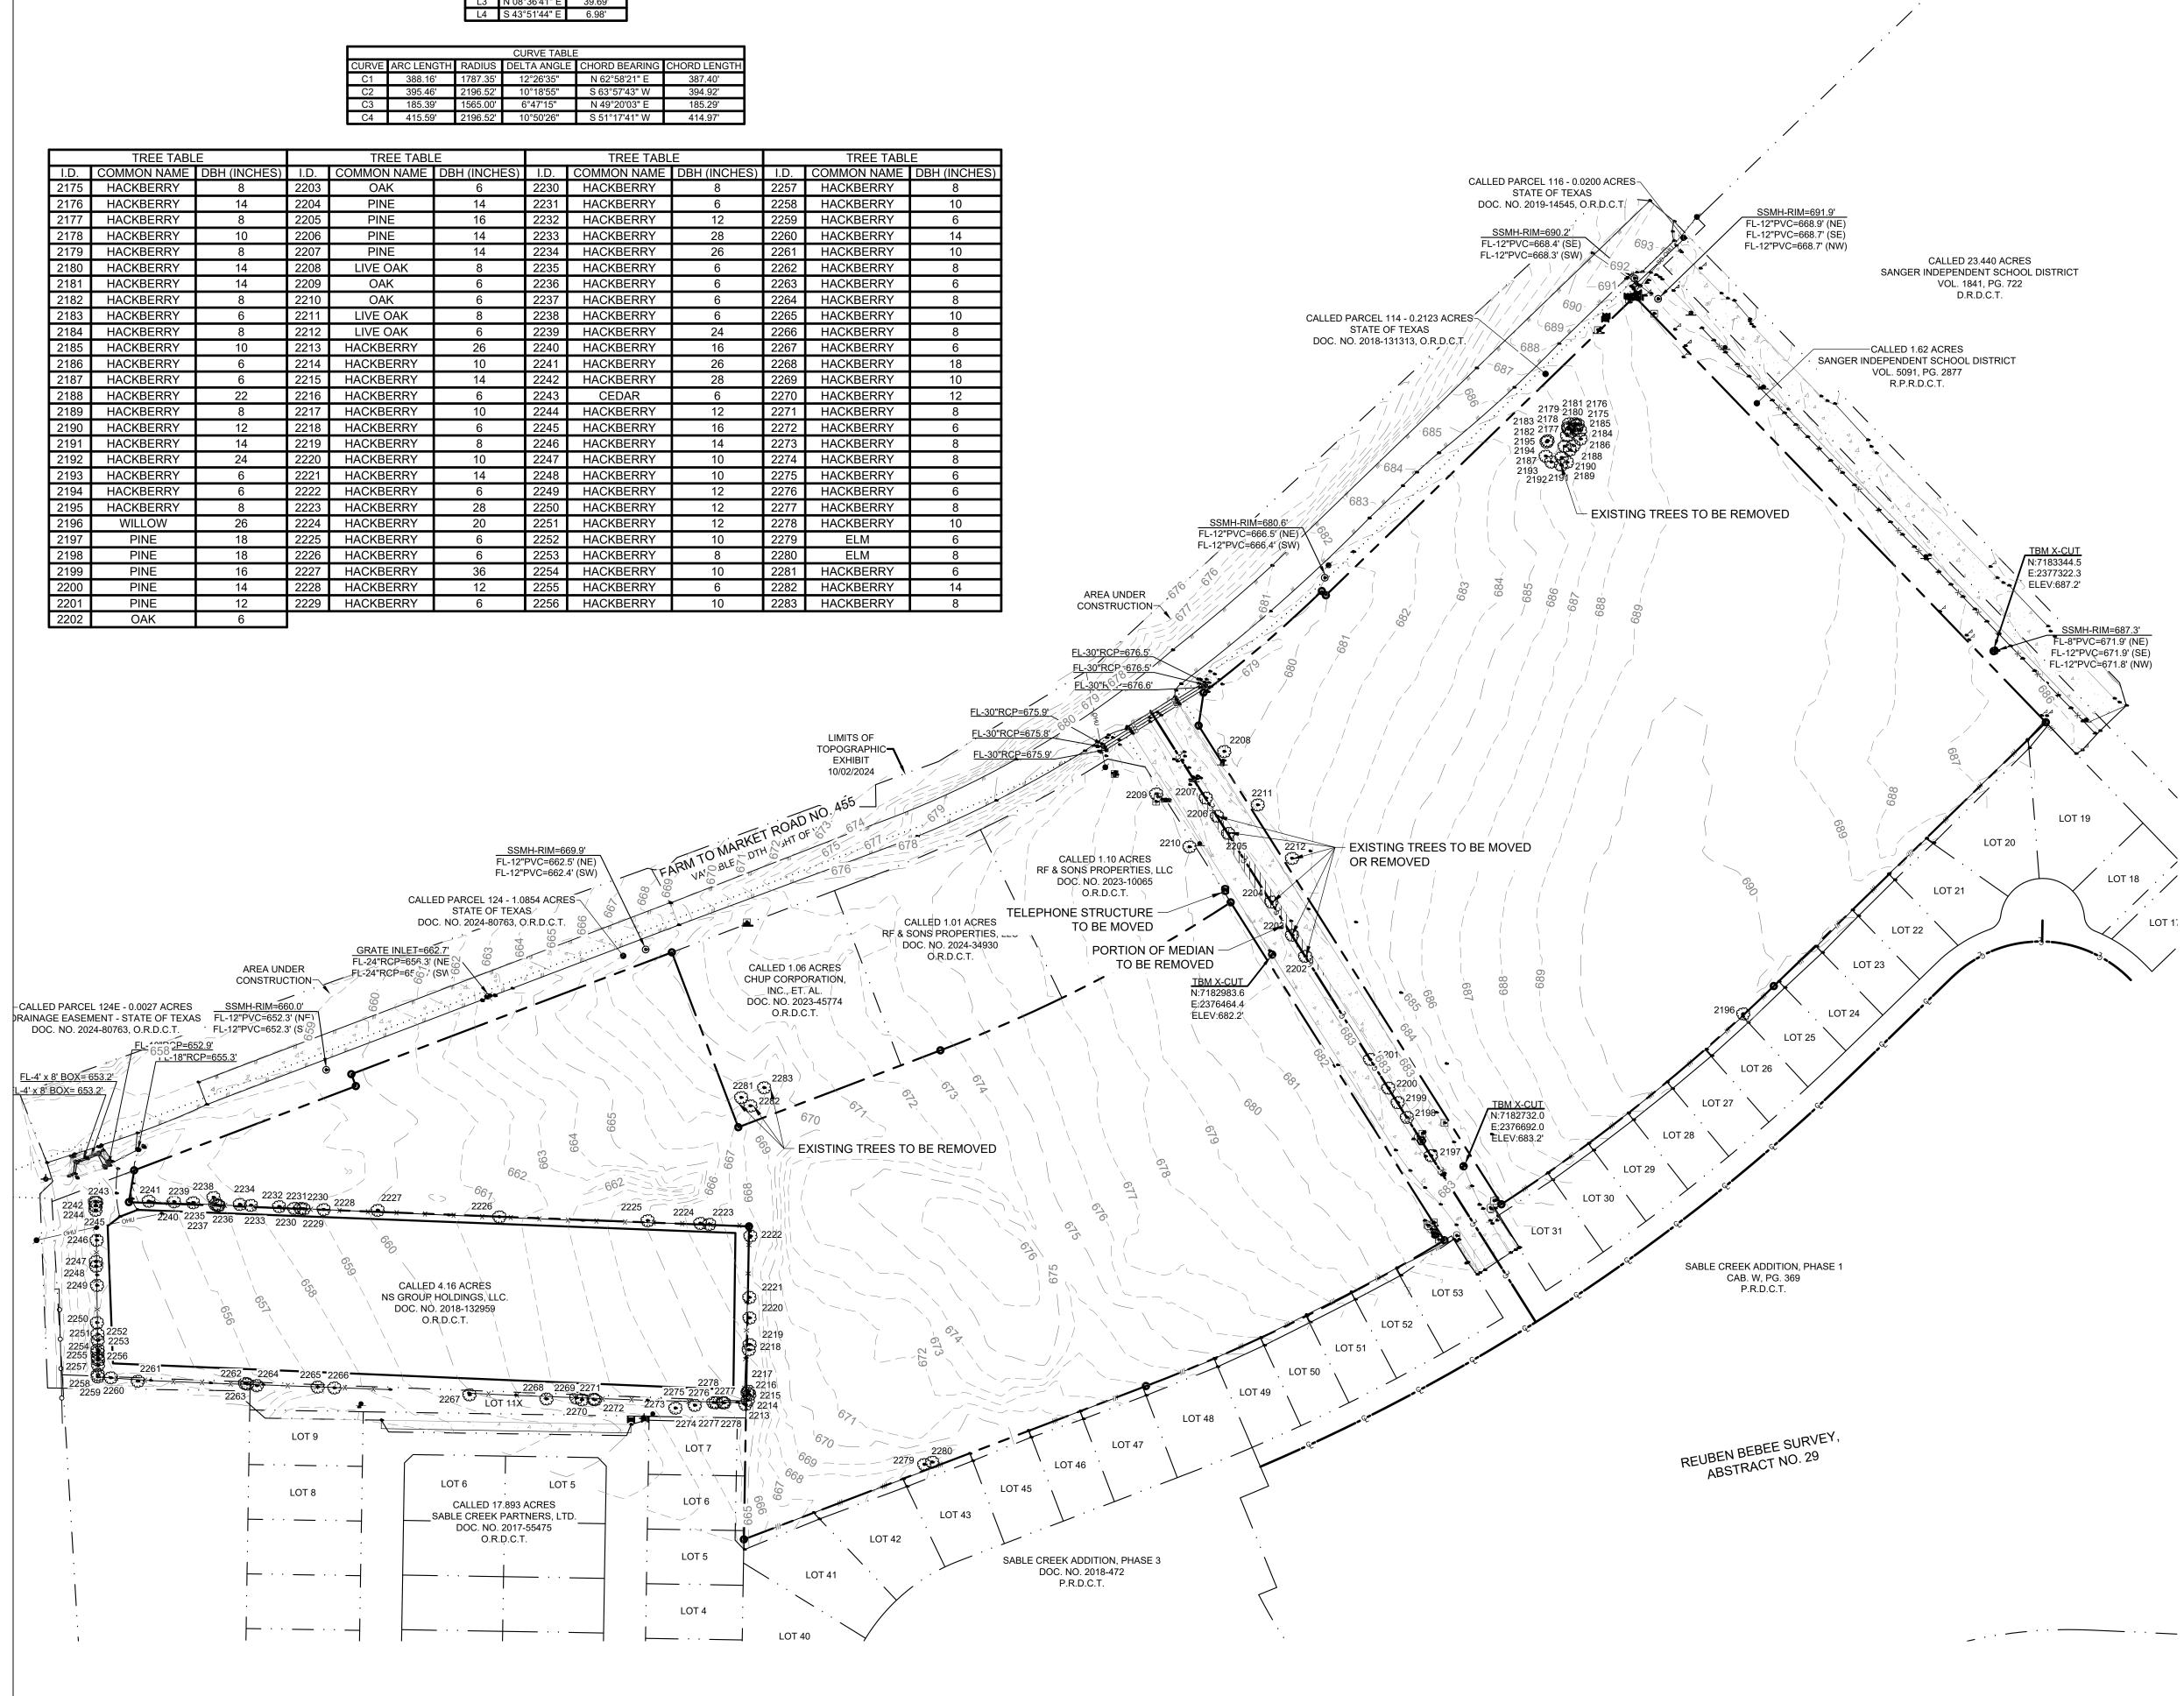

50' SCALE: 1" = 100'

# **LEGEND - EXISTING CONDITIONS**

	LOT BOUNDARY
— — 690 — —	EXISTING MAJOR CONTOUR
689	EXISTING MINOR CONTOUR
	EXISTING ROAD
$\bigcirc$	EXISTING TREE
	EXISTING CONCRETE TO BE REMOVED



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KJE

500 Moseley Rd Cross Roads, TX 76277

Phone 940-387-0805 Fax 940-387-0830

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# Description Date

**OVERALL EXISTING** CONDITIONS

**BENCHMARKS**:


TBM X-CUT TBM X-CUT TBM X-CUT N:7182983.6

ELEV:682.2' ELEV:683.2' ELEV:682.2'

N:7182732.0 N:7182983.6 E:2376464.4 E:2376692.0 E:2376464.4

C0.03



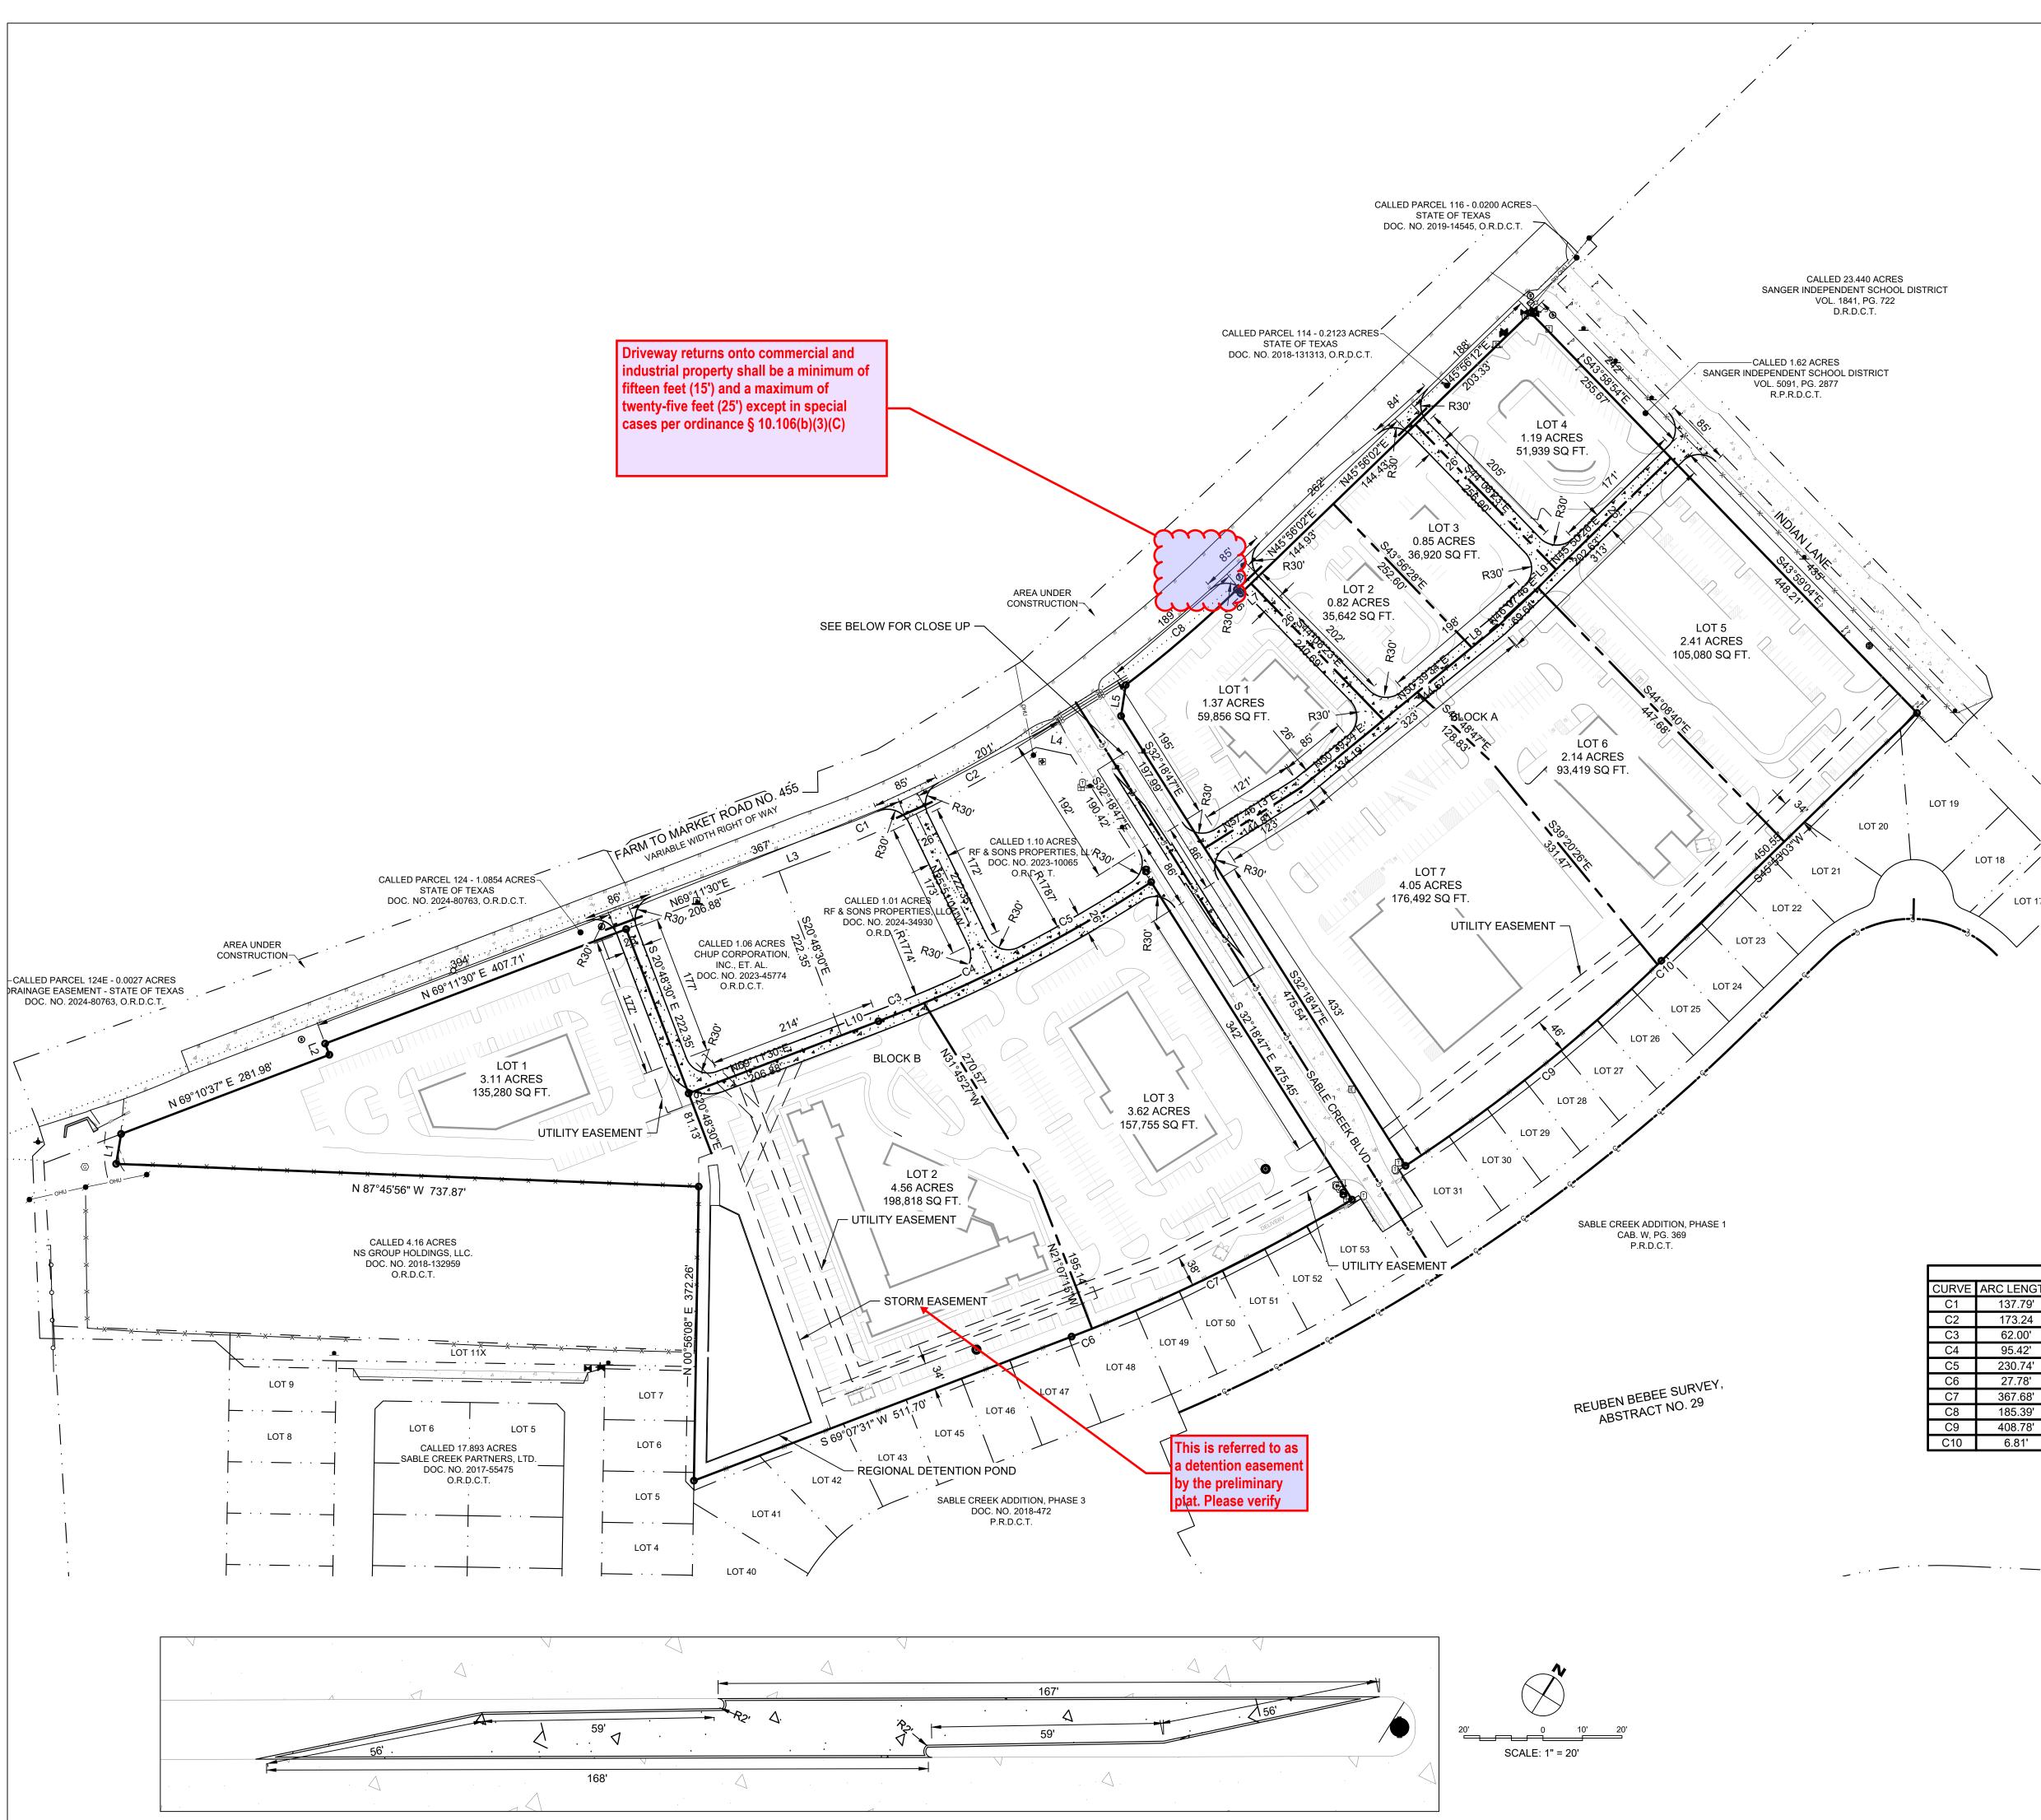

50' SCALE: 1" = 100'

# LEGEND - SITE PLAN

PROPOSED 6" THICK CONCRETE PAVEMENT - - LOT BOUNDARY

PARKING SPACES

— BUILDING - DETENTION POND

	LINE TABLE			
LINE	BEARING	DISTANCE		
L1	N 09°25'57" E	38.34'		
L2	N 20°46'45" W	15.08'		
L3	N 69°11'30" E	50.31'		
L4	S 77°57'10" E	45.34'		
L5	N 08°36'41" E	39.69'		
L6	S 43°51'44" E	6.98'		
L7	N 45°56'02" E	18.33'		
L8	N 50°39'34" E	43.29'		
L9	N 45°13'20" E	32.53'		
L10	N 69°11'30" E	50.24'		

		-	CURVE TABLE		
CURVE	ARC LENGTH	RADIUS	DELTA ANGLE	CHORD BEARING	CHORD LENGTH
C1	137.79'	1565.00'	5°02'40"	N 66°40'10" E	137.74'
C2	173.24	1565.00'	6°20'33"	N 60°58'33" E	173.15'
C3	62.00'	1787.35'	1°59'15"	N 68°12'01" E	62.00'
C4	95.42'	1787.35'	3°03'32"	N 65°40'37" E	95.41
C5	230.74'	1787.35'	7°23'47"	N 60°26'57" E	230.57'
C6	27.78'	2196.52'	0°43'28"	N 68°45'26" E	27.78'
C7	367.68'	2196.52'	9°35'27"	N 63°35'59" E	367.25'
C8	185.39'	1565.00'	6°47'15"	N 49°20'03" E	185.29'
C9	408.78'	2196.52'	10°39'46"	N 53°35'10" E	408.19'
C10	6.81'	2196.52'	0°10'40"	N 45°57'48" E	6.81'

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KJE 500 Moseley Rd Cross Roads, TX 76277 Phone 940-387-0805 Fax 940-387-0830

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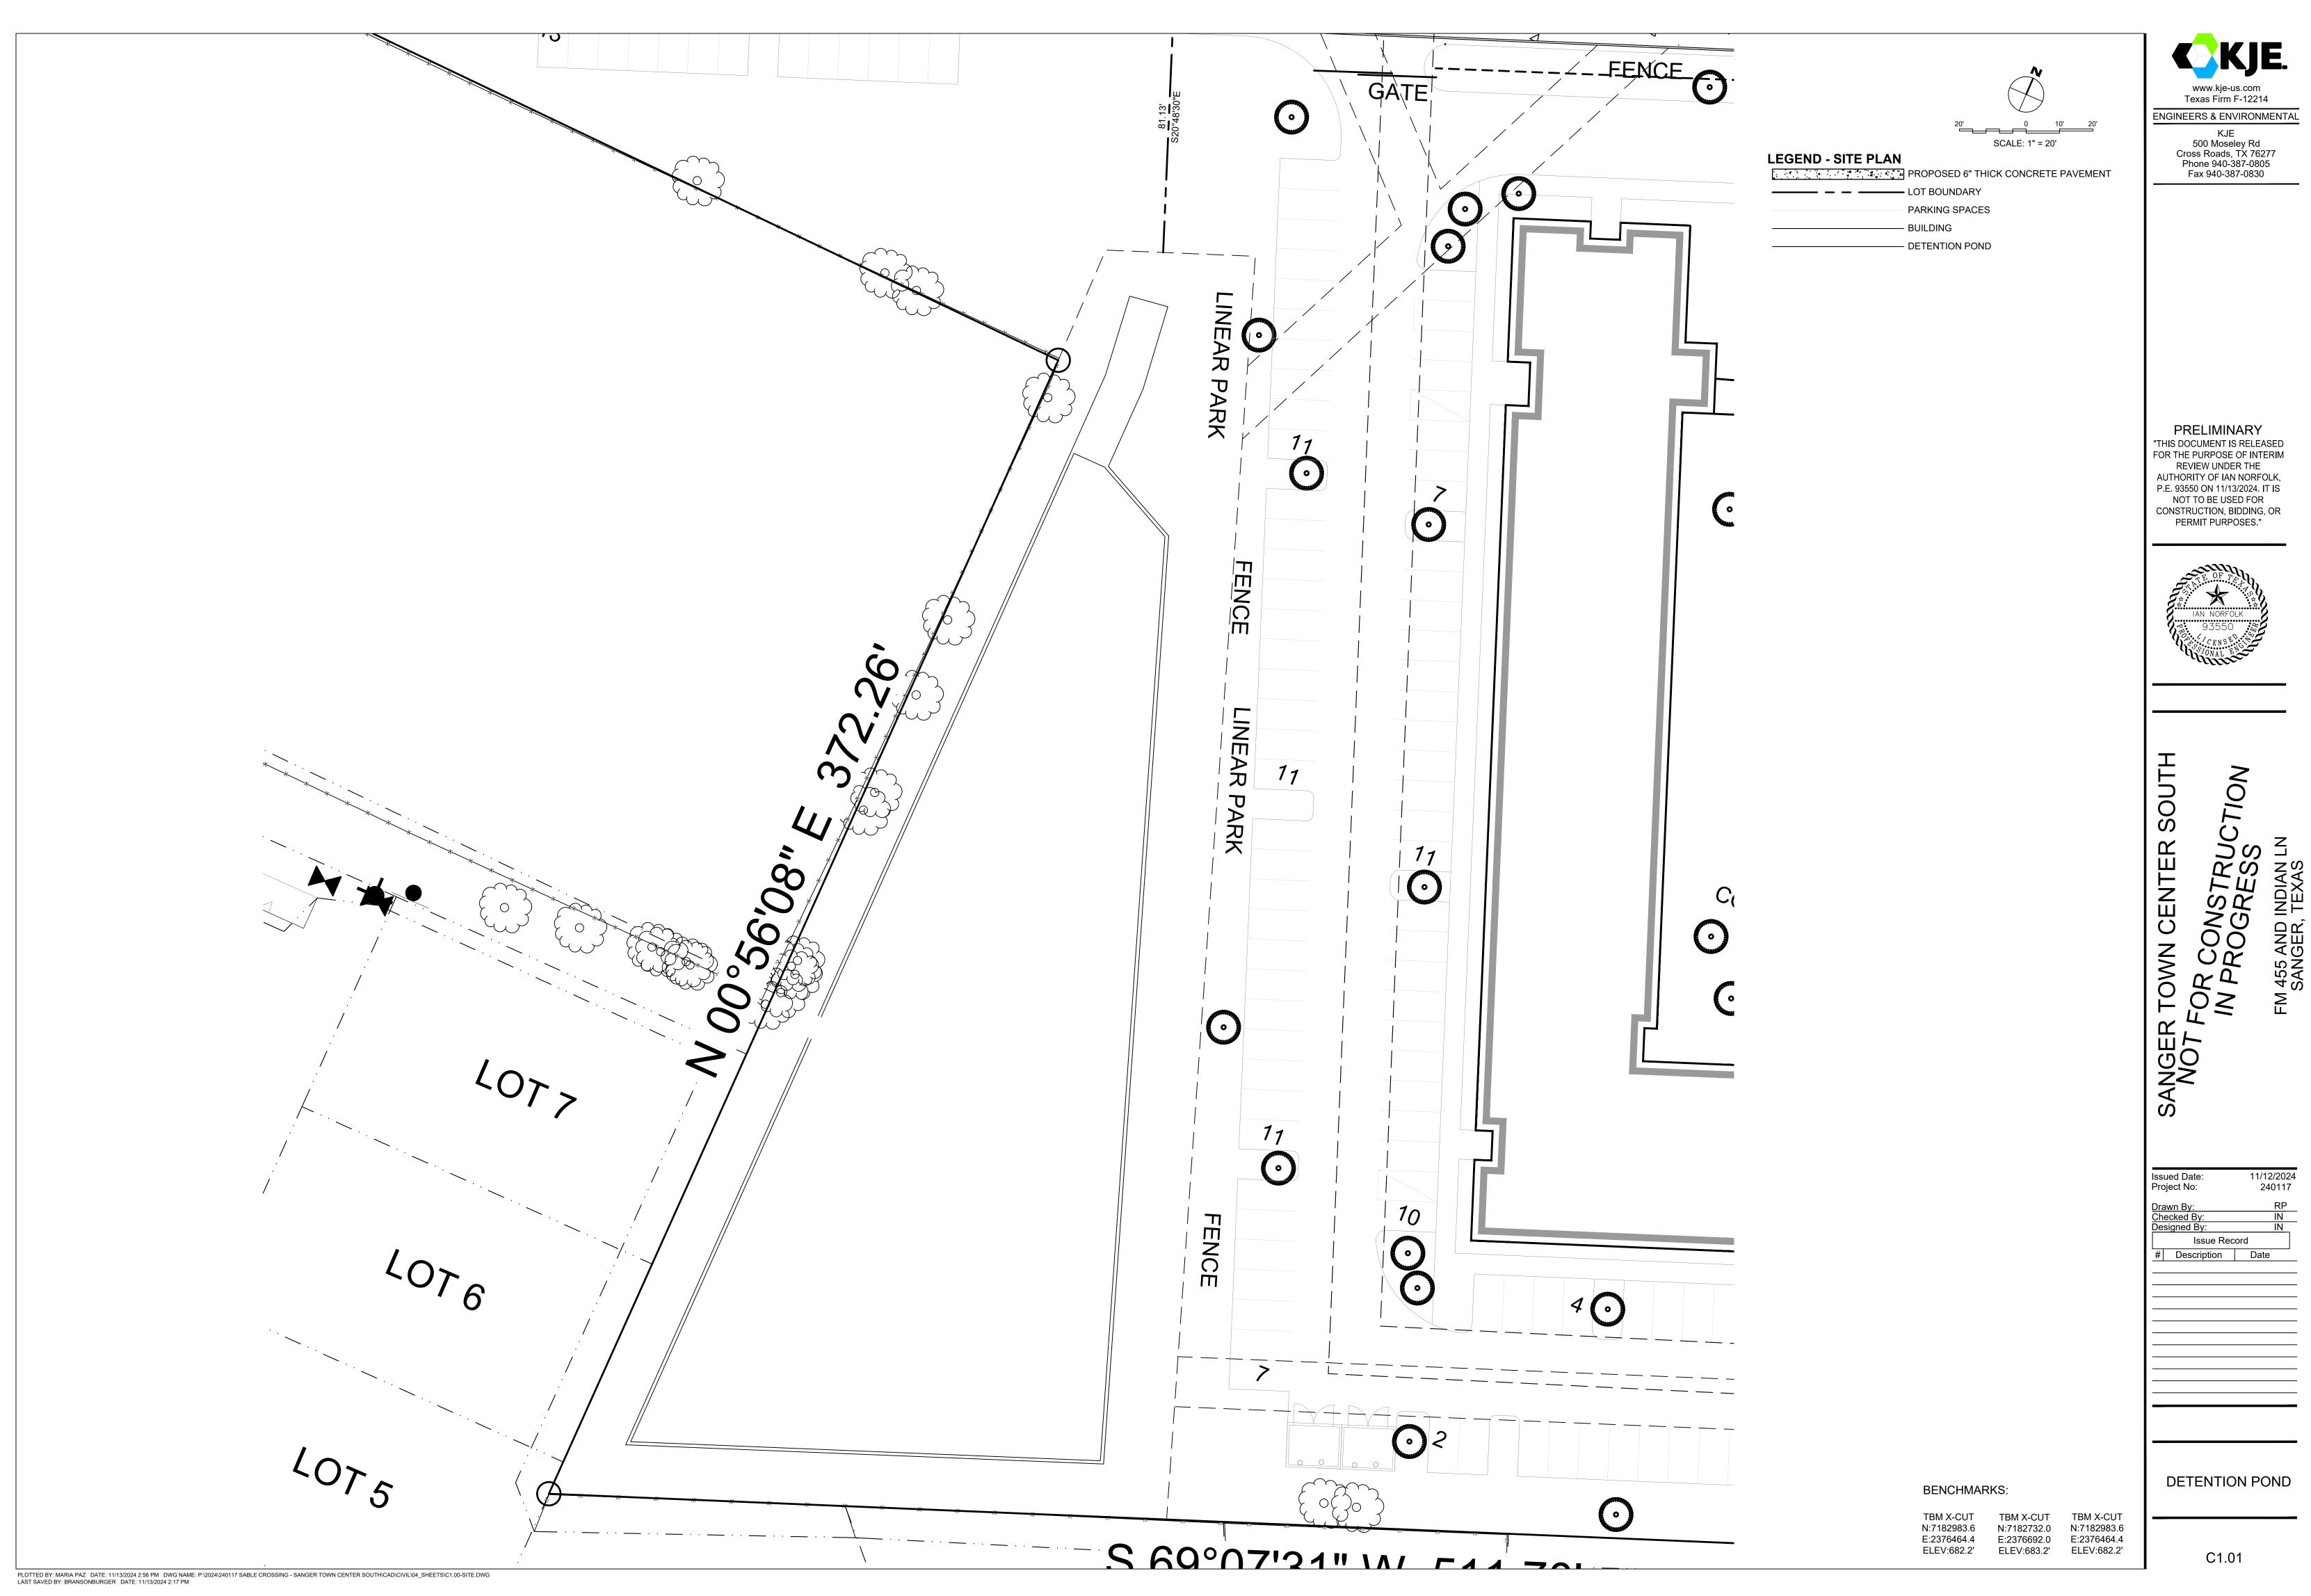
lss	ued Date:	11/12/2024
Pro	oject No:	240117
<b>D</b>		RP
Dra	awn By:	
Ch	ecked By:	IN
De	IN	
	Issue Rec	ord
#	Description	Date

OVERALL SITE PLAN


**BENCHMARKS**:

TBM X-CUT TBM X-CUT N:7182732.0 N:7182983.6 E:2376464.4 E:2376692.0 E:2376464.4 ELEV:682.2' ELEV:683.2' ELEV:682.2'


C1.00



Commercial/Industrial streets shall be

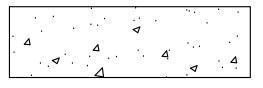

STANDARD PROCTOR OVER SUBBASE SCARIFIED TO A DEPTHOF 6" AND RECOMPACTED TO 95% STANDARD PROCTOR (PAVEMENT SECTION PENDING GEOTECH REPORT RECOMMENDATIONS.)

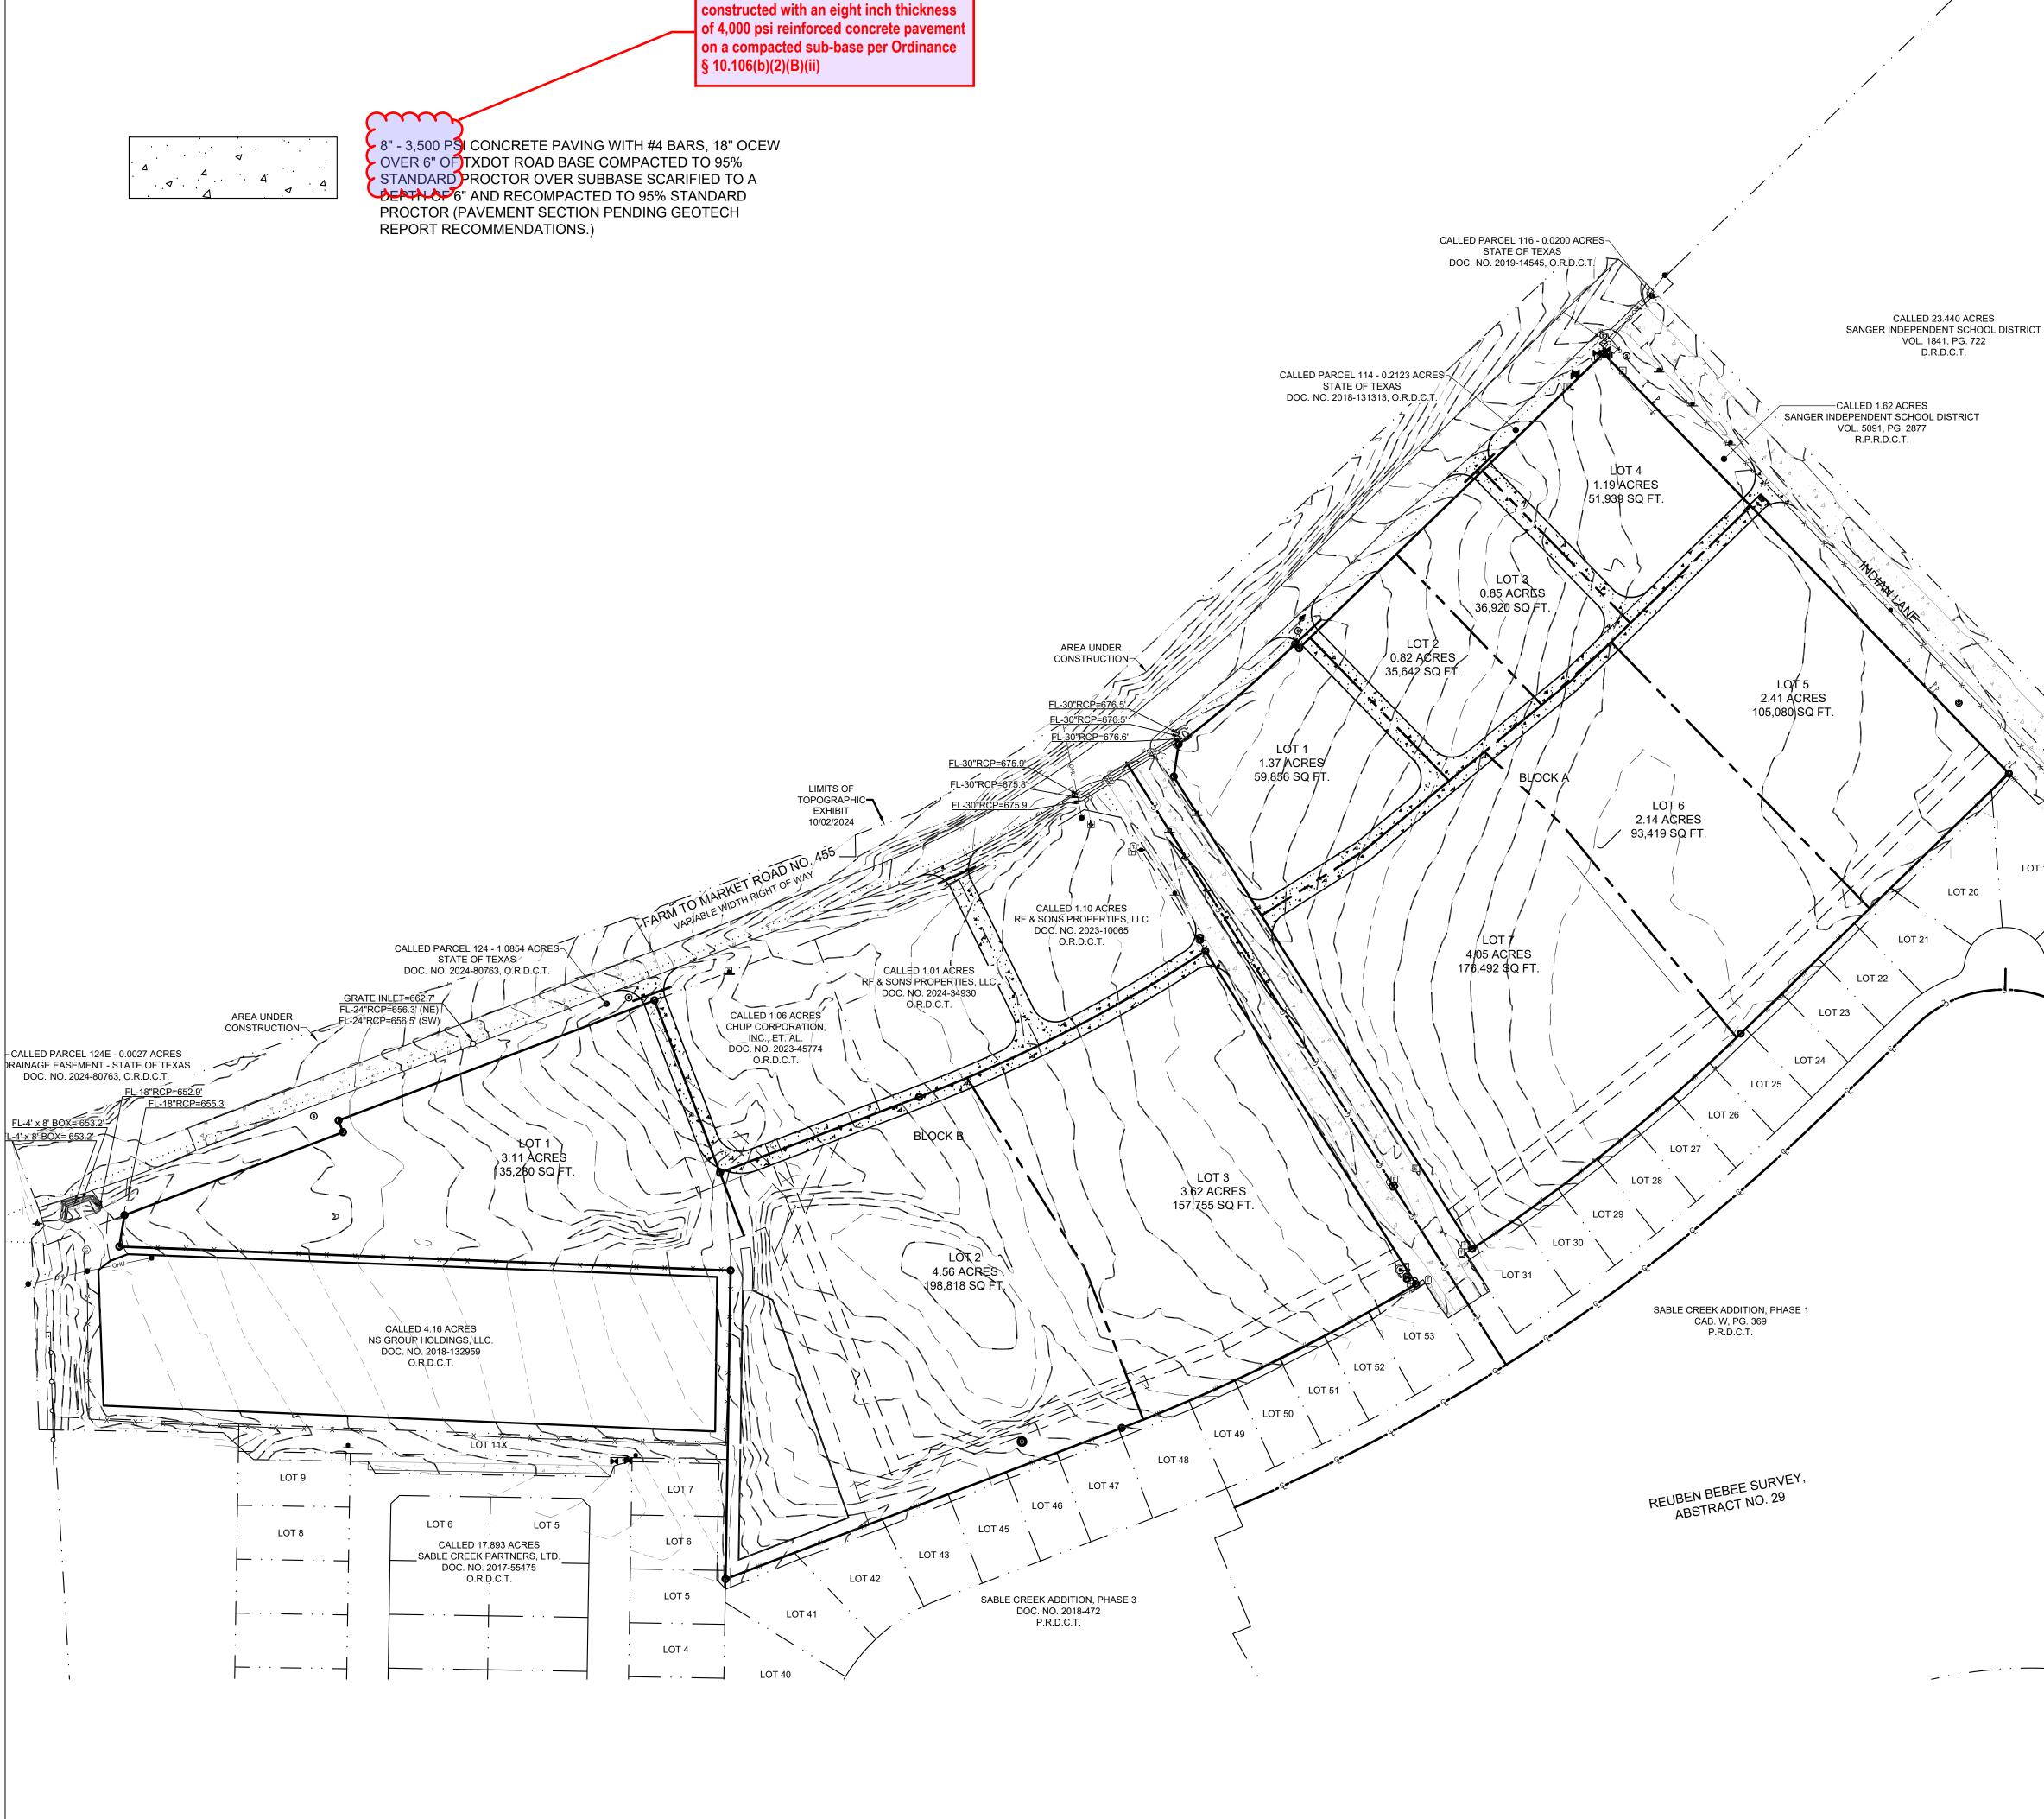

PLOTTED BY: MARIA PAZ DATE: 11/13/2024 2:56 PM DWG NAME: P:\2024\240117 SABLE CROSSING - SANGER TOWN CENTER SOUTH\CAD\CIVIL\04\_SHEETS\C2.00-PAVE.DWG LAST SAVED BY: IANNORFOLK DATE: 11/13/2024 1:30 PM

SCALE: 1" = 100'

LEGEND - PAVING PLAN

PROPOSED 6" THICK CONCRETE PAVEMENT \_\_\_\_ \_ \_ \_ LOT BOUNDARY

- DETENTION POND

LOT 19

\_\_\_\_\_ · · · \_\_\_\_ · · \_\_\_\_

LOT 18

### PAVING NOTES

- REFER TO SOIL PREPARATION & GRADING" NOTES ON THE GRADING PLAN FOR 1. SOIL PREPARATION SPECIFICATIONS UNDER PAVEMENT.
- CONCRETE FOR THE CONCRETE PAVEMENT SHALL HAVE A 28 DAY DESIGN 2. COMPRESSIVE STRENGTH OF 4,000 PSI, A MINIMUM OF 5.5 SACKS OF PORTLAND CEMENT PER CUBIC YARD, 20% MAX CLASS C FLY ASH, 4% TO 6% AIR CONTENT USING AIR ENTRAINING AGENT AS REQUIRED. MID RANGE WATER REDUCING AGENT AND A 4" MAX SLUMP.
- 3. IF THE AIR TEMPERATURE IS GREATER THAN 90 DEGREES WITHIN 24 HOURS AFTER PLACEMENT, HOT WEATHER CONCRETE PROCEDURES SHALL BE USED. THE CONTRACTOR SHALL SUBMIT A PROCEDURE TO THE ENGINEER FOR APPROVAL. IN ADDITION TO MEMBRANE CURING COMPOUND, THESE PROCEDURES MAY INCLUDE THE FOLLOWING:
  - PLACING THE CONCRETE IN THE EARLY MORNING HOURS
  - THE USE OF EVAPORATION REDUCER (SEE BELOW)
  - THE USE OF MISTING AS A CURING METHOD С THE USE OF WET BLANKETS AS A CURING METHOD D
  - THE USE OF A RETARDING ADMIXTURE (NOT PREFERABLE)

CONCRETE SHALL NOT BE PLACED WHEN AIR TEMPERATURE IS LESS THAN 40°F AND FALLING, BUT MAY BE PLACED WHEN THE AIR TEMPERATURE IS 35°F AND RISING.

FOUR CONCRETE CYLINDERS SHALL BE MADE FOR EVERY 75 CUBIC YARDS, ONE TO BE TESTED AT 7 DAYS, TWO AT 28 DAYS, AND ONE TO HOLD. THE CONCRETE SLUMP, TEMPERATURE, AND AIR CONTENT SHALL BE MEASURED EVERY TIME A SET OF FOUR CYLINDERS IS MADE.

ANY CONCRETE TO BE PLACED FURTHER THAN 16 FEET FROM THE END OF A CONCRETE TRUCK SHALL BE PUMPED WITH A COMMERCIAL CONCRETE PUMPING TRUCK OR OTHER PLACEMENT METHOD APPROVED BY THE ENGINEER. THE CONCRETE TRUCK SHALL NOT BE ALLOWED TO DRIVE OVER THE SUBGRADE OR THE PAVEMENT REINFORCEMENT UNLESS APPROVED BY THE ENGINEER.

REINFORCING STEEL SHALL BE NEW DOMESTIC DEFORMED BILLET STEEL CONFORMING TO A.S.T.M. A-615 GRADE 60.

REINFORCING BARS, BAR SUPPORTS, AND SPACERS SHALL BE DETAILED AND PROVIDED IN ACCORDANCE WITH THE A.C.I. DETAILING MANUAL. CHAIRS SHALL NOT BE PLACED FURTHER THAN 4 FEET APART. BAR SUPPORTS SHALL BE THE FOLLOWING DAYTON SUPERIOR PRODUCTS (800-745-3703) OR EQUAL:

- A. AT CONCRETE PAVEMENT: (1/2 OF CONCRETE THICKNESS) HIGH, TYPE R21, OR TYPE BBP
- MASTER BUILDERS CONFILM OR EUCOBAR EVAPORATION REDUCERS SHALL BE 9 USED AFTER EACH FINISHING OPERATION ON THE CAST-IN-PLACE CONCRETE PAVEMENT UNLESS PRIOR APPROVAL FROM THE ENGINEER HAS BEEN OBTAINED TO NOT USE THIS PRODUCT.
- 10. SAWCUTS IN CONCRETE PAVEMENT SHALL BE MADE AS SOON AS THE CONCRETE IS OF SUFFICIENT STRENGTH TO SAW WITHOUT RAVELING THE SURFACE. ALL SAWING OPERATIONS SHALL BE CONDUCTED AND COMPLETED WITHIN FIVE (5) TO EIGHT (8) HOURS AFTER CONCRETE PLACEMENT. ANY TIME LAPSE GREATER THAN 8 HOURS AFTER PLACING THE CONCRETE SHALL BE PERMITTED ONLY IF APPROVED BY THE ENGINEER.
- 11. NO PIPING OR CONDUITS SHALL BE INSTALLED IN ANY CONCRETE WITHOUT THE APPROVAL OF THE ENGINEER.
- 12. PAVING CONTRACTOR IS RESPONSIBLE FOR ALL LAY DOWN CURBS AT INTERSECTIONS WHERE BARRIER FREE RAMPS ARE TO BE CONSTRUCTED.
- 13. THE CONTRACTOR SHALL PROVIDE, CONSTRUCT AND MAINTAIN BARRICADES AND SIGNS IN ACCORDANCE WITH THE MANUAL OF UNIFORM TRAFFIC CONTROL DEVICES.
- 14. SAWCUTS IN CONCRETE PAVING SHALL HAVE A MAXIMUM SPACING OF 15' EACH WAY. ALL JOINTS SHALL BE SEALED WITH SEALANT.
- 15. ALL CONTROL, CONSTRUCTION AND EXPANSION JOINTS MUST BE SEALED WITH A JOINT SEALANT.
- 16. IT WILL BE THE CONTRACTOR'S RESPONSIBILITY TO ACQUIRE ALL NECESSARY PERMITS FROM CITY, COUNTY OR STATE BEFORE CONSTRUCTION IN THE RIGHT-OF-WAY.
- 17. ALL DIMENSIONS ARE TO THE BACK OF CURB OR EDGE OF PAVEMENT, UNLESS OTHERWISE NOTED.
- 18. MANHOLES AND VALVE COVERS IN PAVED AREAS SHALL BE TRAFFIC BEARING AND RIM ELEVATIONS SHALL MATCH FINAL PAVING ELEVATION.

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ENGINEERS & ENVIRONMENTAL KJE

500 Moseley Rd

Cross Roads, TX 76277

Phone 940-387-0805

Fax 940-387-0830





Issued Date:	11/12/2024
Project No:	240117
	RP
Drawn By:	
Checked By:	IN
Designed By:	IN
Issue Re	ecord
# Description	Date

OVERALL	PAVING
PLA	N


C2.00

**BENCHMARKS**:

TBM X-CUT N:7182983.6 E:2376464.4 ELEV:682.2'


TBM X-CUT TBM X-CUT N:7182732.0 E:2376692.0 E:2376464.4 ELEV:683.2' ELEV:682.2'

N:7182983.6

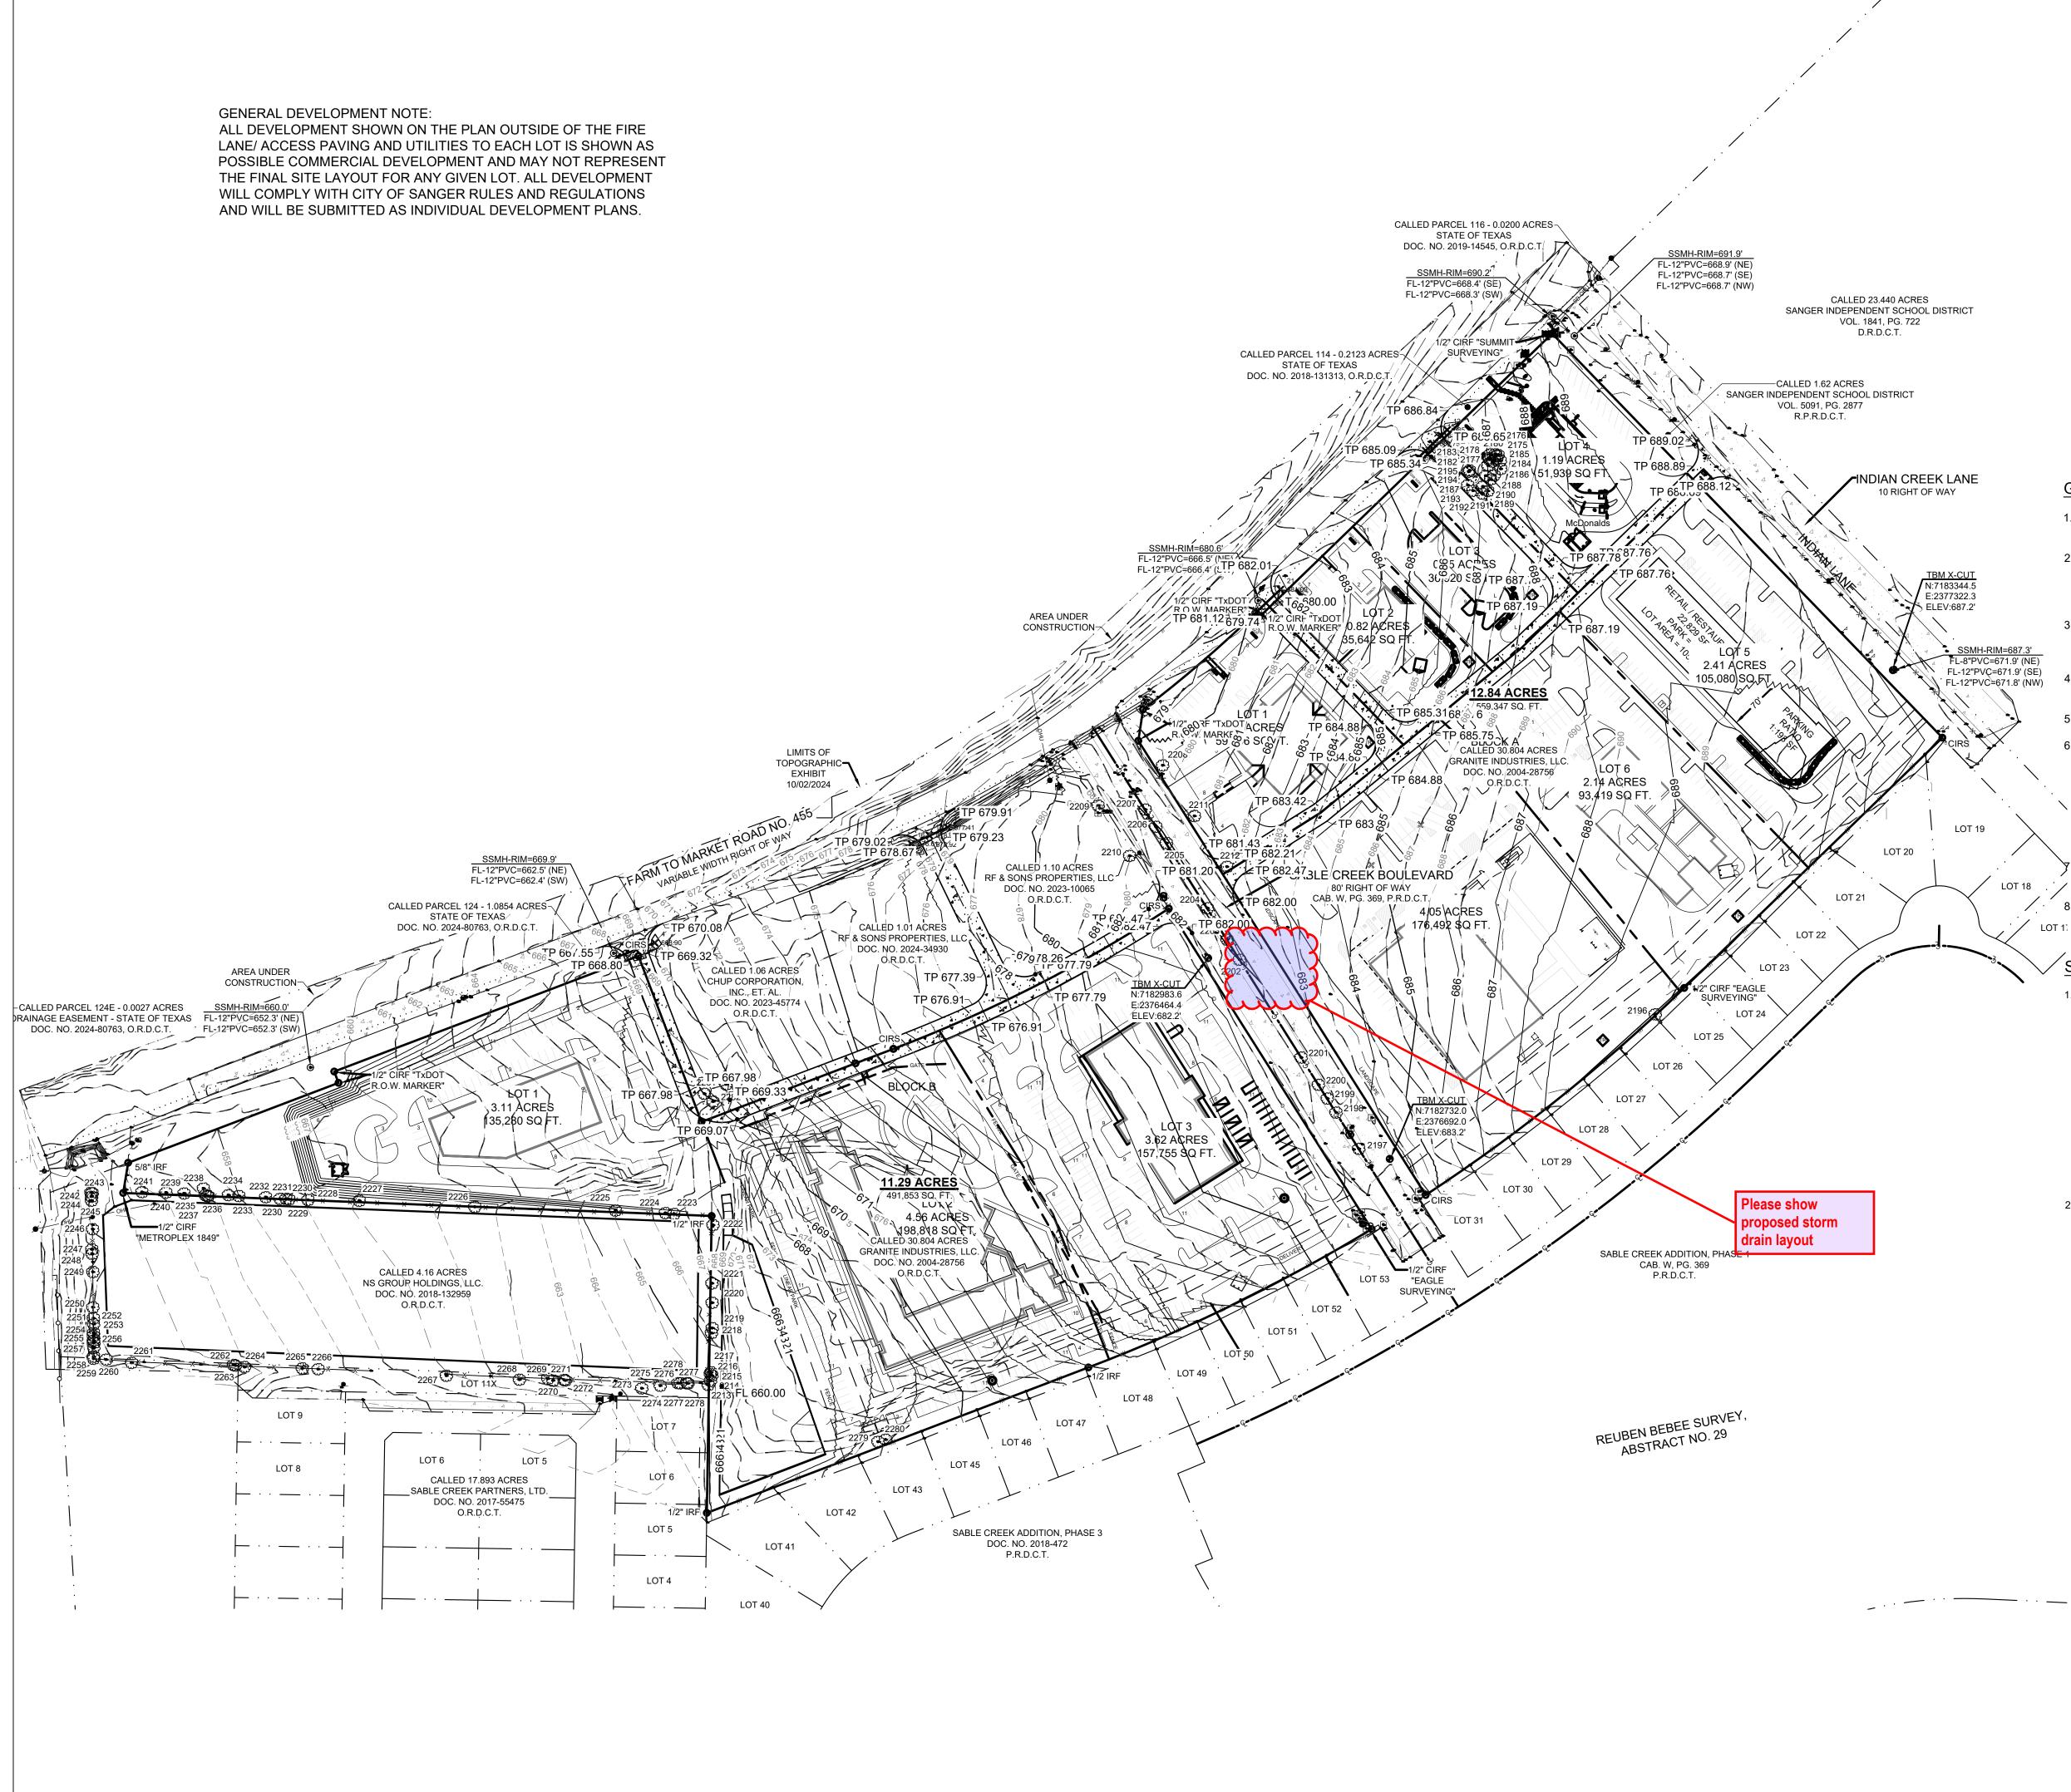

PLOTTED BY: MARIA PAZ DATE: 11/13/2024 2:56 PM DWG NAME: P:\2024\240117 SABLE CROSSING - SANGER TOWN CENTER SOUTH\CAD\CIVIL\04\_SHEETS\C3.00-GRAD.DWG LAST SAVED BY: DUELCHAVEZ DATE: 11/13/2024 2:46 PM



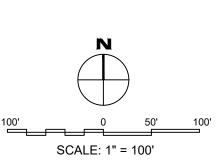



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Issued Date: Project No:	11/12/2024 240117
Drawn By: Checked By:	RP
Designed By: Issue Rec	IN
# Description	Date
OVERALL ( PLA	

PLAN

# **GRADING NOTES**

SITE SHALL BE GRADED TO ASSURE DRAINAGE OF SURFACE WATER AWAY FROM BUILDING.

LEGEND - GRADING PLAN

TC

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G

TS

τw

TG

------ LOT BOUNDARY

- BUILDING

– DETENTION POND

TOP OF CURB

TOP OF PAVING

GUTTER

SIDEWALK

TOP OF WALL

BOTTOM OF WALL

TOP OF GRATE

FLOW ARROW

------ PROPOSED MAJOR CONTOUR

– PROPOSED MINOR CONTOUR

- GRADES NOT OTHERWISE INDICATED ON THE PLANS SHALL BE UNIFORM LEVELS 2. OR SLOPES BETWEEN POINTS WHERE ELEVATIONS ARE GIVEN. ABRUPT CHANGES IN SLOPES SHALL BE WELL ROUNDED. THE CONTRACTOR IS RESPONSIBLE FOR POSITIVE SITE DRAINAGE.
- ACCESSIBLE ROUTES NOT TO EXCEED 5% RUNNING SLOPE AND 2% CROSS SLOPE. HANDICAP PARKING AND ACCESS AISLES NOT TO EXCEED 2% SLOPE IN ANY DIRECTION.
- GREASE TRAPS, MANHOLES, AND VALVE COVERS IN PAVED AREAS SHALL BE TRAFFIC BEARING AND RIM ELEVATIONS SHALL MATCH FINAL PAVING ELEVATION.
- ALL SITE EXCAVATION SHALL BE CONSIDERED UNCLASSIFIED EXCAVATION.

THE GRADES AND CONTOURS SHOWN ON THIS PLAN REPRESENT THE ELEVATIONS AS INDICATED ON THE TOPOGRAPHIC SURVEY BY CROWLEY SURVEYING DATED 09/2022. DUE TO MANY FACTORS INCLUDING POSSIBLE DISTURBANCE OF THE SOIL OR BENCH MARKS BY OTHER PARTIES AND THE EXPANSIVE/SHRINKAGE NATURE OF THE SOIL, THE ELEVATIONS MAY BE SIGNIFICANTLY DIFFERENT IN THE FUTURE (INCLUDING THE BENCH MARKS). NORMAL EQUIPMENT AND MEASUREMENT ACCURACIES SHOULD BE TAKEN INTO ACCOUNT WHEN USING THESE ELEVATIONS.

ALL SLOPES IN UNPAVED AREAS SHALL BE 4:1 OR FLATTER UNLESS OTHERWISE NOTED.


ALL ELEVATIONS ARE TO TOP OF PAVEMENT OR GROUND, UNLESS OTHERWISE NOTED.

# SOIL PREPARATION NOTES


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## **BENCHMARKS**:




TBM X-CUT TBM X-CUT N:7182732.0 N:7182983.6 E:2376692.0 E:2376464.4 ELEV:683.2' ELEV:682.2'

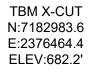

TBM X-CU

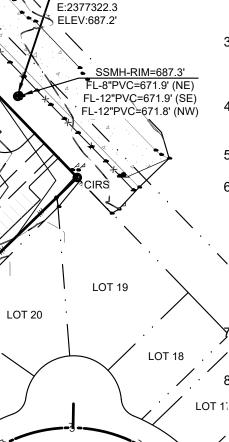N:7183344.5

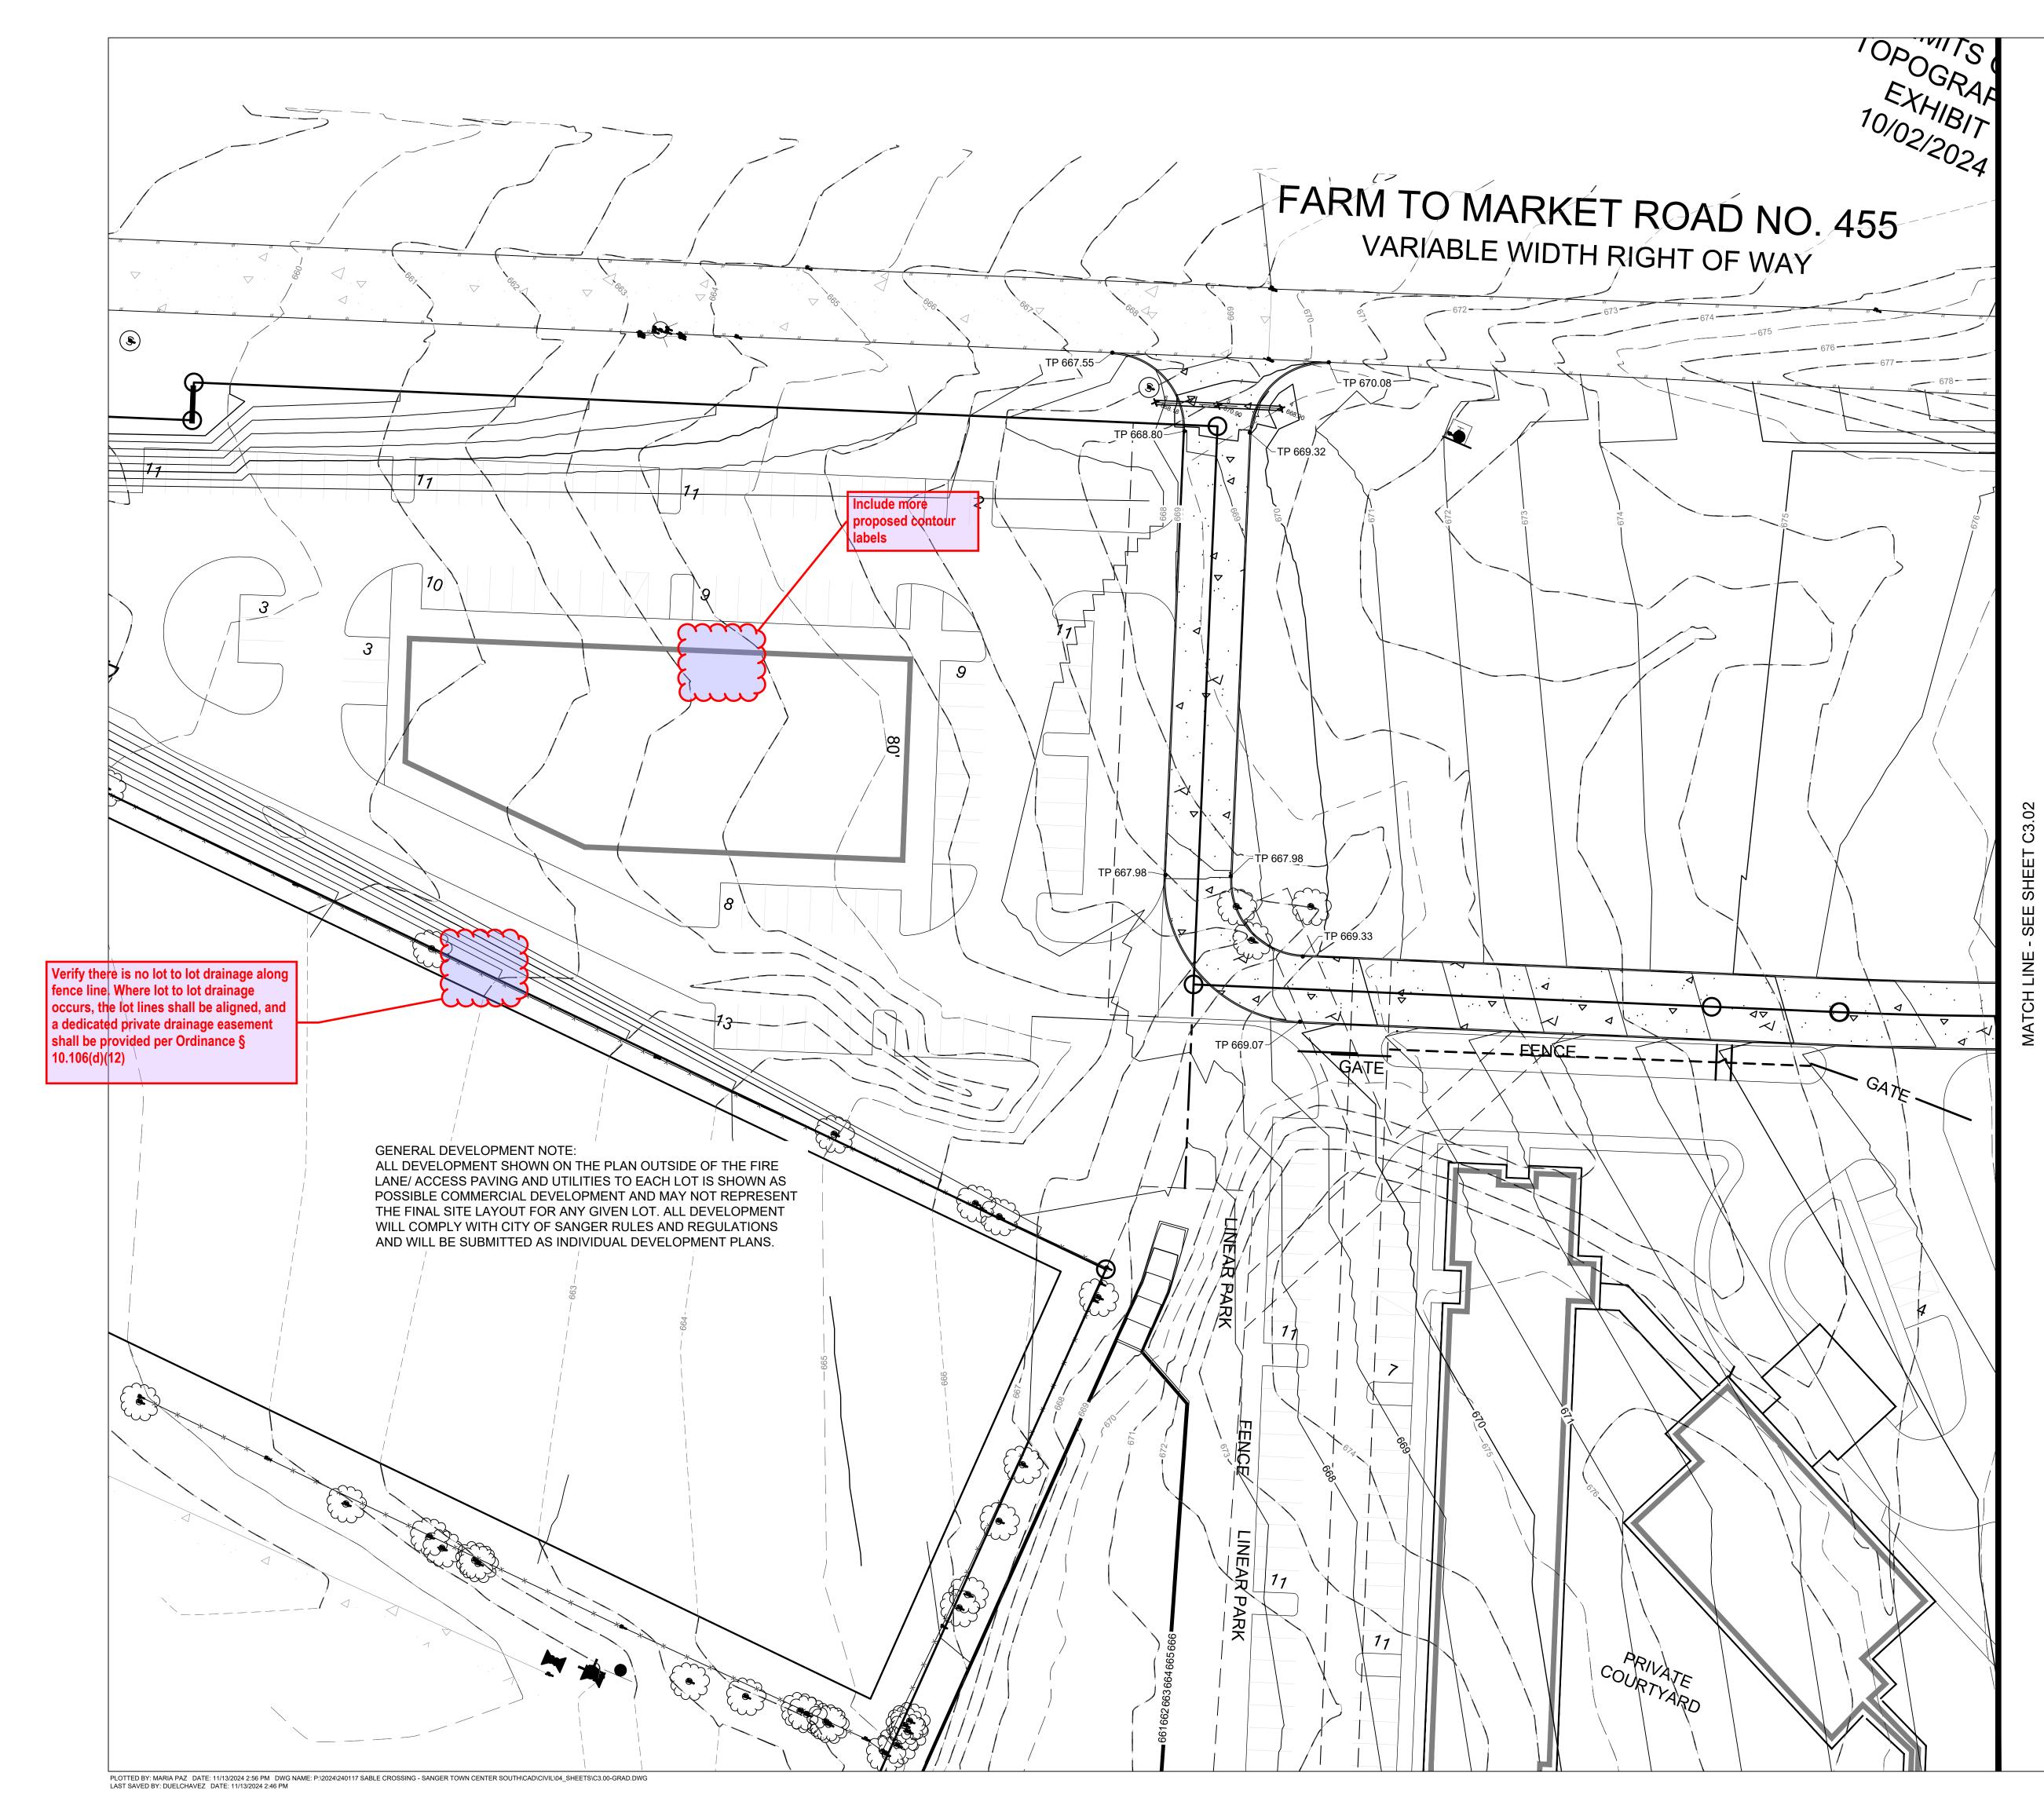

SCALE: 1" = 30'

# **LEGEND - GRADING PLAN**

	LOT BOUNDARY
	BUILDING
	DETENTION POND
580	PROPOSED MAJOR CONTOUR
583	PROPOSED MINOR CONTOUR
TC	TOP OF CURB
TP	TOP OF PAVING
G	GUTTER
TS	SIDEWALK
TW	TOP OF WALL
BW	BOTTOM OF WALL
TG	TOP OF GRATE
$\rightarrow$	FLOW ARROW

# **GRADING NOTES**


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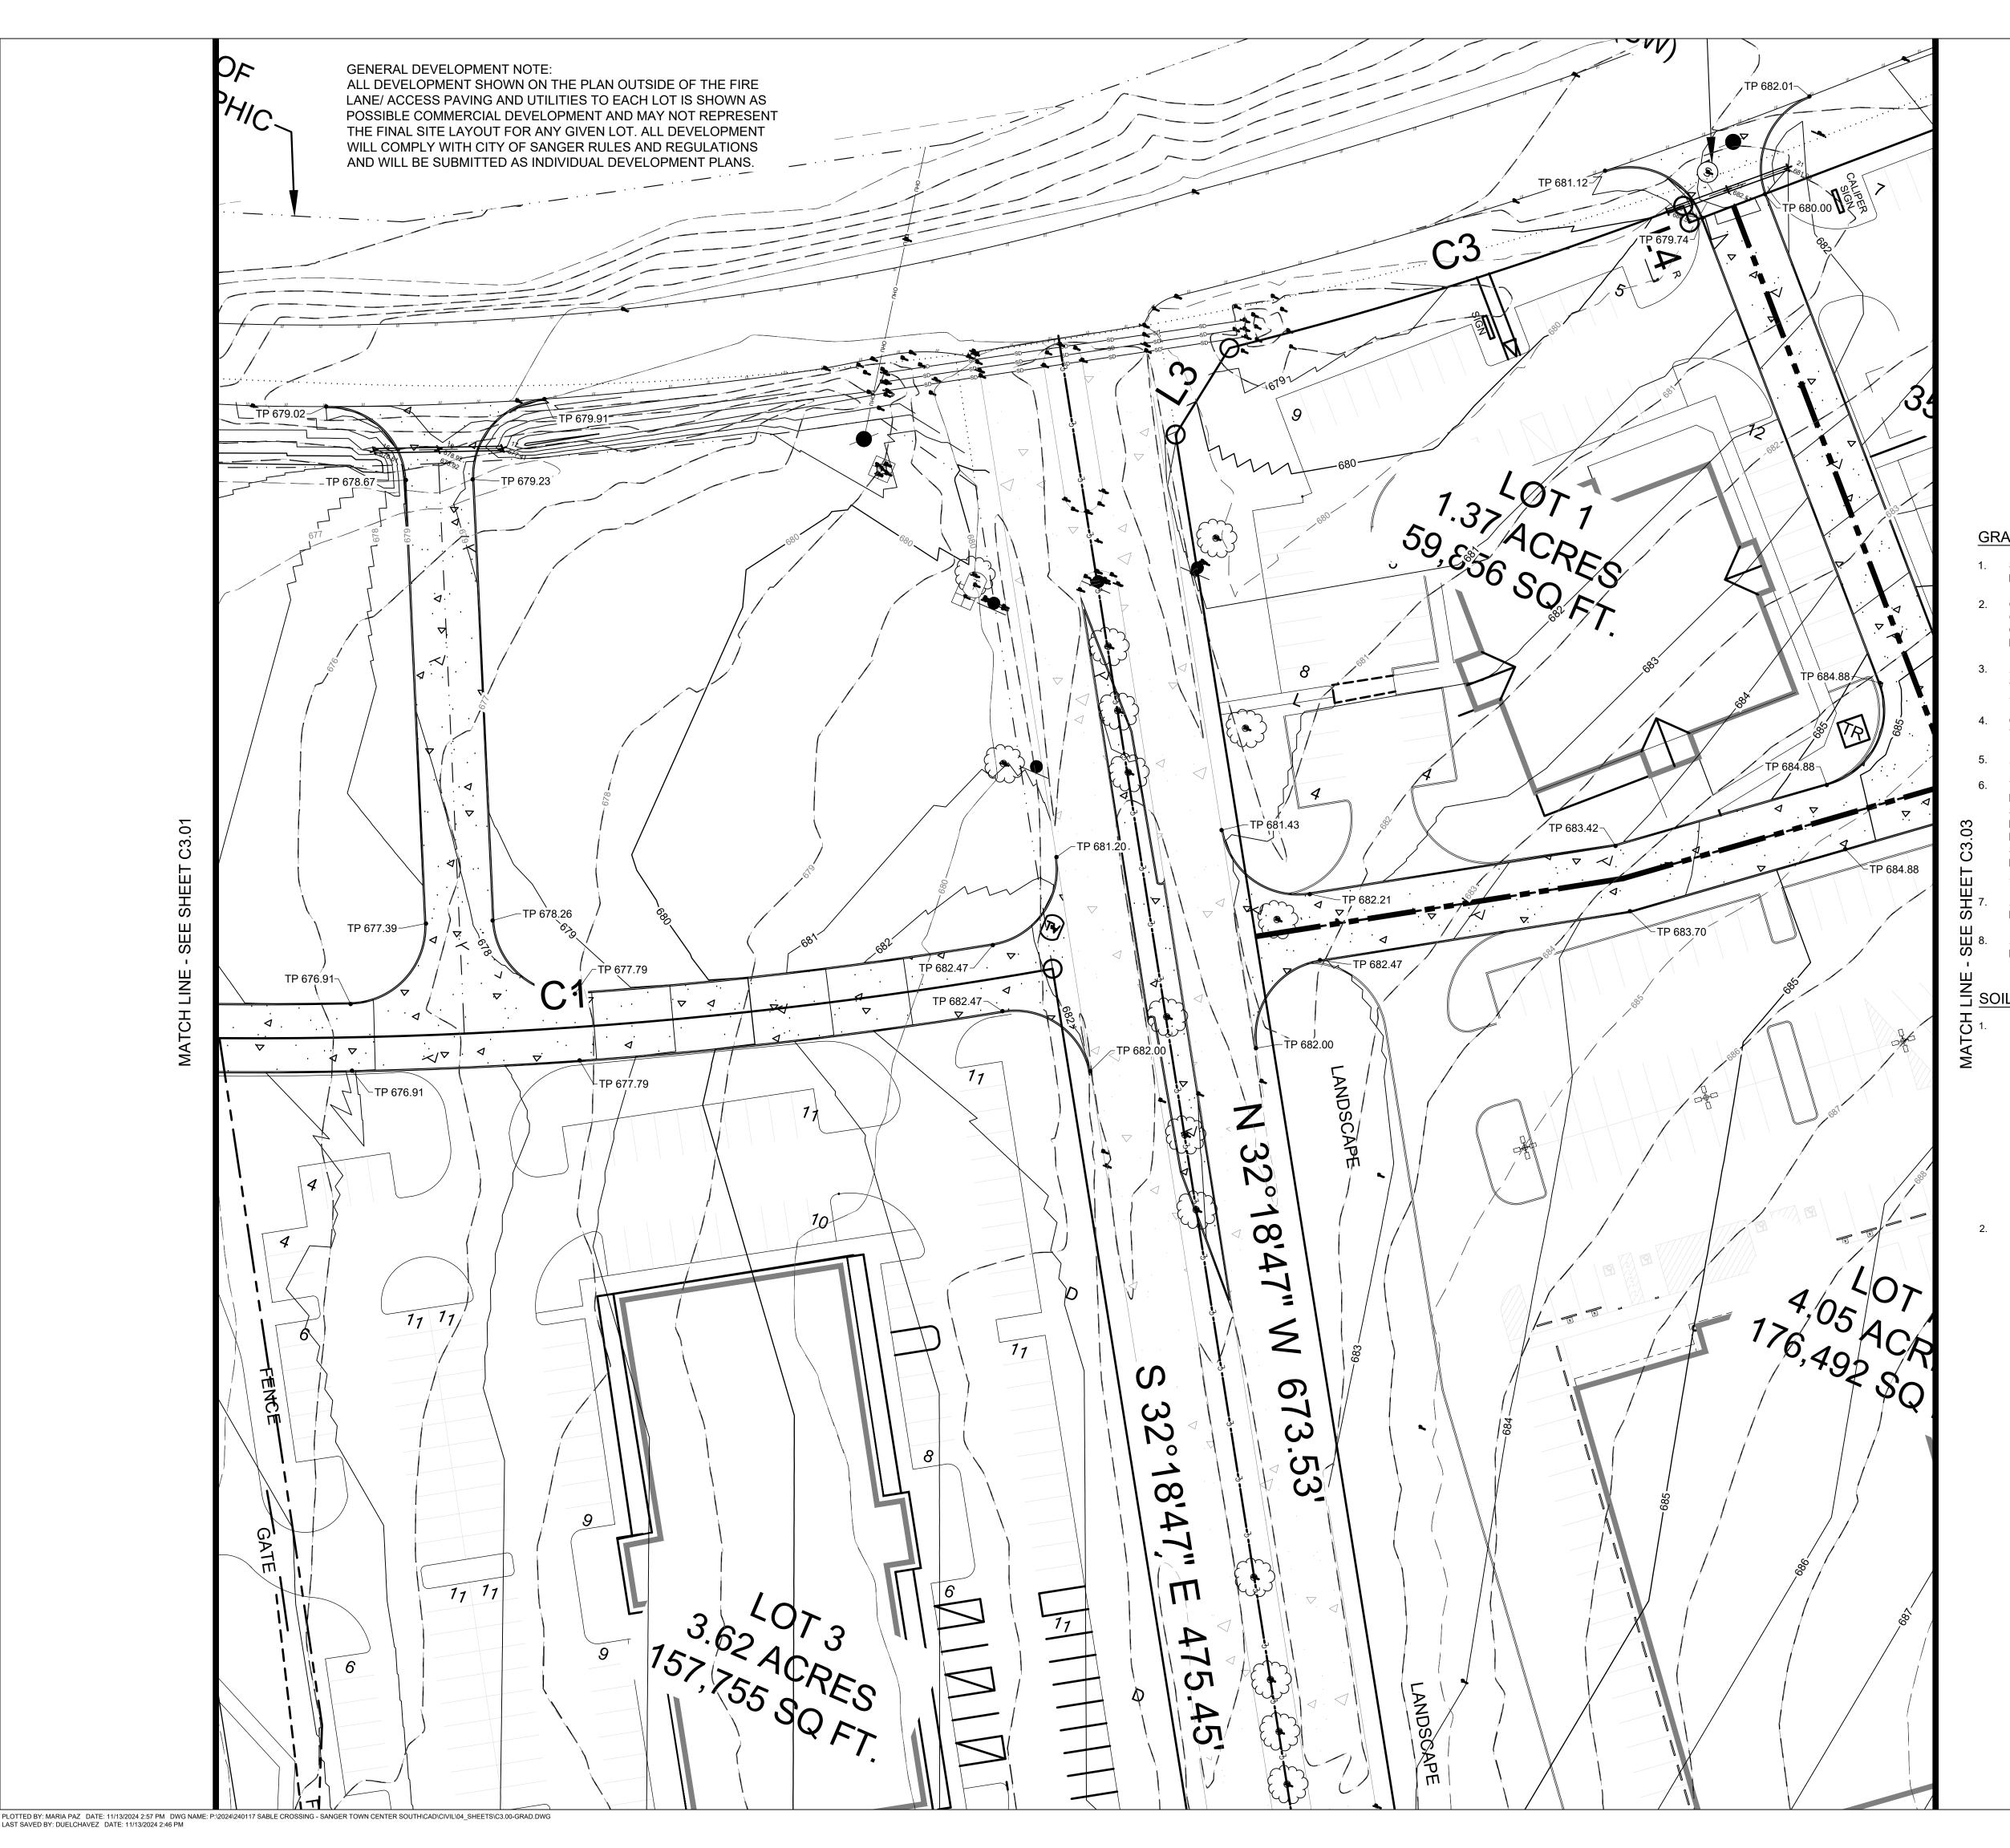
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Issued Date:	11/12/2024
Project No:	240117
Drawn By:	RP
Checked By:	IN
Designed By:	IN
Issue Reco	rd
# Description	Date

**GRADING PLAN I** 



SCALE: 1" = 30'

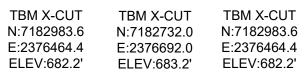

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	signed By:	IN
	Issue Rec	ord
#	Description	Date

**GRADING PLAN II** 

# LEGEND - GRADING PLAN

	LOT BOUNDARY
	BUILDING
	DETENTION POND
580	PROPOSED MAJOR CONTOUR
583	PROPOSED MINOR CONTOUR
TC	TOP OF CURB
TP	TOP OF PAVING
G	GUTTER
TS	SIDEWALK
TW	TOP OF WALL
BW	BOTTOM OF WALL
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$\rightarrow$	FLOW ARROW

# **GRADING NOTES**

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# SOIL PREPARATION NOTES

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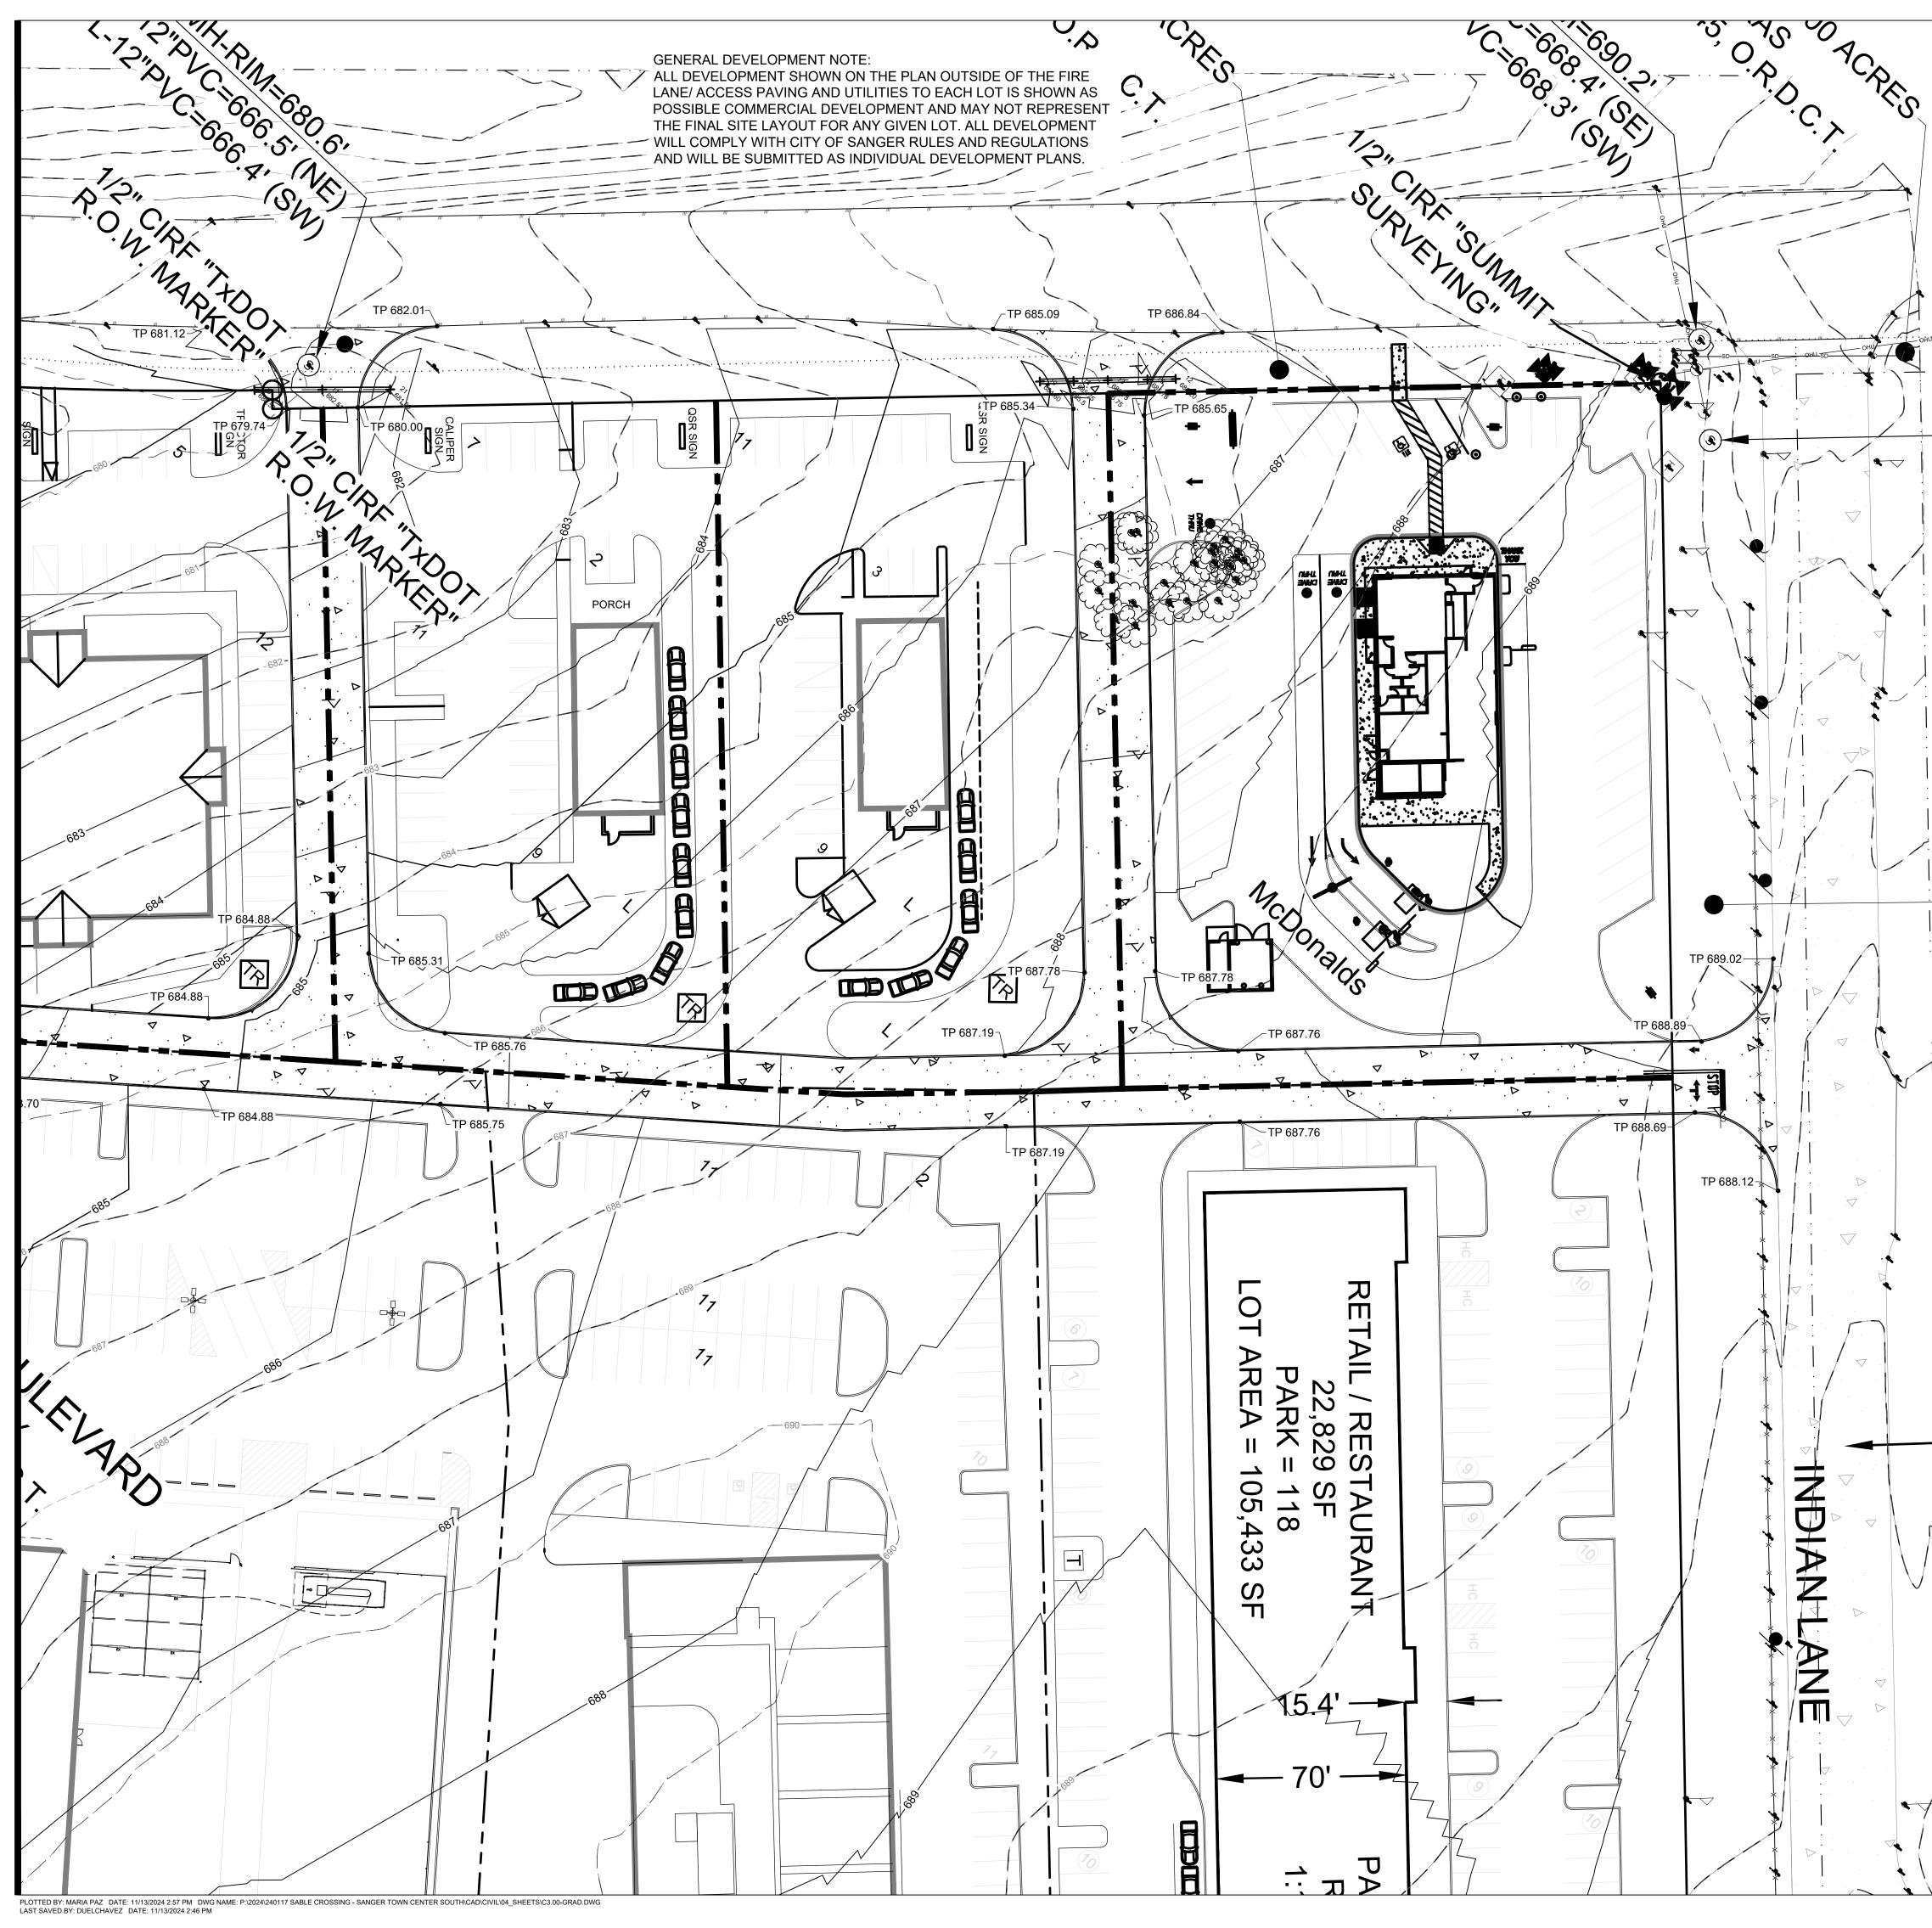
### **BENCHMARKS**:

N:7182983.6

TBM X-CUT TBM X-CUT TBM X-CUT N:7182732.0 N:7182983.6 E:2376464.4 E:2376692.0 E:2376464.4 ELEV:682.2' ELEV:683.2' ELEV:682.2'

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OF ROLL THE E DUMP TRUCK. AN INDERCUT AND
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SCALE: 1" = 30'

# www.kje-us.com Texas Firm F-12214 ENGINEERS & ENVIRONMENTAL

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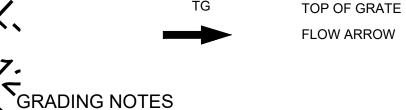




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Pro	oject No:	240117
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	signed By:	
	Issue Rec	ord
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**GRADING PLAN III** 

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LEGEND - GRADING PLAN

- - LOT BOUNDARY

- BUILDING

- DETENTION POND

TOP OF CURB

TOP OF PAVING

GUTTER

SIDEWALK

TOP OF WALL

BOTTOM OF WALL

- PROPOSED MAJOR CONTOUR

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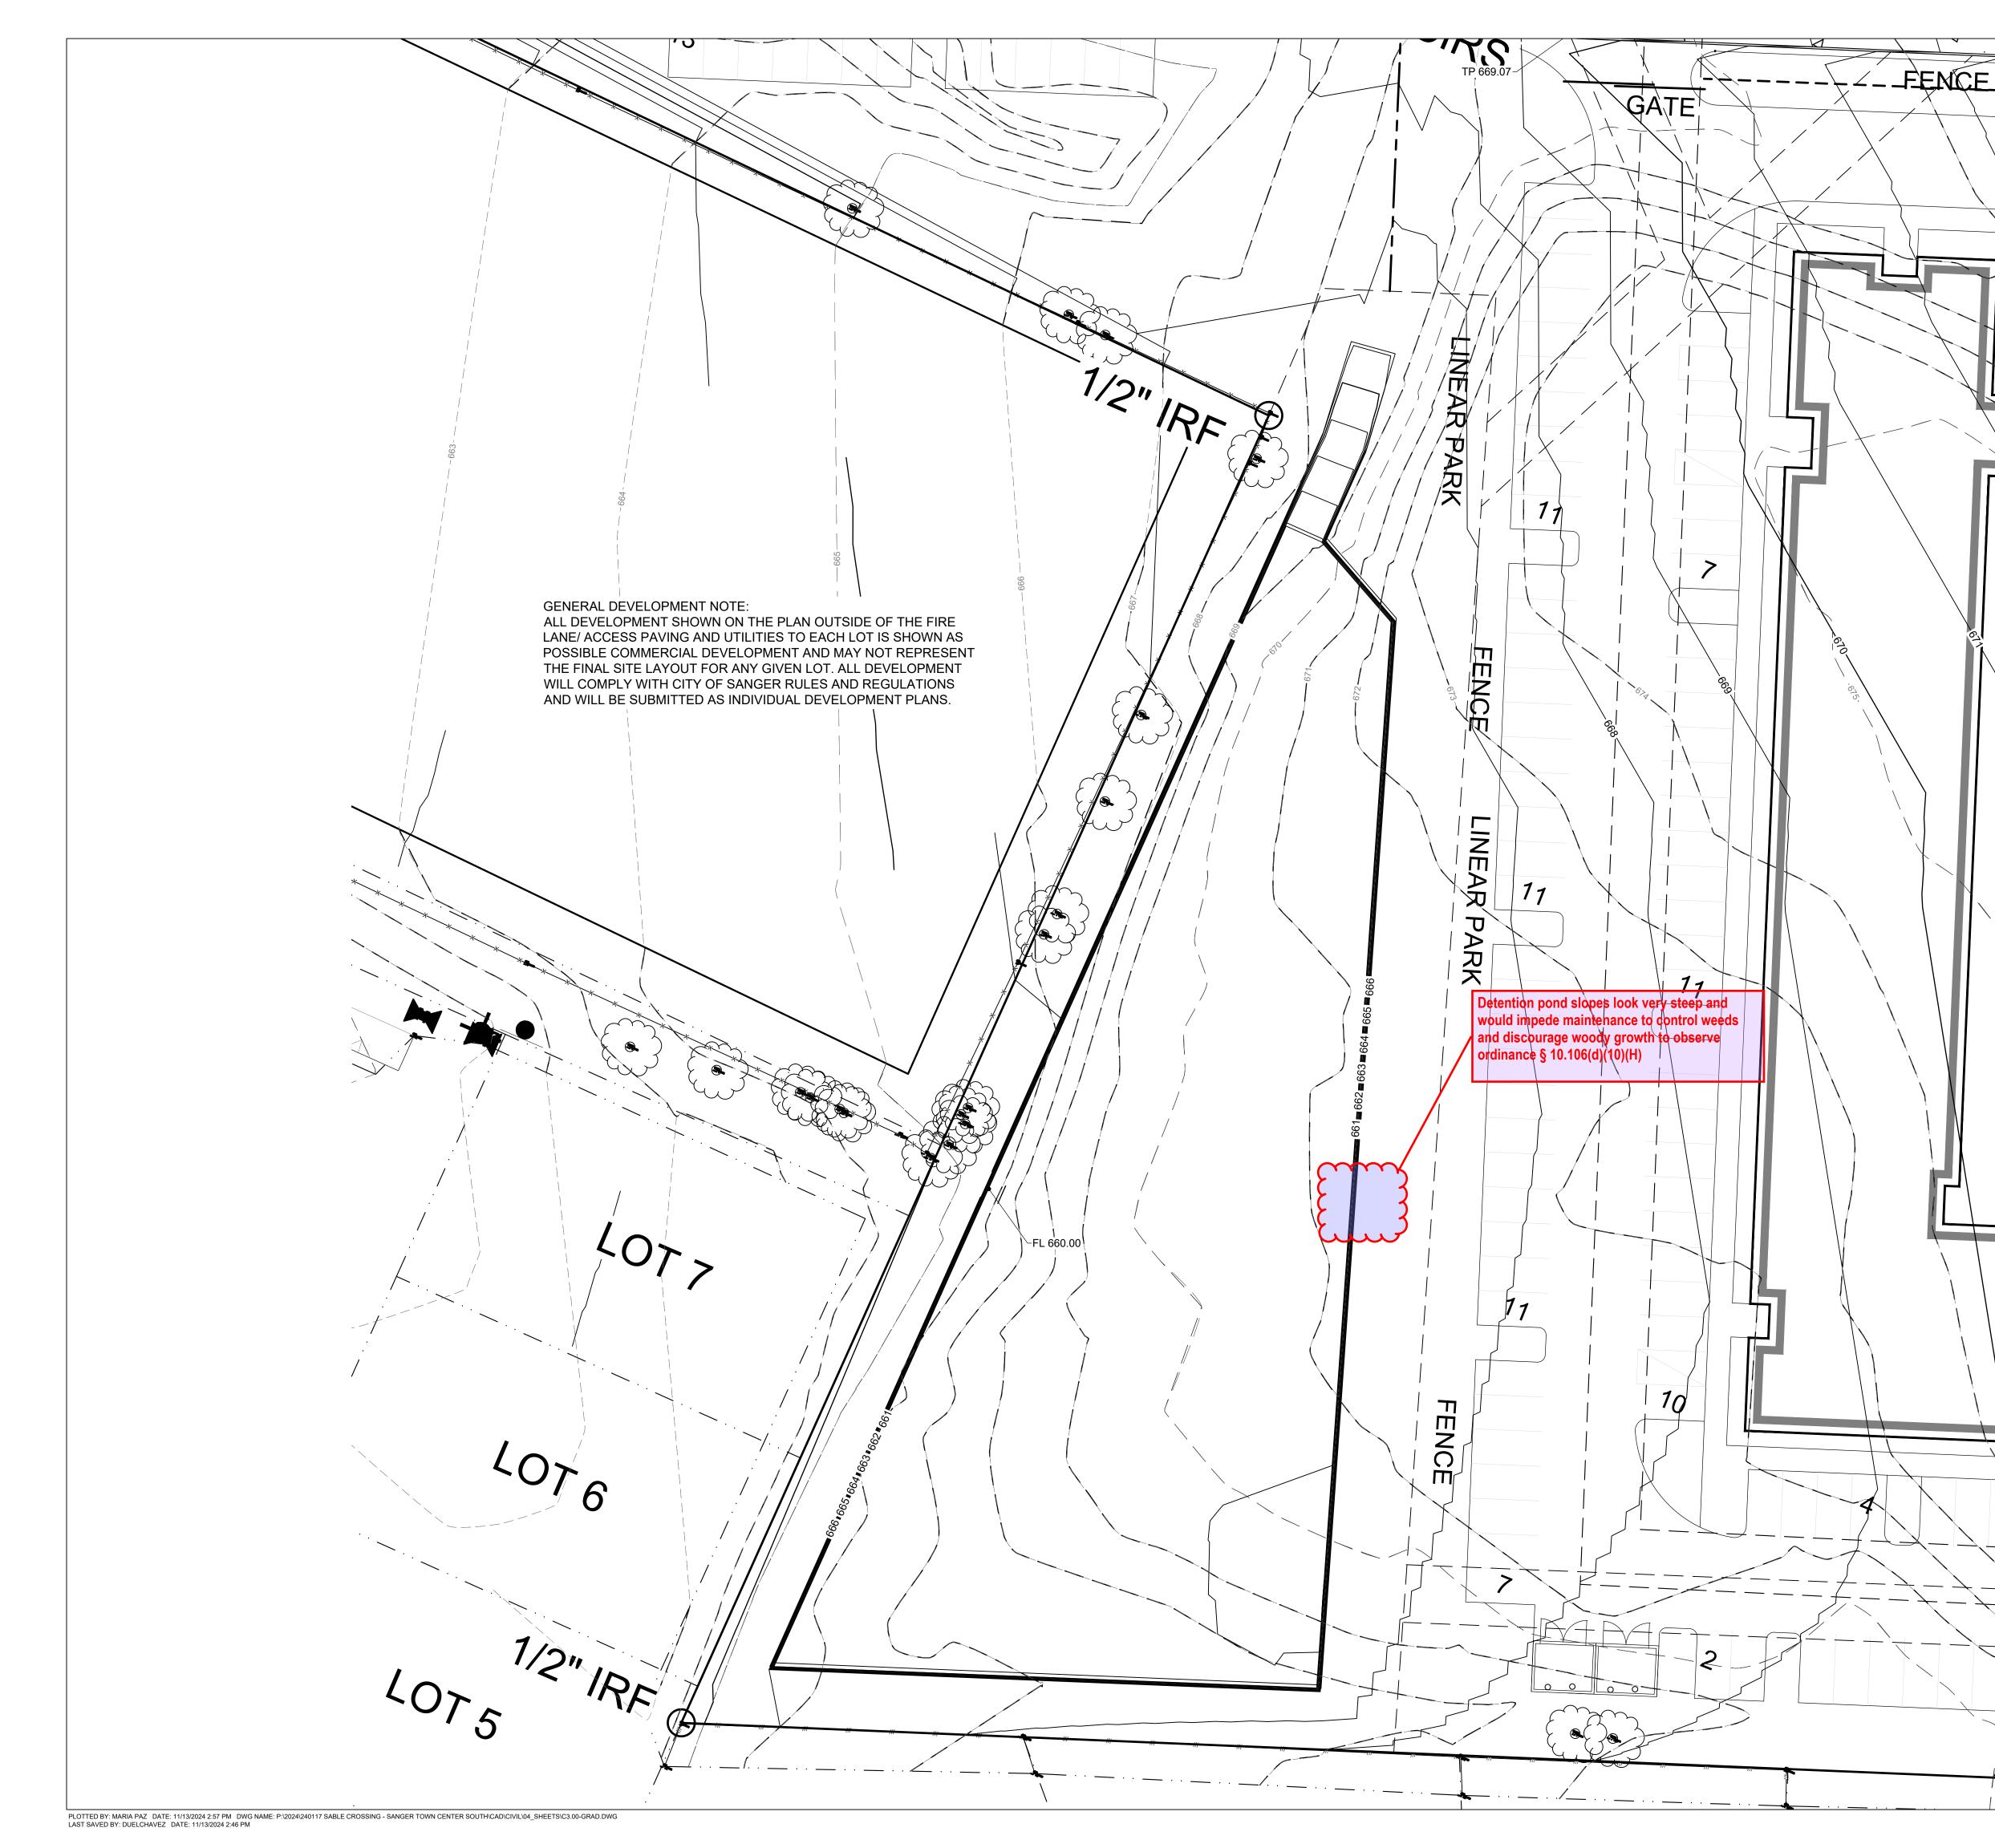
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# **BENCHMARKS**:

TBM X-CUT N:7182983.6







10' SCALE: 1" = 20'

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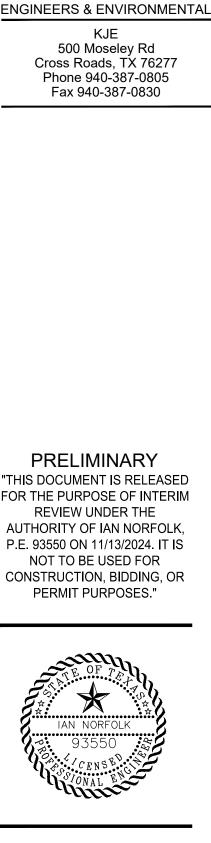
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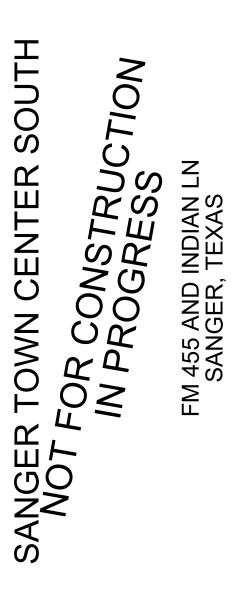
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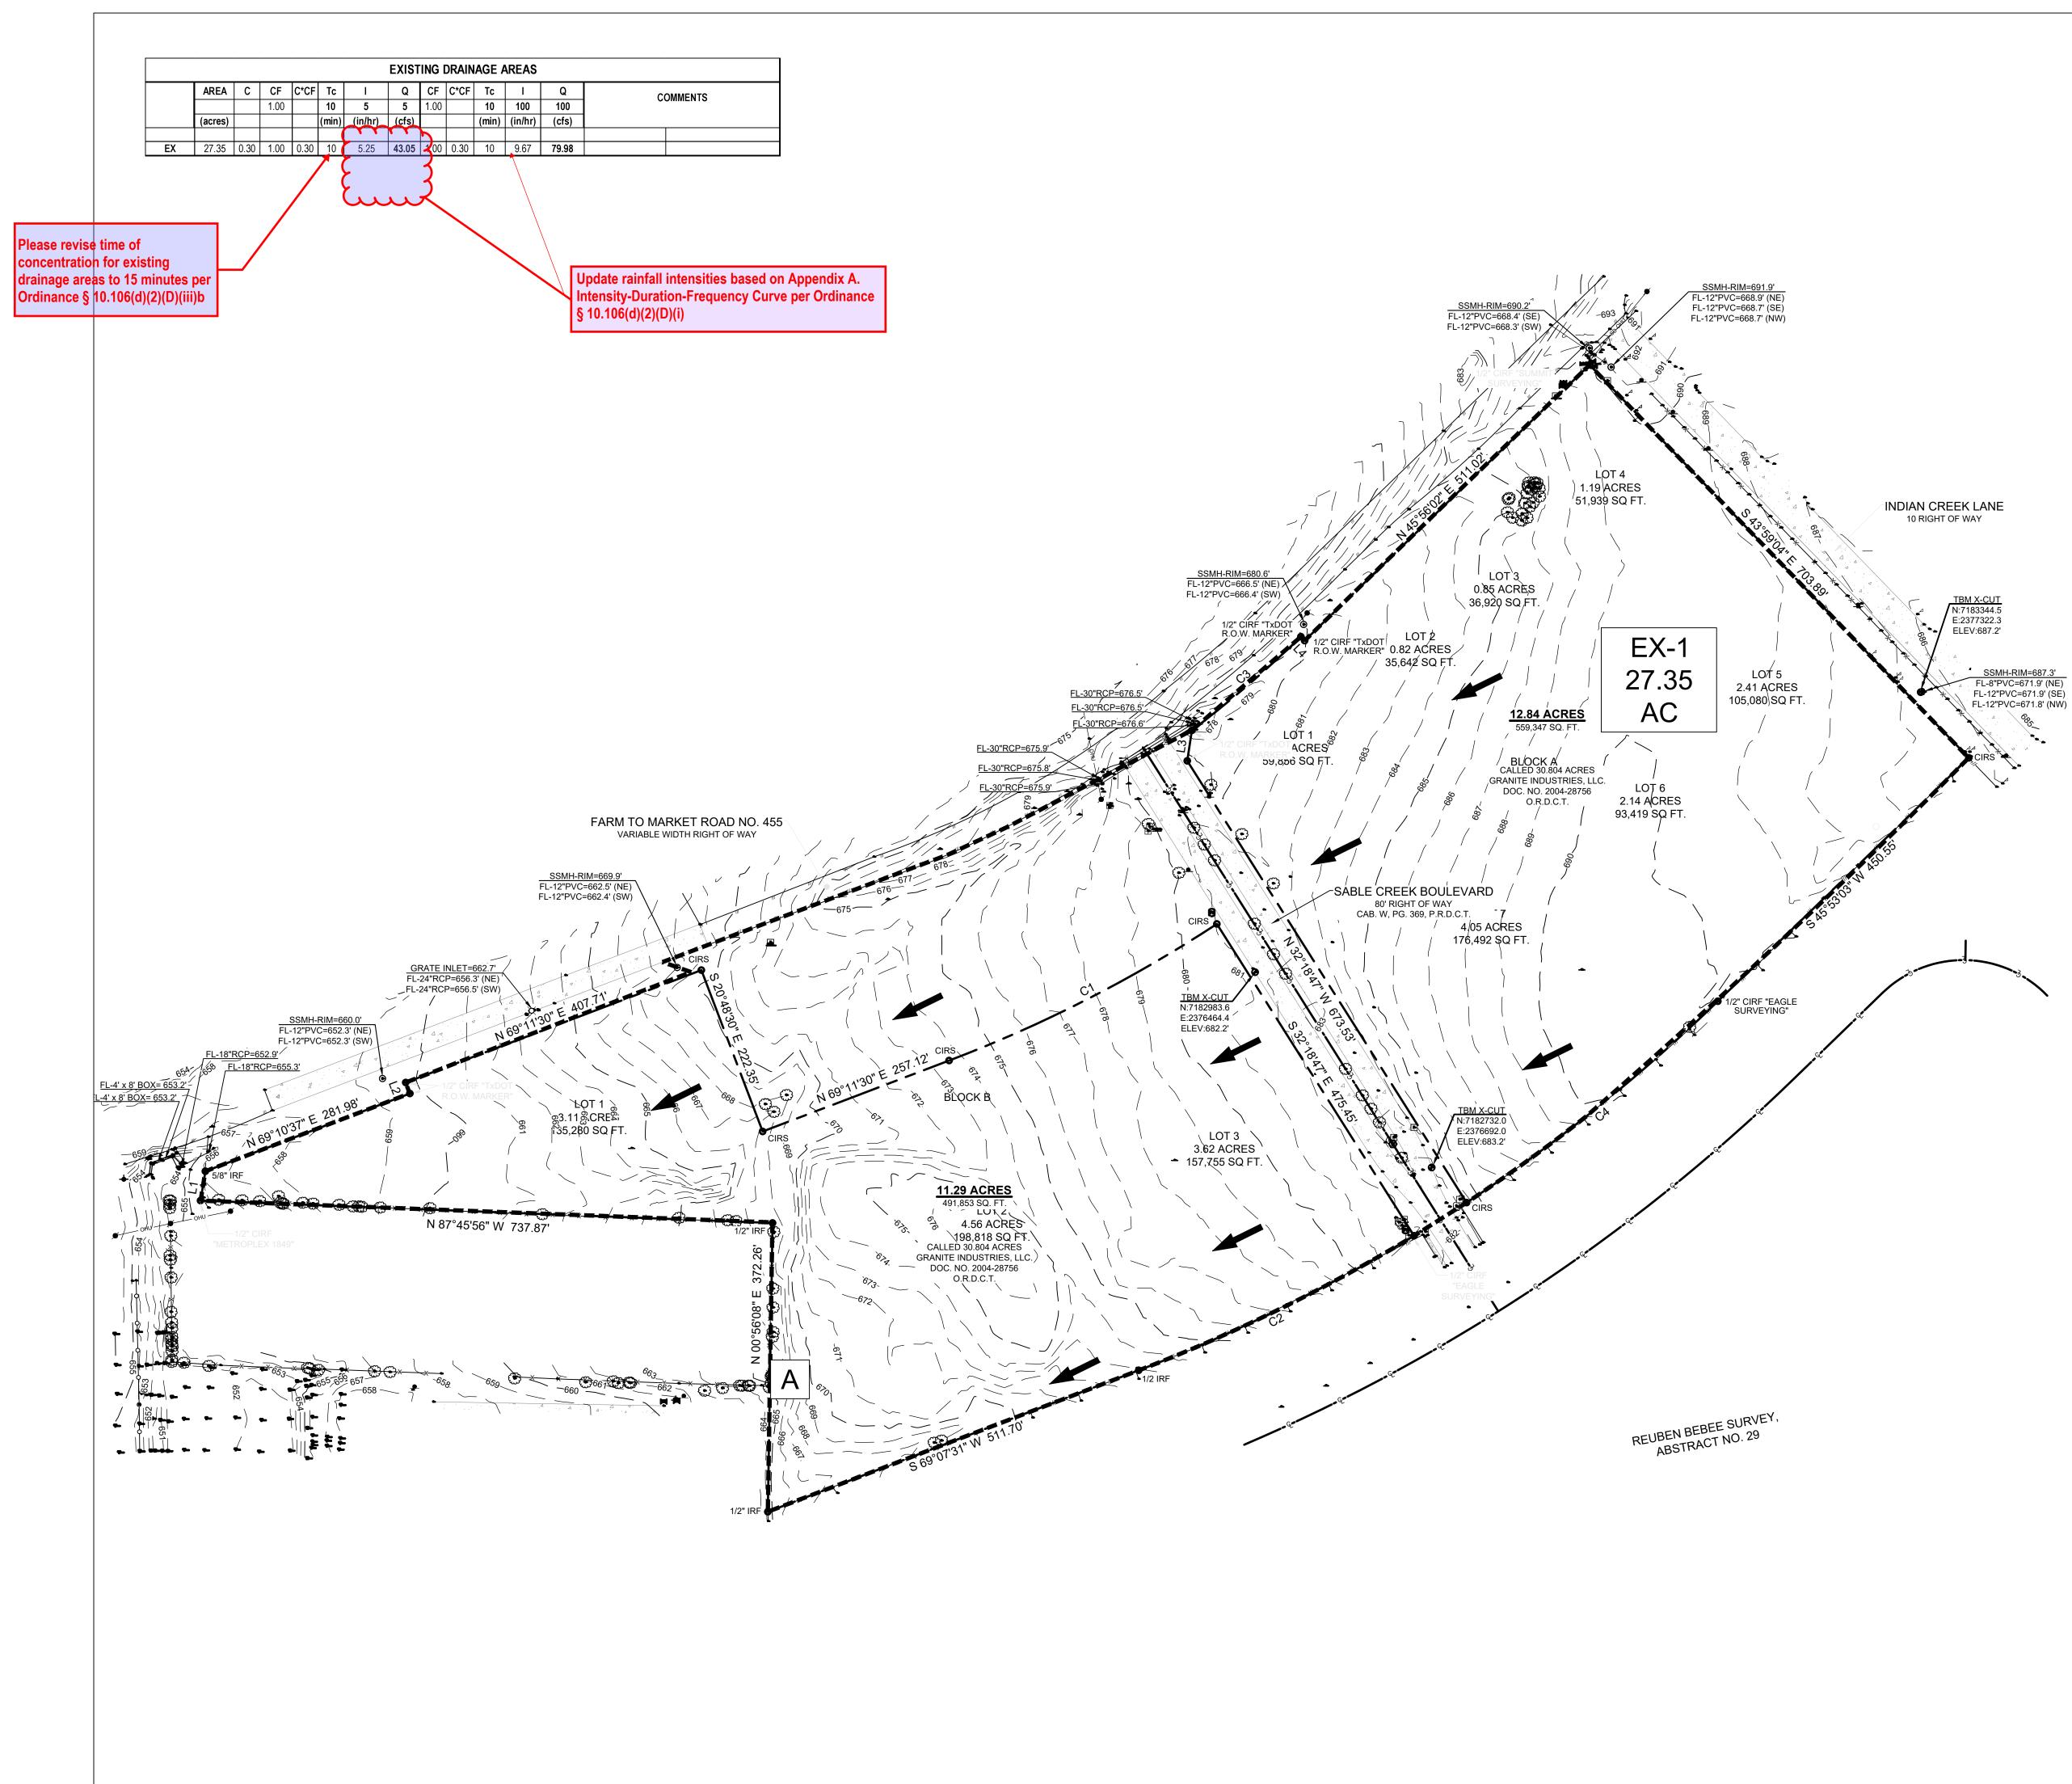
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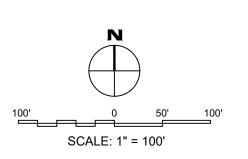
Issued Date:	11/12/2024
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### DETENTION POND GRADING


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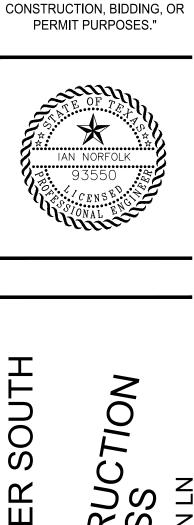


PLOTTED BY: MARIA PAZ DATE: 11/13/2024 2:57 PM DWG NAME: P:\2024\240117 SABLE CROSSING - SANGER TOWN CENTER SOUTH\CAD\CIVIL\04\_SHEETS\C4.00-DRNG.DWG LAST SAVED BY: DUELCHAVEZ DATE: 11/13/2024 1:58 PM



# LEGEND - EXISTING DRAINAGE AREA MAP



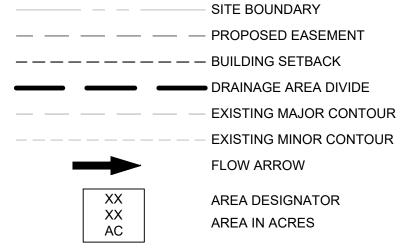

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FOR THE PURPOSE OF INTERIM

**REVIEW UNDER THE** 

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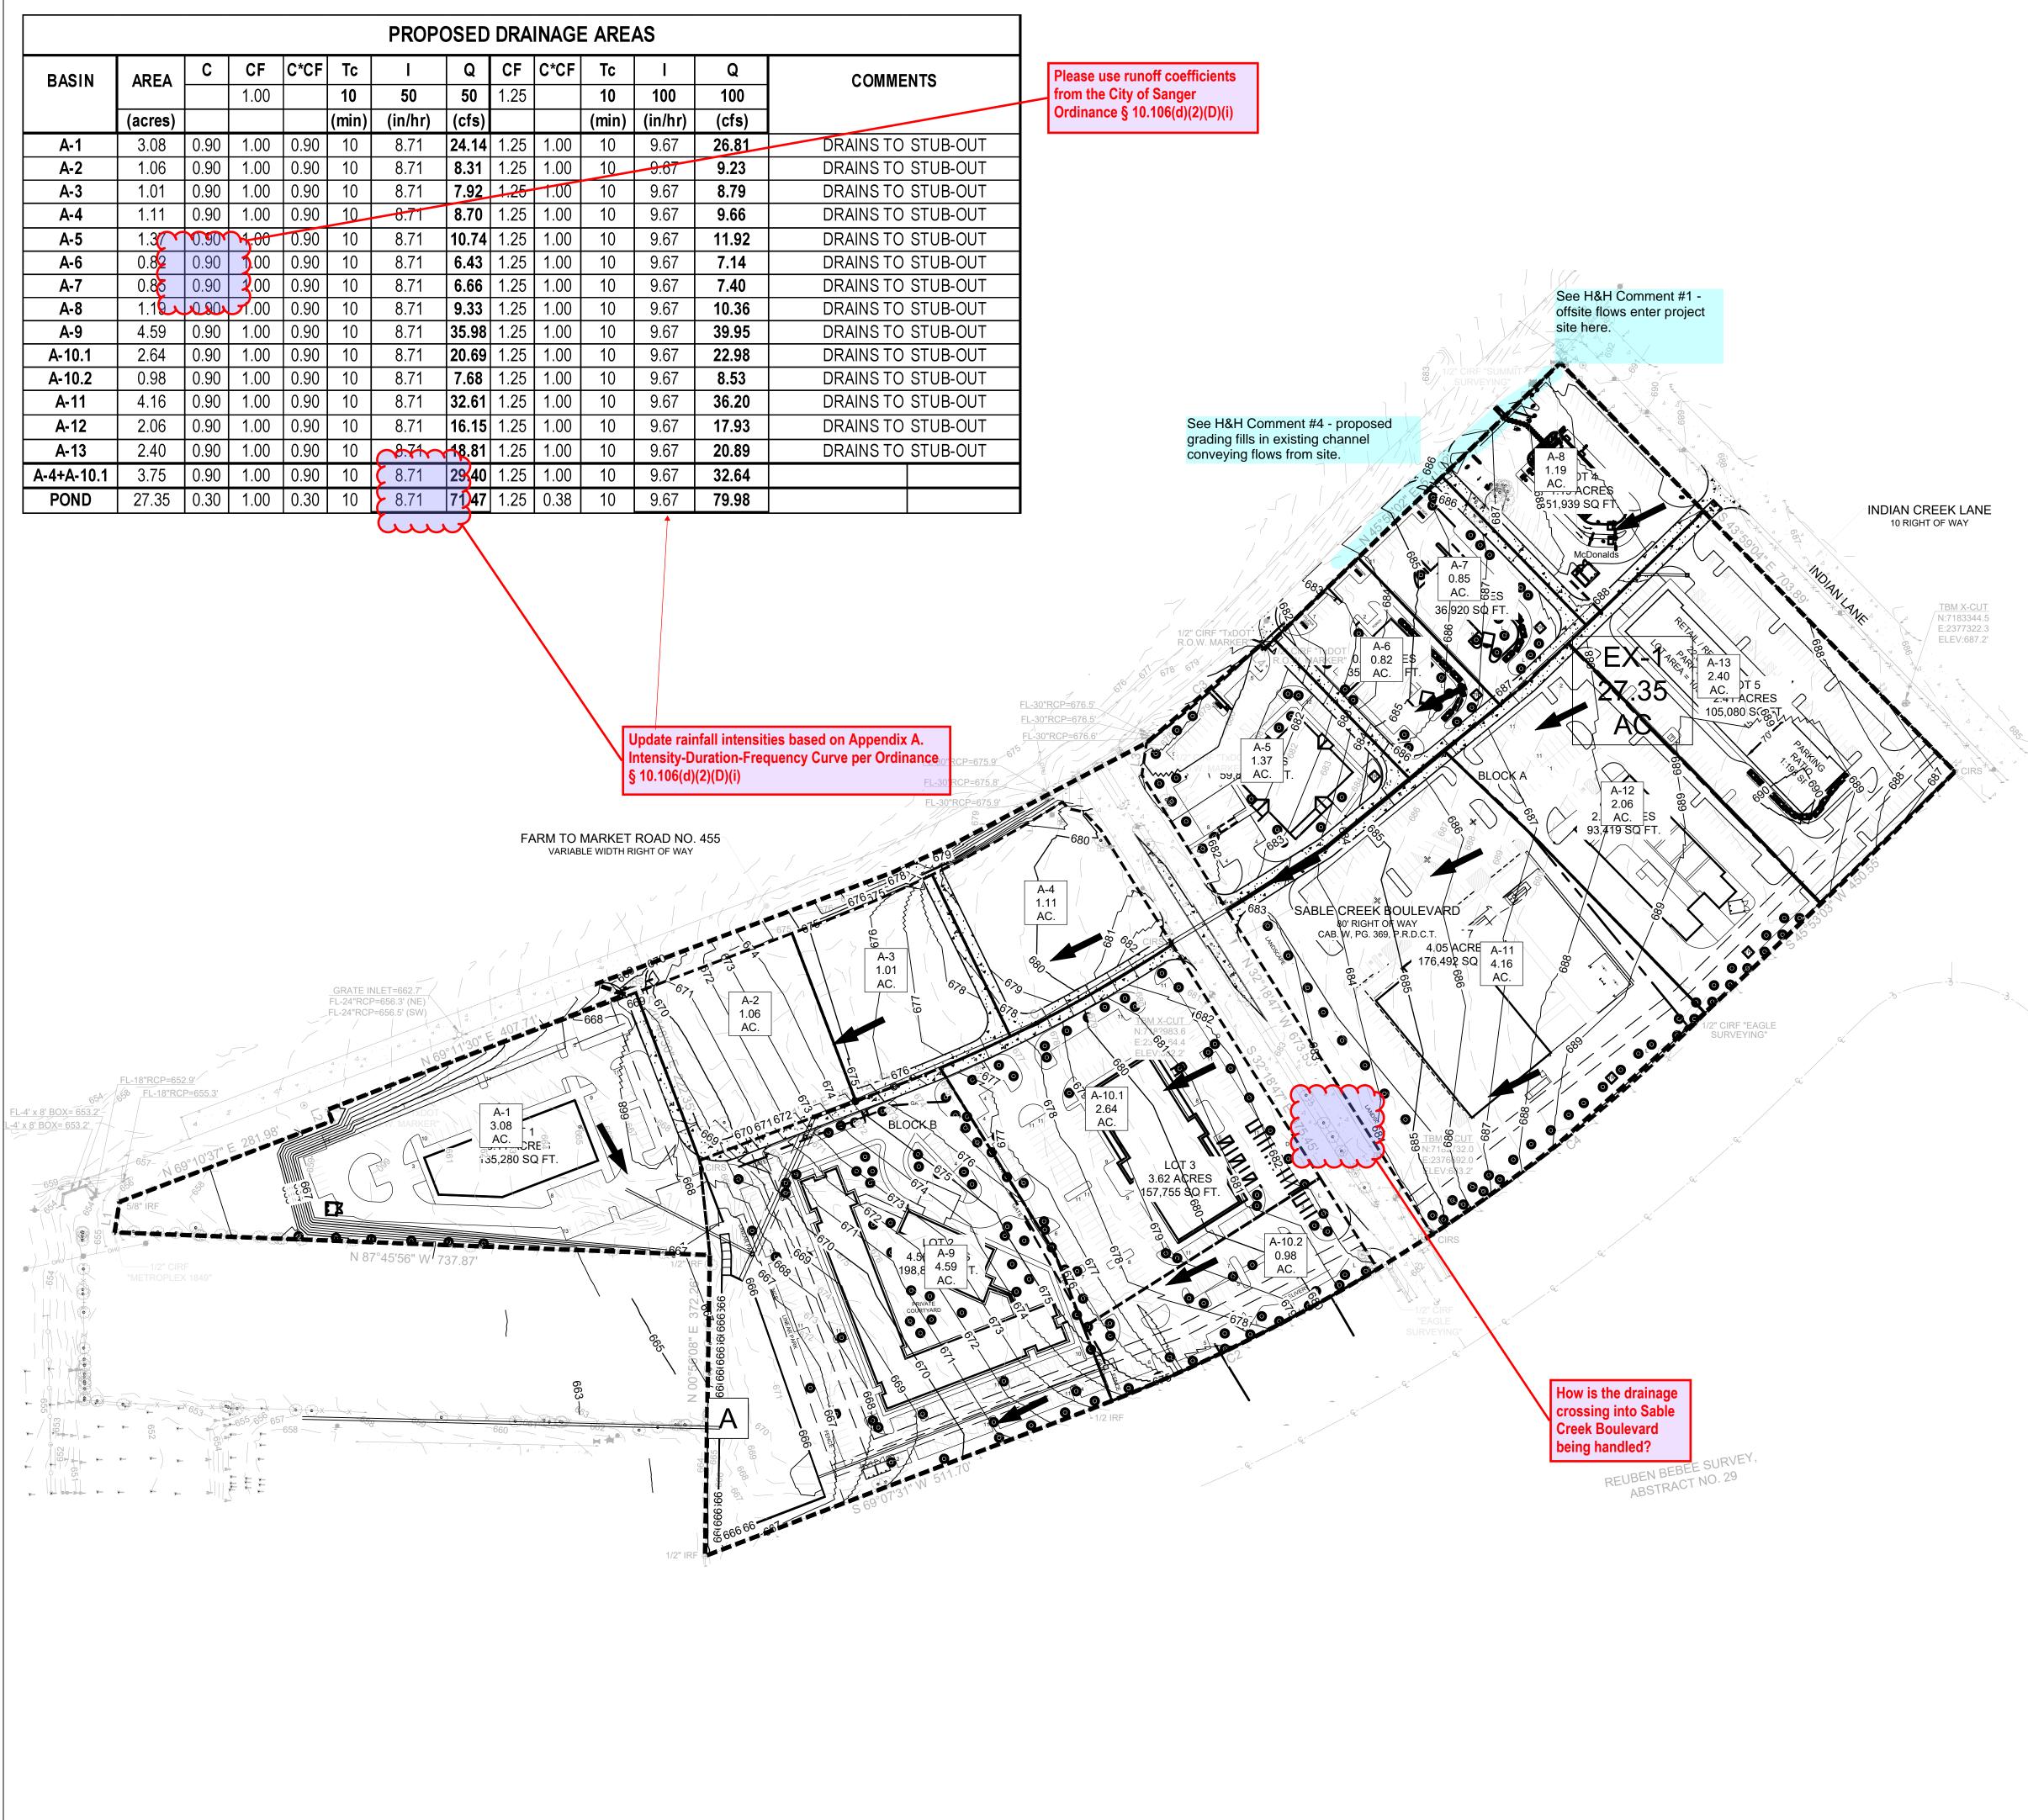
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PRE DRAINAGE AREA MAP


**BENCHMARKS**:

TBM X-CUT TBM X-CUT TBM X-CUT N:7182983.6


N:7182732.0 N:7182983.6 E:2376464.4 E:2376692.0 E:2376464.4 ELEV:682.2' ELEV:683.2' ELEV:682.2'



PLOTTED BY: MARIA PAZ DATE: 11/13/2024 2:57 PM DWG NAME: P:\2024\240117 SABLE CROSSING - SANGER TOWN CENTER SOUTH\CAD\CIVIL\04\_SHEETS\C4.00-DRNG.DWG LAST SAVED BY: DUELCHAVEZ DATE: 11/13/2024 1:58 PM

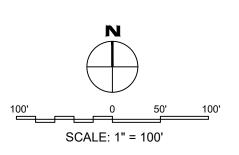

# LEGEND - PROPOSED DRAINAGE AREA MAP

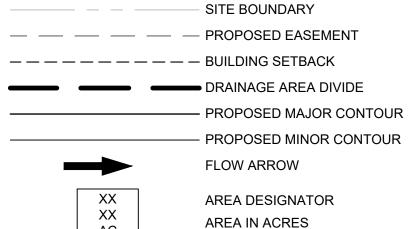


**STUBOUT NOTE:** 

ALL DRAINAGE FOR INTERNAL LOTS WILL BE COLLECTED BY THE MAIN STORM TRUNK LINE AND STUB OUTS TO EACH LOT. EACH STUB OUT IS SIZED FOR FULLY DEVELOPED FLOW.

AC

STUBOUTS ARE EXTENDED INTO EACH LOT ONLY TO THE EXTENT OF NOT IMPACTING PROPOSED UTILITES OR PAVING. EXTENSIONS INTO THE LOTS AFTER THAT POINT ARE FOR THE PURPOSES OF FIELD LOCATION ONLY WITH WYE INLETS. WYE INLETS ARE NO INTENEDED TO COLLECT UNDEVELOPED FLOWS.



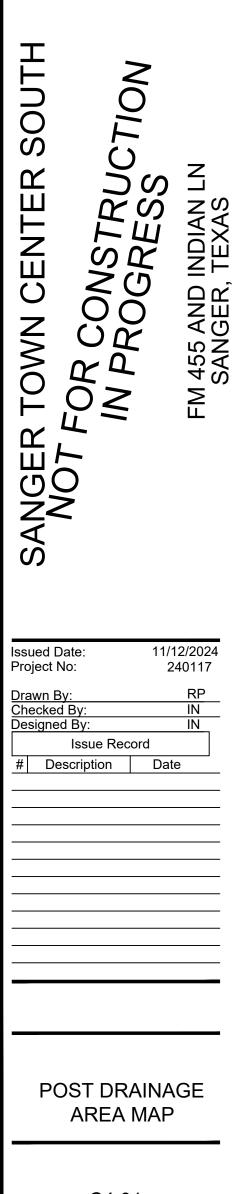


**BENCHMARKS:** 

N:7182732.0

TBM X-CUT TBM X-CUT N:7182983.6 E:2376692.0 E:2376464.4 ELEV:683.2' ELEV:682.2'

		C A	Tc	i <sub>100</sub>		Q (cfs)				Ultimate R	ın-Off Volume - I	requency: 1	00 years								•		outh Outfall Struc			5					
DA Nar	ne EX.	PR. Area (ad		(in/hr)	EX. 100-y		. 100-yr			Area:	27.3 acres		C <sub>factor</sub> :	0.9	Elevation	Depth I	Pond	Orifice - Q=0 FL=	.6(A)(2gh) <sup>0.5</sup> D(ir 660.00 ft	n)= 22.3 O	Prifice - Q=0.6(A) FL= 6	(2gh) <sup>0.3</sup> 62.88 ft	D(in)= 26	Broad Crest We FL=	ir - Q=2.68LH'`` 665.00	° L(ft)= ( ft	2.6 Water Qualit	• • •	Allowable Com	storm pare Event	www.kje-us.com
ΤΟΤΑ	L 0.3	0.9 27.3	10	9.67	79.83	2	39.49	D (min	n) i (in/ 12.1	-			allowable <b>(cfs)</b> 79.83	V <sub>s</sub> (cu-f) 65954	(54)		Volume Or	ifice Dia. (in)	Head Ou	utflow Q O (cfs)	Drifice Dia. H	Head	Outflow Q (cfs)	Length	Head (ft)	Outflow (cfs)	Q Dischar 24hr (c	rge detention fs) (cfs)	Flow Flo (cfs) (cfs	w	Texas Firm F-12214 ENGINEERS & ENVIRONMENTAL
								10	9.6				79.83	95798	(ft) 660.00	(ft) 0.00	0.00	22.28	0.00	0.00		0.00	0.00	2.61	0.00	0.00	0.00	0.00		s) (yi)	KJE 500 Moseley Rd
DA Nar	ne	C A	Тс	i <sub>50</sub>		Q (cfs)		15	7.98	8 197	.64 17787	3.43	79.83	106026	661.00 662.00			22.28 22.28	1.00 2.00	6.98 26.99		0.00	0.00	2.61 2.61	0.00	0.00	0.00				Cross Roads, TX 76277 Phone 940-387-0805 Fax 940-387-0830
	EX.	PR. Area (ad		(in/hr)	EX. 50-y		R. 50-yr	20					79.83	116998	663.00	3.00 5	54,160	22.28	3.00	37.53	25.50	0.13	0.00	2.61	0.00	0.00	0.00	37.53			
ΤΟΤΑ	L 0.3	0.9 27.3	10	8.71	71.91	2	15.72	30	5.5				79.83	101941	663.13 664.00			22.28 22.28		38.70 45.70		0.26 1.13	0.00	2.61	0.00	0.00	0.00	38.70 49,96	38.72 -0.0	01 2	
			<b>-</b>	• I		0 ( - ( - )				Area:	un-Off Volume - 27.3 acres	Frequency:	C <sub>factor</sub> :	0.9	<u> </u>			22.28 22.28		46.21 50.13		1.19 1.75	6.20 14.17	2.61 2.61	0.00 0.00	0.00	<u> </u>	52. <b>4</b> 1 64. <b>3</b> 0	54.57 -2.1 64.31 -0.0		
DA Nar	ne – – – – – – – – – – – – – – – – – – –			125		Q (cfs)	25	D (min				u-f) Q	allowable (Cfs)		665.00		• ·,= · =	22.28		52.61		2.13	17.60	2.61	0.00	0.00	0.00	$\rightarrow$	04.51 -0.0	25	
ΤΟΤΑ	EX.	PR. Area (ad 0.9 27.3	:) (min) 10	(in/hr) 7.79	EX. 25-y 64.31		R. 25-yr 92.93	5	10.8	•			71.91	58672	665.04 665.51			22.28 22.28		52.87 55.82		2.16 2.64	17.93 21.43	2.61 2.61	0.04	0.06		70- <b>8</b> 5	71.91 -1.0 79.83 -0.0	06 50 01 100	
	<b>L</b>   0.0	0.3 21.3		1.13	04.31	I	52.55	10	8.7				71.91	86287	666.00			22.28		58.72		3.13	24.52	2.61	1.00	6.99	0.00	90.24			
		C A	Tc	i <sub>10</sub>		Q (cfs)		15 20	7.1 <sup>°</sup> 6.4				71.91 71.91	95104 <b>104713</b>												(	tun	und .			
DA Nar	ne EX.	PR. Area (ad		(in/hr)	EX. 10-y		R. 10-yr	30	4.94				71.91	90794																	
TOTA	L 0.3		10	6.61	54.57	1	63.71				un-Off Volume -				- ТОР		OND:						[	— BRC	AD CR	ESTED	S #	ee H&H Com 14 - please p	nment provide		PRELIMINARY
	_								/	Area:	27.3 acres		C <sub>factor</sub> :	0.9		66	66.52' 							WEI	R FL: 6	65.00'	m	ore informat	ion		"THIS DOCUMENT IS RELEASED FOR THE PURPOSE OF INTERIM
		C A	Tc	i <sub>2</sub>		Q (cfs)		D (min					allowable (cfs)	V <sub>s</sub> (cu-f)				Δ	4							Δ 					REVIEW UNDER THE AUTHORITY OF IAN NORFOLK,
DA Nar	ne EX.	PR. Area (ad	;) (min)	(in/hr)	EX. 10-y		R. 10-yr	5	9.7				64.31	52852				1	<ul> <li>✓</li> <li></li> </ul>			/				-					P.E. 93550 ON 11/13/2024. IT IS NOT TO BE USED FOR CONSTRUCTION, BIDDING, OR
ΤΟΤΑ	L 0.3		10	4.69	38.72	1	16.16	10	7.79 6.43				64.31 64.31	77173 85445			<	Д	· _									CRETE CO	OMBINATIO	ON	PERMIT PURPOSES."
								20	5.7				64.31	94212				$\Delta \triangleleft$		< Δ	Δ		· · · ·	26" OF	RIFICE	✓		TO BE DE CITY OF S			
								30	4.44				64.31	82175	_			:	4	Δ	₹			FL: 662		⊿.	STAN	IDARD FC	OR MINIMU		
										Area:	un-Off Volume - 27.3 acres	Frequency:	C <sub>factor</sub> :	0.9	_			4										FORCEME WALKS	ENTS FOR		IAN NORFOLK
						Undata int	ensities and	D (min				u-f) Q	allowable (Cfs)	V <sub>s</sub> (cu-f)	_				/												93550 55 (CENSE)
						runoff coe	fficients to	5	8.24	4 204	.08 6122	2.94	54.57	44852					1			+			I						CENSE VONAL ENSE
						make City Drainage a	of Sanger and Storm	10	6.6 <sup>°</sup> 5.4(				54.57 54.57	65483 72591											$\rightarrow$						
							rovements s (§ 10.106(d)	20	4.9				54.57 54.57	<b>80145</b>			· A 7			// .											
						Drainage a Sewer Imp	and Storm	30	3.78				54.57	70287						Δ											
						Sewer mp	novements)	_ ⊢			Run-Off Volume -	Frequency:	<u> </u>	0.0	_			Δ		⊲ .		$\bigtriangleup$	$\triangleleft$								
								D (min		Area: hr) Q <sub>PR</sub>	27.3 acres (cfs) V <sub>r</sub> (c	u-f) Q	allowable (Cfs)	<b>V<sub>s</sub> (cu-f)</b>	-			<u>.                                    </u>			22 3" DL										
								5	5.80				38.72	31924	-						EL: 660.										SCI SCI
								10	4.69				38.72	46462					OUTE				SECTIC		ΔII						
								15	3.89 3.49				38.72 38.72	51861 <b>57359</b>					0011			N.T.S.			/ \1						
								30	2.7				38.72	50672																	
													SANGE	R TOWN CENT	FR SOUTH																
	RUI	OFF COLLECTION POIN	Γ (Inlet or Manh	nole)	1		INCREM	IENTAL DRAI	INAGE		TIME	AT DESI		STORM	SLOPE OF		SELECTE		VELOCITY	STANDAR	MINOD		, FLOW TIME			HYDRAUL	IC GRADE				
				UPSTREA	DOWNSTR	DISTANCE BETWEEN		RUNOFF II	NCREMEN	CA FROM WYE		REA STOF		RUNOFF	HYDRAULI C	#	STORM SEWER			ן פטט ן	MINOR LOSS	VELOCITY HEAD	IN SEVVER	DS		GRADE		MINOR		INLET TOP	NAC SAN
LINE/LAT	AREA	JUNCTIONS	AREA	M STATION	EAM	COLLECTI		COEFF.	TAL "CA"	OR MH (LINK TO	ATED M STAT	FION FREQU	(in/hr)	"Q"	GRADIENT	BARRELS	SIZE		COLLECTI	JUNCTION LOSS	COEFF. "Kj"	(V2/2g) (feet)	DISTANCE V x 60	HYD. GRADE	FRICTION LOSSES	AFTER FRICTION	JUNCTION LOSSES	LOSSES	GRADE AFTER	ELEVATIO N	
							(acres)	C*Cf		LATERAL'S	(minu	,	.)	(c.f.s.)	3		RCB	(teet	) "\/"	К	I Ŋ	(feet)	(minutes)			LOSS			HYD. JUMP		
1	2	3 4	5	6	7	8	9	10 C	11	12	<b>13 14</b> 10.0		16 00 TABLE	17	<b>18</b> 0.01	19	20	21	<b>22</b> 12.00	23	24	25	26	27	28	29	30	31	32	33	
	A	INLET	A-13	1515.13	1455.01	60.12	2.40	0.90	2.16		2.16 10.0	0 100.0	00 9.67	20.89	0.00	1.00	30.00		4.26		1.50	0.28	0.24	676.32	0.13	676.46	0.00	0.42	676.88	688.32	(0)
		BEND 45° MH 0°	A-8	1455.01 1389.35	1389.35 1219.23	65.66 170.12	1.19	0.90	1.07		2.1610.23.2310.4			20.71 30.67	0.00	1.00 1.00	30.00 36.00		4.22		0.35 0.50	0.28	0.26	676.08 675.63	0.14 0.31	676.23 675.94	0.00	0.10 0.15	676.32 676.08	688.32 688.00	
		MH 0°	A-7	1219.23	1146.95	72.28	0.85	0.90	0.77		4.00 11.1	5 100.0	00 9.26	37.01	0.00	1.00	36.00		5.24		0.50	0.29	0.23	675.23	0.19	675.42	0.00	0.21	675.63	687.03	Issued Date: 11/12/2024
		MH 0° MH 0°	A-12 A-6	1146.95 1091.24		55.71 150.76	2.06 0.82	0.90	1.85 0.74		5.8511.36.5911.6			53.70 59.96	0.00	1.00	48.00		4.27		0.50 0.50	0.28	0.22	675.02 674.62	0.07	675.09 674.84	0.00	0.14 0.18	675.23 675.02	686.49 686.04	Project No:         240117           Drawn By:         RP
		BEND 30°		940.48	829.27	111.21					6.59 12.1	2 100.	00 8.91	58.73	0.00	1.00	48.00		4.67		0.30	0.34	0.40	674.38	0.16	674.54	0.00	0.08	674.62	684.88	Drawn By:     RP       Checked By:     IN       Designed By:     IN
		WYE 45° MH 0°	A-11 A-5	829.27 817.36		11.91 101.74	4.16 1.37	0.90	3.74 1.23		10.3312.911.5712.9			90.65	0.00	1.00 1.00	48.00		7.21		0.50	0.81	0.03	674.34 673.40	0.04	674.38 673.83	0.00	0.00 0.51	674.38 674.34	682.75 682.52	Issue Record # Description Date
		MH 0°		715.62	521.53	194.09					11.57 12.7	76 100.0	00 8.69	100.48	0.00	1.00	48.00		8.00		0.50	0.99	0.40	672.09	0.81	672.90	0.00	0.50	673.40	680.41	
		MH 0° MH 0°	A-4+A-10.1 A-3	521.53 276.87		244.66 54.97	3.75 1.01	0.90	3.38 0.91		14.9413.115.8513.5			127.66 133.16	0.01	1.00	48.00 48.00		10.16 10.60		0.50 0.50	1.60 1.74	0.40	669.64 668.37	1.65 0.40	671.29 668.77	0.00	0.80 0.87		677.61 674.13	
		MH 45°		221.90	195.08	26.82					15.85 13.6	65 100.0	00 8.37	132.67	0.01	1.00	48.00		10.56		0.50	1.73	0.04	667.31	0.19	667.50	0.00	0.87	668.37	672.48	
		WYE 60° MH 0°	A-2 A-1	195.08 35.72	35.72	159.36 35.72	1.06 3.08	0.90 0.90	0.95 2.77		16.8013.619.5813.9			140.40 161.91	0.01	1.00 1.00	48.00 54.00		11.17 10.18		0.50	1.94 1.61	0.24	666.01 665.00	1.30 0.21	667.31 665.21	0.00	0.00 0.81		669.46 666.75	
LINE	P																														
		INLET	A-10.2	382.10		382.10	0.98	0.90	0.88		0.88 10.0	)0 100.0	00 9.67	8.53	0.01	1.00	18.00		4.83		1.50	0.36	1.32	665.00	2.15	667.15	0.00	0.54	667.69	674.72	
	OUTFALI																														
		INLET	POND	517.27		517.27	27.35	0.30	8.21		8.21 10.0	)0 100.(	00 9.67	79.34	0.01	1.00	42.00		8.25		1.50	1.06	1.05	660.50	2.74	663.24	0.00	1.59	664.83	666.00	
																												NCHMARKS			DRAINAGE

PLOTTED BY: MARIA PAZ DATE: 11/13/2024 2:57 PM DWG NAME: P:\2024\240117 SABLE CROSSING - SANGER TOWN CENTER SOUTH\CAD\CIVIL\04\_SHEETS\C4.00-DRNG.DWG LAST SAVED BY: DUELCHAVEZ DATE: 11/13/2024 1:58 PM

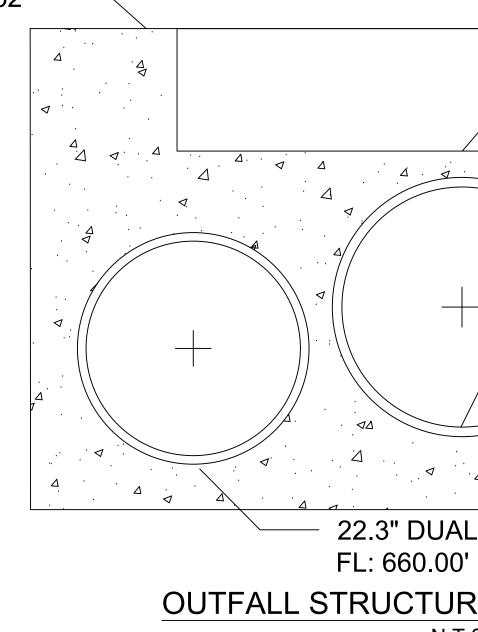



DRAINAGE CALCULATIONS I

**BENCHMARKS**:

 
 TBM X-CUT
 TBM X-CUT
 TBM X-CUT


 N:7182983.6
 N:7182732.0
 N:7182983.6
 E:2376464.4 E:2376692.0 E:2376464.4 ELEV:682.2' ELEV:683.2' ELEV:682.2'

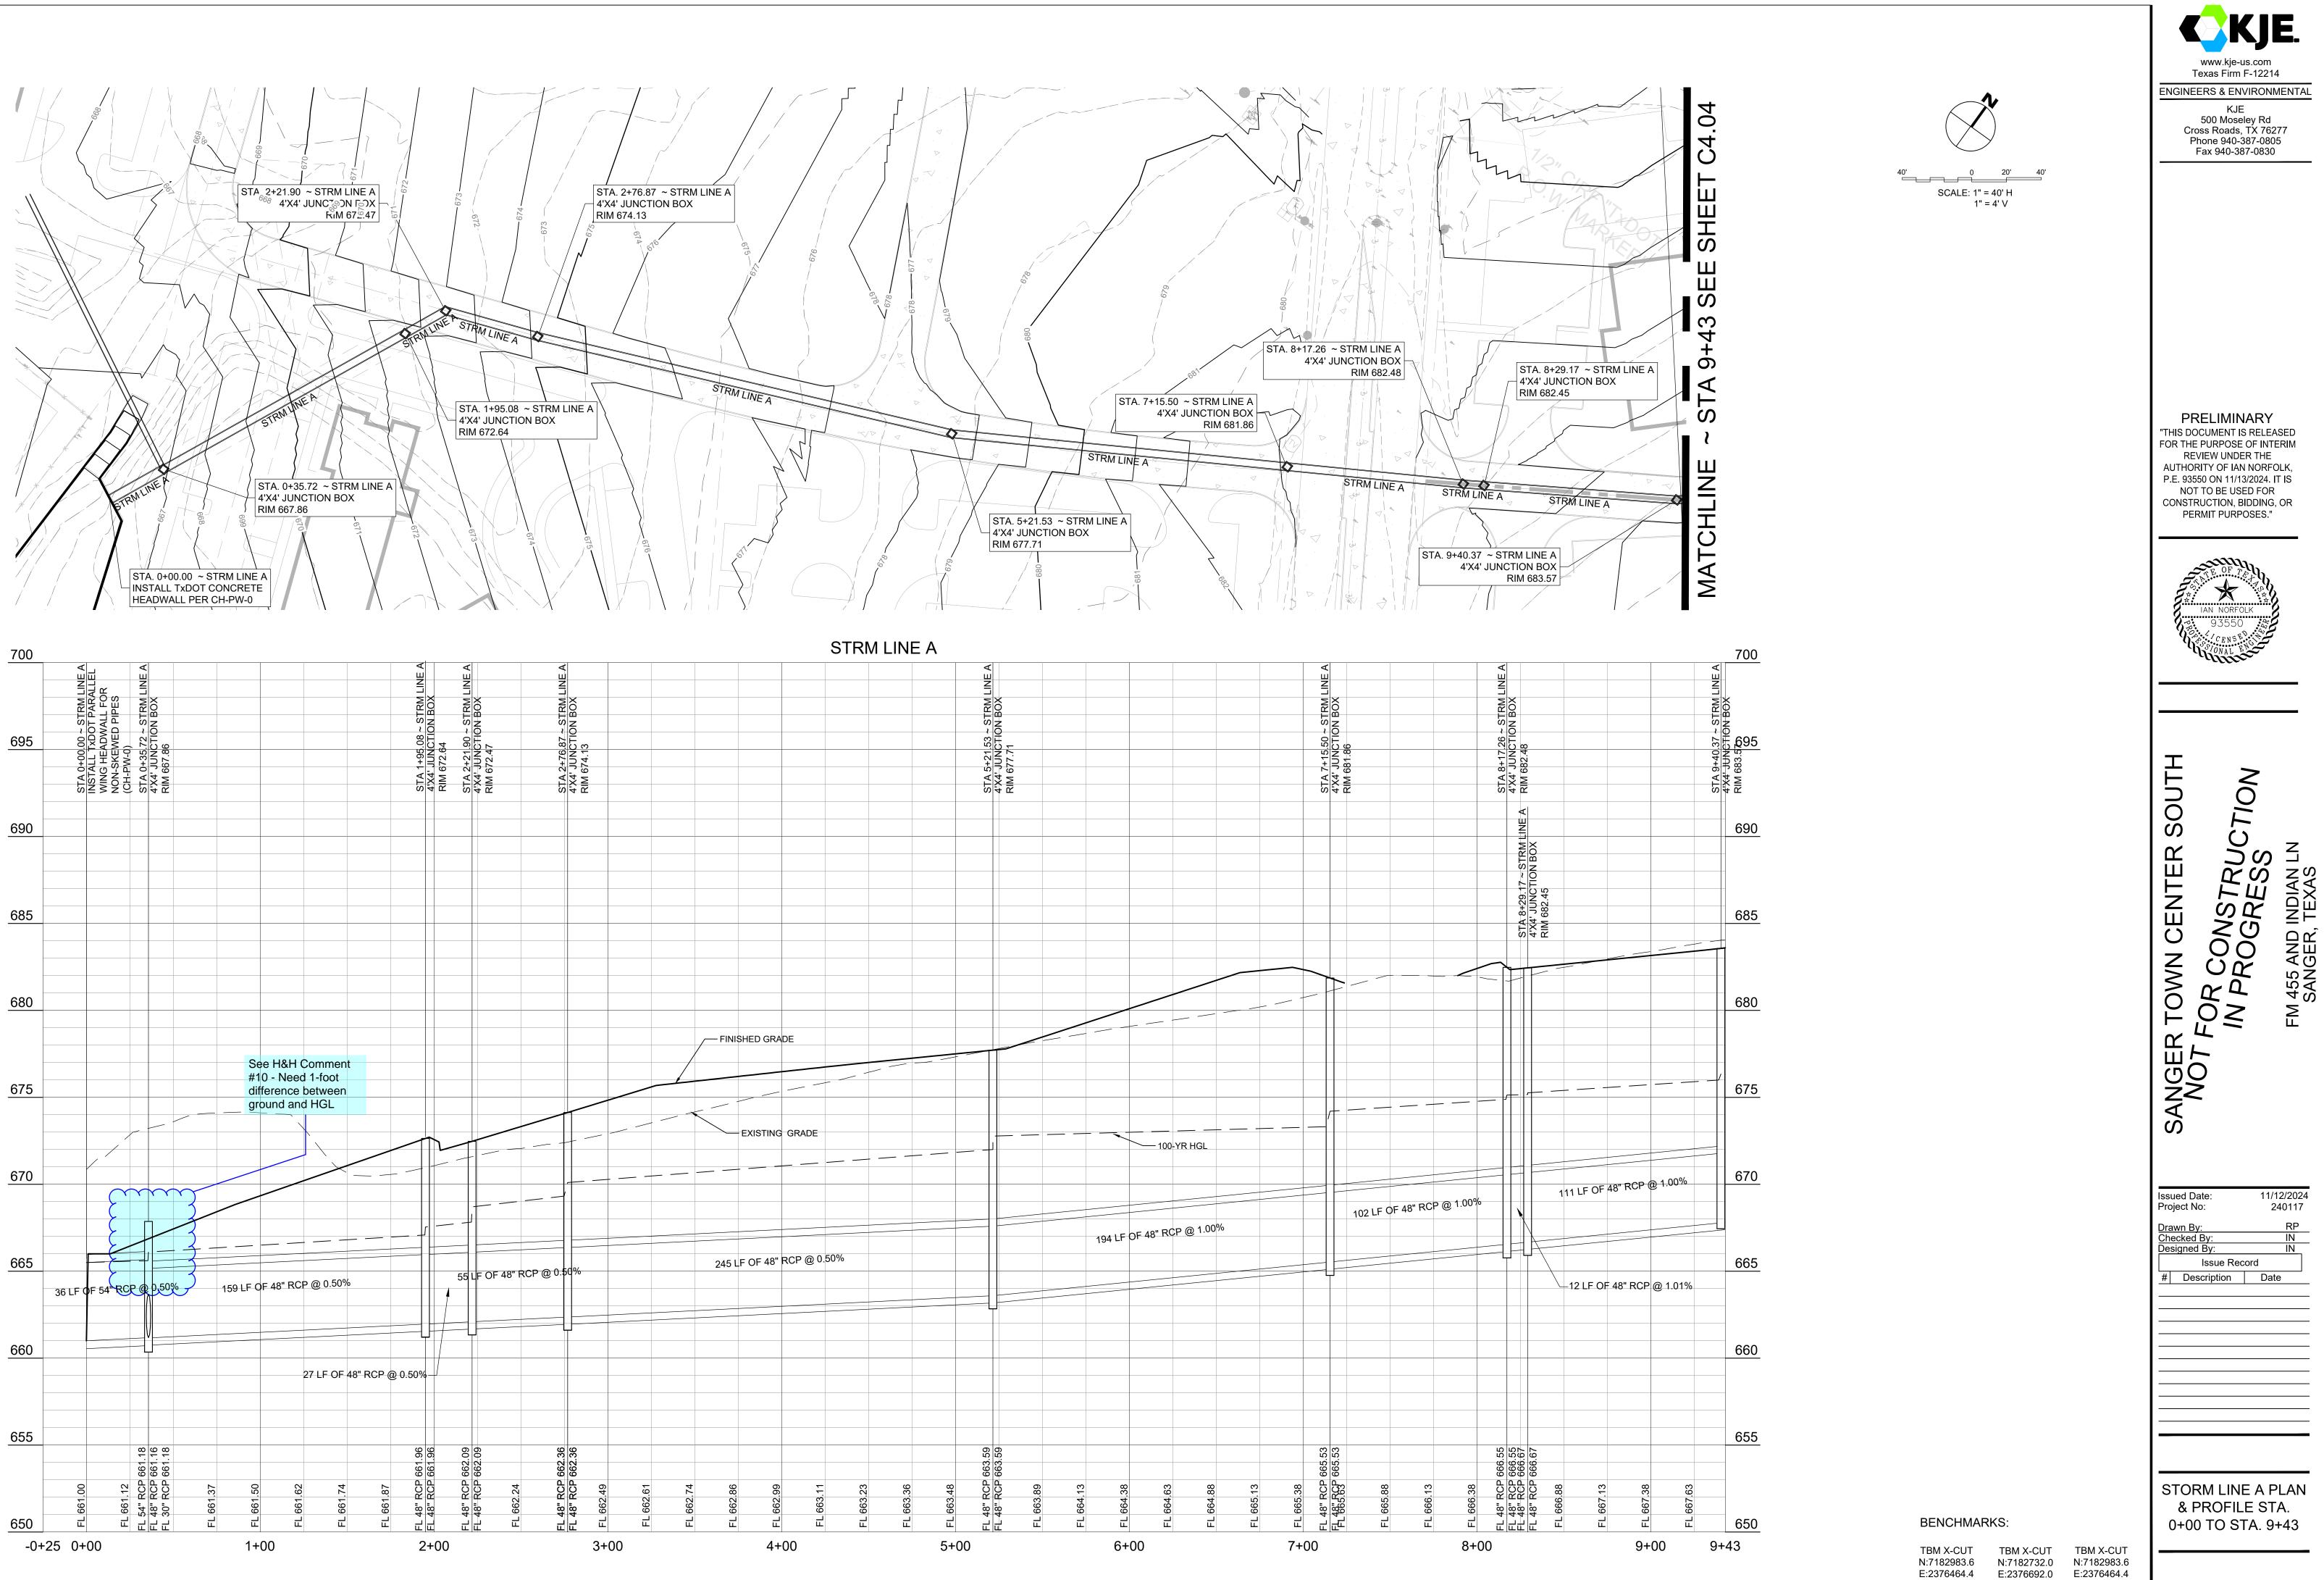


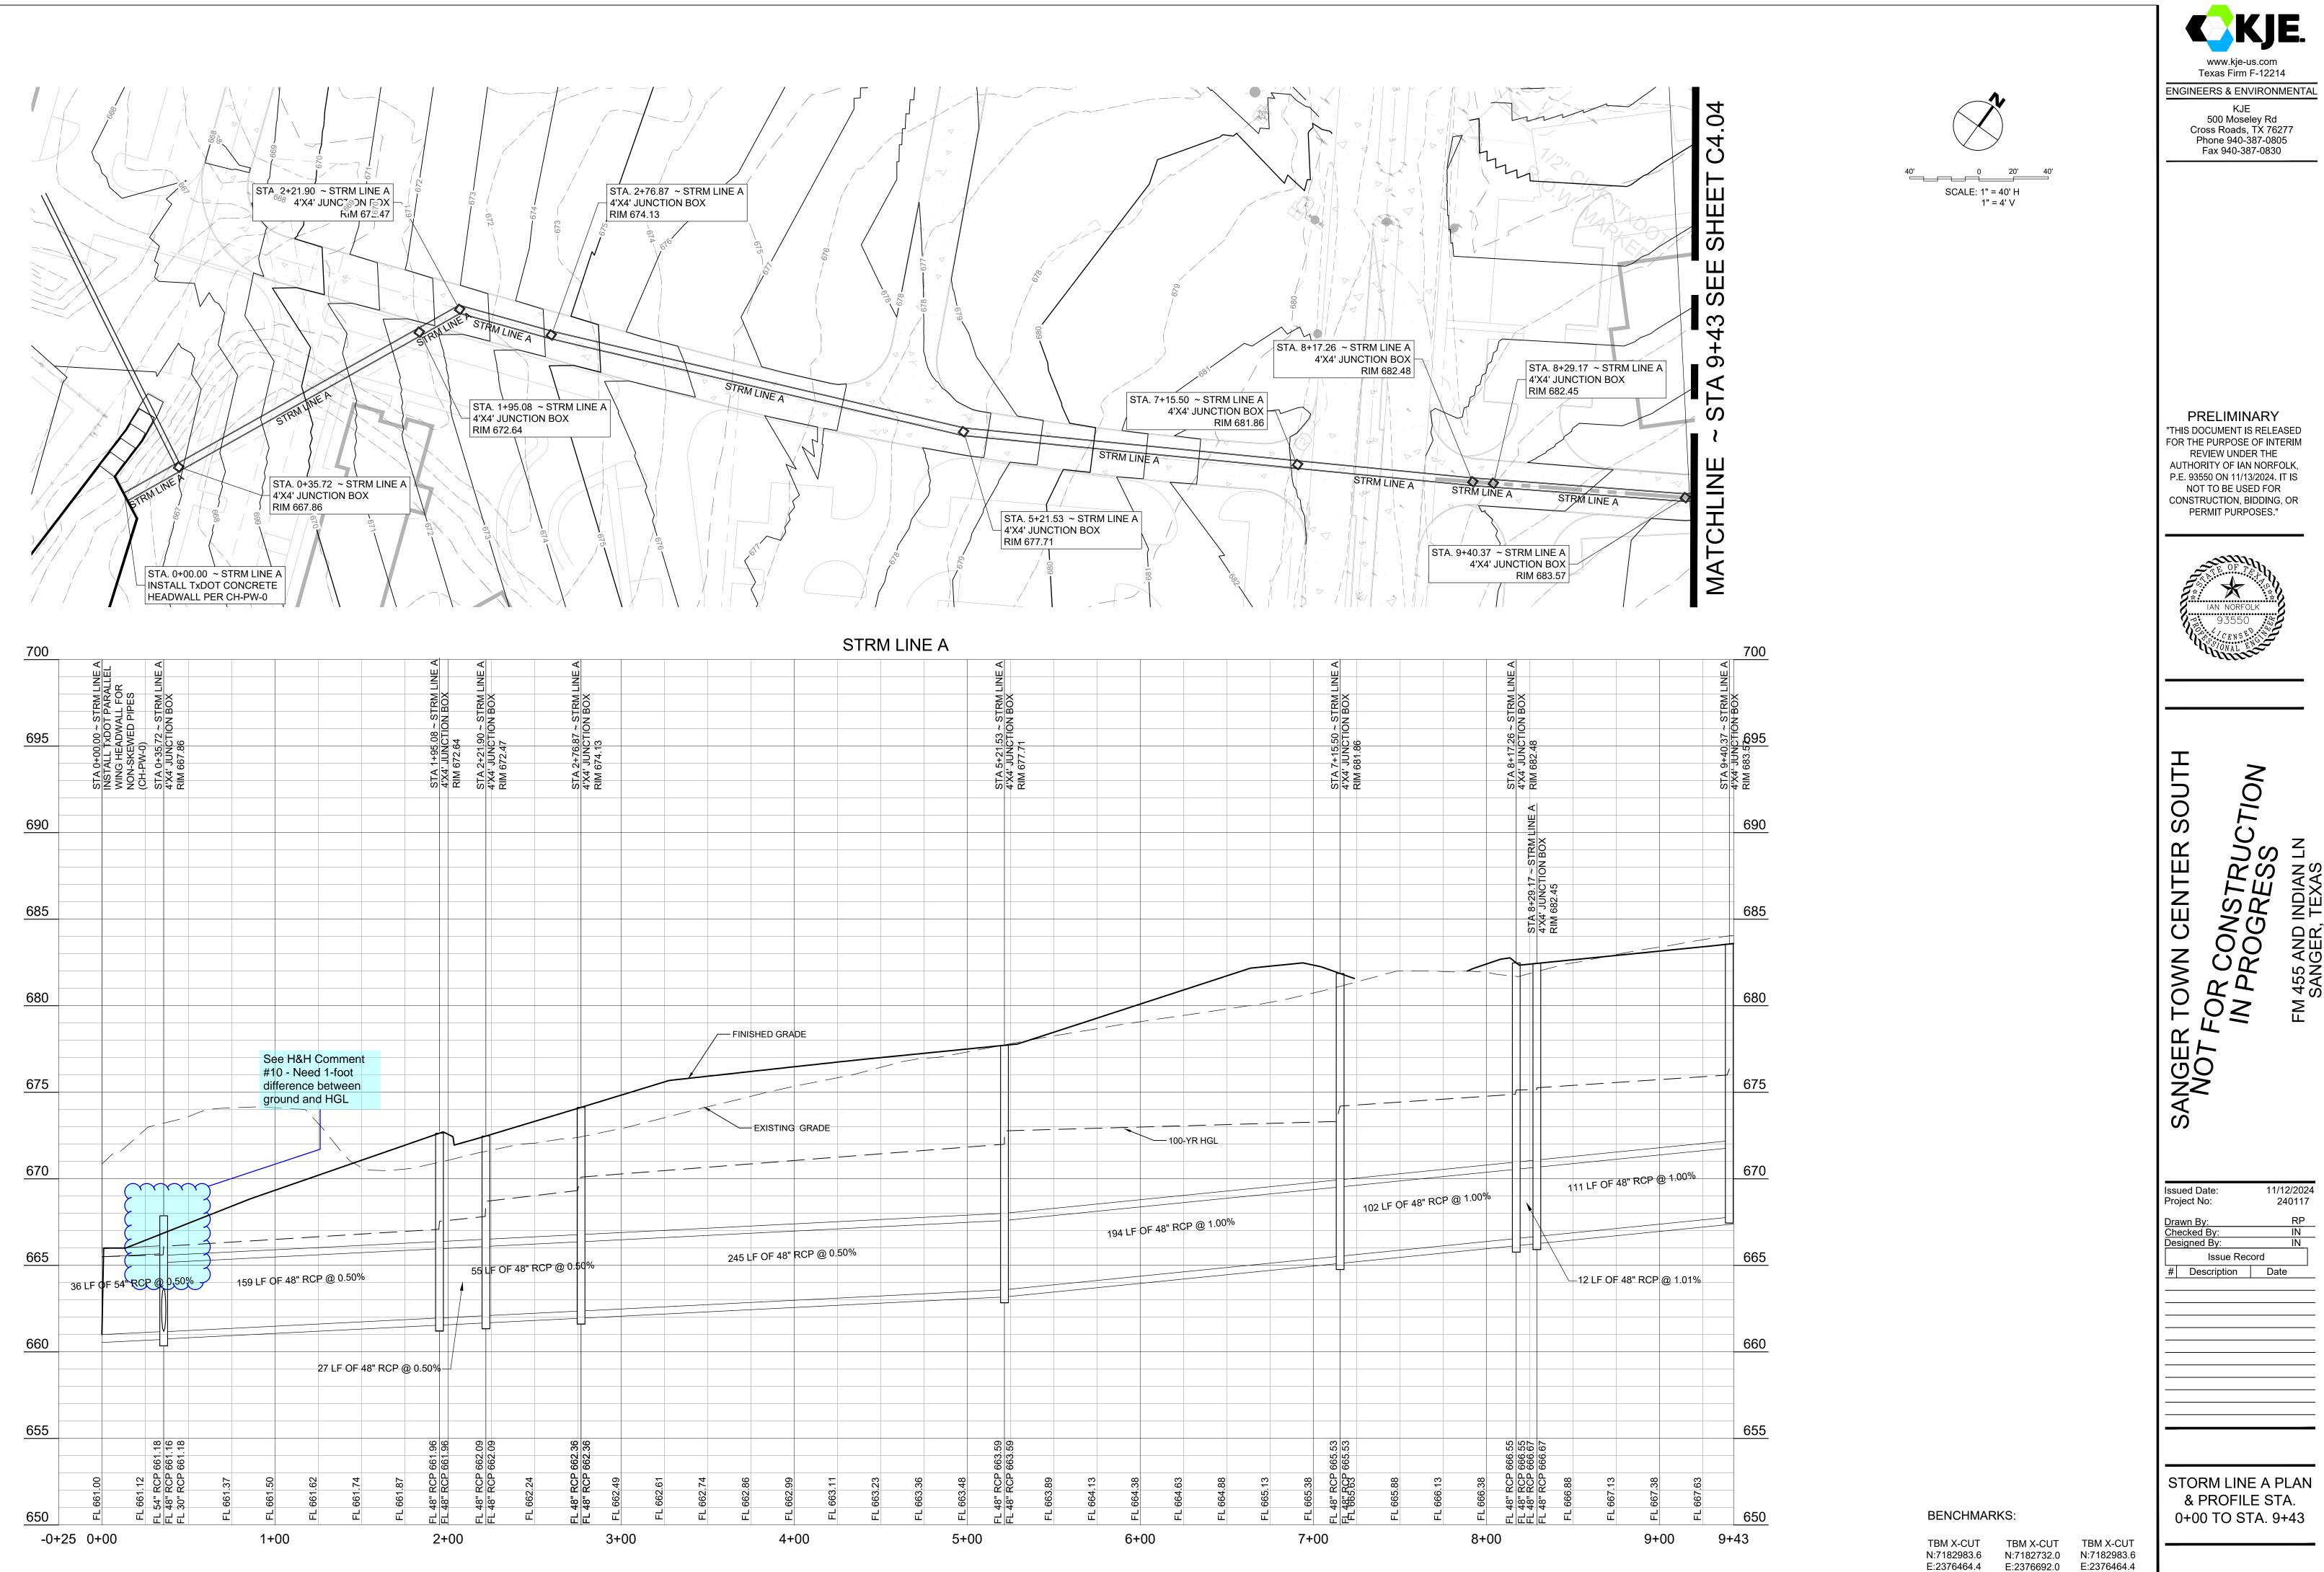


PLOTTED BY: MARIA PAZ DATE: 11/13/2024 2:57 PM DWG NAME: P:\2024\240117 SABLE CROSSING - SANGER TOWN CENTER SOUTH\CAD\CIVIL\02\_BASEFILES\240117-DAM.DWG LAST SAVED BY: DUELCHAVEZ DATE: 11/13/2024 2:49 PM

ELEV:682.2' ELEV:683.2' ELEV:682.2'

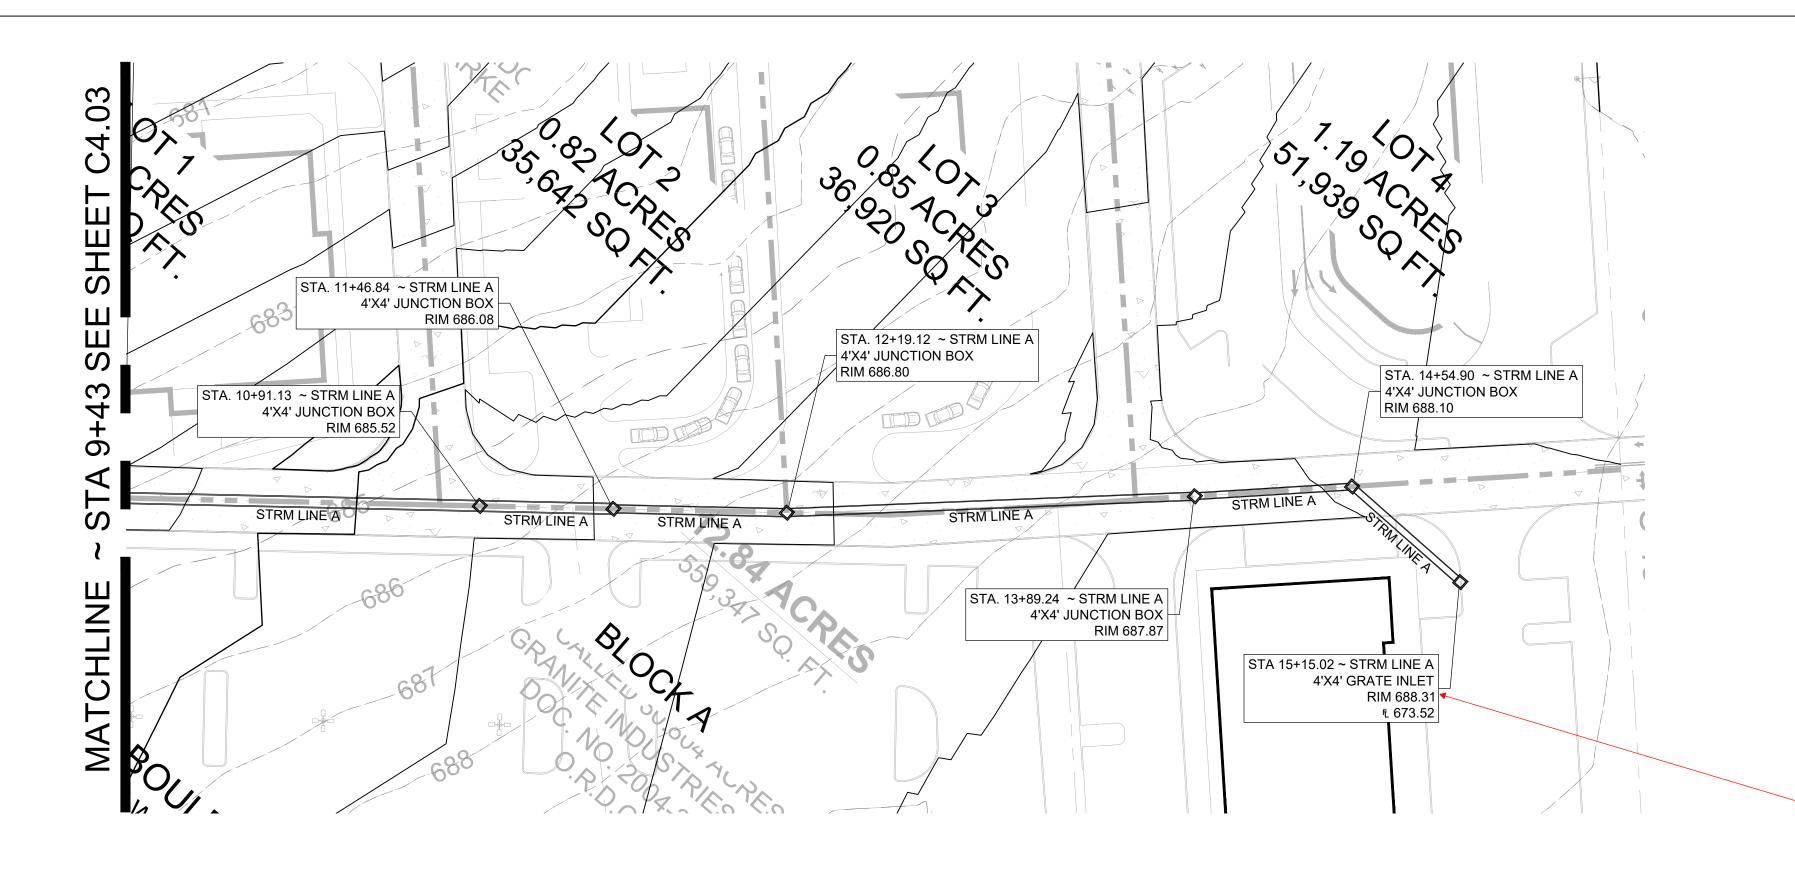

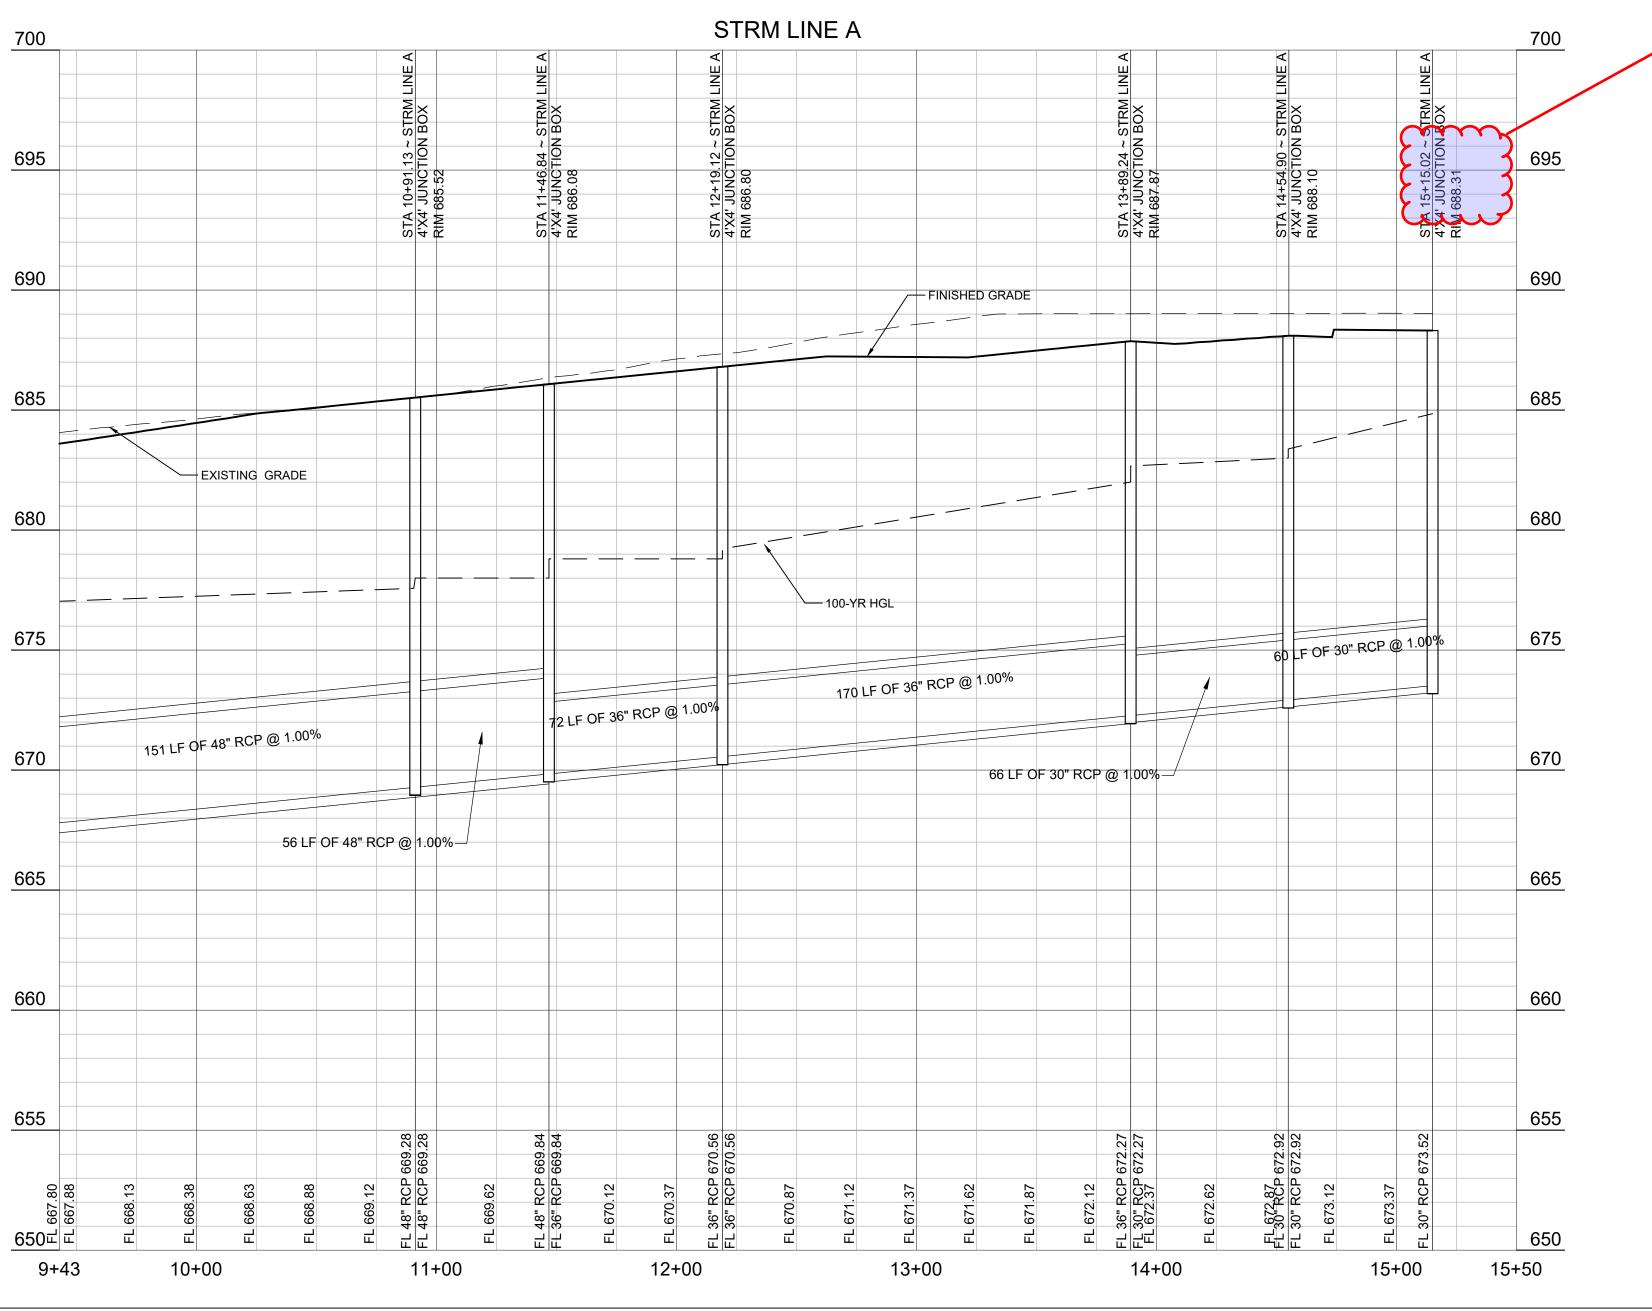


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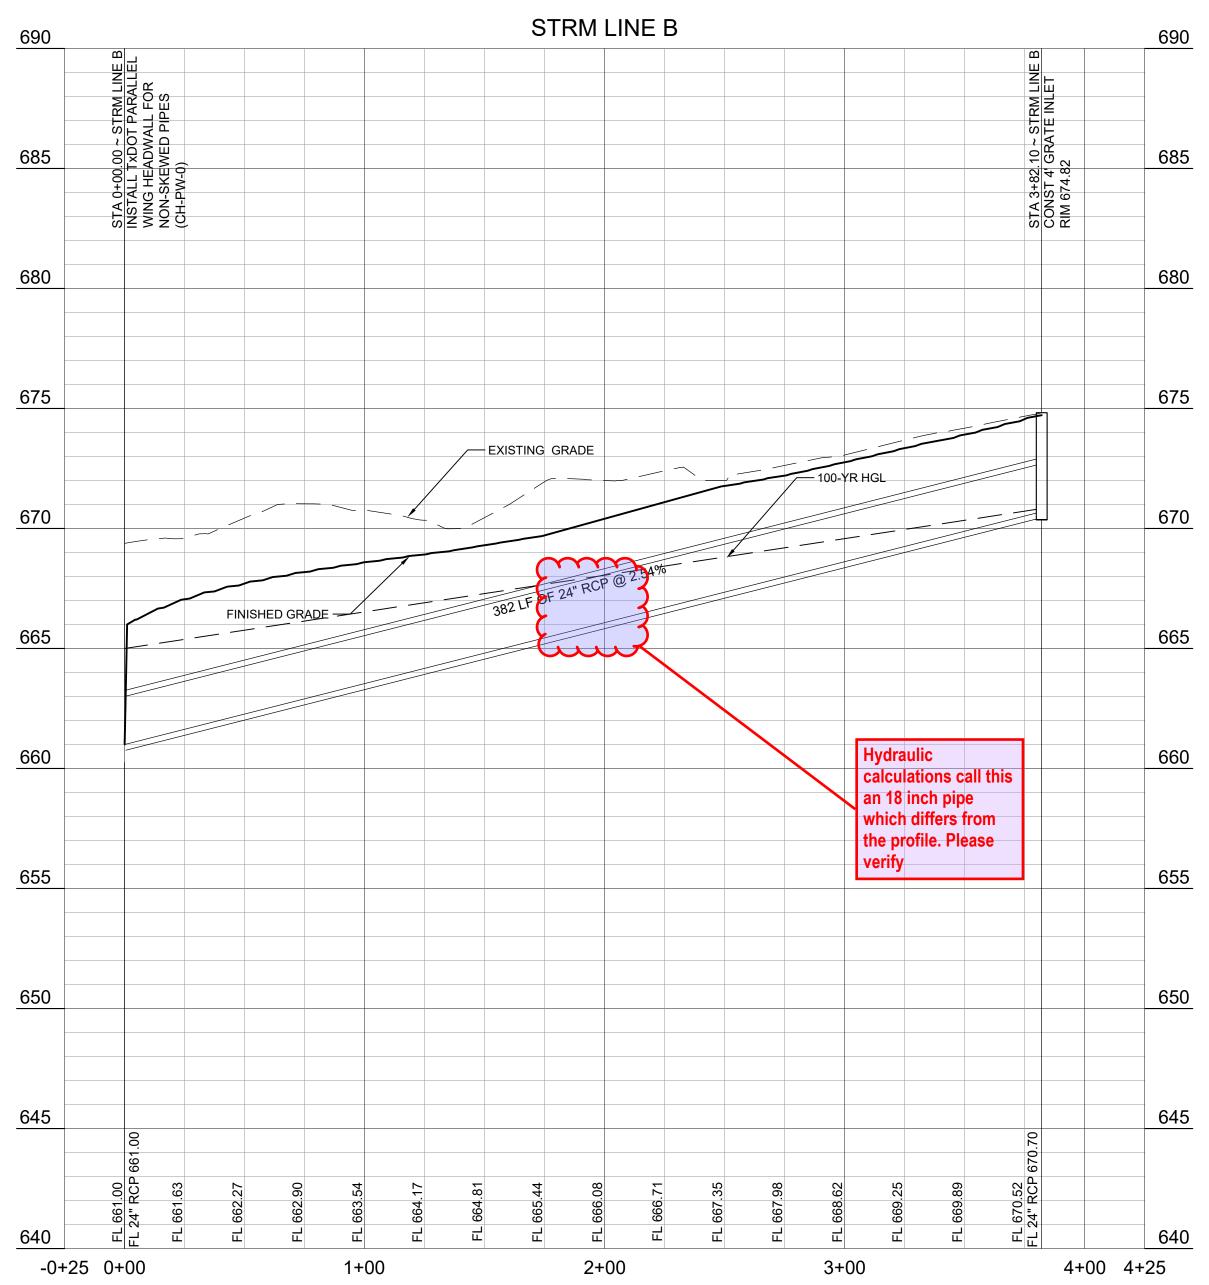


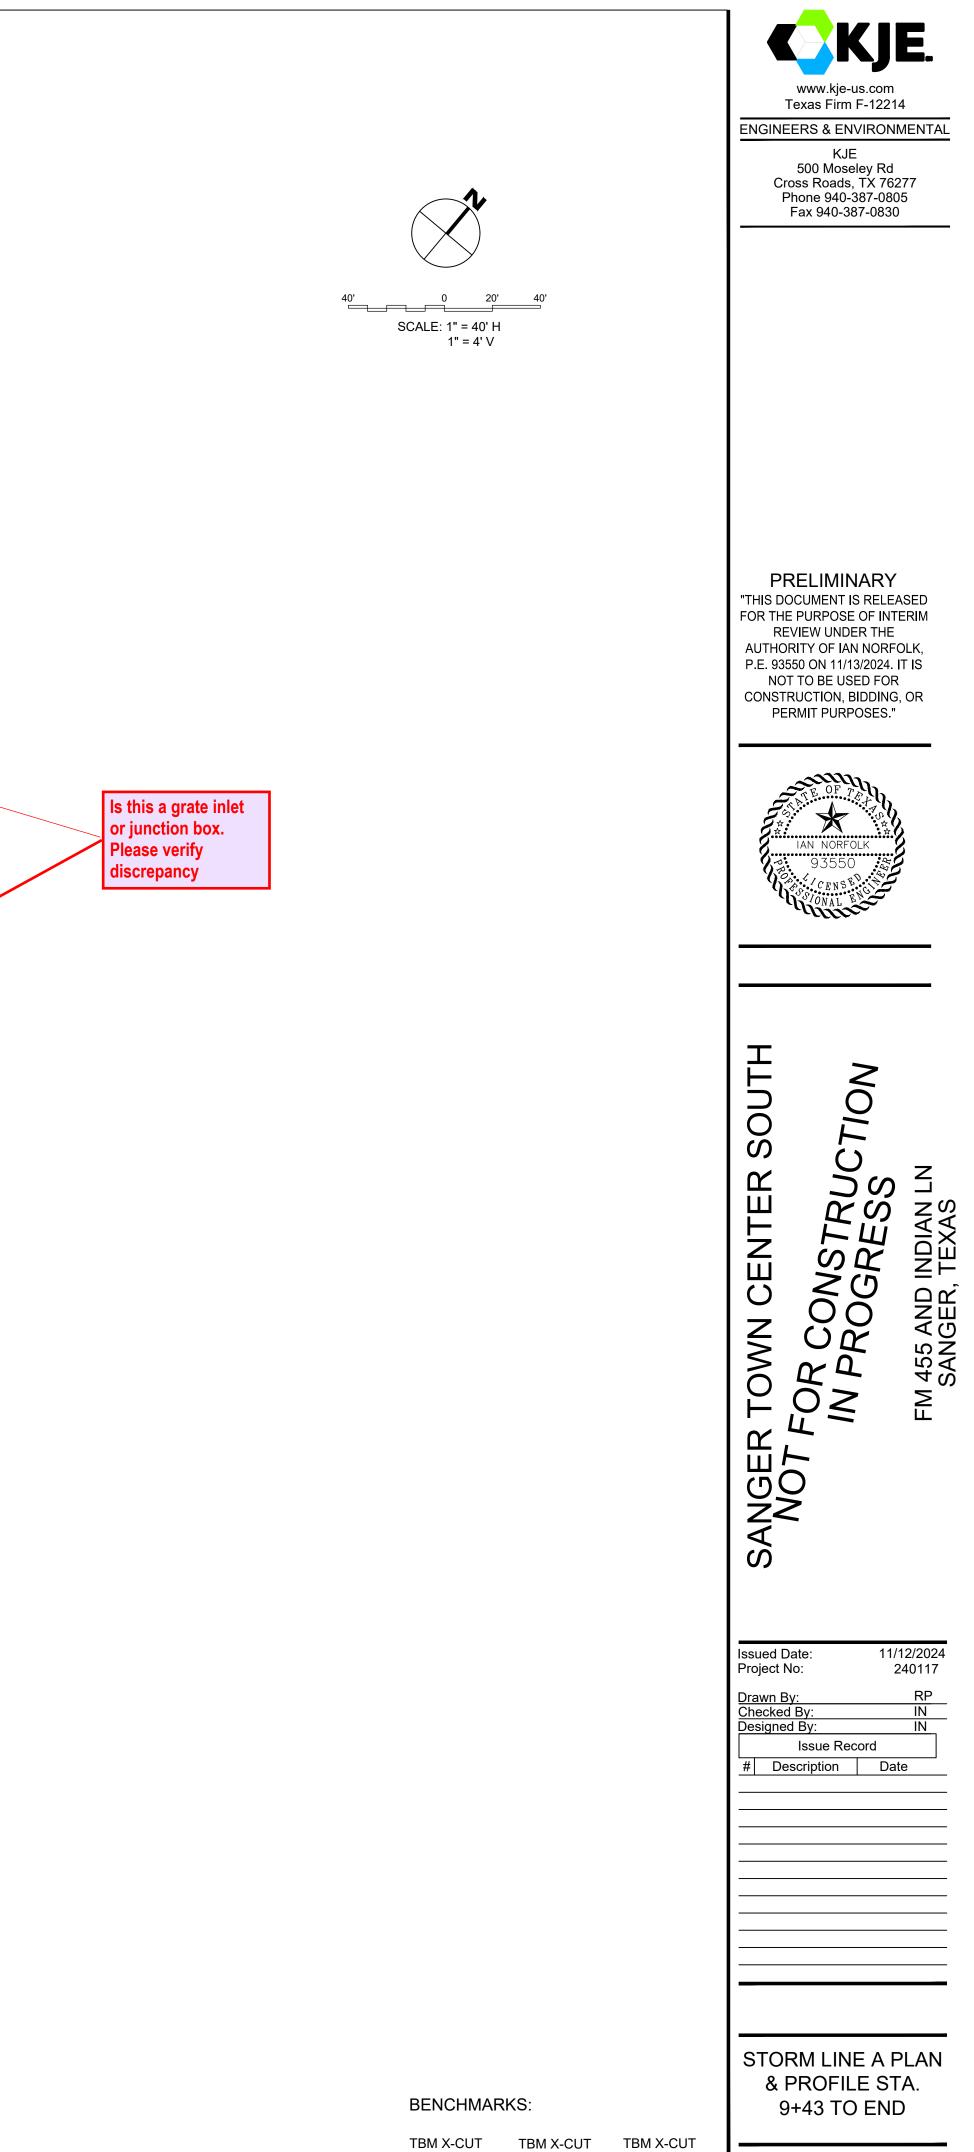N:7182732.0 N:7182983.6 E:2376464.4 E:2376692.0 E:2376464.4

N:7182983.6

ELEV:682.2' ELEV:683.2' ELEV:682.2'



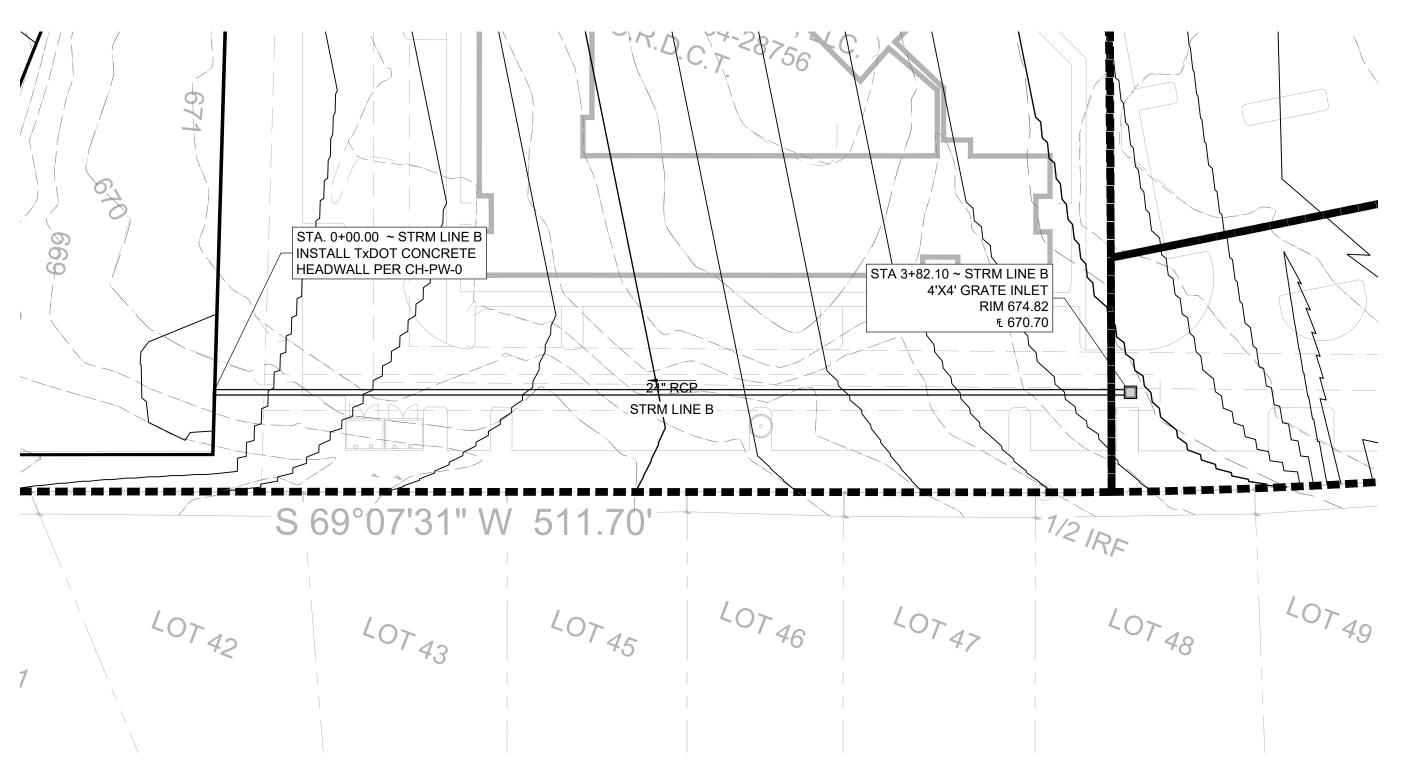

PLOTTED BY: MARIA PAZ DATE: 11/13/2024 2:58 PM DWG NAME: P:\2024\240117 SABLE CROSSING - SANGER TOWN CENTER SOUTH\CAD\CIVIL\02\_BASEFILES\240117-DAM.DWG LAST SAVED BY: DUELCHAVEZ DATE: 11/13/2024 2:49 PM



KJE 500 Moseley Rd Cross Roads, TX 76277 Phone 940-387-0805 Fax 940-387-0830


PRELIMINARY "THIS DOCUMENT IS RELEASED FOR THE PURPOSE OF INTERIM REVIEW UNDER THE AUTHORITY OF IAN NORFOLK, P.E. 93550 ON 11/13/2024. IT IS NOT TO BE USED FOR CONSTRUCTION, BIDDING, OR PERMIT PURPOSES."





Drawn By: Checked By Designed By Issue Record # Description Date


STORM LINE B PLAN & PROFILE STA. 0+00 TO STA. 3+82

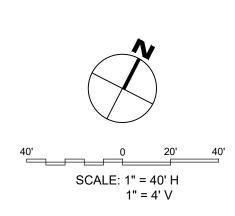


**BENCHMARKS**:

TBM X-CUT TBM X-CUT TBM X-CUT

N:7182983.6 N:7182732.0 N:7182983.6 E:2376464.4 E:2376692.0 E:2376464.4 ELEV:682.2' ELEV:683.2' ELEV:682.2'

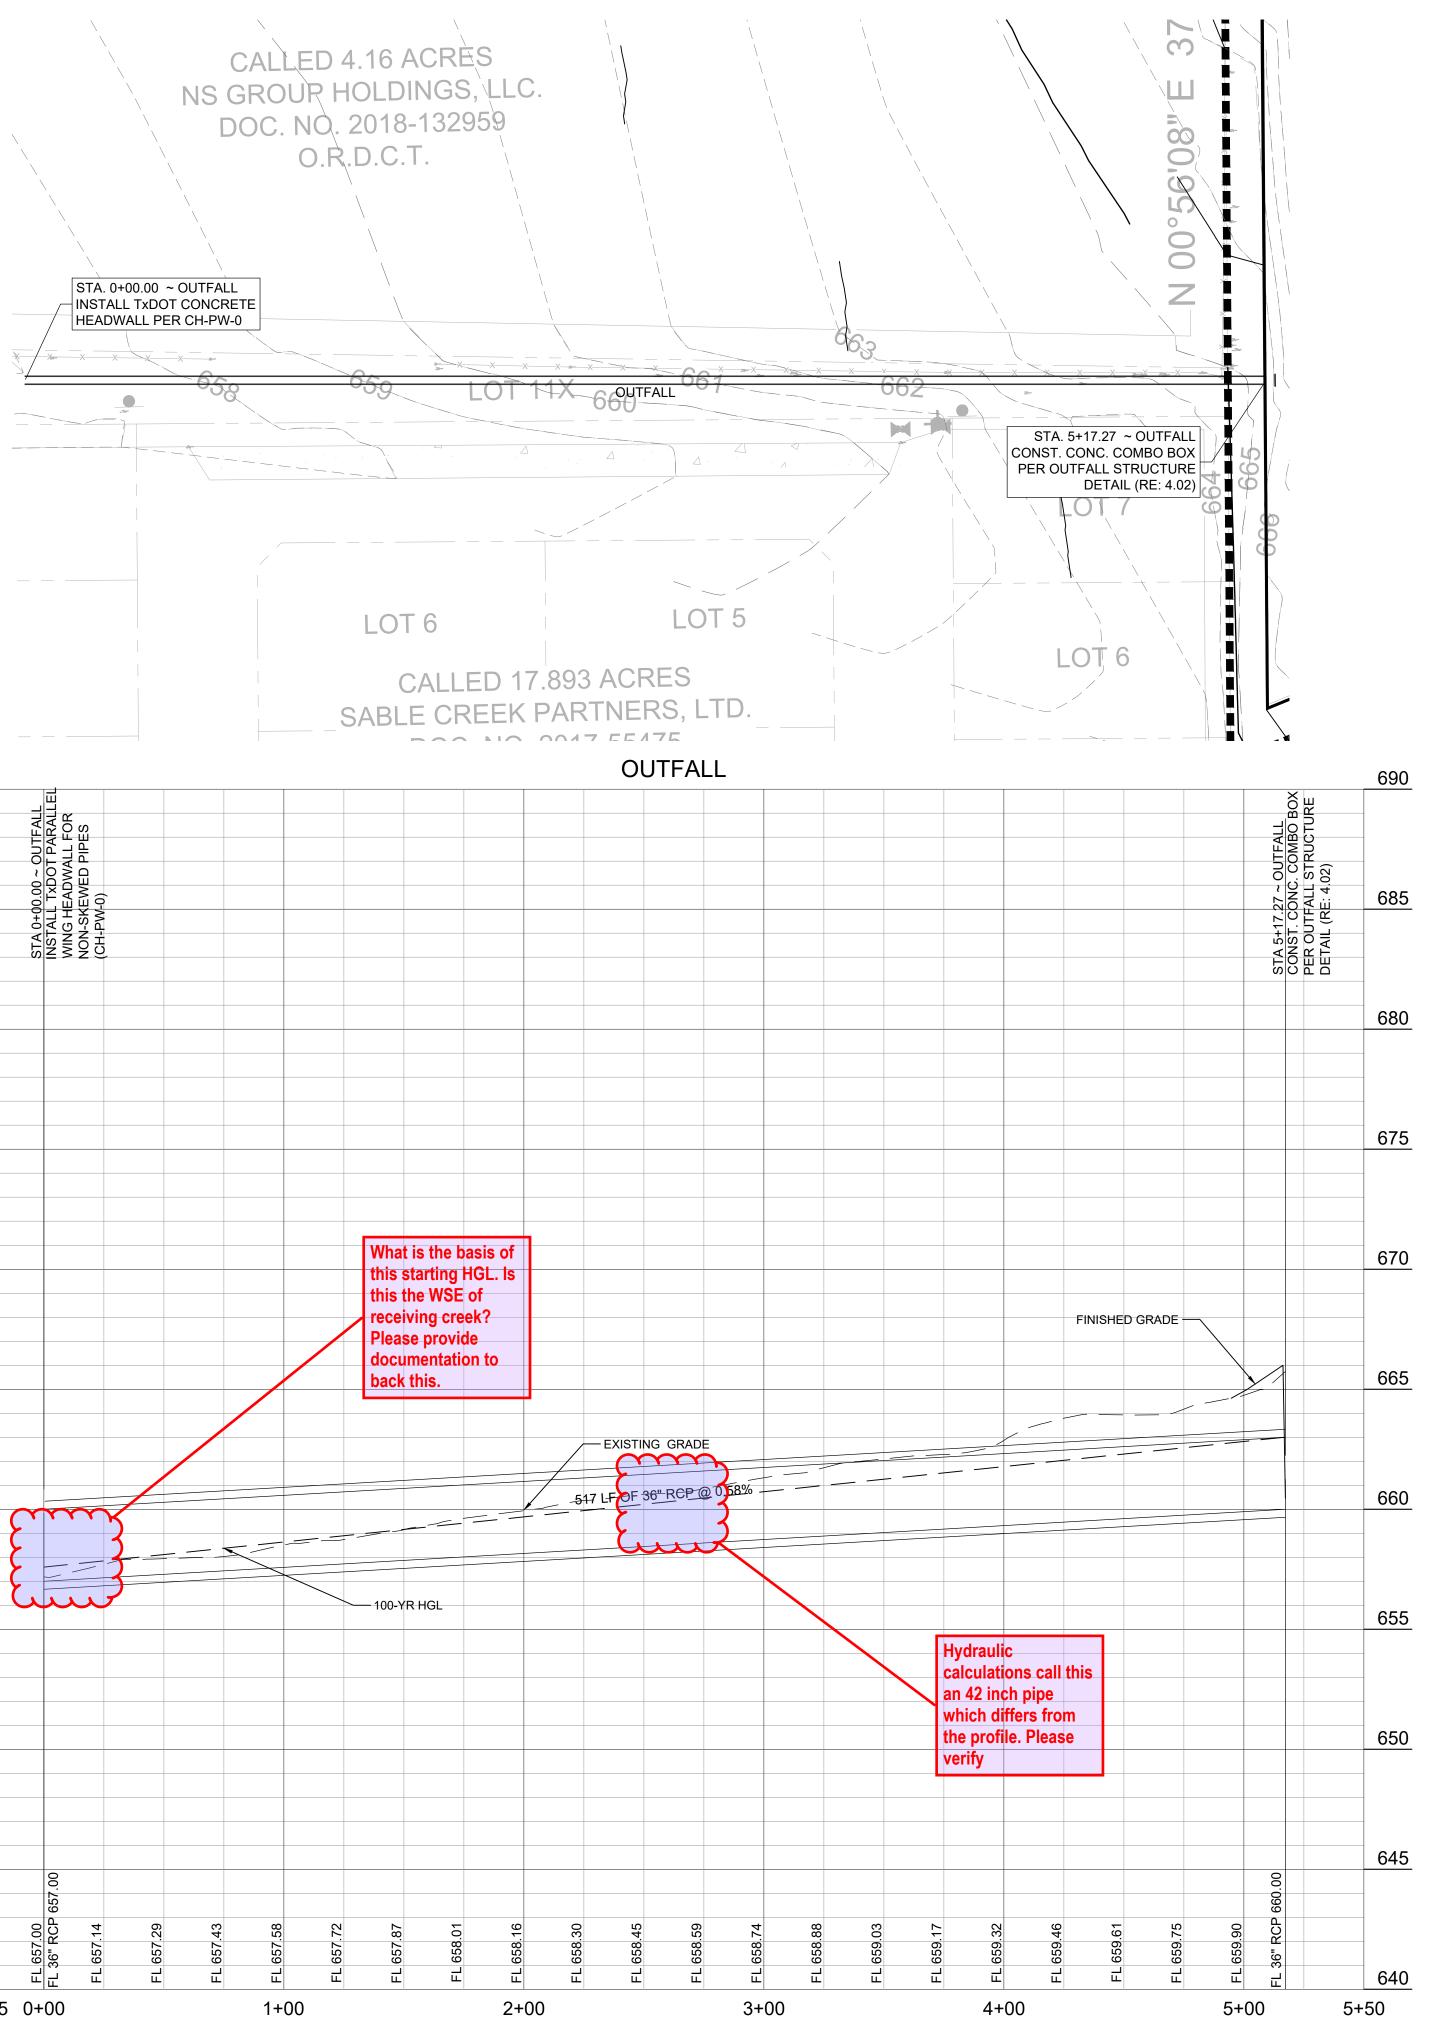

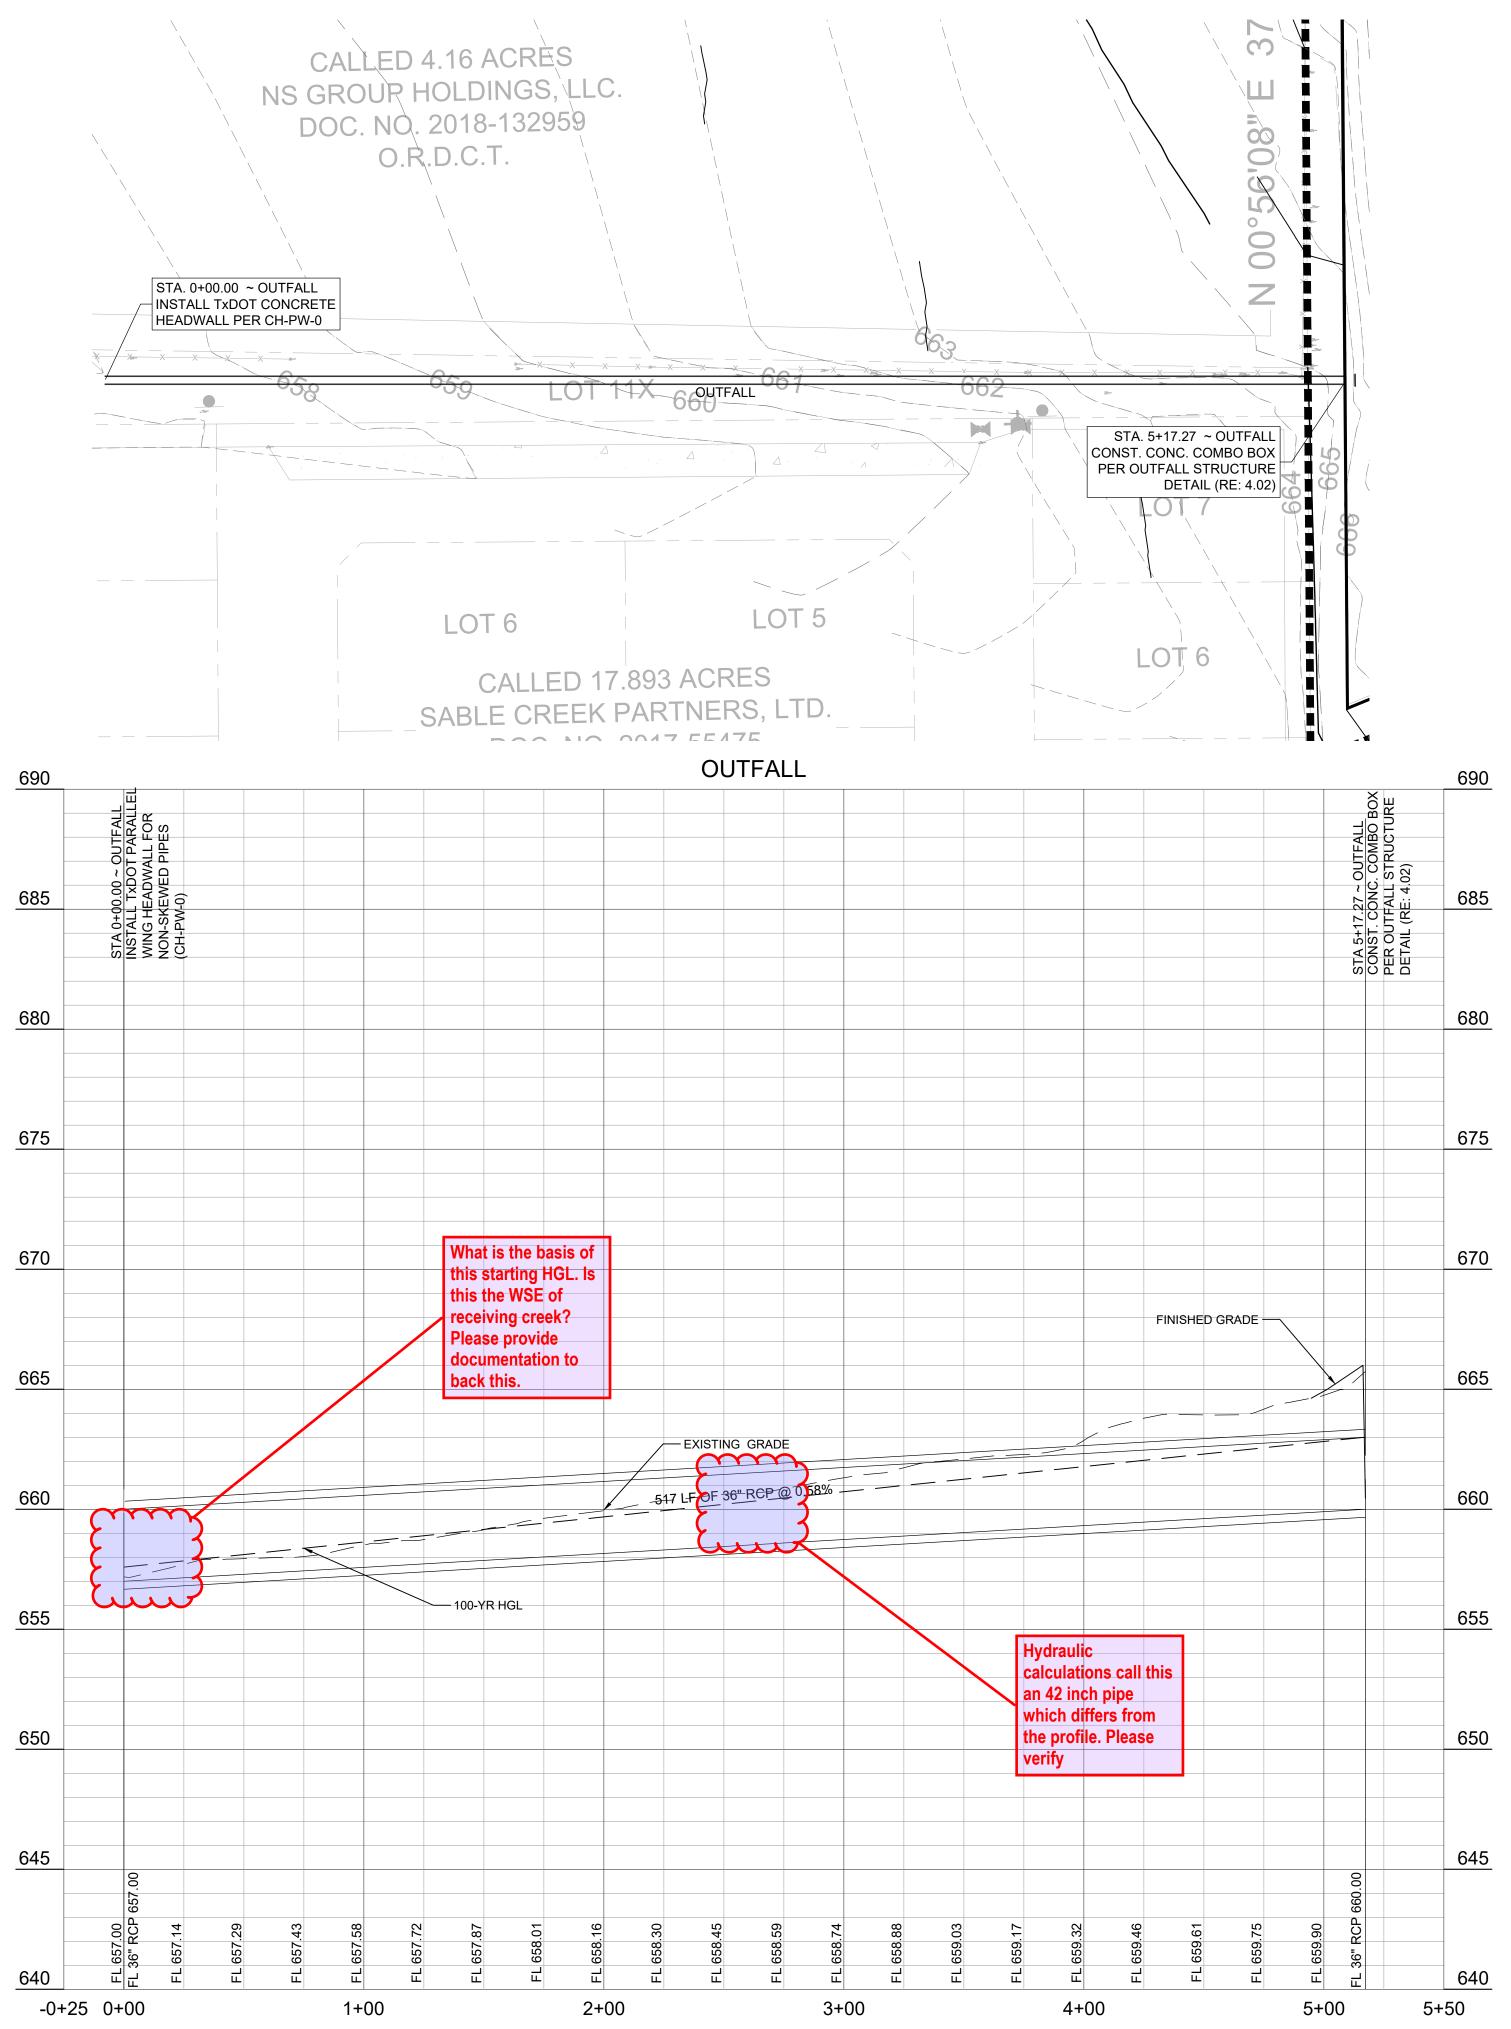

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40' 0 20' 40' SCALE: 1" = 40' H 1" = 4' V

PRELIMINARY "THIS DOCUMENT IS RELEASED FOR THE PURPOSE OF INTERIM REVIEW UNDER THE AUTHORITY OF IAN NORFOLK, P.E. 93550 ON 11/13/2024. IT IS NOT TO BE USED FOR CONSTRUCTION, BIDDING, OR PERMIT PURPOSES."






rav	vn By:		RP
he	cked By:		IN
esi	gned By:		IN
	Issue Rec	ord	
ŧ	Description	Date	

OUTFALL PLAN & PROFILE 0+00 to END

**BENCHMARKS**:

TBM X-CUT TBM X-CUT TBM X-CUT

N:7182983.6 N:7182732.0 N:7182983.6 E:2376464.4 E:2376692.0 E:2376464.4 ELEV:682.2' ELEV:683.2' ELEV:682.2'

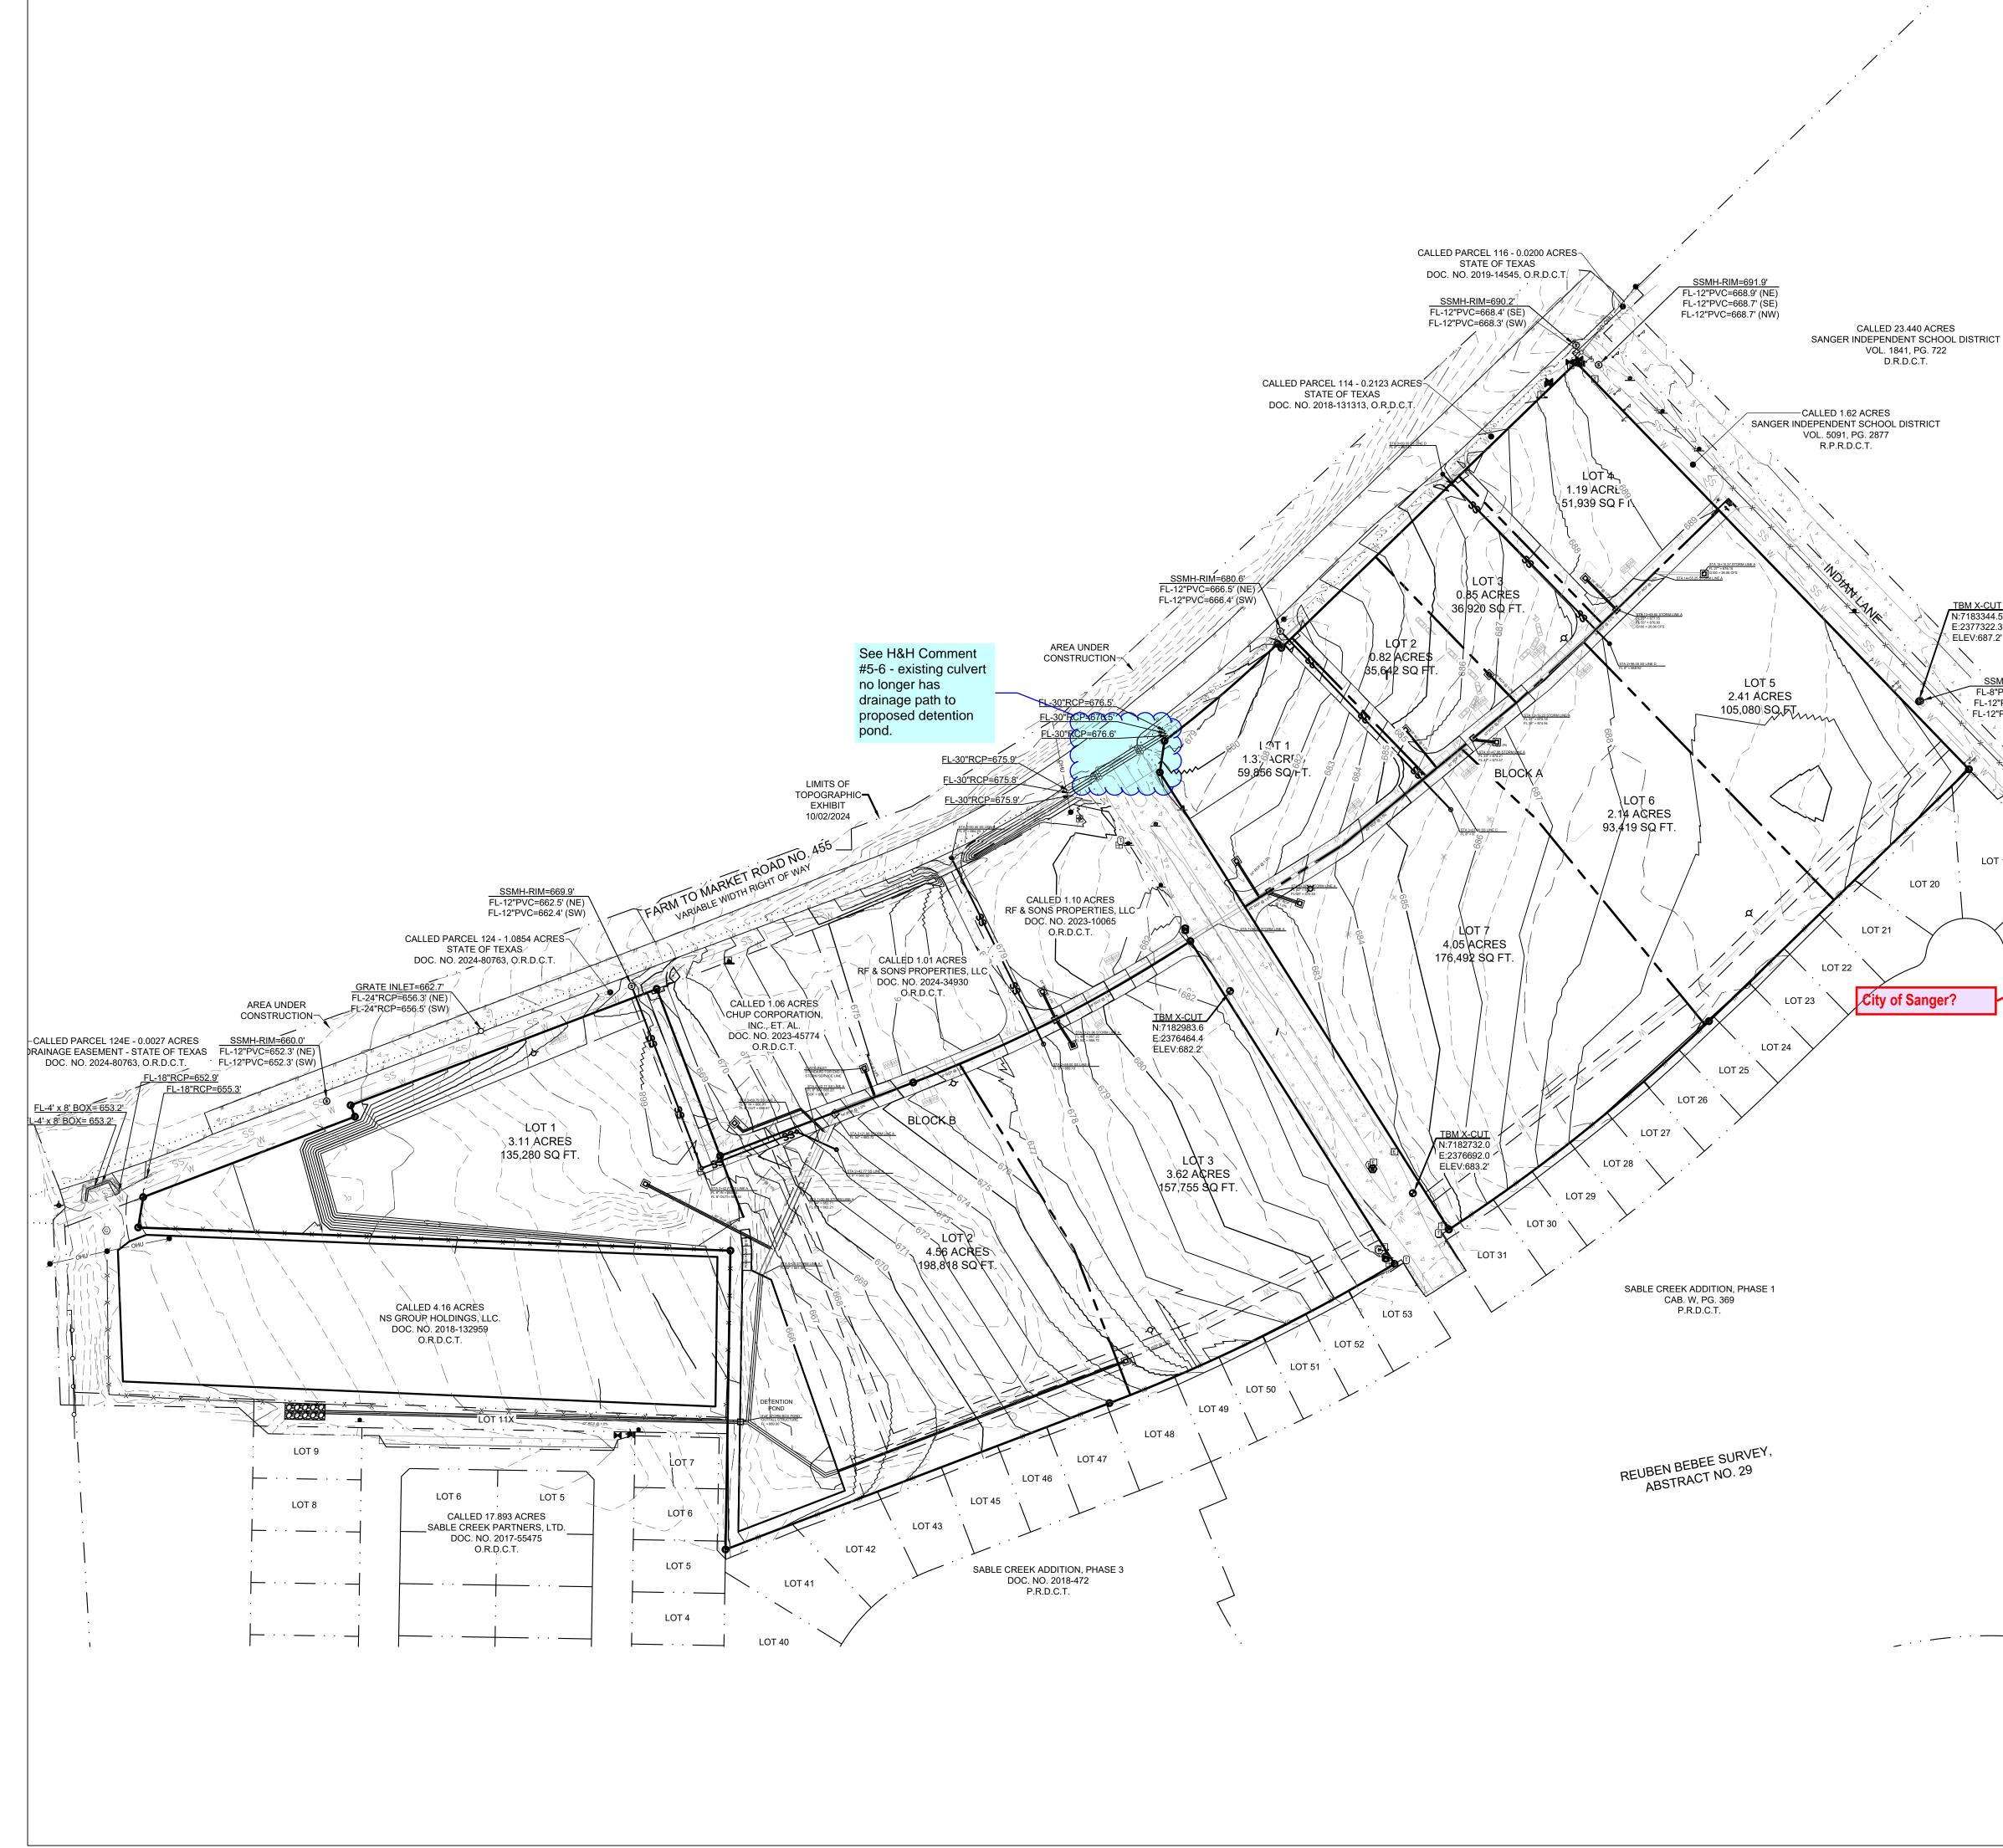

PLOTTED BY: MARIA PAZ DATE: 11/13/2024 2:58 PM DWG NAME: P:/2024/240117 SABLE CROSSING - SANGER TOWN CENTER SOUTH/CAD/CIVIL/04\_SHEETS/C5.00-UTIL-SEWER.DWG LAST SAVED BY: MARIAPAZ DATE: 11/13/2024 2:10 PM

SCALE: 1" = 100'

LEGEND - UTILITY	PLAN
	SITE BOUNDARY
	- PROPOSED EASEMENT
	— — BUILDING SETBACK
	PROPOSED WATER LINE
- <b>-</b>	PROPOSED FIRE HYDRANT
Ť	PROPOSED VALVE
WM	PROPOSED WATER METER
0	PROPOSED SANITARY SEWER MANHOLE
0	PROPOSED CLEANOUT

### SITE UTILITY NOTES

TBM X-CUT

N:7183344.5

E:2377322.3

ELEV:687.2

SSMH-RIM=68

FL-12"PVC=671.9' (SE)

FL-12"PVC=671.8' (NW)

LOT 19

LOT 18

FL-8"PVC=671.9' (NE)

- THE CONTRACTOR SHALL BE RESPONSIBLE FOR LOCATING ALL UTILITIES, WHETHER PRIVATE OR PUBLIC, PRIOR TO EXCAVATING. THE INFORMATION AND DATA SHOWN WITH RESPECT TO EXISTING UNDERGROUND FACILITIES AT OR CONTIGUOUS TO THE SITE IS APPROXIMATE AND BASED ON THE INFORMATION AND DATA FURNISHED BY THE OWNERS OF SUCH UNDERGROUND FACILITIES OR ON PHYSICAL APPEARANCES OBSERVED IN THE FIELD. THE OWNER AND ENGINEER SHALL NOT BE RESPONSIBLE FOR THE ACCURACY OR COMPLETENESS OF ANY SUCH INFORMATION OR DATA; AND THE CONTRACTOR SHALL HAVE FULL RESPONSIBILITY FOR REVIEWING AND CHECKING ALL SUCH INFORMATION AND DATA, FOR LOCATING ALL UNDERGROUND FACILITIES, FOR COORDINATION OF THE WORK WITH THE OWNERS OF SUCH UNDERGROUND FACILITIES DURING CONSTRUCTION, FOR THE SAFETY AND PROTECTION THEREOF, AND REPAIRING ANY DAMAGE THERETO RESULTING FROM THE WORK, THE COST OF ALL OF WHICH WILL BE CONSIDERED AS HAVING BEEN INCLUDED IN THE CONTRACT PRICE. CONTRACTOR SHALL VERIFY LOCATION AND ELEVATIONS OF EXISTING UTILITIES PRIOR TO CONSTRUCTION AND IS RESPONSIBLE FOR COSTS INCURRED BY PROCEEDING WITH ELEVATIONS OF EXISTING UTILITIES THAT DIFFER FROM THOSE PRESENTED ON THESE PLANS. DISCREPANCIES SHALL BE PRESENTED TO THE ENGINEER FOR REVIEW PRIOR TO PROCEEDING WITH WORK. CONTRACTOR SHALL NOTIFY ANY AFFECTED UTILITY COMPANIES, AGENCIES AND ENGINEER AT LEAST 48 HOURS PRIOR TO BEGINNING CONSTRUCTION.
- ALL UTILITIES SHALL BE CONSTRUCTED IN ACCORDANCE WITH THE CITY OF \_ PUBLIC WORKS SPECIFICATIONS.
- THE SITE UTILITY CONTRACTOR SHALL PROVIDE ALL THE MATERIALS AND APPURTENANCES NECESSARY FOR THE COMPLETE INSTALLATION OF THE UTILITIES. ALL PIPE AND FITTINGS SHALL BE INSPECTED BY THE CITY INSPECTOR PRIOR TO BEING COVERED.
- ALL WORK SHALL COMPLY WITH ALL APPLICABLE CODES, REGULATIONS, AND/OR MOVALYSTANDARDS AND REQUIREMENTS.
- THE SITE UTILITY CONTRACTOR SHALL MAKE ARRANGEMENTS WITH THE CITY OF CAINESVILLE FOR THE CONNECTIONS TO THE EXISTING WATER AND WASTEWATER MAINS
- THE CONTRACTOR SHALL ADJUST THE LOCATION OF THE PROPOSED WATER LINES AS REQUIRED TO AVOID CONFLICTS WITH THE OTHER UTILITIES.
- THRUST BLOCKS SHALL BE PROVIDED AT ALL TEES, ELBOWS AND BENDS, AND WILL BE OF SUFFICIENT SIZE TO COMPLY WITH CITY STANDARDS FOR EXISTING SOIL CONDITIONS.
- ALL FIRE PROTECTION MATERIALS SHALL BE U.L. LISTED, FACTORY MUTUAL 8. APPROVED, AND TO NFPA STANDARDS, UNLESS OTHERWISE DIRECTED BY THE ENGINEER.
- MATCH TOPS OF ALL MANHOLES AND VAULTS WITH PROPOSED GROUND 9. ELEVATIONS.
- 10. ALL FILL MATERIAL IS TO BE IN PLACE AND COMPACTED BEFORE INSTALLATION OF PROPOSED UTILITIES.
- 11. WATER & SANITARY SEWER UTILITIES SHALL BE KEPT TEN FEET (10') APART (PARALLEL) OR, WHEN CROSSING PROVIDE 24" VERTICAL CLEARANCE (OUTSIDE EDGE OF PIPE TO OUTSIDE EDGE OF PIPE, UNLESS OTHERWISE NOTED.)
- 12. UNDERGROUND LINES SHALL BE INSTALLED, INSPECTED AND APPROVED **BEFORE BACKFILLING.**
- 13. TOPS OF EXISTING MANHOLES SHALL BE RAISED AS NECESSARY TO BE FLUSH WITH PROPOSED PAVEMENT ELEVATIONS, AND ARE TO BE ONE FOOT ABOVE FINISHED GROUND ELEVATIONS WITH WATER TIGHT LIDS.
- 14. ALL CONCRETE FOR ENCASEMENT SHALL HAVE A MINIMUM 28-DAY COMPRESSION STRENGTH OF 3000 P.S.I.
- 15. CONTRACTOR SHALL MAINTAIN A MINIMUM OF 48" COVER BELOW FINISHED GRADE TO TOP OF ALL WATERLINES.
- 16. ALL NECESSARY INSPECTIONS AND/OR CERTIFICATIONS REQUIRED BY CODES AND/OR UTILITY SERVICE COMPANIES SHALL BE IN POSSESSION BEFORE THE FINAL CONNECTION OF SERVICE.
- 17. CONTRACTOR SHALL COORDINATE WITH ALL UTILITY COMPANIES FOR INSTALLATION REQUIREMENTS AND SPECIFICATIONS.
- 18. ACTUAL ROUTING OF ELECTRICAL SERVICE FROM THE EXISTING TRANSFORMER IS TO BE COORDINATED WITH THE ELECTRICAL UTILITY.
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- 21. IN THE EVENT OF VERTICAL CONFLICT BETWEEN WATERLINES, SANITARY LINES, STORM LINES AND GAS LINES (EXISTING AND PROPOSED), THE SANITARY LINE SHALL BE DUCTILE IRON PIPE WITH MECHANICAL JOINTS AT LEAST 10 FEET ON BOTH SIDES OF CROSSING, THE WATERLINE SHALL HAVE MECHANICAL JOINTS WITH APPROPRIATE THRUST BLOCKING AS REQUIRED TO PROVIDE A MINIMUM OF 24" CLEARANCE. MEETING REQUIREMENTS OF ANSI A21.10 OR A21.11 (AWWA C-151) (CLASS 50).
- 22. CONTRACTOR SHALL COORDINATE ALL UTILITY POLE RELOCATIONS WITH THE APPROPRIATE UTILITY COMPANY. BENCHMARKS:
- 23. CONTRACTOR SHALL COORDINATE WEIN THE GITY FIRE MARSHAL TO BROY UPF SHOWN AND NOTIFY ENGINEER OF CHANGES 4.4 E:2376692.0 E:2376464.4 ELEV:682.2' ELEV:683.2' ELEV:682.2'

PRELIMINARY THIS DOCUMENT IS RELEASED FOR THE PURPOSE OF INTERIM REVIEW UNDER THE AUTHORITY OF IAN NORFOLK, P.E. 93550 ON 11/13/2024. IT IS NOT TO BE USED FOR CONSTRUCTION, BIDDING, OR PERMIT PURPOSES."

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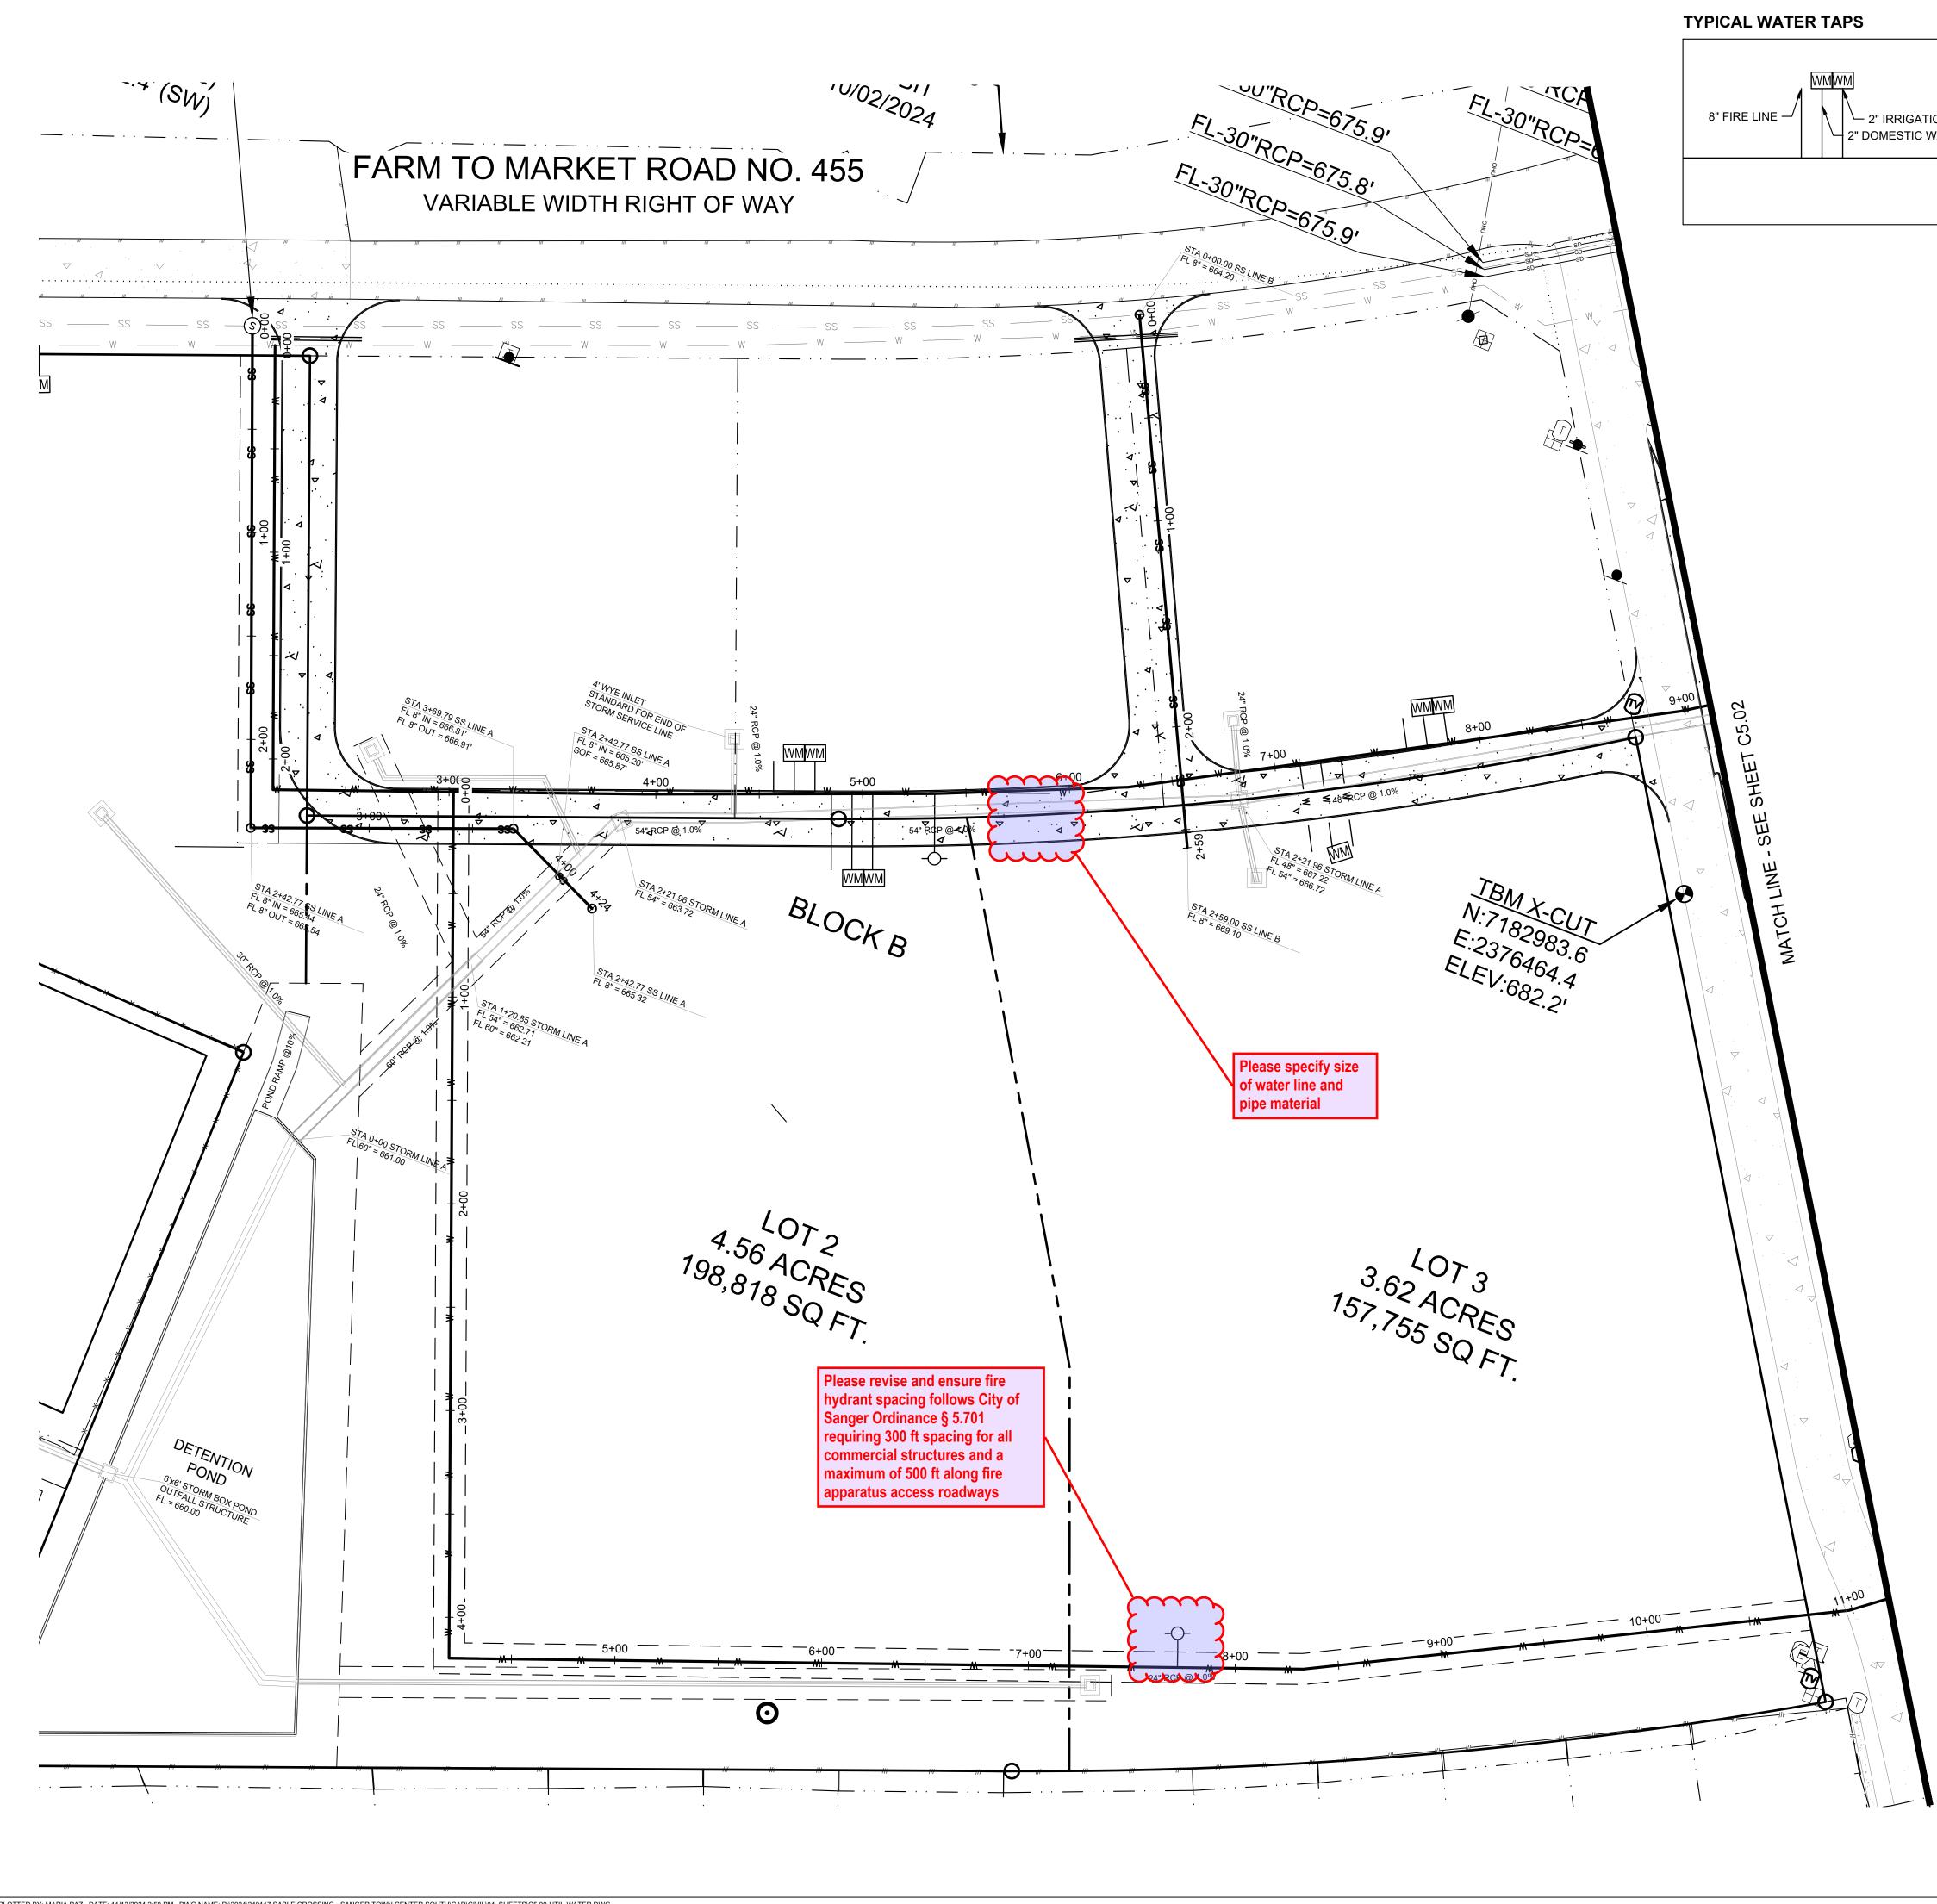
500 Moseley Rd Cross Roads, TX 76277 Phone 940-387-0805 Fax 940-387-0830







Issued Date:	11/12/2024
Project No:	240117
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Drawn By:	RP
Checked By:	IN
Designed By:	IN
Issue Re	cord
# Description	Date
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OVERALL UTILITY
PLAN



PLOTTED BY: MARIA PAZ DATE: 11/13/2024 2:59 PM DWG NAME: P:\2024/240117 SABLE CROSSING - SANGER TOWN CENTER SOUTH\CAD\CIVIL\04\_SHEETS\C5.00-UTIL-WATER.DWG LAST SAVED BY: MARIAPAZ DATE: 11/12/2024 5:10 PM



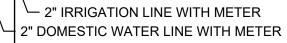

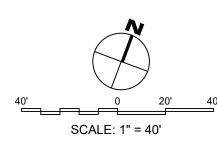


KJE 500 Moseley Rd Cross Roads, TX 76277 Phone 940-387-0805 Fax 940-387-0830

# **LEGEND - UTILITY PLAN**

	- SITE BOUNDARY
	PROPOSED EASEMENT
	- BUILDING SETBACK
	- PROPOSED WATER LINE
- <b>Ç</b> -	PROPOSED FIRE HYDRANT
Т	PROPOSED VALVE
WM	PROPOSED WATER METER
	- PROPOSED SANITARY SEWER LINE
0	PROPOSED SANITARY SEWER MANHOLE

## SITE UTILITY NOTES

- 1. THE CONTRACTOR SHALL BE RESPONSIBLE FOR LOCATING ALL UTILITIES, WHETHER PRIVATE OR PUBLIC, PRIOR TO EXCAVATING. THE INFORMATION AND DATA SHOWN WITH RESPECT TO EXISTING UNDERGROUND FACILITIES AT OR CONTIGUOUS TO THE SITE IS APPROXIMATE AND BASED ON THE INFORMATION AND DATA FURNISHED BY THE OWNERS OF SUCH UNDERGROUND FACILITIES OR ON PHYSICAL APPEARANCES OBSERVED IN THE FIELD. THE OWNER AND ENGINEER SHALL NOT BE RESPONSIBLE FOR THE ACCURACY OR COMPLETENESS OF ANY SUCH INFORMATION OR DATA: AND THE CONTRACTOR SHALL HAVE FULL RESPONSIBILITY FOR REVIEWING AND CHECKING ALL SUCH INFORMATION AND DATA. FOR LOCATING ALL UNDERGROUND FACILITIES. FOR COORDINATION OF THE WORK WITH THE OWNERS OF SUCH UNDERGROUND FACILITIES DURING CONSTRUCTION, FOR THE SAFETY AND PROTECTION THEREOF, AND REPAIRING ANY DAMAGE THERETO RESULTING FROM THE WORK, THE COST OF ALL OF WHICH WILL BE CONSIDERED AS HAVING BEEN INCLUDED IN THE CONTRACT PRICE. CONTRACTOR SHALL VERIFY LOCATION AND ELEVATIONS OF EXISTING UTILITIES PRIOR TO CONSTRUCTION AND IS RESPONSIBLE FOR COSTS INCURRED BY PROCEEDING WITH ELEVATIONS OF EXISTING UTILITIES THAT DIFFER FROM THOSE PRESENTED ON THESE PLANS DISCREPANCIES SHALL BE PRESENTED TO THE ENGINEER FOR REVIEW PRIOR TO PROCEEDING WITH WORK. CONTRACTOR SHALL NOTIFY ANY AFFECTED UTILITY COMPANIES, AGENCIES AND ENGINEER AT LEAST 48 HOURS PRIOR TO BEGINNING CONSTRUCTION.
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- 3. THE SITE UTILITY CONTRACTOR SHALL PROVIDE ALL THE MATERIALS AND APPURTENANCES NECESSARY FOR THE COMPLETE INSTALLATION OF THE UTILITIES. ALL PIPE AND FITTINGS SHALL BE INSPECTED BY THE CITY INSPECTOR PRIOR TO BEING COVERED.
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- THE SITE UTILITY CONTRACTOR SHALL MAKE ARRANGEMENTS WITH THE CITY OF GAINESVILLE FOR THE CONNECTIONS TO THE EXISTING WATER AND WASTEWATER MAINS.
- THE CONTRACTOR SHALL ADJUST THE LOCATION OF THE PROPOSED WATER LINES AS REQUIRED TO AVOID CONFLICTS WITH THE OTHER UTILITIES.
- 7. THRUST BLOCKS SHALL BE PROVIDED AT ALL TEES, ELBOWS AND BENDS, AND WILL BE OF SUFFICIENT SIZE TO COMPLY WITH CITY STANDARDS FOR EXISTING SOIL CONDITIONS.
- 8. ALL FIRE PROTECTION MATERIALS SHALL BE U.L. LISTED, FACTORY MUTUAL APPROVED, AND TO NFPA STANDARDS, UNLESS OTHERWISE DIRECTED BY THE ENGINEER.
- 9. MATCH TOPS OF ALL MANHOLES AND VAULTS WITH PROPOSED GROUND ELEVATIONS.
- 10. ALL FILL MATERIAL IS TO BE IN PLACE AND COMPACTED BEFORE INSTALLATION OF PROPOSED UTILITIES.
- 11. WATER & SANITARY SEWER UTILITIES SHALL BE KEPT TEN FEET (10') APART (PARALLEL) OR, WHEN CROSSING PROVIDE 24" VERTICAL CLEARANCE (OUTSIDE EDGE OF PIPE TO OUTSIDE EDGE OF PIPE, UNLESS OTHERWISE NOTED.)
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- 22. CONTRACTOR SHALL COORDINATE ALL BENCHMARKS: APPROPRIATE UTILITY COMPANY.
- TBM X-CUT TBM X-CUT TBM X-CUT 23. CONTRACTOR SHALL COORDINATE WITH 7118 298 FT FIRE WITA & STARLOTO PAR ON 8283.6 ANY ADDITIONAL FIRE SAFETY FEATURES 3766640 ING FERE 7669 RANTS FOR 76464.4 SHOWN AND NOTIFY ENGINEER OF CHANGE \$82.2' ELEV:683.2' ELEV:682.2'

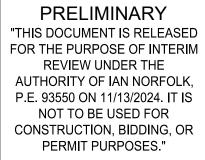








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WATER PLAN




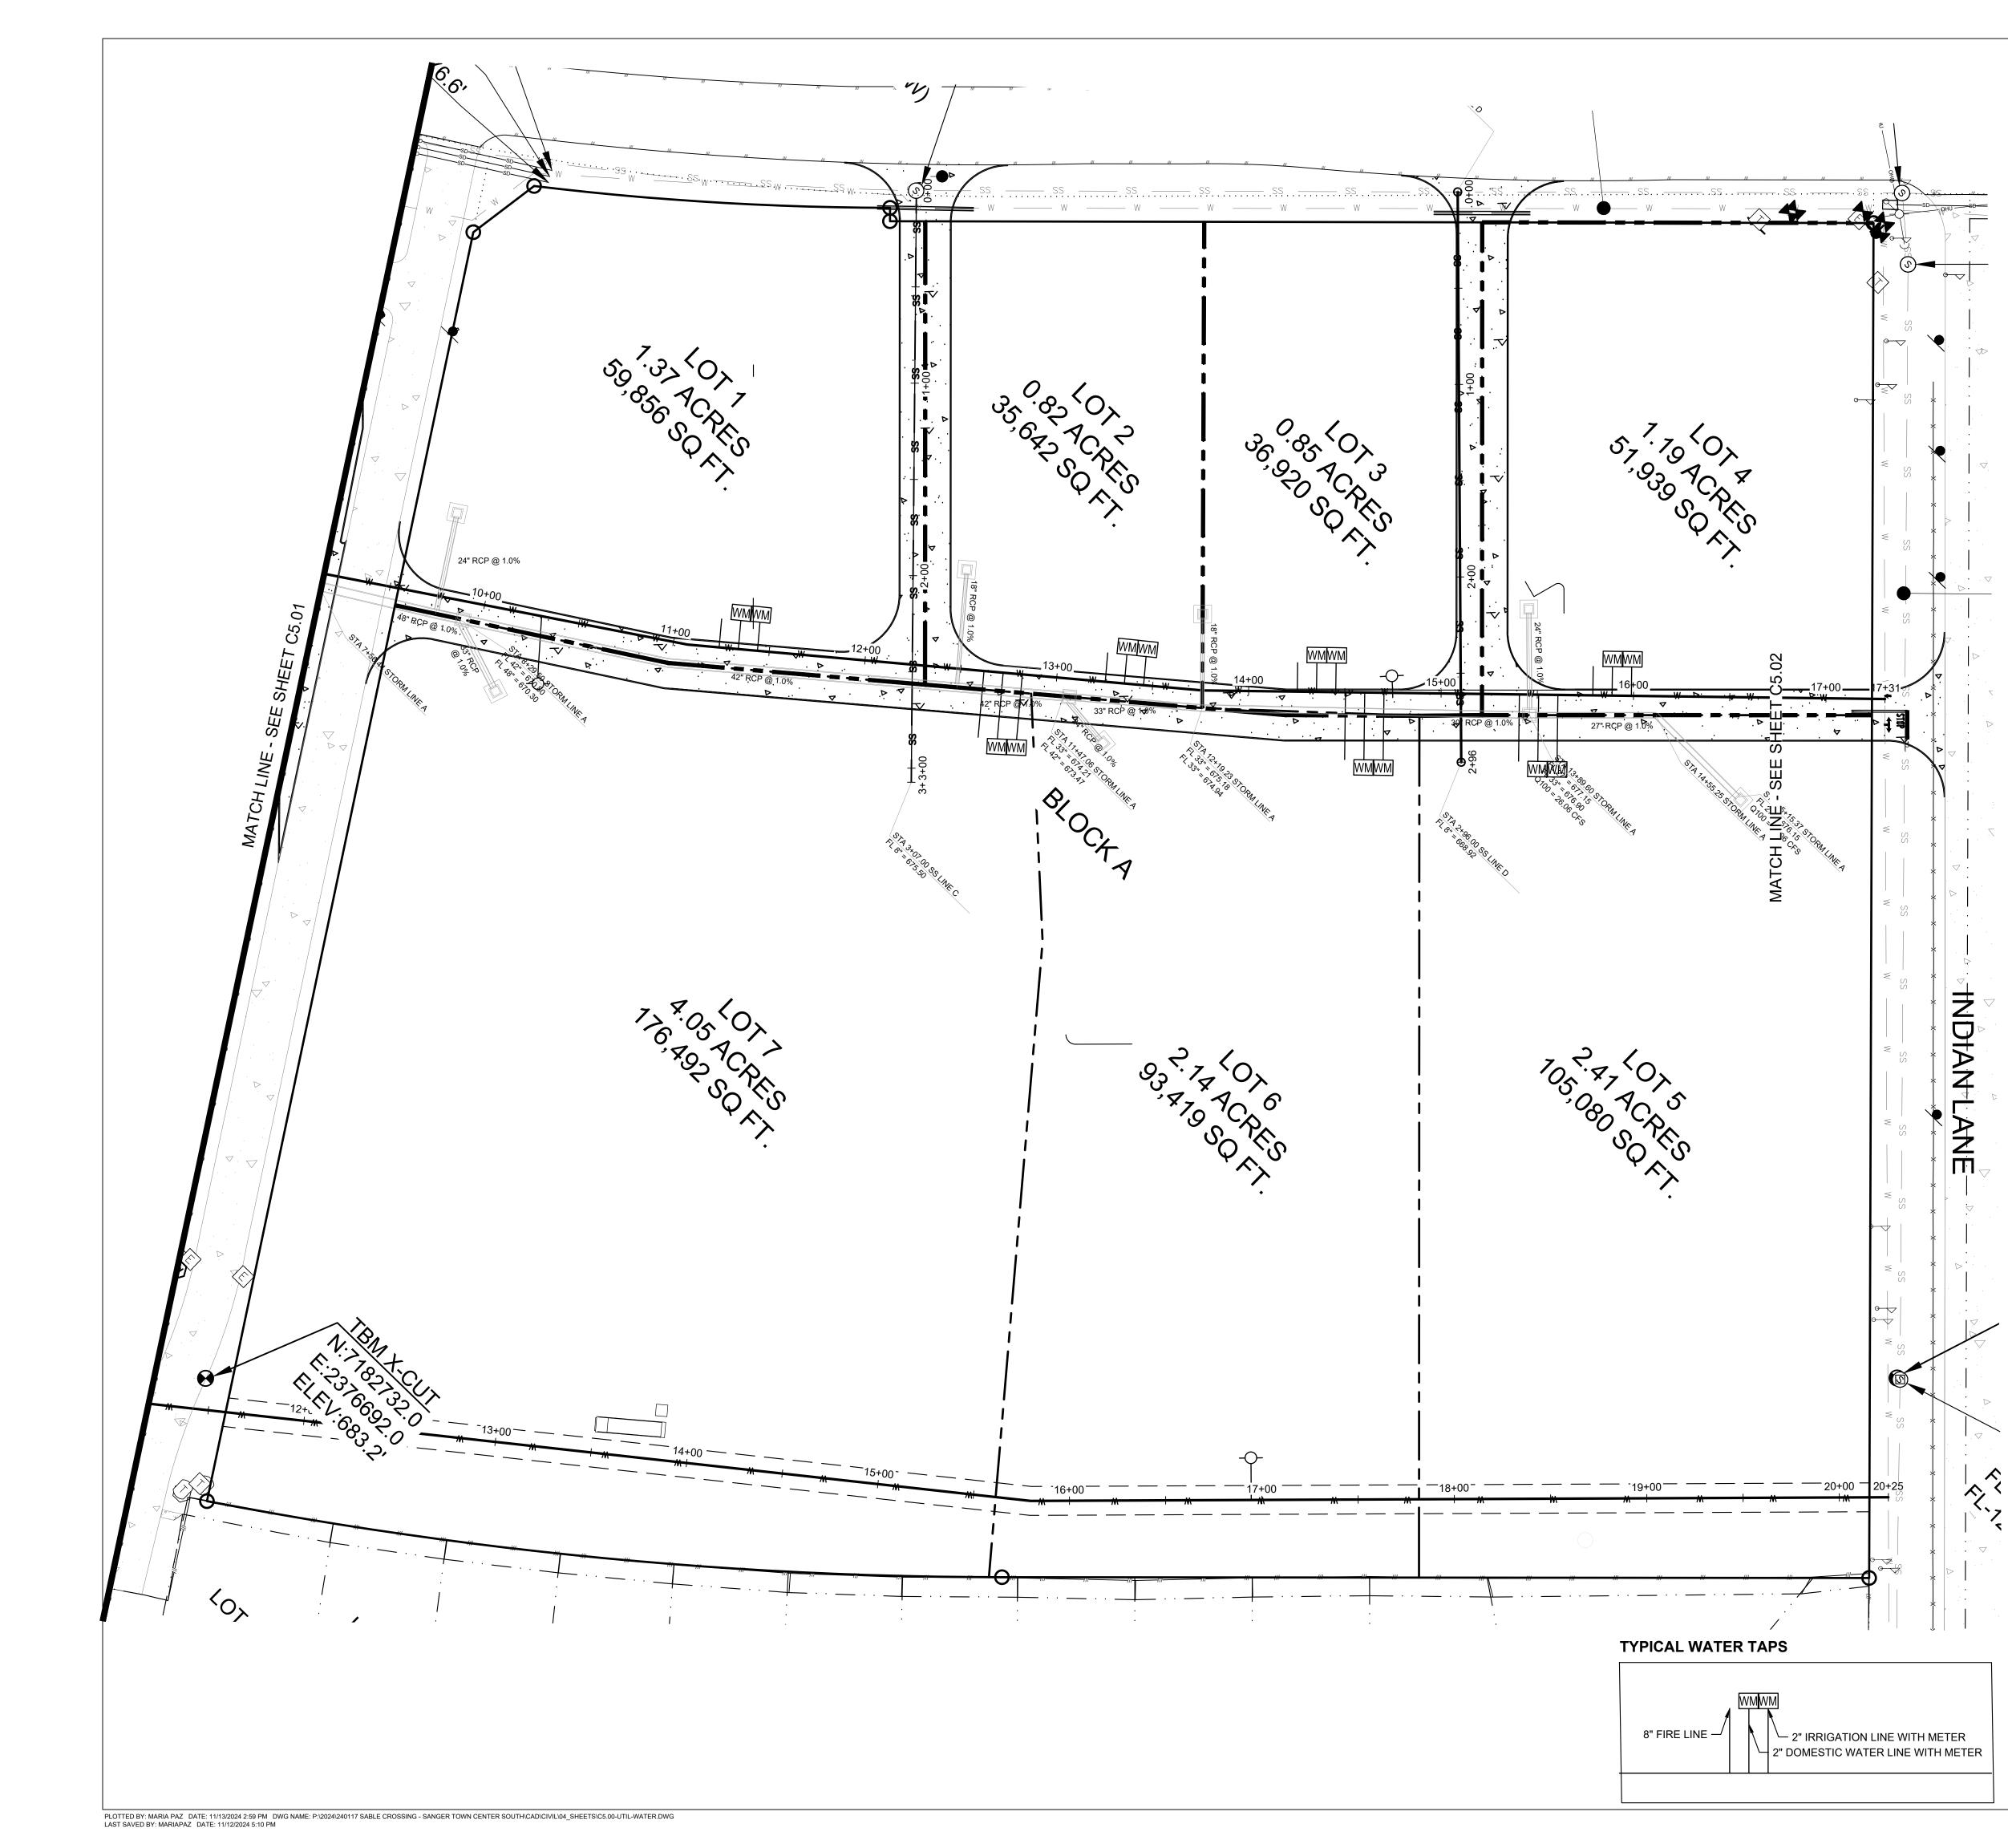

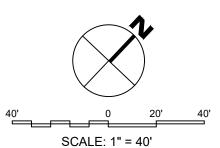

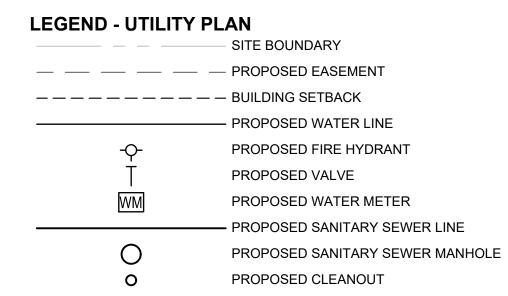
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- APPROPRIATE UTILITY COMPANY.TBM X-CUTTBM X-CUTTBM X-CUTTBM X-CUT23.CONTRACTOR SHALL COORDINATE WITH THE CLX FIRE MARSHALT OF BOVIDE<br/>ANY ADDITIONAL FIRE SAFETY FEATURES, INCLUDING FIRE HYDEAN SNOT<br/>SHOWN AND NOTIFY ENGINEER OF CHANGES.N:7182983.6<br/>LX FIRE SAFETY FEATURES, INCLUDING FIRE HYDEAN SNOT<br/>ELEV:682.2'N:7182983.6<br/>ELEV:682.2'N:7182983.6<br/>E:2376464.4<br/>ELEV:683.2'

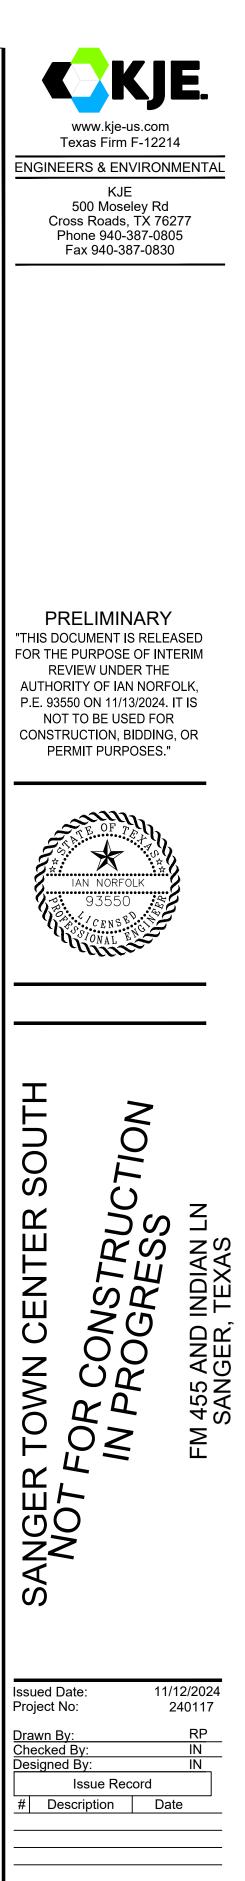

WATER PLAN

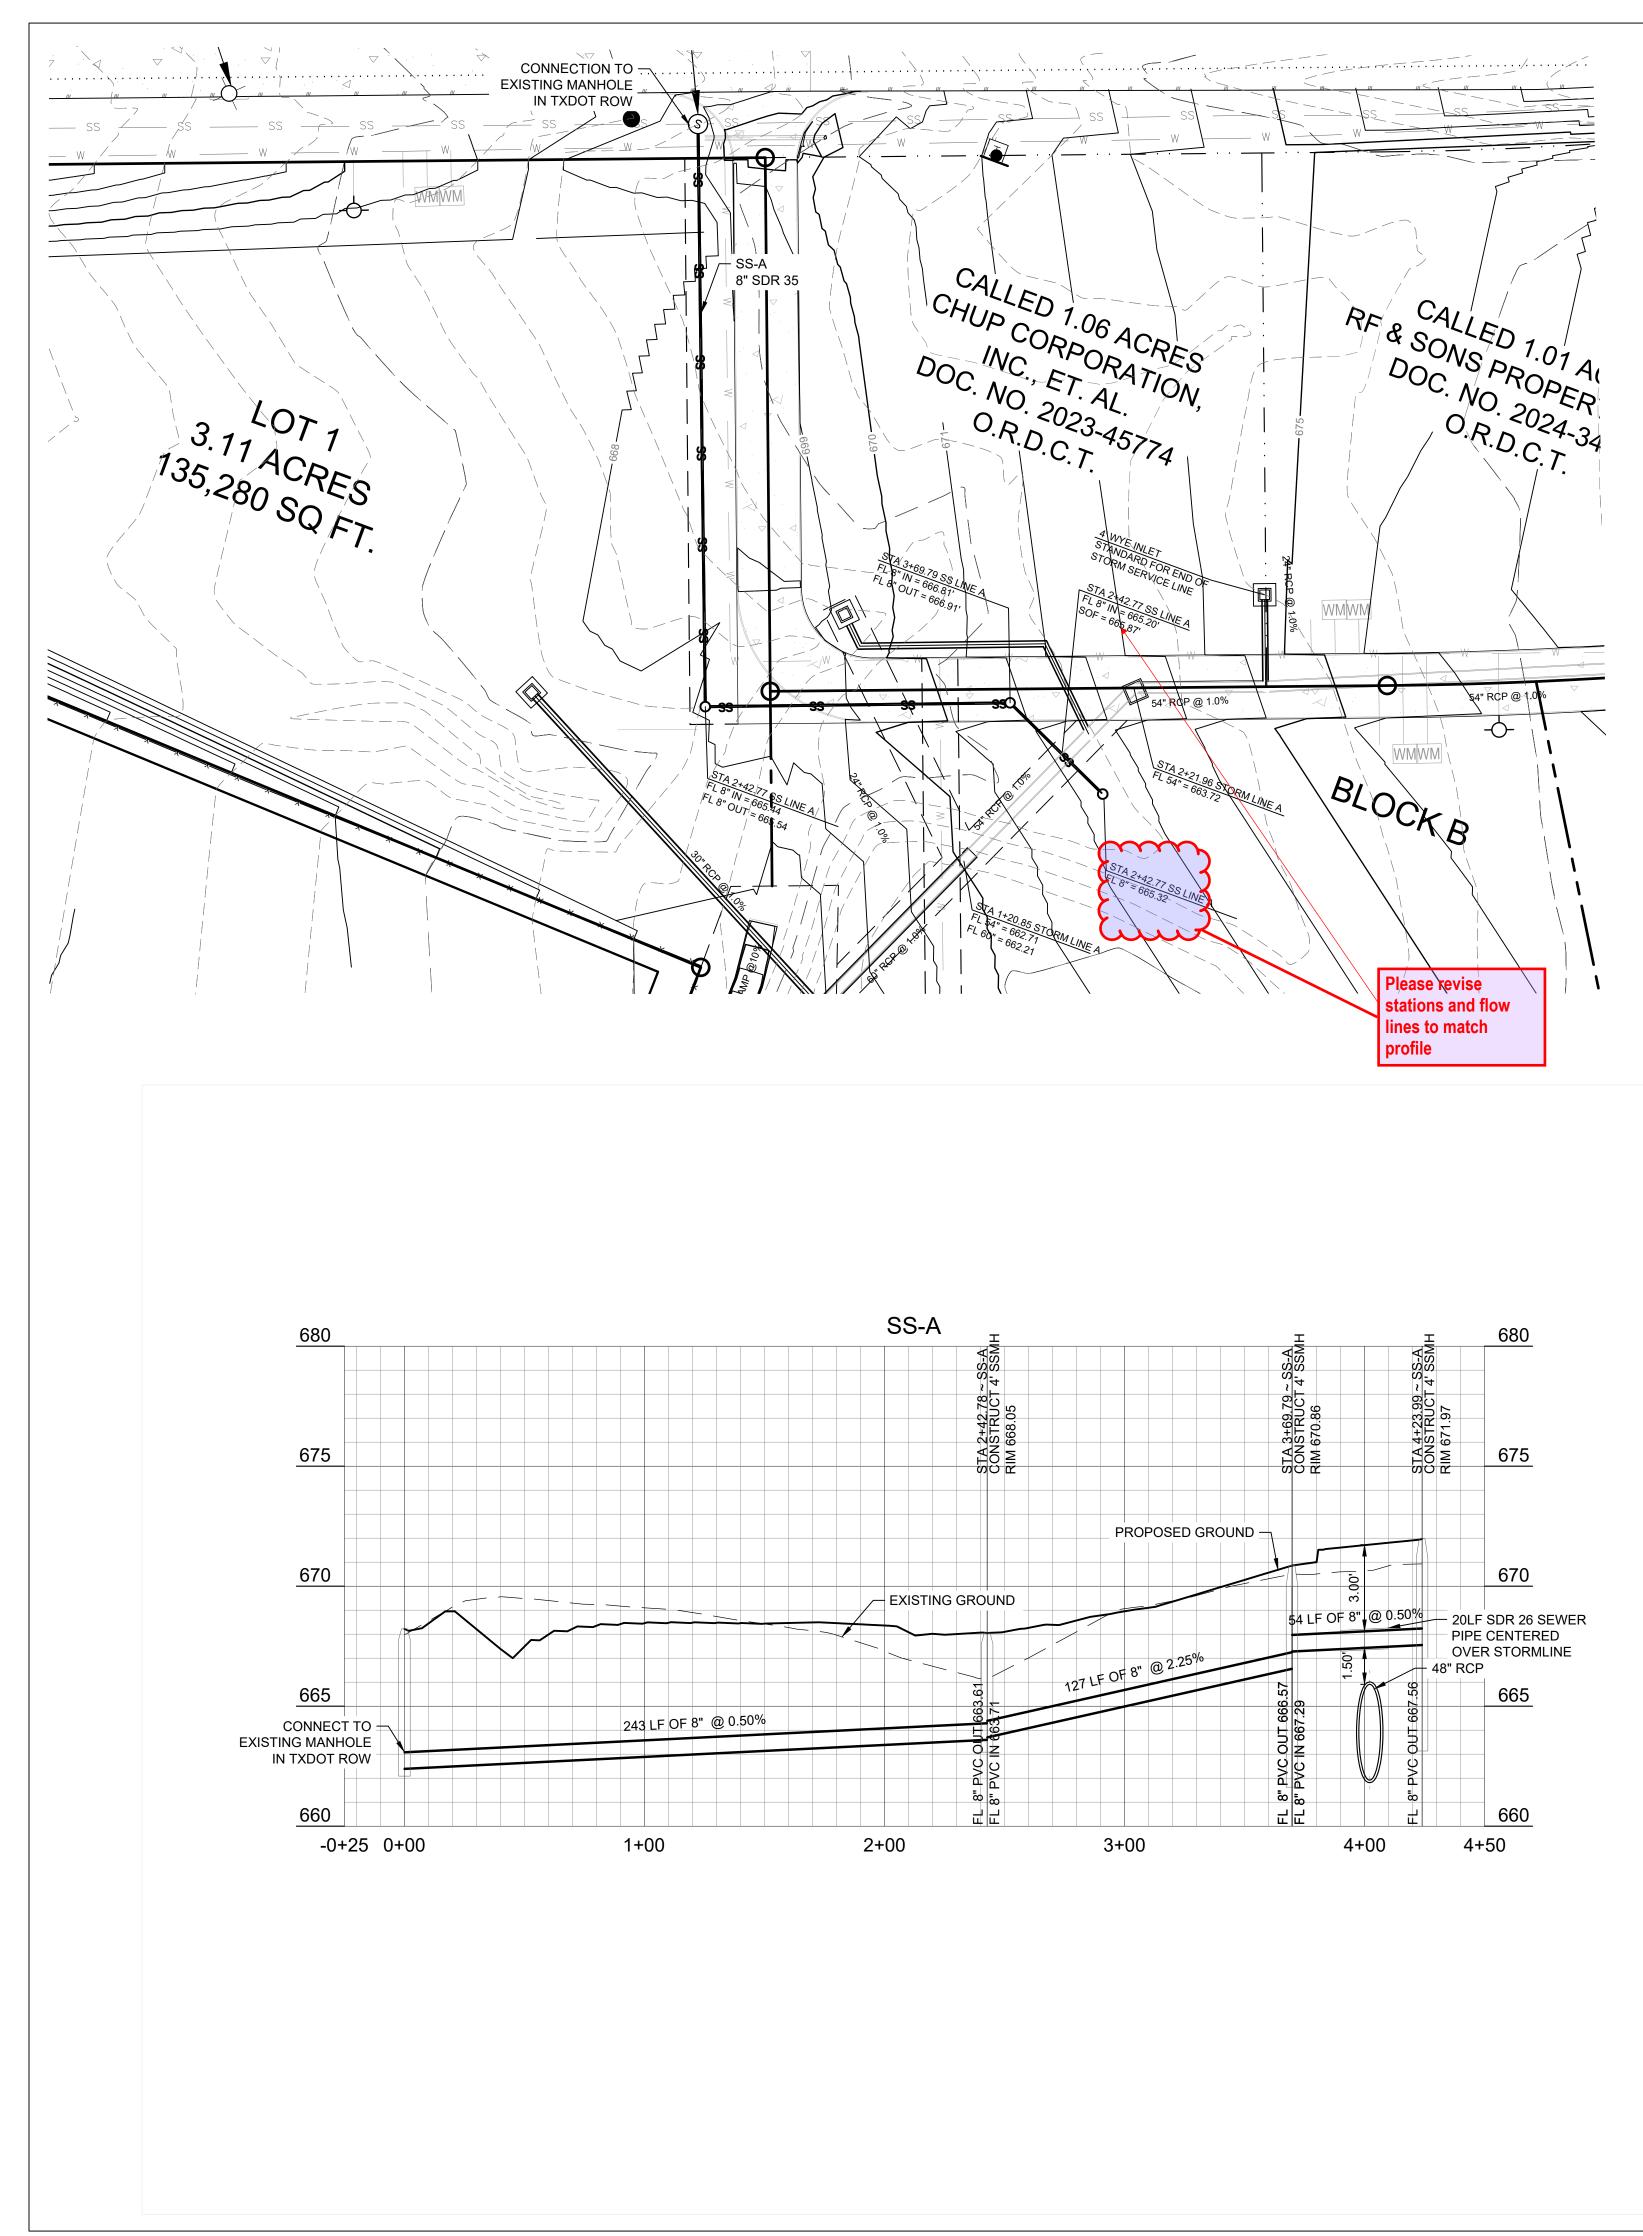

PLOTTED BY: MARIA PAZ DATE: 11/13/2024 2:59 PM DWG NAME: P:/2024/240117 SABLE CROSSING - SANGER TOWN CENTER SOUTH/CAD/CIVIL/04\_SHEETS/C5.00-UTIL-SEWER.DWG LAST SAVED BY: MARIAPAZ DATE: 11/13/2024 2:10 PM

City of Sanger 2. 7. 8.

SCALE: 1" = 40'

LEGEND - UTILITY PLAN - SITE BOUNDARY — — — — — — — — — — BUILDING SETBACK — PROPOSED WATER LINE PROPOSED FIRE HYDRANT -PROPOSED VALVE WM PROPOSED WATER METER - PROPOSED SANITARY SEWER LINE Ο PROPOSED SANITARY SEWER MANHOLE PROPOSED CLEANOUT 0

### SITE UTILITY NOTES

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MATCH TOPS OF ALL MANHOLES AND VAULTS WITH PROPOSED GROUND ELEVATIONS.

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# www.kje-us.com Texas Firm F-12214 ENGINEERS & ENVIRONMENTAL KJE 500 Moseley Rd

Cross Roads, TX 76277

Phone 940-387-0805

Fax 940-387-0830

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Issued Date:		11/12/2024
Project No:		240117
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Che	ecked By:	IN
Designed By:		IN
	Issue Rec	ord
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SANITARY SEWER LINE SS-A


**BENCHMARKS:** 

TBM X-CUT N:7182983.6 E:2376464.4 ELEV:682.2'

TBM X-CUT TBM X-CUT N:7182732.0

N:7182983.6 E:2376692.0 E:2376464.4 ELEV:683.2' ELEV:682.2'

675.9, – SS-B 8" SDR 35 RF& SONS PROPERTIES, LLC DOC. NO. 2023-10065, LLC ACRES ERTIES, LLC -34930 18" RCP @ 1 [BM N:7182 E:23764 ELEV:68

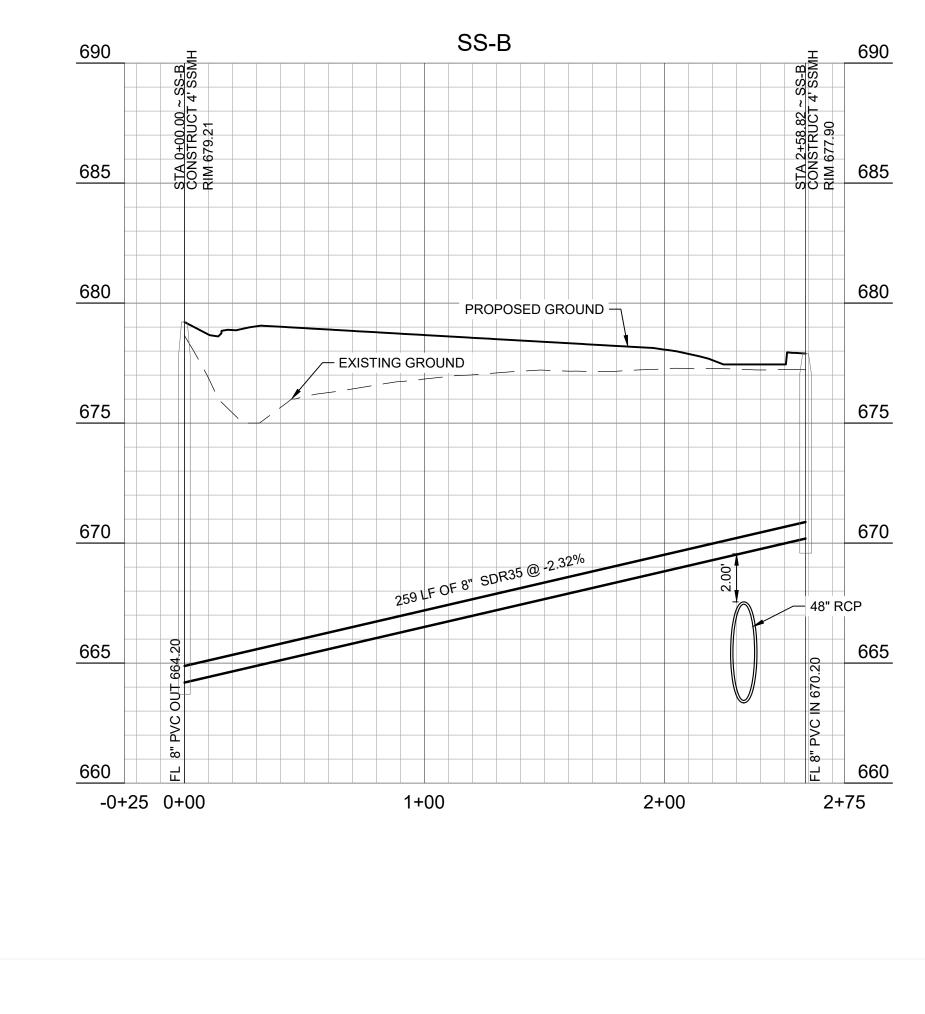

PLOTTED BY: MARIA PAZ DATE: 11/13/2024 2:59 PM DWG NAME: P:\2024\240117 SABLE CROSSING - SANGER TOWN CENTER SOUTH\CAD\CIVIL\04\_SHEETS\C5.00-UTIL-SEWER.DWG LAST SAVED BY: MARIAPAZ DATE: 11/13/2024 2:10 PM

20' SCALE: 1" = 40' LEGEND - UTILITY PLAN \_\_\_\_\_ – SITE BOUNDARY — — PROPOSED EASEMENT — — — — — — — — — — BUILDING SETBACK — PROPOSED WATER LINE PROPOSED FIRE HYDRANT ----PROPOSED VALVE WM PROPOSED WATER METER - PROPOSED SANITARY SEWER LINE Ο PROPOSED SANITARY SEWER MANHOLE PROPOSED CLEANOUT 0 SITE UTILITY NOTES 1. THE CONTRACTOR SHALL BE RESPONSIBLE FOR LOCATING ALL UTILITIES, WHETHER PRIVATE OR PUBLIC, PRIOR TO EXCAVATING. THE INFORMATION AND DATA SHOWN WITH RESPECT TO EXISTING UNDERGROUND FACILITIES AT OR CONTIGUOUS TO THE SITE IS APPROXIMATE AND BASED ON THE INFORMATION AND DATA FURNISHED BY THE OWNERS OF SUCH UNDERGROUND FACILITIES OR ON PHYSICAL APPEARANCES OBSERVED IN THE FIELD. THE OWNER AND ENGINEER SHALL NOT BE RESPONSIBLE FOR THE ACCURACY OR COMPLETENESS OF ANY SUCH INFORMATION OR DATA; AND THE CONTRACTOR SHALL HAVE FULL RESPONSIBILITY FOR REVIEWING AND CHECKING ALL SUCH INFORMATION AND DATA. FOR LOCATING ALL UNDERGROUND FACILITIES, FOR COORDINATION OF THE WORK WITH THE OWNERS OF SUCH UNDERGROUND FACILITIES DURING CONSTRUCTION, FOR THE SAFETY AND PROTECTION THEREOF, AND REPAIRING ANY DAMAGE THERETO RESULTING FROM THE WORK, THE COST OF ALL OF WHICH WILL BE CONSIDERED AS HAVING BEEN INCLUDED IN THE CONTRACT PRICE. CONTRACTOR SHALL VERIFY LOCATION AND ELEVATIONS OF EXISTING UTILITIES PRIOR TO CONSTRUCTION AND IS RESPONSIBLE FOR COSTS INCURRED BY PROCEEDING WITH ELEVATIONS OF EXISTING UTILITIES THAT DIFFER FROM THOSE PRESENTED ON THESE PLANS. DISCREPANCIES SHALL BE PRESENTED TO THE ENGINEER FOR REVIEW PRIOR TO PROCEEDING WITH WORK. CONTRACTOR SHALL NOTIFY ANY AFFECTED UTILITY COMPANIES, AGENCIES AND ENGINEER AT LEAST 48 HOURS PRIOR TO BEGINNING CONSTRUCTION. 2. ALL UTILITIES SHALL BE CONSTRUCTED IN ACCORDANCE WITH THE CITY OF PUBLIC WORKS SPECIFICATIONS. 3. THE SITE UTILITY CONTRACTOR SHALL PROVIDE ALL THE MATERIALS AND APPURTENANCES NECESSARY FOR THE COMPLETE INSTALLATION OF THE UTILITIES. ALL PIPE AND FITTINGS SHALL BE INSPECTED BY THE CITY INSPECTOR PRIOR TO BEING COVERED. 4. ALL WORK SHALL COMPLY WITH ALL APPLICABLE CODES, REGULATIONS, AND/OR LOCAL STANDARDS AND REQUIREMENTS. 5. THE SITE UTILITY CONTRACTOR SHALL MAKE ARRANGEMENTS WITH THE CITY OF GAINESVILLE FOR THE CONNECTIONS TO THE EXISTING WATER AND WASTEWATER MAINS. 6. THE CONTRACTOR SHALL ADJUST THE LOCATION OF THE PROPOSED WATER LINES AS REQUIRED TO AVOID CONFLICTS WITH THE OTHER UTILITIES. THRUST BLOCKS SHALL BE PROVIDED AT ALL TEES, ELBOWS AND BENDS, AND WILL BE OF SUFFICIENT SIZE 7. TO COMPLY WITH CITY STANDARDS FOR EXISTING SOIL CONDITIONS. 8. ALL FIRE PROTECTION MATERIALS SHALL BE U.L. LISTED, FACTORY MUTUAL APPROVED, AND TO NFPA STANDARDS, UNLESS OTHERWISE DIRECTED BY THE ENGINEER. MATCH TOPS OF ALL MANHOLES AND VAULTS WITH PROPOSED GROUND ELEVATIONS. 9 10. ALL FILL MATERIAL IS TO BE IN PLACE AND COMPACTED BEFORE INSTALLATION OF PROPOSED UTILITIES. 11. WATER & SANITARY SEWER UTILITIES SHALL BE KEPT TEN FEET (10') APART (PARALLEL) OR, WHEN CROSSING PROVIDE 24" VERTICAL CLEARANCE (OUTSIDE EDGE OF PIPE TO OUTSIDE EDGE OF PIPE, UNLESS OTHERWISE NOTED.) 12. UNDERGROUND LINES SHALL BE INSTALLED, INSPECTED AND APPROVED BEFORE BACKFILLING. 13. TOPS OF EXISTING MANHOLES SHALL BE RAISED AS NECESSARY TO BE FLUSH WITH PROPOSED PAVEMENT ELEVATIONS, AND ARE TO BE ONE FOOT ABOVE FINISHED GROUND ELEVATIONS WITH WATER TIGHT LIDS. 14. ALL CONCRETE FOR ENCASEMENT SHALL HAVE A MINIMUM 28-DAY COMPRESSION STRENGTH OF 3000 P.S.I. 15. CONTRACTOR SHALL MAINTAIN A MINIMUM OF 48" COVER BELOW FINISHED GRADE TO TOP OF ALL WATERLINES. 16. ALL NECESSARY INSPECTIONS AND/OR CERTIFICATIONS REQUIRED BY CODES AND/OR UTILITY SERVICE COMPANIES SHALL BE IN POSSESSION BEFORE THE FINAL CONNECTION OF SERVICE. 17. CONTRACTOR SHALL COORDINATE WITH ALL UTILITY COMPANIES FOR INSTALLATION REQUIREMENTS AND SPECIFICATIONS. 18. ACTUAL ROUTING OF ELECTRICAL SERVICE FROM THE EXISTING TRANSFORMER IS TO BE COORDINATED WITH THE ELECTRICAL UTILITY. 19. ACTUAL ROUTING OF GAS SERVICE FROM THE EXISTING GAS LINE TO THE TERMINUS POINT TO THE BUILDING IS TO BE COORDINATED WITH THE GAS UTILITY. 20. ACTUAL ROUTING OF TELEPHONE SERVICE FROM THE EXISTING TELEPHONE LINE TO THE BUILDING IS TO BE COORDINATED WITH THE TELEPHONE UTILITY. 21. IN THE EVENT OF VERTICAL CONFLICT BETWEEN WATERLINES, SANITARY LINES, STORM LINES AND GAS LINES (EXISTING AND PROPOSED), THE SANITARY LINE SHALL BE DUCTILE IRON PIPE WITH MECHANICAL JOINTS AT LEAST 10 FEET ON BOTH SIDES OF CROSSING, THE WATERLINE SHALL HAVE MECHANICAL JOINTS WITH APPROPRIATE THRUST BLOCKING AS REQUIRED TO PROVIDE A MINIMUM OF 24" CLEARANCE. MEETING REQUIREMENTS OF ANSI A21.10 OR A21.11 (AWWA C-151) (CLASS 50). 22. CONTRACTOR SHALL COORDINATE ALL UTILITY POLE RELOCATIONS WITH THE APPROPRIATE UTILITY COMPANY. 23. CONTRACTOR SHALL COORDINATE WITH THE CITY FIRE MARSHAL TO PROVIDE ANY ADDITIONAL FIRE SAFETY FEATURES, INCLUDING FIRE HYDRANTS, NOT SHOWN AND NOTIFY ENGINEER OF CHANGES.



KJE 500 Moseley Rd Cross Roads, TX 76277 Phone 940-387-0805 Fax 940-387-0830

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Drawn By:		
Checked By:		IN
Designed By:		IN
	Issue Rec	ord
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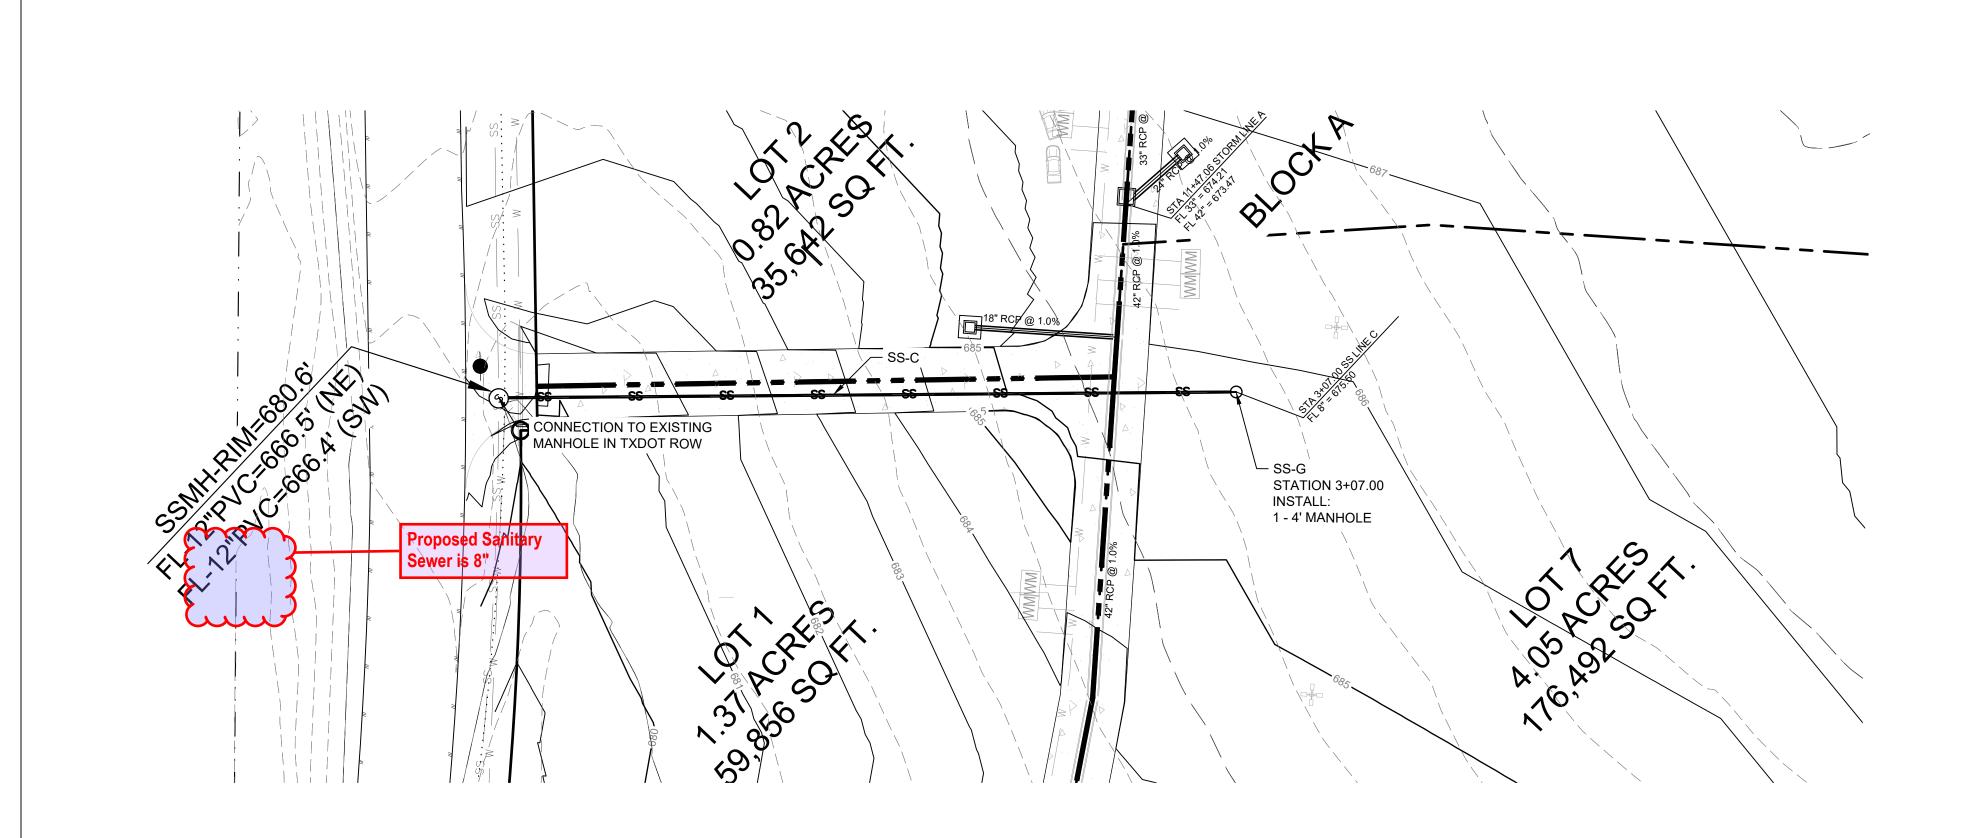
SANITARY SEWER LINE SS-B


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WATERLINES.

SCALE: 1" = 40'

LEGEND - UTILITY PLAN \_\_\_\_\_ – SITE BOUNDARY — — — PROPOSED EASEMENT --- --- --- BUILDING SETBACK - PROPOSED WATER LINE PROPOSED FIRE HYDRANT -0-PROPOSED VALVE WM PROPOSED WATER METER - PROPOSED SANITARY SEWER LINE Ο PROPOSED SANITARY SEWER MANHOLE PROPOSED CLEANOUT 0

### SITE UTILITY NOTES

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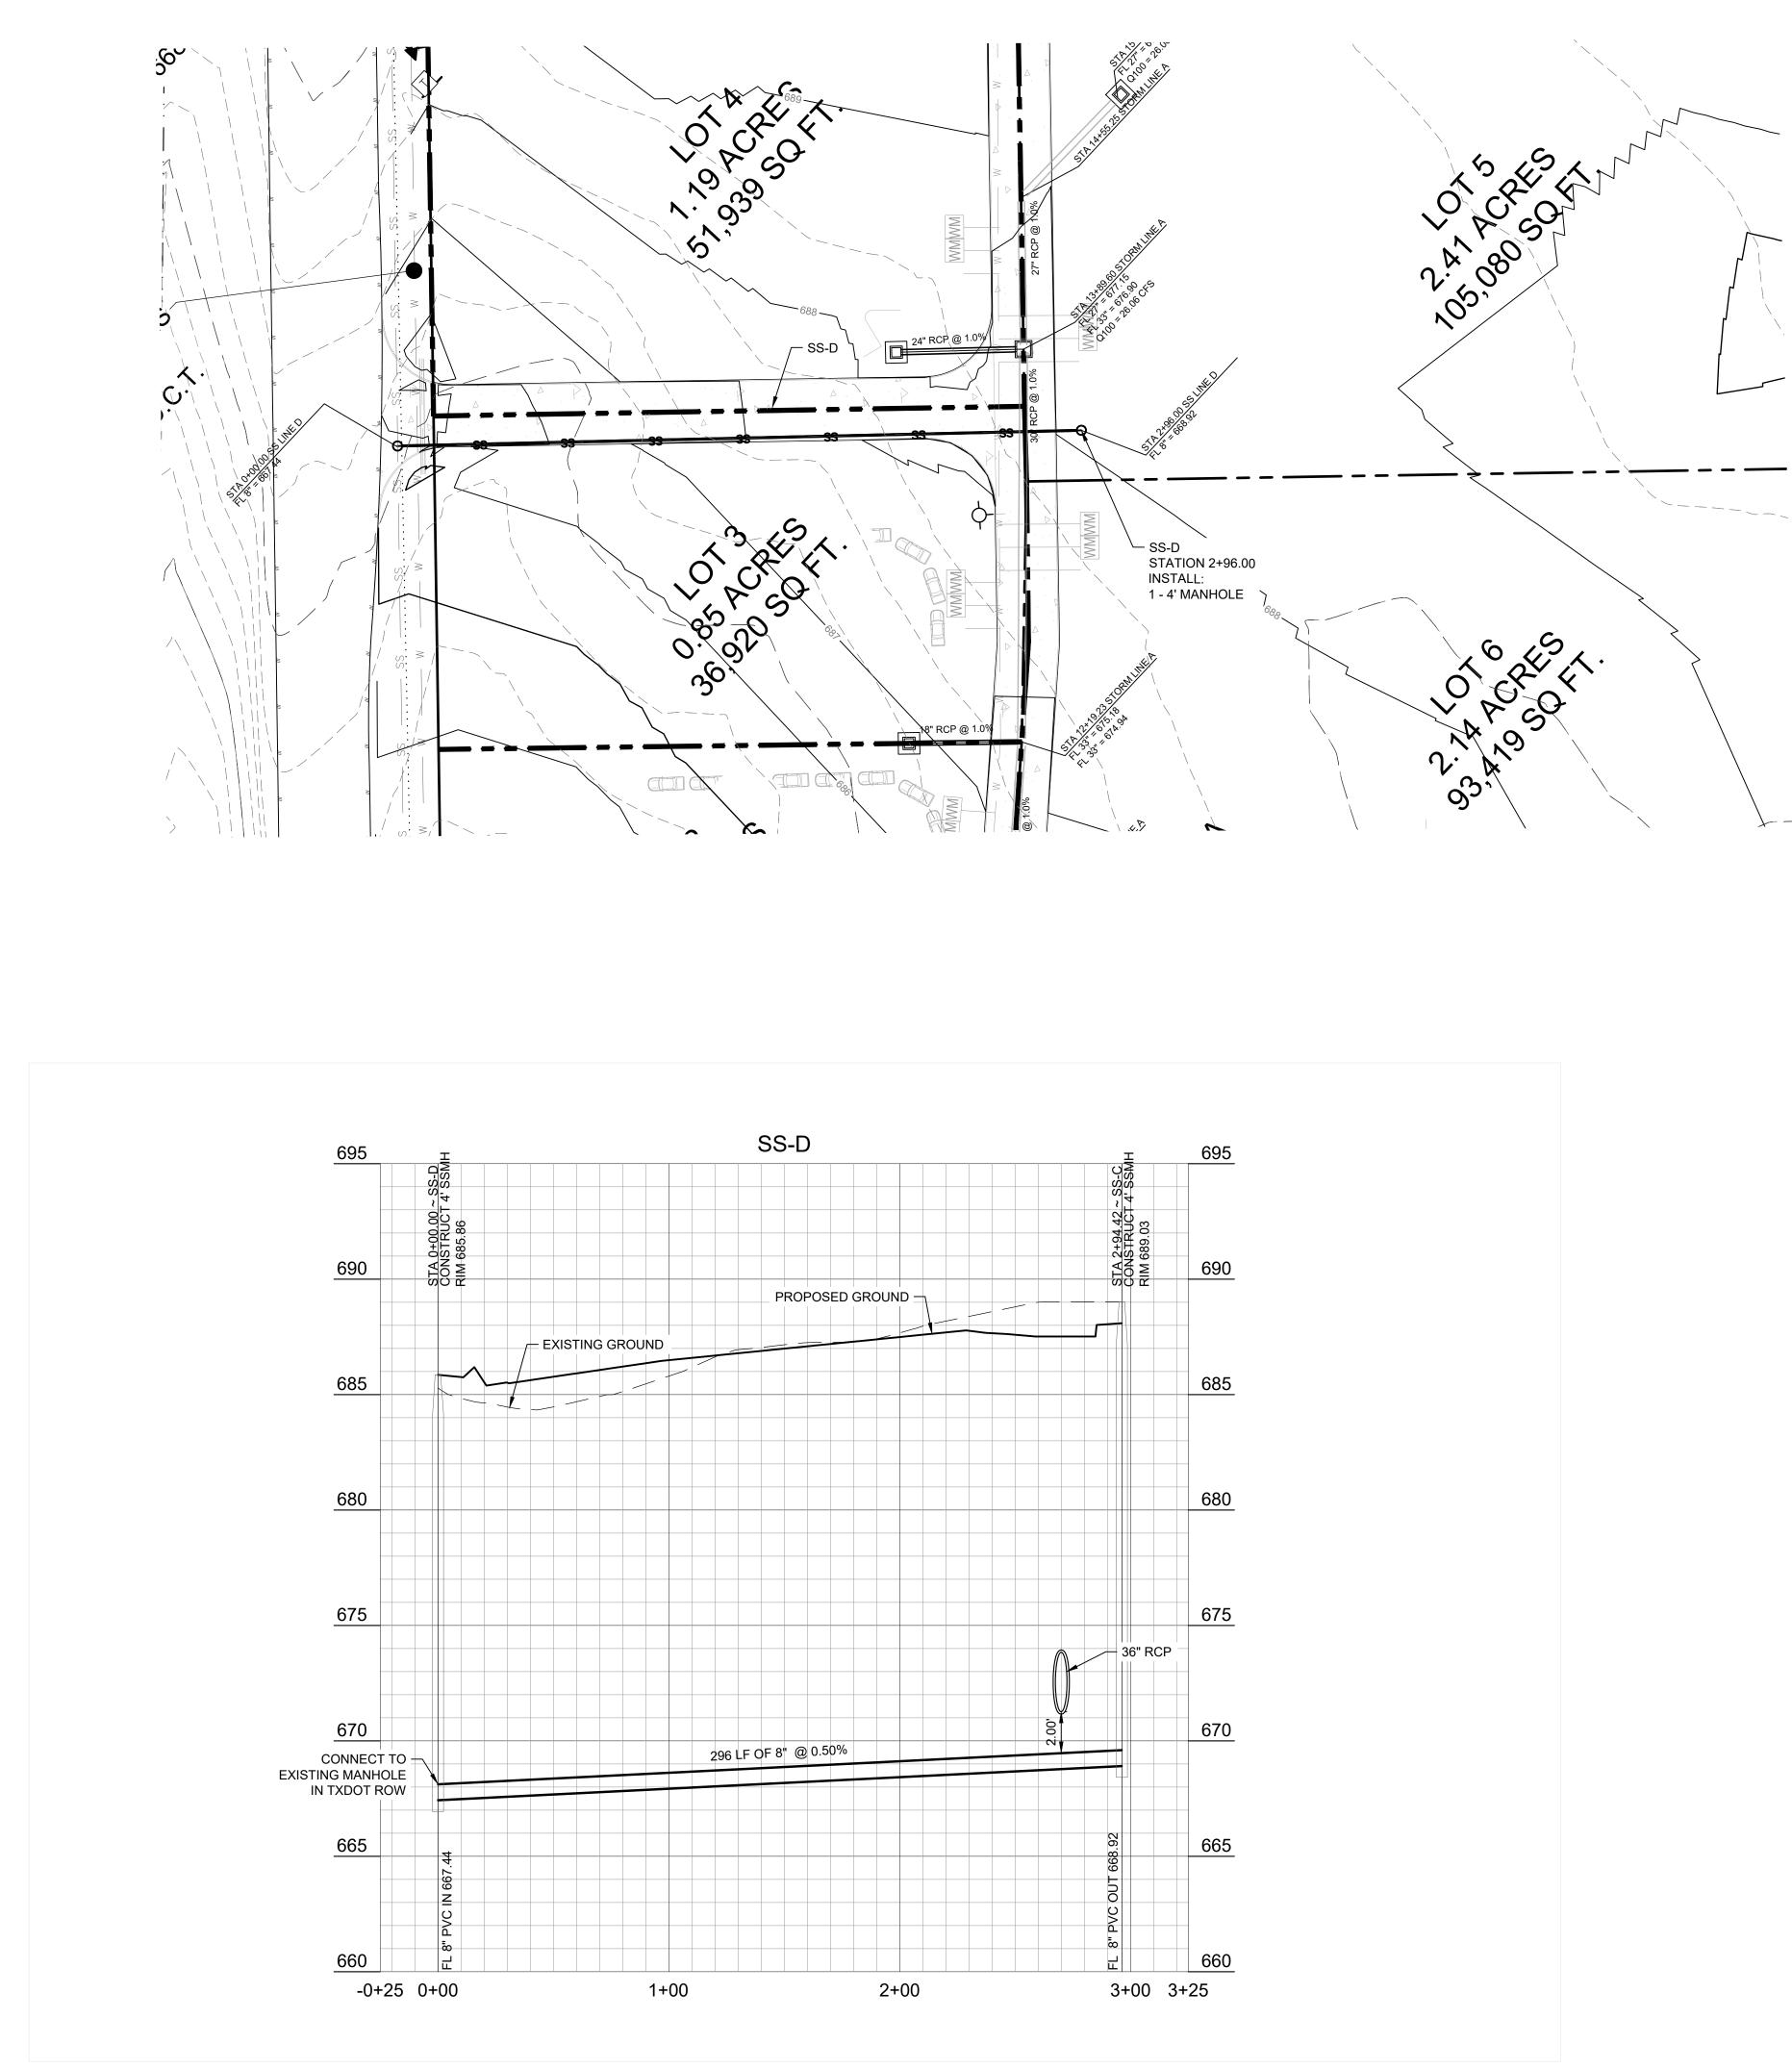
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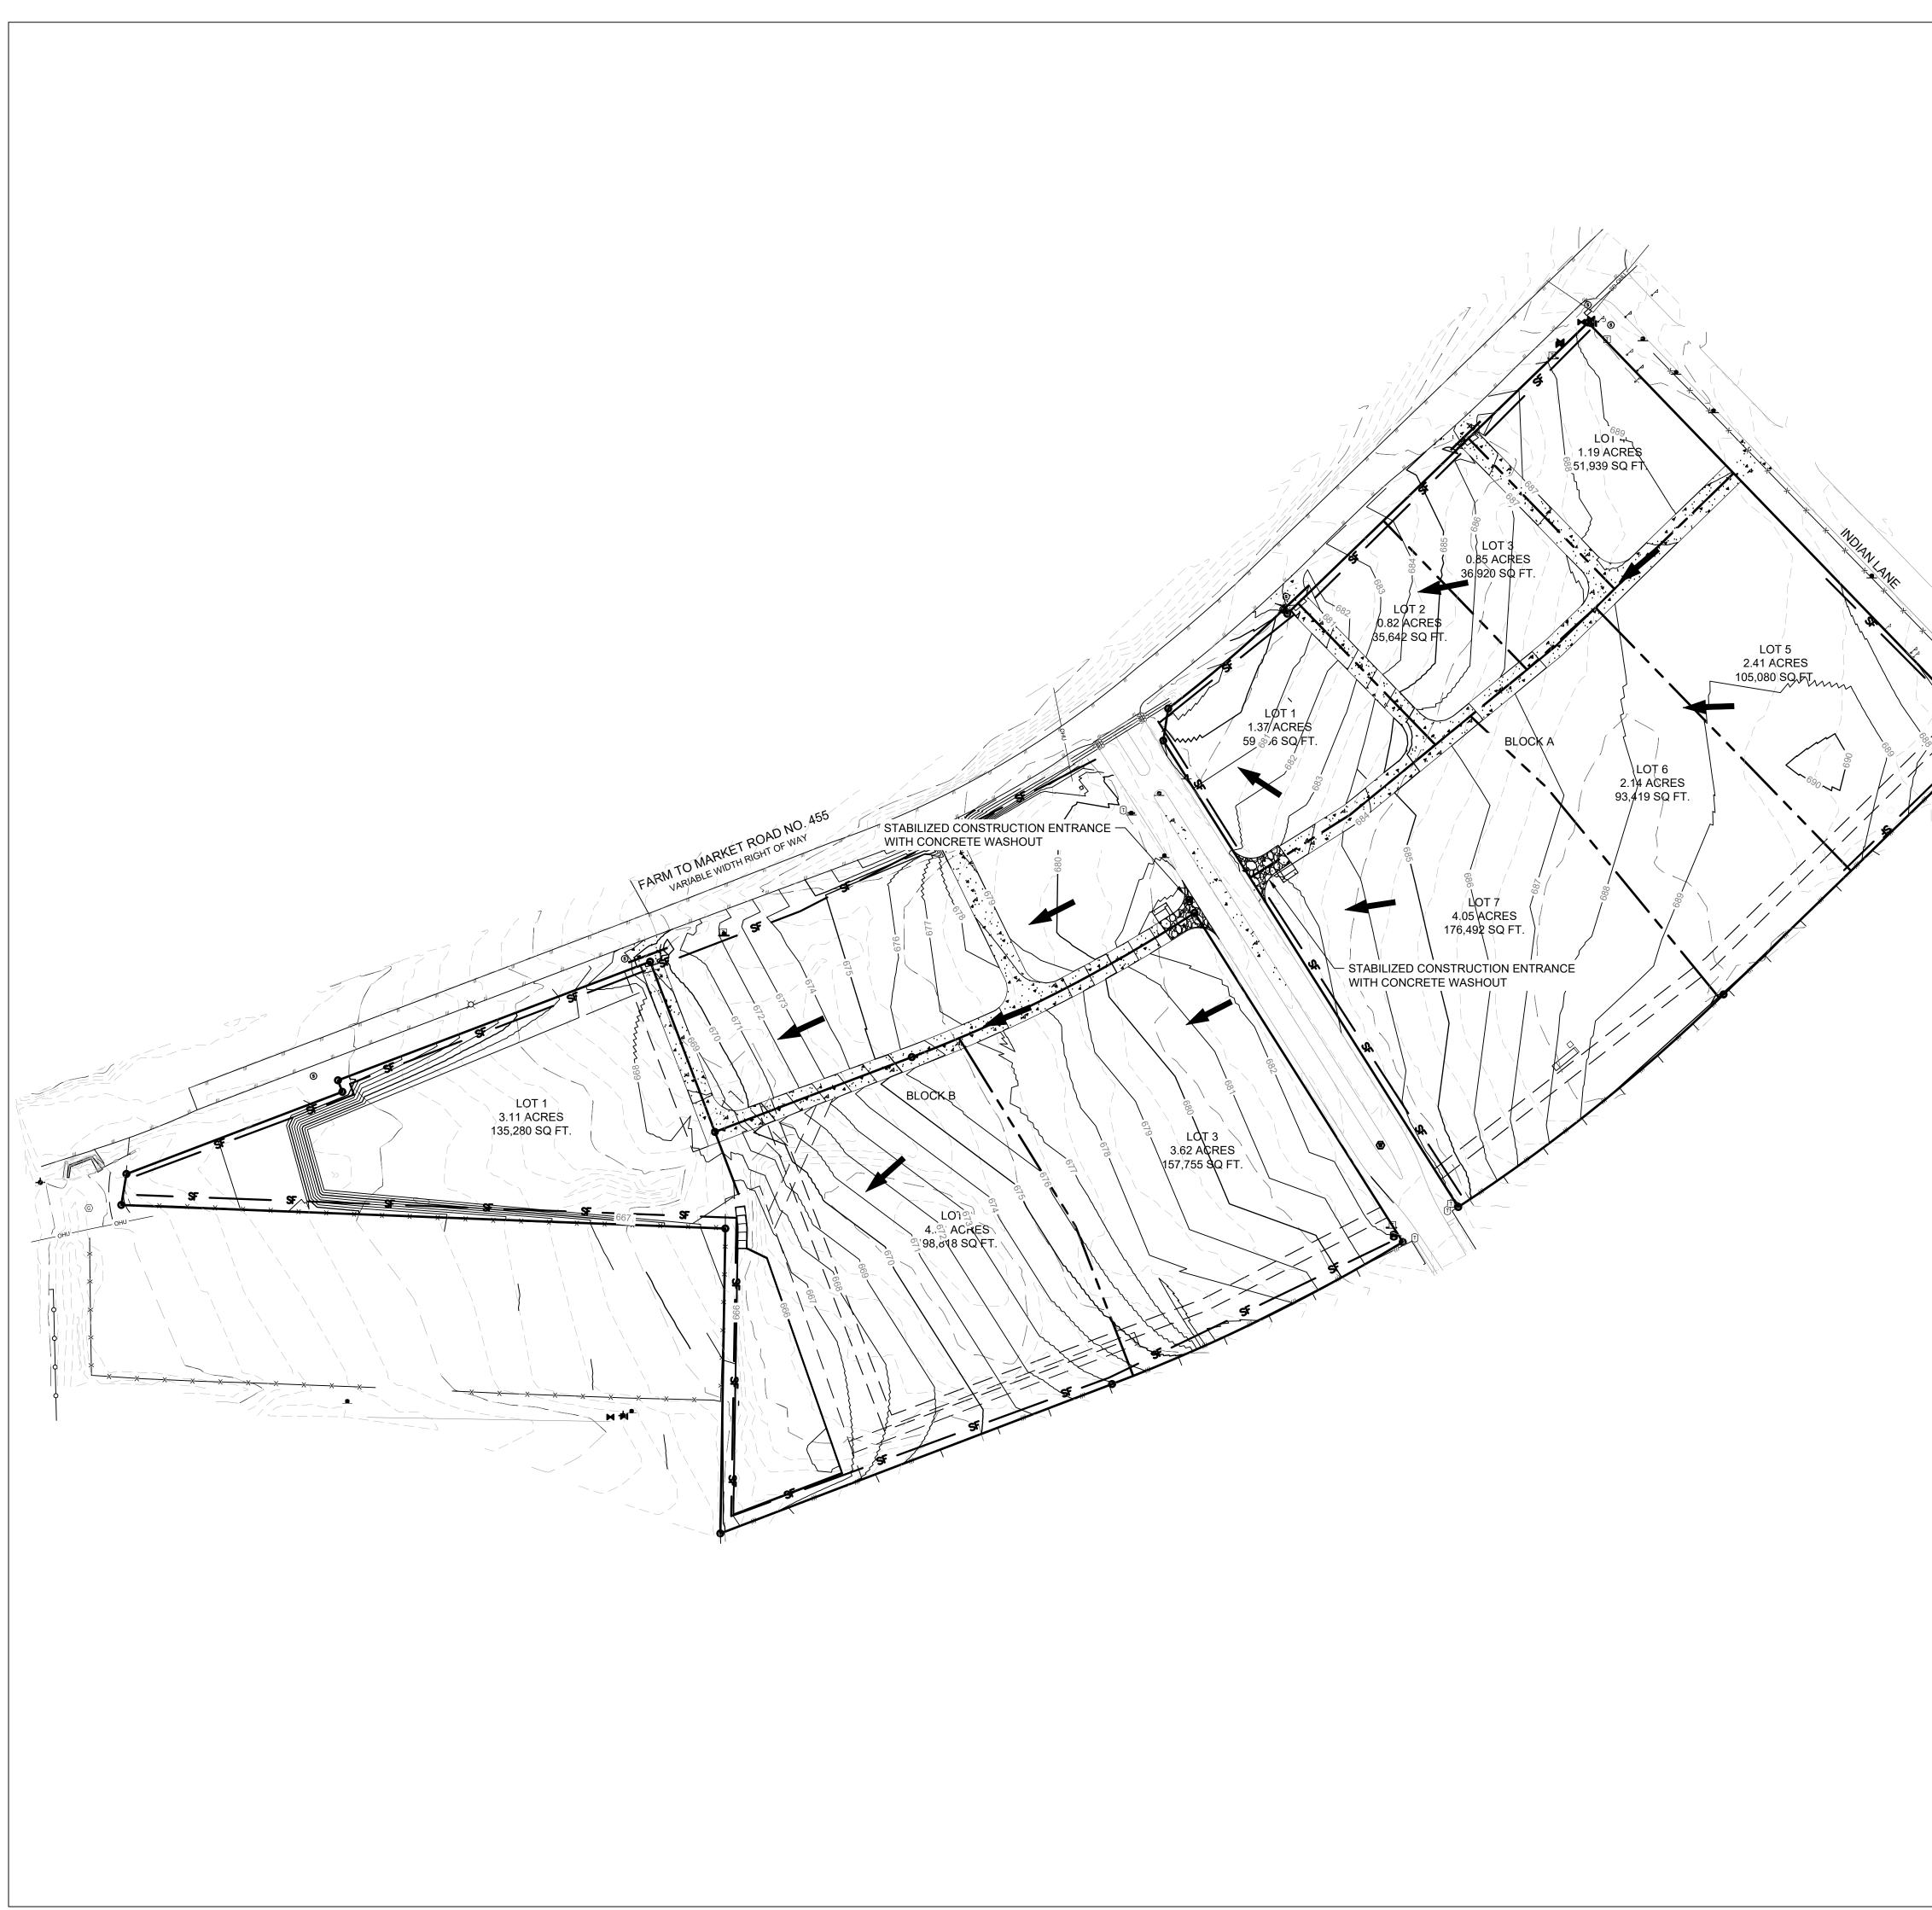
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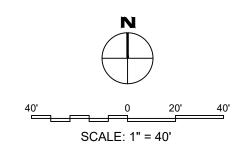
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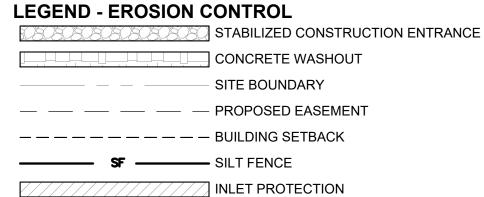
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FLOW ARROW
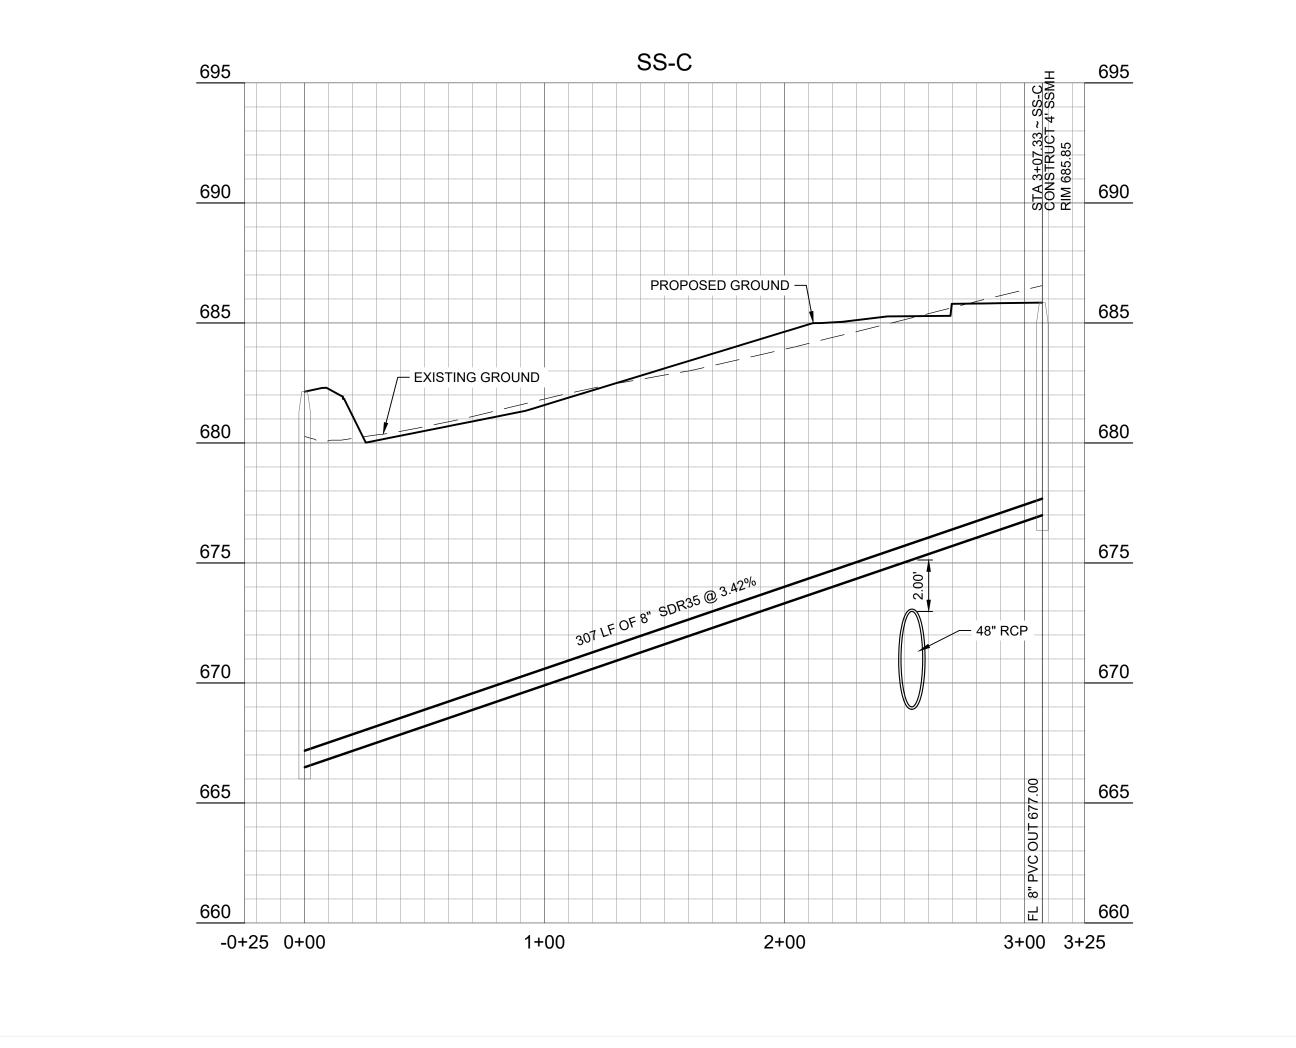
### EROSION CONTROL NOTES

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- EROSION CONTROL MEASURES MAY ONLY BE PLACED IN FRONT OF INLETS, OR IN CHANNELS, DRAINAGEWAYS OR BORROW DITCHES AT RISK OF CONTRACTOR. CONTRACTOR SHALL REMAIN LIABLE FOR ANY DAMAGE CAUSED BY THE MEASURES, INCLUDING FLOODING DAMAGE, WHICH MAY OCCUR DUE TO BLOCKED DRAINAGE. AT THE CONCLUSION OF ANY PROJECT, ALL CHANNELS, DRAINAGEWAYS AND BORROW DITCHES IN THE WORK ZONE SHALL BE DREDGED OF ANY SEDIMENT GENERATED BY THE PROJECT OR DEPOSITED AS A RESULT OF EROSION CONTROL MEASURES.
- LAND DISTURBING ACTIVITIES SHALL NOT COMMENCE UNTIL APPROVAL TO DO SO HAS BEEN RECEIVED BY GOVERNING AUTHORITIES (INCLUDING STORM WATER POLLUTION PREVENTION PLAN.) THE GENERAL CONTRACTOR SHALL STRICTLY ADHERE TO THE APPROVED TPDES SWPPP DRAWINGS DURING CONSTRUCTION OPERATIONS.
- 4. PRIOR TO COMMENCING ANY CONSTRUCTION, A CONSTRUCTION ENTRANCE AND PERIMETER SILT FENCE SHALL BE INSTALLED AT THE LOCATIONS SHOWN, OR AS DESCRIBED IN THE SWPPP.
- 5. THE CONTRACTOR IS RESPONSIBLE FOR COMPLYING WITH ALL EROSION CONTROL MEASURES SHOWN ON THE PLANS. THE EROSION CONTROL SYSTEM DESCRIBED WITHIN THE CONSTRUCTION DOCUMENTS SHOULD BE CONSIDERED TO REPRESENT THE MINIMUM ACCEPTABLE STANDARDS FOR THIS PROJECT. ADDITIONAL EROSION CONTROL MEASURES MAY BE REQUIRED DEPENDENT UPON THE STAGE OF CONSTRUCTION, THE SEVERITY OF THE RAINFALL EVENT AND/OR AS DEEMED NECESSARY AS A RESULT OF ON-SITE INSPECTIONS BY THE OWNER, THEIR REPRESENTATIVES OR THE JURISDICTIONAL AUTHORITIES. THESE ADDITIONAL MEASURES SHALL BE INSTALLED AT NO ADDITIONAL COST TO THE OWNER. IT IS THE CONTRACTOR'S ULTIMATE RESPONSIBILITY TO ASSURE THAT THE STORM WATER DISCHARGE FROM THE SITE DOES NOT EXCEED THE TOLERANCES ESTABLISHED BY ANY OF THE JURISDICTIONAL AUTHORITIES.
- 6. IF INSTALLATION OF STORM DRAINAGE SYSTEM SHOULD BE INTERRUPTED BY WEATHER OR NIGHTFALL, THE PIPE ENDS SHALL BE COVERED WITH FILTER FABRIC.
- 7. AS INLETS ARE COMPLETED, TEMPORARY SEDIMENT BARRIERS SHALL BE INSTALLED.
- 8. AT THE COMPLETION OF THE PAVING AND FINAL GRADING, THE DISTURBED AREA(S) SHALL BE REVEGETATED IN ACCORDANCE WITH THE SWPPP.
- 9. THE SPECIFIC PLANT MATERIALS PROPOSED TO PROTECT FILL AND EXCAVATED SLOPES SHALL BE AS INDICATED WITHIN THE SWPPP. PLANT MATERIALS MUST BE SUITABLE FOR USE UNDER LOCAL CLIMATE AND SOIL CONDITIONS. IN GENERAL, HYDROSEEDING OR SODDING BERMUDA GRASS IS ACCEPTABLE DURING THE SUMMER MONTHS (MAY 1 TO AUGUST 30). WINTER RYE OR FESCUE GRASS MAY BE PLANTED DURING TIMES OTHER THAN THE SUMMER MONTHS AS A TEMPORARY MEASURE UNTIL SUCHTIME AS THE PERMANENT PLANTING CAN BE MADE.
- 10. SILT FENCE AND INLET SEDIMENT BARRIERS SHALL REMAIN IN PLACE UNTIL REVEGETATION HAS BEEN COMPLETED.
- 11. DISTURBED AREAS THAT ARE SEEDED OR SODDED SHALL BE CHECKED PERIODICALLY TO SEE THAT GRASS COVERAGE IS PROPERLY MAINTAINED. DISTURBED AREAS SHALL BE WATERED, FERTILIZED, AND RESEEDED OR RESODDED, IF NECESSARY. GENERAL CONTRACTOR SHALL BE RESPONSIBLE TO TAKE WHATEVER MEANS NECESSARY TO ESTABLISH PERMANENT SOIL STABILIZATION.
- 12. SEDIMENT SHALL BE REMOVED FROM THE SEDIMENT BASIN BEFORE IT IS 50% FULL, IF IMPLEMENTED BY THE SWPPP.
- 13. FREQUENT INSPECTIONS OF THE SILT FENCE SHALL BE MADE. ALL REPAIRS OR REPLACEMENTS SHALL BE MADE IMMEDIATELY.
- 14. THE CONTRACTOR SHALL INSPECT HIS STABILIZATION AND EROSION CONTROL MEASURES AT MINIMUM OF ONCE EVERY 14 DAYS, AND WITHIN 24 HOURS OF ANY STORM EVENT GREATER THAN 0.5 INCHES. THE CONTRACTOR SHALL REPAIR INADEQUACIES REVEALED BY THE INSPECTION BEFORE THE NEXT STORM EVENT AND SHALL MODIFY HIS SWP3 WITHIN 7 DAYS OF THE INSPECTION. ACCUMULATED SILT SHALL BE REMOVED AND DISPOSED OF WHEN IT REACHES A DEPTH OF SIX (6) INCHES.
- 15. CONTRACTOR SHOULD ATTAIN A 75% BERMUDA COVERING BY SEEDING OR SODDING OVER ALL AFFECTED CONSTRUCTION AREAS BEFORE EROSION CONTROL CAN BE REMOVED.
- 16. CONTRACTOR IS RESPONSIBLE FOR PREPARING, FILING, & MAINTAINING THE SWPPP & THE NOI.
- 17. WHERE SILT FENCE CAN NOT BE USED, THE CONTRACTOR MAY SUBSTITUTE WITH THE FOLLOWING: -TRIANGULAR SEDIMENT FILTER DIKE P**BENCTOMASKES**<sup>1050A</sup> -"TEXAS POWER MULCH" MULCH FILLED FILTER SOCK
- 18.
   THE CONTRACTOR SHALL REFERT 我的 2000 COT SWPPP

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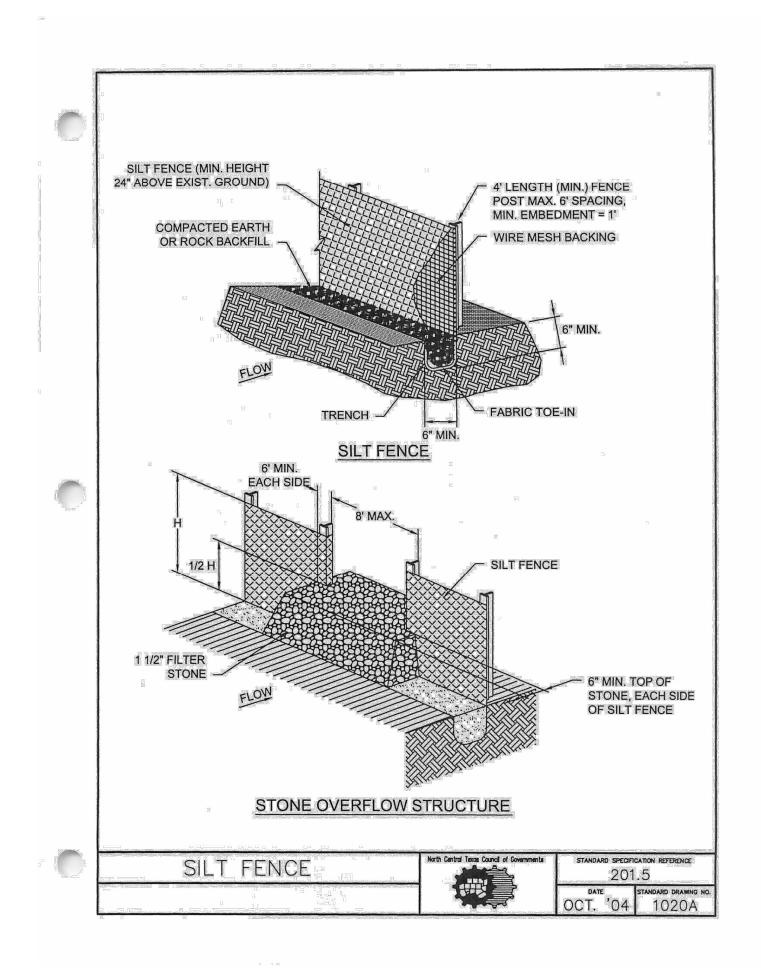
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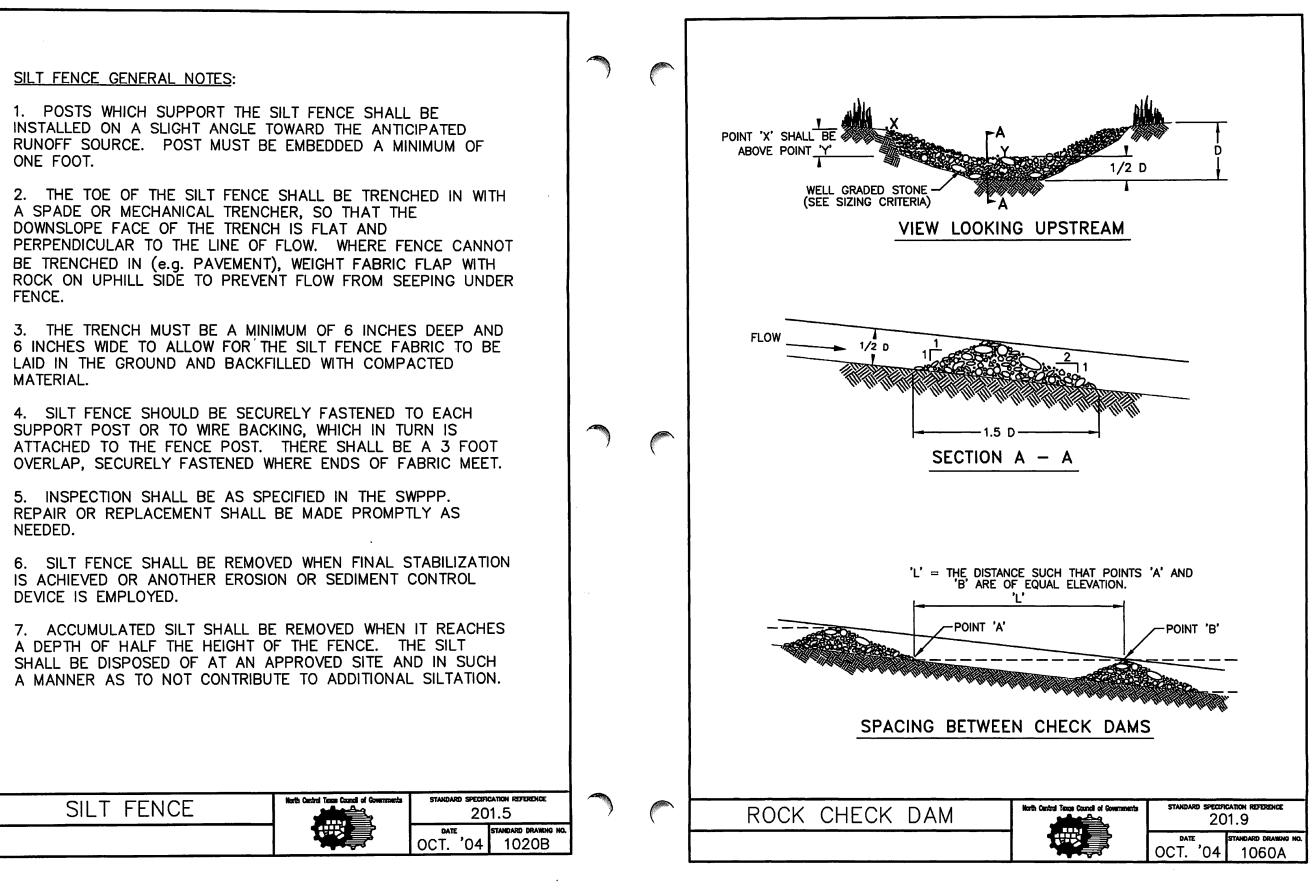
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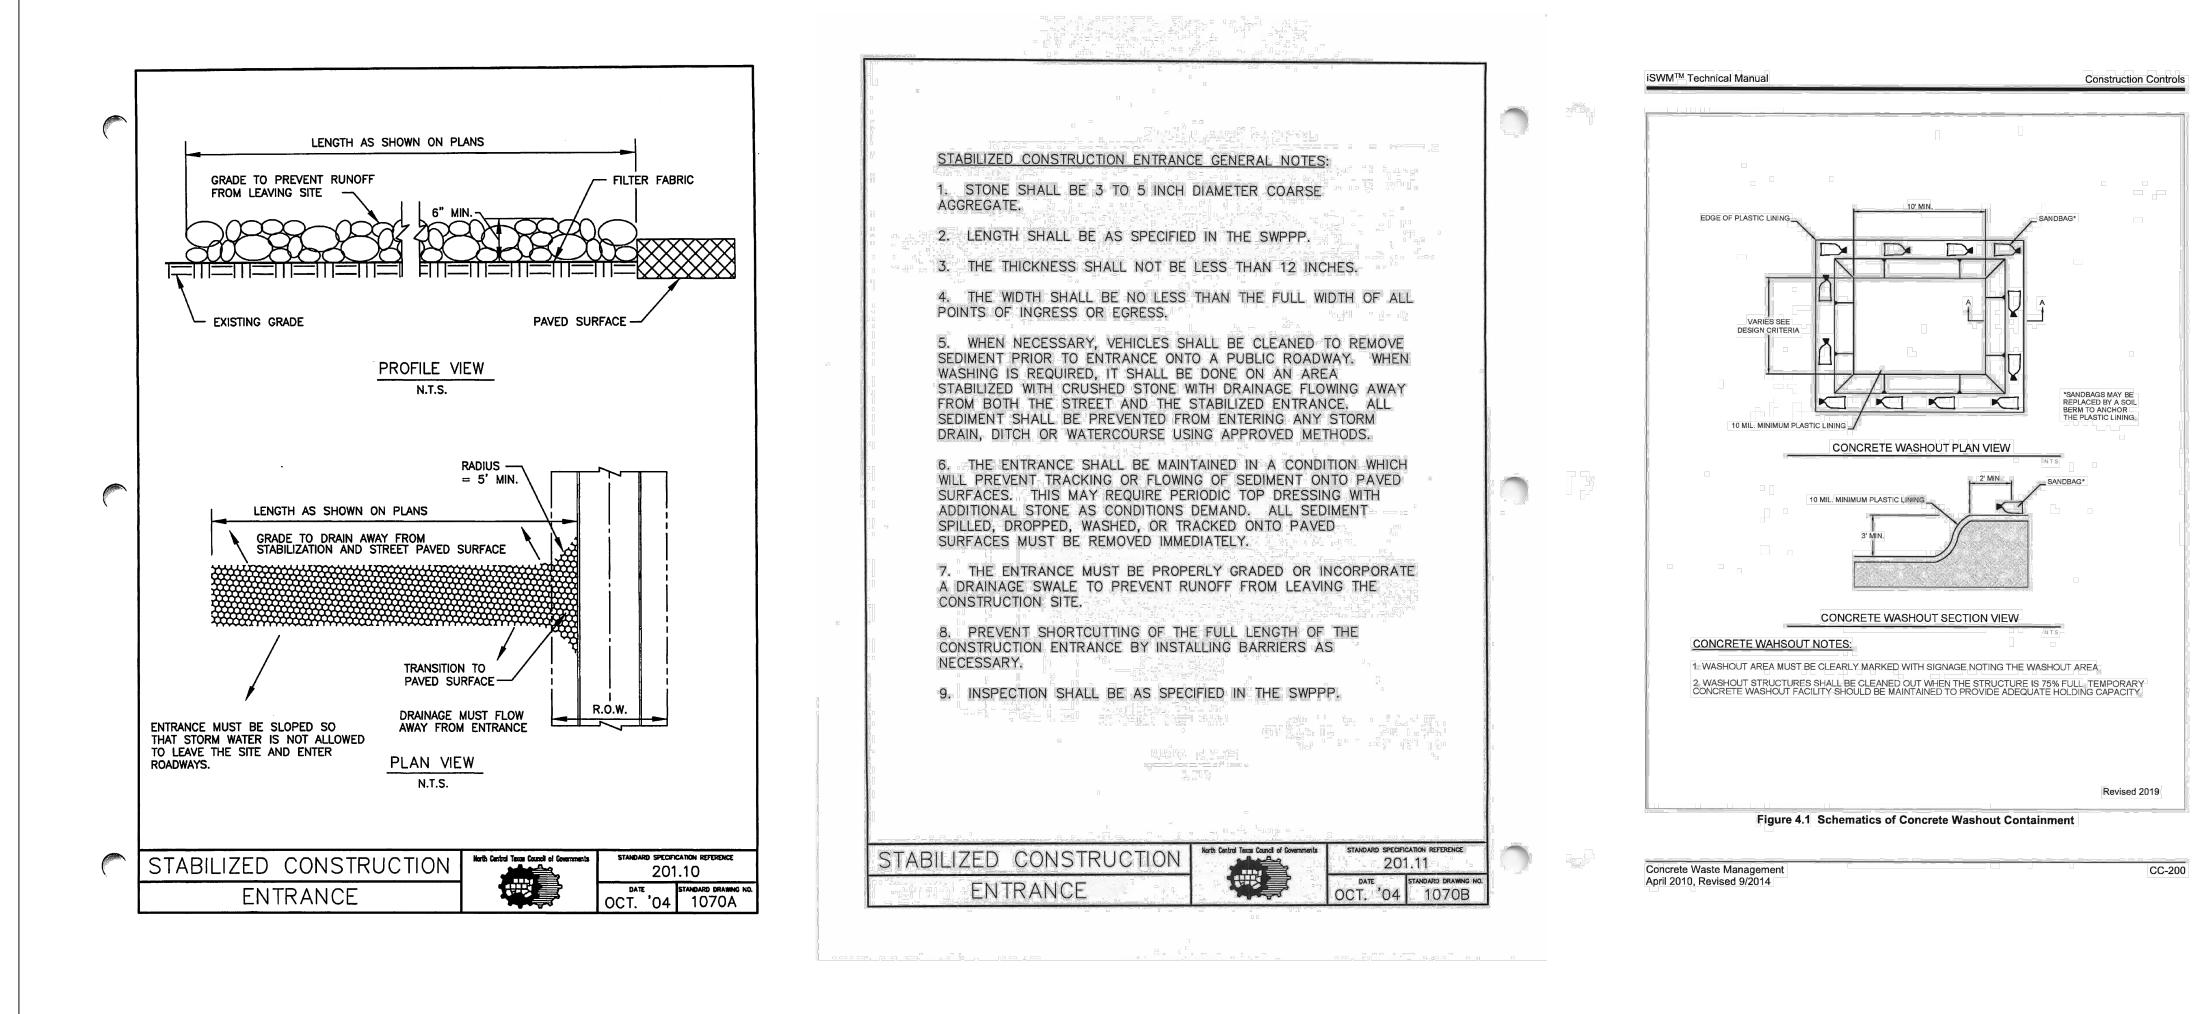
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Issued Date:	11/12/2024
Project No:	240117
Drawn By:	RP
Checked By:	IN
Designed By:	IN
Issue Rec	cord
# Description	Date


# **EROSION CONTROL**








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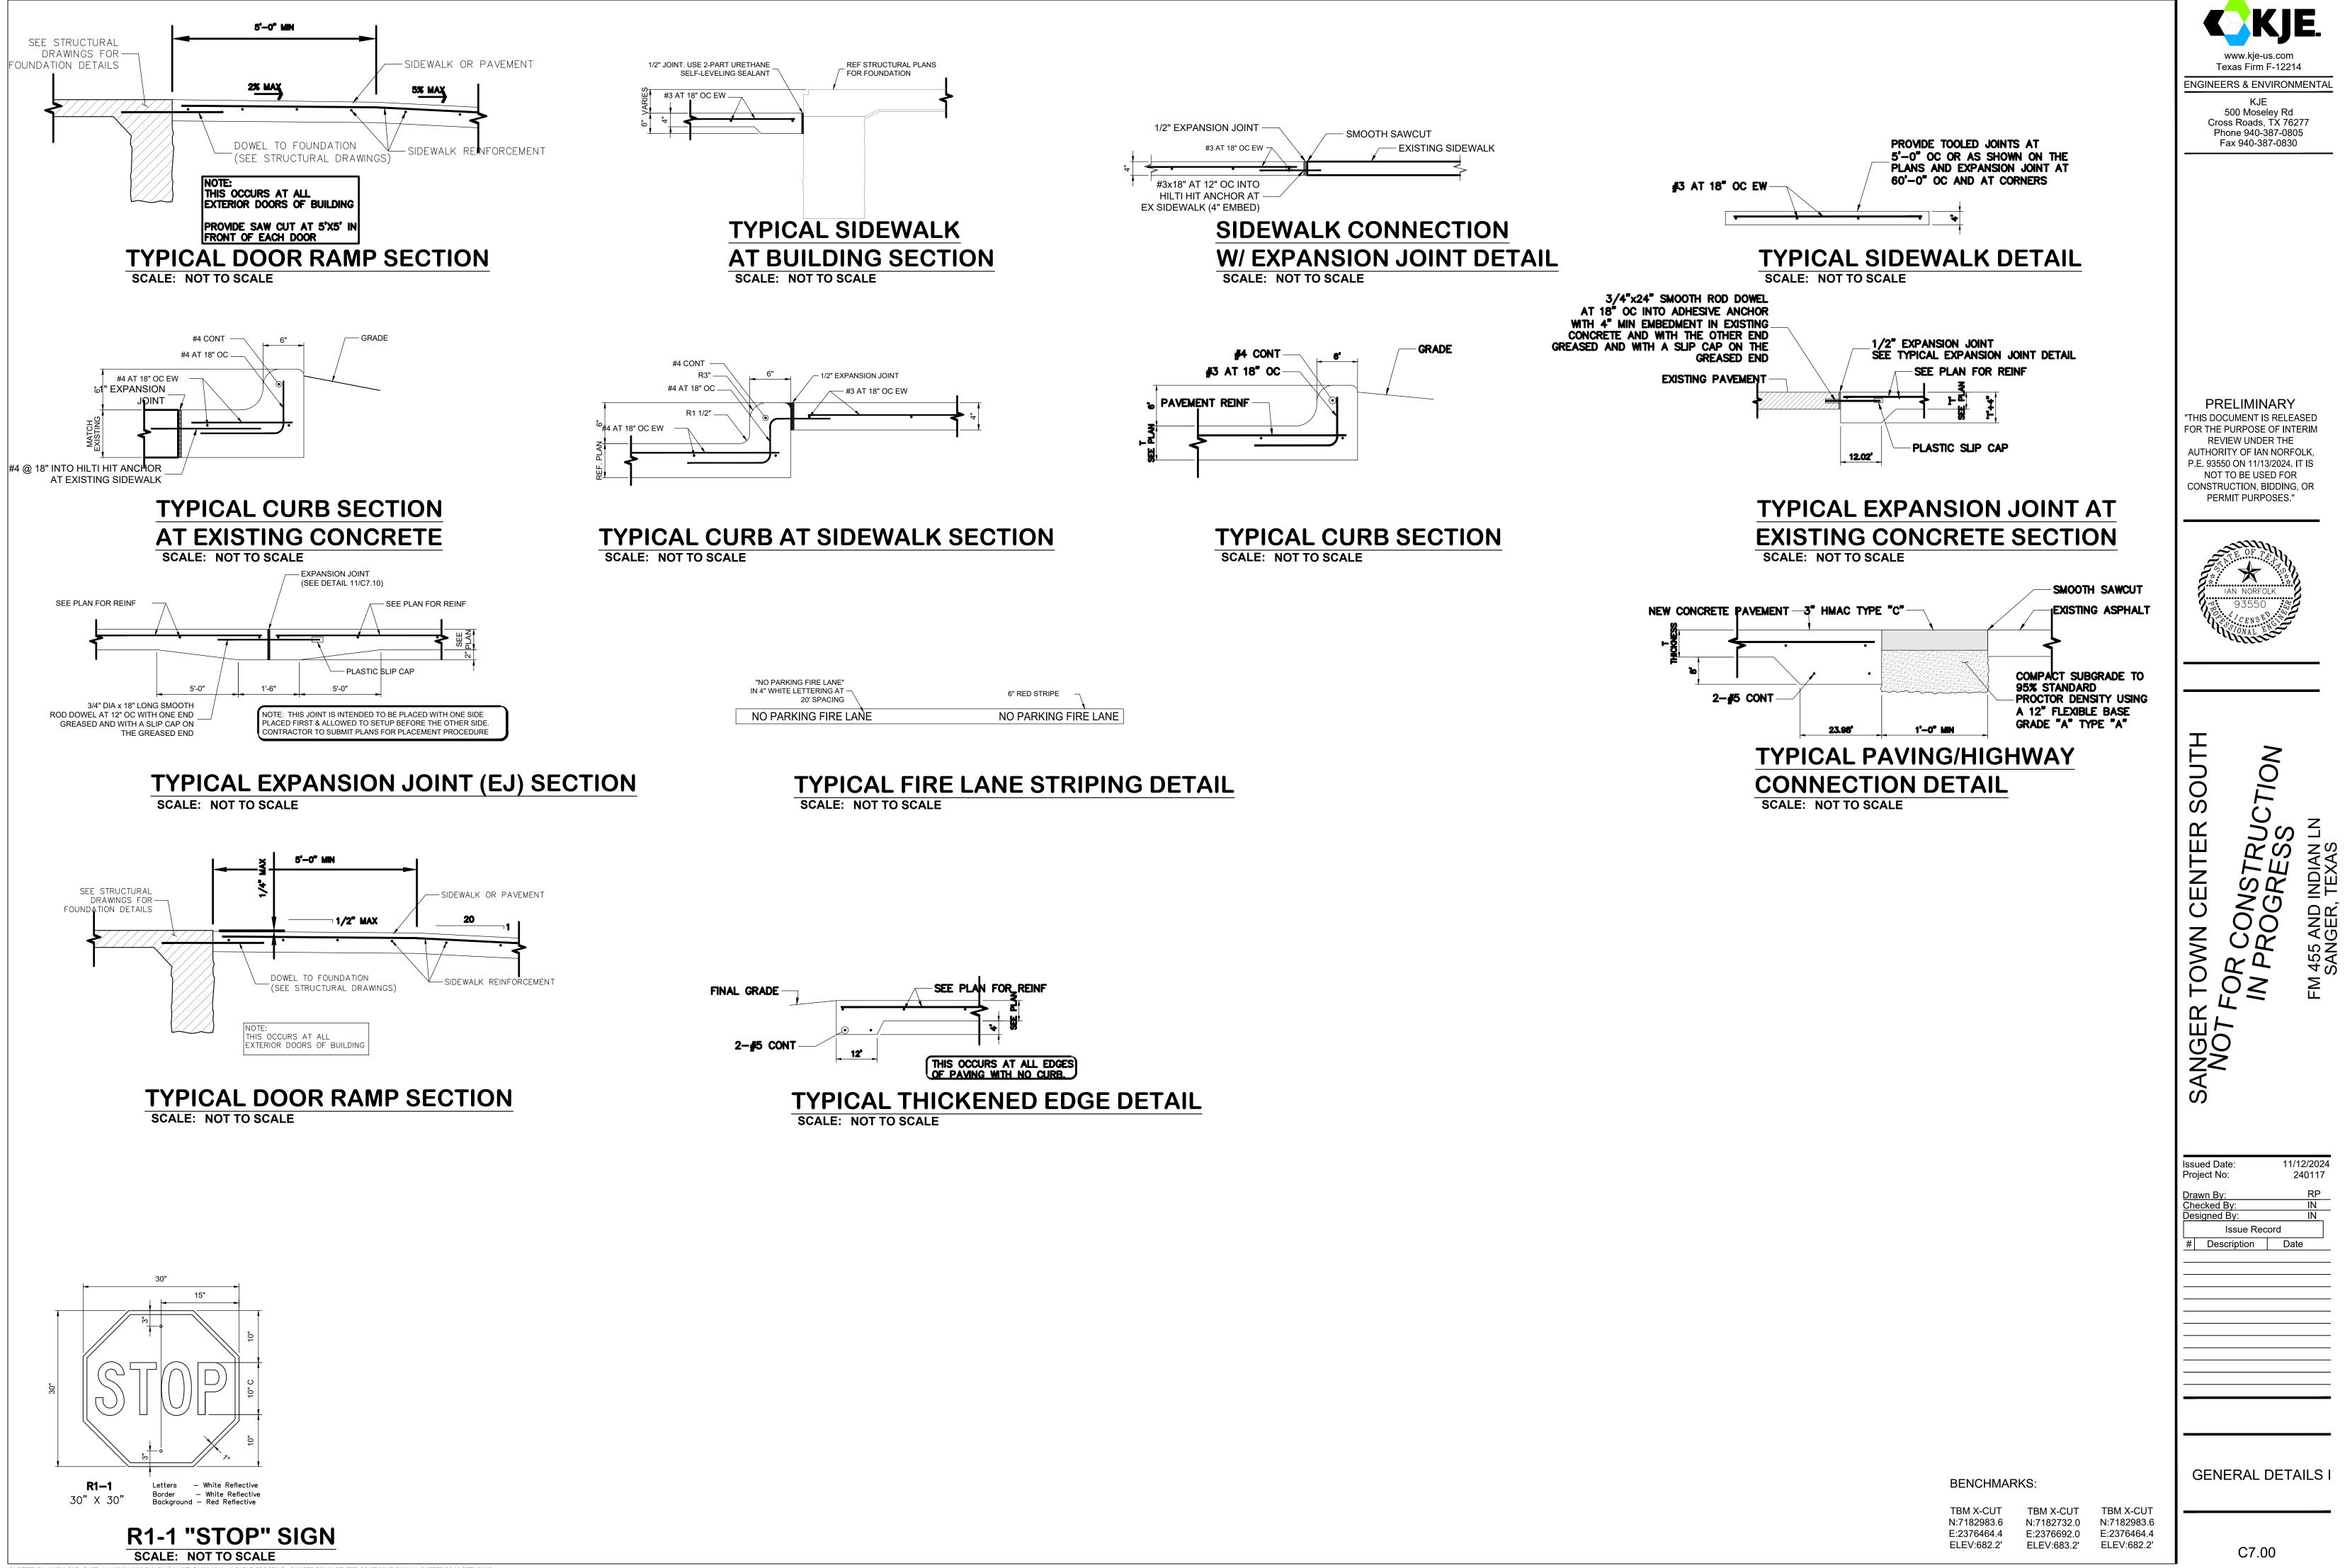
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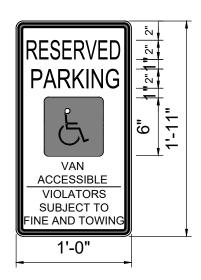
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'NO PARKING FIRE LANE" 4" WHITE LETTERING AT 20' SPACING	6" RED STRIPE
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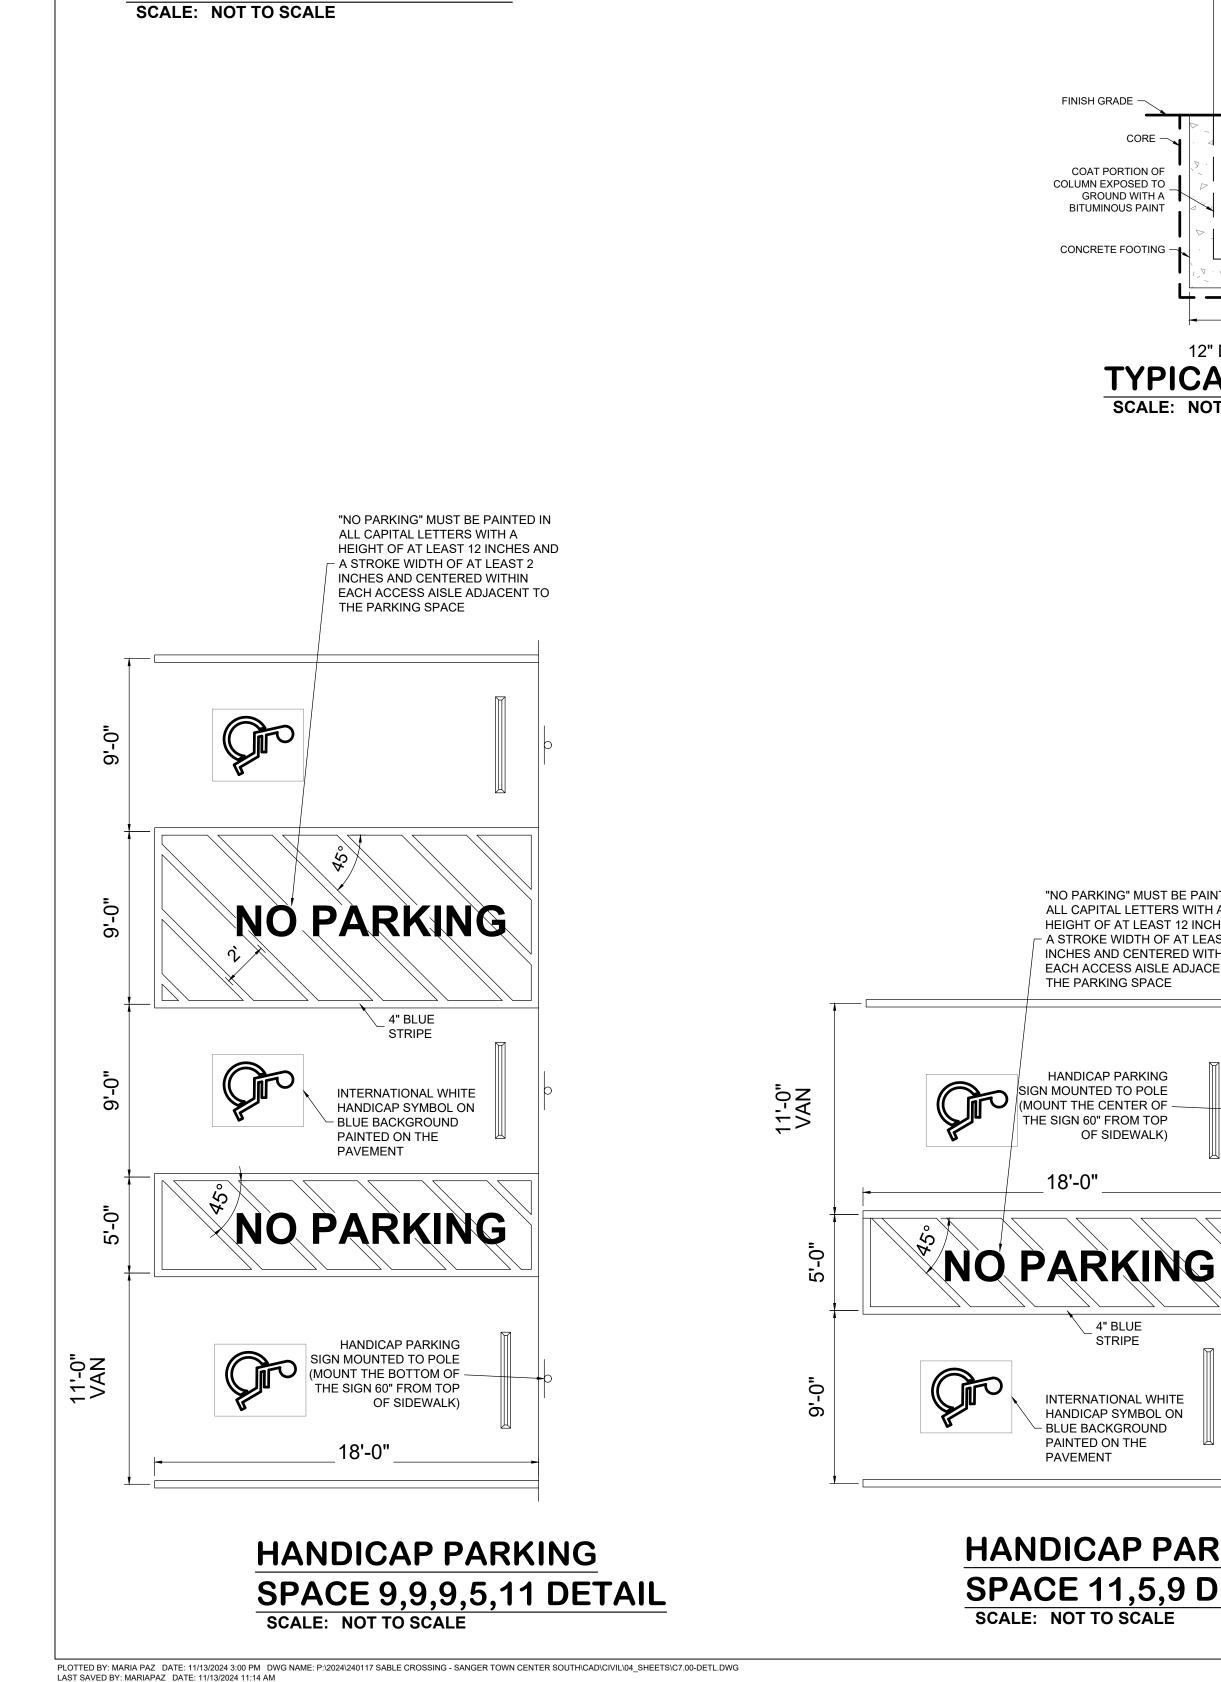
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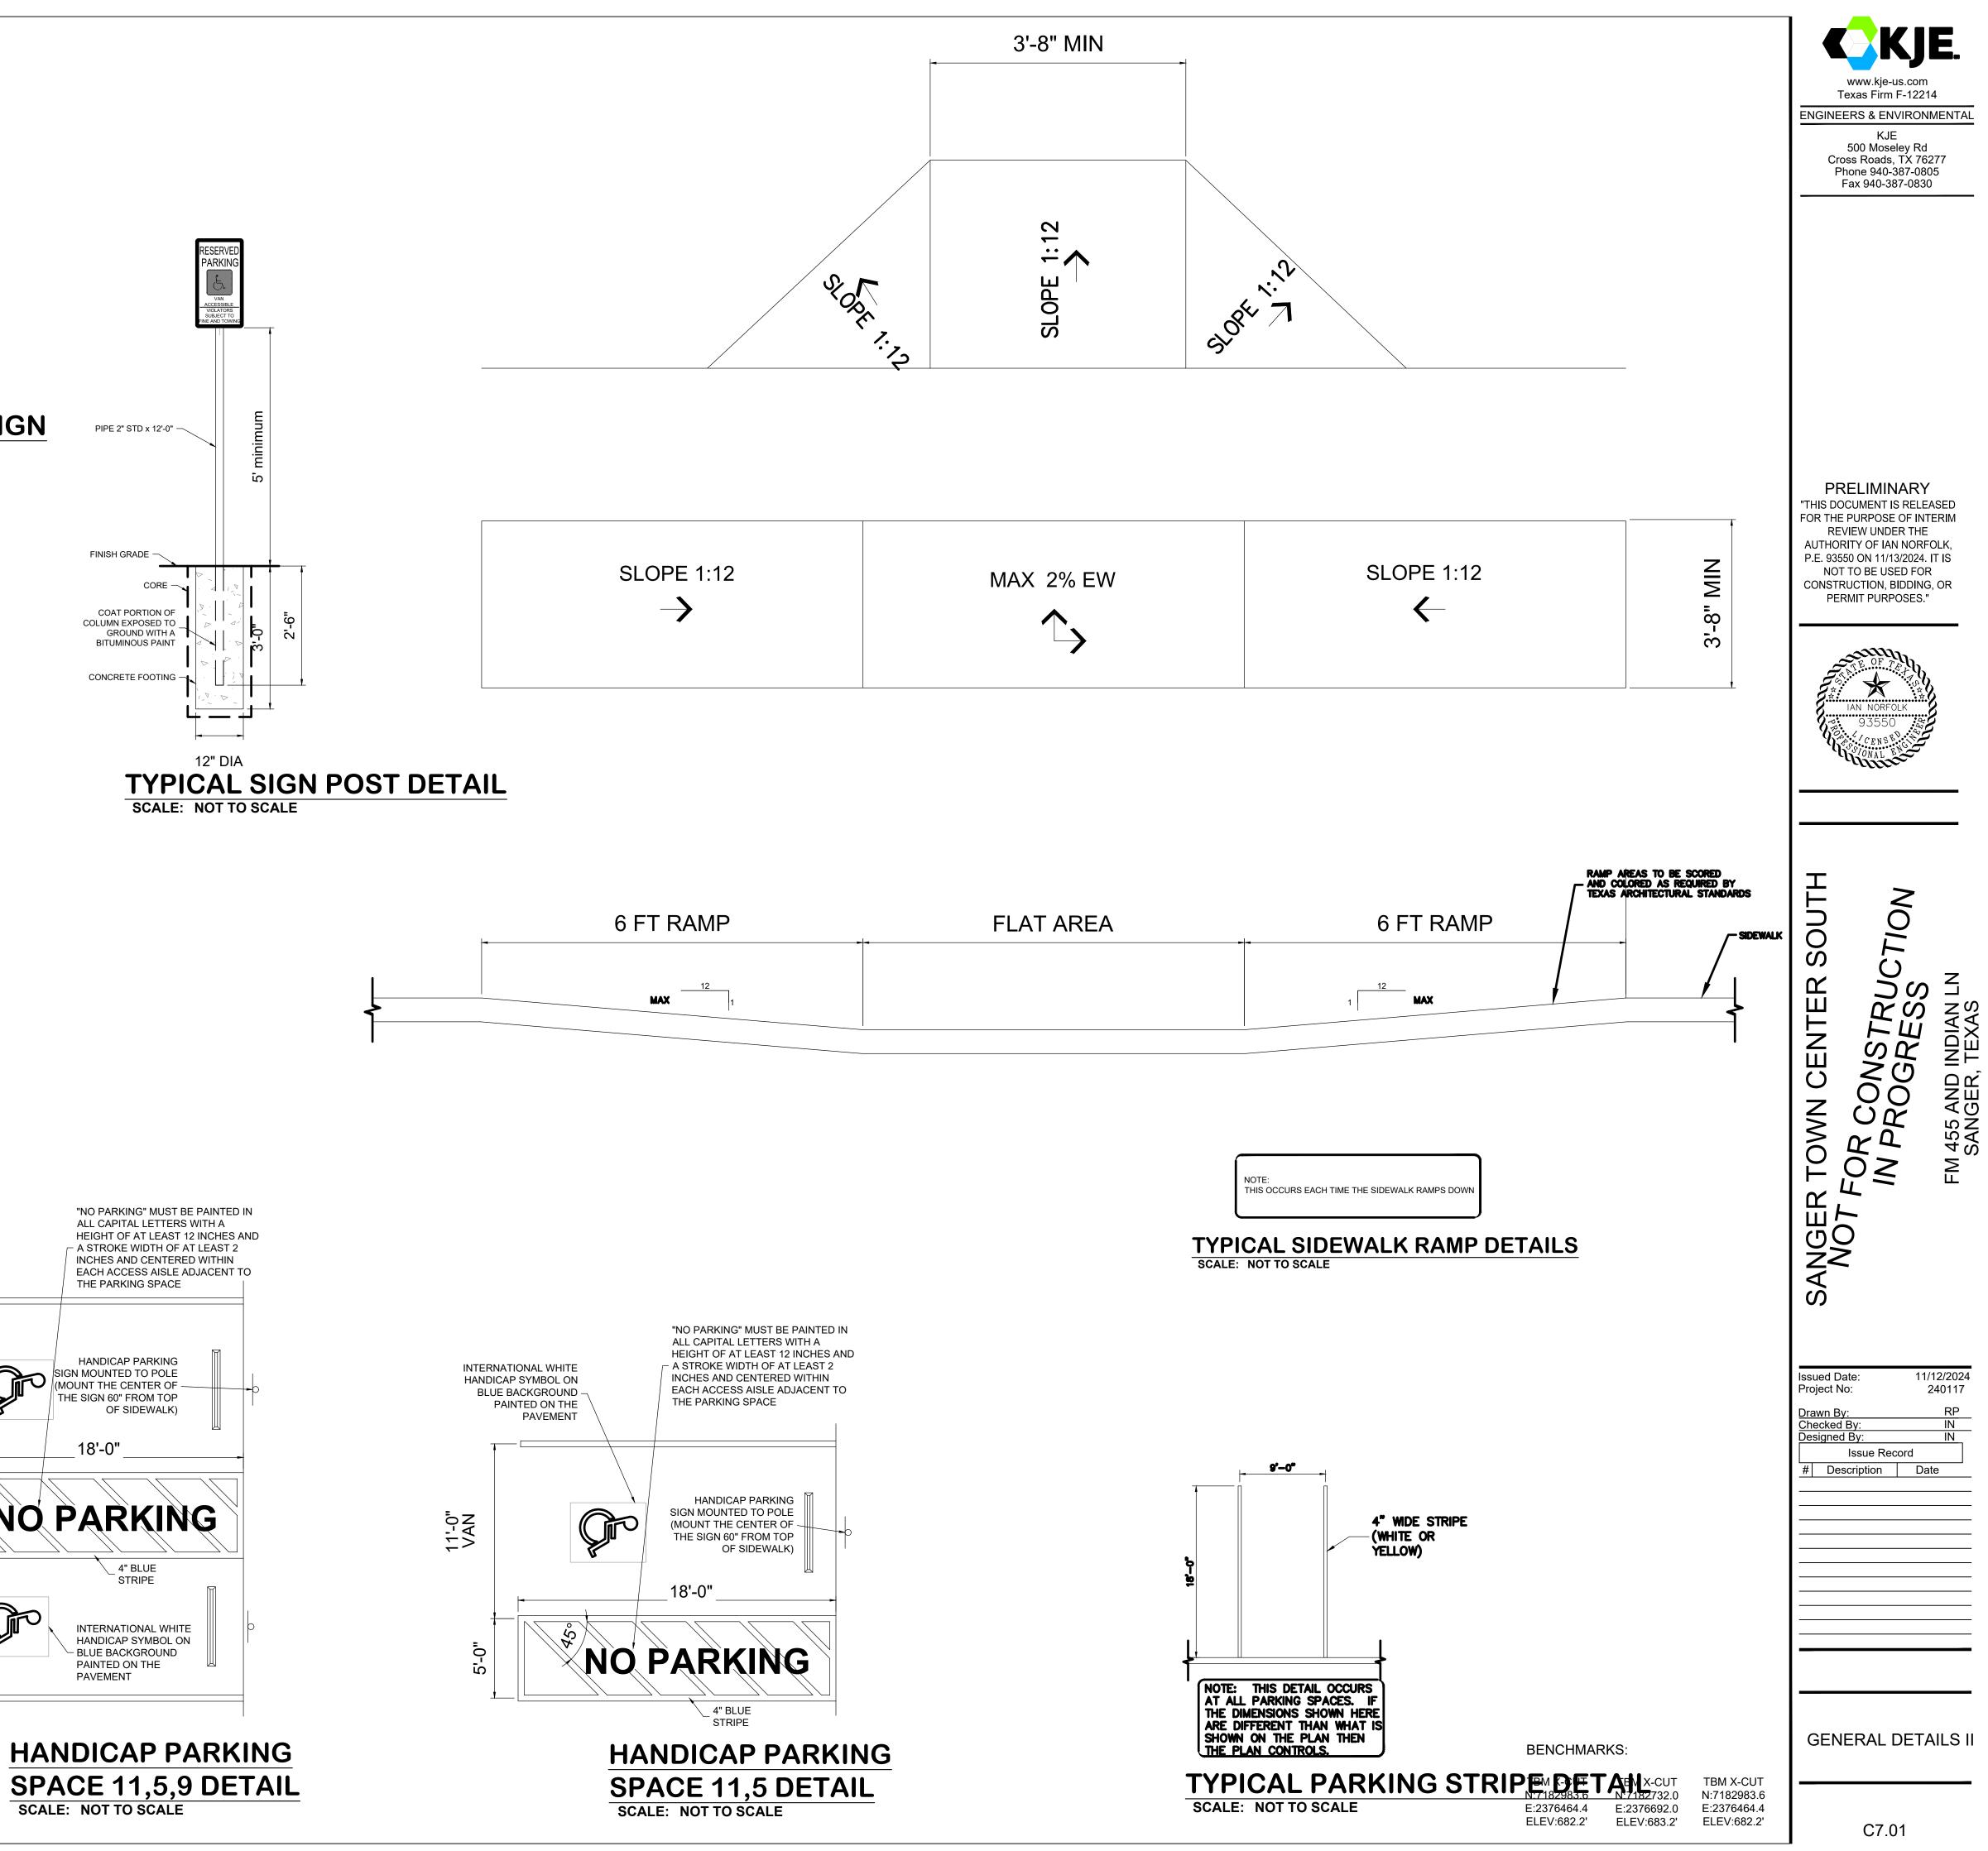


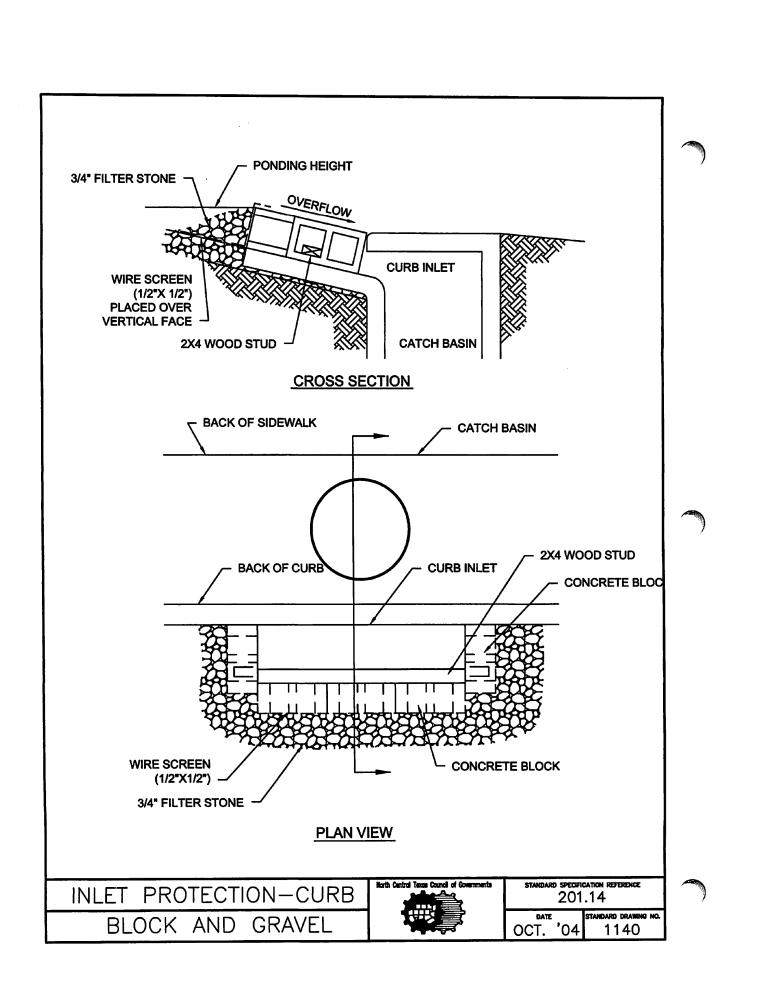
# **RESERVED PARKING W/ VAN ACCESSIBLE SIGN**

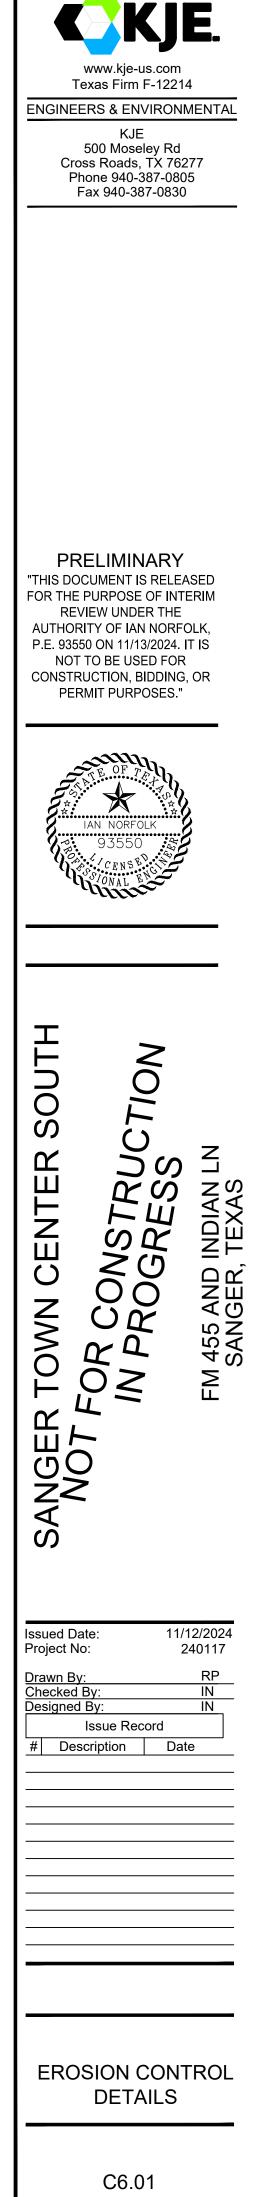


# **RESERVED PARKING SIGN** SCALE: NOT TO SCALE





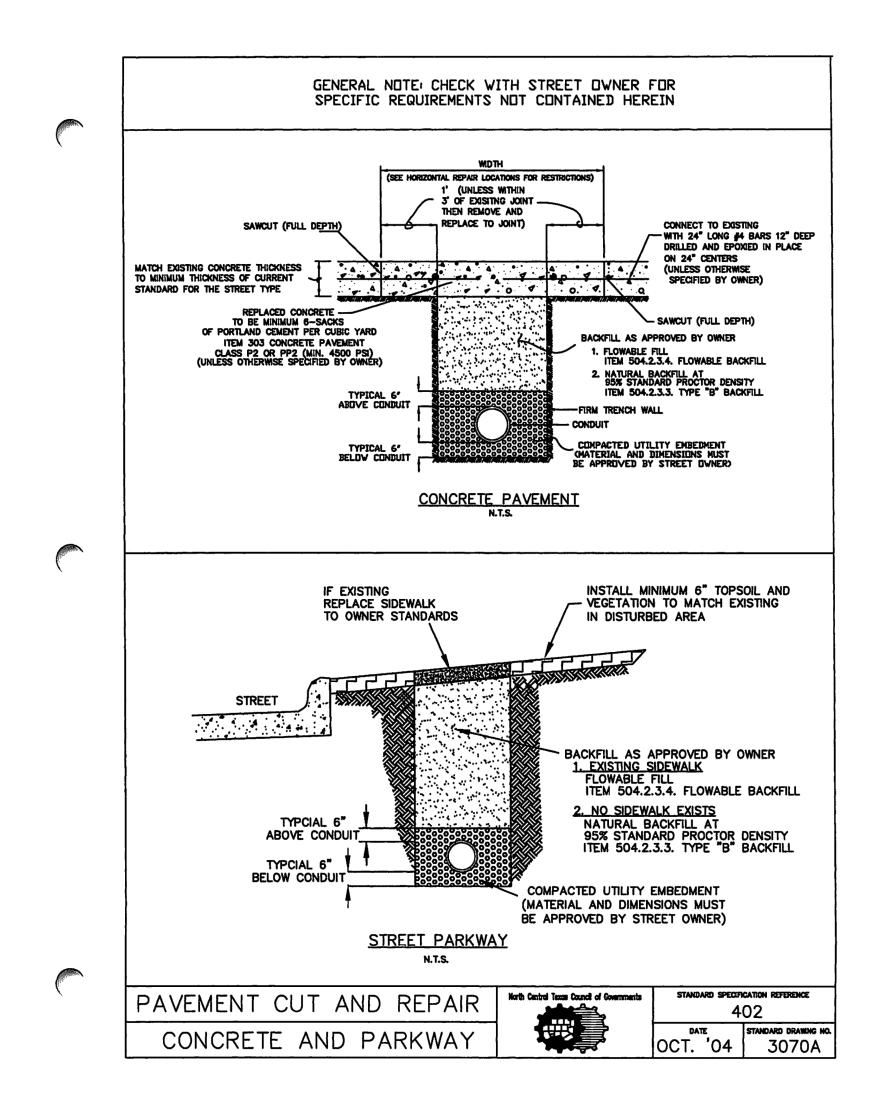

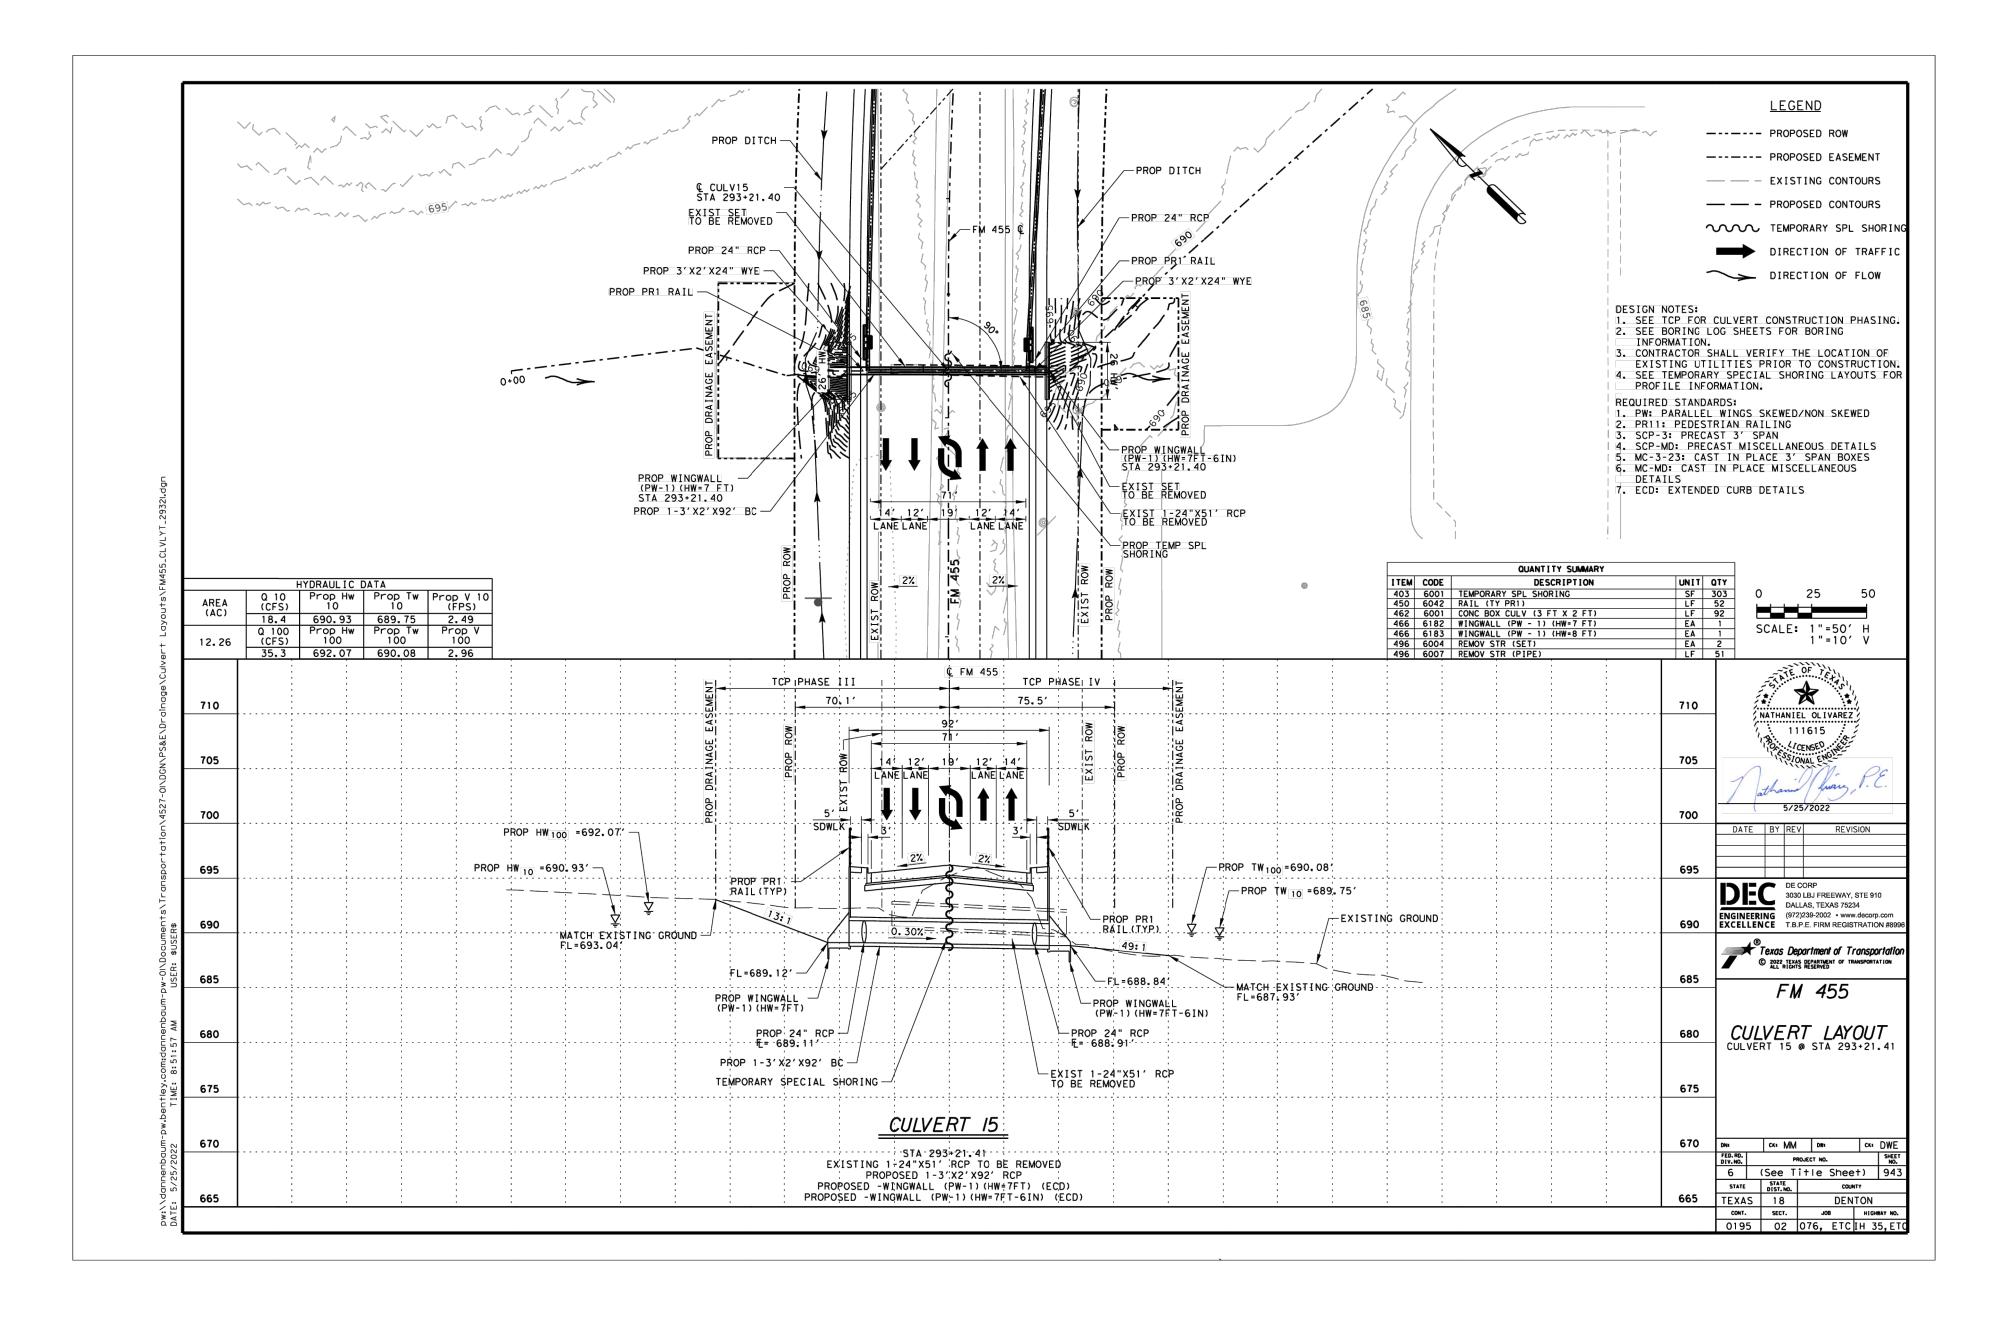





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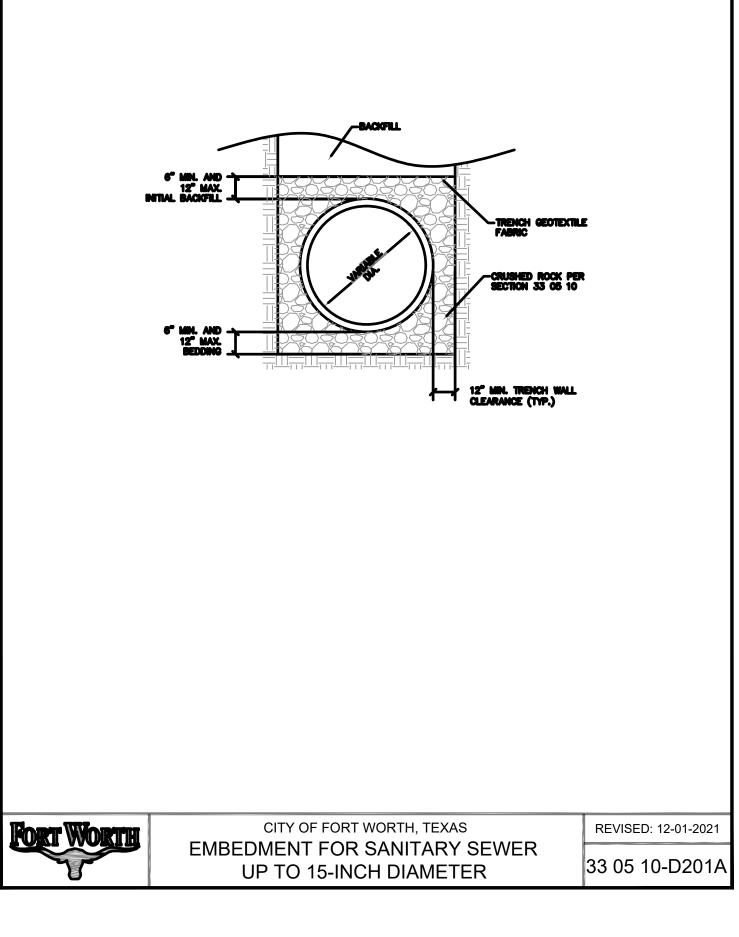
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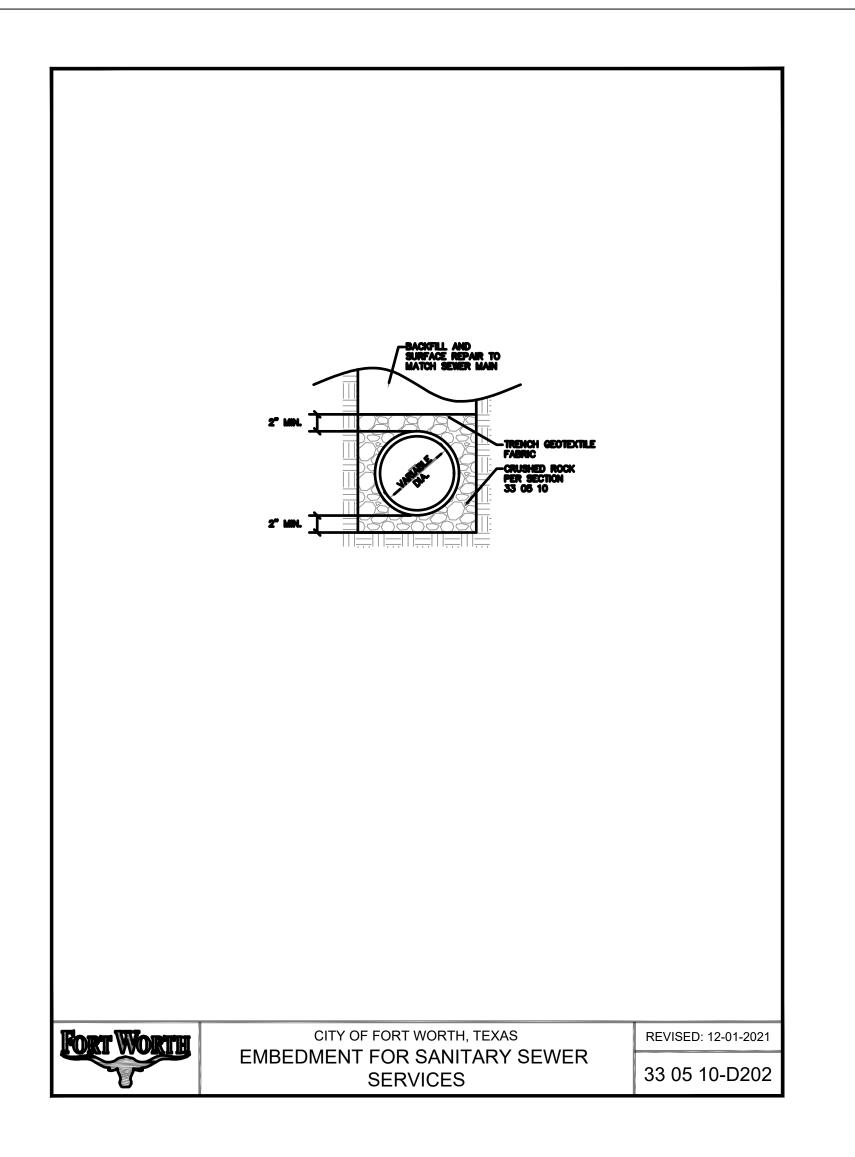
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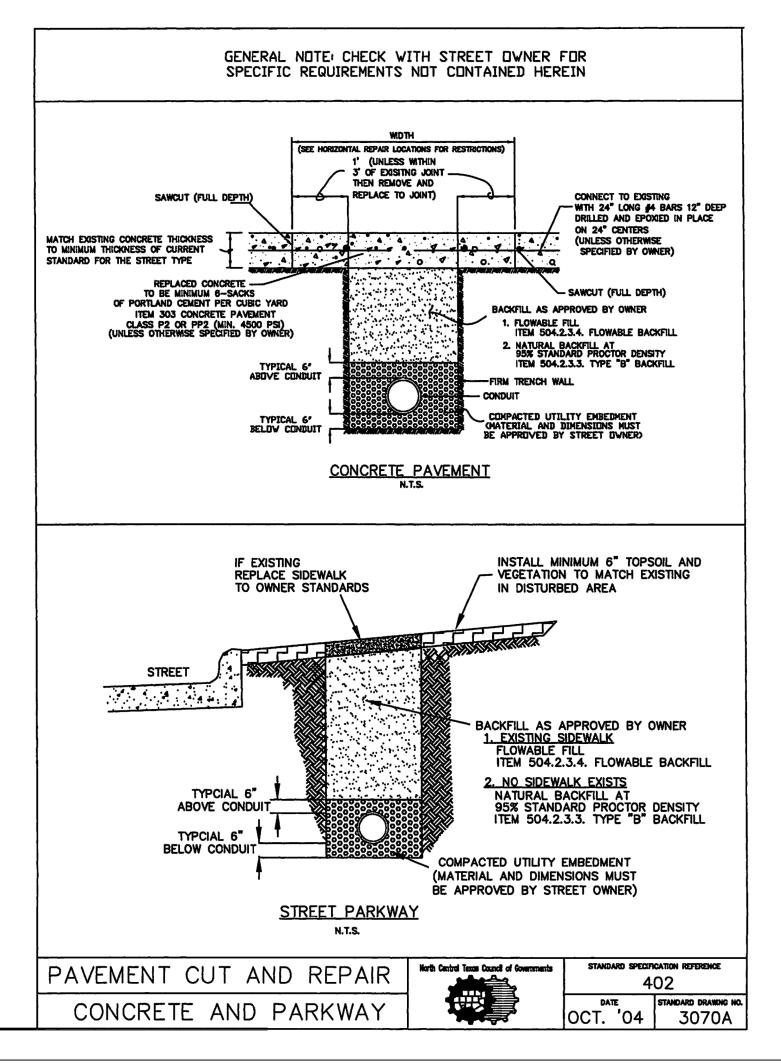
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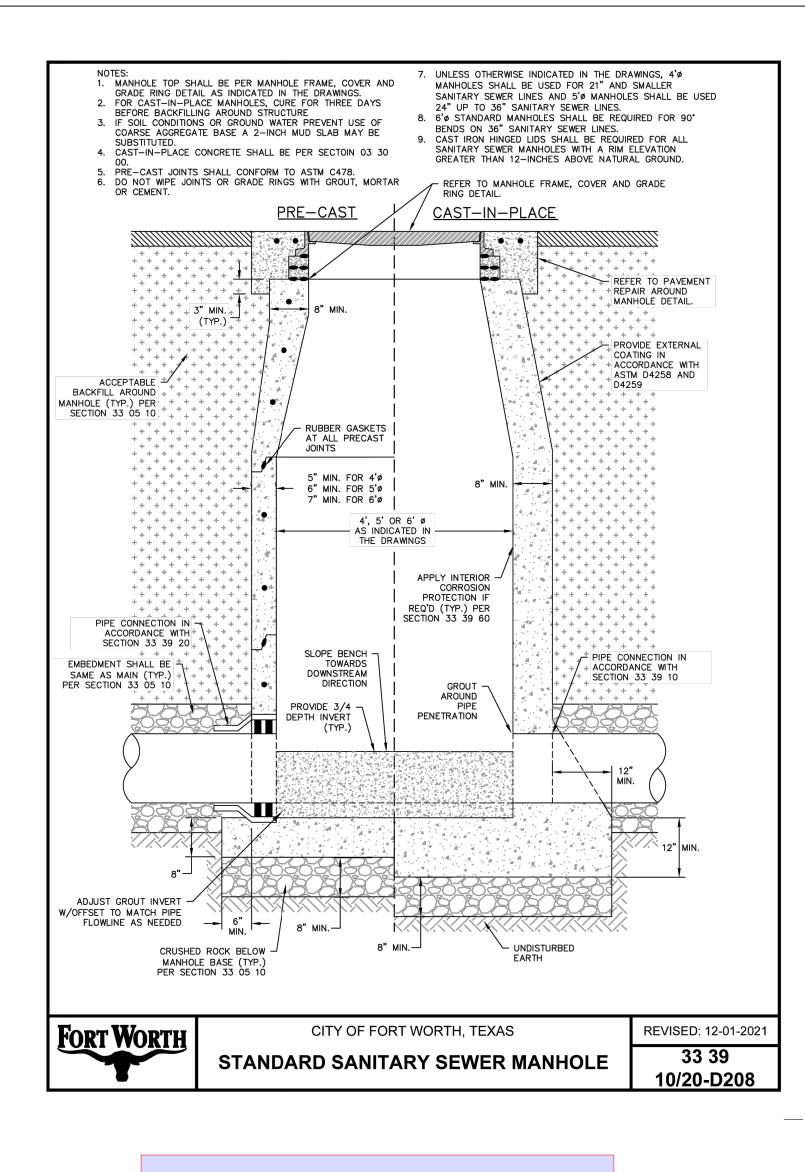









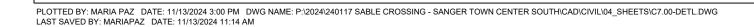

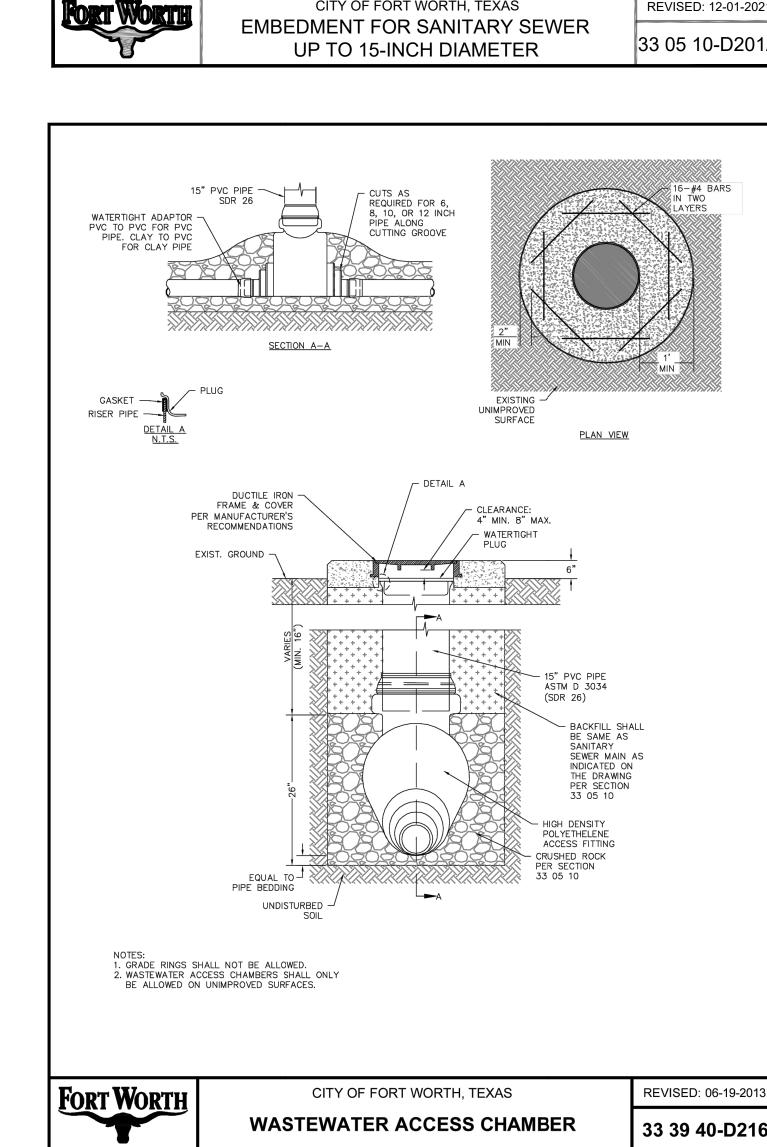

Please reference latest NCTCOG standard specifications for public works construction for all improvements under the jurisdictions of the City of Sanger ordinances

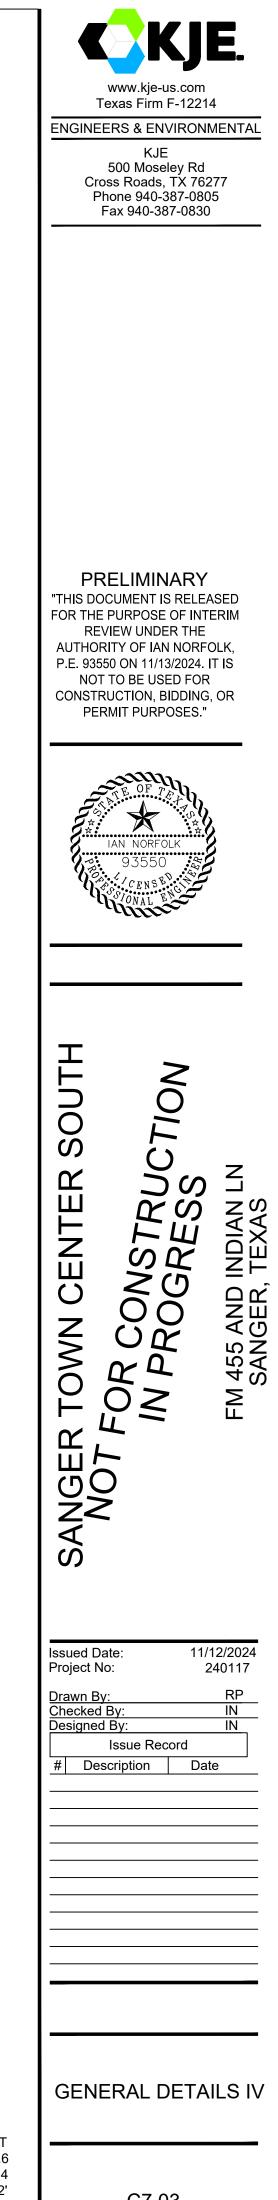


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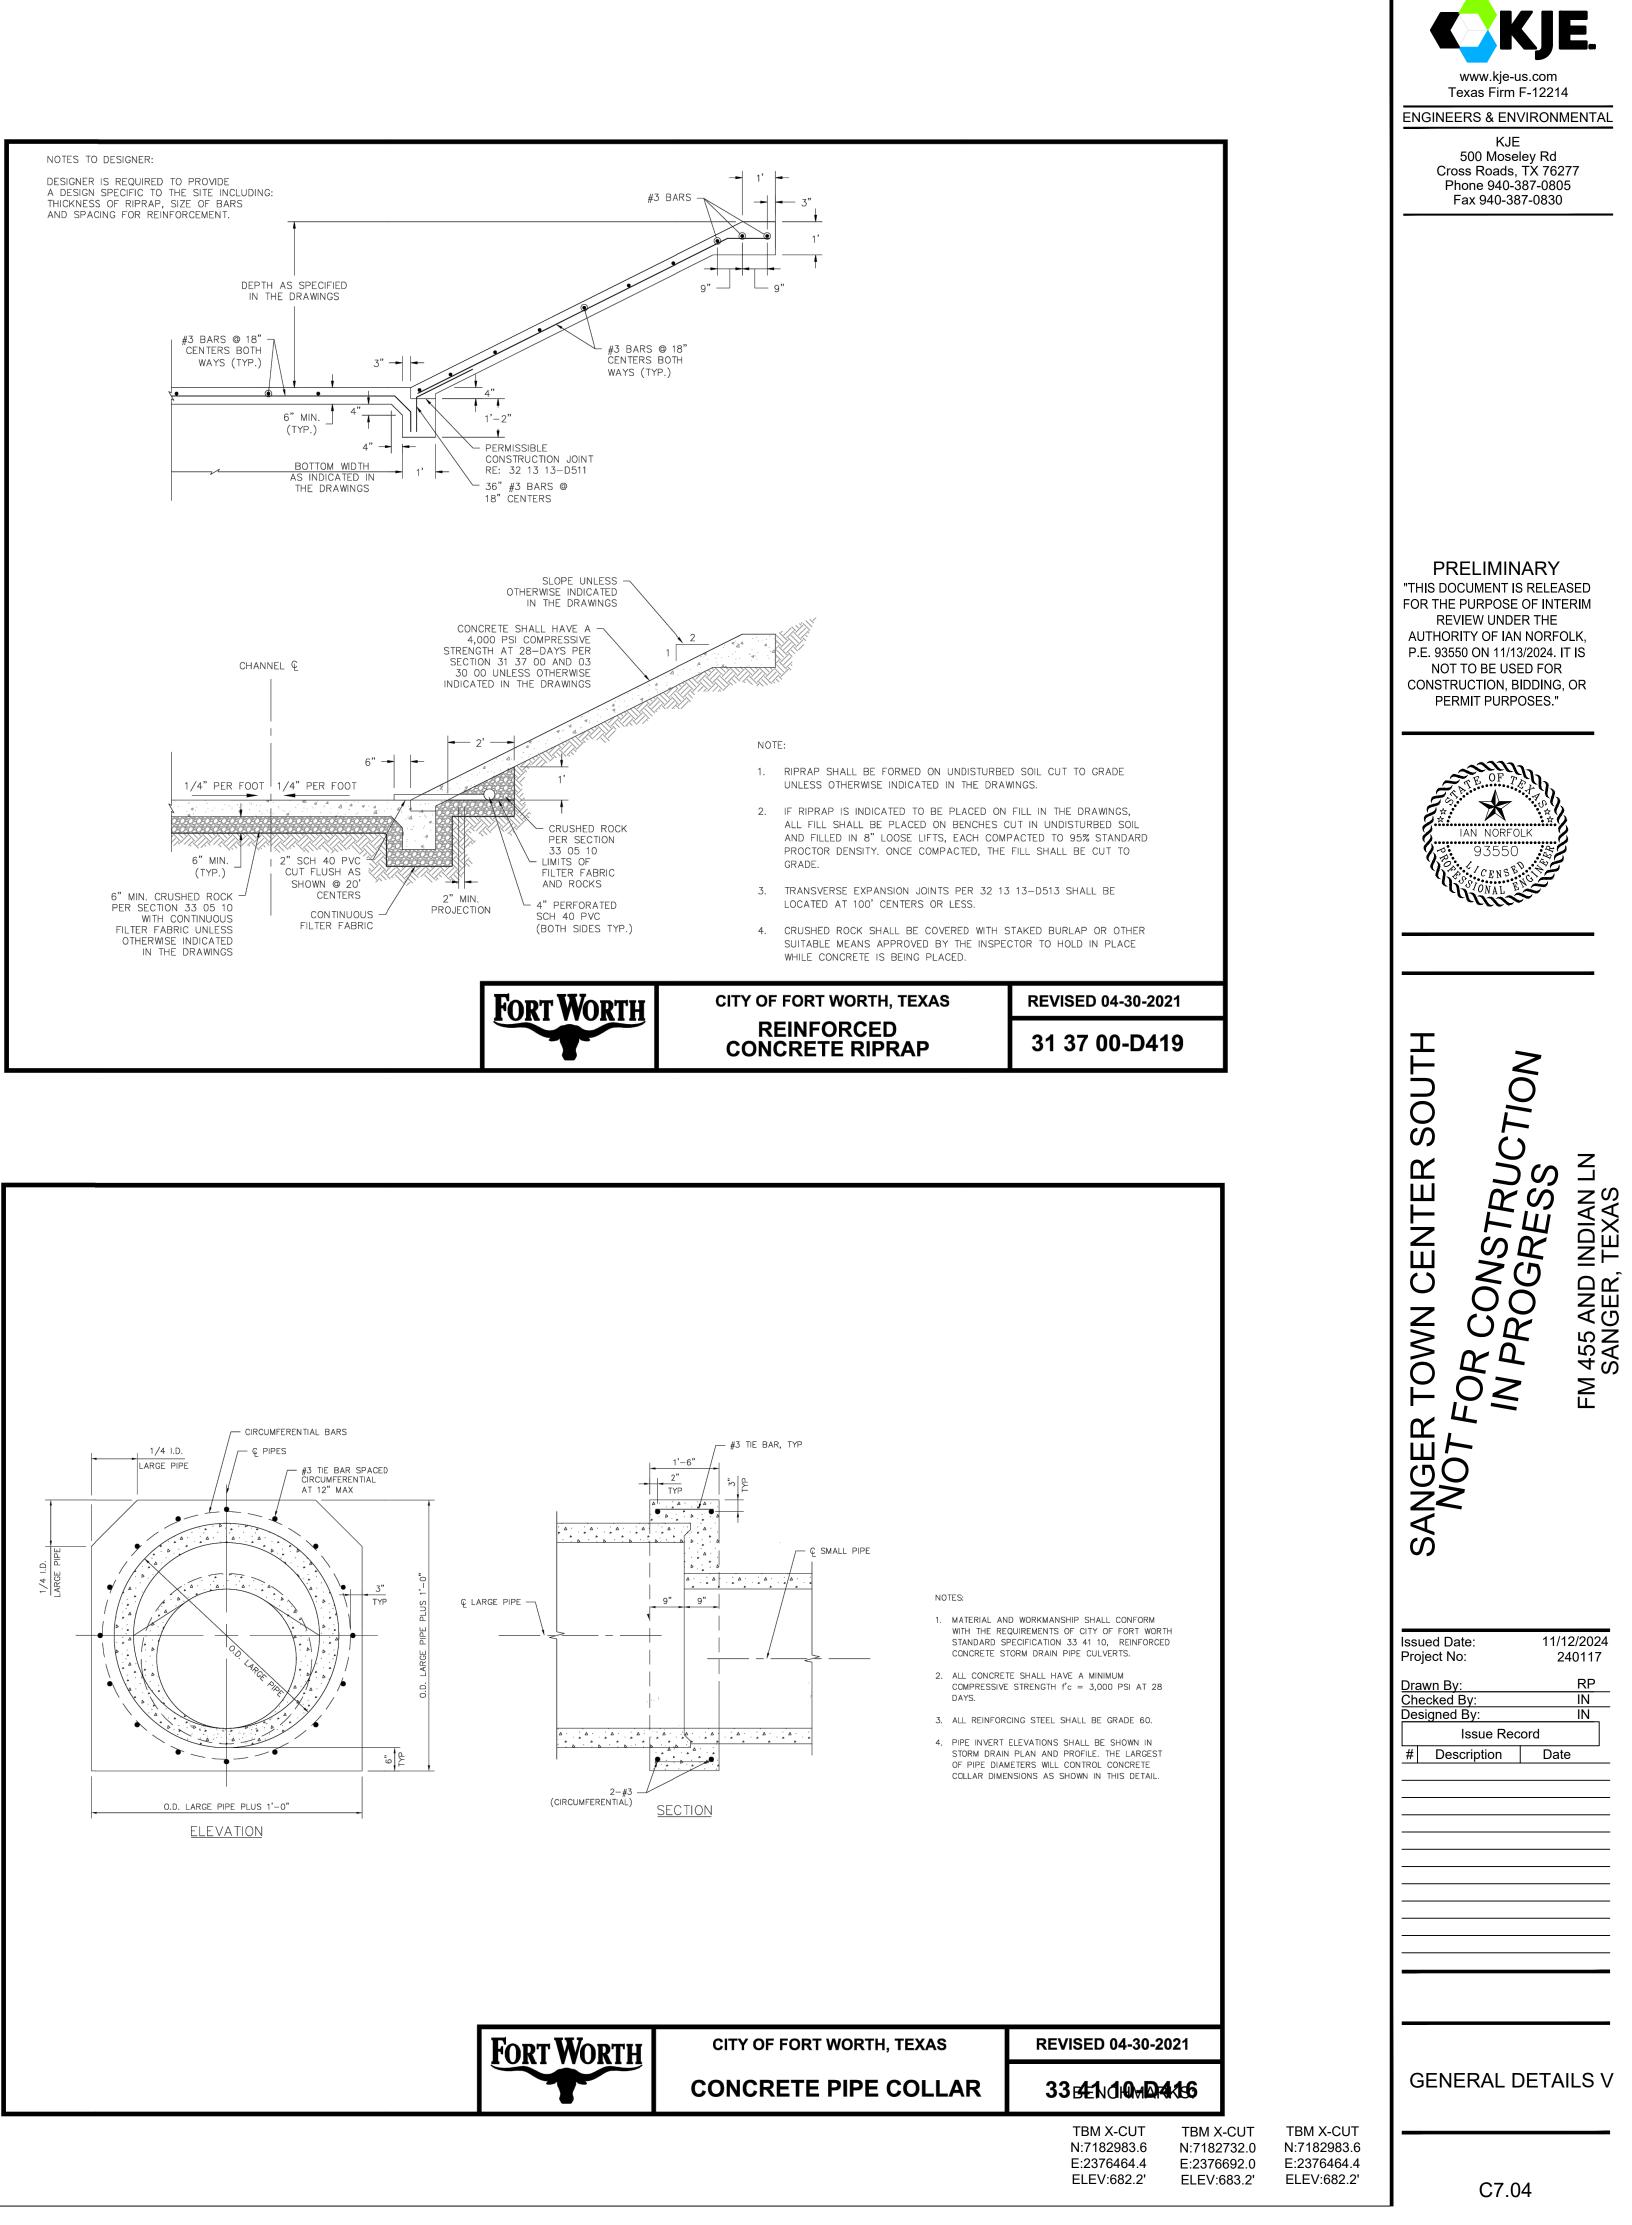
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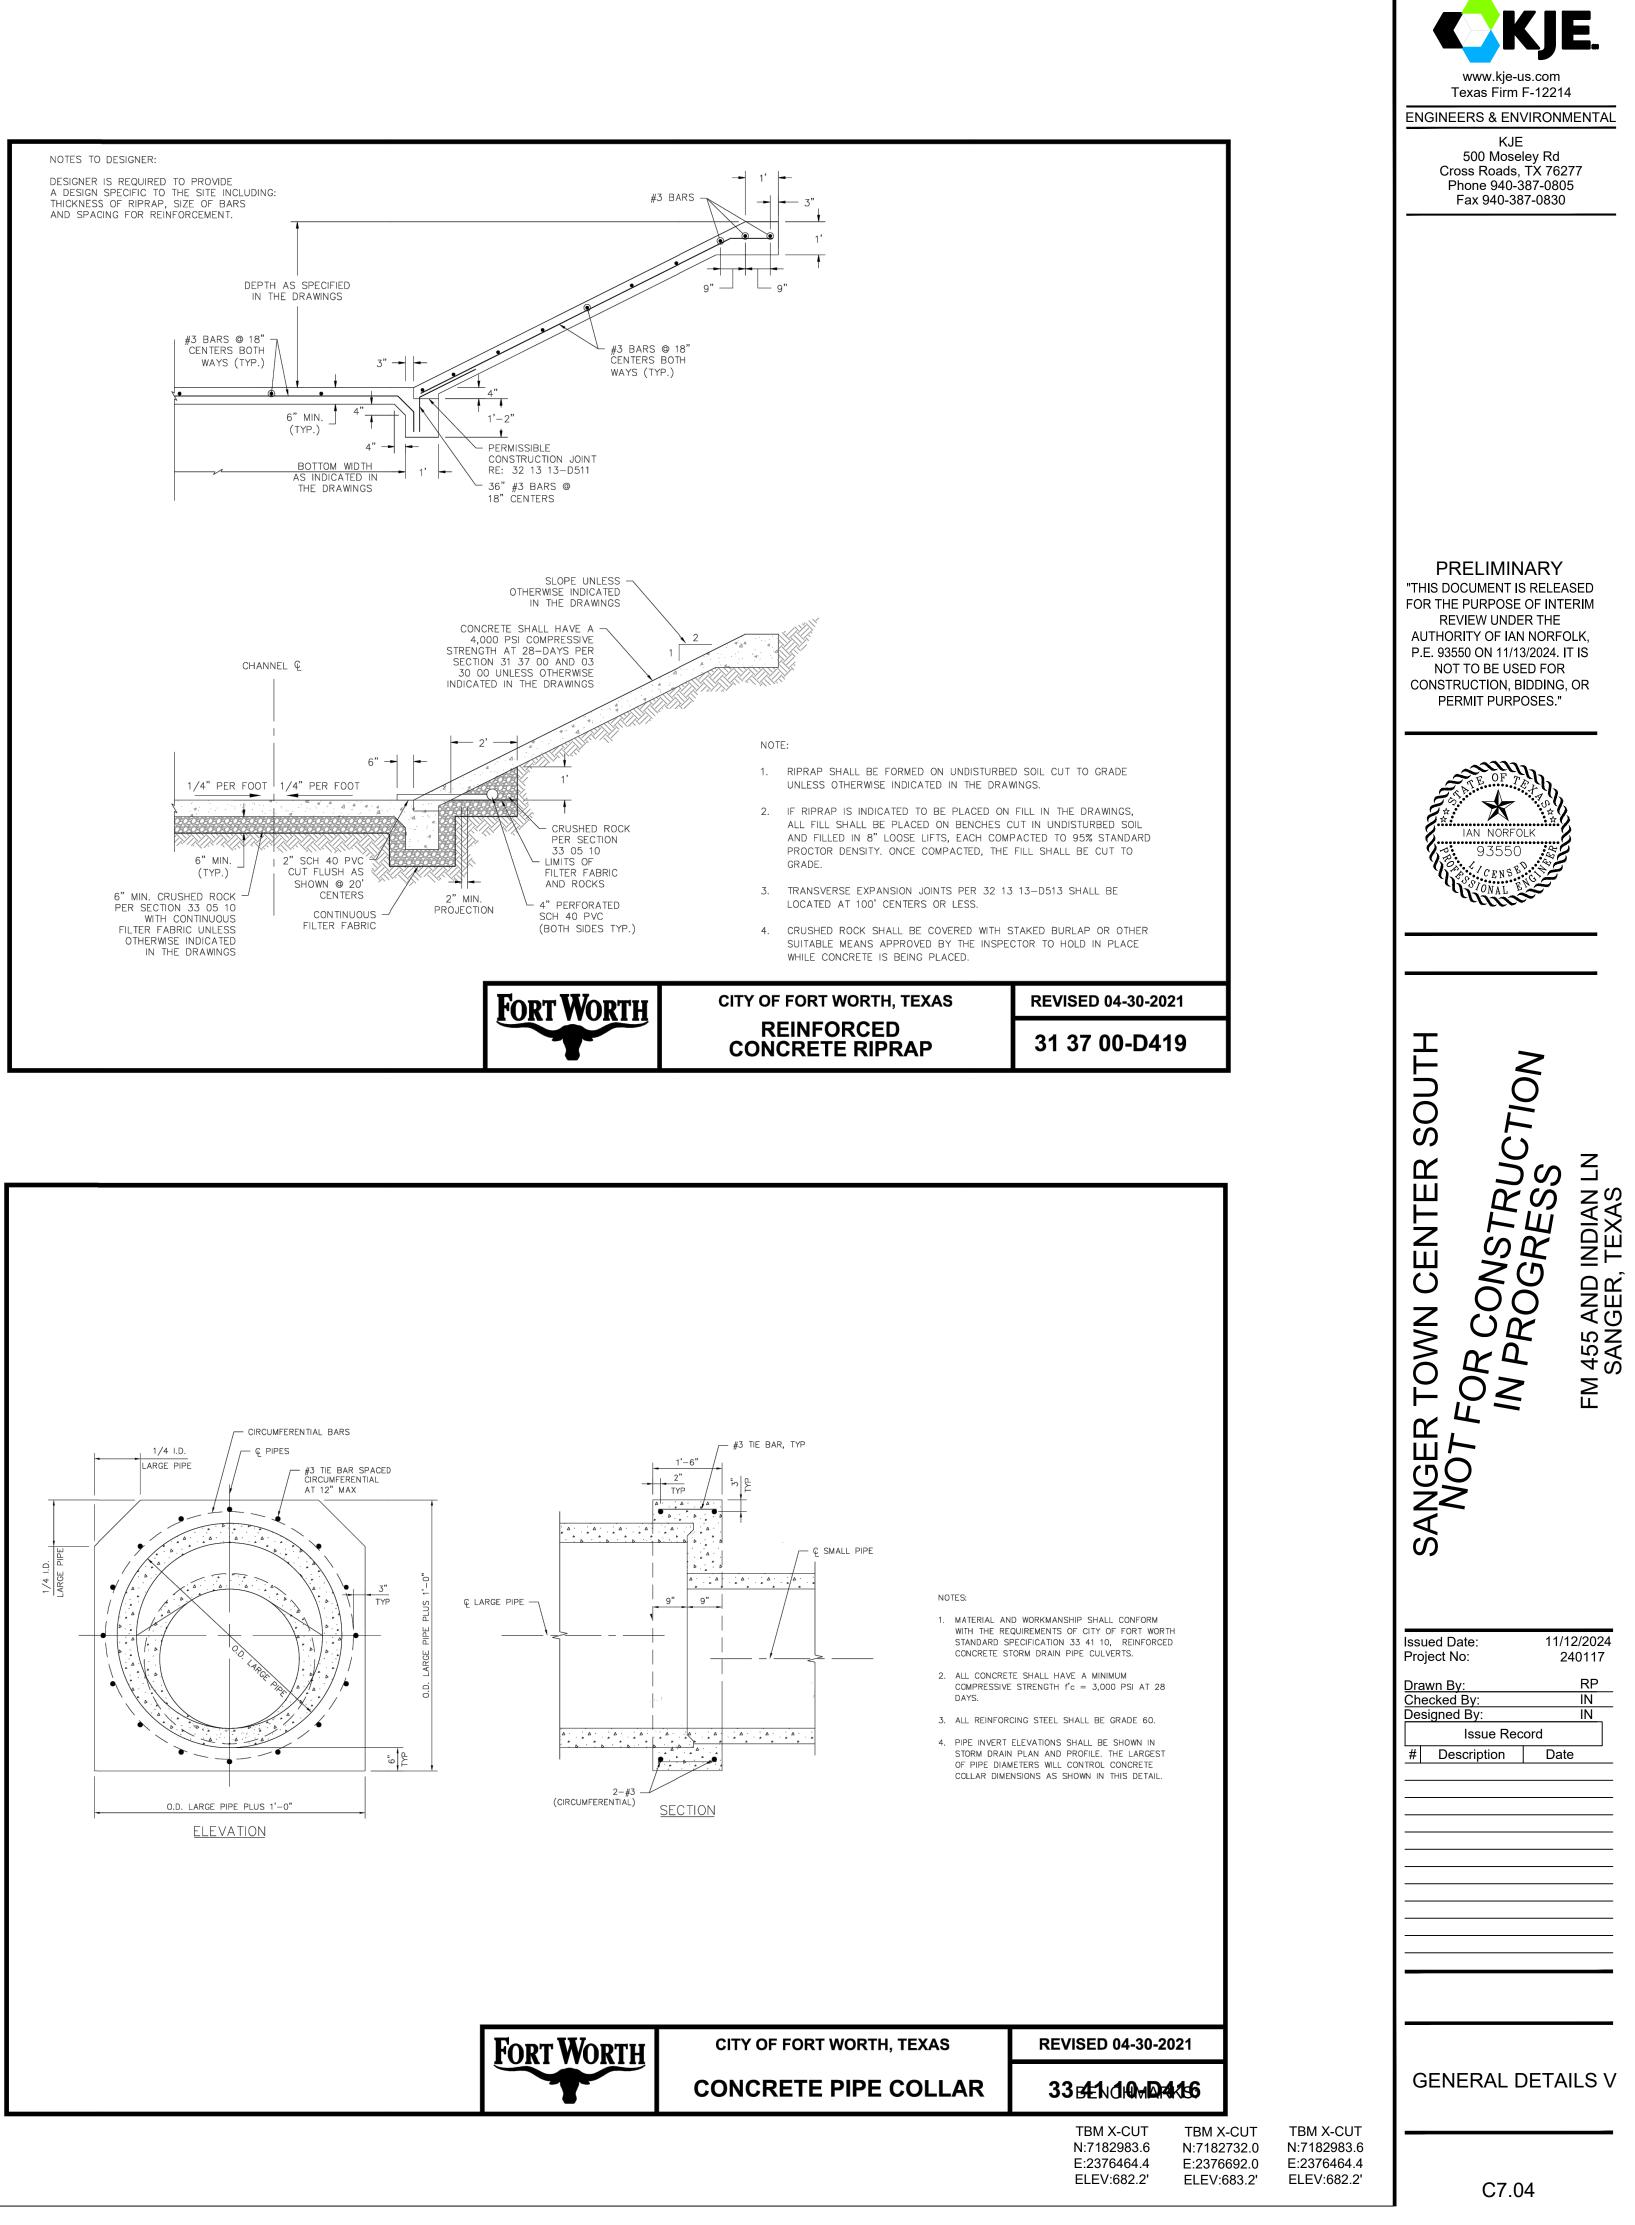
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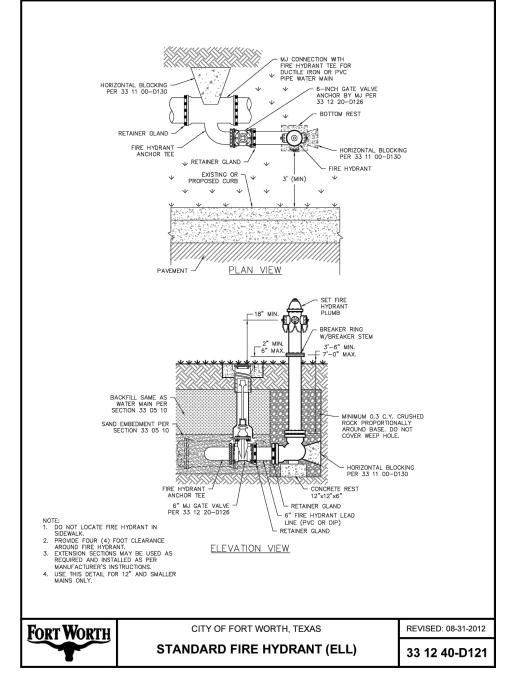



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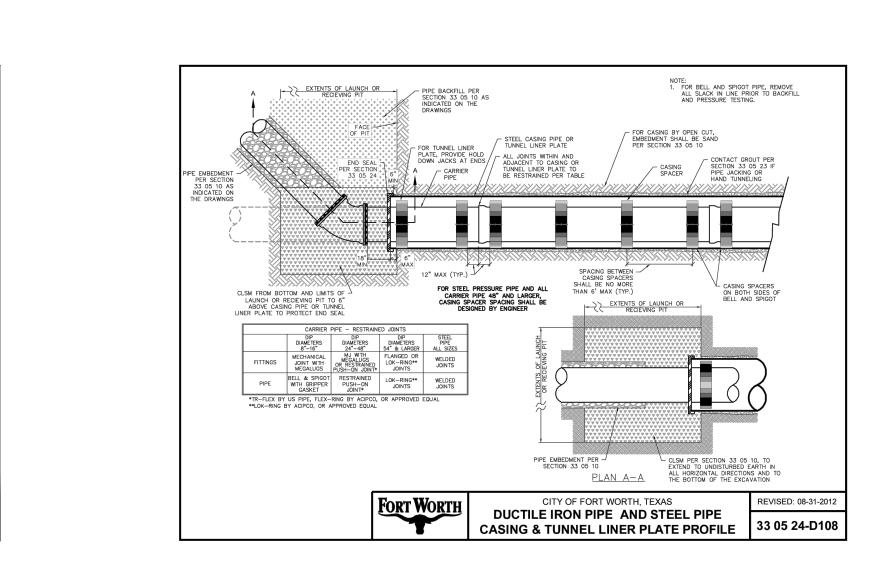








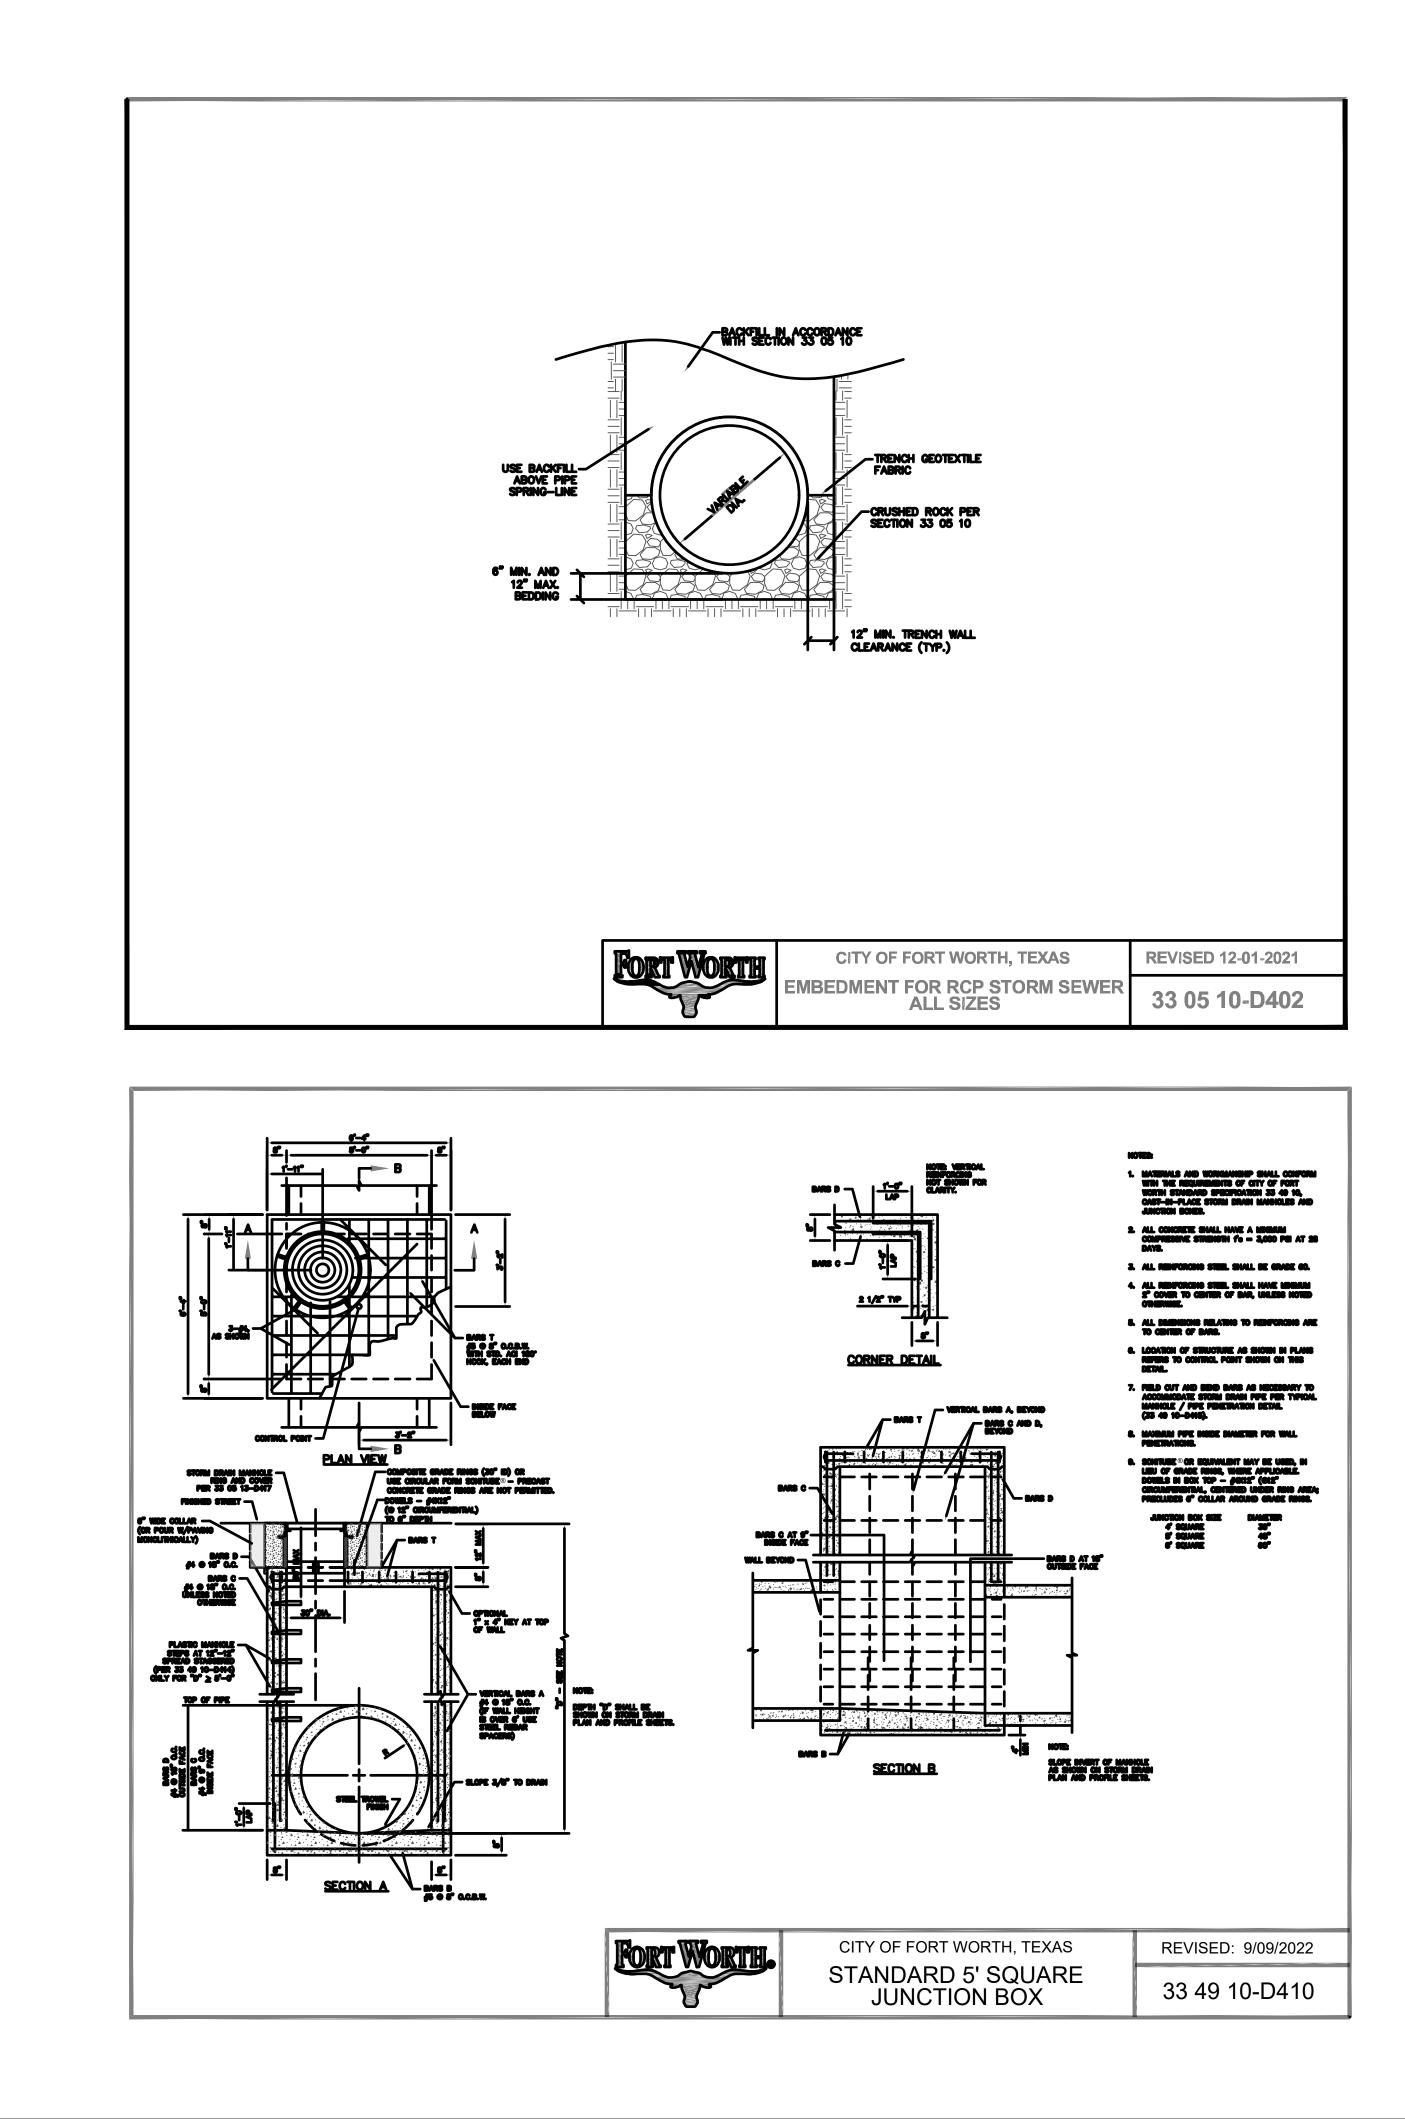



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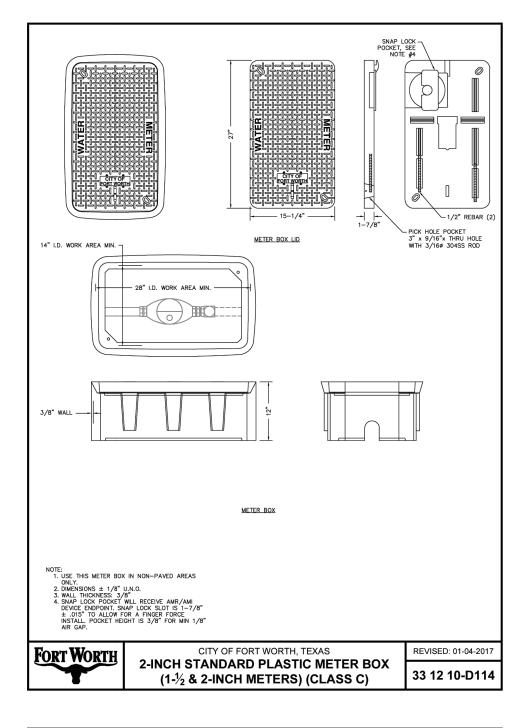
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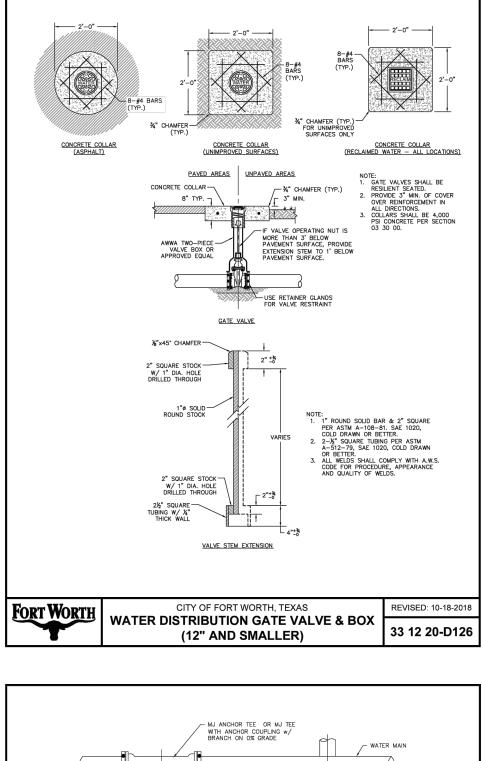
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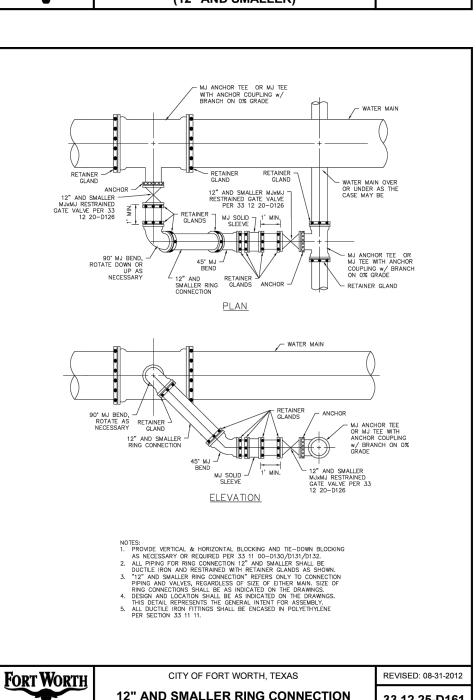
ENGINEERS & ENVIRONMENTAL KJE 500 Moseley Rd Cross Roads, TX 76277 Phone 940-387-0805 Fax 940-387-0830 PRELIMINARY "THIS DOCUMENT IS RELEASED FOR THE PURPOSE OF INTERIM REVIEW UNDER THE AUTHORITY OF IAN NORFOLK, P.E. 93550 ON 11/13/2024. IT IS NOT TO BE USED FOR CONSTRUCTION, BIDDING, OR PERMIT PURPOSES." SOUTH Ζ Ο Ē FOR CONSTRUC IN PROGRESS FM 455 AND INDIAN LN SANGER, TEXAS () CENTER TOWN 0 SANGER NOT F 11/12/2024 Issued Date: 240117 Project No: RP <u>Drawn By:</u> Checked By Designed By Issue Record # Description Date

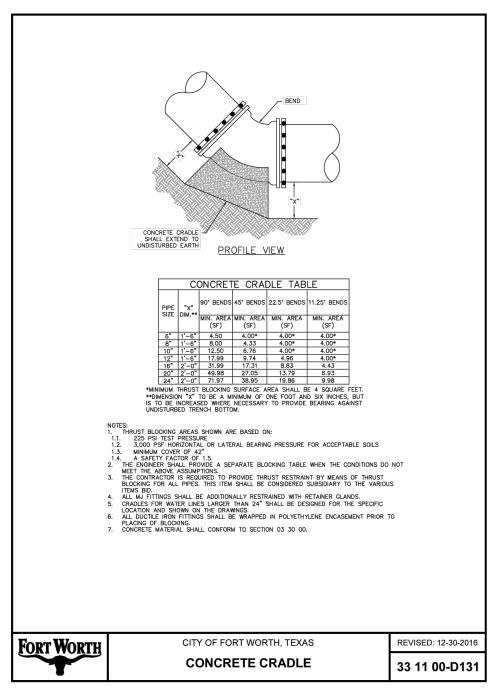www.kje-us.com Texas Firm F-12214

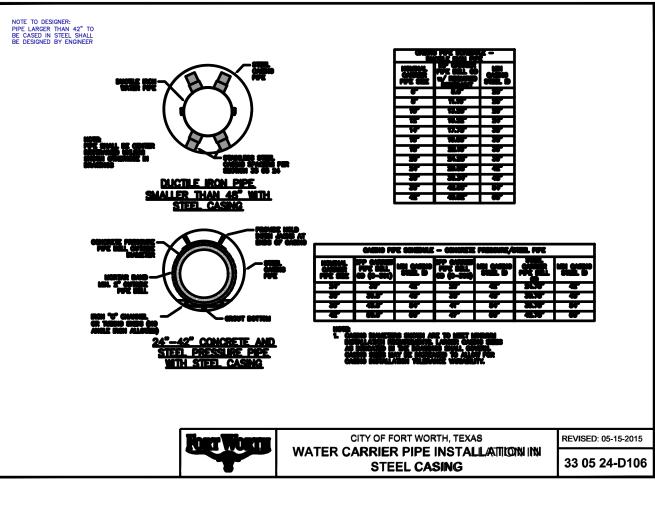**GENERAL DETAILS VI** 

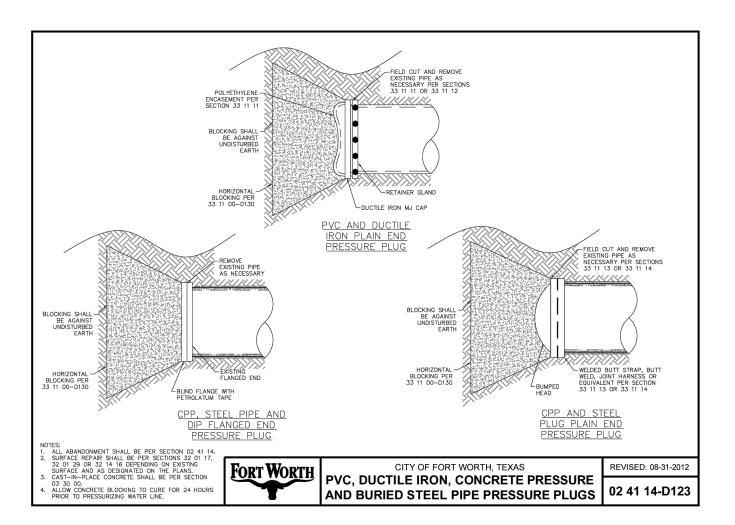

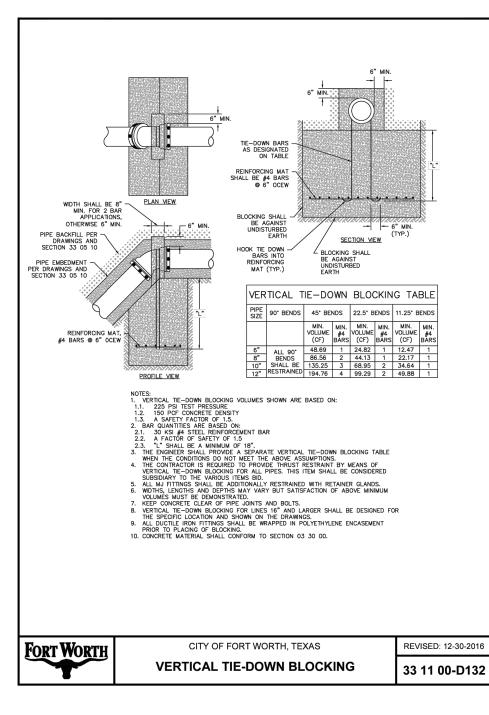


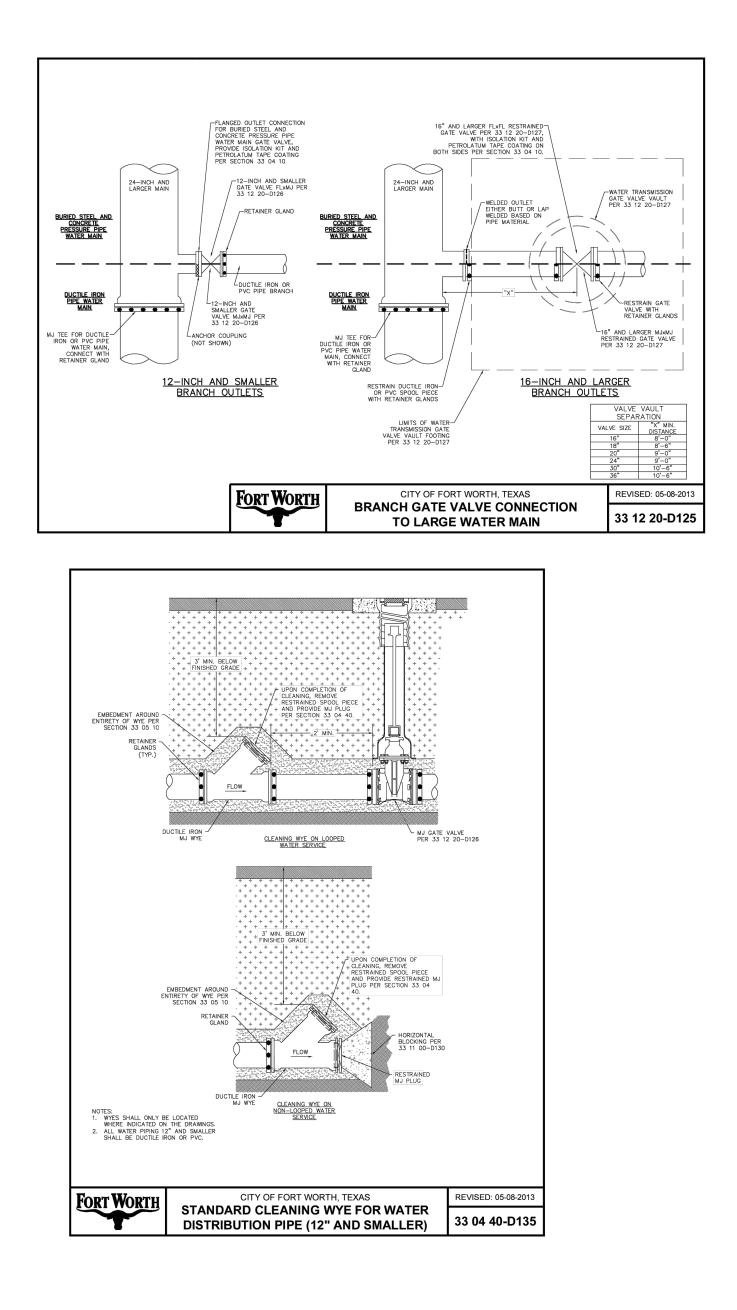



12" AND SMALLER RING CONNECTION


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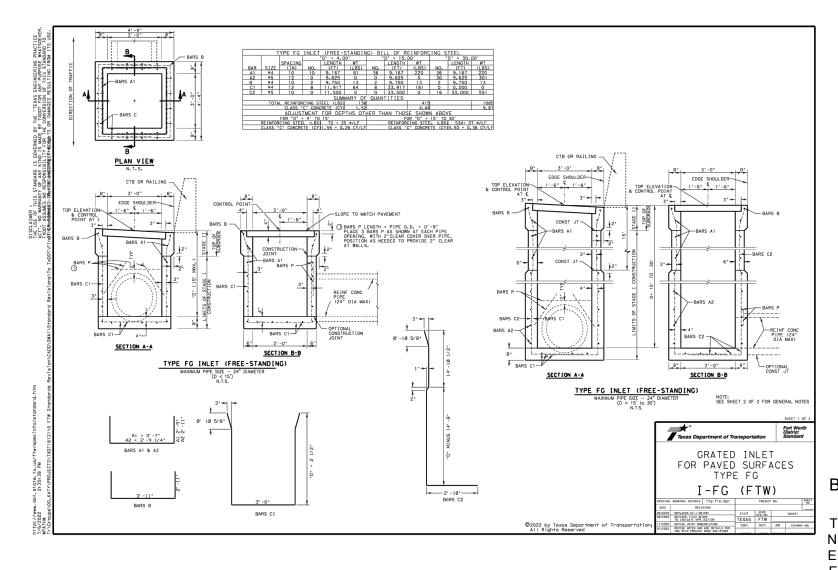
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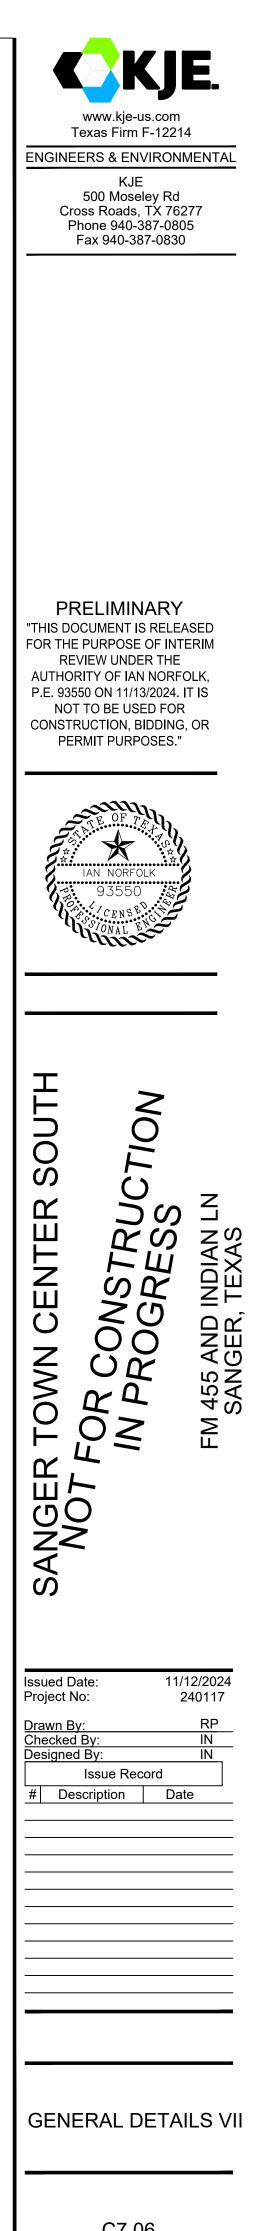




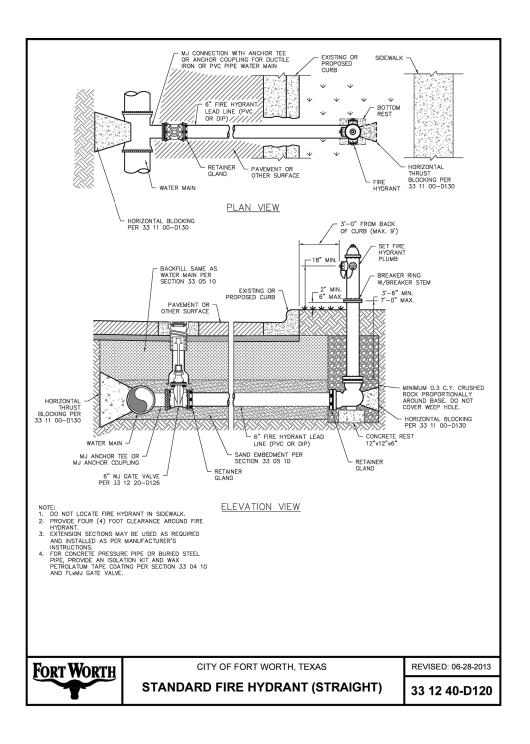

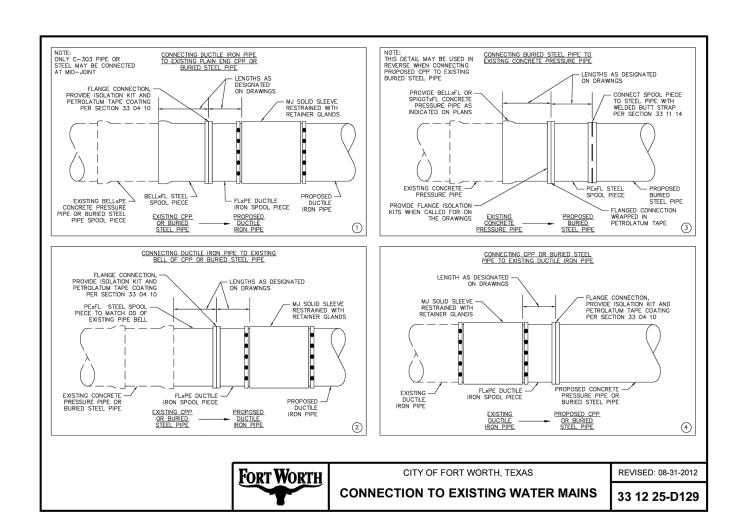

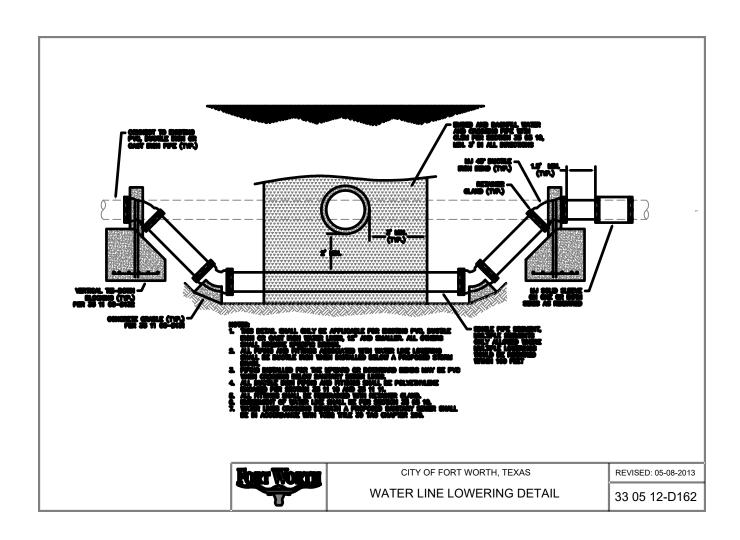

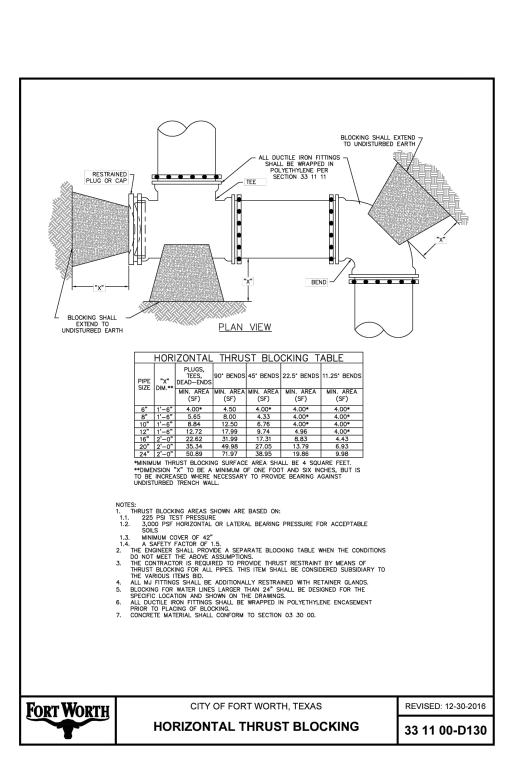

**BENCHMARKS:** 

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November 27, 2024 AVO 37449.004

Ms. Ramie Hammonds Development Services Director/Building Official City of Sanger 201 Bolivar Street P.O. Box 1729 Sanger, Texas 76266

#### Re: Sanger Town Center South Preliminary Platt Review

Dear Ms. Hammonds,

Halff Associates, Inc. was requested by the City of Sanger to review the <u>Preliminary Platt</u> for Sanger Town Center South. The submittal was prepared by KJE Inc. and was received on November 13<sup>th</sup>, 2024.

#### **General Comments**

- 1. Please address comments on attached markups and provide annotated responses on markups. Please note, not all comments are written on letter since some comments are easier to show and explain on the markups. Please annotate markup with responses.
- 2. Please note additional comments may be provided in subsequent reviews once additional data/responses is received.

#### Hydrology and Hydraulics

 Culvert at corner of Indian Lane and East Chapman Drive appears to convey flow from Sanger High School to site of future detention pond. This culvert is not shown on plans. Please account for offsite flows in detention pond size calculations and other applicable drainage calculations. See pg. 14 of submittal.



Ms. Ramie Hammonds November 27, 2024 Page 2 of 3

- Please revise Tc of existing drainage area to 15 minutes per Sanger Drainage criteria for parks. § 10.106(d)(2)(D)(iii). Alternatively, provide calculations demonstrating Tc to be 10 minutes as is currently shown.
- 3. Please provide proposed inlets and storm sewer on same plan sheet as proposed grading.
- 4. Proposed grading appears to fill in roadside channel along East Chapman Drive. Also, proposed model appears to increase discharge to this channel. Please not that TxDOT approval will be required to make these changes within their Right-of-Way. See pg. 14 of submittal.
  - **a.** Please provide hydraulic calculations demonstrating existing conditions and proposed conditions capacity of channel
- 5. Culvert at Sable Creek Boulevard no longer appears to discharge to proposed detention pond in proposed conditions. Please revise. See pg. 20 of submittal.
- 6. Please note that TxDOT approval will be required to discharge additional flow into existing culvert. See pg. 20 of submittal.
- Please provide inlet capacity calculations, and street capacity calculations if street is used for overflow. See § 10.106(d)(4) Street and Alley Capacity and 10.106(d)(5) Inlet Placement and Capacity.
- 8. Please provide finished-floor elevations of all structures §10.106(d)(4)(C)
- Please specify material used for new stormwater pipes and include n value used in calculations. § 10.106(d)(6)(C)
- Please lower HGL or raise proposed ground elevations at Junction Box at STA 0+35.72 to allow for 1 foot of difference between HGL and ground surface. § 10.106(d)(6)(D)(ii). See page 16 of submittal
- 11. Please overlay FEMA Zone A floodplain on proposed and existing grading exhibit, and please clarify that no grading is proposed in Ranger Branch Tributary 4 floodplain.
- 12. Please provide bottom slope of detention pond § 10.106(d)(10)(C)
- 13. Please provide 1 foot of freeboard in detention pond for the 100-year storm and 2 feet of sediment storage. See § 10.106(d)(10)(A)
- 14. Please provide more information on 24 hour water quality discharge than what is currently in table on "Drainage Calculations 1" sheet (page 15 of submittal). Please provide more explanation as to how pond was calculated to drain in 24 hours. § 10.106(d)(10)(F)
- 15. Please provide downstream assessment. Sanger criteria § 10.106(d)(10)(B) states "All detention facilities designed shall consider the timing of the flood peak in the main channel into which the detention facility drains. Delaying the peak from a site in lower portions of a watershed may result in a higher peak on the main channel."

Ms. Ramie Hammonds November 27, 2024 Page 3 of 3

If you have any questions or need additional information, please do not hesitate to call me at (214) 937-3954.

Sincerely, HALFF TBPELS Firm No. 312

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Randy Peterman, PE, CFM, ENV SP