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UTILITIES

UTILITIES		
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WATER	NORTH PARK PUBLIC WATER	
SEWER	FOUR RIVERS SANITATION AUTHORITY	
ELECTRIC	COMMONWEALTH EDISON	
TELEPHONE	CHARTER COMMUNICATIONS	
GAS	NICOR	
CABLE	CHARTER COMMUNICATIONS	

(CONTRACTOR TO BE RESPONSIBLE FOR COORDINATING ANY ADJUSTMENTS TO BE MADE.)

J.U.L.I.E. Know what's below. Call before you dig. OR CALL (800) 892-0123


MAIN STREET PEDESTRIAN CROSSING

FOR

VILLAGE OF ROSCOE ROSCOE, ILLINOIS

PROPOSED PEDESTRIAN CROSSING
BRIDGE STREET AND MAIN STREET
WINNEBAGO COUNTY

SEPTEMBER 2025

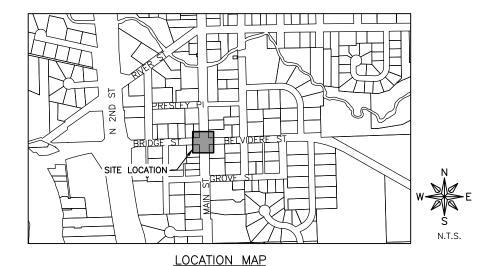



ILLINOIS IOWA

ILLINOIS PROFESSIONAL DESIGN FIRM NUMBER: 184003525

WISCONSIN





FOR BID

ORIGINAL	SET FOR PROJECT:	25-934		DATE CREATED:	9/8/2025
		REVIS	SIONS		
REV. NO.		DESCR	IPTION		DATE

GENERAL NOTES

- THIS PROJECT SHALL BE CONSTRUCTED IN ACCORDANCE WITH THE MUNICIPAL CODE, CITY OF VILLAGE OF ROSCOE, ILLINOIS, CURRENT EDITION, THE ILLINOIS DEPARTMENT OF TRANSPORTATION'S "STANDARD SPECIFICATIONS FOR ROAD AND BRIDGE CONSTRUCTION", CURRENT EDITION, "SUPPLEMENTAL SPECIFICATIONS AND RECURRING SPECIAL PROVISIONS," CURRENT EDITION, SPECIAL PROVISIONS AND THE "STANDARD SPECIFICATIONS FOR WATER AND SEWER MAIN CONSTRUCTION IN ILLINOIS", CURRENT EDITION. SIGN CONSTRUCTION AND PAVEMENT MARKINGS SHALL CONFORM TO THE REQUIREMENTS OF THE "MANUAL ON UNIFORM TRAFFIC CONTROL DEVICES". CURRENT EDITION.
- 2. IN THESE CONTRACT DOCUMENTS MENTION IS MADE OF THE "ENGINEER". WHICH SHALL MEAN FEHR GRAHAM OR THEIR DULY AUTHORIZED AGENT. IN THESE CONTRACT DOCUMENTS MENTION IS MADE OF THE "OWNER", WHICH SHALL MEAN VILLAGE OF ROSCOE, OR THEIR DULY AWARDED AGENT.
- 3. AS PART OF THE BIDDING PROCEDURE, THE CONTRACTOR SHALL VERIFY THAT THE QUANTITIES FOR PAY ITEMS, AS PRESENTED IN THESE PLAN DOCUMENTS, ARE SUBSTANTIALLY CORRECT. IF DISCREPANCIES ARE DETECTED, THE CONTRACTOR SHALL NOTIFY THE ENGINEER OF THE DISCREPANCY PRIOR TO THE BID DATE.
- 4. QUANTITIES SHOWN ARE ESTIMATES FOR INFORMATION ONLY. PAYMENT WILL BE BASED ON ACTUAL QUANTITIES MEASURED IN THE FIELD OR ON PAYMENT LIMIT DETAILS.
- 5. THE CONTRACTOR SHALL BE PAID FOR MATERIALS AND EQUIPMENT SUCCESSFULLY INSTALLED IN ACCORDANCE WITH THE PLANS AND SPECIFICATIONS AS MEASURED OR VERIFIED IN PLACE BY THE ENGINEER OR HIS AGENT.
- 6. IN CASE OF CONFLICT BETWEEN THE ABOVE MENTIONED SPECIFICATIONS. THE ENGINEER SHALL DETERMINE WHICH OF THE SPECIFICATIONS SHALL GOVERN. THE ENGINEER'S DECISION SHALL BE FINAL AND NO ADDITIONAL COMPENSATION SHALL BE AWARDED UNLESS APPROVED BY THE ENGINEER.
- THE PROPOSED IMPROVEMENTS MUST BE CONSTRUCTED IN ACCORDANCE WITH THE ENGINEERING PLANS AS APPROVED BY THE OWNER. IMPROVEMENT REPRESENTATIONS AS SHOWN ON THESE PLANS, ARE AS ACCURATE AS POSSIBLE FROM THE INFORMATION AVAILABLE. HOWEVER SOME FIELD REVISIONS MAY BE REQUIRED TO ACCOMMODATE UNFORESEEN CIRCUMSTANCES THE ENGINEER SHALL BE ADVISED OF ANY NECESSARY REVISIONS WITH SUFFICIENT LEAD TIME ALLOWED TO PROPERLY CONSIDER AND ACT UPON SAID REQUESTS. PROPER CONSTRUCTION TECHNIQUES MUST BE FOLLOWED IN CONSTRUCTING THOSE IMPROVEMENTS AS DETAILED IN THIS ENGINEERING PLAN.
- THE ENGINEER SHALL HAVE THE AUTHORITY TO INSPECT, APPROVE OR REJECT THE WORKMANSHIP AND/OR MATERIALS WHICH GO TO MAKE UP IMPROVEMENTS AS DETAILED IN THESE PLANS AND SPECIFICATIONS.
- GENERAL SAFETY PROVISION: TO PROVIDE DRIVERS WITH SAFE TRAVEL CONDITIONS DURING THE CONSTRUCTION PROJECT, AND TO PROVIDE SAFE WORKING CONDITIONS FOR ALL EMPLOYEES, THE RULES, REGULATIONS, AND CONDITIONS STATED BELOW WILL PREVAIL FOR THE DURATION OF THIS CONTRACT. ANY EMPLOYEE OF THE CONTRACTOR OR HIS SUBCONTRACTORS WHO REFUSES TO COMPLY WITH THESE GENERAL SAFETY PROVISIONS SHALL BE REMOVED FROM THE JOB SITE IN ACCORDANCE WITH STATE AND LOCAL REQUIREMENTS. THE CONTRACTOR AND ANY SUBCONTRACTORS RETAINED BY HIM SHALL COMPLY WITH THE STATE AND FEDERAL REQUIREMENTS OF THE OCCUPATIONAL SAFETY AND HEALTH ACT OF 1970 (OSHA), JULY 1, 1987 AS IT RELATES TO CONTRACTOR'S OPERATIONS
- 10. THE CONTRACTOR SHALL COMPLY WITH ALL STATE REGULATIONS REGARDING AIR, WATER, AND NOISE POLLUTION. THE CONTRACTOR WILL NOT BE ALLOWED TO BUILD FIRES ON THE SITE.
- 11. THE SCALE SHOWN ON THE DRAWINGS APPLIES ONLY TO THE FULL SIZE PLANS NOT THE REDUCED SIZE PLANS.
- 12. IT SHALL BE THE CONTRACTOR'S RESPONSIBILITY TO MAINTAIN DRAINAGE FLOWS AT ALL TIMES DURING THE PERFORMANCE OF THE WORK. METHODS USED BY THE CONTRACTOR SHALL BE SUBJECT TO THE APPROVAL OF THE ENGINEER. COST OF MAINTAINING DRAINAGE FLOWS SHALL BE INCIDENTAL TO THE CONTRACT.
- 13. WHERE SECTION OR SUBSECTION MONUMENTS ARE ENCOUNTERED, THE ENGINEER SHALL BE NOTIFIED BEFORE SUCH MONUMENTS ARE REMOVED OR DISTURBED. THE CONTRACTOR SHALL PROTECT AND CAREFULLY PRESERVE ALL PROPERTY MARKERS, MONUMENTS AND RIGHT-OF-WAY PINS UNTIL THE OWNER, AND AUTHORIZED SURVEYOR, OR AGENT HAS WITNESSED OR OTHERWISE REFERENCED THEIR LOCATION. THE CONTRACTOR SHALL BE RESPONSIBLE FOR HAVING AN AUTHORIZED SURVEYOR RE-ESTABLISH ANY SECTION OR SUBSECTION MONUMENTS DESTROYED BY HIS OPERATIONS. REPLACEMENT OF MONUMENTS WILL BE DETERMINED BY THE ENGINEER.
- 14. THE CONTRACTOR SHALL REMOVE, STORE, AND RELOCATE TO THE SATISFACTION OF THE ENGINEER ALL EXISTING SIGNAGE IN ACCORDANCE WITH STATE AND LOCAL REQUIREMENTS, AND CONSIDER THIS AS INCIDENTAL TO THE CONTRACT.
- 15. OUTSIDE THE EXISTING RIGHT-OF-WAY, THE CONTRACTOR SHALL USE CARE IN GRADING OR EXCAVATION NEAR ANY AND ALL EXISTING SIGNS OUTSIDE THE RIGHT-OF-WAY. ANY SIGNS REMOVED FOR CONSTRUCTION PURPOSES SHALL BE CAREFULLY REMOVED AND RE-ERECTED BY THE CONTRACTOR AT A LOCATION NEAREST TO THE ORIGINAL LOCATION, OR AT A LOCATION DETERMINED BY THE ENGINEER IN THE FIELD. REMOVAL AND RE-ERECTED SIGNS AND ANY DAMAGE DONE TO EXISTING SIGNS BY THE CONTRACTOR'S OPERATIONS SHALL BE REPAIRED OR REPLACED AT NO ADDITIONAL EXPENSE TO THE OWNER.
- 16. ALL ITEMS SHALL INCLUDE ALL THE NECESSARY MATERIALS AND LABOR TO COMPLETE THE ITEM IN PLACE. MATERIALS AND LABOR NOT SPECIFICALLY IDENTIFIED SHALL BE CONSIDERED INCIDENTAL TO THE PROJECT.
- 17. AT THE END OF EACH DAY, THE CONTRACTOR SHALL SECURE THE CONSTRUCTION WORK ZONE FROM POTENTIAL INTRUDERS
- 18. THE CONTRACTOR SHALL FIELD VERIFY THE ELEVATIONS OF THE BENCHMARKS PRIOR TO COMMENCING WORK. THE CONTRACTOR SHALL ALSO FIELD VERIFY LOCATION, ELEVATION AND SIZE OF EXISTING UTILITIES, AND VERIFY PAVEMENT ELEVATIONS WHERE MATCHING INTO EXISTING WORK. THE CONTRACTOR SHALL FIELD VERIFY HORIZONTAL CONTROL BY REFERENCING SHOWN COORDINATES TO KNOWN PROPERTY LINES. NOTIFY ENGINEER OF DISCREPANCIES IN EITHER VERTICAL OR HORIZONTAL CONTROL PRIOR TO PROCEEDING WITH WORK.
- 19. THE CONTRACTOR SHALL CONTACT THE ENGINEER OF ANY ERRORS OR DISCREPANCIES WHICH MAY BE SUSPECTED IN LINES AND GRADES, AND SHALL NOT PROCEED WITH THE WORK UNTIL ALL LINES AND GRADES WHICH ARE BELIEVED TO BE IN ERROR HAVE BEEN VERIFIED OR CORRECTED BY THE ENGINEER OR HIS REPRESENTATIVE
- 20. THE ENGINEER AND OWNER ARE NOT RESPONSIBLE FOR THE CONSTRUCTION MEANS, METHODS, TECHNIQUES, SEQUENCE OR PROCEDURES, TIME OF PERFORMANCE, PROGRAMS OR ANY SAFETY PRECAUTIONS USED BY THE CONTRACTOR. THE CONTRACTOR IS SOLELY RESPONSIBLE FOR EXECUTION OF THEIR WORK IN ACCORDANCE WITH THE CONTRACT DOCUMENTS
- 21. ALL ITEMS TO BE REMOVED AND NOT DEFINED AS A PAY ITEM SHALL BE CONSIDERED INCIDENTAL TO THE PROJECT.
- 22. ALL EXCESS EARTH EXCAVATION, EXCESS MATERIALS, OR OTHER REMOVED ITEMS SHALL BE HAULED OFF-SITE AT THE CONTRACTOR'S EXPENSE. UNLESS OTHERWISE APPROVED BY THE OWNER.
- 23. THE CONTRACTOR SHALL REMOVE AND DISPOSE OF ALL OBSTRUCTIONS, TREES, DEBRIS AND BRUSH AS DESIGNATED BY THE OWNER AND AS INDICATED ON THE PLANS. THIS WORK SHALL BE IN ACCORDANCE WITH SECTION 201 OF THE ILLINOIS DEPARTMENT OF TRANSPORTATION'S "STANDARD SPECIFICATIONS FOR ROAD AND BRIDGE CONSTRUCTION IN ILLINOIS", CURRENT EDITION. ALL MATERIALS SHALL BE DISPOSED OF AT THE CONTRACTOR'S EXPENSE. DURING CONSTRUCTION, CARE SHALL BE TAKEN TO MINIMIZE DAMAGE TO THE EXISTING TREES AND LANDSCAPING. ONLY THOSE ITEMS DESIGNATED BY THE OWNER
- 24. ALL ROADWAY REMOVAL ITEMS SHALL CONFORM TO THE ILLINOIS DEPARTMENT OF TRANSPORTATION'S "STANDARD . ALL ROADWAY REMOVAL HEMS SHALL CONFORM TO THE HILLINGS DEPARTMENT OF TRANSPORTATION'S STANDARD SPECIFICATIONS FOR ROAD AND BRIDGE CONSTRUCTION IN ILLINOIS", CURRENT EDITION. ALL JOINTS BETWEEN THE PORTION REMOVED AND THAT LEFT IN PLACE SHALL BE SAWED TO SUCH A DEPTH THAT A CLEAN, NEAT EDGE WILL RESULT WITH NO SPALLING TO THE REMAINING PORTION. THE COST OF SAWING SHALL BE CONSIDERED INCIDENTAL TO THE CONTRACT. ADDITIONAL SAWING OR RE-SAWING MAY BE REQUIRED AS DIRECTED BY THE ENGINEER WITH NO ADDITIONAL COMPENSATION BEING ALLOWED. THE COST OF SAWCUTTING THE EXISTING PAVEMENT SHALL NOT BE PAID FOR SEPARATELY, BUT SHALL BE CONSIDERED INCIDENTAL TO THE CONTRACT.

GENERAL NOTES CONTINUED

- 25. WHEN ARTIFICIAL LIGHTING IS UTILIZED DURING NIGHT OPERATIONS, THE CONTRACTOR SHALL EXERCISE UTMOST PRECAUTIONS IN PREVENTING ADVERSE VISIBILITY TO THE MOTORING PUBLIC, AS WELL AS ADJOINING RESIDENTIAL AREAS.
- 26. THE CONTRACTOR IS REQUIRED TO STAY WITHIN THE NOTED PROPERTY BOUNDARIES RIGHT-OF-WAY AND EASEMENTS AS SHOWN IN THE PLANS. ANY ADDITIONAL EASEMENTS SHALL BE SECURED BY THE CONTRACTOR AT NO EXTRA COST.
- 27. ANY AREAS DAMAGED OR DISTURBED DURING THE PROJECT AS A DIRECT OR INDIRECT RESULT OF CONTRACTOR OPERATIONS, SHALL BE RESTORED TO A CONDITION EQUAL TO OR BETTER THAN THE ORIGINAL CONDITION. THE COST OF SAID RESTORATION OR REPAIR SHALL BE BORNE TOTALLY BY THE CONTRACTOR WITH NO EXTRA COMPENSATION BEING AWARDED UNDER THIS CONTRACT. THE RESPONSIBILITY FOR THE REPAIR OR REPLACEMENT OF ANY UTILITY, STRUCTURE, LANDSCAPING, DAMAGED OR DESTROYED BY THE CONTRACTOR DURING MOBILIZATION OR CONSTRUCTION SHALL BE BORNE SOLELY BY THE CONTRACTOR, WITH NO EXPENSE BEING CHARGED TO THE ENCINEER OR OWNER. PRIOR TO ACCEPTANCE OF THIS REPAIR OR REPLACEMENT, THE CONTRACTOR SHALL PRESENT THE OWNER WITH A "SIGNOFF LETTER", SIGNED BY A RESPONSIBLE OFFICIAL OF THE OWNER OF THE DAMAGED UTILITY STATING THAT THE REPAIR OR REPLACEMENT IS ACCEPTABLE.

CONSTRUCTION STAKING

1. THE CONTRACTOR SHALL BE RESPONSIBLE FOR STAKING THE PROPOSED IMPROVEMENTS.

EROSION CONTROL NOTES

- 1. UNLESS OTHERWISE SPECIFIED, ALL EROSION AND SEDIMENT CONTROL MEASURES AND THEIR MAINTENANCE, CLEARING AND REMOVAL SHALL BE CONSIDERED INCIDENTAL TO CONSTRUCTION.
- 2. THIS WORK SHALL CONFORM TO THE APPLICABLE STANDARDS FROM THE ILLINOIS URBAN MANUAL, THE ILLINOIS DEPARTMENT OF TRANSPORTATION STANDARD SPECIFICATION, CURRENT EDITION, THE PROJECT SPECIFICATIONS, AND THE APPROPRIATE
- 3. THE CONTRACTOR SHALL IMPLEMENT THE EROSION AND SEDIMENT CONTROL MEASURES AS INDICATED ON THESE EROSION CONTROL PLANS.
- 4. THE CONTROLS SHALL BE INSTALLED AS DETAILED AND WHERE INDICATED ON THE EROSION CONTROL PLAN SHEETS AND AS DIRECTED BY THE INSPECTOR.
- 5. SITE ACTIVITIES SHOULD ENSURE THAT EXISTING VEGETATION IS PRESERVED WHERE PRACTICABLE
- 6. DISTURBED PORTIONS OF THE SITE SHALL BE STABILIZED (TEMPORARILY OR PERMANENTLY SEEDED, MULCHED, SODDED OR PAVED) AS SOON AS PRACTICABLE, BUT IN NO CASE MORE THAN 7 CALENDAR DAYS AFTER THE CONSTRUCTION ACTIVITY IN THAT PORTION OF THE SITE HAS TEMPORARILY OR PERMANENTLY CEASED.
- 7. UNTIL SUCH TIME AS THE PROJECT SITE REACHES FINAL STABILIZATION THE CONTRACTOR SHALL BE RESPONSIBLE TO ADJUST, REPAIR, OR REPLACE, ALL VEGETATION, EROSION CONTROLS, SEDIMENT CONTROLS, AND ANY OTHER PROTECTIVE MEASURES AS REQUIRED IN ORDER TO MAINTAIN THEIR INTENDED FUNCTION IN A GOOD AND EFFECTIVE OPERATING CONDITION.
- 8. FXCFPT FOR FLOWS FROM FIRE FIGHTING ACTIVITIES, SOURCES OF NON-STORM WATER EXPECTED DURING THE CONSTRUCTION PROCESS THAT MAY BE COMBINED WITH STORM WATER DISCHARGES ARE:
- B. WATERS USED TO WASH VEHICLES (DETERGENTS ARE NOT TO BE USED)
- WATERS USED TO CONTROL DUST
 POTABLE WATER FROM WATER MAIN FLUSHING
- LANDSCAPE IRRIGATION DRAINAGE UNCONTAMINATED GROUND WATER FROM DEWATERING EXCAVATED TRENCHES
- G. PAVEMENT WASH WATERS WHERE SPILLS OR LEAKS OF TOXIC OR HAZARDOUS MATERIALS HAVE NOT OCCURRED (UNLESS
- ALL SPILLED MATERIAL HAS BEEN REMOVED) ALSO, DETERGENTS ARE NOT TO BE USED UNCONTAMINATED AIR CONDITIONING CONDENSATE THE ABOVE NON-STORM DISCHARGES SHALL BE DIRECTED AWAY FROM UNPROTECTED, BARE, OR OTHERWISE UNSTABILIZED SOIL. THE CONTRACTOR SHALL FURTHER IMPLEMENT APPROPRIATE POLLUTION PREVENTION MEASURES TO ENSURE THAT ANY OF THE ABOVE DISCHARGES DO NOT CAUSE EROSION OR DEGRADE THE QUALITY OF RUNOFF FROM THE
- 9. THE OWNER SHALL HAVE AUTHORIZATION TO DETERMINE THE ADEQUACY OF THE CONTRACTOR'S EROSION CONTROL EFFORTS.
 THE OWNER SHALL HAVE FULL AUTHORITY OVER THE GENERAL CONTRACTOR AND ANY SUBCONTRACTOR TO CAUSE POLLUTANT
 CONTROL MEASURES TO BE REPAIRED, MODIFIED, MAINTAINED, SUPPLEMENTED, OR WHATEVER ELSE IS NECESSARY IN ORDER
 TO ACHIEVE EFFECTIVE POLLUTANT CONTROL OR TO SUSPEND OR LIMIT THE CONTRACTORS OPERATIONS PENDING ADEQUATE
- 10. PERIMETER EROSION BARRIER TO BE CONSTRUCTED OF SILT FENCE UNLESS NOTED OTHERWISE.
- 11. INLET PROTECTION SHALL BE A DANDY BAG, DANDY SACK, ROCSOC, OR APPROVED EQUAL.
- 12. EROSION CONTROL BLANKET SHALL BE OF NORTH AMERICAN GREEN DS75 OR APPROVED EQUAL
- 13. A TEMPORARY CONCRETE WASHOUT FACILITY SHALL BE CONSTRUCTED AT A LOCATION APPROVED BY THE ENGINEER. WASHOUT FACILITY SHALL BE UTILIZED FOR ALL APPLICABLE OPERATIONS.
- 14. STABILIZED CONSTRUCTION ENTRANCES SHALL BE INSTALLED, TO THE DIMENSIONS AS SHOWN, AT APPROVED LOCATIONS FOR THIS PROJECT. ALL CONSTRUCTION TRAFFIC MUST UTILIZE THE STABILIZED CONSTRUCTION ENTRANCES WHEN EXITING THE SITE. ALL COST FOR EROSION CONTROL AND RESTORATION WORK ASSOCIATED WITH THE APPROVED STABILIZED CONSTRUCTION ENTRANCES SHALL BE CONSIDERED INCIDENTAL TO THE CONTRACT.
- 15. TEMPORARY EROSION CONTROL MEASURES INCLUDE TEMPORARY DITCH CHECKS, PERIMETER EROSION BARRIER, INLET AND PIPE PROTECTION, TEMPORARY SEEDING, AND ANY OTHER TEMPORARY EROSION CONTROL MEASURE NEEDED TO LIMIT THE AMOUNT OF SOIL EROSION AND SEDIMENTATION DURING CONSTRUCTION.
- 16. AT THE COMPLETION OF THE PROJECT, ALL TEMPORARY FROSION CONTROL ITEMS SHALL BE REMOVED FROM THE SITE, AND BECOME THE PROPERTY OF THE CONTRACTOR. CONTRACTOR MUST STABILIZE ANY AREA DISTURBED BY THE REMOVAL OF EROSION CONTROL ITEMS.
- 17. CONTRACTOR SHALL CLEAN ANY DEBRIS TRACKED OFFSITE DAILY

SEEDING OF DISTURBED AREAS

- 1. THE FINAL TOP 6" INCHES OF SOIL IN ANY DISTURBANCE AREA MUST BE A COHESIVE SOIL CAPABLE OF SUPPORTING
- 2. FERTILIZER HAVING AN ANALYSIS OF 10-10-10 SHALL BE APPLIED AT A RATE OF 90 LBS/ACRE TO ALL DISTURBED AREAS AND INCORPORATED INTO THE SEEDBED PRIOR TO SOWING THE SEED.
- 3. THE CONTRACTOR SHALL SEED AND STABILIZE ALL DISTURBED AREAS ADJACENT TO IMPROVEMENTS WITH SEEDING, IDOT CLASS 1A AND NAG DS75 EROSION CONTROL BLANKET OR APPROVED EQUAL IN ACCORDANCE WITH IDOT STANDARD SPECIFICATION OR AS APPROVED BY THE ENGINEER.

SEEDING OF DISTURBED AREAS CONTINUED

- 1. GUARANTEE: ALL SEEDED AREAS SHALL BE MAINTAINED AND MOWED FOR AT LEAST 30 DAYS AFTER GERMINATION. SCATTERED BARE SPOTS NO LARGER THAN TWO SQUARE FOOT WILL BE ALLOWED UP TO A MAXIMUM OF 5% OF ANY SEEDED AREA INCLUDING 30—DAY MAINTENANCE, MOWING AND WATERING AS NECESSARY.
- 2. THIS WORK SHALL CONFORM TO THE APPLICABLE STANDARDS FROM THE ILLINOIS URBAN MANUAL, THE ILLINOIS DEPARTMENT OF TRANSPORTATION STANDARD SPECIFICATION SECTIONS, CURRENT EDITION, THE PROJECT SPECIFICATIONS, AND THE APPROPRIATE DETAILS.
- 3. RESTORATION THE CONTRACTOR SHALL RESTORE ALL AREAS DISTURBED DURING CONSTRUCTION OF THE IMPROVEMENTS AND RELATED APPURTENANCES OR AS PART OF ANY OF THEIR ACTIVITIES TO A CONDITION EQUAL TO OR BETTER THAN THE

UTILITIES

- 1. UTILITIES SHOWN ON THE PLANS ARE FOR ILLUSTRATIVE PURPOSES ONLY AND NO GUARANTEE OF THEIR ACCURACY IS MADE UTILITIES SHOWN ON THE PLANS ARE FOR ILLUSTRATIVE PURPOSES ONLY AND NO GOARANTEE OF THEIR ACCURACY IS MADE
 OR INFERRED. THE LOCATION OF EXISTING UTILITIES AS SHOWN ON THE DRAWINGS REPRESENT DATA RECEIVED FROM
 VARIOUS SOURCES. IT IS NOT GUARANTEED TO BE CORRECT OR ALL—INCLUSIVE. THE CONTRACTOR SHALL CONDUCT HIS
 OWN INVESTIGATION INTO THE LOCATION, SIZE, DEPTH AND NATURE OF ANY AND ALL EXISTING UTILITIES THAT MAY INTERFERE
 WITH THE WORK UNDER THIS CONTRACT. ANY EXISTING UTILITIES THAT ARE TO REMAIN IN SERVICE SHALL BE FULLY
 PROTECTED BY THE CONTRACTOR AND ANY DAMAGE CAUSED BY THE CONSTRUCTION OPERATIONS SHALL BE IMMEDIATELY
 REPAIRED OR REPLACED TO THE SATISFACTION OF THE ENGINEER OR THE OWNER. THE CONTRACTOR SHALL BE RESPONSIBLE
 FOR CONTRACTION AND ALL LITTLY COMPANIES DECARDING ON HISTMENTS INFERSEADY. THIS WORK SHALL BE FAT THE FOR CONTACTING ANY AND ALL UTILITY COMPANIES REGARDING ADJUSTMENTS NECESSARY. THIS WORK SHALL BE AT THE CONTRACTOR'S EXPENSE AND CONSIDERED INCIDENTAL TO THE PROJECT COST. THE CONTRACTOR SHALL BE RESPONSIBLE FOR THE PROTECTION OF ALL UNDERGROUND, OVERHEAD, OR SURFACE UTILITIES EVEN THOUGH THEY MAY NOT BE SHOWN ON THE PLANS. ANY UTILITY THAT IS DAMAGED DURING CONSTRUCTION SHALL BE REPAIRED TO THE SATISFACTION OF THE ENGINEER OR THE OWNER OR REPLACED. THIS WORK SHALL BE AT THE CONTRACTOR'S EXPENSE.
- 2. THE CONTRACTOR MUST VERIFY AND LOCATE ALL EXISTING UTILITIES ON OR ADJACENT TO THE SITE. PRIOR TO BEGINNING THE CONTRACTOR MUST VERIFY AND LOCATE ALL EXISTING UTILITIES ON ON ADJOCATION OF THE STILL THROUGH CONSTRUCTION ACTIVITIES, CONTACT JULLIE. AT 1-800-892-0123 (OR 811) FOR EXACT FIELD LOCATION OF UTILITIES. DAMAGE, AND THE COST THEREOF, TO ANY AND ALL UTILITIES SHALL BE THE SOLE RESPONSIBILITY OF THE CONTRACTOR. ANY AND ALL EXISTING UTILITIES SHOWN HEREON ARE APPROXIMATE. THE ENGINEER AND SURVEYOR ASSUMES NO RESPONSIBILITY FOR THE LOCATION OF THE EXISTING UTILITIES SHOWN HEREON.
- 3. IF THERE ARE ANY UTILITIES WHICH ARE NOT MEMBERS OF THE J.U.L.I.E. SYSTEM, THE CONTRACTOR SHALL BE SOLELY RESPONSIBLE FOR DETERMINING THIS AND REQUESTING SAID UTILITIES TO FIELD VERIFY AND MARK PERTINENT UTILITY
- 4 THE LITILITY LOCATIONS DEPTHS FTC SHOWN ON THESE PLANS ARE APPROXIMATE ONLY AND SHALL BE VERIFIED BY THE CONTRACTOR WITH ALL AFFECTED UTILITY COMPANIES PRIOR TO INITIATING CONSTRUCTION OPERATIONS; THE ENGINEER AND OWNER ASSUME NO RESPONSIBILITY FOR THE ADEQUACY, SUFFICIENCY OR EXACTNESS OF THESE UTILITY REPRESENTATIONS.
- 5. THE CONTRACTOR SHALL CONTACT THE NECESSARY UTILITY COMPANIES FOR ANY UTILITY RFI OCATIONS. THE CONTRACTOR SHALL PAY FOR ALL COSTS ASSOCIATED WITH RELOCATION OF UTILITIES ON OR ADJACENT TO THE SUBJECT PROPERTY OR WITHIN THE ROAD RIGHT-OF-WAY.
- 6. TRENCH BACKFILL SHALL BE USED IN LOCATIONS WHERE THERE IS AN EXISTING OR PROPOSED PERMANENT SURFACE.
- 7. ABANDONED UNDERGROUND UTILITIES THAT CONFLICT WITH CONSTRUCTION OR HAVE THE POTENTIAL FOR CREATING FUTURE PROBLEMS SHALL BE DISPOSED OF OUTSIDE THE LIMITS OF THE PROJECT AT AN APPROVED LOCATION OBTAINED BY THE CONTRACTOR, ACCORDING TO THE "STANDARD SPECIFICATIONS FOR WATER & SEWER CONSTRUCTION IN ILLINOIS", CURRENT EDITION, AND AS DIRECTED BY THE ENGINEER. THIS WORK WILL NOT BE PAID FOR SEPARATELY, BUT SHALL BE CONSIDERED INCIDENTAL TO EARTH EXCAVATION AND NO ADDITIONAL COMPENSATION WILL BE ALLOWED.
- 8. ANY AND ALL FIELD TILES AND OR STORM SEWERS DAMAGED OR ENCOUNTERED DURING THE CONSTRUCTION ACTIVITIES SHALL BE REPAIRED, REPLACED AND/OR CONNECTED IMMEDIATELY BY THE CONTRACTOR. COST FOR SAID REPAIRS, REPLACEMENT, AND/OR CONNECTION SHALL BE THE SOLE RESPONSIBILITY OF THE CONTRACTOR.

TRAFFIC CONTROL

- 1. THE CONTRACTOR SHALL PROVIDE, INSTALL AND MAINTAIN ALL TRAFFIC CONTROL ITEMS NECESSARY FOR THE CONSTRUCTION OF ITEMS WITH IN THE ROAD RIGHT-OF-WAY. ALL WORK PERFORMED SHALL HAVE TRAFFIC CONTROL IN ACCORDANCE WITH THE "MANUAL ON UNIFORM TRAFFIC CONTROL DEVICES" AND OF THE ILLINOIS DEPARTMENT OF TRANSPORTATION'S "STANDARD SPECIFICATIONS FOR ROAD AND BRIDGE CONSTRUCTION IN ILLINOIS", CURRENT EDITION.
- 2. ALL TRAFFIC CONTROL DEVICES USED FOR THE MAINTENANCE OF TRAFFIC SHALL BE REFLECTORIZED PRIOR TO INSTALLATION AND CLEANED AS NECESSARY THROUGHOUT THE DURATION OF THE CONTRACT. ALL SIGNS SHALL BE FURNISHED, INSTALLED AND MAINTAINED BY THE CONTRACTOR. PAYMENT SHALL BE CONSIDERED INCIDENTAL TO THE PROJECT.
- 3. TRAFFIC CONDITIONS, ACCIDENTS, AND OTHER UNFORESEEN CONDITIONS MAY REQUIRE THE ENGINEER TO MODIFY THE LOCATION OF THE TRAFFIC CONTROL DEVICES. THE CONTRACTOR SHALL MAKE THE NECESSARY ADJUSTMENTS AS DIRECTED BY THE ENGINEER WITHOUT DELAY. THE CONTRACTOR SHALL RESPOND WITHIN 30 MINUTES FROM THE TIME OF NOTIFICATION BY THE ENGINEER TO ANY REQUEST MADE BY THE ENGINEER FOR CORRECTION, IMPROVEMENT OR MODIFICATION OF THE MAINTENANCE OF TRAFFIC CONTROL DEVICES. DURING CONSTRUCTION OPERATIONS, THE CONTRACTOR SHALL TAKE NECESSARY PRECAUTIONS TO PROTECT ADJACENT TRAFFIC LANGES OPEN TO TRAFFIC FROM DEBRIS BEING BLOWN OR OTHERWISE REMOVED FROM THE CONSTRUCTION AREAS. THE CONTRACTOR SHALL ALSO BE RESPONSIBLE FOR KEEPING DEBRIS OFF THE ADJACENT TRAFFICELD LANGE SUPFACE. COST INCIDENTAL TO THE PROJECT. TRAVELED LANE SURFACE. COST INCIDENTAL TO THE PROJECT.
- 4. THE CONTRACTOR SHALL SUBMIT MAINTENANCE OF TRAFFIC AND STAGING OF CONSTRUCTION PLANS FOR APPROVAL BY THE ENGINEER PRIOR TO COMMENCING WORK
- 5. THE CONTRACTOR SHALL PERFORM THE WORK UNDER STAGE CONSTRUCTION IN THE EVENT THAT THE CONTRACTOR WILL NEED TO CLOSE PUBLIC ROADS, CONTRACTOR SHALL SUBMIT PROPOSED DETOUR ROUTE AND ASSOCIATED SIGNAGE TO THE ENGINEER PRIOR TO COMMENCING WORK
- 6. TRAFFIC CONTROL DEVICES, STREET NAME SIGNS, AND PAVEMENT MARKINGS SHALL BE INSTALLED IN ACCORDANCE WITH VILLAGE OF ROSCOE ORDINANCES AND THE "MANUAL ON UNIFORM TRAFFIC CONTROL DEVICES". LOCATIONS OF SIGNS AND MARKINGS SHALL BE SPECIFIED BY THE PLANS, AND/OR AS DIRECTED BY THE ENGINEER.
- 7. PROVIDE TO THE ENGINEER AND THE OWNER THE NAME AND PHONE NUMBER OF INDIVIDUALS RESPONSIBLE FOR MAINTAINING TRAFFIC CONTROL MEASURES DURING CONSTRUCTION. THIS INDIVIDUAL SHALL BE AVAILABLE TO CORRECT TRAFFIC CONTROL PROBLEMS 24 HOURS PER DAY.
- 8. THE CONTRACTOR SHALL NOTIFY THE POST OFFICE, POLICE DEPARTMENT, FIRE DEPARTMENT, 911 DISPATCH CENTER, ILLINOIS DEPARTMENT OF TRANSPORTATION, STATE POLICE, APPROPRIATE SCHOOL DISTRICT AND THE LOCAL AGENCY A MINIMUM OF DAYS PRIOR TO CLOSING ANY PORTION OF THE STREET OR ALLEY.

FEHR GRAHAM

FNGINFFRING & FNVIRONMENTAL

ILLINOIS DESIGN FIRM NO. 184-003525

ILLINOIS IOWA

WISCONSIN

VILLAGE OF ROSCOE 10631 MAIN STREET ROSCOE, IL 61073

OWNER/DEVELOPER

MAIN STREET PEDESTRIAN CROSSING ROSCOE, ILLINOIS


APPROVED BY: TN DATE: 9/8/2025 SCALE: AS NOTED

REVISIONS DESCRIPTION DATE

GENERAL NOTES SET TYPE: FOR BID

JOB NUMBER 25-934 SHEET NUMBER

2 of 13

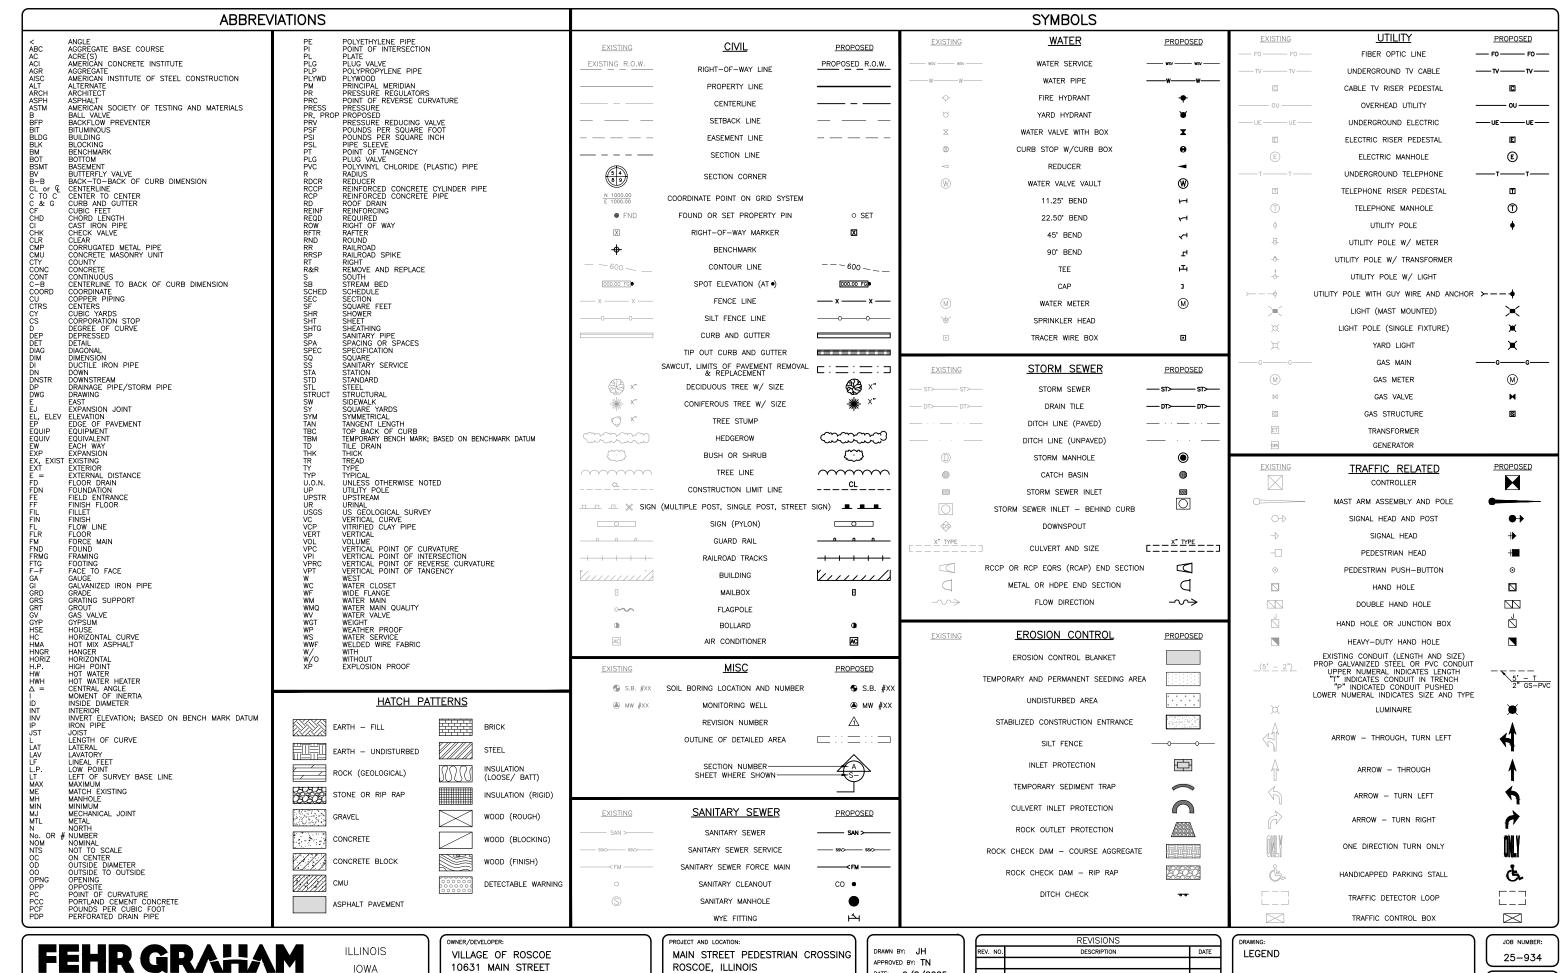

WISCONSIN

ROSCOE, IL 61073

DATE: 9/8/2025 SCALE: AS NOTED

	REVISIONS	
REV. NO.	DESCRIPTION	DATE
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SET TYPE: FOR BID

SHEET NUMBER: 3 of 13

ENGINEERING & ENVIRONMENTAL

ILLINOIS DESIGN FIRM NO. 184-003525

SUMMARY OF QUANTITIES

No.	Description	Quantity	Unit
1	HMA PAVEMENT REMOVAL	25.0	SY
2	COMBINATION CURB AND GUTTER REMOVAL	40.0	LF
3	SIDEWALK REMOVAL	655.0	SF
4	P.C.C. SIDEWALK, 4"	705.0	SF
5	COMBINATION CONCRETE CURB AND GUTTER, TYPE M6.24	40.0	LF
6	THERMOPLASTIC PAVEMENT MARKING - LINE 4"	125.0	LF
7	THERMOPLASTIC PAVEMENT MARKING - LINE 6"	110.0	LF
8	THERMOPLASTIC PAVEMENT MARKING - LINE 12"	120.0	LF
9	THERMOPLASTIC PAVEMENT MARKING - LINE 24" -	30.0	LF
10	METHYL METHACYRLATE (MMA) PAVEMENT MARKING - LINE 4"	45.0	LF
11	METHYL METHACYRLATE (MMA) PAVEMENT MARKING - LINE 24"	25.0	LF
12	DETECTABLE WARNINGS	30.0	SF
13	EROSION AND SEDIMENT CONTROL	1.0	LS
14	RESTORATION	1.0	LS
15	CONCRETE WASHOUT BASIN	1.0	LS
16	TRAFFIC CONTROL & PROTECTION	1.0	LS
17	STOP SIGN RELOCATE	1.0	EA
18	CONSTRUCTION LAYOUT	1.0	LS



ILLINOIS IOWA WISCONSIN OWNER/DEVELOPER:

VILLAGE OF ROSCOE
10631 MAIN STREET
ROSCOE, IL 61073

PROJECT AND LOCATION:

MAIN STREET PEDESTRIAN CROSSING ROSCOE, ILLINOIS

DRAWN BY: JH
APPROVED BY: TN
DATE: 9/8/2025
SCALE: AS NOTED

	REVISIONS	
REV. NO.	DESCRIPTION	DATE

DRAWING:
SUMMARY OF QUANTITIES


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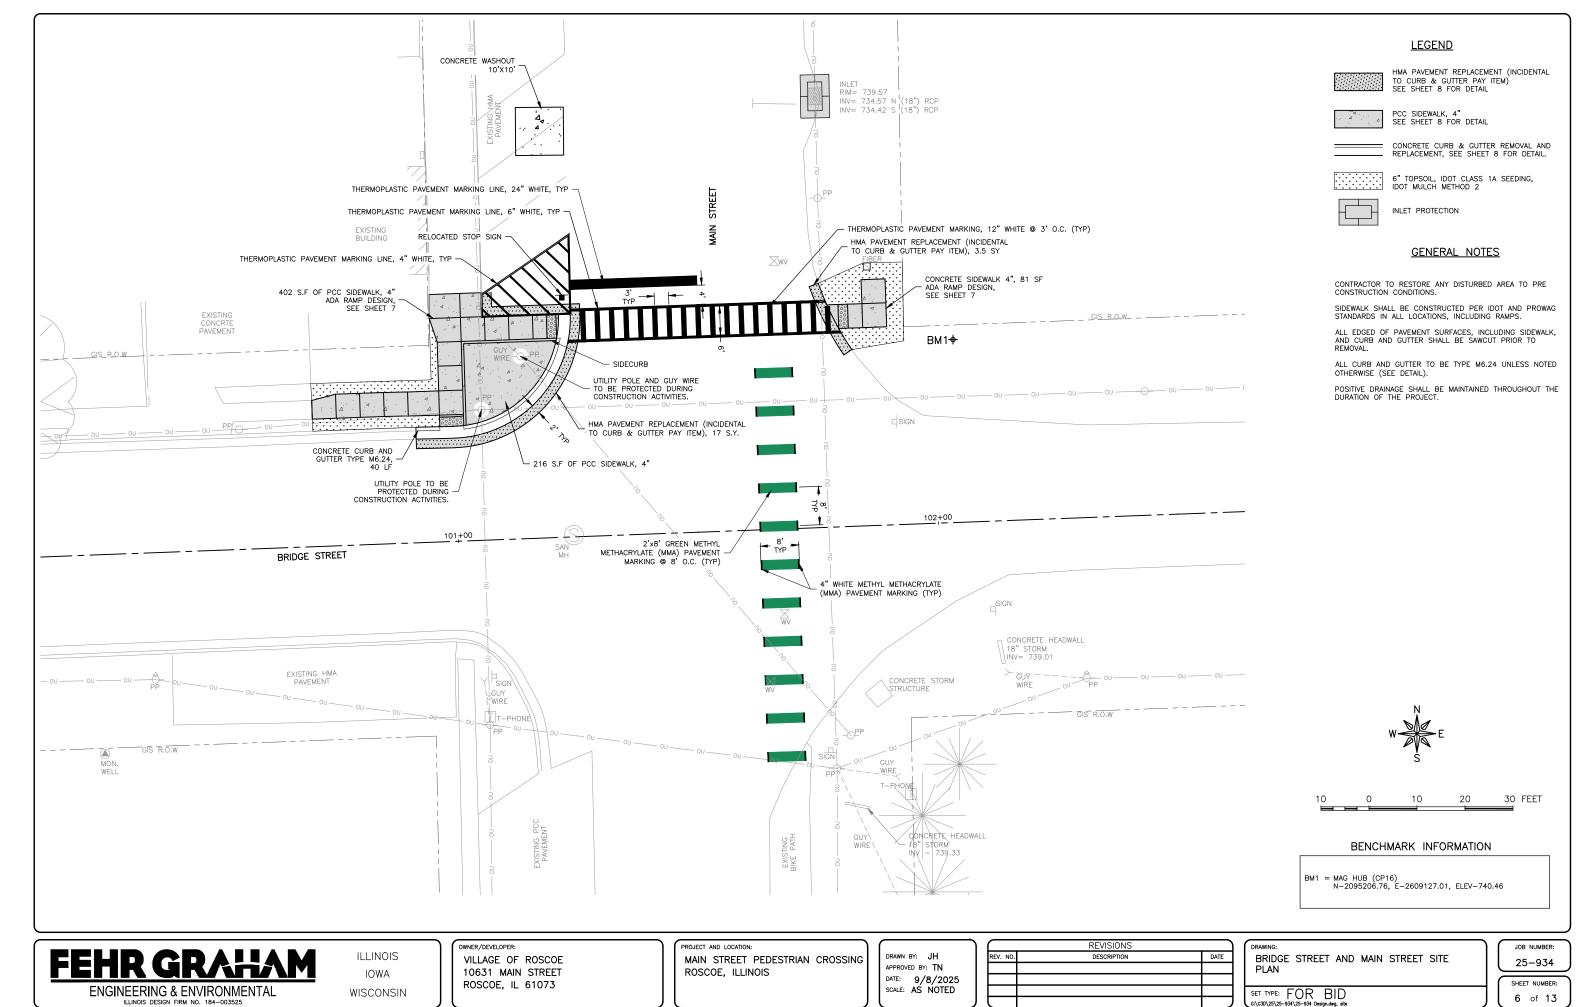
25-934

SHEET NUMBER:


4 of 13



PLOT DATE: 9/8/25 © 2025 FEHR GRAHAM

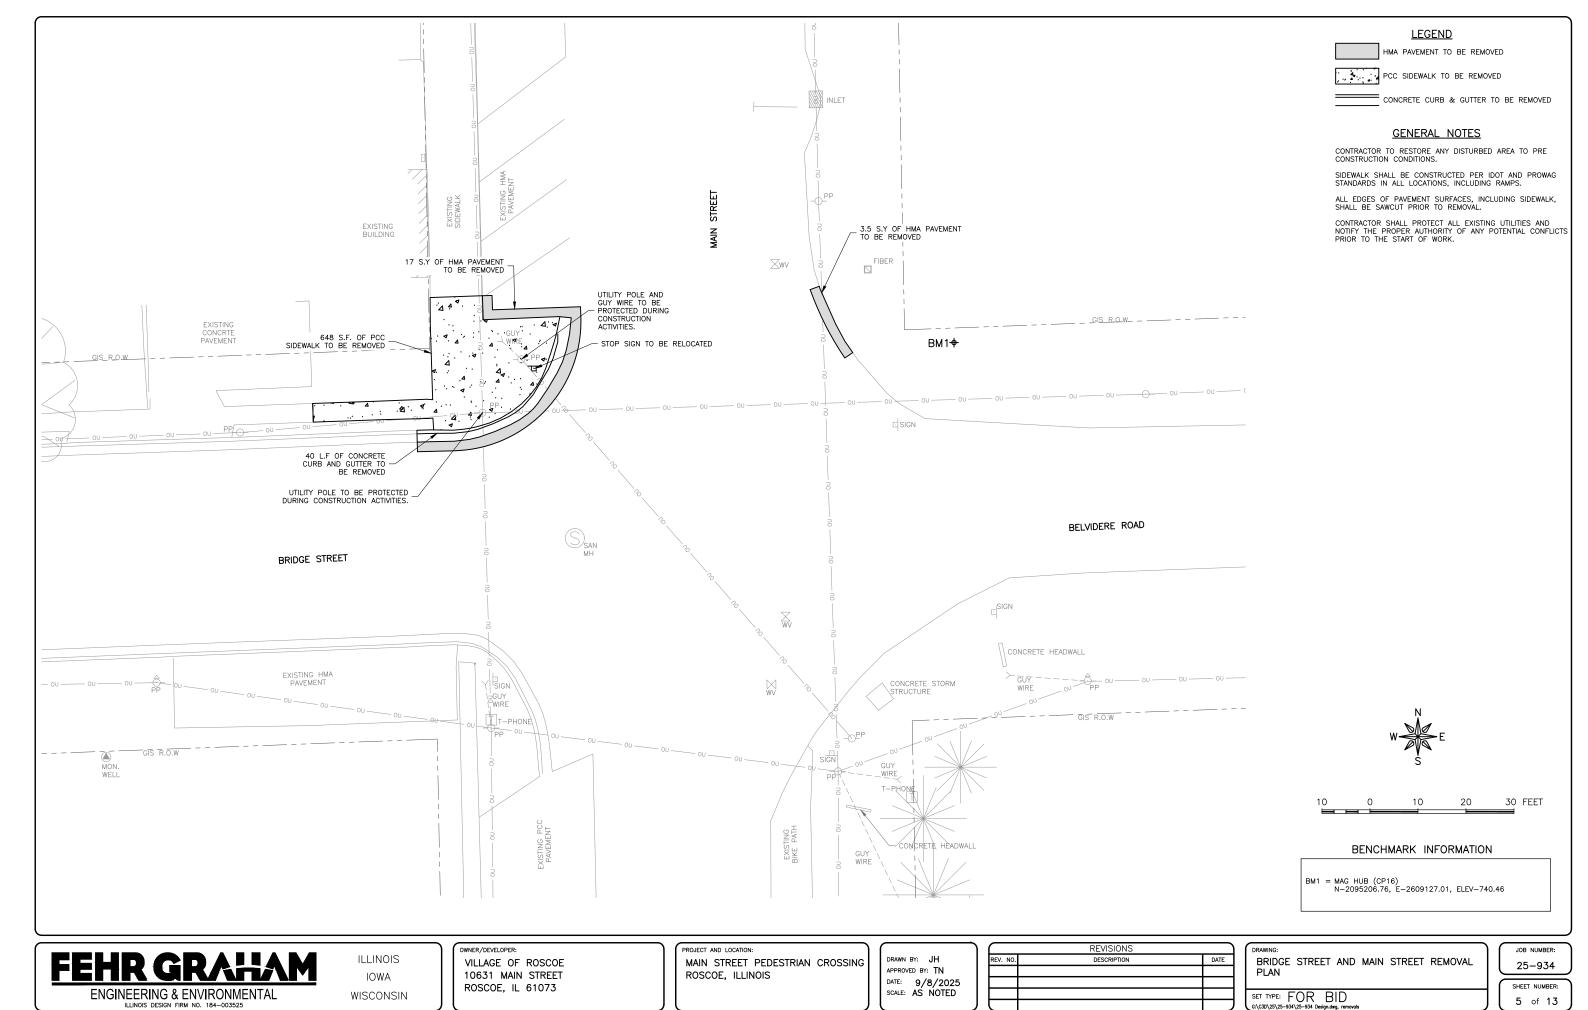

PLOT DATE: 9/8/25 © 2025 FEHR GRAHAM

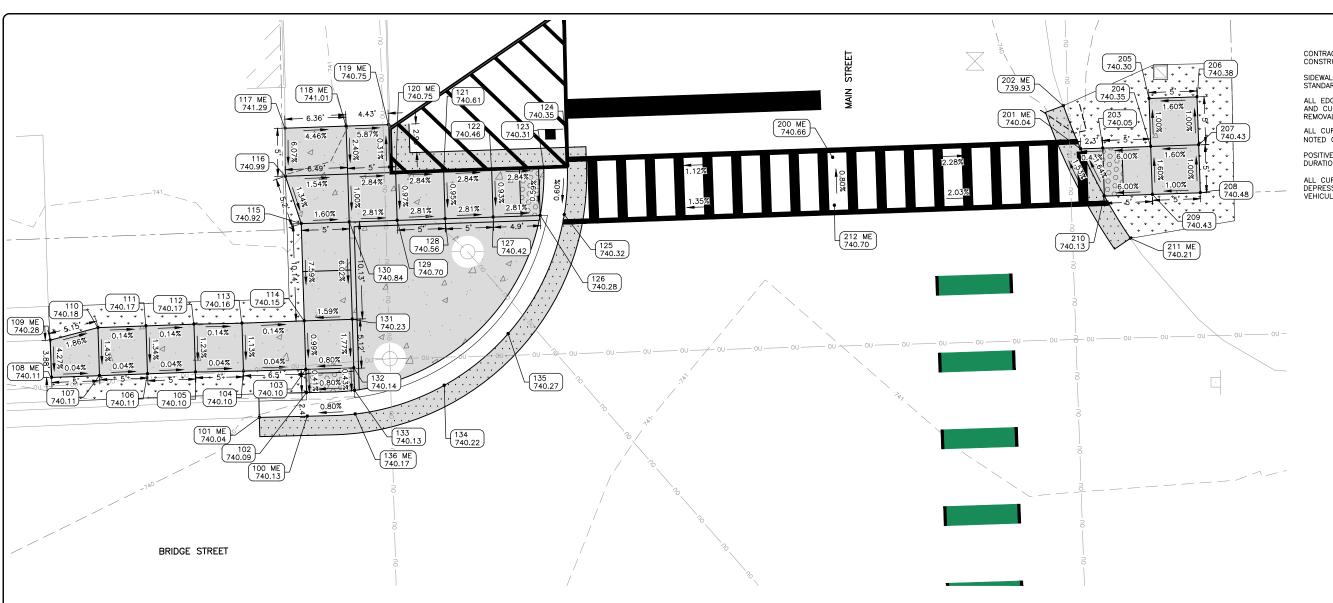

GENERAL NOTES

CONTRACTOR TO RESTORE ANY DISTURBED AREA TO PRE CONSTRUCTION CONDITIONS

SIDEWALK SHALL BE CONSTRUCTED PER IDOT AND PROWAG STANDARDS IN ALL LOCATIONS, INCLUDING RAMPS.

ALL EDGES OF PAVEMENT SURFACES, INCLUDING SIDEWALK, AND CURB AND GUTTER SHALL BE SAWCUT PRIOR TO PEMOVAL

ALL CURB AND GUTTER TO BE TYPE M6.24 UNLESS NOTED OTHERWISE (SEE DETAIL)

POSITIVE DRAINAGE SHALL BE MAINTAINED THROUGHOUT THE DURATION OF THE PROJECT.

ALL CURB & GUTTER TO HAVE 3' TRANSITION FROM DEPRESSED CURB TO STANDARD CURB IN DIRECTIONS OF VEHICULAR TRAVEL.

ADA POINT TABLE				
POINT	STATION	OFFSET	ELEV	
100 ME	100+96.96	-21.53	740.13	
101 ME	100+91.97	-21.59	740.04	
102	100+96.98	-23.99	740.09	
103	100+97.00	-26.41	740.10	
104	100+90.50	-26.47	740.10	
105	100+85.50	-26.56	740.10	
106	100+80.50	-26.57	740.11	
107	100+75.50	-26.56	740.11	
108 ME	100+70.50	-26.57	740.11	
109 ME	100+70.51	-30.46	740.28	
110	100+75.53	-31.58	740.18	
111	100+80.53	-31.57	740.17	
112	100+85.53	-31.56	740.17	
113	100+90.53	-31.47	740.16	
114	100+97.03	-31.47	740.15	
115	100+97.09	-41.61	740.92	
116	100+95.63	-46.59	740.99	
117 ME	100+95.78	-51.60	741.29	
118 ME	101+02.14	-51.58	741.01	

ADA POINT TABLE				
POINT	STATION	OFFSET	ELEV	
119 ME	101+06.56	-51.56	740.75	
120 ME	101+07.12	-46.56	740.75	
121	101+12.12	-46.54	740.61	
122	101+17.12	-46.53	740.46	
123	101+22.55	-46.51	740.31	
124	101+25.01	-46.50	740.35	
125	101+24.50	-41.50	740.32	
126	101+21.99	-41.51	740.28	
127	101+17.09	-41.53	740.42	
128	101+12.09	-41.54	740.56	
129	101+07.09	-41.56	740.70	
130	101+02.09	-41.58	740.84	
131	101+02.03	-31.45	740.23	
132	101+01.99	-26.37	740.14	
133	101+01.98	-24.04	740.13	
134	101+11.33	-24.20	740.22	
135	101+18.18	-29.33	740.27	
136 ME	101+01.97	-21.57	740.17	

ADA POINT TABLE				
POINT	STATION	OFFSET	ELEV	
200 ME	101+52.66	-46.41	740.66	
201 ME	101+78.51	-46.32	740.04	
202 ME	101+76.88	-50.89	739.93	
203	101+80.81	-46.32	740.05	
204	101+85.81	-46.30	740.35	
205	101+85.82	-51.30	740.30	
206	101+90.82	-51.28	740.38	
207	101+90.81	-46.28	740.43	
208	101+90.79	-41.28	740.48	
209	101+85.79	-41.30	740.43	
210	101+80.77	-41.32	740.13	
211 ME	101+83.34	-36.82	740.21	
212 ME	101+52.65	-41.41	740.70	



BENCHMARK INFORMATION

10

BM1 = MAG HUB (CP16) N-2095206.76, E-2609127.01, ELEV-740.46

FEHR GRAHAM

ENGINEERING & ENVIRONMENTAL ILLINOIS DESIGN FIRM NO. 184-003525

ILLINOIS IOWA

WISCONSIN

owner/developer:
VILLAGE OF ROSCOE
10631 MAIN STREET
ROSCOE, IL 61073

PROJECT AND LOCATION:

MAIN STREET PEDESTRIAN CROSSING ROSCOE, ILLINOIS

DRAWN BY: JH
APPROVED BY: TN
DATE: 9/8/2025
SCALE: AS NOTED


	REVISIONS	`
REV. NO.	DESCRIPTION	DATE

DRAWING:
ADA 1 BRIDGE STREET AND MAIN STREET

SET TYPE: FOR BID G:\C30\25\25-934\25-934 Design_dwg. ADA1 JOB NUMBER: 25-934

15 FEET

SHEET NUMBER:

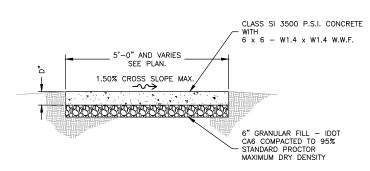

NOTE: WALK CONSTRUCTED OF CLASS SI 3500 PSI CONCRETE WITH 5 TO 8% AIR ENTRAINMENT, 3/4" MAX. AGGREGATE SIZE TO A MINIMUM THICKNESS OF 4". WALK TO BE FINISHED WITH A FLOAT, STEEL TROWEL AND BARN BROOM FINISH WITH TOOLED JOINTS AND EDGES AND CURING COMPOUND. FORMED JOINTS TO BE FINISHED WITH 1/4" RADIUS.

INSTALL 1/2" WIDE EXPANSION JOINTS WITH BITUMINOUS JOINT FILLER AT 30'-0" O.C. (EXTEND FULL DEPTH OF WALK).

SCORE TOOLED JOINTS, 1/2 D DEEP, AT 5'-0" O.C. UNLESS OTHERWISE NOTED. SEE SIDEWALK JOINT DETAILS.

INSTALL 1/2" WIDE BITUMINOUS ISOLATION JOINT WHERE SIDEWALK ABUTS A CURB, CONCRETE DRIVEWAY, STRUCTURE OR AT AN ADJACENT CURB JOINT (EXTEND FULL DEPTH OF WALK).


DEPTH D = 4" MIN. EXCEPT AT CURB RAMPS WHERE D = 6" MIN. OR AT DRIVEWAYS WHERE D = 6" MIN.

SIDEWALK RAMPS AT DRIVES TO BE CONSTRUCTED ACCORDING TO IDOT STANDARD No. 424001.


AGGREGATE BASE COURSE SHALL BE CONSIDERED INCIDENTAL TO THE SIDEWALK PAY ITEM.


EXCAVATION FOR NEW SIDEWALK SHALL BE CONSIDERED INCIDENTAL TO THE SIDEWALK PAY ITEM.

SIDEWALK CROSS SECTION DETAIL

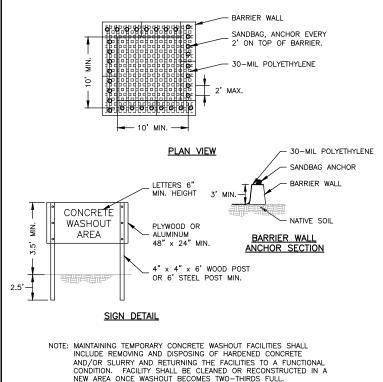

CONCRETE WASHOUT PIT DETAIL

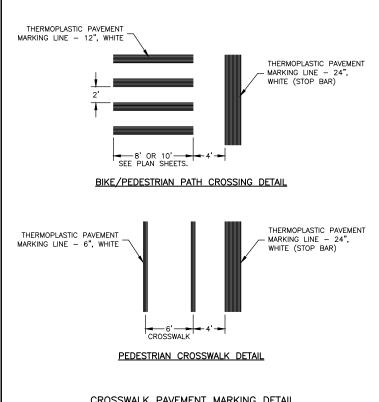


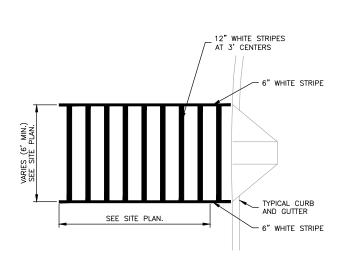


NOTE: MARKINGS FOR STREET SHALL BE ACCORDING TO LOCAL CODE REQUIREMENTS AND AS OUTLINED IN SECTION 3B OF THE "MANUAL ON UNIFORM TRAFFIC CONTROL DEVICES FOR STREETS AND

PEDESTRIAN CROSSWALK DETAIL

CROSSWALK PAVEMENT MARKING DETAIL

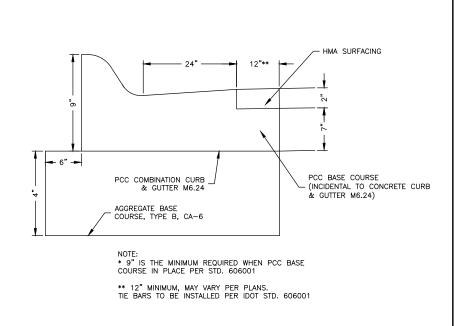

PCC COMBINATION CURB & GUTTER DETAIL TYPE M6.24 (HMA PAVEMENT)

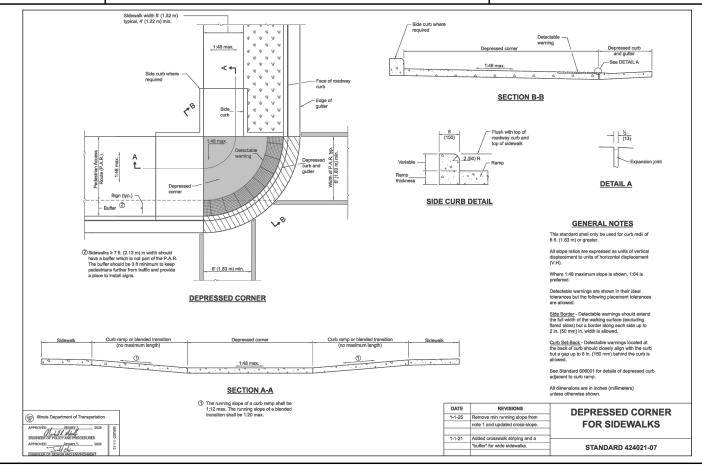

ENGINEERING & ENVIRONMENTAL

ILLINOIS DESIGN FIRM NO. 184-003525

ILLINOIS IOWA

WISCONSIN

OWNER/DEVELOPER VILLAGE OF ROSCOE 10631 MAIN STREET ROSCOE, IL 61073

PROJECT AND LOCATION:


MAIN STREET PEDESTRIAN CROSSING ROSCOE, ILLINOIS


RAWN BY: JH APPROVED BY: TN DATE: 9/8/2025 SCALE: AS NOTED


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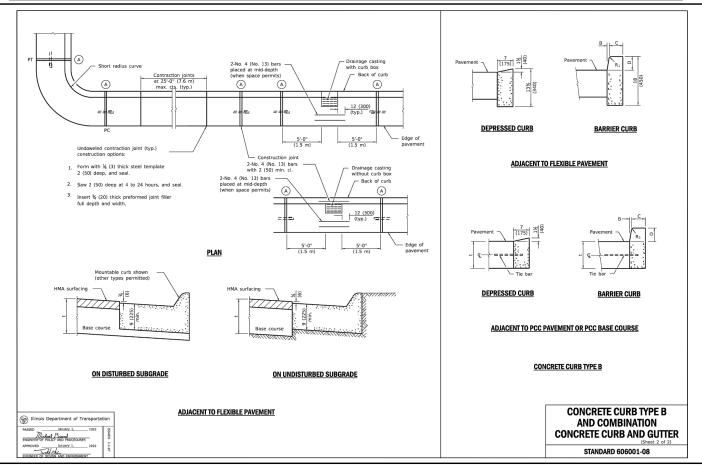
DETAILS 1 SET TYPE: FOR BID

JOB NUMBER 25-934 SHEET NUMBER: 8 of 13



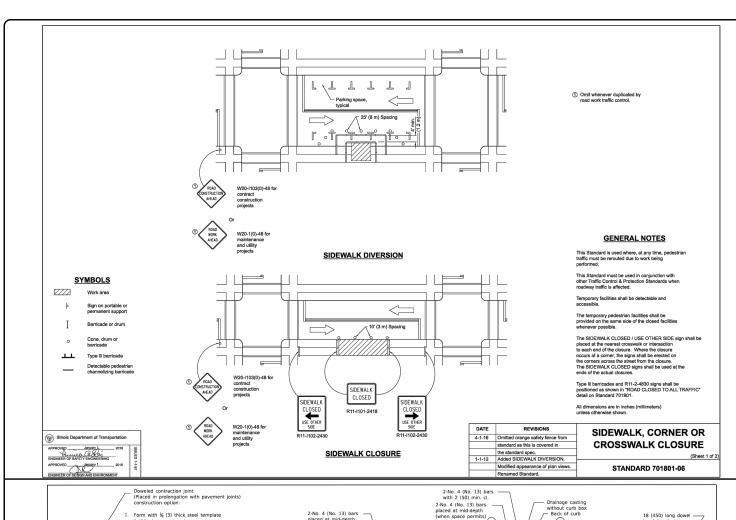

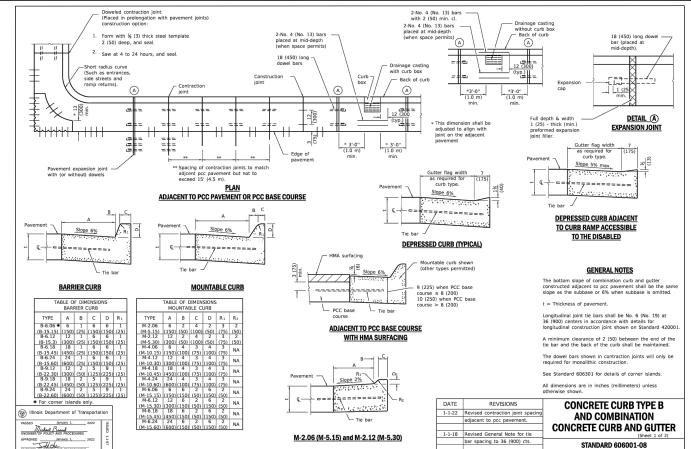

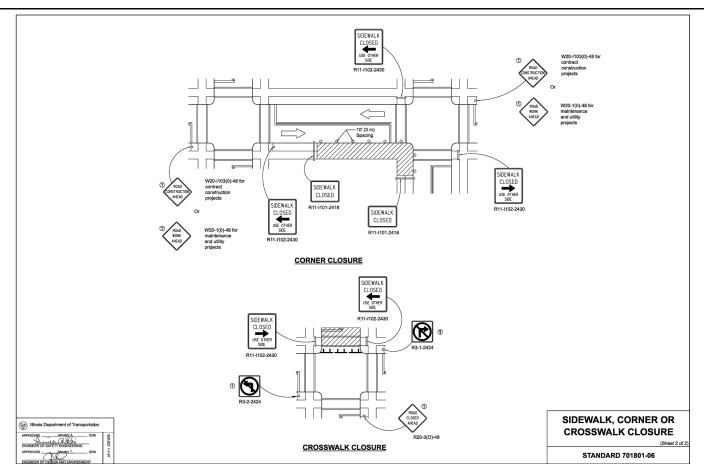



ENGINEERING & ENVIRONMENTAL ILLINOIS DESIGN FIRM NO. 184-003525

ILLINOIS IOWA

WISCONSIN

VILLAGE OF ROSCOE 10631 MAIN STREET ROSCOE, IL 61073

OWNER/DEVELOPER:

PROJECT AND LOCATION:


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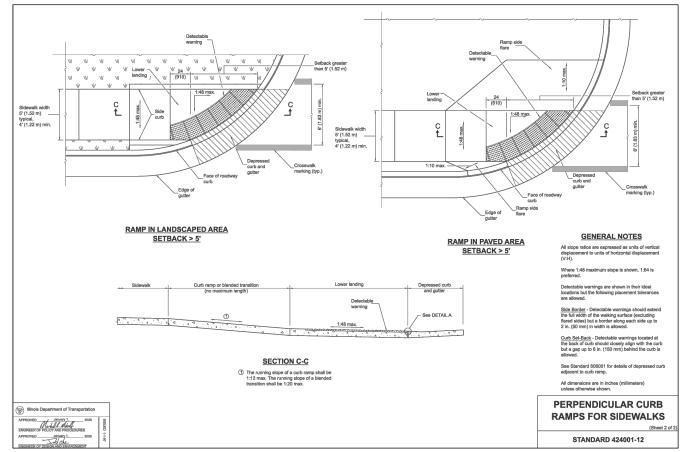
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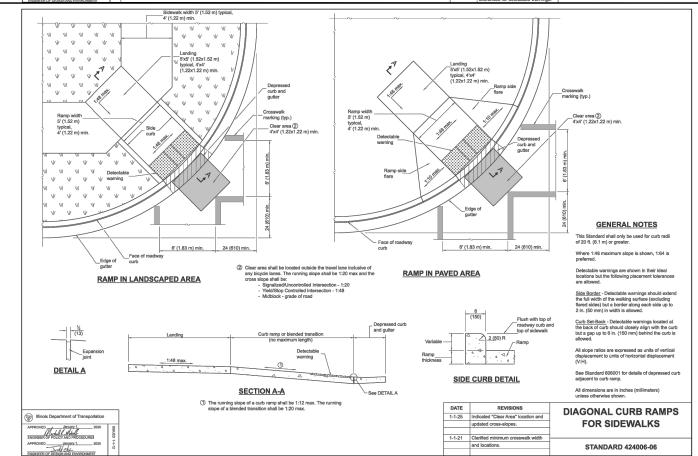
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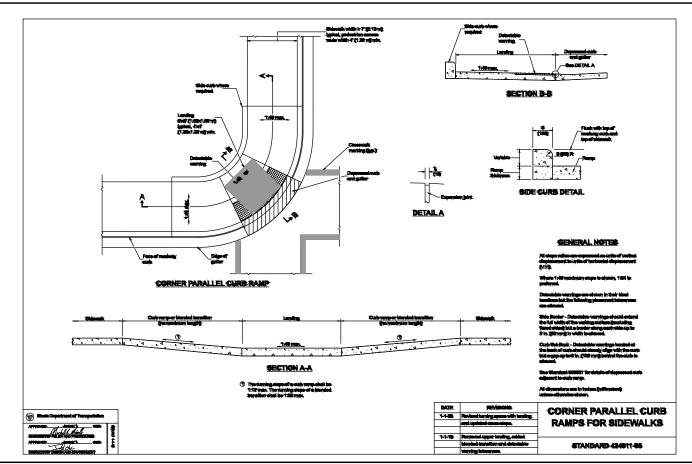
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JOB NUMBER: 25-934 SHEET NUMBER: 9 of 13









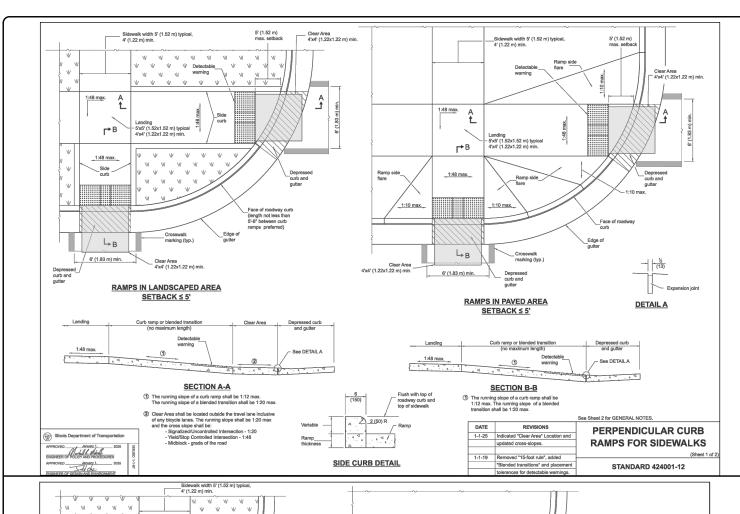

ILLINOIS IOWA

WISCONSIN

VILLAGE OF ROSCOE 10631 MAIN STREET ROSCOE, IL 61073 PROJECT AND LOCATION:

MAIN STREET PEDESTRIAN CROSSING
ROSCOE, ILLINOIS

DRAWN BY: JH
APPROVED BY: TN
DATE: 9/8/2025
SCALE: AS NOTED


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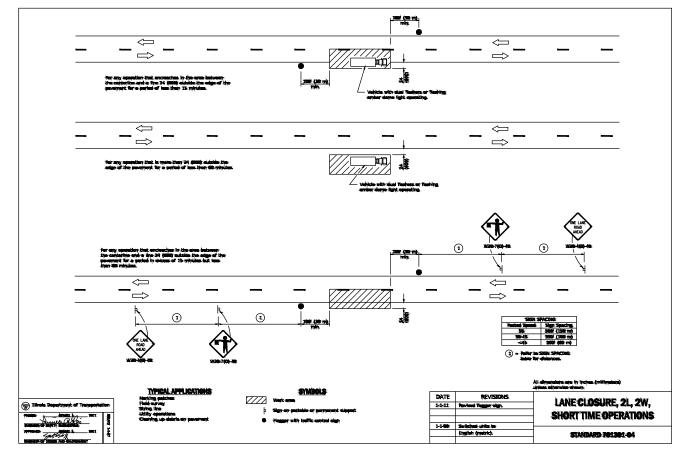
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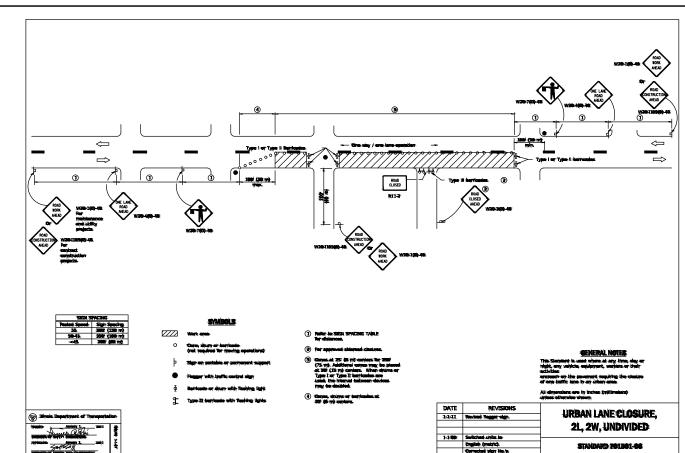
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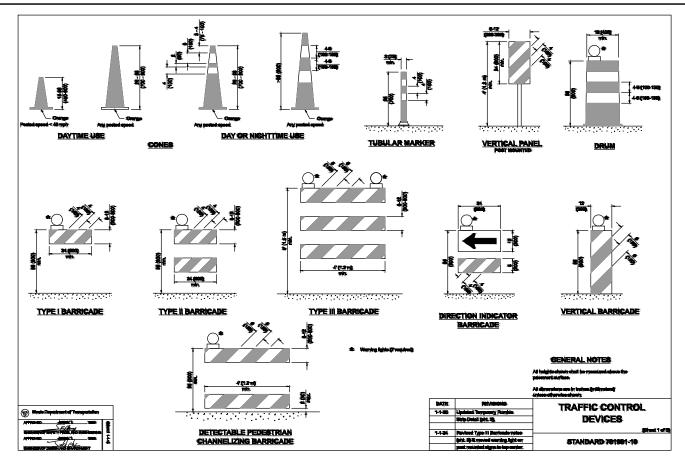
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SHEET NUMBER: 10 of 13









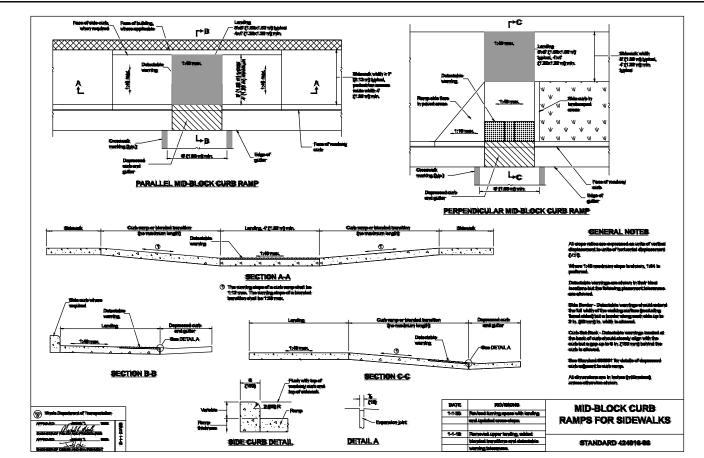

ILLINOIS IOWA WISCONSIN WNER/DEVELOPER:
VILLAGE OF ROSCOE
10631 MAIN STREET
ROSCOE, IL 61073

PROJECT AND LOCATION:

MAIN STREET PEDESTRIAN CROSSING
ROSCOE, ILLINOIS


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DATE: 9/8/2025	
SCALE: AS NOTED	
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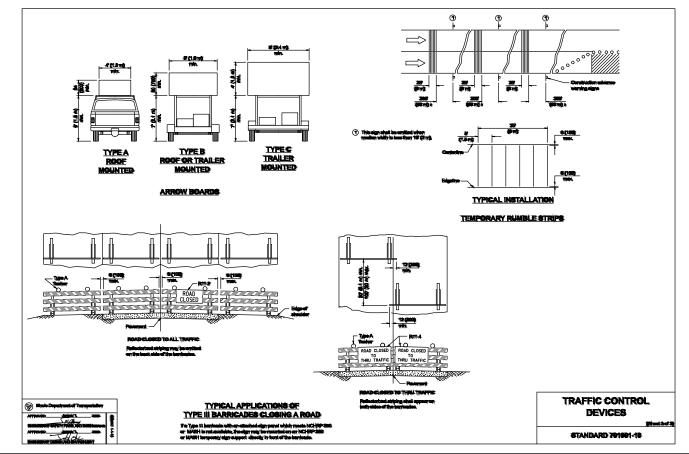
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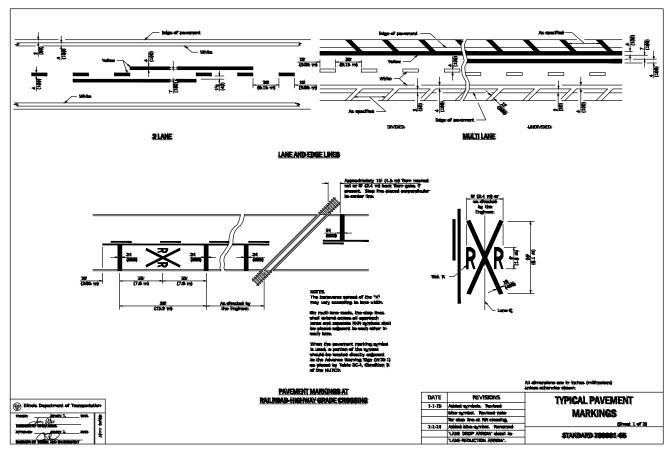
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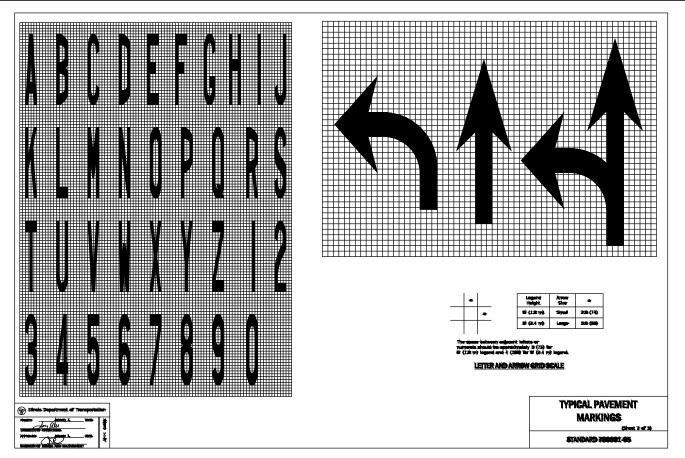
JOB NUMBER: 25-934

SHEET NUMBER: 11 of 13







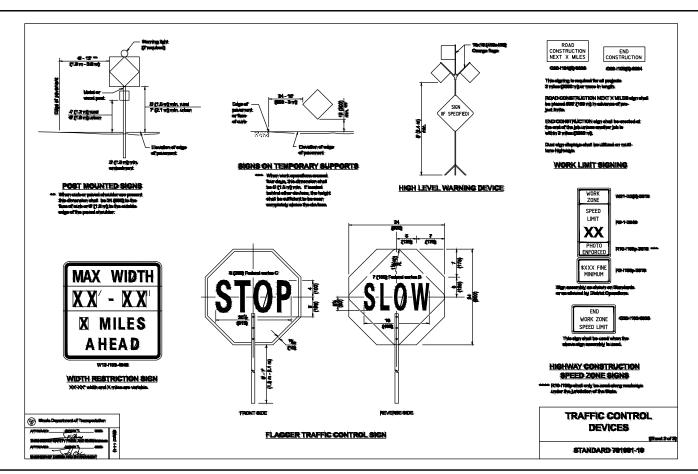



ILLINOIS IOWA WISCONSIN owner/developer:

VILLAGE OF ROSCOE
10631 MAIN STREET
ROSCOE, IL 61073

PROJECT AND LOCATION:

MAIN STREET PEDESTRIAN CROSSING ROSCOE, ILLINOIS

DRAWN BY: JH
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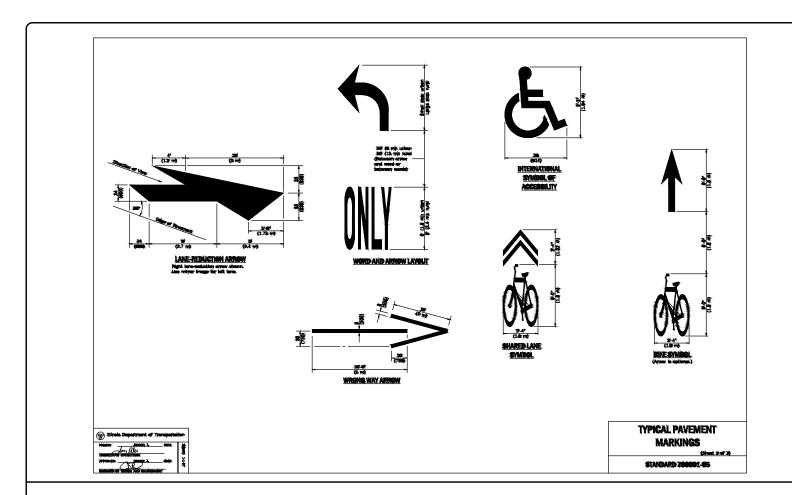
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DETAILS 5

SET TYPE: FOR BID

JOB NUMBER:
25-934

SHEET NUMBER:

12 of 13



FEHR GRAHAM

ILLINOIS IOWA WISCONSIN OWNER/DEVELOPER:

VILLAGE OF ROSCOE

10631 MAIN STREET

ROSCOE, IL 61073

PROJECT AND LOCATION:

MAIN STREET PEDESTRIAN CROSSING ROSCOE, ILLINOIS

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SCALE: AS NOTED

	REVISIONS	
REV. NO.	DESCRIPTION	DATE

DRAWING:
DETAILS 6

SET TYPE: FOR BID
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25-934 SHEET NUMBER: 13 of 13

JOB NUMBER: