



<u>LEGEND</u>


HMA PAVEMENT

CONCRETE PAVEMENT

AGGREGATE PAVEMENT

- NOTE:

 1. BASE BID TO BE FUNDED BY DCEO GRANT AND CITY OF ROCHELLE FUNDS. IMPROVEMENTS GENERALLY INCLUDE ALL GRADING, CONCRETE AND HMA PAVING, AND IMPROVEMENTS ADJACENT TO THE EXISTING RAIL SPUR.
- 2. ALTERNATE BID IS TO BE FUNDED BY GREDCO AND GENERALLY INCLUDES ALL GRADING, STORM WATER MANAGEMENT, STORM SEWER AND AGGREGATE PAVEMENT IMMEDIATELY NORTH OF THE BASE BID.

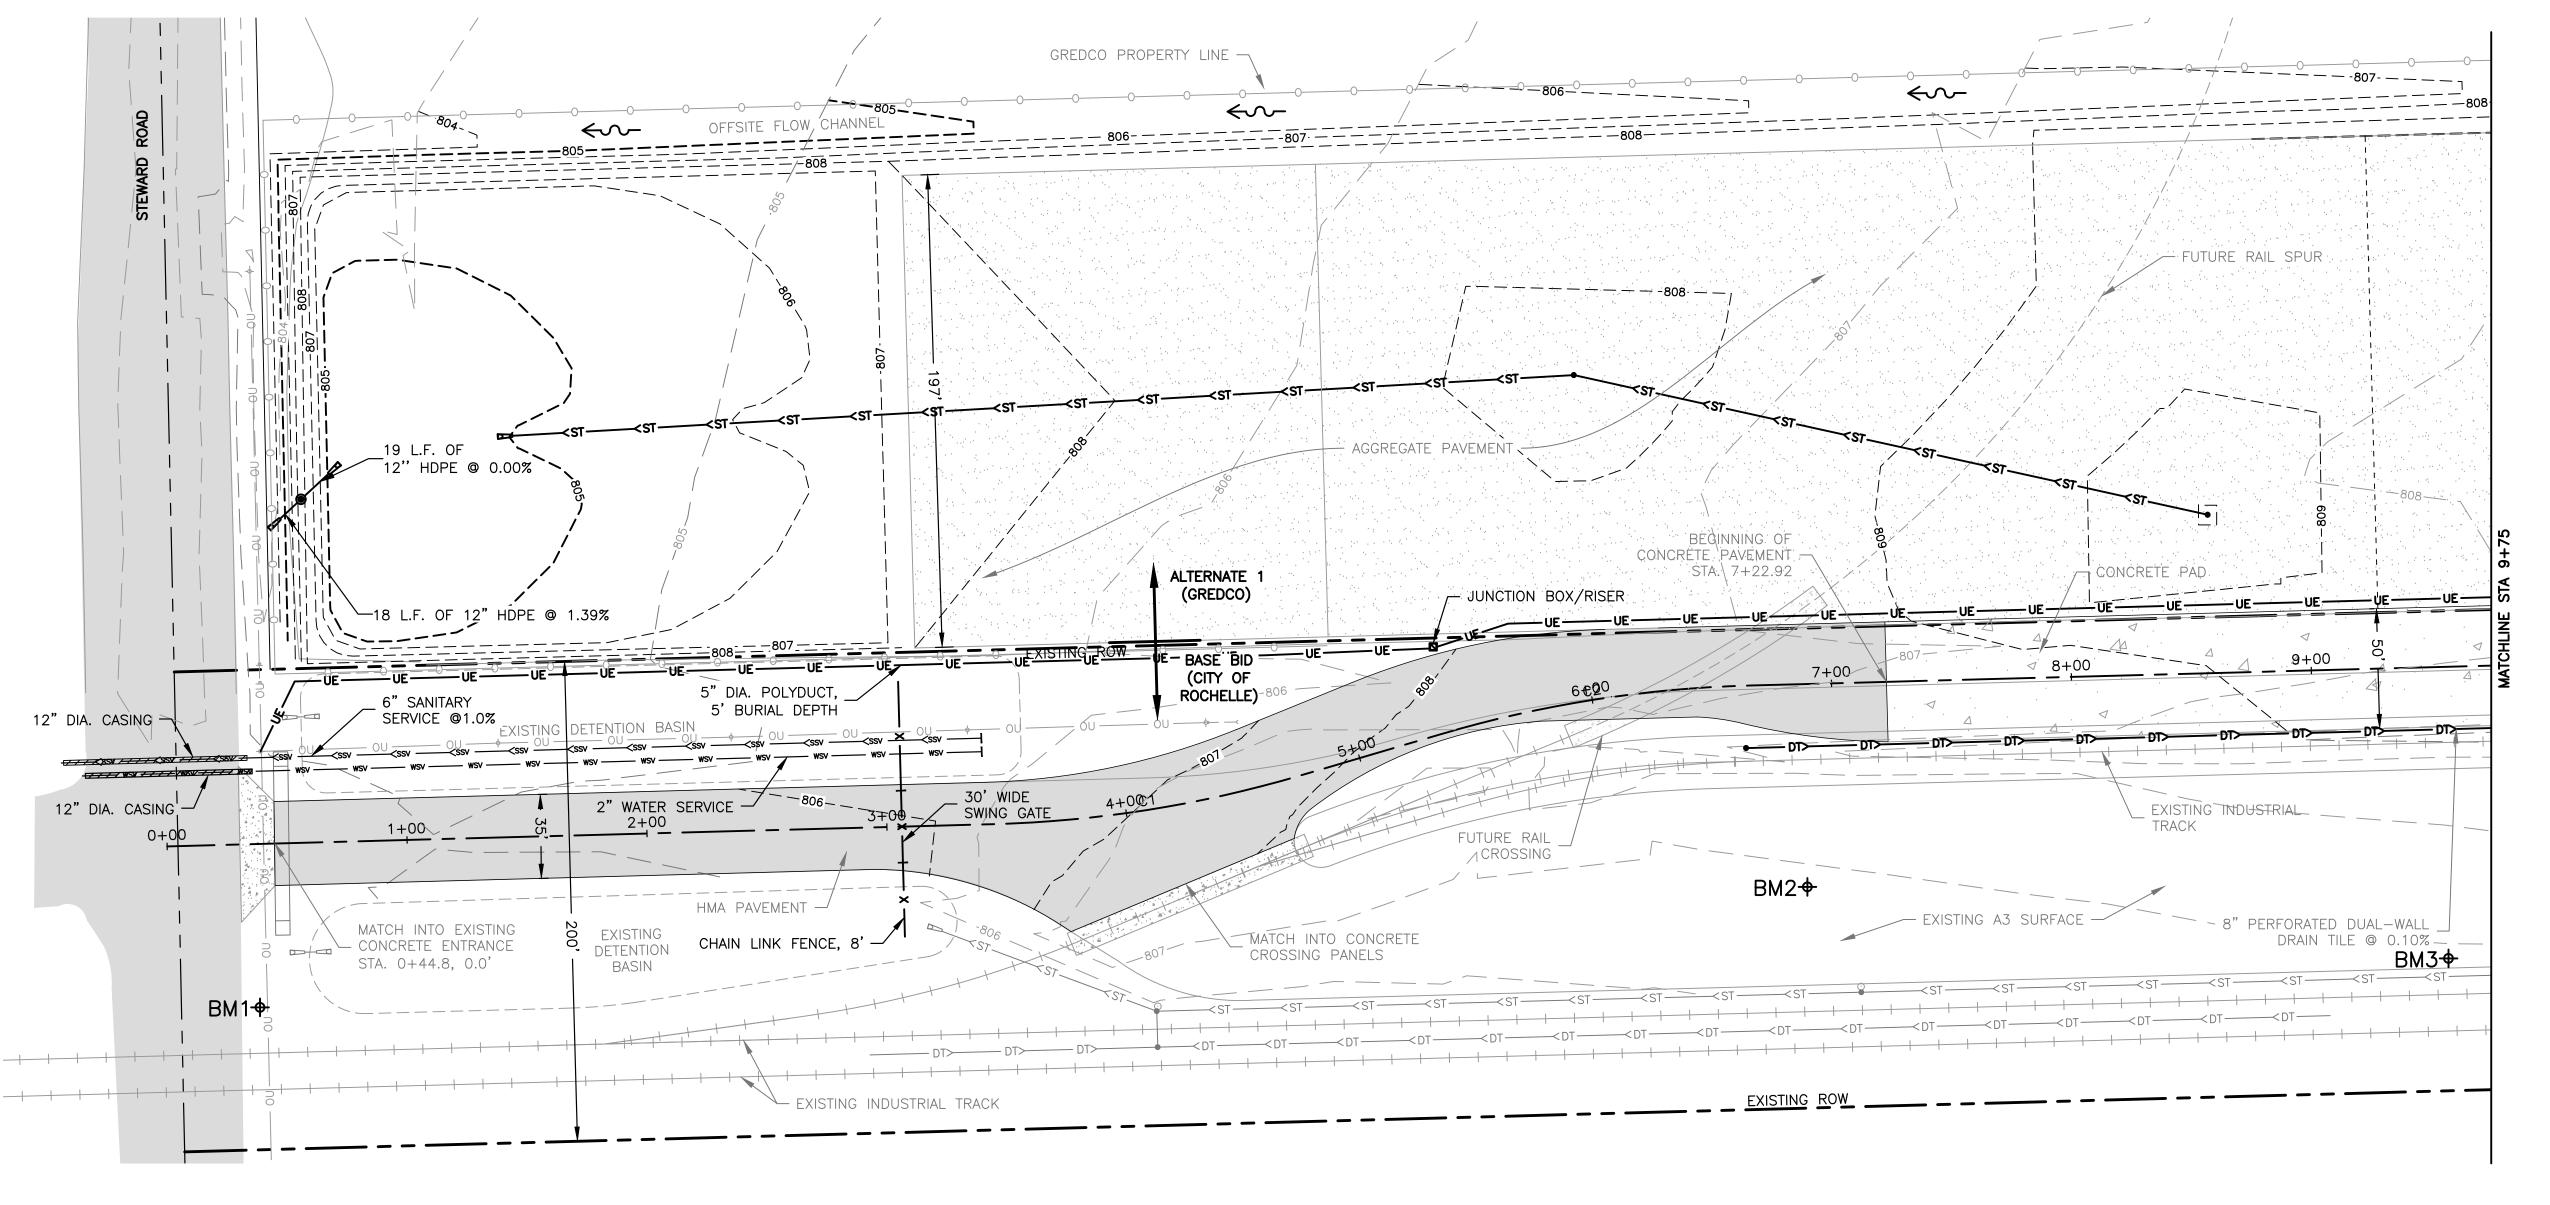

COATED SAND SOLUTIONS

CURVE TABLE										
CURVE #	R	L	Т	Δ	CHORD	BEARING	Е	PC STA	PI STA	PT STA
C1	499.70	129.49	65.11	014°50'50"	129.13	N81°01'56"E	4.19	3+44.22	4+09.33	4+73.71
C2	500.00	129.60	65.17	014°51'05"	129.24	N81°02'04"E	4.19	5+35.63	6+00.80	6+65.23

FEHR GRAHAM

ENGINEERING & ENVIRONMENTAL ILLINOIS DESIGN FIRM NO. 184-003525

ILLINOIS IOWA

WISCONSIN

OWNER/DEVELOPER: CITY OF ROCHELLE 420 NORTH SIXTH STREET ROCHELLE, IL 61068

PROJECT AND LOCATION: PROPOSED TRANSLOAD YARD **EXPANSION** ROCHELLE, ILLINOIS


DRAWN BY: YJ APPROVED BY: NJC DATE: 03/03/23 SCALE: AS NOTED

	REVISIONS	
REV. NO.	DESCRIPTION	DATE

DRAWING: SITE PLAN 1	
SET TYPE: CHANGE ORDER G:\C3D\20\20-1026A\20-1026A - DESIGN.dwg, SITE	1

JOB NUMBER: 20-1026A SHEET NUMBER: **3** of .



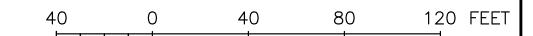



HMA PAVEMENT

CONCRETE PAVEMENT

AGGREGATE PAVEMENT

- NOTE:

 1. BASE BID TO BE FUNDED BY DCEO GRANT AND CITY OF ROCHELLE FUNDS. IMPROVEMENTS GENERALLY INCLUDE ALL GRADING, CONCRETE AND HMA PAVING, AND IMPROVEMENTS ADJACENT TO THE EXISTING RAIL SPUR.
- 2. ALTERNATE BID IS TO BE FUNDED BY GREDCO AND GENERALLY INCLUDES ALL GRADING, STORM WATER MANAGEMENT, STORM SEWER AND AGGREGATE PAVEMENT IMMEDIATELY NORTH OF THE BASE BID.

CONNECT TO EXISTING 8" DRAIN TILE. - INV=800.75± ONTRACTOR TO FIELD

8" CONCRETE HEADWALL TILE OUTLET

18+00

CONCRETE PAD -

CONNECT TO EXISTING FIELD TILE WITH 2' DIA. CATCH BASIN WITH CLOSED LID

> 8" DIA. PERFORATED DUAL-WALL DRAIN TILE

CONTRACTOR TO FIELD

- RIM=808.00

VERIFY

INV=801.75±

FEHR GRAHAM

5" DIA. POLYDUCT,

5' BURIAL DEPTH

ILLINOIS IOWA WISCONSIN OWNER/DEVELOPER: CITY OF ROCHELLE 420 NORTH SIXTH STREET ROCHELLE, IL 61068

OFFSITE FLOW CHANNEL

 $\leftarrow \sim$

-- AGGREGATE PAVEMENT

EXISTING ROW

- EXISTING INDUSTRIAL TRACK

13+00

14" CONCRETE PAD —

12+004

273 L.F. OF

ALTERNATE 1

(GREDCO)

BASE BID (CITY OF

12" HDPE @ 0.10%

PROJECT AND LOCATION: PROPOSED TRANSLOAD YARD **EXPANSION** ROCHELLE, ILLINOIS

-√>

CONCRETE PAD —

LIGHT POLE

AND BASE

METER BASE AND 200A

SINGLE PHASE SERVICE

DRAIN TILE @ 0.10%

DRAWN BY: YJ APPROVED BY: NJC DATE: 03/03/23 SCALE: AS NOTED

	REVISIONS	
REV. NO.	DESCRIPTION	DATE


DRAWING: SITE PLAN 2


SET TYPE: CHANGE ORDER 1 G:\C3D\20\20-1026A\20-1026A - DESIGN.dwg, SITE (2)

JOB NUMBER: 20-1026A SHEET NUMBER:

4 of .

ENGINEERING & ENVIRONMENTAL ILLINOIS DESIGN FIRM NO. 184-003525 © 2023 FEHR GRAHAM

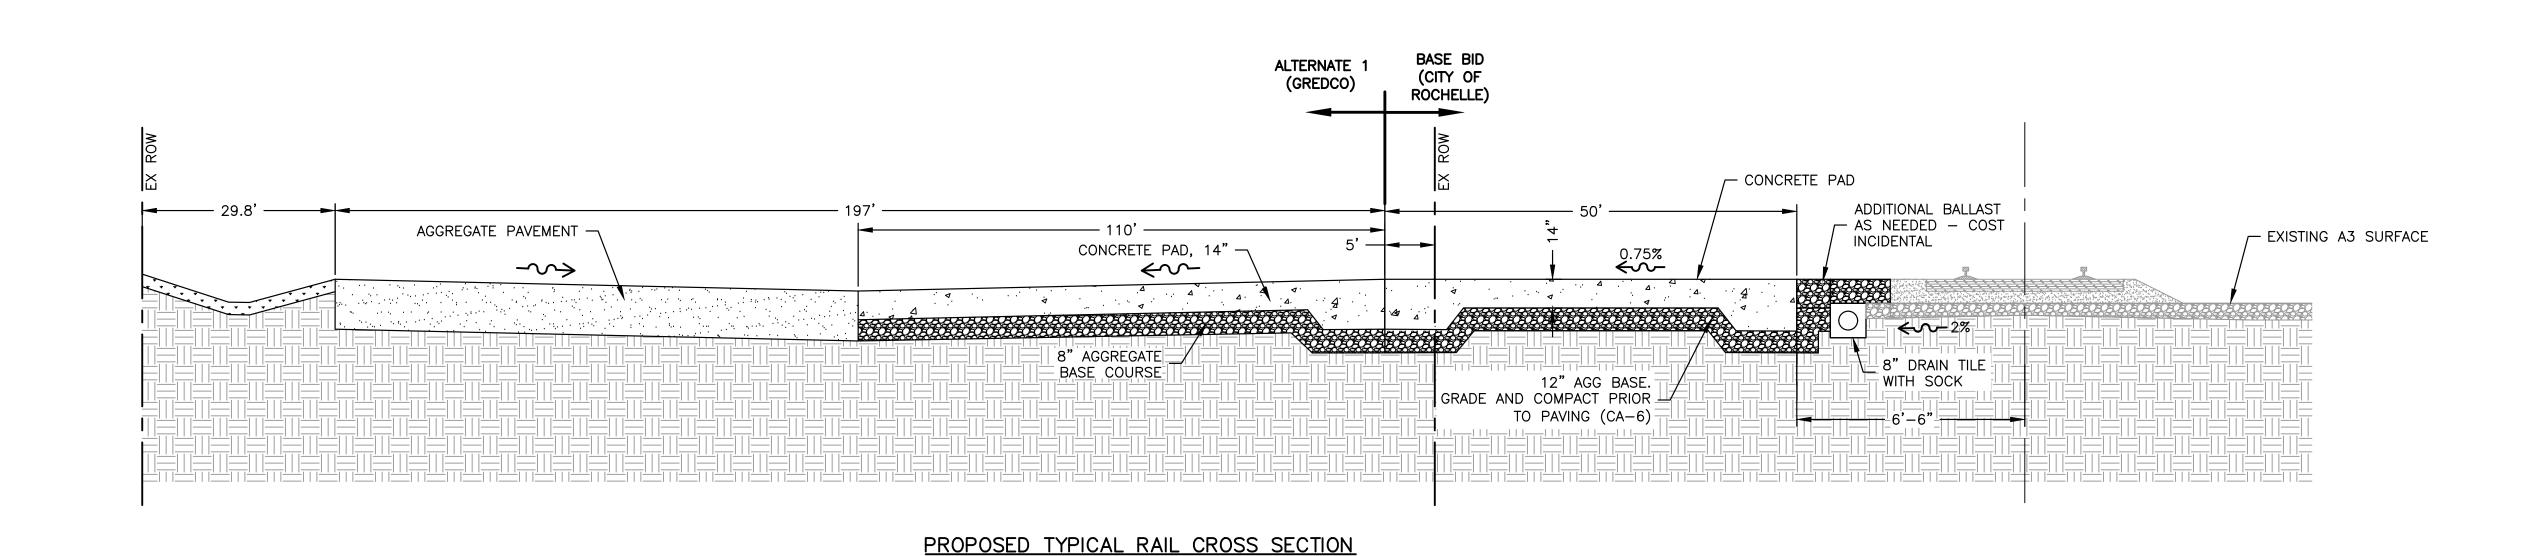

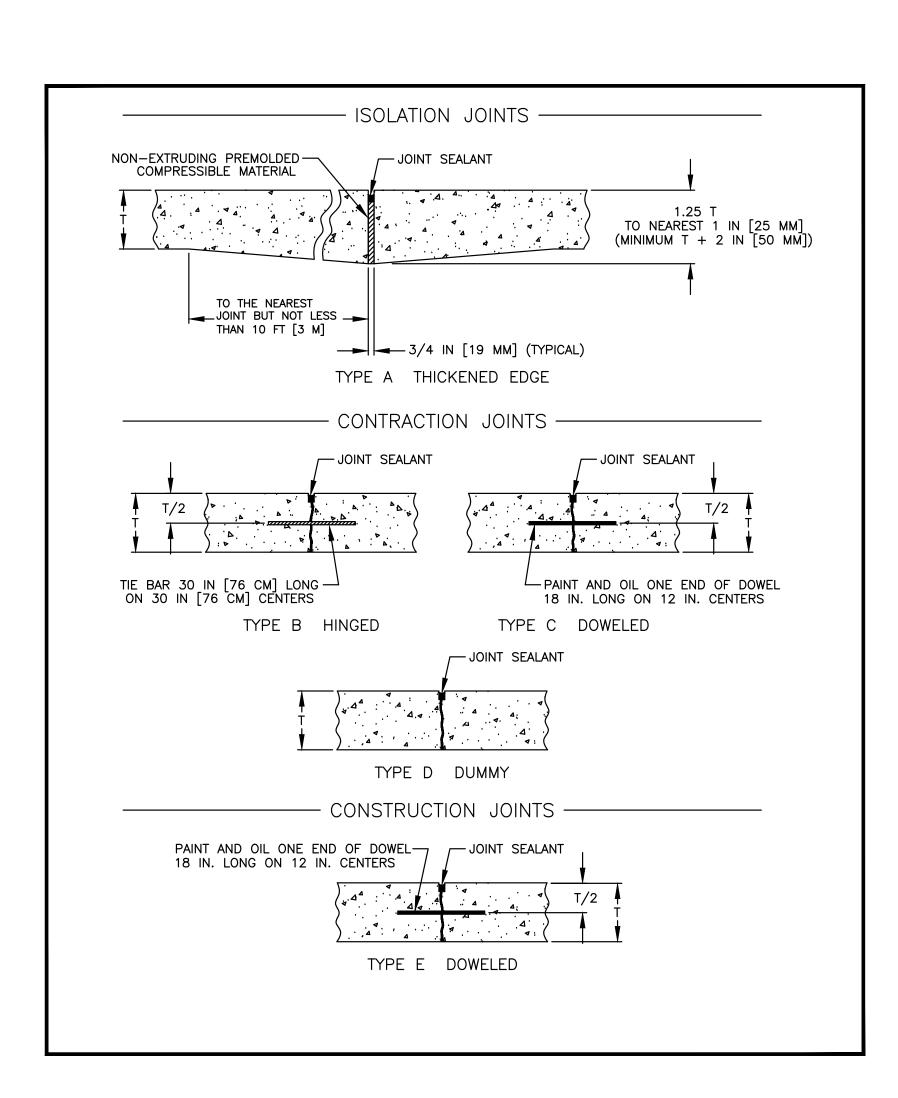



ENGINEERING & ENVIRONMENTAL

ILLINOIS IOWA WISCONSIN OWNER/DEVELOPER:
CITY OF ROCHELLE
420 NORTH SIXTH STREET
ROCHELLE, IL 61068

PROPOSED TRANSLOAD YARD EXPANSION ROCHELLE, ILLINOIS

DRAWN BY: YJ
APPROVED BY: NJC
DATE: 03/03/23
SCALE: AS NOTED

	REVISIONS	
REV. NO.	DESCRIPTION	DATE


	DRAWING:
	DETAILS
	OLIANIOE ODDED 4
	SET TYPE: CHANGE ORDER 1
- (G:\C3D\20\20-1026A\Plans\20-1026 - Plans.dwg, DET

JOB NUMBER:


20-1026A

SHEET NUMBER:

5 of .

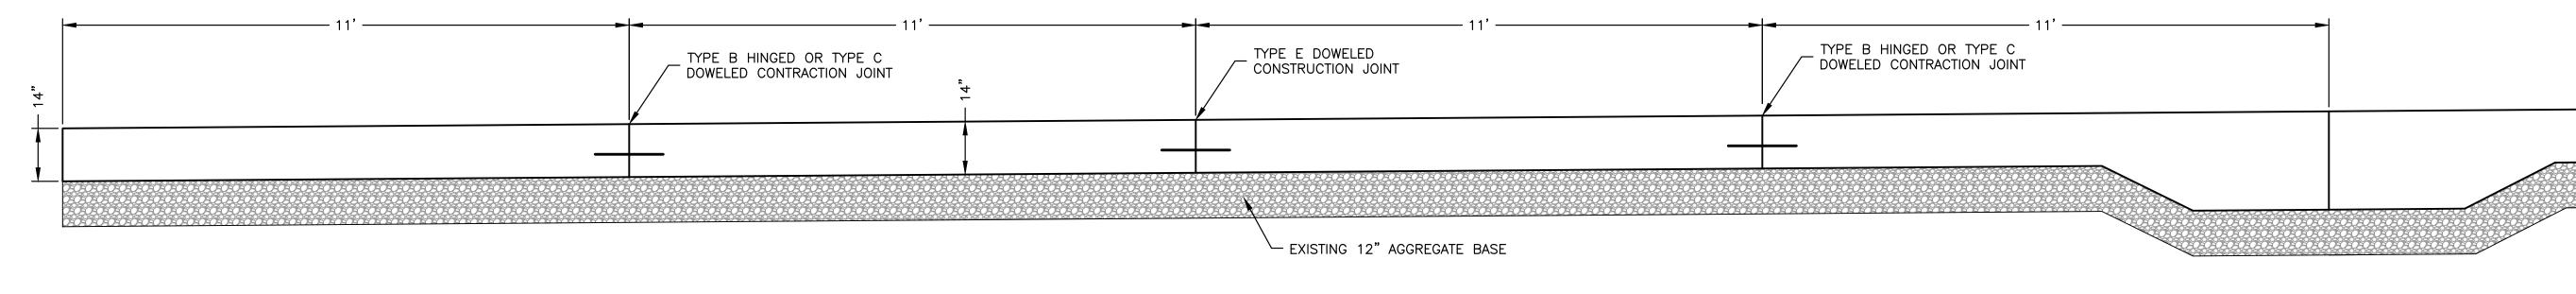

CONCRETE PAD N.T.S.

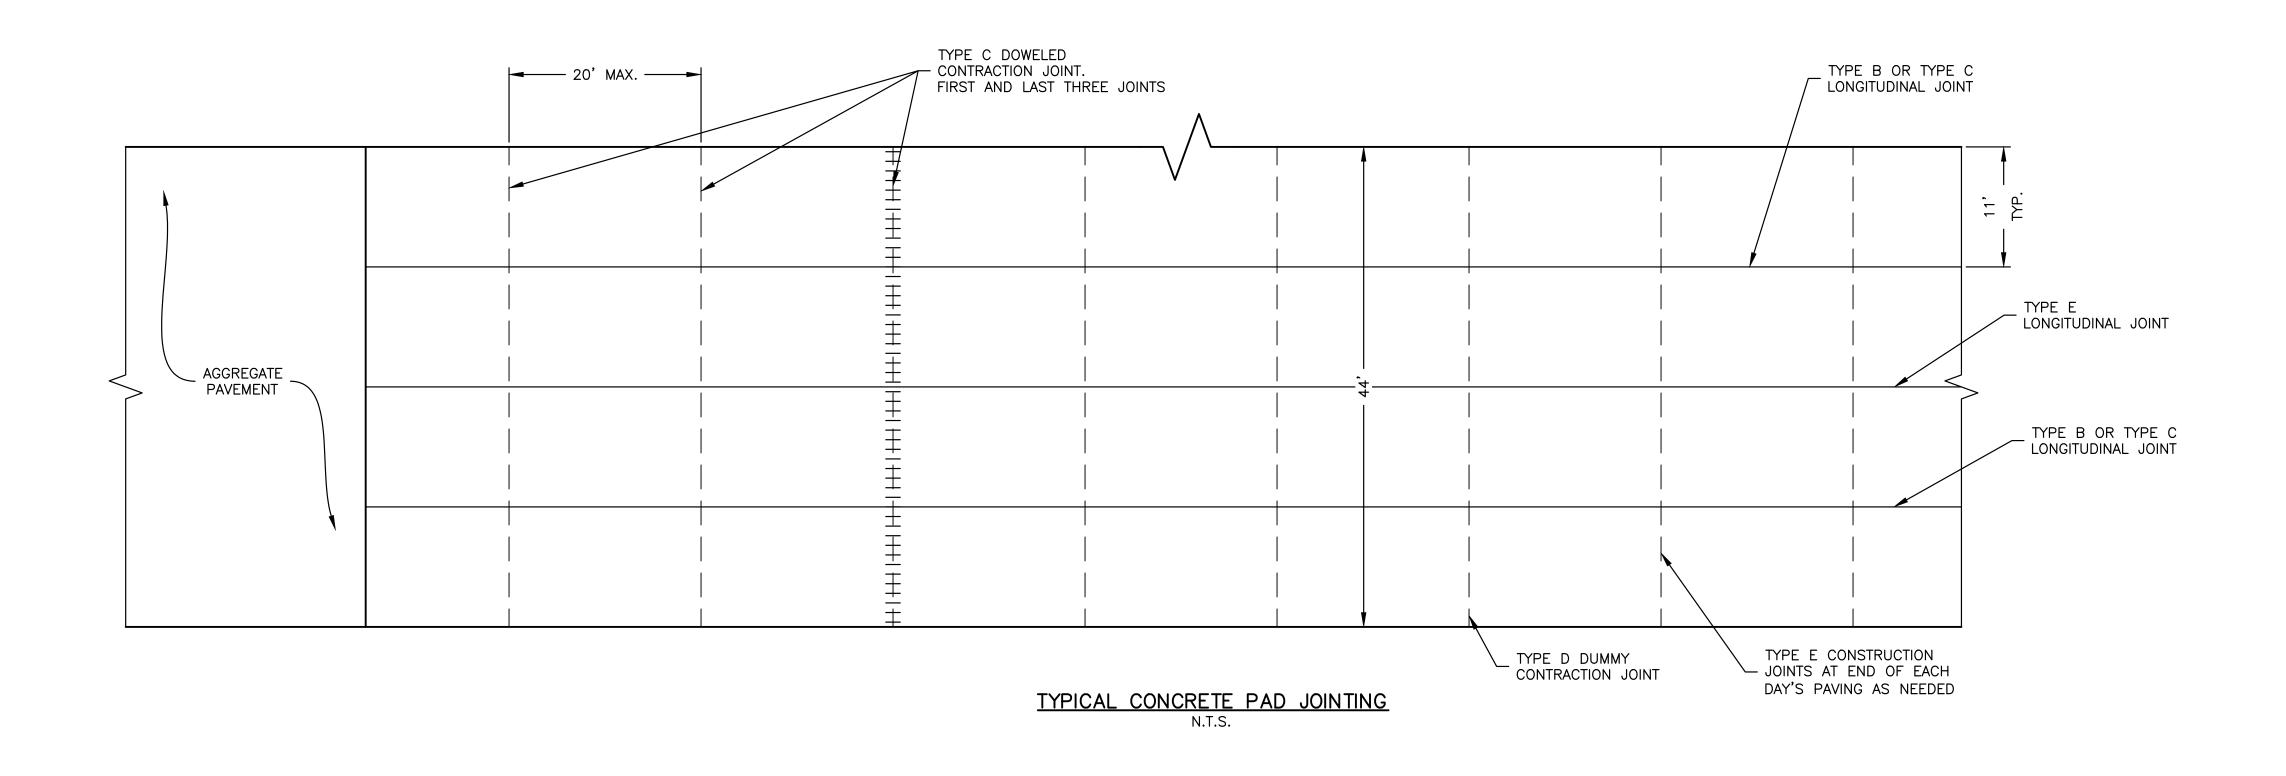

FEHR GRAHAM

ENGINEERING & ENVIRONMENTAL

ILLINOIS IOWA

WISCONSIN

OWNER/DEVELOPER:
CITY OF ROCHELLE
420 NORTH SIXTH STREET
ROCHELLE, IL 61068

PROPOSED TRANSLOAD YARD EXPANSION ROCHELLE, ILLINOIS

DRAWN BY: YJ
APPROVED BY: NJC
DATE: 03/03/23
SCALE: AS NOTED


DRAWING:
DETAILS

SET TYPE: CHANGE ORDER 1
G:\C3D\20\20-1026A\Plans\20-1026 - Plans.dwg, DET 1

DATE

JOB NUMBER:
20-1026A

SHEET NUMBER:
6 of .

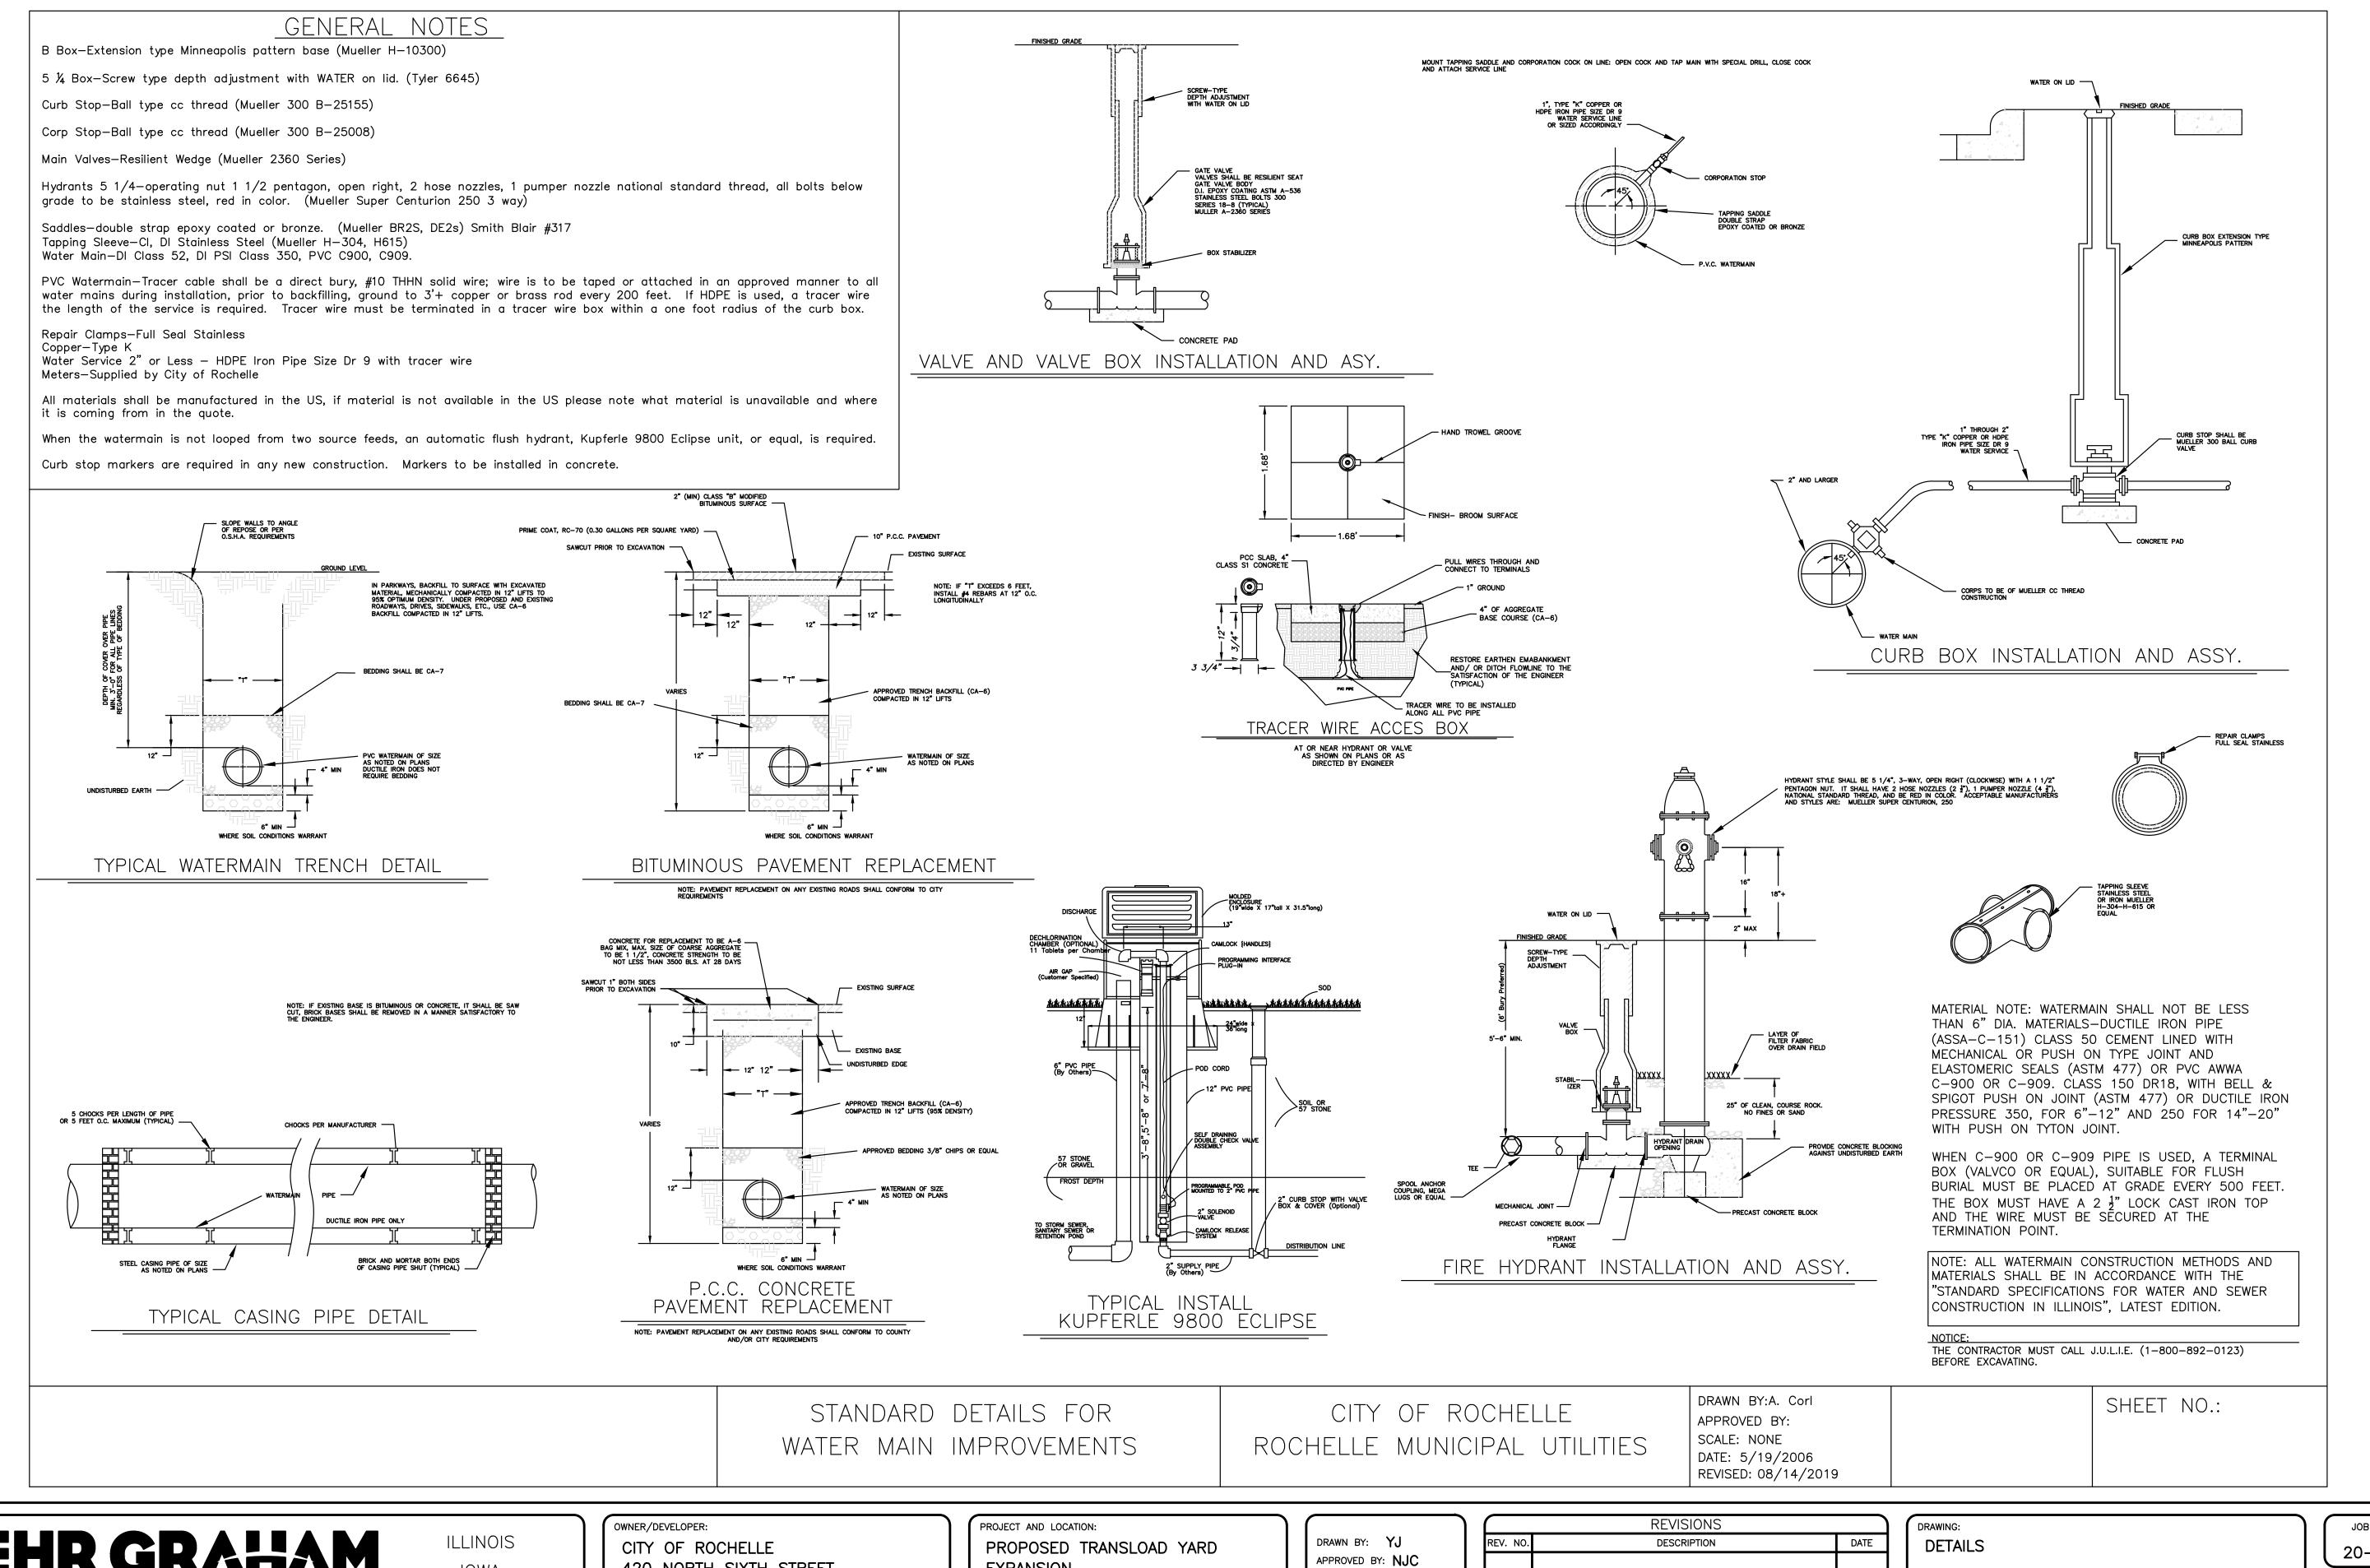

FEHR GRAHAM

ENGINEERING & ENVIRONMENTAL

ILLINOIS DESIGN FIRM NO. 184-003525

IOWA

WISCONSIN

420 NORTH SIXTH STREET ROCHELLE, IL 61068


EXPANSION ROCHELLE, ILLINOIS DATE: 03/03/23 SCALE: AS NOTED

SET TYPE: CHANGE ORDER 1

2:\C3D\20\20-1026A\Plans\20-1026 - Plans.dwg, DET 1A

JOB NUMBER: 20-1026A SHEET NUMBER:

7 of .

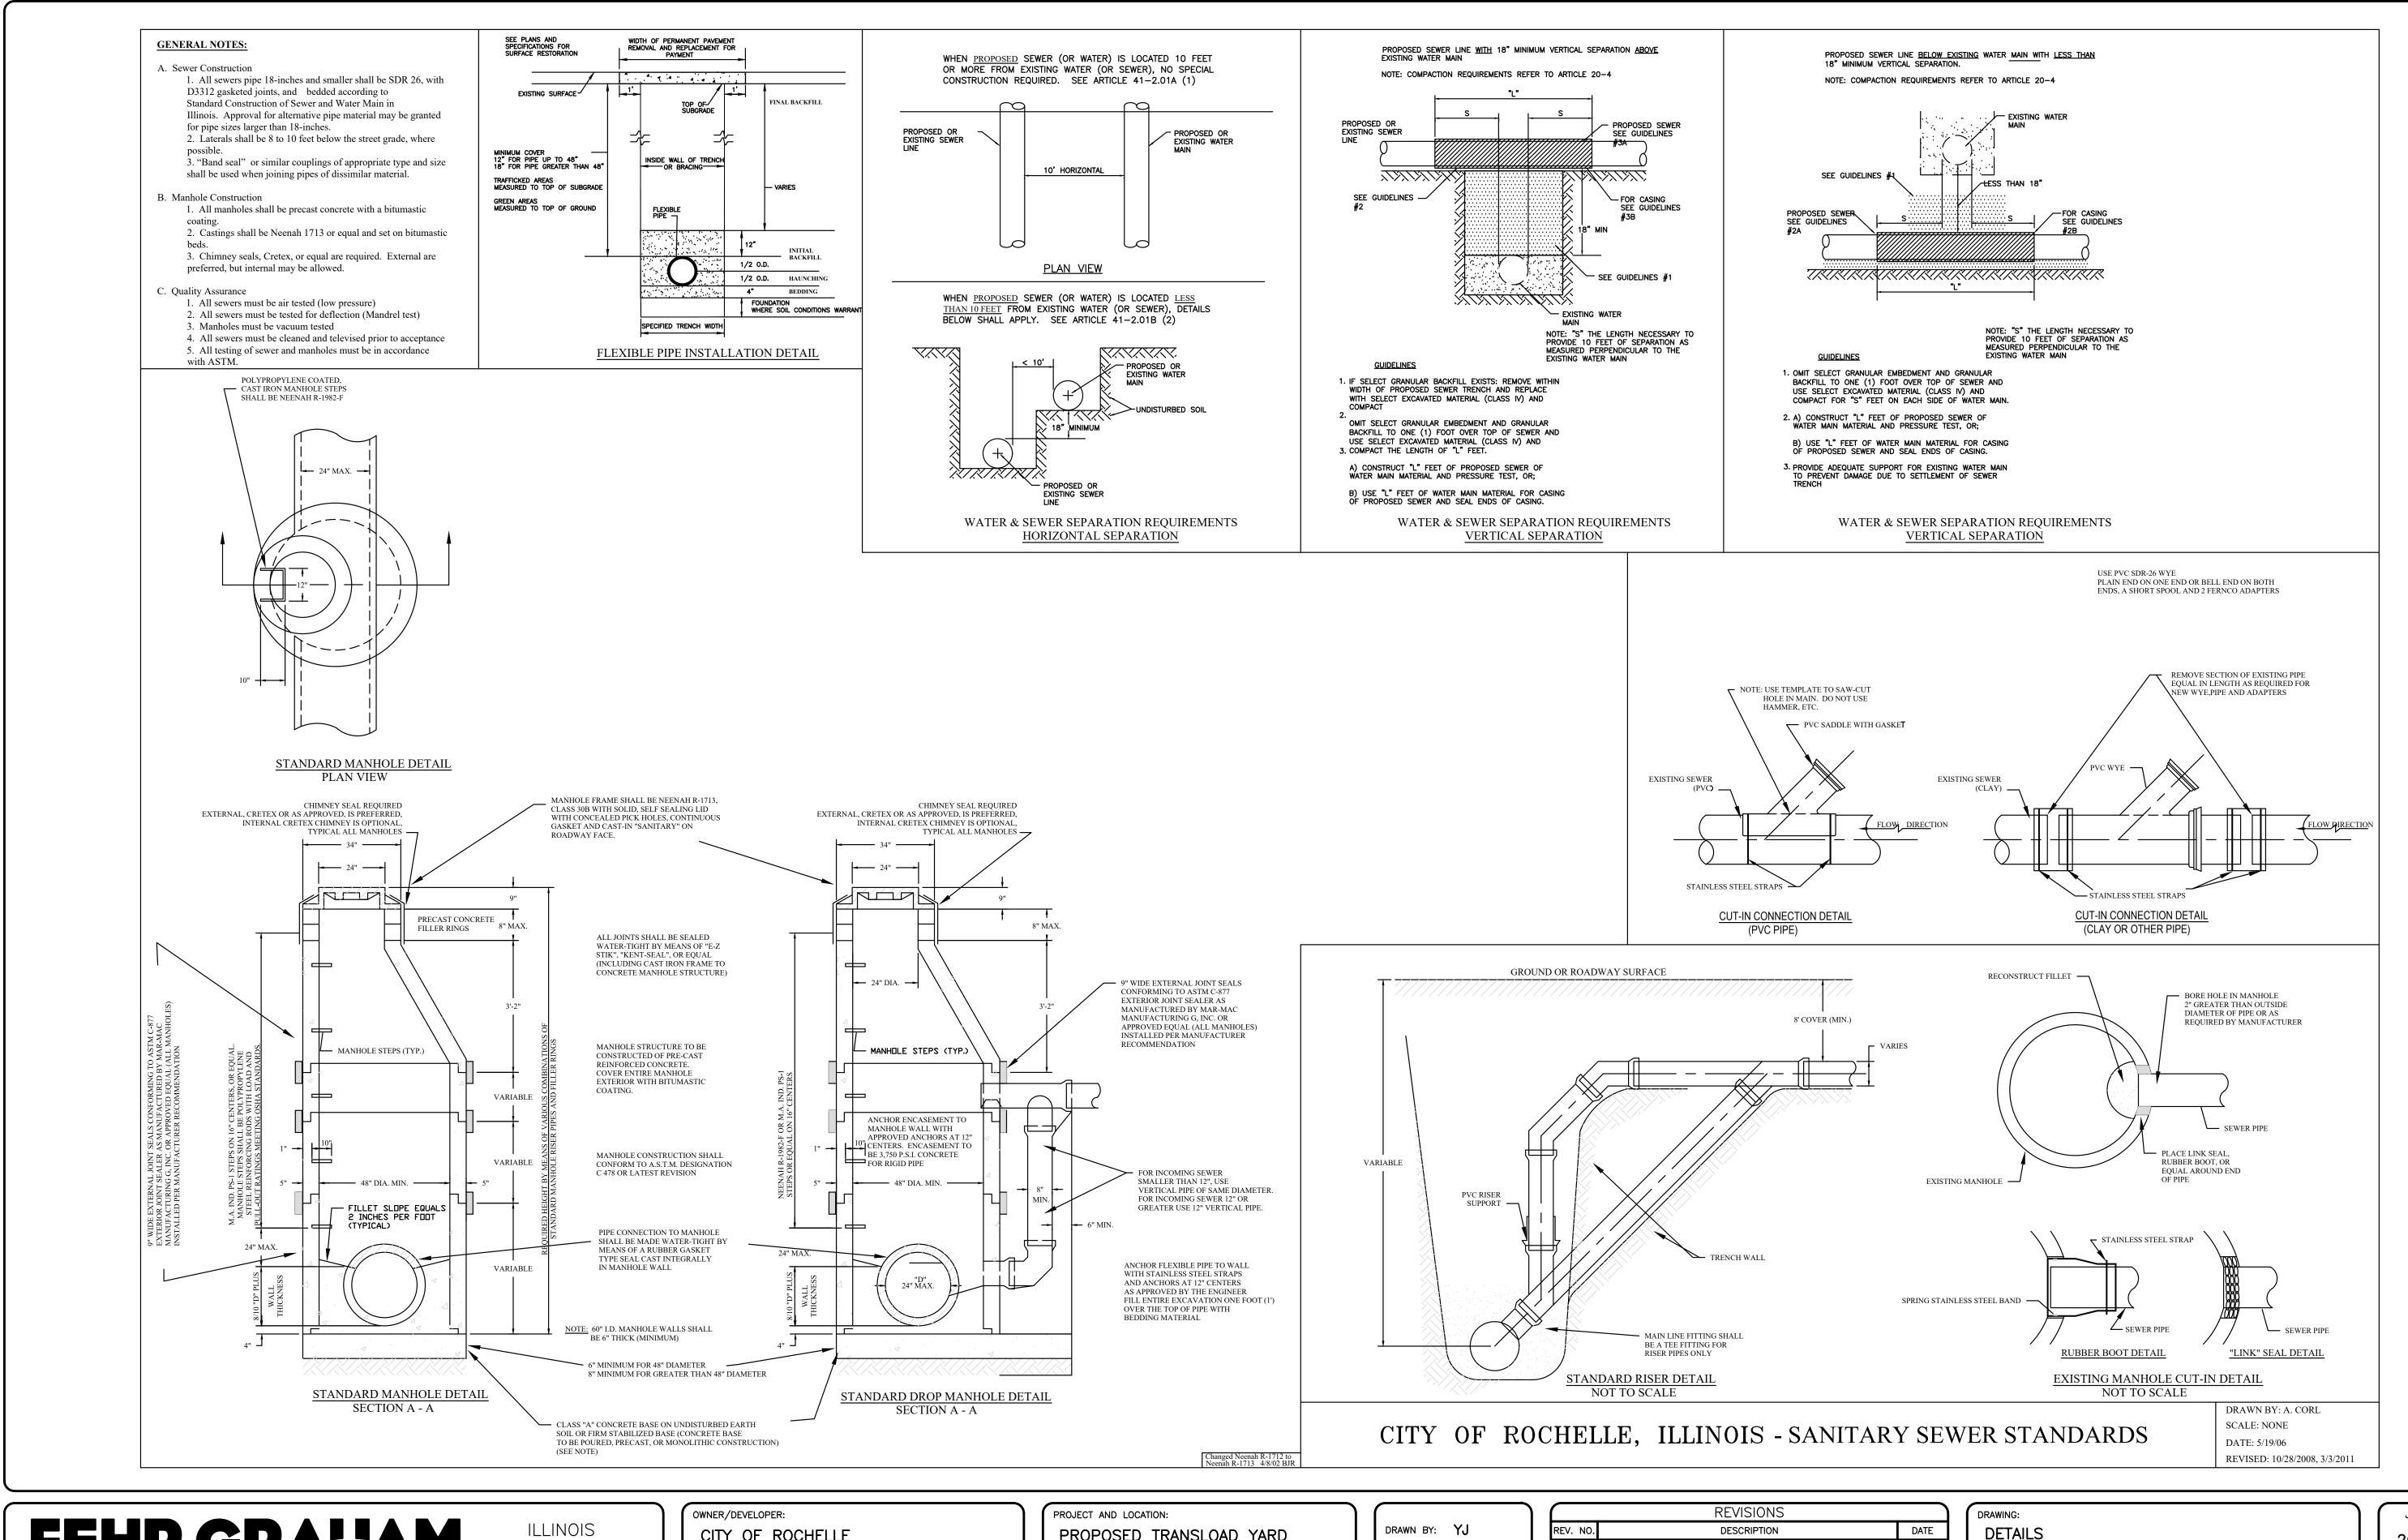

FEHR GRAHAM

ENGINEERING & ENVIRONMENTAL

ILLINOIS DESIGN FIRM NO. 184-003525

ILLINC

IOWA WISCONSIN CITY OF ROCHELLE
420 NORTH SIXTH STREET
ROCHELLE, IL 61068

PROPOSED TRANSLOAD YARD EXPANSION ROCHELLE, ILLINOIS

DRAWN BY: YJ
APPROVED BY: NJC
DATE: 03/03/23
SCALE: AS NOTED


	REVISIONS	
REV. NO.	DESCRIPTION	DATE
		1 1

DRAWING:
DETAILS

SET TYPE: CHANGE ORDER 1
G:\C3D\20\20-1026A\Plans\20-1026 - Plans.dwg, DET 1B

JOB NUMBER:
20-1026A

SHEET NUMBER:
8 of .

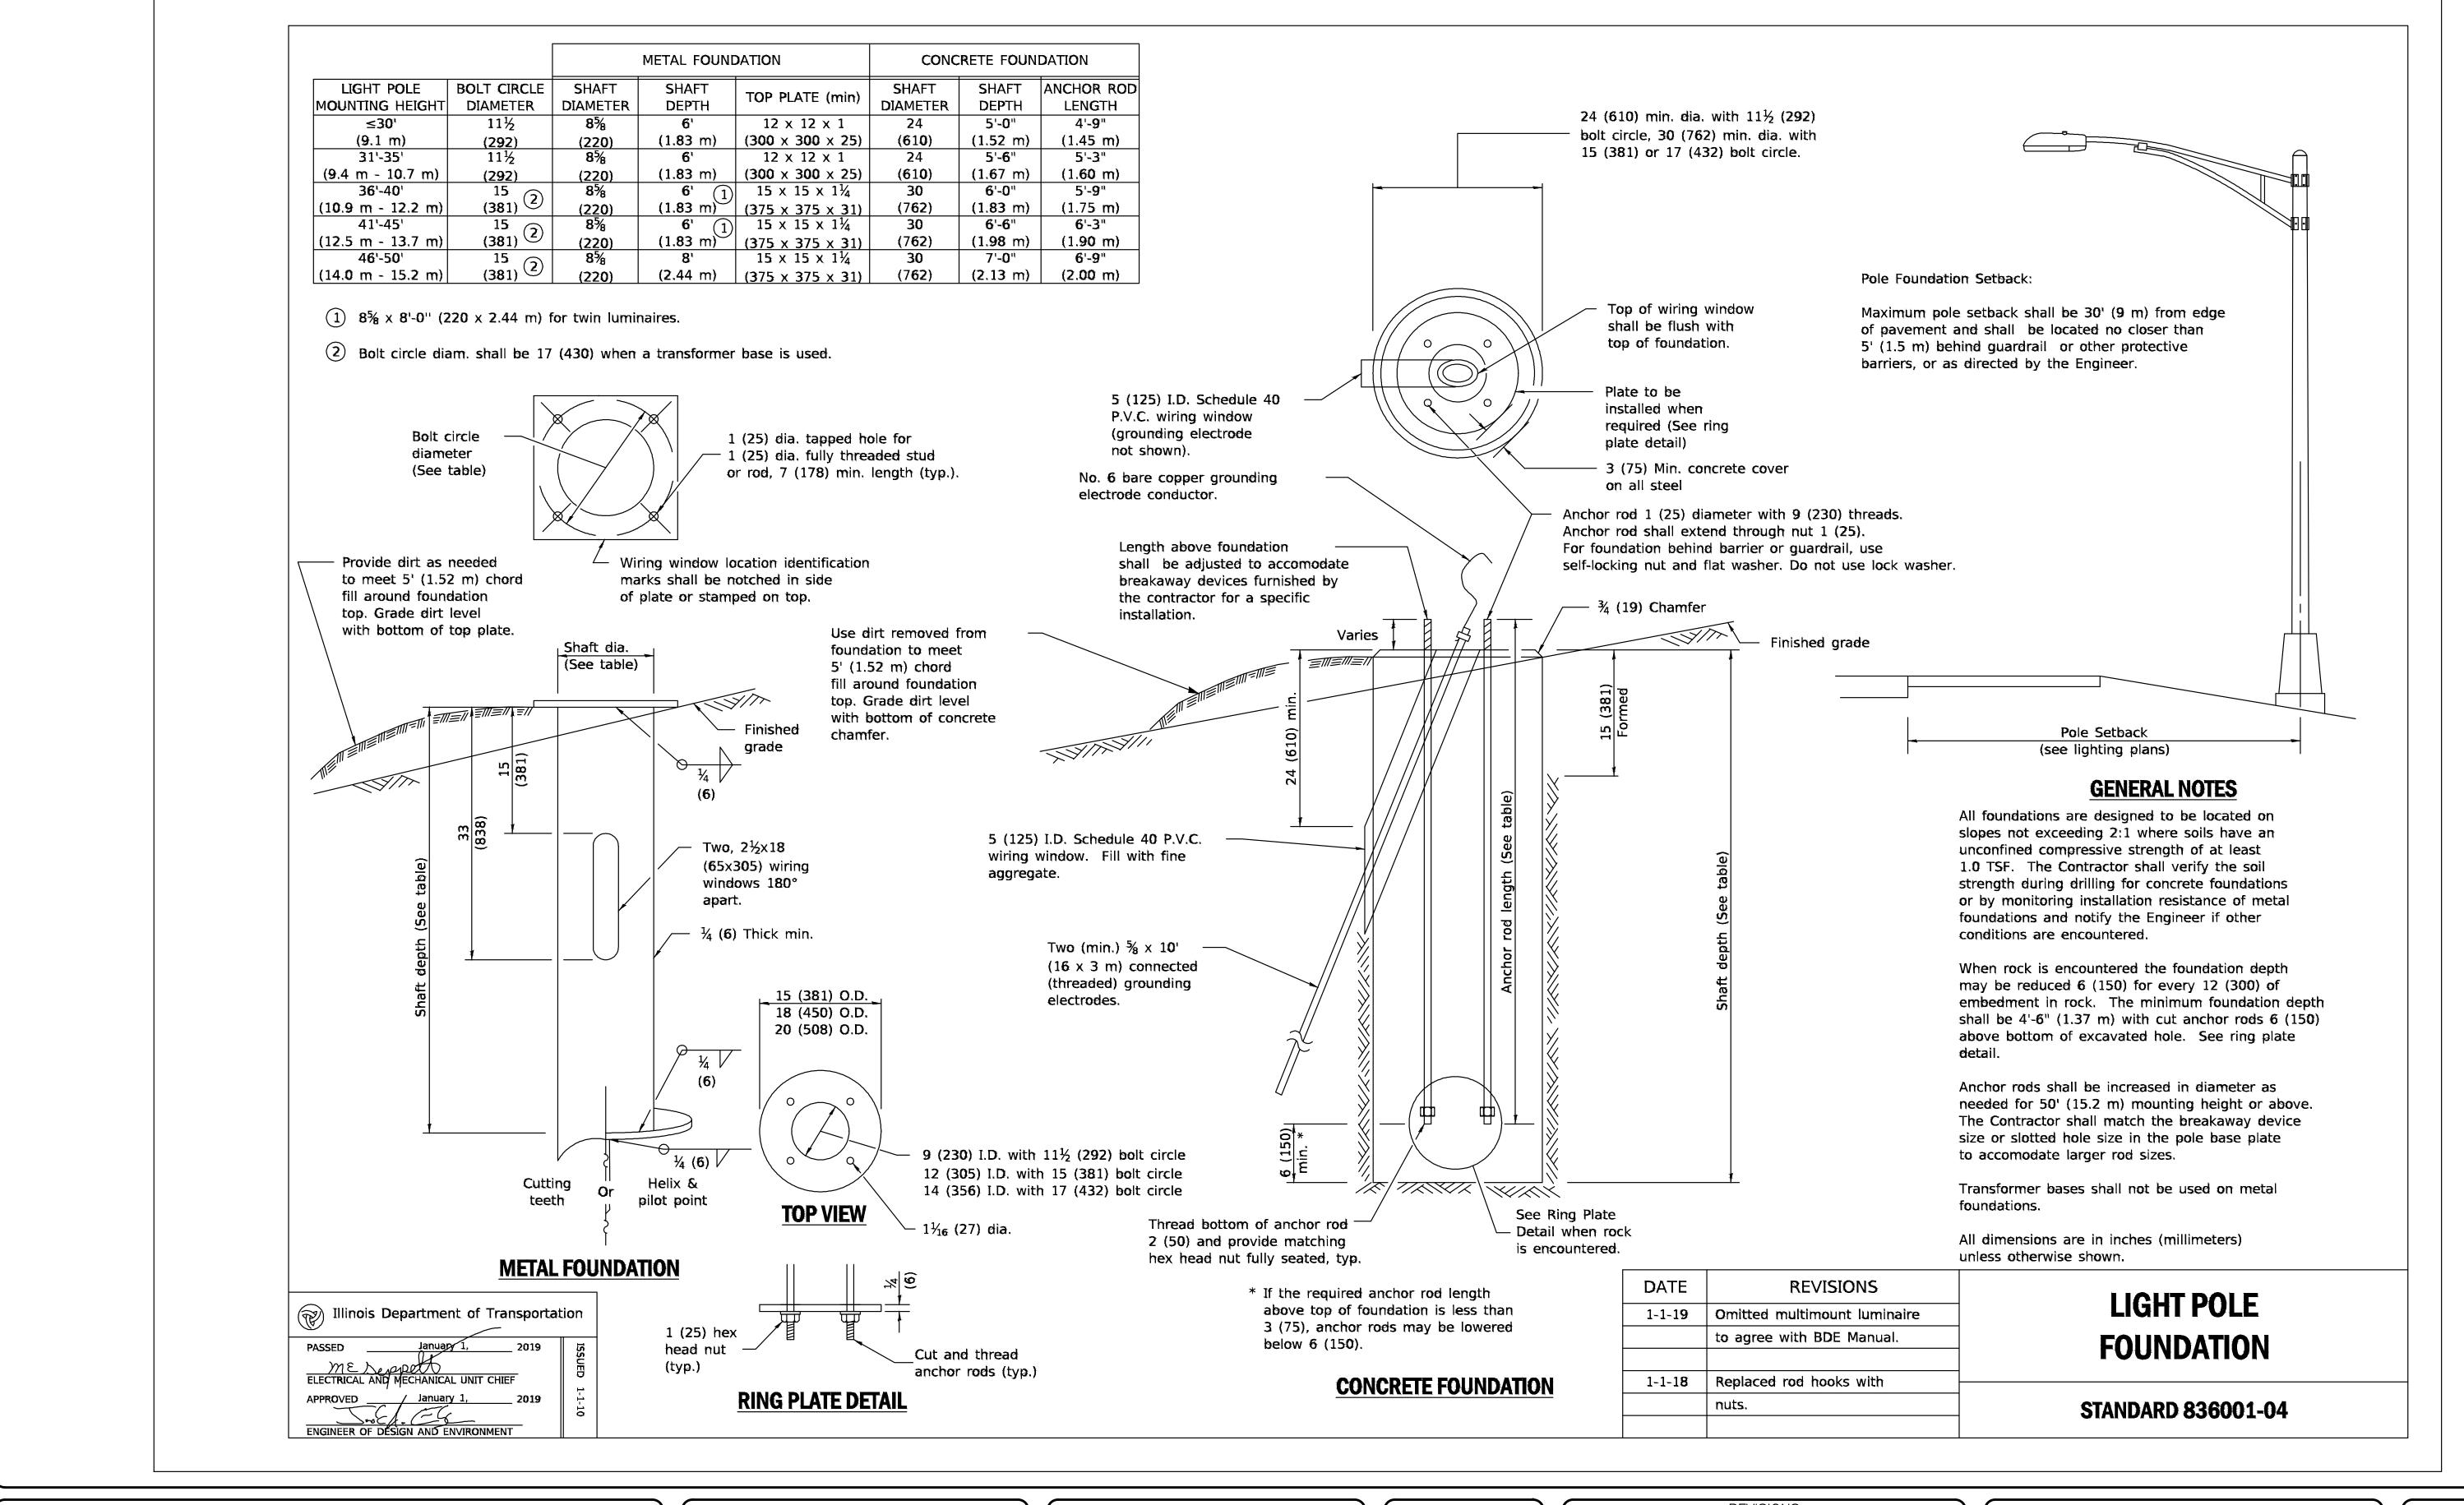

FEHR GRAHAM

ENGINEERING & ENVIRONMENTAL

ILLINOIS DESIGN FIRM NO. 184-003525

ILLINOIS IOWA

IOWA WISCONSIN OWNER/DEVELOPER:

CITY OF ROCHELLE

420 NORTH SIXTH STREET

ROCHELLE, IL 61068

PROPOSED TRANSLOAD YARD

EXPANSION ROCHELLE, ILLINOIS

DRAWN BY: YJ
APPROVED BY: NJC
DATE: 03/03/23
SCALE: AS NOTED

	REVISIONS	
REV. NO.	DESCRIPTION	DATE

DRAWING:
DETAILS

SET TYPE: CHANGE ORDER 1


S:\C3D\20\20-1026A\Plans\20-1026 - Plans.dwg, DET 1C

JOB NUMBER:

20-1026A

SHEET NUMBER:

9 of .

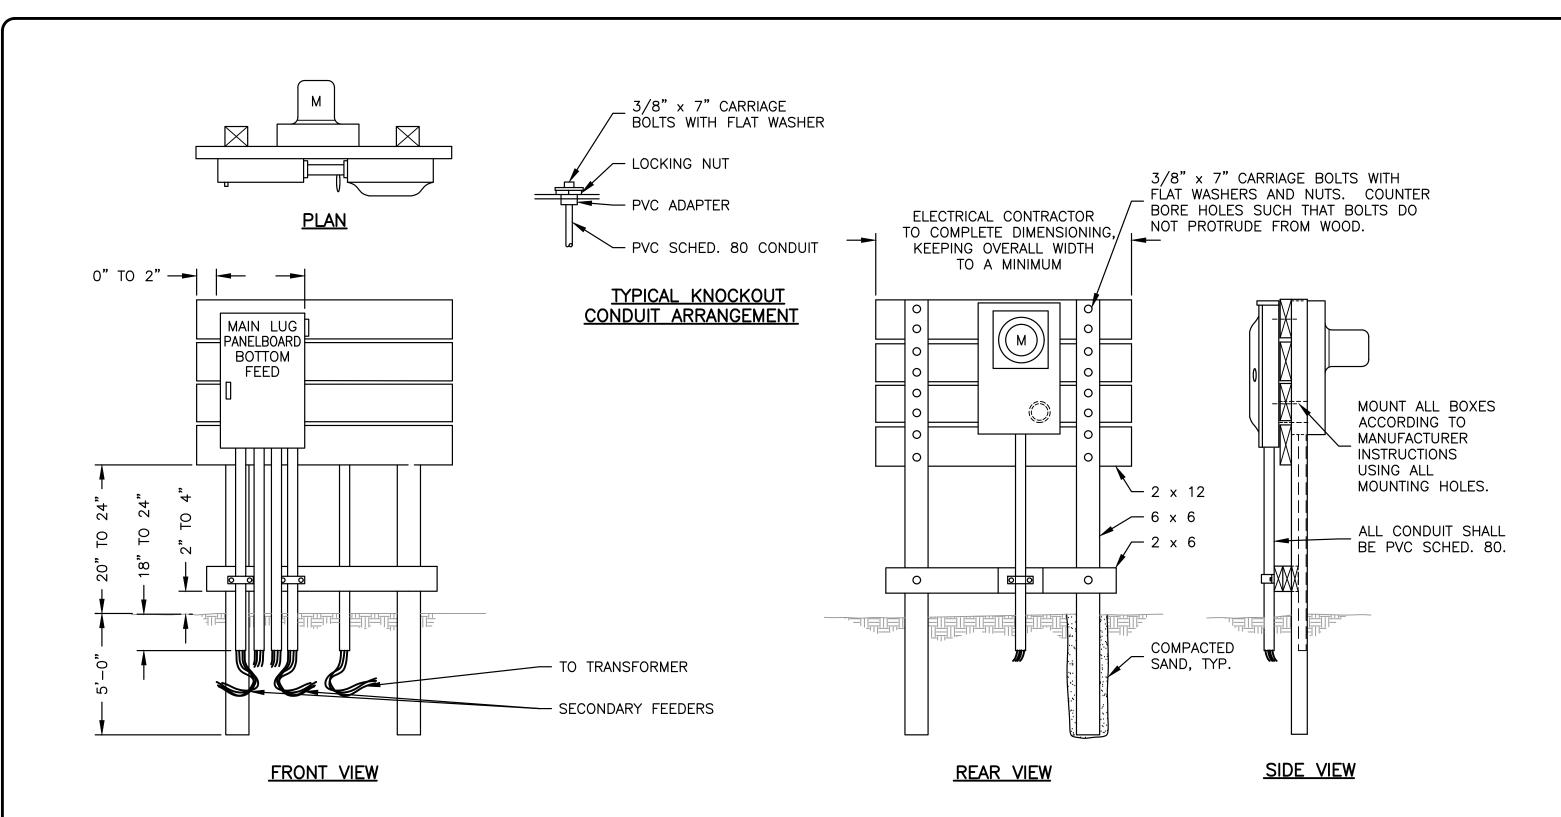

NOTE: ALL CONSTRUCTION CCA TREATED WOOD.

ELECTRICAL SERVICE PANEL DETAILS

FEHR GRAHAM

ENGINEERING & ENVIRONMENTAL
ILLINOIS DESIGN FIRM NO. 184-003525

ILLINOIS IOWA

WISCONSIN

OWNER/DEVELOPER:

CITY OF ROCHELLE

420 NORTH SIXTH STREET

ROCHELLE, IL 61068

PROPOSED TRANSLOAD YARD EXPANSION

ROCHELLE, ILLINOIS

DRAWN BY: YJ
APPROVED BY: NJC
DATE: 03/03/23
SCALE: AS NOTED

)		REVISIONS	
ı	REV. NO.	DESCRIPTION	DATE
ı			
ı			
ı			


	DRAWING: DETAILS		
}	SET TYPE: CHANGE ORDER G:\C3D\20\20-1026A\Plans\20-1026 - Plans.dwg, DET 1D	1	

20-1026A

SHEET NUMBER:

10 of .


JOB NUMBER:

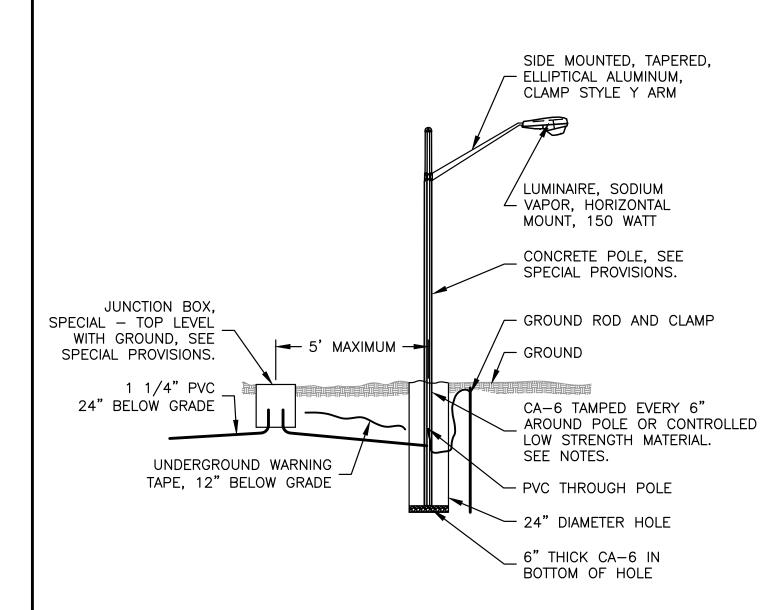

NOTE: AT SOME LOCATIONS THE POLE MAY BE LOCATED IN AREAS WHERE SAND HAS BEEN PLACED AS BACKFILL IN TRENCHES. THE SAND SHALL BE REMOVED FOR INSTALLATION OF THE POLE AND THE HOLE SHALL BE BACKFILLED WITH CONTROLLED LOW STRENGTH MATERIAL. THE CONTRACTOR SHALL USE CARE IN REMOVING THE SAND SO THAT PAVED AREAS WILL NOT BE UNDERMINED. THIS WORK SHALL BE AS DIRECTED BY THE ENGINEER.

THE COST OF EXCAVATION FOR THE POLE AND BACKFILLING WITH CA-6 SHALL BE INCLUDED IN THE COST OF THE POLE. CONTROLLED LOW STRENGTH MATERIAL WILL BE PAID FOR AT THE CONTRACT UNIT PRICE PER CUBIC YARD.


LIGHT POLE INSTALLATION DETAIL

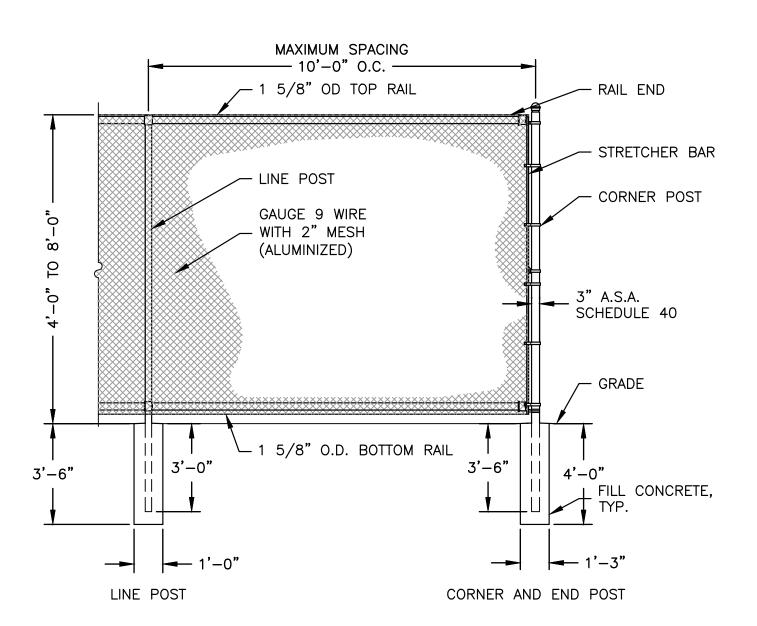

NOTE: FENCE MATERIAL; FENCING SHALL BE 2" — 9 GAUGE CHAIN LINK WITH ALUMINIZED COATING. LINE FENCE POSTS SHALL BE SPACED 10'—0" O.C. ALL ALUMINIZED COATING SHALL BE APPLIED AT 0.4 OZ./S.F. POST MATERIAL; ALL POSTS SHALL BE SCHEDULE 40 WITH 2 OZ./S.F. GALVANIZED COATING OR ALLIED SS40. CORNER END POSTS SHALL BE 3" O.D. LINE POSTS SHALL BE 2 1/2" ROUND O.D. GATE POSTS FOR 4' AND 5' LEAVES SHALL BE 3" O.D. AND GATE POSTS FOR 10' LEAVES SHALL BE 4" O.D.

FENCE INSTALLATION SHALL FOLLOW SECTION 664 OF STANDARD SPECIFICATIONS FOR ROAD AND BRIDGE CONSTRUCTION.

CHAIN LINK FENCE DETAIL

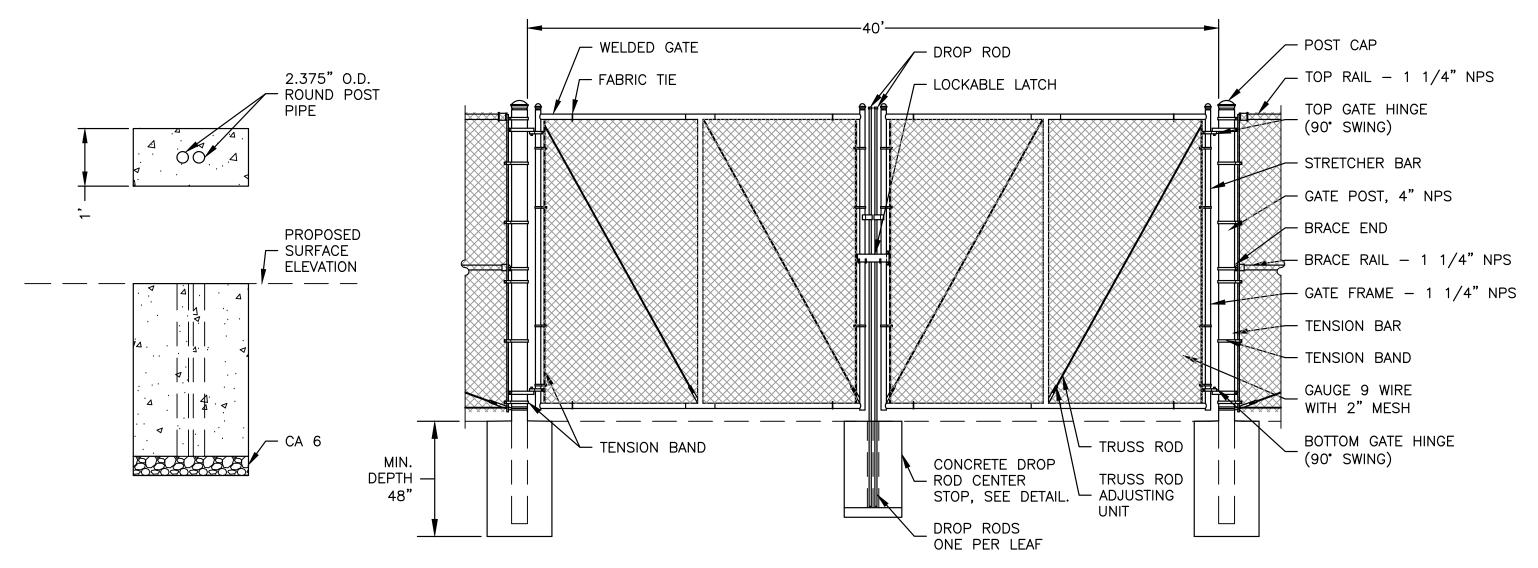

CONCRETE DROP ROD CENTER STOP DETAIL

DOUBLE SWING GATE WITH CENTER DROP ROD

NOTE: PIPES SHALL BE SET THROUGH CONCRETE TO ALLOW DRAINAGE TO AGGREGATE.

HORIZONTAL LOCATION SET BY CONTRACTOR TO EFFECTIVELY HOLD DOUBLE SWING GATE IN CLOSED POSITION.

DROP ROD STOPS FOR GATES IN OPEN POSITION SHALL BE TO SAME DIMENSIONS AND CONSTRUCTION WITH THE EXCEPTION THAT WIDTH \times LENGTH MAY BE 1' \times 1'.

CONTRACTOR SHALL FIELD VERIFY LOCATIONS OF DROP ROD STOPS FOLLOWING INSTALLATION OF GATE.

CHAIN LINK FENCE DOUBLE DRIVE-THRU SWING GATE WITH CENTER STOP DETAIL

FEHR GRAHAM

ENGINEERING & ENVIRONMENTAL

ILLINOIS DESIGN FIRM NO. 184-003525

ILLINOIS IOWA

WISCONSIN

OWNER/DEVELOPER:

CITY OF ROCHELLE

420 NORTH SIXTH STREET

ROCHELLE, IL 61068

PROPOSED TRANSLOAD YARD

EXPANSION ROCHELLE, ILLINOIS DRAWN BY: YJ
APPROVED BY: NJC
DATE: 03/03/23
SCALE: AS NOTED

REVISIONS
REV. NO. DESCRIPTION DATE

DRAWING:
DETAILS

SET TYPE: CHANGE ORDER 1
G:\C3D\20\20-1026A\Plans\20-1026 - Plans.dwg, DET 1E

JOB NUMBER:
20-1026A

SHEET NUMBER:

11 of .