
SITE PLAN

16 FENCOURT AVENUE, RANDOLPH, MA

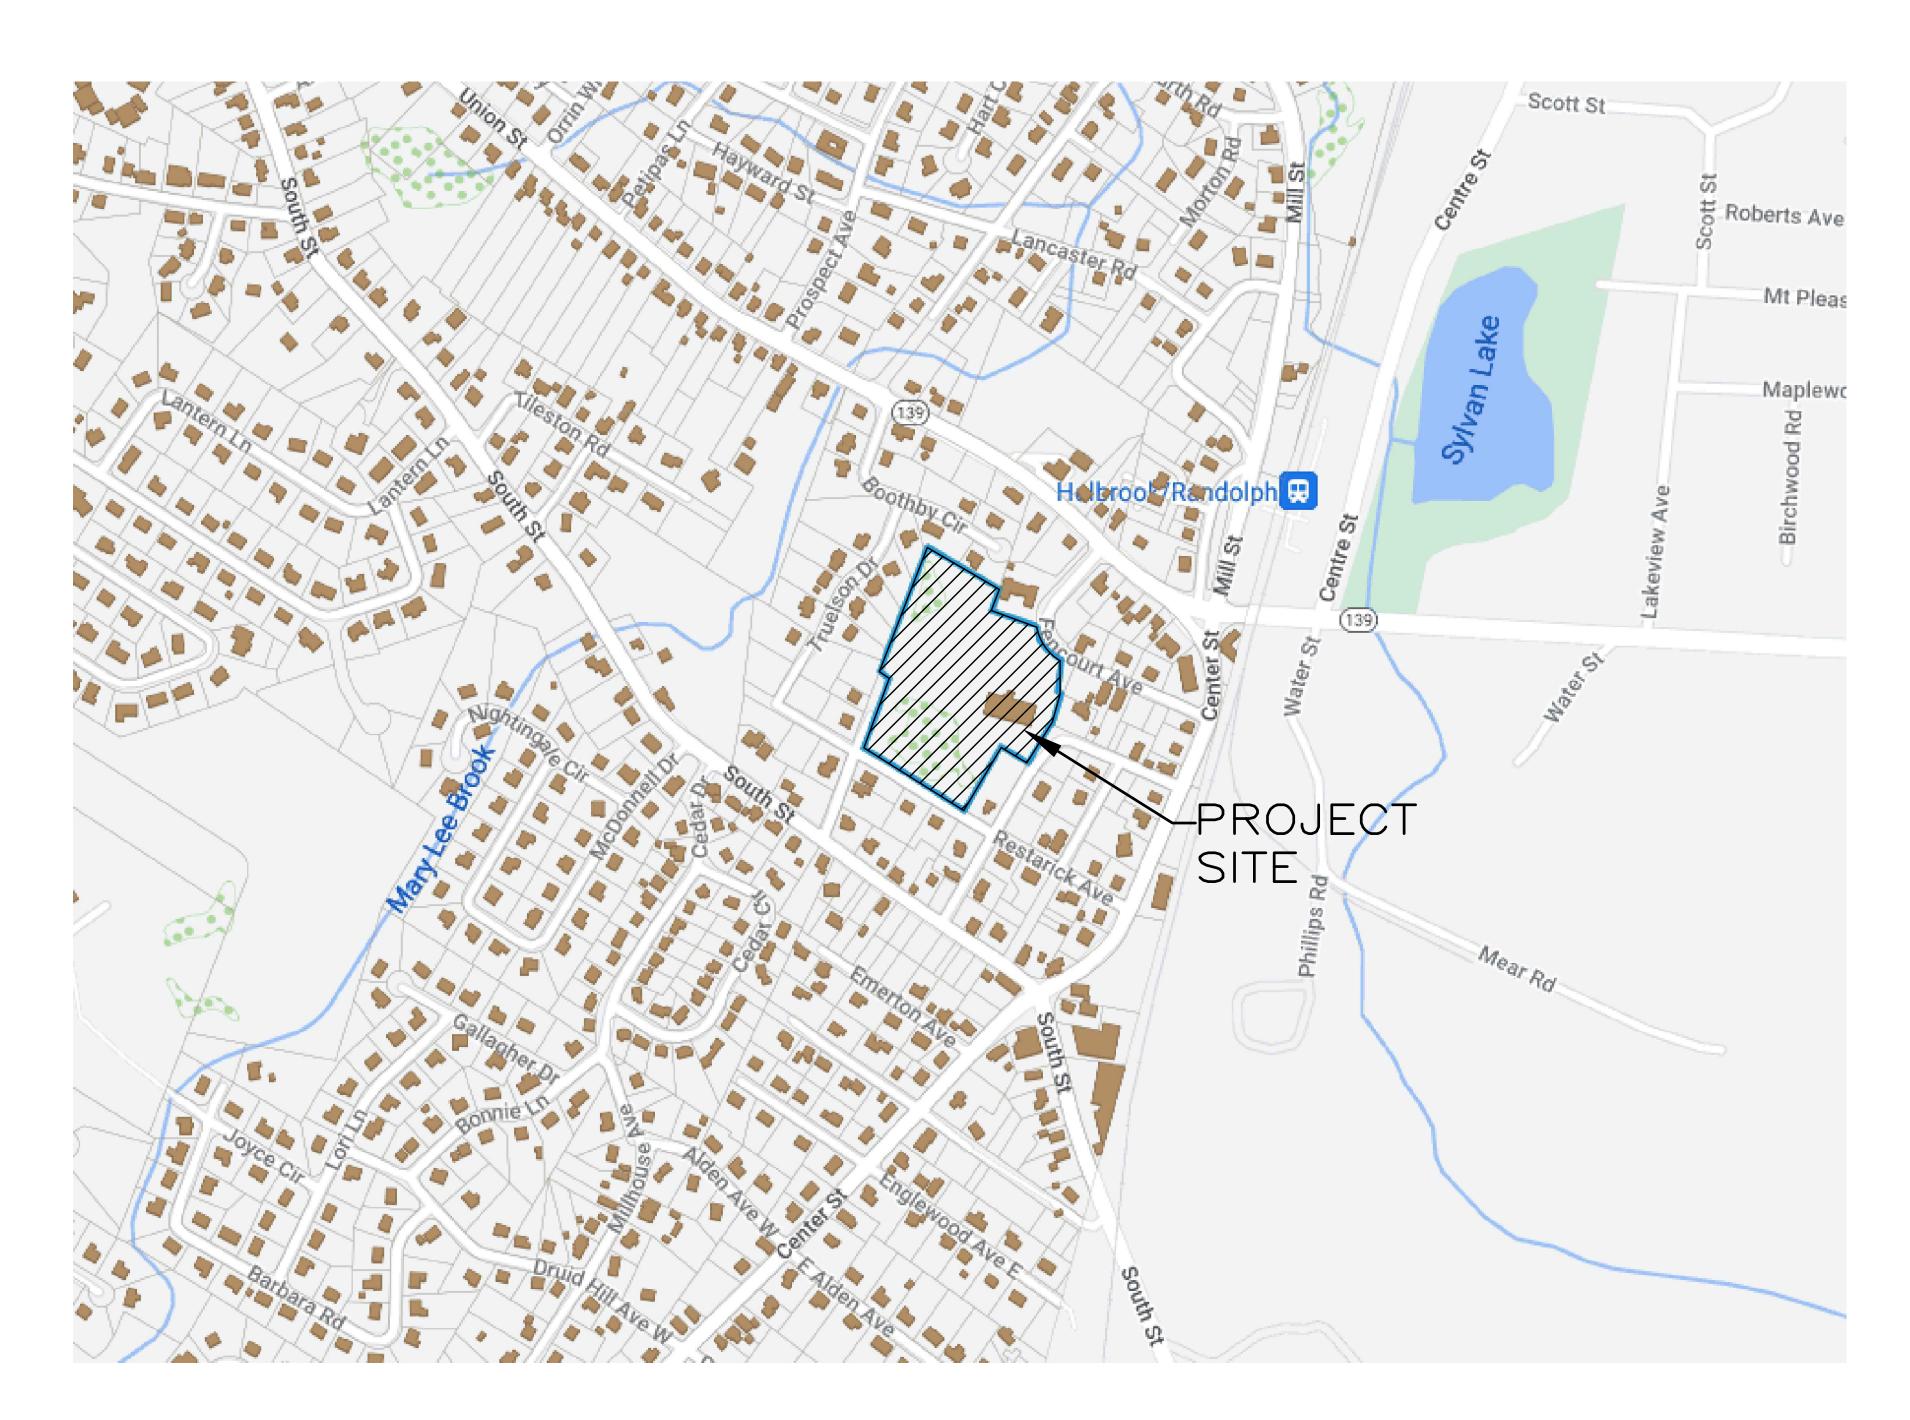

LOCUS MAP APPROX. 1" = 300'

ZONING ITEM	UCTD	EXISTING	PROPOSED
MIN. LOT AREA	5 ACRES	7.13 ACRES	7.13 ACRES
MIN. LOT FRONTAGE/DEPTH	100/75 FT	142.5/599FT	142.5/599FT
MAX. YARD — FRONT	10 FT**	167.5 FT	5.4 FT
MIN. YARD - SIDE	30 FT***	69.9 FT	30 FT
MIN. YARD — REAR	30 FT***	287.3 FT	30 FT
BUILDING HEIGHT	NOTE***	1 STORY	3 STORIES
MIN. OPEN SPACE	10%	79%	45.1%
			•
VARIANCE REQUIRED			

DIMENSIONAL REQUIREMENTS

** IN ORDER TO DEFINE A CONSISTENT BUILDING LINE ALONG THE STREET, NEW BUILDING SHALL NOT

- **** THE MINIMUM PERMITTED HEIGHT FOR BUILDING IN A UCTD PROJECT SHALL BE TWO (2) STORIES OR TWENTY (20) FEET, WHICHEVER IS GREATER, AND THE MAXIMUM PERMITTED HEIGHT FOR BUILDING AND STRUCTURES IN A UCTD PROJECT SHALL BE FOUR (4) STORIES OR (FORTY) 40 FEET, WHICH

DRAWING INDEX:

- C-1 TITLE SHEET
- C-2 LAYOUT PLAN
- GRADING AND DRAINAGE PLAN
- C-4 UTILITY PLAN
- C-5 DEMOLITION & EROSION CONTROL PLAN
- C-6 DETAIL SHEET 1
- C-7 DETAIL SHEET 2
- C-8 DETAIL SHEET 3

RECORD OWNER: TAJ ESTATES OF RANDOLPH II, LLC BOOK 39214 PAGE 555

<u>DATUM:</u>
ALL ELEVATIONS ARE ON NAVD 1988 DATUM

GENERAL NOTES

- 1. NOTIFY DIG-SAFE AT 1-888-DIG-SAFE PRIOR TO EXCAVATION.
- EXISTING CONDITIONS BASE MAP PROVIDED BY TURNING POINT ENGINEERING, INC. REFERENCE TO THE EXISTING CONDITIONS PLAN.

OWNER/APPLICANT:

TAJ ESTATES OF RANDOLPH II, LLC 16 FENCOURT AVENUE RANDOLPH, MA 02368

LEGAL COUNCIL:

KEVIN M. REILLY, ESQ 19 SOUTH MAIN STREET RANDOLPH, MA 02368 (781) 961-7343

DENNIS COLWELL ARCHITECTS 132 CENTRAL STREET, SUITE 203 FOXBOROUGH, MA 02035 (508) 241-2122

<u>CIVIL ENGINEER:</u>

HARDY + MAN DESIGN GROUP PC 1285 WASHINGTON STREET WEYMOUTH, MA 02189 (781) 335-1464


LAND SURVEYOR:

BORDERLAND ENGINEERING, INC. 61 PLEASANT STREET, STUDIO B RANDOLPH, MA 02368 (781) 963-9500

TRAFFIC ENGINEER:

VANASSE & ASSOCIATES, INC. 35 NEW ENGLAND BUSINESS CENTER DRIVE SUITE 140 ANDOVER, MA 01810 (978) 474-8800

SITE LIGHTING CONSULTANT: BOSTON LIGHT SOURCE 64 COMMERCIAL WHARF BOSTON, MA 02110 (617) 788-2400

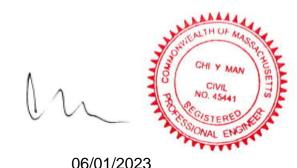

	REVISIONS:		
NO.:	COMMENTS:	DATE:	
1	SITE PLAN REVIEW COMMENTS	9-26-2022	RANDO
2	REVISED PER TOWN COMMENTS	2-15-2023	
3	NO CHANGE	5-25-2023	DRAWN BY: JKY
			DESIGNED BY: CYM
			CHECKED BY: CYM

TITLE SHEET 16 Fencourt Ave RANDOLPH, MASSACHUSETTS


DATE: 9-06-2022 LATEST REVISION: 5-25-2023 SCALE: 1" = 40'


HARDY + MAN DESIGN GROUP, PC PREPARED FOR:


1285 WASHINGTON STREET WEYMOUTH, MA (781) 335-1464


PERMITTING

SHEET

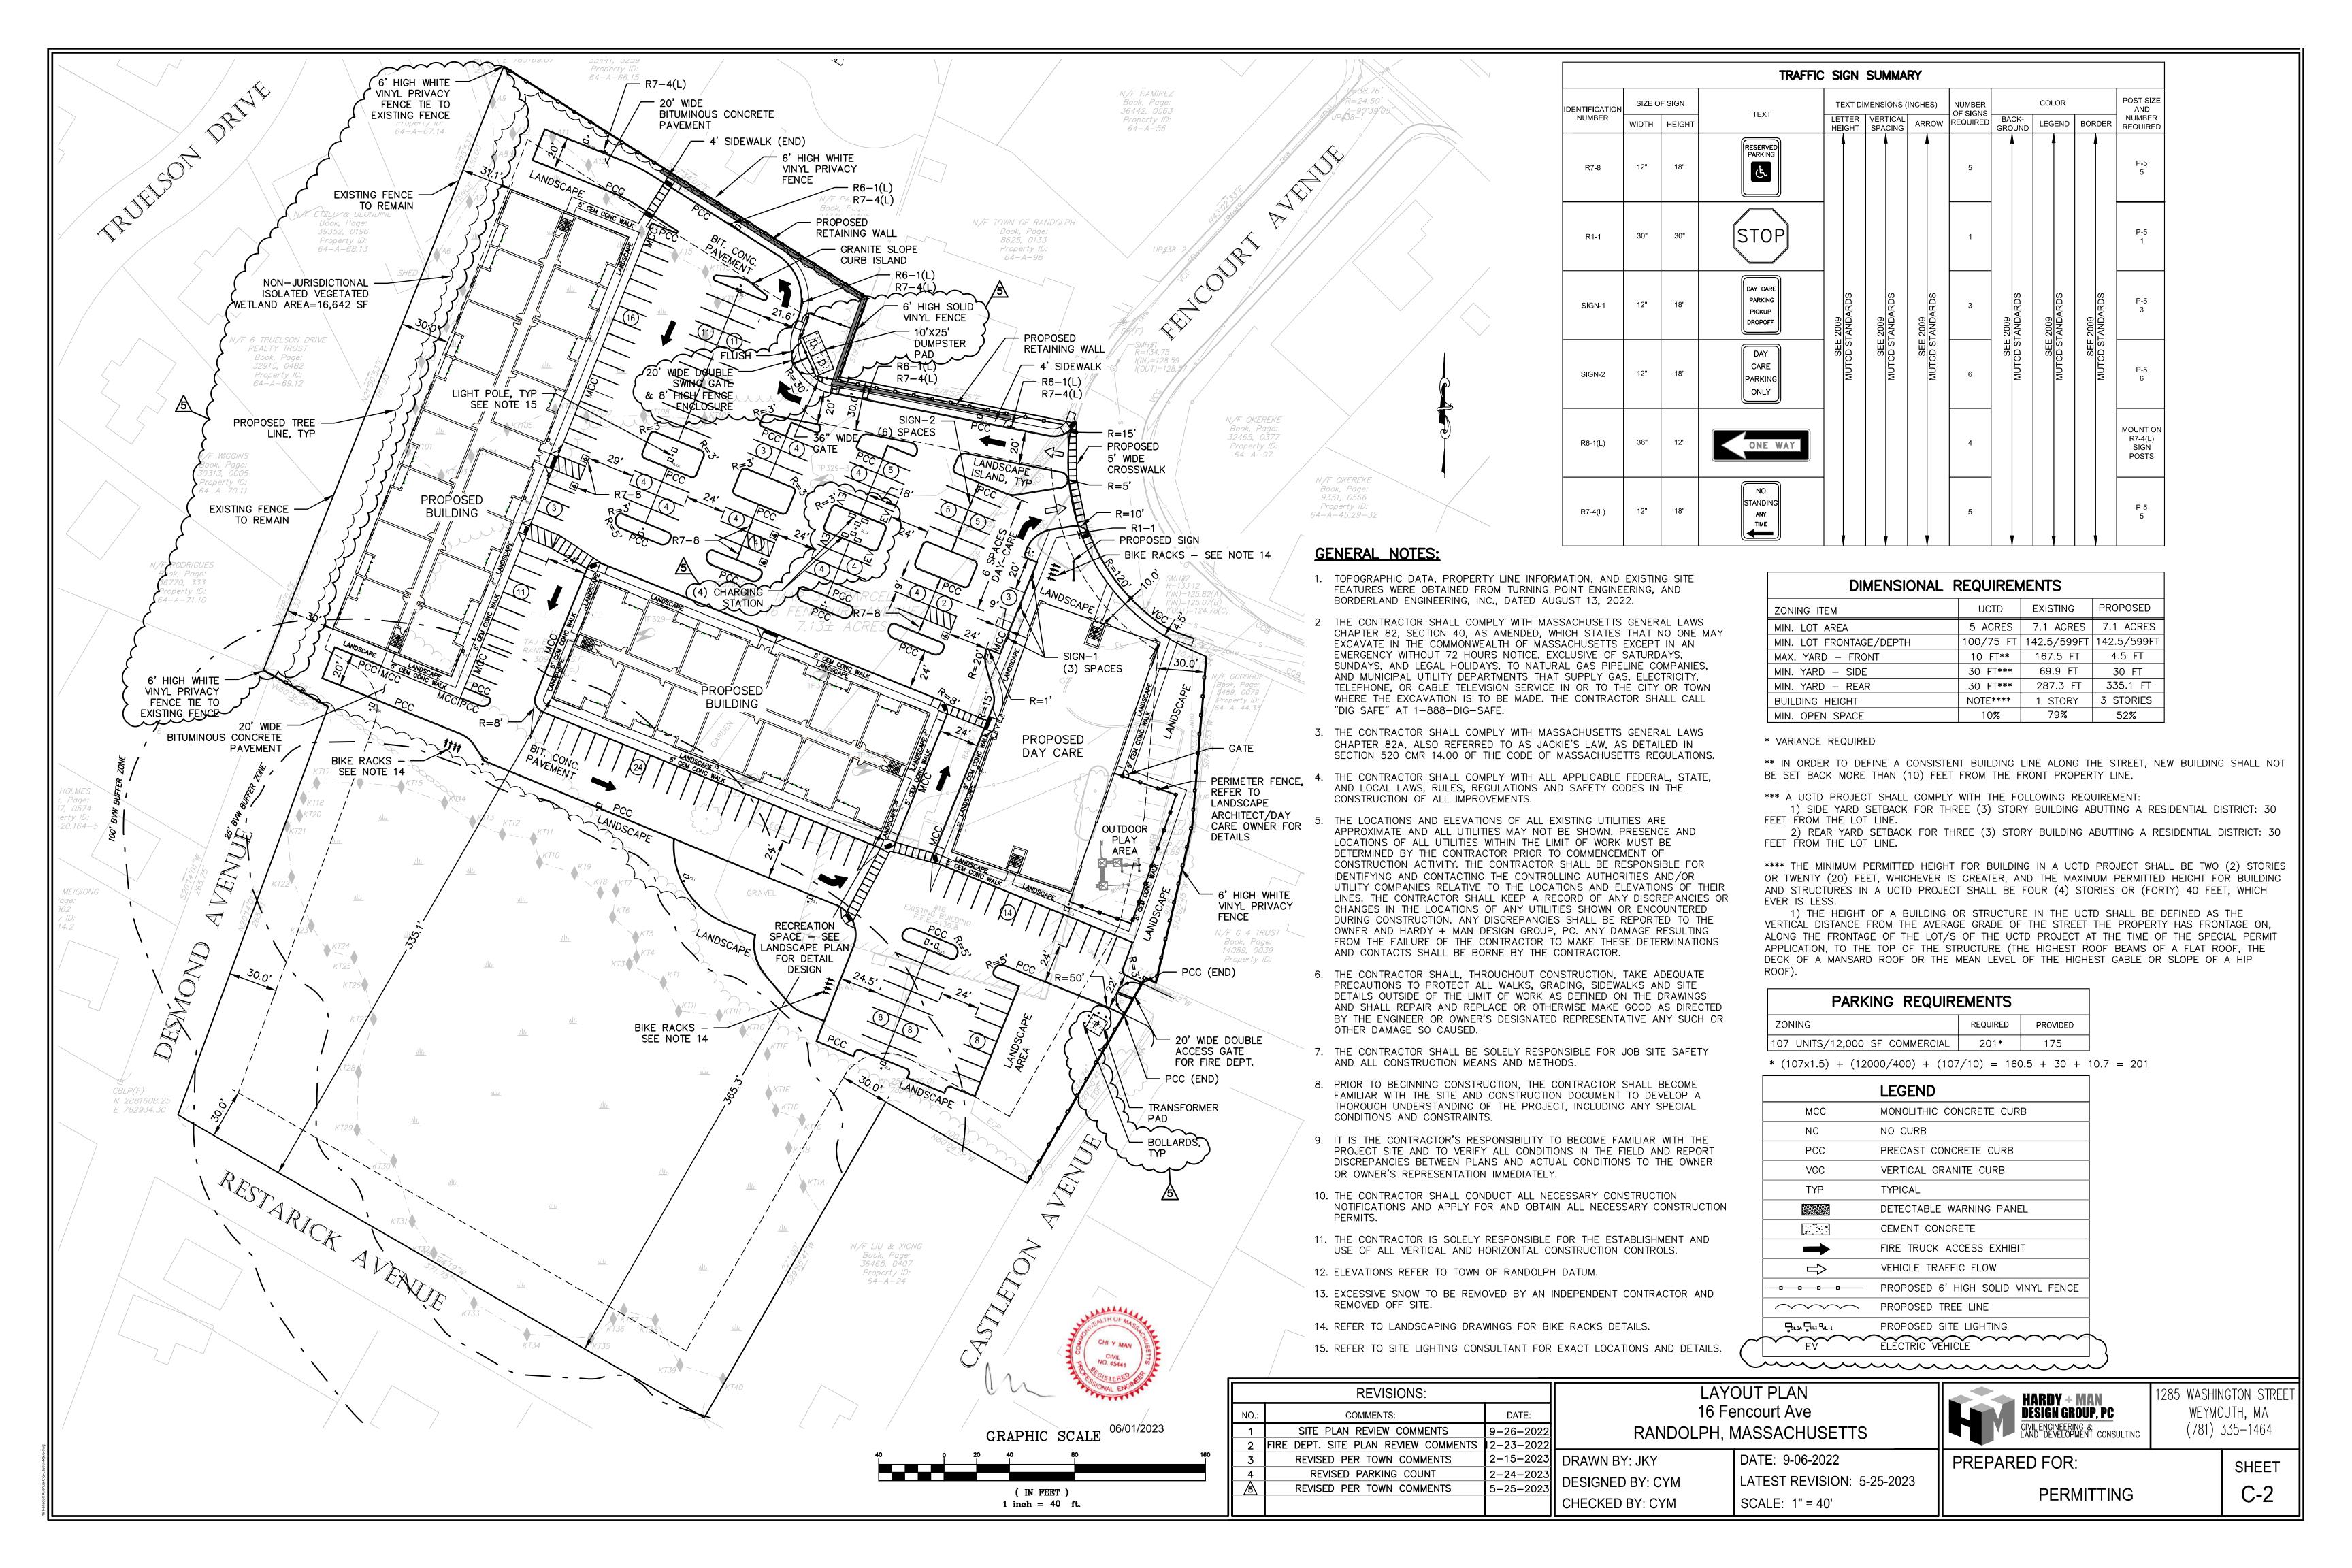

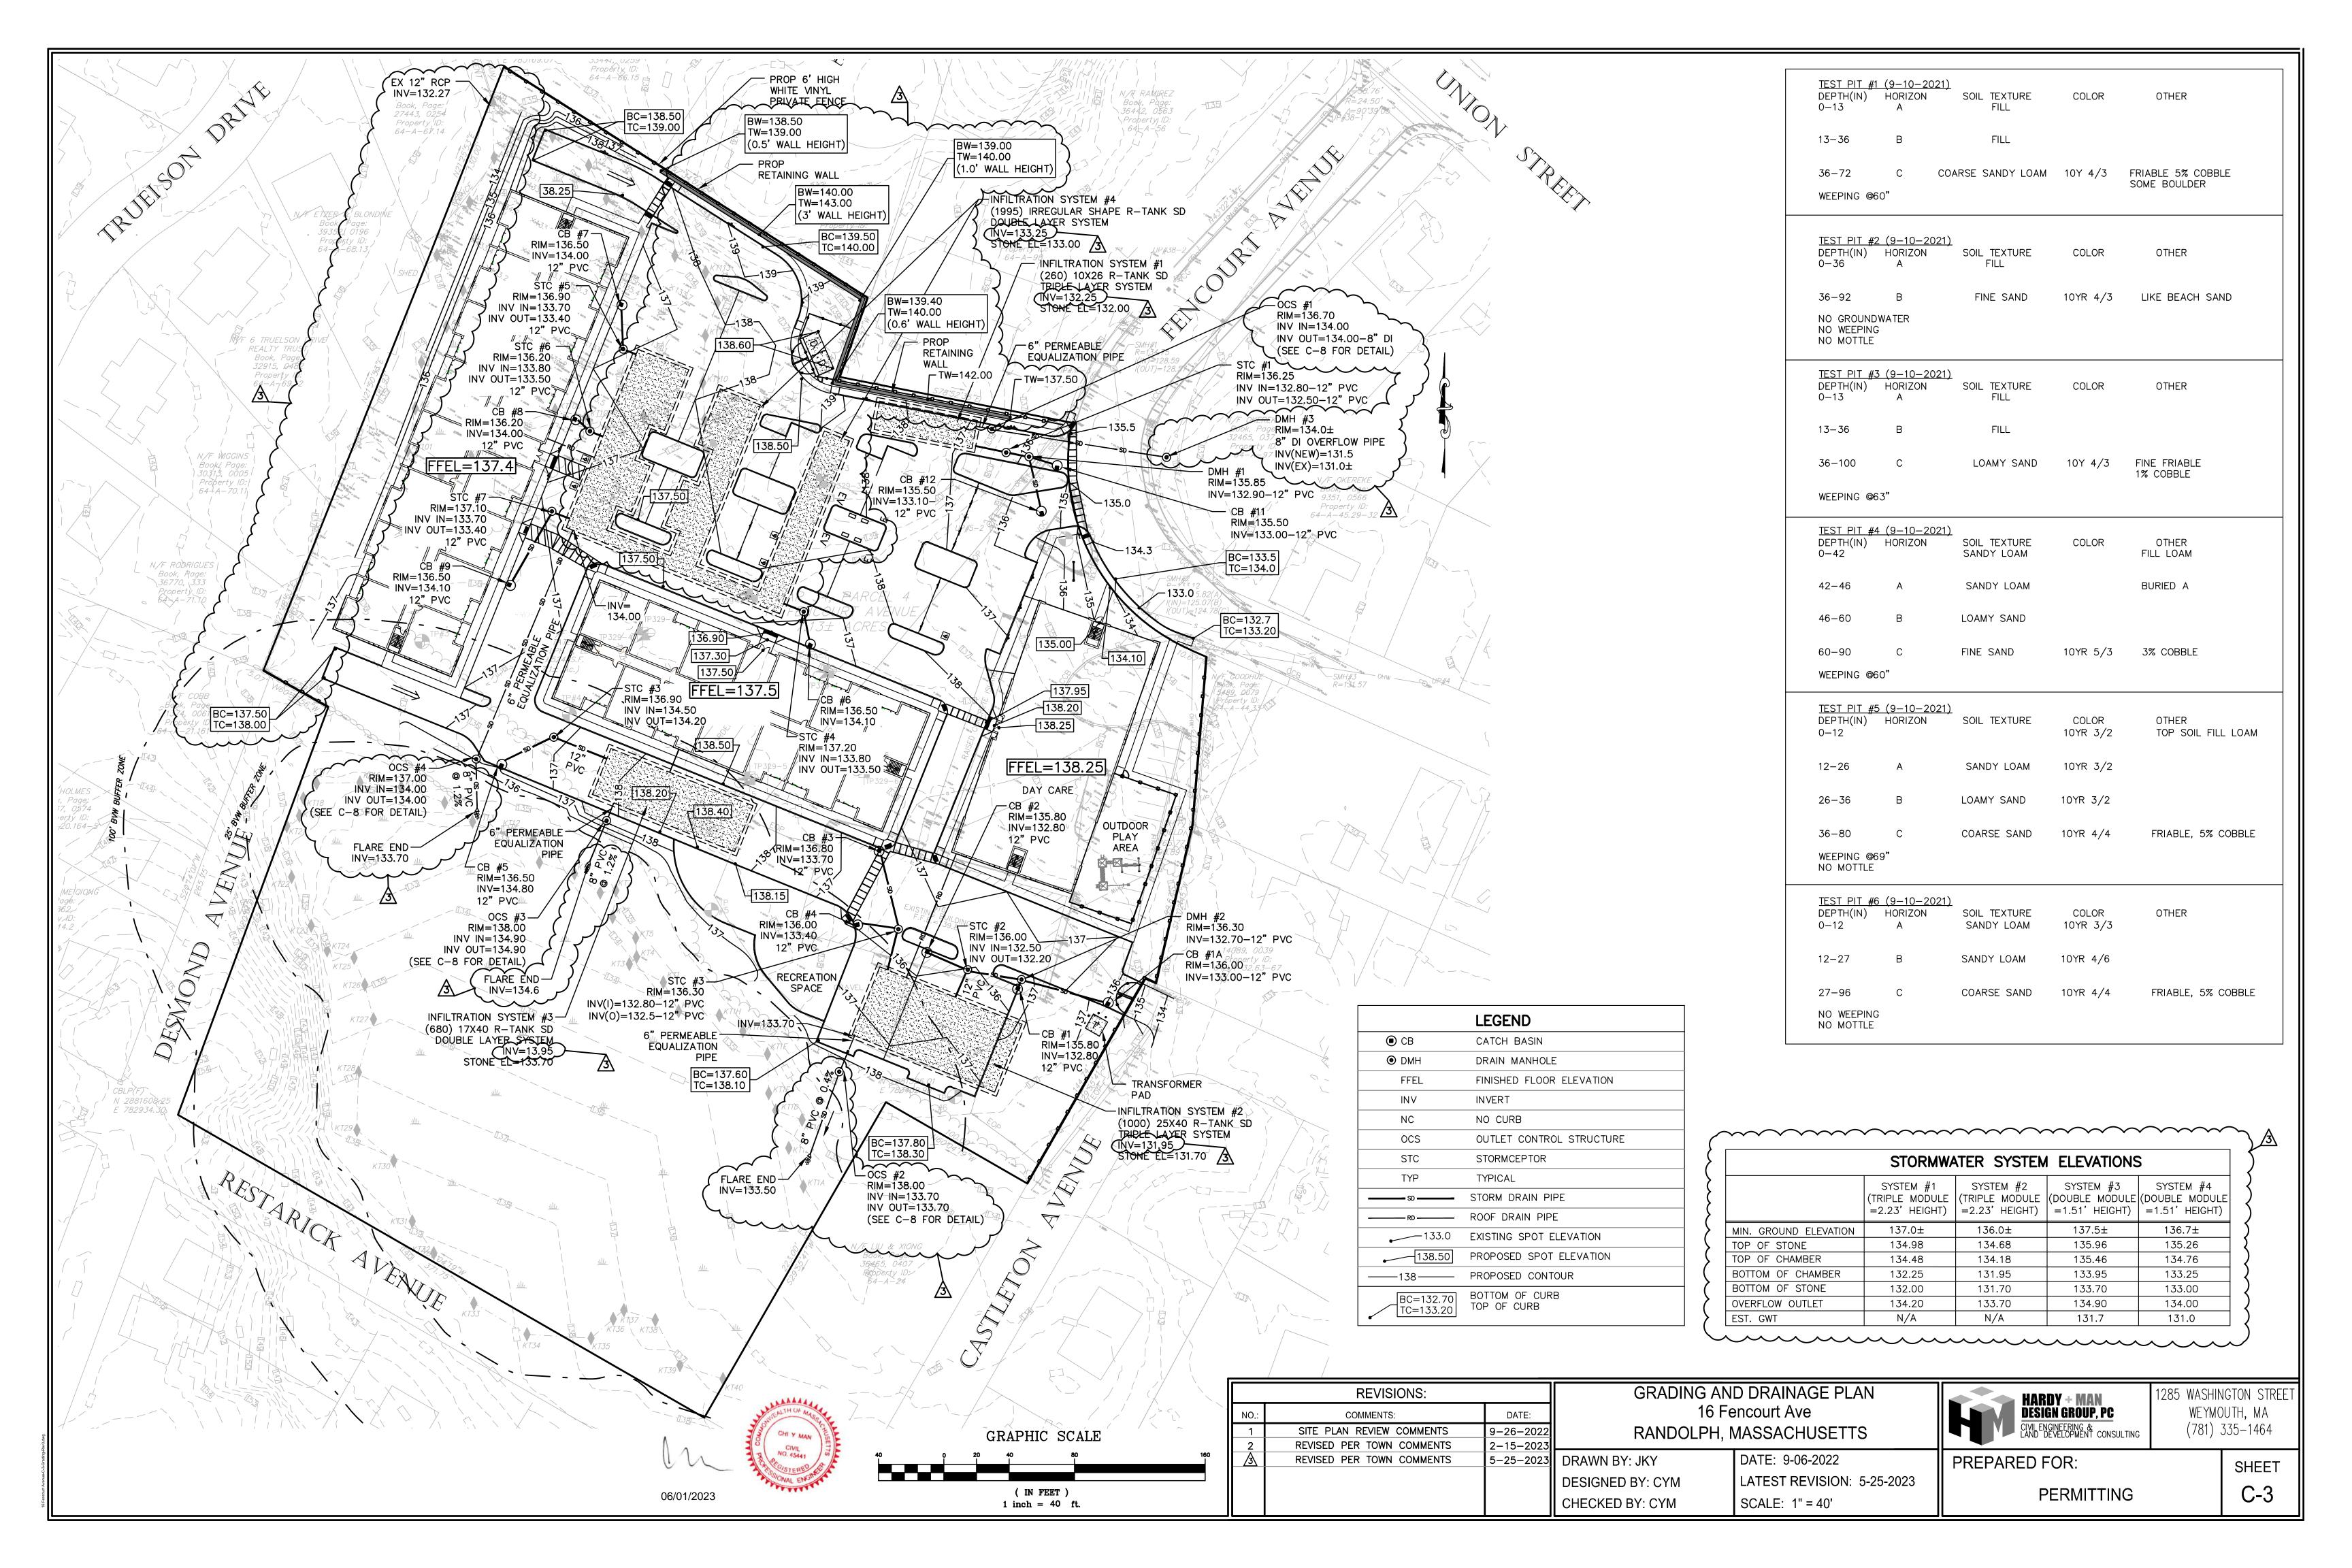

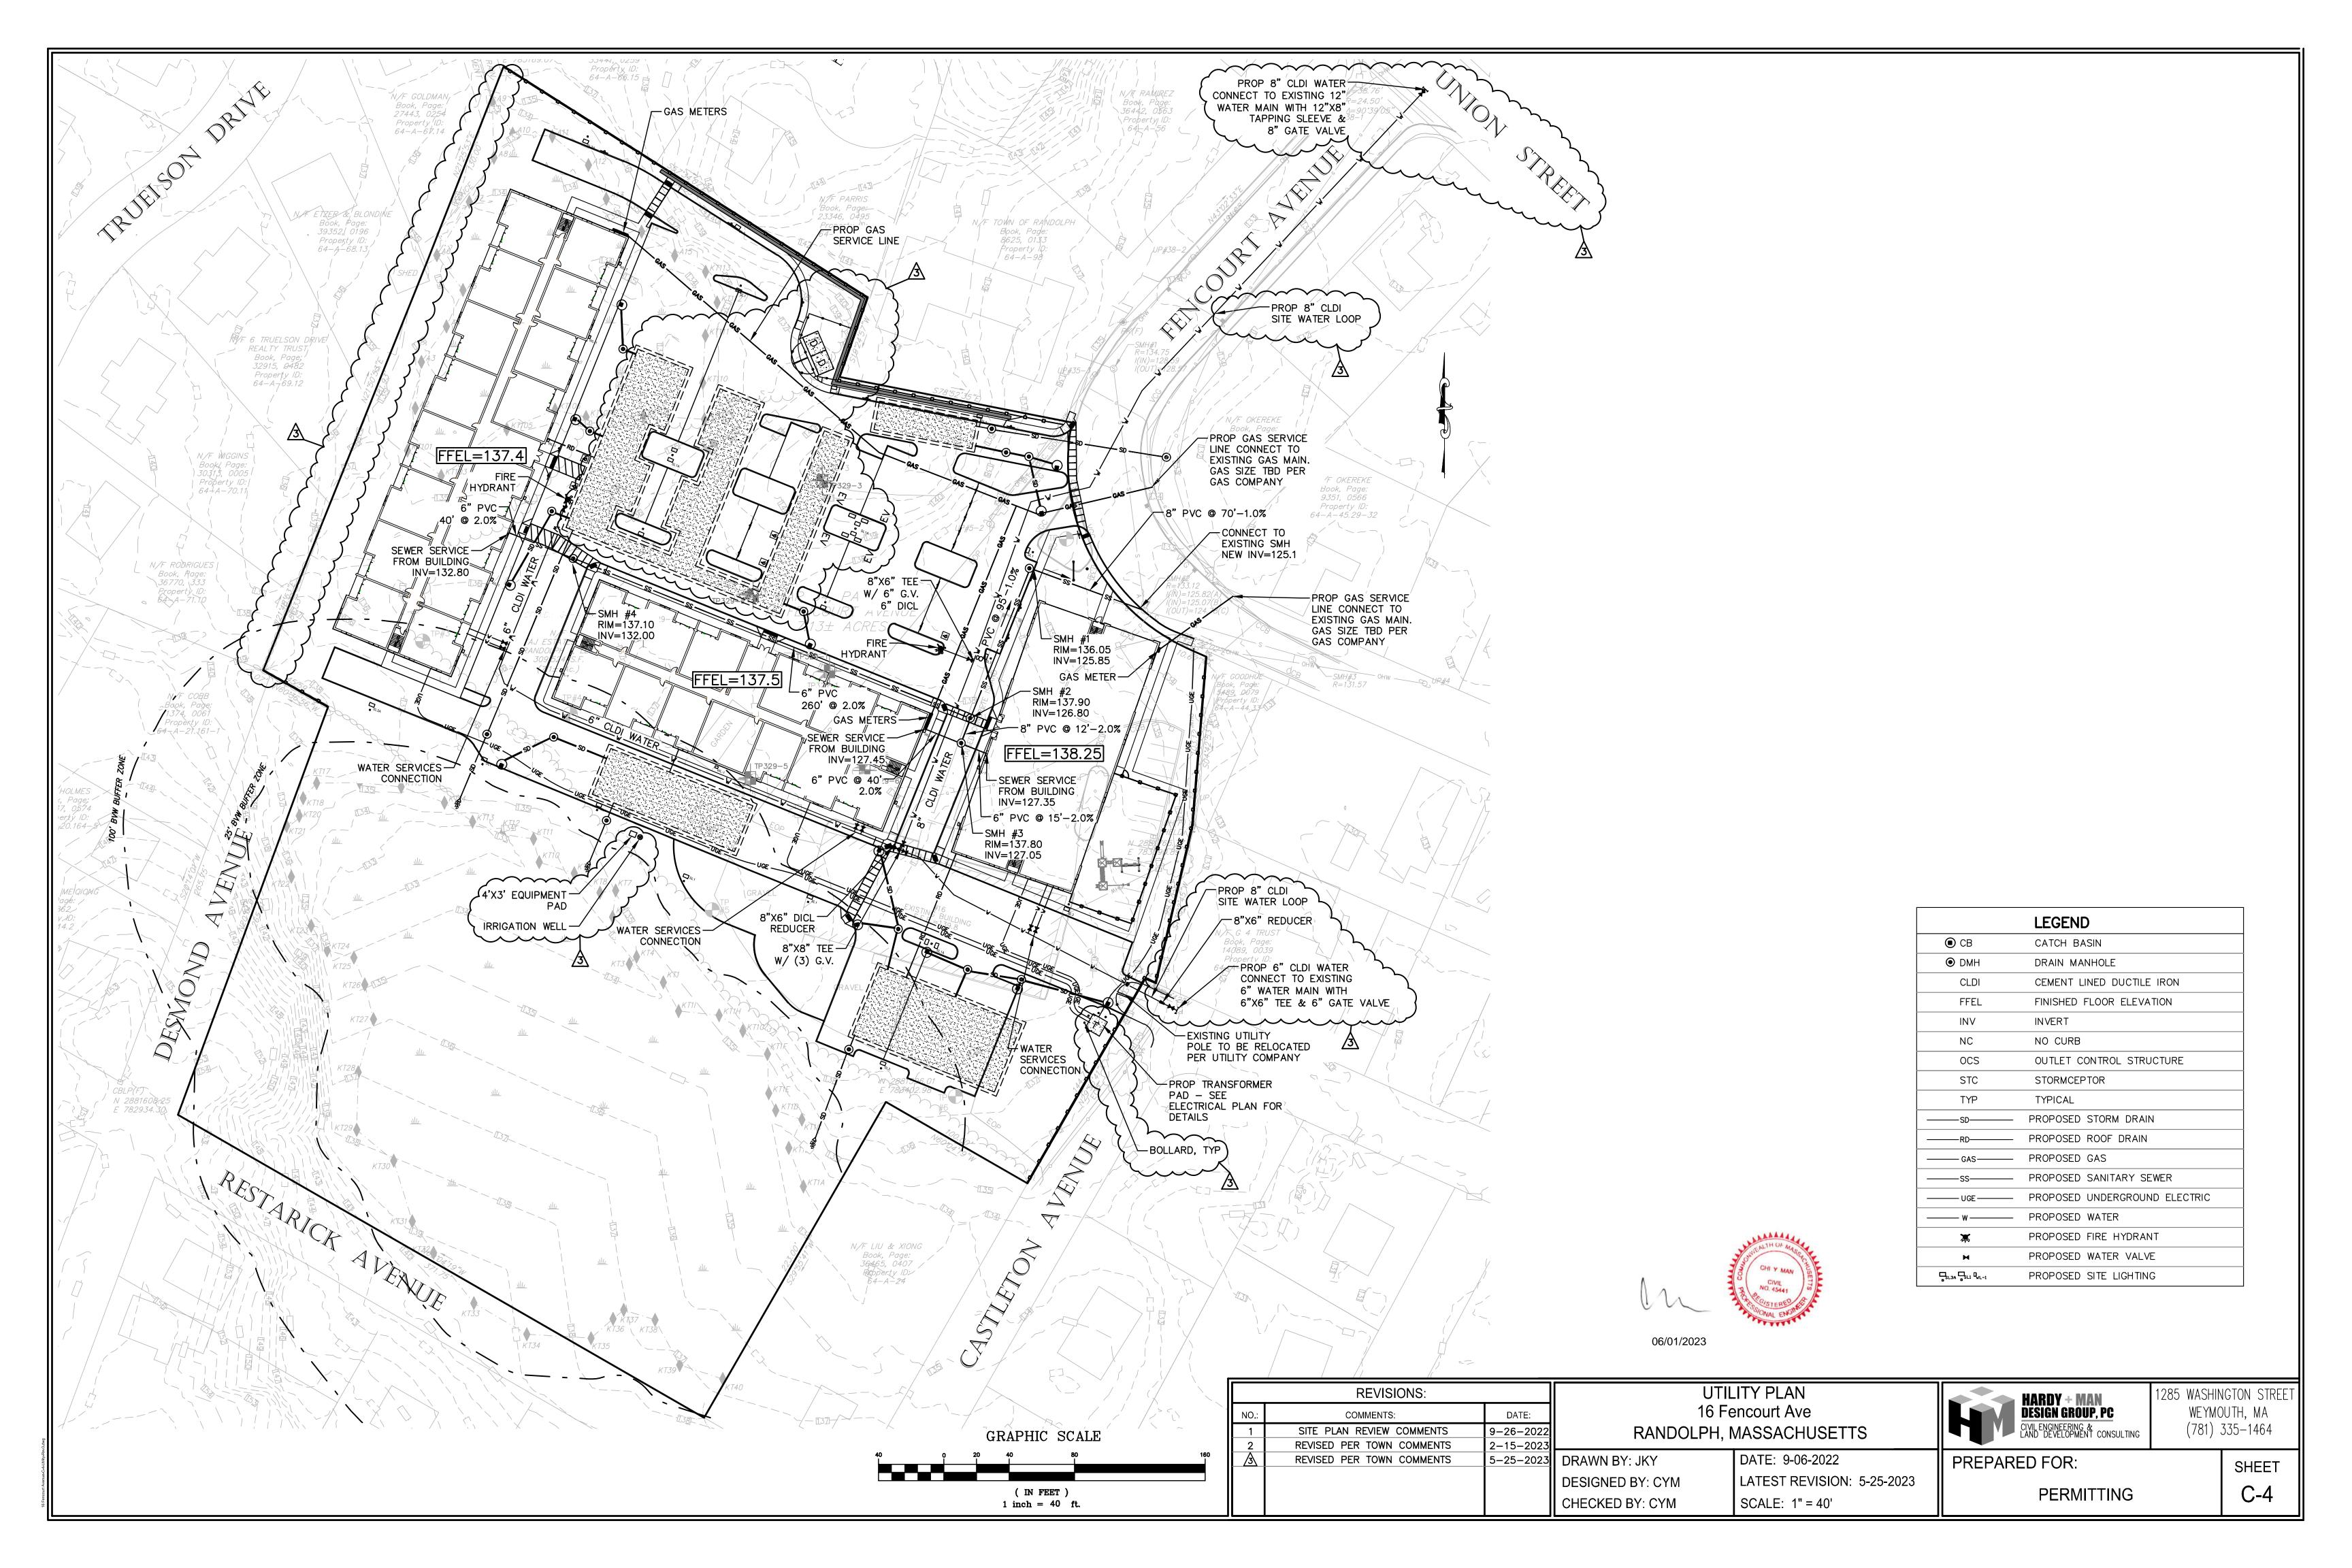

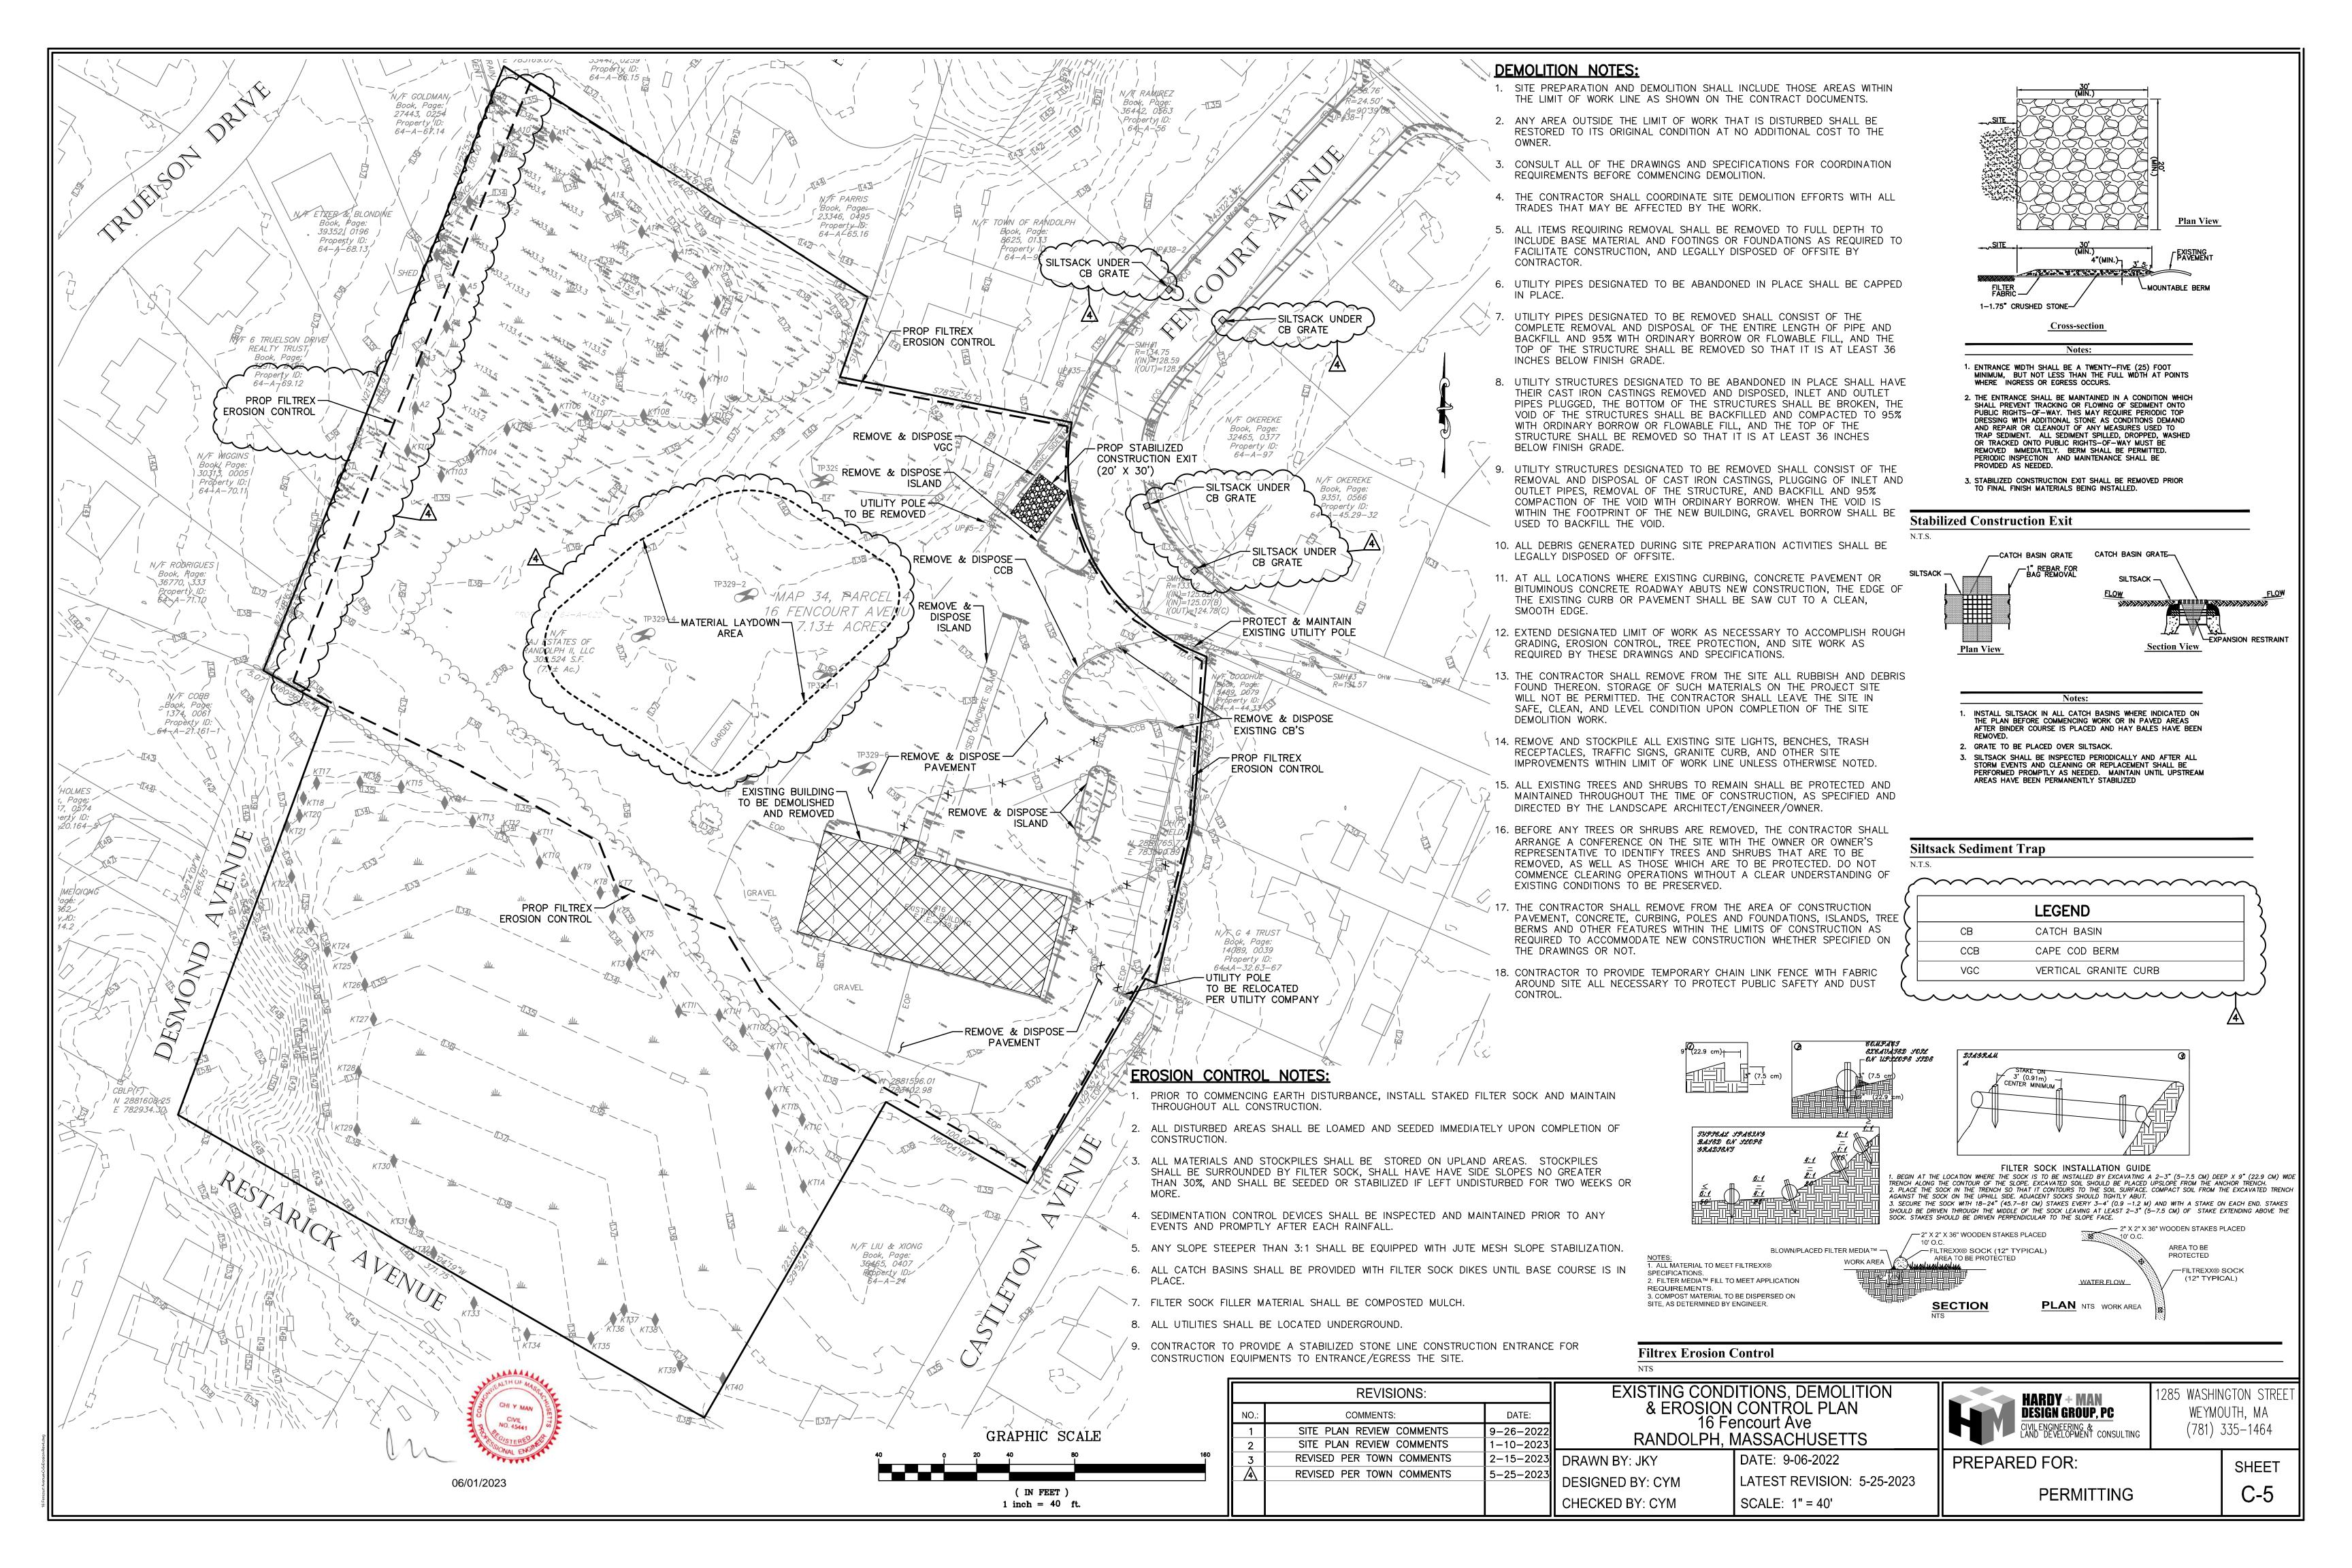

J. On-	Site Revi	iew (minim	num of two hole	es requ	ired at eve	ry propo	sed prim	nary and i	reserve disp	oosal area)		
Deep	Observation	n Hole Numb	er: <u>329-1</u> Hole #	3/29/2 Date	1	Time		45 - clo		Latitude		 ongitude:
I. Land	Use (e.g., wo	oodland, agricult	ural field, vacant lot, e						es (e.g., cobbles,			Slope (%)
Des	scription of Lo	ocation:										
2. Soil P	arent Materia	al:										
B Distar	nces from:	One	n Water Body _	fe	La et	indform D	rainage W	Pos Iav	ition on Landscap	oe (SU, SH, BS, Wet	FS, TS)	foot
Diotai	1000 110111.		Property Line _				-	•	feet			
I. Unsuita	ble Material		Yes □ No									
5. Grour	ndwater Obse	erved: \(\) Yes	s 🛚 No		If yes	s:	Depth Wee	ping from Pit	_	Depth St	tanding Wate	er in Hole
	THE TOTAL STATE OF	1				Soil Log						
Depth (in)	Soil Horizon	Soil Texture	Soil Matrix: Color-	Red	oximorphic Fea	atures		ragments Volume	Soil Structure	Soil Consistence		Other
	/Layer	(USDA	Moist (Munsell)	Depth	Color	Percent	Gravel	Cobbles & Stones	Con Chactare	(Moist)		Other
0-96	FILL	-	-	-	-	-	-	-	-	-		-
96-122	С	LS	10YR 4/3	102"	10YR 6/8	40%	15%	15%	М	V. Friable		


									l			


БССР	Ohservation	Hole Numl	oer: <u>329-2</u>	3/	29/21			- cloudy	reserve dis _i		
	Observation	THOIC HUIII	Hole #	Da	te -	Time		ather	Latitude		Longitude:
1. Land l	Jse: (e.g.,	woodland, agr	icultural field, va	cant lot, etc.) Veg	etation		Surface Sto	nes (e.g., cobbles,	stones, boulders, etc.	.) Slope (%)
Descri	iption of Loca	ation:	-								
2. Soil Pa	arent Materia	1:					Landform			Position on Landscap	pe (SU, SH, BS, FS, TS)
3. Distan	ces from:	Open Wate	r Body	feet		Drain	age Way _	feet	Wetla	nds feet	
1. Unsuital	hle	Proper	ty Line	feet	D	rinking W	ater Well _	feet	Ot	her feet	
		⊠ Yes □	No If Yes:	☐ Distu	bed Soil	☑ Fill Mate	erial [☐ Weathered	Fractured Rock	Bedrock	
5. Groun	dwater Obse	rved: X Ye	s 🗌 No			If	yes: <u>92"</u> D	epth Weeping fr	om Pit	98" Depth Standing	g Water in Hole
	Γ						I Log	Framonto			
Depth (in)	Soil Horizon S				cimorphic Fea	76 by Volulli			Soil Structure	Soil Consistence	Other
	/Layer	(USDA)	(Munsell)	Depth	Color	Percent	Gravel	Cobbles & Stones		(Moist)	
0-24	FILL	-	-	-	-	-	-	-	-	-	_
	^	FSL	10YR 3/2	_	-	-	<5%	<5%	Cr	Friable	
24-32	Α					_	<5%	<5%	Sabk	Friable	
24-32 32-46	В	SL	2.5Y 6/8	-	-	1					
		SL LS	2.5Y 6/8 10YR 4/2	64"	- 10YR 6/8	50%	5%	5%	М	V. Friable	
32-46	В				- 10YR 6/8 -	50%	5% 25%	5% 10%	M SG	V. Friable Loose	
32-46 46-80	B C1	LS	10YR 4/2	64"	- 10YR 6/8 -					_	
32-46 46-80	B C1	LS	10YR 4/2	64"	- 10YR 6/8 -					_	

Deep			ann or two more	3 requi	eu al eve	у ргоро	sea prim	ary and r	eserve disp	osai area)	
	Observation	Hole Numb	er: <u>329-3</u> Hole #	3/29/2		Time		45 - clo		Latitude	 Longitude:
1 Land	Use /		ural field, vacant lot, e								
			urai field, vacant lot, e					Surface Stone	es (e.g., copples,	stones, boulders, etc	c.) Slope (%)
2. Soil P	arent Materia	al:									
o D: I	•										
3. Distar	nces from:	-	n Water Body				-	•		Wetland	
			Property Line _] Yes □ No				-91				er feet
5 Grour	ndwater Obse	erved: Yes	s 🖂 No		If ve	z·	Donth Moor	oine from Dit		Depth Standi	ng Matar in Halo
o. Oloui	id Water Obec				., , 0	Soil Log		onig nom en	-	Depth Standi	ng water in riole
	Soil Horizon	Soil Texture	Soil Matrix: Color-	Redo	ximorphic Fe		Coarse F	ragments Volume		Soil	
Depth (in)	/Layer	(USDA	Moist (Munsell)	Depth	Color	Percent	Gravel	Cobbles & Stones	Soil Structure	Consistence (Moist)	Other
0-8	A / FILL	FSL	10YR 3/2	-	-	_	<5%	<5%	Cr	Friable	
		1.0	10VD 4/2	_	_	_	20%	30%	М	V. Friable	
8-132	С	LS	10YR 4/3				2070			V. I Habie	
8-132	С	LS	101 R 4/3				2070			v. I habie	
8-132	С	LS	10114 4/3				2070			v. i flable	
8-132	С	LS	10114 4/3				20,0			v. i flable	
8-132	С	LS	10114 4/3				20,0			v. i flable	
8-132	C	LS	10114.4/3				20,0			v. i flable	
8-132	C	LS	101 R 4/3				20,0			V. I Hable	

Deep				110100 1	oquii ou ui	every p	roposea p	Jilliary and	reserve dis _l	Jusai area)	
•	Observation	Hole Numl	Der: 329-4 Hole #		/29/21	Time		- cloudy ather	Latitude		Longitude:
1. Land l	Jse: (e.g.,	woodland, agr	icultural field, va	cant lot, etc	c.) Veg	etation		Surface Stor	nes (e.g., cobbles,	stones, boulders, e	tc.) Slope (%)
Descri	ption of Loca	ation:									
2. Soil Pa	arent Materia	ıl: ———					Landform			Position on Landso	ape (SU, SH, BS, FS, TS)
3. Distan	ces from:	Open Wate	r Body	feet				feet		nds feet	
4. Unsuita		Propert	ty Line	feet	D	rinking W	ater Well _	feet	Ot	her feet	i e
5. Groun	dwater Obse	rved: X Ye	s 🗌 No	T			l Log	Depth Weeping	from Pit	118" Depth Stan	ding Water in Hole
Depth (in)	Soil Horizon /Layer	Soil Texture (USDA)	Soil Matrix: Color-Moist	Redo Depth	ximorphic Fea	atures Percent		Volume Cobbles &	Soil Structure	Soil Consistence (Moist)	Other
0-46	FILL	-	(Munsell)	- Deptil	-	-	- Graver	Stones -	_	-	-
		FSL	10YR 3/2	_	_		<5%	<5%	Cr	Friable	
46-56	Α	1 02									
46-56 56-64	В	SL	2.5Y 6/8	_	-	-	<5%	<5%	Sabk	Friable	
			2.5Y 6/8 10YR 5/2	- 86"	- 10YR 6/8	40%	<5% 5%	<5% 5%	Sabk	Friable Loose	
56-64	В	SL									
56-64	В	SL									

Deep						y propo	ood piiiii	ary arrar	eserve disp	ocar aroay	
	Observation	Hole Numb	er: <u>329-5</u> Hole #	3/29/2 Date	1	Time		45-clou Weather		Latitude	 Longitude:
			ural field, vacant lot, e		Vegetation			Surface Stone	es (e.g., cobbles,	stones, boulders, e	Slope (%)
	arent Materia							1		310000	
00111	archi Materie				La	ndform		Posi	tion on Landscap	e (SU, SH, BS, FS	s, TS)
3. Distar	nces from:	Oper	n Water Body	fee	et		•	ay			nds feet
			Property Line _					ell		Oth	
4. Unsuita	able Materials	s Present: 🗵	Yes 🗌 No	If Yes: L	_ Disturbed S	Soil 🖂 I	-ill Material		Weathered/Fra	ctured Rock L	_ Bedrock
5. Grour	ndwater Obse	erved: 🛛 Yes	s 🗌 No		If yes	6: <u>76"</u> De	pth Weeping	from Pit	9	0" Depth Standing	Water in Hole
		Y				Soil Log		***************************************			
Depth (in)	enth (in) Soil Horizon Soil Texture Soil Matrix: Color-				ragments Volume	Soil Structure	Soil	Other			
Depair (III)	/Layer	(USDA	Moist (Munsell)	Depth	Color	Percent	Gravel	Cobbles & Stones	Jon Structure	(Moist)	- Cinci
0-56	FILL	-	-	-	-	-	1	-	-	-	-
56-60	А	FSL	10YR 2/1	-	-	-	<5%	<5%	Cr	Friable	
60-68	В	C. Sand	10YR 6/8	-	-	_	15%	10%	SG	Loose	
	С	Sand	10YR 5/3	72"	10YR 6/8	40%	20%	10%	SG	Loose	
68-94											
68-94											
68-94			7.00								

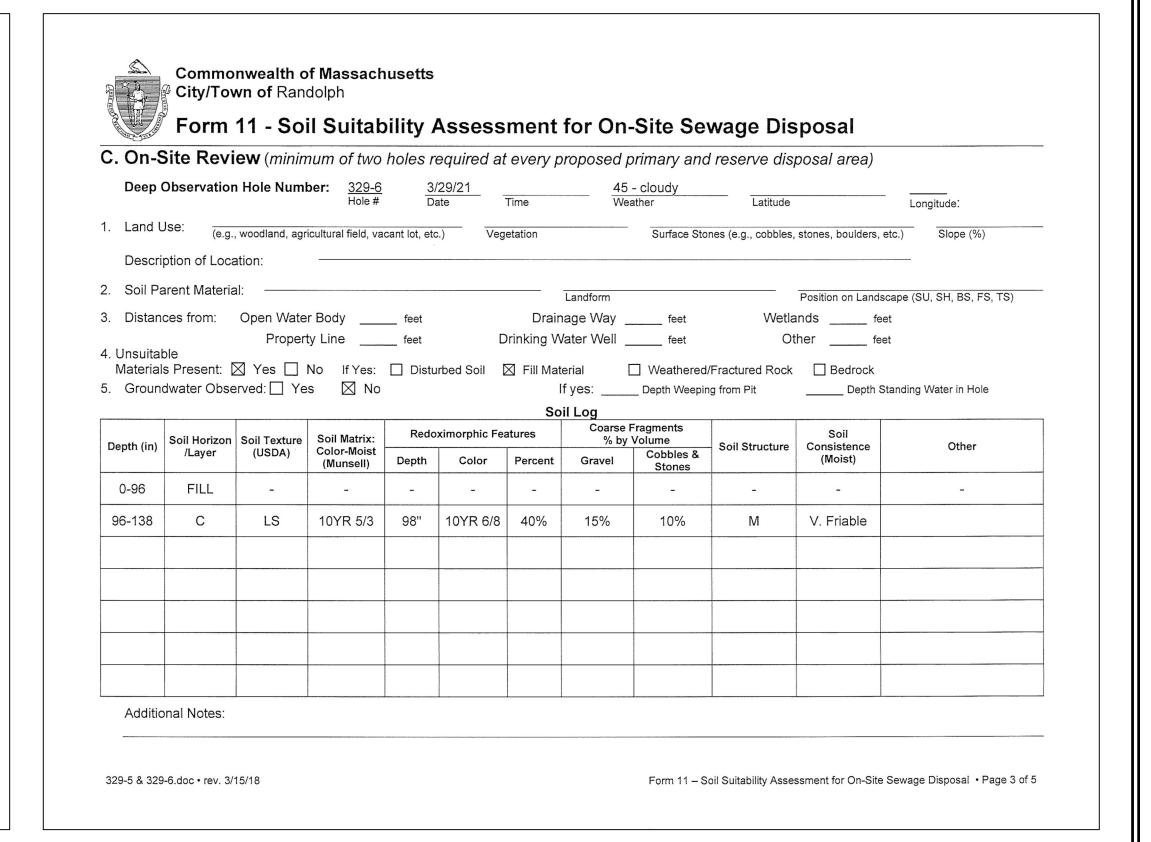

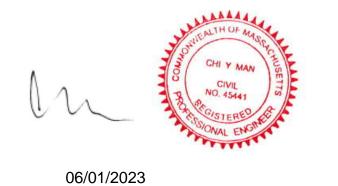

	REVISIONS:		
NO.:	COMMENTS:	DATE:	
1	SITE PLAN REVIEW COMMENTS	9-26-2022	
2	REVISED PER TOWN COMMENTS	2-15-2023	
3	NO CHANGE	5-25-2023	DF
			DE
			CH

16 Fe	TAILS 1 encourt Ave MASSACHUSETTS	HARDY DESIGN CIVIL ENGIN LAND DEVI
/	DATE: 9-06-2022	DDEDADED EC

DY + MAN AN GROUP, PC GINEERING & CONSULTING 1285 WASHINGTON STREET WEYMOUTH, MA (781) 335-1464

DRAWN BY: JKY

DESIGNED BY: CYM


CHECKED BY: CYM


S

DATE: 9-06-2022 LATEST REVISION: 5-25-2023 SCALE: AS SHOWN

PREPARED FOR:
PERMITTING


SHEET C-6

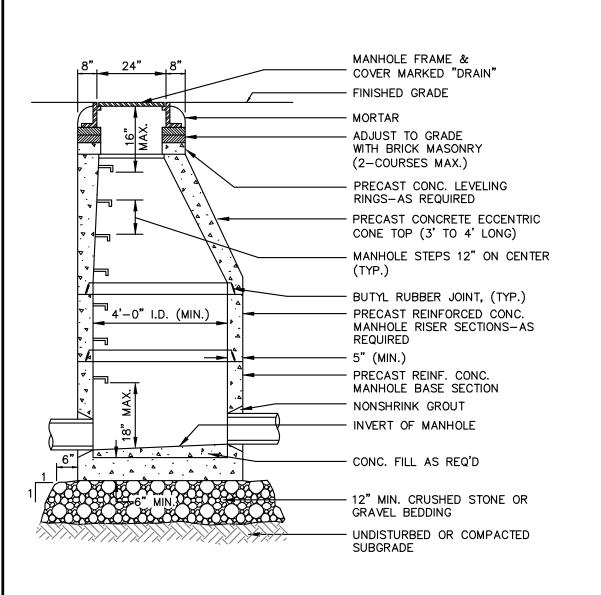

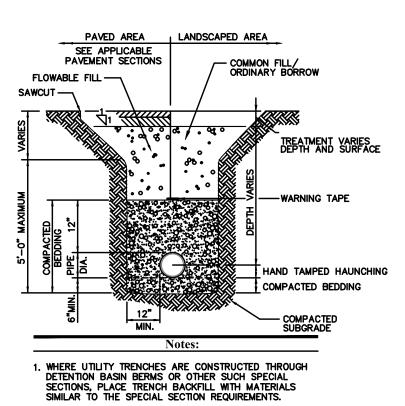

2. USE METALLIC TRACING/WARNING TAPE OVER ALL PIPES.

3. PAVEMENT SECTION TO CONFORM TO TOWN OF BRAINTREE DEPARTMENT OF PUBLIC WORKS (DPW) SPECIFICATION.

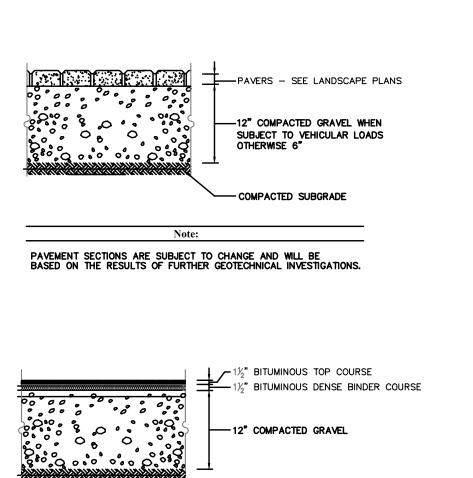


- COMPACTED SUBGRADE


- BIT. CONC. PAVEMENT

- TACK COAT

PAVEMENT SECTIONS ARE SUBJECT TO CHANGE AND WILL BE BASED ON THE RESULTS OF FURTHER GEOTECHNICAL INVESTIGATIONS.

PAVEMENT OUTSIDE OF SITE BOUNDARY SHALL CONFIRM TO MASSDOT STANDARD

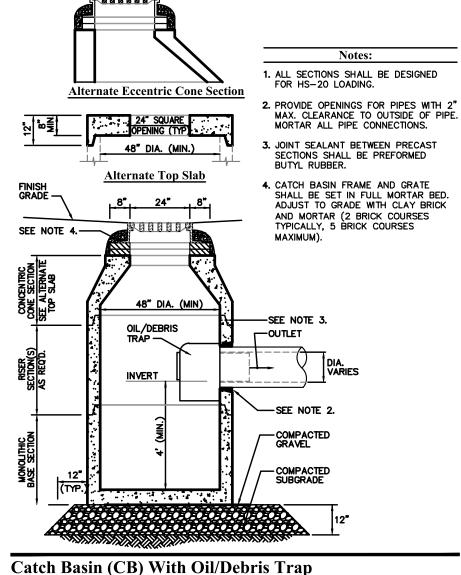

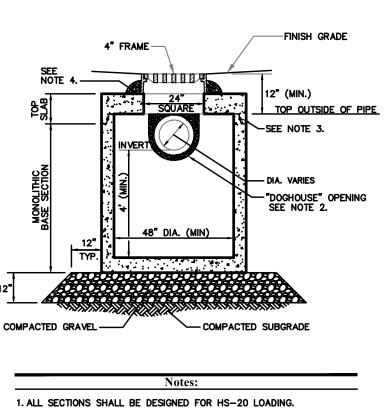

4. CATCH BASIN FRAME AND GRATE (4"DEPTH) SHALL BE SET IN FULL MORTAR BED.

5. ADJUST TO FINISH GRADE WITH CLAY BRICK AND MORTAR AS

Catch Basin (CB) Shallow Cover

Specify whether gas sealed cleanout cover is required. Will be furnished plain if not requested.

2. PROVIDE DOGHOUSE OPENING FOR PIPES WITH 2" MAX. CLEARANCE TO OUTSIDE OF PIPE. TOP SLAB SHALL NOT REST DIRECTLY ON PIPE. R-3705-10 28 5/8 12 31 1/2 15 GROUT ALL PIPE CONNECTIONS (NON-SHRINK GROUT). 16 5/8 8 3. JOINT SEALANT BETWEEN PRECAST SECTIONS SHALL BE PREFORMED BUTYL RUBBER.

Catch Basin Trap

R-3705 Series Catch Basin Trap

1. PRODUCT FROM NEENAH ENTERPRISES, INC , MODEL NUMBER $R\!-\!3705$

SANITARY TRAP

Cast or grouted in manhole wall. Pipe bell is not the structural support.

Precast Concrete Drain Manhole (DMH)

Min 15" High

w/ 4" Cap

48"Ø


Section Thru Chamber

PROPOSED HOME


Typical Wye and Chimney Detail (Residential)

HOUSE FOUNDATION

8"

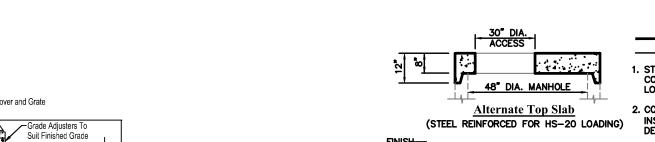

Utility Trench

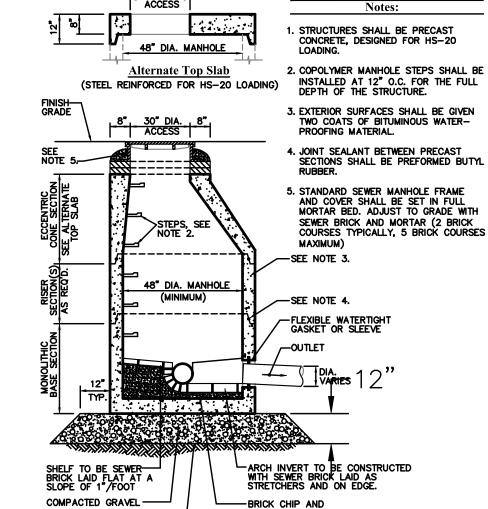




VERTICAL GRANITE CURB


TREATMENT VARIES —


SLOPE VARIES ---

N.T.S.

Bituminous Concrete Pavement Section

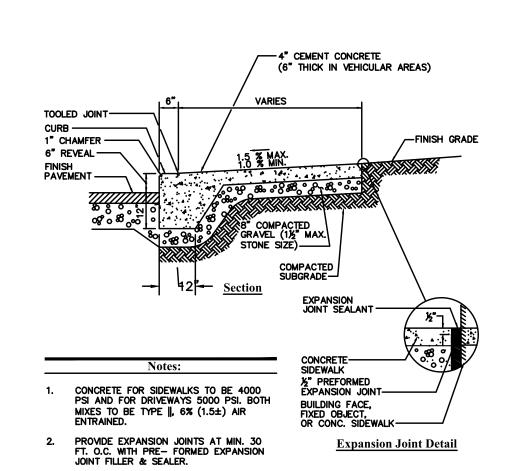

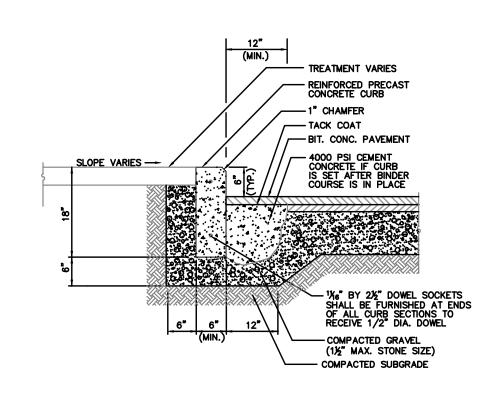


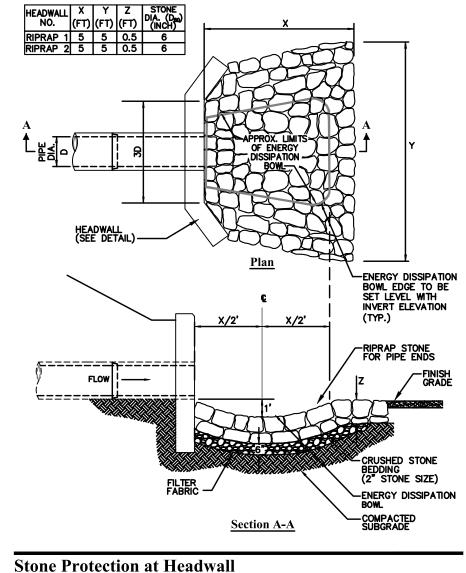


1. The Use Of Flexible Connection is Recommended at The Inlet and Outlet Where Applicable. 2. The Cover Should be Positioned Over The Inlet Drop Pipe and The Oil Port. 3. The Stormceptor System is protected by one or more of the following U.S. Patents: #4985148, #5498331, #5725760, #5753115, #5849181, #6068765, #6371690. 4. Contact a Concrete Pipe Division representative for further details not listed on this drawing. 5. Stormceptor #9 and #10 Using STC 450 i Model.





(Tee Opening to Face Side Wall)

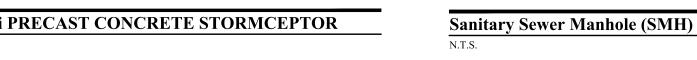


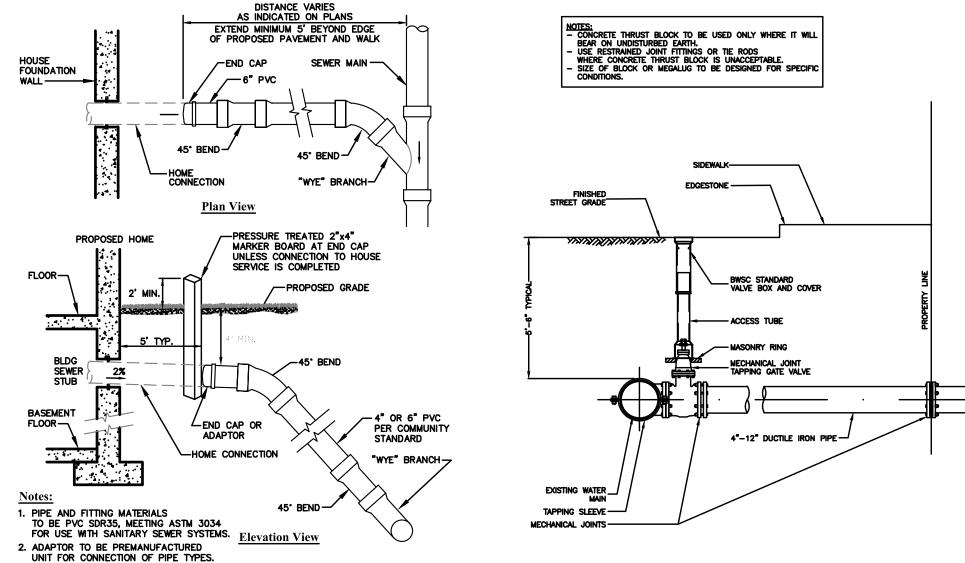


COMPACTED SUBGRADE-

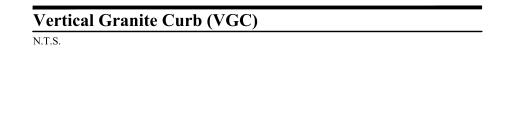


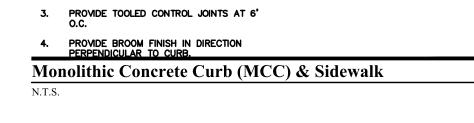


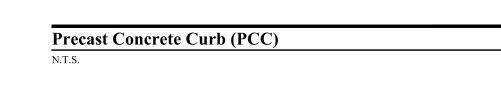


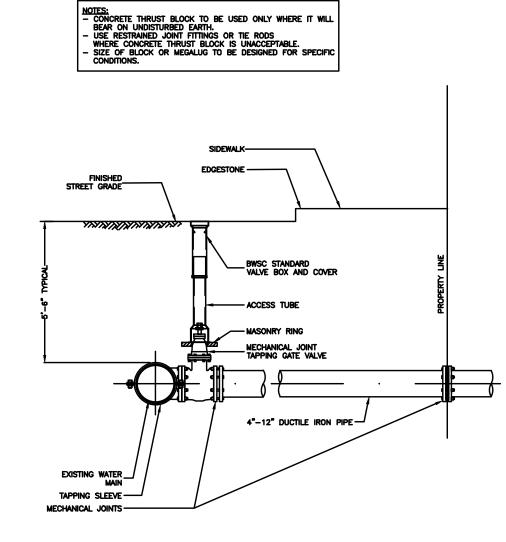


Water Connection to Existing Main

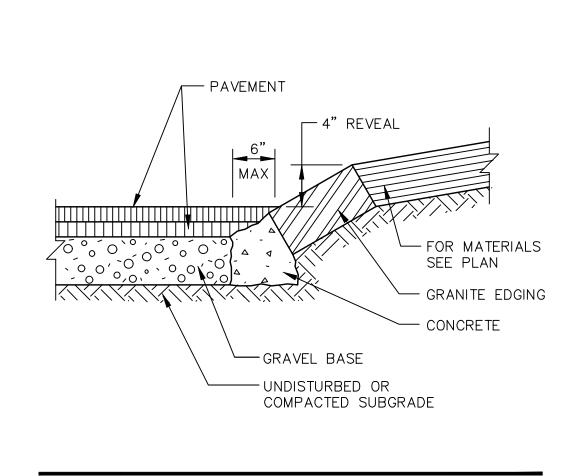

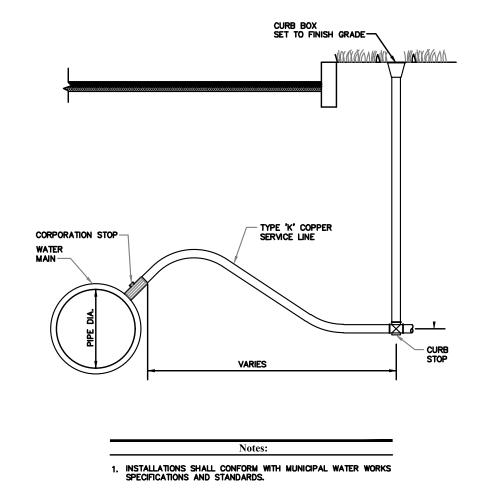

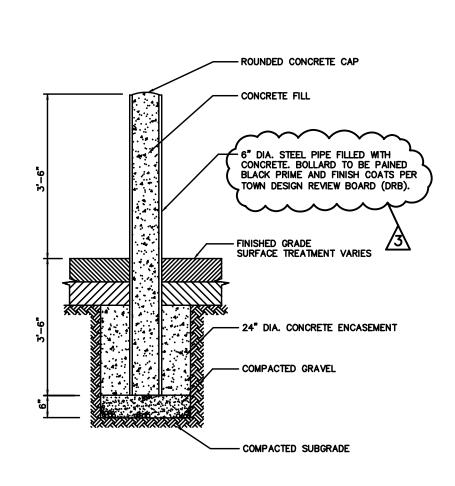

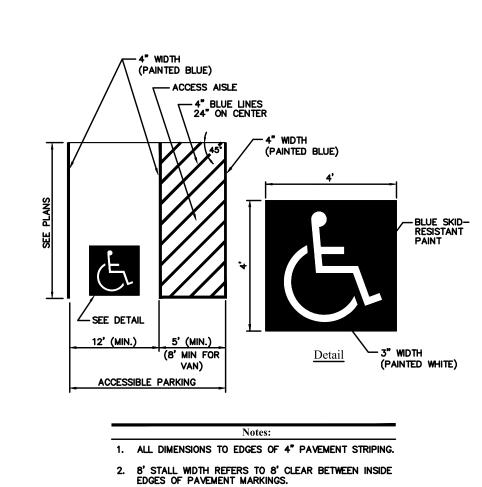

3. ALL SLOPES THROUGHOUT THE ACCESSIBLE PARKING AND AISLE AREAS SHALL NOT EXCEED 1.5%. 4. ACCESS AISLE MEASURED BETWEEN OUTSIDE EDGES OF

Corporation/Curb Stop with Box **Bollard** N.T.S.

	PAVEMENT MARKINGS.	
Accessible	Parking Space	
N.T.S.		

Slope Granite Curb



	REVISIONS:		
NO.:	COMMENTS:	DATE:	
1	SITE PLAN REVIEW COMMENTS	9-26-2022	RANDO
2	REVISED PER TOWN COMMENTS	2-15-2023	
3	REVISED PER TOWN COMMENTS	5-25-2023	DRAWN BY: JKY
			DESIGNED BY: CYM
			CHECKED BY: CYM

DETAILS 2					
16 Fe	encourt Ave				
RANDOLPH, N	MASSACHUSETTS				
DRAWN BY: JKY	DATE: 9-06-2022				

	DESIGN GROUP, P
	CIVIL ENGINEERING & LAND DEVELOPMENT CON
PREPARED FOR:	

1285 Washington Stree T WEYMOUTH, MA (781) 335-1464

PERMITTING

SHEET

| DATE. 9-00-2022 LATEST REVISION: 5-25-2023

HARDY + MAN

