### LEGEND

DESCRIPTION	EXISTING	PROPOSED
PROPERTY LINE		
RIGHT-OF-WAY LINE		
ABUTTERS LOT LINE		
EASEMENT LINE		
BUILDING SETBACK		
LIMITS OF WORK		
BUILDING		
EDGE OF PAVEMENT		
DIRT ROAD		
EDGE OF CURB		
SIDEWALK		
PAVEMENT SAWCUT LINE		
INTERMEDIATE CONTOURS		
INDEX CONTOURS	——————————————————————————————————————	100
SPOT GRADE	x 100.5	+ 100.5
GRAVITY SANITARY SEWER	ss	ss
STORM DRAIN	SD	D D D D
WATER SERVICE	——————————————————————————————————————	——— w——
UNDERGROUND ELECTRIC LINE	E	———Е——
TEL-DATA SERVICE	DATA	DATA
COMMUNICATION SERVICE	COM	COM
CABLE TV SERVICE	CTV	CTV
GAS SERVICE	G	G
SANITARY SEWER MANHOLE	MANHOLE S SEWER CO CLEANOUT O	MANHOLE (S)
STORM DRAIN STRUCTURES	MANHOLE ① CATCH BASIN	MANHOLE ( CATCH BASIN (
WATER SERVICE STRUCTURES	MANHOLE (W) HYDRANT C VALVE	MANHOLE (W) HYDRANT (X) VALVE (X)
ELECTRICAL SERVICE STRUCTURES	MANHOLE © UTILITY CO. METER \( \times \)  MOST BOX \( \tilde{\text{E}} \)	MANHOLE (E) UTILITY CO. POLE
COMMUNICATION STRUCTURES	MANHOLE T TELEPHONE CABLE	MANHOLE ①
GAS SERVICE STRUCTURES	BOX  BOX  GV  GG  WANHOLE  GV  GG  O	MANHOLE (6) VALVE 🔀
STONE WALL		
TREELINE		
EROSION CONTROL (SILT FENCE)		EC EC EC
TEST PIT		

## **ABBREVIATIONS**

D.C.	DITUMINOUS CUIDD	MINI	MINIMITA
BC	BITUMINOUS CURB	MIN	MINIMUM
BIT	BITUMINOUS	MON	MONUMENT
BLDG	BUILDING	NTS	NOT TO SCALE
BND	BOUND	N/A	NOT APPLICABLE
BOC	BOTTOM OF CURB	N/F	NOW OR FORMERLY
BOT	BOTTOM	OHW	OVERHEADWIRES
BW	BOTTOM OF WALL	PVC	POLYVINYL CHLORIDE
CB	CATCH BASIN	PVMT	PAVEMENT
CEM	CEMENT	R	RADIUS
CO	CLEAN OUT	RD	ROOF DRAIN
CONC	CONCRETE	REV	REVISION
DIA	DIAMETER	ROW	RIGHT-OF-WAY
DMH	DRAIN MANHOLE	R&D	REMOVE AND DISPOSE
EG	EXISTING GRADE	R&R	REMOVE AND RESET
EL/ELEV	ELEVATION	R&S	REMOVE AND STACK
ELEC	ELECTRIC	SAN	SANITARY
EMH	ELECTRIC MANHOLE	SCH	SCHEDULE
EOP	EDGE OF PAVEMENT	SF	SQUARE FOOT
EXIST	EXISTING	SMH	SEWER MANHOLE
FFE	FINISHED FLOOR ELEVATION	TBM	BENCHMARK
G	GAS	TC	TOP OF CURB
GC	GRANITE CURB	TP	TEST PIT
GRAN	GRANITE	TW	TOP OF WALL
INV	INVERT	TYP	TYPICAL
IP	IRON PIN	UP	UTILITY POLE
LOW	LIMIT OF WORK	W	WATER
MAX	MAXIMUM	WG	WATER GATE
MH	MANHOLE	WV	WATER VALVE

### STORMWATER MANAGEMENT NOTES:

ALL STORMWATER MANAGEMENT AND EROSION CONTROL SYSTEMS PROPOSED IN THIS PLAN REFER TO THE STORMWATER REPORT ACCOMPANYING THIS PLAN PREPARED BY THE SAME OFFICE.

### **EXISTING UTILITY NOTES:**

- I. EXISTING UTILITIES ARE AS SOWN IN MOST RECENT SURVEY AND/OR AS SHOWN ON THE AS BUILT PLAN ENTITLED "AS-BUILT PLAN OF LAND" PREPARED BY NORFOLK RAM GROUP AND DATED MAY 2005.
- . SEWER MANHOLE RIM ELEVATIONS ARE AS DETERMINED BY THE LATEST SURVEY. SMH #1 INVERT ELEVATION AS PROVIDED BY RECET SURVEY. SMH #2 INVERT ELEVATION CALCULATED BY SUBTRACTING THE RIM-INVERT DIFFERENCE OF THE AS-BUILT PLAN FROM THE RIM ELEVATION DETERMINED BY RECENT SURVEY.
- 3. INVERT AT THE NEW SERWER SERVICE CONNECTION MUST BE DETERMINED ON-SITE BY THE CONTRACTOR AND MUST BE CONFIRMED BY THE ENGINEER OF THE RECORD PRIOR TO CORING, CONNECTION AND BACKFILL, BY THE ENGINEER OF THE RECORD.

#### **GENERAL NOTES:**

- 1. NO CONSTRUCTION SHALL BEGIN UNTIL ANY AND ALL PERMITS ARE OBTAINED FROM THE TOWN OF RANDOLPH.
- THE CONTRACTOR IS RESPONSIBLE FOR SITE SAFETY, COORDINATION WITH THE OWNER AND ALL SUBCONTRACTORS, AND THE MEANS AND METHODS OF CONSTRUCTING THE PROPOSED WORK.
- COMPLY WITH THE LATEST OSHA STANDARDS FOR EXCAVATING WORK. FOLLOW ALL REQUIREMENTS OF OSHA EXCAVATION STANDARDS INCLUDING, BUT NOT LIMITED TO, THE PROVISION FOR A COMPETENT PERSON ON SITE AND ANY REQUIRED DOCUMENTATION REQUIRING CERTIFICATION BY A PROFESSIONAL ENGINEER.
- PER MASSACHUSETTS LAW, CALL 1-888-DIG-SAFE (1-888-344-7233), THE MUNICIPALITY, AND OTHER UTILITY OWNERS IN THE AREA NOT ON THE DIGSAFE LIST AT LEAST 72 HOURS PRIOR TO ANY UNDERGROUND EXCAVATION ON SITE. SUBMIT DIGSAFE VERIFICATION NUMBER TO THE APPROPRIATE MUNICIPALITY PRIOR TO ANY DIGGING, TRENCHING, ROCK REMOVAL, DEMOLITION, BORING, BACKFILLING, GRADING, LANDSCAPING, OR ANY OTHER EARTH MOVING OPERATIONS.
- LOCATIONS OF EXISTING UTILITIES ARE APPROXIMATE. IN ADDITION, SOME UTILITIES MAY NOT BE SHOWN. DETERMINE THE EXACT LOCATION OF UTILITIES BY TEST PIT OR OTHER METHODS, AS NECESSARY TO PREVENT DAMAGE TO UTILITIES AND/OR INTERRUPTIONS IN UTILITY SERVICE. PERFORM TEST PIT EXCAVATIONS AND OTHER INVESTIGATIONS TO LOCATE UTILITIES, AND PROVIDE THIS INFORMATION TO THE ENGINEER, PRIOR TO CONSTRUCTING THE PROPOSED IMPROVEMENTS. THE ENGINEER WILL USE THE TEST PIT INFORMATION AND OTHER INFORMATION COLLECTED BY THE CONTRACTOR ON THE LOCATION OF EXISTING UTILITIES TO DIRECT THE CONTRACTOR IN THE EVENT THAT THERE IS A CONFLICT BETWEEN AN EXISTING UTILITY AND THE
- 6. TEST PITS TO LOCATE EXISTING UTILITIES MAY BE ORDERED BY THE ENGINEER.
- NOTIFY THE ENGINEER OF ANY UTILITIES IDENTIFIED DURING CONSTRUCTION THAT ARE NOT SHOWN ON THE DRAWINGS OR THAT DIFFER IN SIZE OR MATERIAL.
- FIELD VERIFY ALL EXISTING CONDITIONS PRIOR TO CONSTRUCTION. IF FIELD CONDITIONS ARE OBSERVED THAT VARY SIGNIFICANTLY FROM THOSE SHOWN ON THESE PLANS, IMMEDIATELY NOTIFY THE ENGINEER IN WRITING FOR RESOLUTION OF THE CONFLICTING INFORMATION.
- 9. THE CONTRACTOR IS RESPONSIBLE TO INSTALL UTILITIES ACCORDINGLY WITH THE TOWN OF BROOKLINE STANDARDS AND TO REQUEST AND SCHEDULE INSPECTIONS.
- 10. PROPOSED AND EXISTING UTILITY ELEVATIONS MUST BE CONFIRMED PRIOR TO INSTALLATION AND BACKFILLING AND APPROVED BY THE ENGINEER OF RECORD.
- 11. WATERPROOFING AND OTHER STRUCTURAL DETAILS MUST BE PERFORMED AND DEPICTED BY A REGISTERED STRUCTURAL ENGINEER.
- 12. AS OF JANUARY 1, 2019, ALL TRENCH EXCAVATION CONTRACTORS SHALL COMPLY WITH MASSACHUSETTS GENERAL LAWS CHAPTER 82A, TRENCH EXCAVATION SAFETY REQUIREMENTS, TO PROTECT THE GENERAL PUBLIC FROM UNAUTHORIZED ACCESS TO UNATTENDED TRENCHES. TRENCH EXCAVATION PERMIT REQUIRED. THIS APPLIES TO ALL TRENCHES, BOTH ON PUBLIC AND/OR PRIVATE PROPERTY.
- 13. AFTER ALL ENGINEERING PERMITS ARE OBTAINED, THE CONTRACTOR NEEDS TO NOTIFY THE ENGINEERING DIVISION A MINIMUM OF 48-HOURS IN ADVANCE AND SCHEDULE AN APPOINTMENT TO HAVE SITE UTILITIES AND STORMWATER COMPONENTS INSPECTED. THE SYSTEM & UTILITIES MUST BE FULLY EXPOSED FOR THE INSPECTOR. ONCE THE INSPECTOR IS SATISFIED, THE SYSTEM & UTILITIES MAY BE BACKFILLED.
- 14. THE NEW SERVICE(S) AND/OR STRUCTURE(S) SHALL BE PRESSURE TESTED OR VIDEOTAPED AFTER FINAL INSTALLATION IS COMPLETE. METHOD OF FINAL INSPECTION SHALL BE DETERMINED SOLELY BY THE CONSTRUCTION INSPECTOR FROM THE TOWN ENGINEERING DIVISION. THE SEWER SERVICE WILL NOT BE ACCEPTED UNTIL ONE OF THE TWO METHODS STATED ABOVE IS COMPLETED. A CERTIFICATE OF OCCUPANCY WILL NOT BE RECOMMENDED UNTIL ALL PIPING AND STRUCTURES ARE TESTED AND PASS.
- 15. PRIOR TO THE ISSUANCE OF AN OCCUPANCY PERMIT, AN AS-BUILT PLAN MUST BE SUBMITTED TO THE ENGINEERING DIVISION IN BOTH DIGITAL FORMAT AND IN HARD COPY. THE PLAN MUST SHOW ALL UTILITIES AND DRAINAGE COMPONENTS (UTILIZING SWING TIES), ANY EASEMENTS AND FINAL GRADING. THE AS-BUILT PLAN MUST BE STAMPED, SIGNED, AND DATED BY A PROFESSIONAL ENGINEER OR PROFESSIONAL LAND SURVEYOR.
- 16. ALL WORK MUST BE DONE IN ACCORDANCE WITH "TOWN OF RANDOLPH ZONING BY-LAWS". ALL WORK SHALL BE SUBJECT TO INSPECTION AND APPROVAL BY THE TOWN OF RANDOLPH ENGINEERING DEPARTMENT.
- 17. ALL GAS AND ELECTRIC SERVICE LINES ARE SHOWN AS CONCEPT. THE UTILITY PROVIDER AND OR ELECTRIC/MECHANICAL ENGINEER MUST PROVIDE CONSTRUCTION AND DESIGN DETAILS INCLUDING BUT NOT LIMITED TO THE SIZE, LOCATION, TRENCH DETAIL, AND SETBACKS.


### **EROSION AND SEDIMENT CONTROL NOTES:**

- 1. ALL EROSION AND SEDIMENT CONTROL MEASURES ARE TO BE PLACED PRIOR TO COMMENCEMENT OF LAND DISTURBANCE ACTIVITIES. THE CONTRACTOR IS RESPONSIBLE FOR NOTIFYING THE TOWN OF HOLBROOK CONSERVATION COMMISSION ONE (1) WEEK PRIOR TO THE START OF CONSTRUCTION FOR INSPECTION OF THE EROSION CONTROL MEASURES.
- 2. THE CONTRACTOR IS RESPONSIBLE FOR INSTALLATION OF ANY ADDITIONAL EROSION CONTROL MEASURES NECESSARY TO PREVENT EROSION AND SEDIMENTATION.
- 3. ALL DISTURBANCES TO DRAIN TO APPROVED SEDIMENT CONTROL MEASURES AT ALL TIMES DURING LAND DISTURBING ACTIVITIES AND DURING SITE DEVELOPMENT UNTIL FINAL STABILIZATION IS ACHIEVED.
- 4. THE CONTRACTOR SHALL INSPECT ALL EROSION CONTROL MEASURES WEEKLY AND AFTER EACH RAINFALL EVENT. ANY NECESSARY REPAIRS OR CLEANUP TO MAINTAIN THE EFFECTIVENESS OF THE EROSION CONTROL DEVICES SHALL BE MADE IMMEDIATELY.
- 5. THE CONTRACTOR SHALL MAINTAIN A SURPLUS SUPPLY OF NECESSARY EROSION CONTROL DEVICES ON-SITE FOR EMERGENCY USE (STRAW BALES, WATTLES, FILTER BERM, SILT FENCE, STAKES, CRUSHED STONE).

# CONSTRUCTION SEQUENCE NOTES:

ITEMS MUST OCCUR IN THE ORDER LISTED; ITEMS CANNOT OCCUR CONCURRENTLY UNLESS SPECIFICALLY NOTED.


- 1. NO CONSTRUCTION CAN BEGIN UNTIL ANY AND ALL PERMITS ARE OBTAINED FROM THE TOWN OF RANDOLPH.
- 2. STAKE LIMITS OF CLEARING.
- 3. INSTALL EROSION CONTROL BARRIERS AT LIMIT OF WORK AS DEPICTED.
- 4. SCHEDULE INSPECTION BY CONTACTING THE TOWN OF RANDOLPH.
- 5. PERFORM DEMOLITION OF THE EXISTING SITE APPURTENANCES.
- 6. PERFORM CLEARING AND CURB CUT NECESSARY TO INSTALL STONE CONSTRUCTION ENTRANCES.
- 7. INSTALL CONSTRUCTION ENTRANCES.
- 8. INSTALL REMAINING EROSION CONTROL SYSTEMS.
- 9. SCHEDULE INSPECTION BY CONTACTING THE CITY OF FRAMINGHAM.
- 10. PERFORM CLEARING AND GRUBBING AS NECESSARY.
- 11. STRIP AND STOCKPILE LOAM.
- 12. PERFORM EARTHWORK CUT AND FILLS FOR ROUGH GRADE.
- 13. INSTALL CONCRETE FOUNDATION FOR THE PROPOSED STRUCTURES.
- 14. CONSTRUCT UPPER STRUCTURE INCLUDING ROOFS AND SIDING.
- 15. INSTALLATION OF UTILITIES.
- 16. REMOVE TEMPORARY CONTROLS EXCEPT PERIMETER CONTROLS AND STONE CONSTRUCTION ENTRANCE.
- 17. PERFORM FINE GRADING AND PREPARE SUBGRADE FOR PAVING.
- 18. PERMANENT/FINAL STABILIZATION.
- 19. REMOVE STONE CONSTRUCTION ENTRANCE AND PERIMETER EROSION CONTROLS.
- 20. PERFORM AS-BUILT SURVEYS AND SUBMIT TO TOWN OF RANDOLPH FOR ACCEPTANCE.

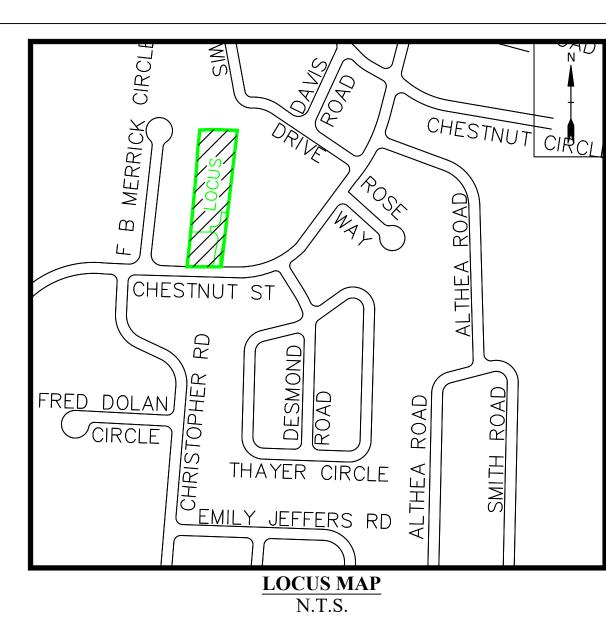

#### BASE PLAN NOTES:

- 1. THE EXISTING CONDITIONS INFORMATION SHOWN ON THE DRAWINGS IS BASED ON THE FOLLOWING:
- EXISTING CONDITIONS TAKEN FROM A CAD FILE TITLED "P2252.DWG" PROVIDED TO THE ENGINEERING CONSULTANT BY BORDERLAND ENGINEERING, INC VIA EMAIL IN DWG FORMAT IN AUGUST 2021.
- AS-BUILT PLAN OF LAND PROVIDED BY NORFOLK RAM GROUP TITLED "LOT 8-A CHESTNUT ST., LOT 8-B PROPOSED ROADWAY OFF CHESTNUT ST." AND DATED MAY 2008.
- THE DRAWING IS BASED ON N.A.V.D. 88 DATUM.
- SUB-SURFACE EXPLORATIONS WERE OBSERVED BY GREGORY BUNAVICZ (S.E. #2712). THE SUBSURFACE EXPLORATION LOGS AND LOCATIONS ARE SHOWN ON THE PLANS.
- THE PROPERTY IS LOCATED WITHIN A SURFACE WATER PROTECTION AREA (ZONE C).
- THE PROJECT AREA IS NOT LOCATED WITHIN NATURAL HERITAGE AND ENDANGERED SPECIES PROGRAM (NHESP) LIMITS OF ESTIMATED PRIORITY HABITAT.
- THE PROJECT AREA IS NOT LOCATED WITHIN THE LIMITS OF BORDERING LAND SUBJECT TO FLOODING (BLSF) AND THE 100-YEAR FLOOD ZONE (PANEL #250250, EFFECTIVE DATE 07/17/2021).
- 2. BOLD TEXT AND LINES INDICATE PROPOSED WORK. LIGHT TEXT AND LINES INDICATE APPROX. EXIST. CONDITIONS.

	SHEET KEY
SHEET NO.	SHEET TITLE
1	LEGEND & GENERAL NOTES
2	RE-DIVISION OF DEFINITIVE PLAN OF LAND
3	EXISTING CONDITIONS & DEMOLITION PLAN
4	PROPOSED CONDITIONS PLAN
5	DETAILS-1
6	DETAILS-2

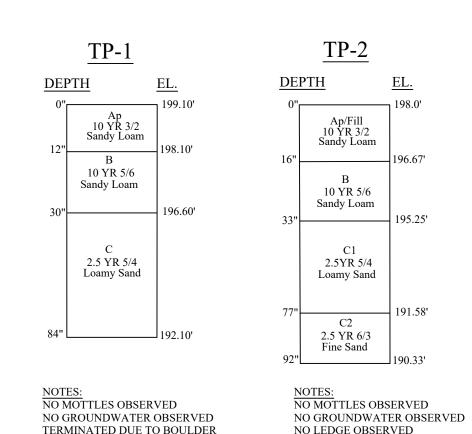

### SUBSURFACE EXPLORATION NOTES:

- 1. TEST PITS WERE PERFORMED BY GREGORY BUNAVICZ (S.E. #2712).
- 2. THE LOGS SHOWN ABOVE REPRESENT THE SOIL DATA PROVIDED BY BORDERLAND ENGINEERING, INC. AND RECIEVED BY MUNDEN ENGINEERING VIA EMAIL ON 08/13/2021.
- 3. THE LOCATION OF THE TEST PITS WERE DETERMINED BASED ON FIELD MEASUREMENTS PERFORMED BY GREGORY BUNAVICZ.
- 4. ELEVATIONS AT THE TEST PIT LOCATIONS WERE DETERMINED BASED ON THE GROUND SURFACE LOCATIONS SHOWN ON THE EXISTING LAND SURVEY PLAN PROVIDED BY DON ROSA. PLS.
- 5. STRATIFICATION LINES REPRESENT APPROXIMATE BOUNDARIES BETWEEN SOIL AND BEDROCK LAYERS. ACTUAL LAYERING MAY BE GRADUAL. FLUCTUATIONS OF GROUNDWATER MAY OCCUR DUE TO OTHER FACTORS THAN THOSE PRESENT AT THE TIMES IT WAS MEASURED.


SUBSURFACE EXPLORATION LOGS NOT TO SCALE

Prepared By:



Munden Engineering

P.O. Box 990211 Boston MA 02199 781-302-6099 mundenengineering.com

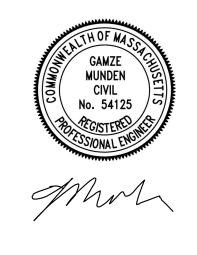

Prepared For:

MICHAEL PERRY 297 CHESTNUT ST RANDOLPH MA

Rev. No.	Rev. Date	Description
D-4	12/20/2021	

Date: 12/20/2021

Drawn by: JLV

Approved by: GM

LEGEND & GENERAL

AS NOTED SCALE:

SHEET 1 OF 6

RESIDENTIAL DISTRICT -RH NOTES: TABLE OF DIMENSIONAL REQUIREMENTS 1. THIS PLAN IS A MODIFCATION OF A PLAN ENTITLED "DEFINITIVE" PLAN OF LAND LOT 8A CHESTNUT ST., LOT 8B, PROPSED ROADWAY <u>REQUIRED</u> <u>LOT 8 A</u> <u>LOT 8 B1</u> <u>LOT 8 B2</u> OFF CHESTNUT ST. IN RANDOLPH, MA. MIN. LOT SIZE 13,362 sf. 24,670 sf. 12,000 s.f. 12,209 sf. DATED: 11/13/2002, RECORDED 1/16/2003 100.01 116.83' LOT FRONTAGE 100' *252.07*′ PLAN #31 OF 2003 IN PLAN BOOK 504, PAGE 31 *75'* 97.15' 132.85' LOT WIDTH 229.83' LOT DEPTH 100' 127' 122.67' 177.15' BY NORFOLK RAM GROUP, LLC ENGINEERING: ENVIRONMENT ONE ROBERTS ROAD, PLYMOUTH, MA 02360 2. SUBJECT TO ALL RIGHTS, EASEMENTS, COVENANTS OR RESTRICTIONS OF RECORD. REFERENCES: DEED REFERENCE: NORFOLK COUNTY REGISTRY OF DEEDS BOOK 29949, PAGE 482 BOOK 29533, PAGE 550 PLAN REFERENCE: PLAN ENTITLED "DEFINITIVE PLAN OF LAND", PREPARED FOR REGISTRY USE ONLY SEE "BROOKVIEW ESTATES" BY NORFOLK RAM GROUP, LLC, DATED NOVEMBER 13, REC. PLAN 573/76 2002, BOOK 504, PAGE 31. TOWN OF RANDOPLH ASESSOR'S MAP 25, LAST REVISED JUNE 14, 2021. #1 F.B. MERRICK CIRCLE #9 F.B. MERRICK CIRCLE #19 F.B. MERRICK CIRCLE PROPERTY ID 25-B-7 #15 F.B. MERRICK CIRCLE "PROPERTY ID 25-B-75 #5 F.B. MERRICK CIRCLE PROPERTY ID 25-B-73 N/F PROPERTY ID 25-B-74 "PROPERTY ID 25-B-76 BENHUR & N/F THE CROWELL REVOC TRUST CHRISTIANA C. EGWIM N/F CARMENCITA SABIJON KEVIN BROOKS HUY PHAM \_\_\_ N17°48'06"E N2017'58"E CIRCLE 140.67' N19°33'41"E 53.90' 90.08' 70.25' THAYER CIRCLE N21°08'39"E UTILITY ACCESS AND 73.40' (RECORD) 73.44' (CALCULATED) — 53.90' DETENTION BASIN LOCUS MAP EASEMENT 1" = 800' R=50.00' TOWN OF RANDOLPH DEPARTMENT REVIEWS: \_\_L=120.63° ∆=138°13′46″ PROPOSED LOT 8 A (PORTION OF MAP PROPOSED LOT 8 B1 (PORTION OF MAP 25B, PROPOSED LOT 8 B2 PORTION OF MAP 25B, `25B, PARCEL 8) PARCEL 68) AREA=12,209 S.F. AREA=13,362 S.F. TOWN OF RANDOLPH BOARD OF HEALTH PARCEL 68) 0.28 ACRES 0.30 ACRES AREA=24,670 S.F. 0.56 ACRES 301 CHESTNUT 192 STREET REALTY TRUST tn 297 CHESTNUT ST MAP 25-B-8 EXISTING ∆=90°05'31" u SINGLE-FAMILY R=25.00' TOWN OF RANDOLPH WATER DEPARTMENT DWELLING PROPOSED 25-FT #39 LEWIS DRIVE T=25.04' *∆=11°16′23*" WIDE RIGHT-OF-WAY PROPERTY ID L=39.31' R=120.00'LENGTH=332.7' R=35.00' 25-B-21.10 T=11.84' AREA=14,388 S.F. R=25.00' L=51.46' L=23.61'O.33 ACRES L=33.73' PRISCILLA A. RILEY *∆=84°14′28″-∆=77°18'35"* -T=31.65' -*S25°54'24"W* T=20.00' R=50.00' - L=108.27° TOWN OF RANDOLPH SEWER DEPARTMENT *79.98'* ∆=124°04'06" DATE: *34.72*′ **♦** *S19°54'59"W* 40.66' S24°00'05"W TOWN OF RANDOLPH FIRE DEPARTMENT S21°00'52"W #41 LEWIS DRIVE 168.12' PROPERTY ID 25-B-20.9 - R=30.00' S25°51'34"W S21°00'52"W 237.93' S21°00'52"W L=8.56' S06 04'55"W IOANNIS KÖRKOVELES & #281 CHESTNUT ST. ∆=16°21′23" INGE P. SCHMIDT PROPOSED LOT 8 B3 NON-BUILDABLE LOT PROPERTY ID 25-B-67 (PORTION OF MAP 25B, PRAYOON & CHANCHAI NINCILA PARCEL 68) TOWN OF RANDOLPH DEPARTMENT OF PUBLIC WORKS THIS PLAN IS A PROPOSED RE-DIVISION OF LOTS 8-A AND 8-B. AS SHOWN ON A AREA=170.4 S.F. RECORDED PLAN FILED WITH THE NORFOLK COUNTY REGISTRY OF DEEDS IN PLAN BOOK 504, 0.0039 ACRES #291 CHESTNUT ST. BASED UPON THE PROPOSED 25-FT WIDE RIGHT OF WAY, LOT 8-A HAS BEEN MODIFIED. PROPERTY ID 25-B-9 LOT 8-B HAS BEEN DIVIDED INTO THREE LOTS LABELED 8-B1, 8-B2, AND 8-B3. N/F JULIA ALEXANDER THE REVISED ROADWAY IS INTENDED TO BE ACCESS FOR LOTS 8-B1 AND 8-B2 ONLY. RANDOLPH DPW ENGINEER LOT 8-B3 IS A NON-BUILDABLE LOT. APPROVED BY THE TOWN OF RANDOLPH PLANNING BOARD CURVE TABLE **CURVE** DEL TA RADIUS *TANGENT* LENGTH 90°05'31" *25.00' 39.31'* 25.04' 23.61' *11°16'23"* 120.00' 11.84' DATE: \_\_\_\_\_ 77"18'35" *25.00* ' 20.00' *33.73* ' <u>LEGEND</u> , CLERK OF THE TOWN OF RANDOLPH C4 84°14'28" *35.00'* 31.65' 51.46' GRAPHIC SCALE CB/lp HEREBY CERTIFY THAT THE NOTICE OF APPROVAL OF THIS PLAN ..CONCRETE BOUND FOUND fnd BY THE PLANNING BOARD HAS BEEN RECEIVED AND RECORDED *C5* 138°13'46" 120.63' 50.00° AT THIS OFFICE AND NO NOTICE OF APPEAL WAS RECEIVED .CONCRETE BOUND TO BE SET DURING THE TWENTY DAYS NEXT AFTER SUCH RECEIPT AND n/a 108.27' 124°04'06" | *50.00'* RECORDING OF SAID NOTICE. ( IN FEET ) 4.31' 16°21′23″ 30.00' *8.56'* 1 inch = 20 ft.THIS ENDORSEMENT OF THE PLANNING BOARD SHOULD NOT BE CONSTRUED TOWN OF RANDOLPH CLERK TO BE A DETERMINATION OF CONFORMANCE WITH ZONING REGULATIONS. LAND SURVEYOR: DON ROSA, PLS 80 MILLBROOK AVE. Re-Division of Definitive Plan of Land REVISIONS **CERTIFICATIONS:** FIELD: GB ZONING DESIGNATION: ENGINEER: DATE DESCRIPTION WALPOLE, MA 02081 LOT 8A CHESTNUT ST., PROPOSED ROADWAY CALCS: DGR I CERTIFY THAT THIS PLAN IS BASED ON AN ACTUAL FIELD SURVEY AND THE SINGLE FAMILY RESIDENTIAL (RH) DONROSA.PLS@GMAIL.COM AND LOT 8B OFF CHESTNUT ST. LATEST PLANS AND DEEDS OF RECORD. (781) 603-8106 DRAWN BY: JLV Munden Engineering IN RANDOLPH, MA I CERTIFY THAT THE DWELLING SHOWN LIES IN ZONE X, AREAS OF MINIMAL PREPARED BY: DON ROSA, PLS CHECKED BY: GM/DGR ASSESSORS REFERENCE: FLOOD HAZARD AS SHOWN ON COMMUNITY PANEL NUMBER 25021C0212E, WITH 80 MILLBROOK AVE. AN EFFECTIVE DATE OF JULY 17, 2012. APPROVED BY: DGR TOWN OF RANDOLPH WALPOLE, MA 02081 P.O. BOX 990211 301 CHESTNUT ST. PARCEL ID 25-B-8 PREPARED FOR: MICHAEL PERRY, TRUSTEE OF THE Boston MA 02199 I HEREBY CERTIFY THAT THIS PLAN HAS BEEN PREPARED IN CONFORMITY WITH 297 CHESTNUT ST. PARCEL ID 25-B-68

PROFESSIONAL LAND SURVEYOR

THE RULES AND REGULATIONS OF THE REGISTERS OF DEEDS OF THE

COMMONWEALTH OF MASSACHUSETTS.

297 CHESTNUT ST REALTY TRUST

SHEET 2

297 CHESTNUT ST

RANDOLPH, MA 02368


(781) 302-6099

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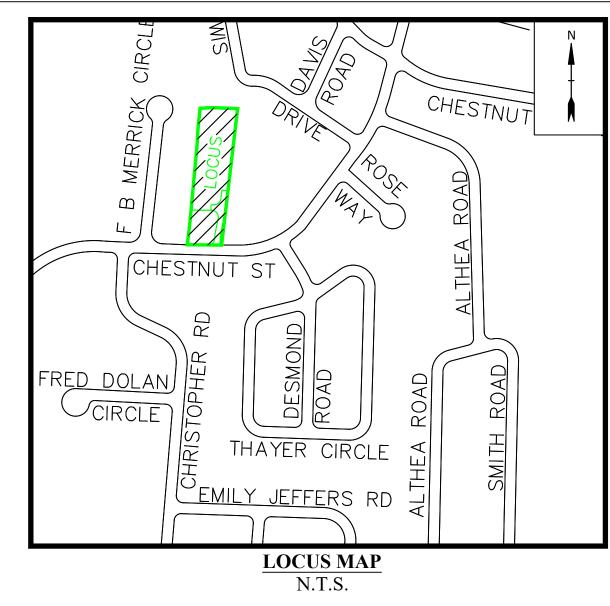
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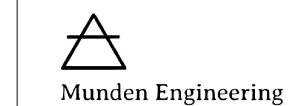
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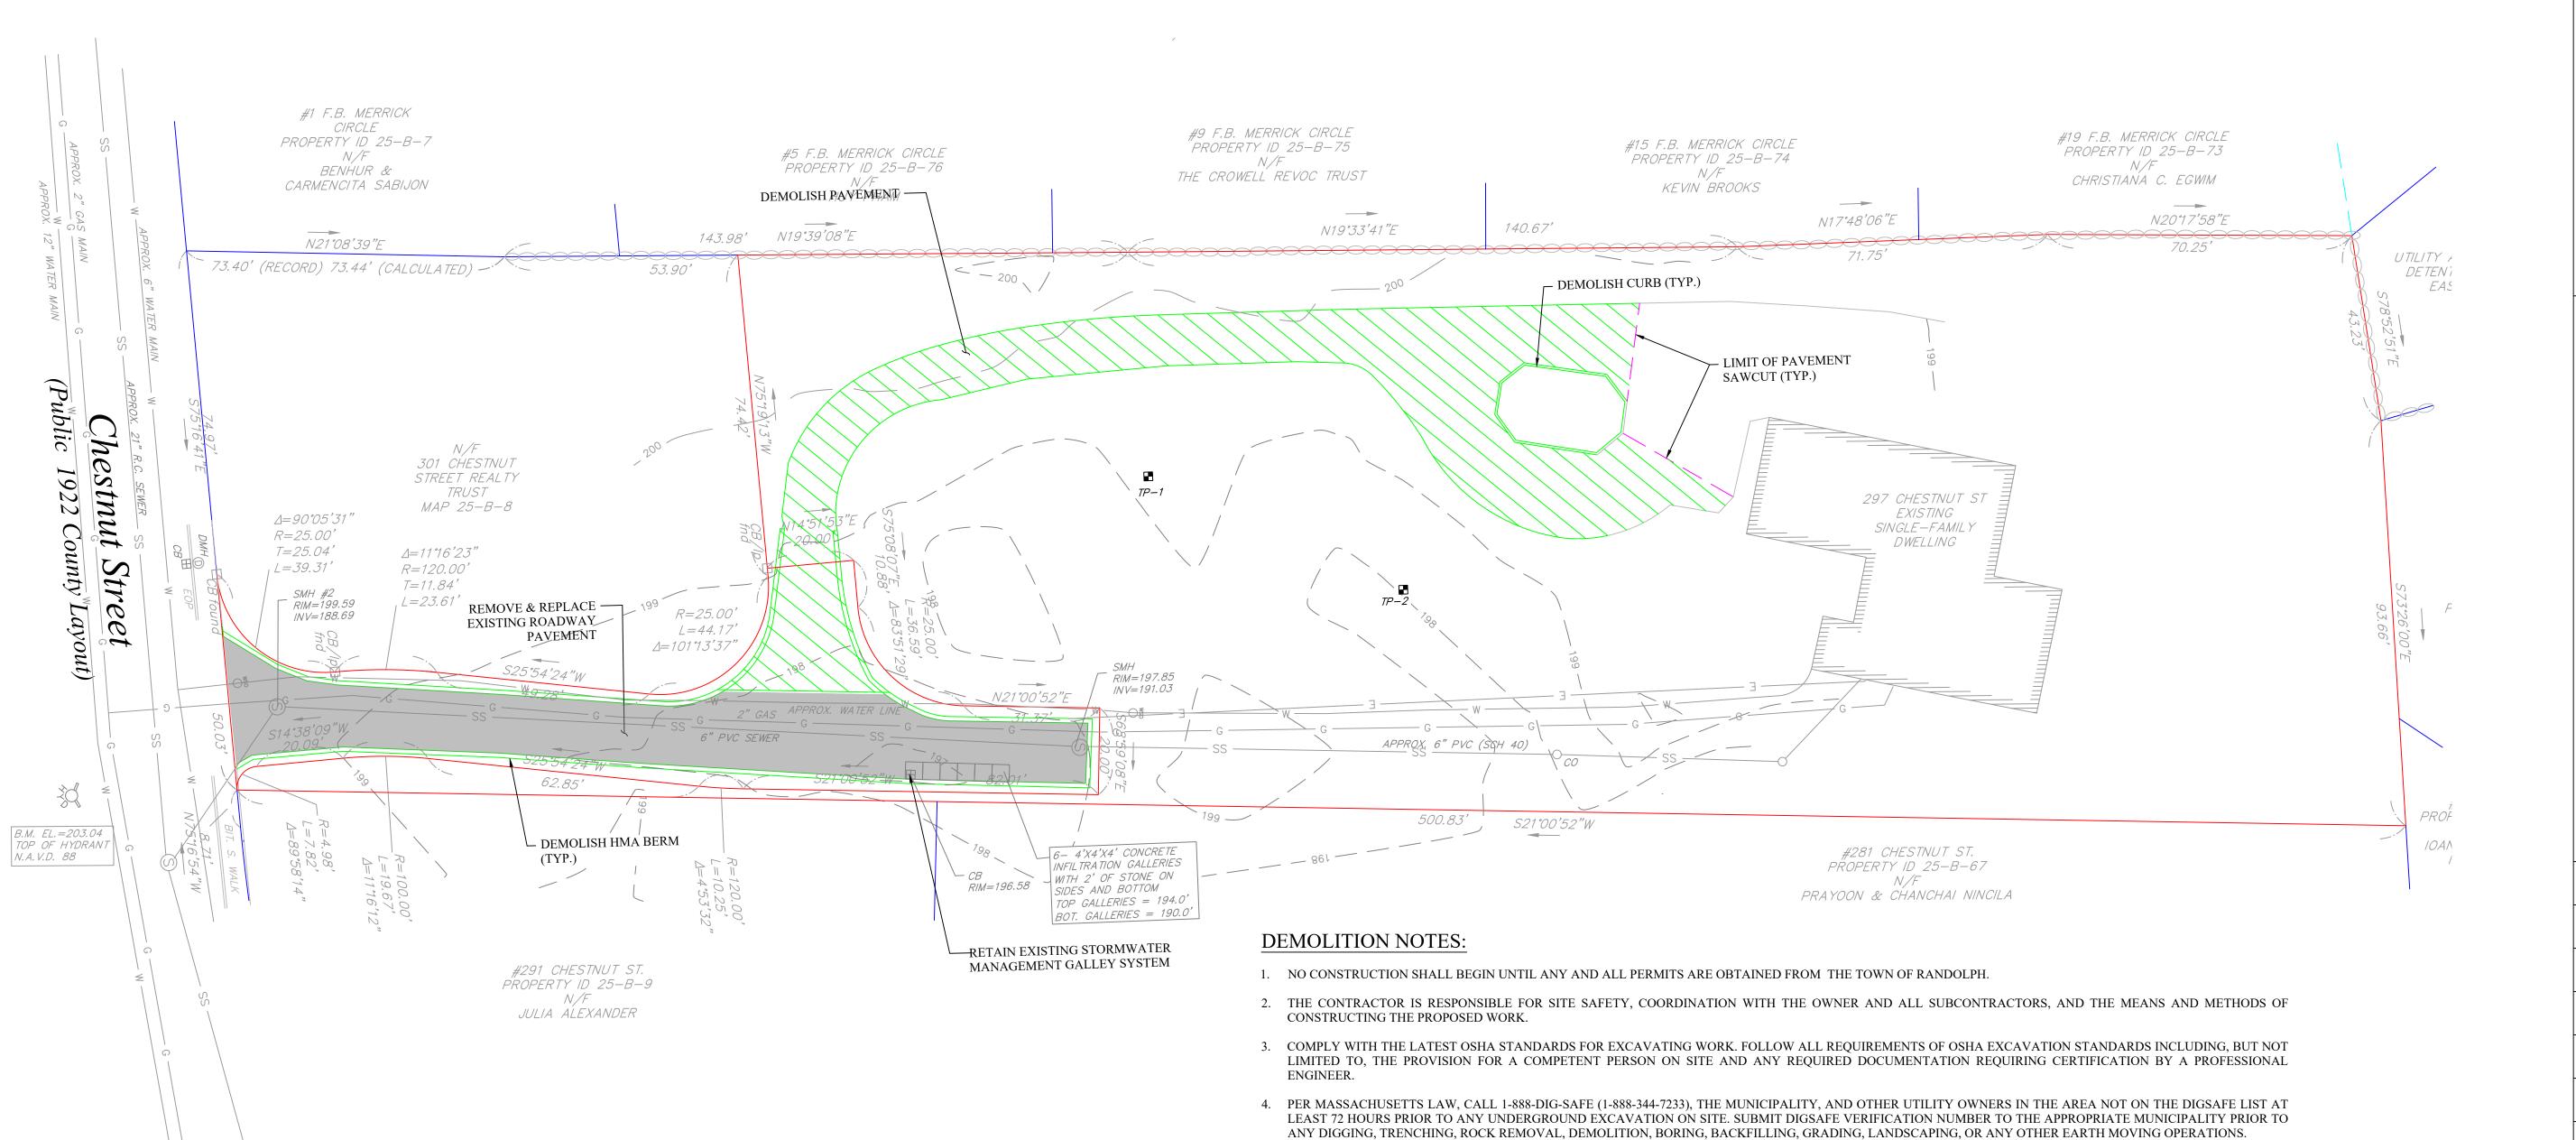
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Prepared By:



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5. LOCATIONS OF EXISTING UTILITIES ARE APPROXIMATE. IN ADDITION, SOME UTILITIES MAY NOT BE SHOWN. DETERMINE THE EXACT LOCATION OF UTILITIES BY TEST PIT OR OTHER METHODS, AS NECESSARY TO PREVENT DAMAGE TO UTILITIES AND/OR INTERRUPTIONS IN UTILITY SERVICE. PERFORM TEST PIT

7. NOTIFY THE ENGINEER OF ANY UTILITIES IDENTIFIED DURING CONSTRUCTION THAT ARE NOT SHOWN ON THE DRAWINGS OR THAT DIFFER IN SIZE OR MATERIAL.

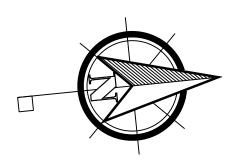8. FIELD VERIFY ALL EXISTING CONDITIONS PRIOR TO CONSTRUCTION. IF FIELD CONDITIONS ARE OBSERVED THAT VARY SIGNIFICANTLY FROM THOSE SHOWN ON

THESE PLANS, IMMEDIATELY NOTIFY THE ENGINEER IN WRITING FOR RESOLUTION OF THE CONFLICTING INFORMATION.

9. REFER TO LOCAL UTILITY COMPANIES FOR LOCATION, CONSTRUCTION DETAILS, AND SPECIFICATIONS.

6. TEST PITS TO LOCATE EXISTING UTILITIES MAY BE ORDERED BY THE ENGINEER.

EXCAVATIONS AND OTHER INVESTIGATIONS TO LOCATE UTILITIES, AND PROVIDE THIS INFORMATION TO THE ENGINEER, PRIOR TO CONSTRUCTING THE PROPOSED IMPROVEMENTS. THE ENGINEER WILL USE THE TEST PIT INFORMATION AND OTHER INFORMATION COLLECTED BY THE CONTRACTOR ON THE LOCATION OF EXISTING UTILITIES TO DIRECT THE CONTRACTOR IN THE EVENT THAT THERE IS A CONFLICT BETWEEN AN EXISTING UTILITY AND THE PROPOSED



Prepared For:

MICHAEL PERRY 297 CHESTNUT ST RANDOLPH MA 02368

· .	Rev. Date	Description
e:	12/20/2021	

SCALE: 1" = 20'

Drawn by: JLV

Approved by: GM

**EXISTING CONDITIONS AND DEMOLITION PLAN** 

AS NOTED SCALE:

SHEET 3 OF 6

