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RIDGEWAY COMMUNITY PARK VILLAGE OF RIDGEWAY RIDGEWAY, WISCONSIN PROJECT NUMBER 22.055



PARKITECTURE
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+ Parkitecture

COMMUNITY PARK IMPROVEMENTS
HUGHETTE ROAD
RIDGEWAY, WI 53582

Project #: 22.055 Issued For: REVIEW Date: 09/11/2023

T100

File: V:\22.055 Ridgeway Park\CAD\P-T.






















COMMUNITY PARK IMPROVEMENTS HUGHETTE ROAD RIDGEWAY, WI 53582


**EXISTING CONDITIONS PHOTOS** 

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Project #: Issued For: Date: Sheet Number C002

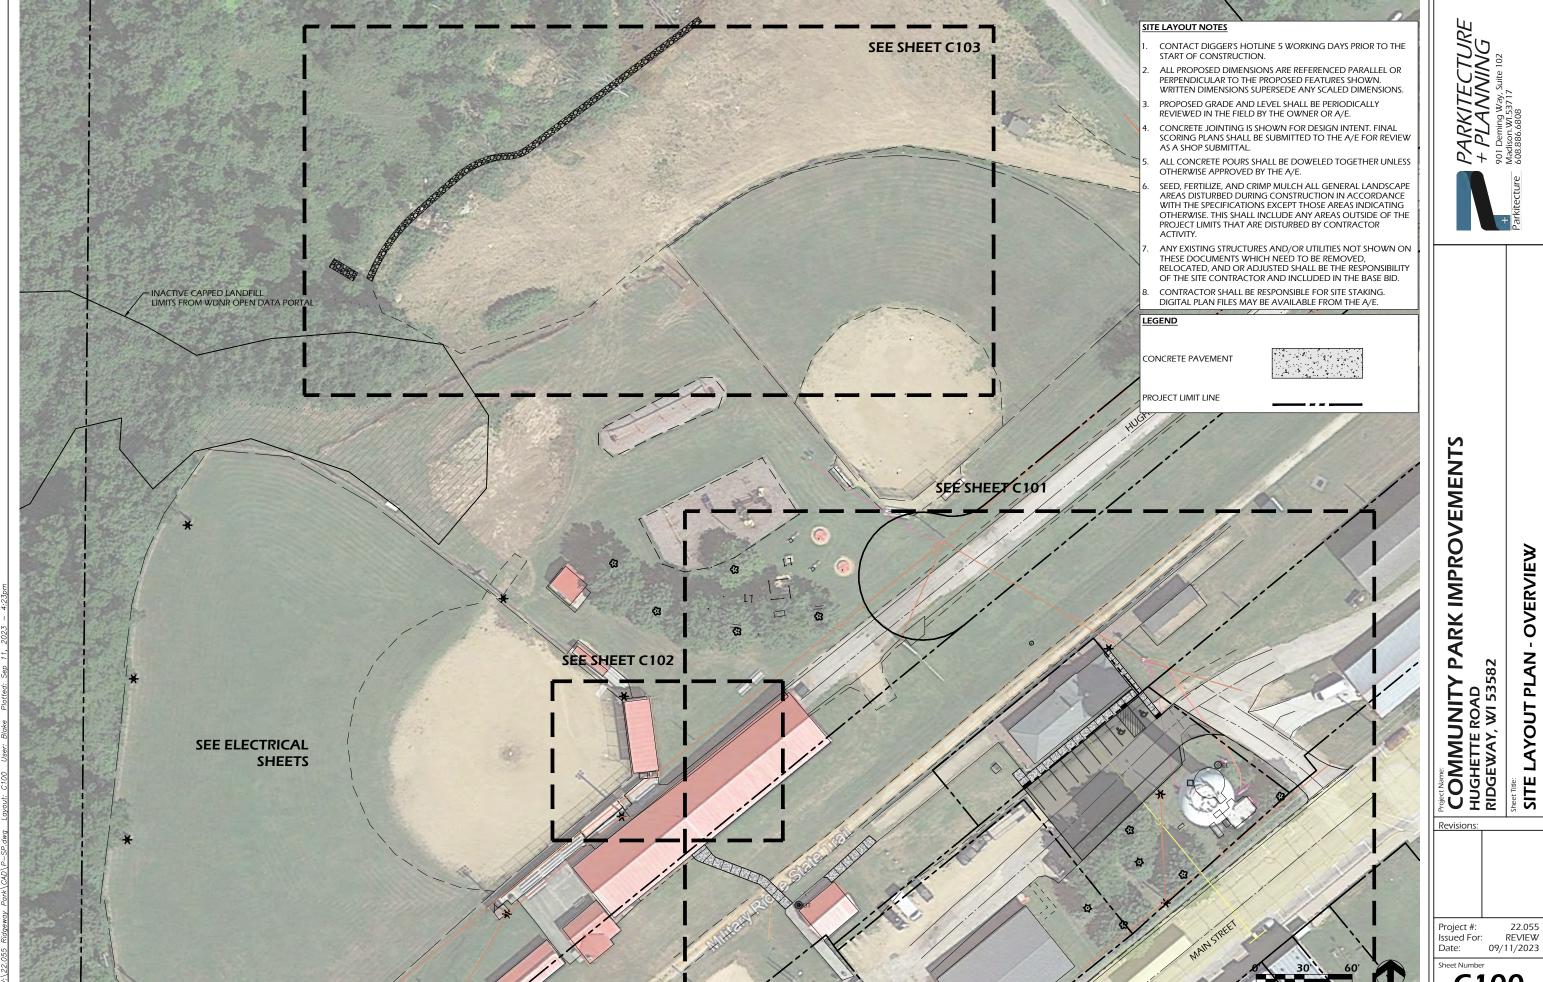

C100



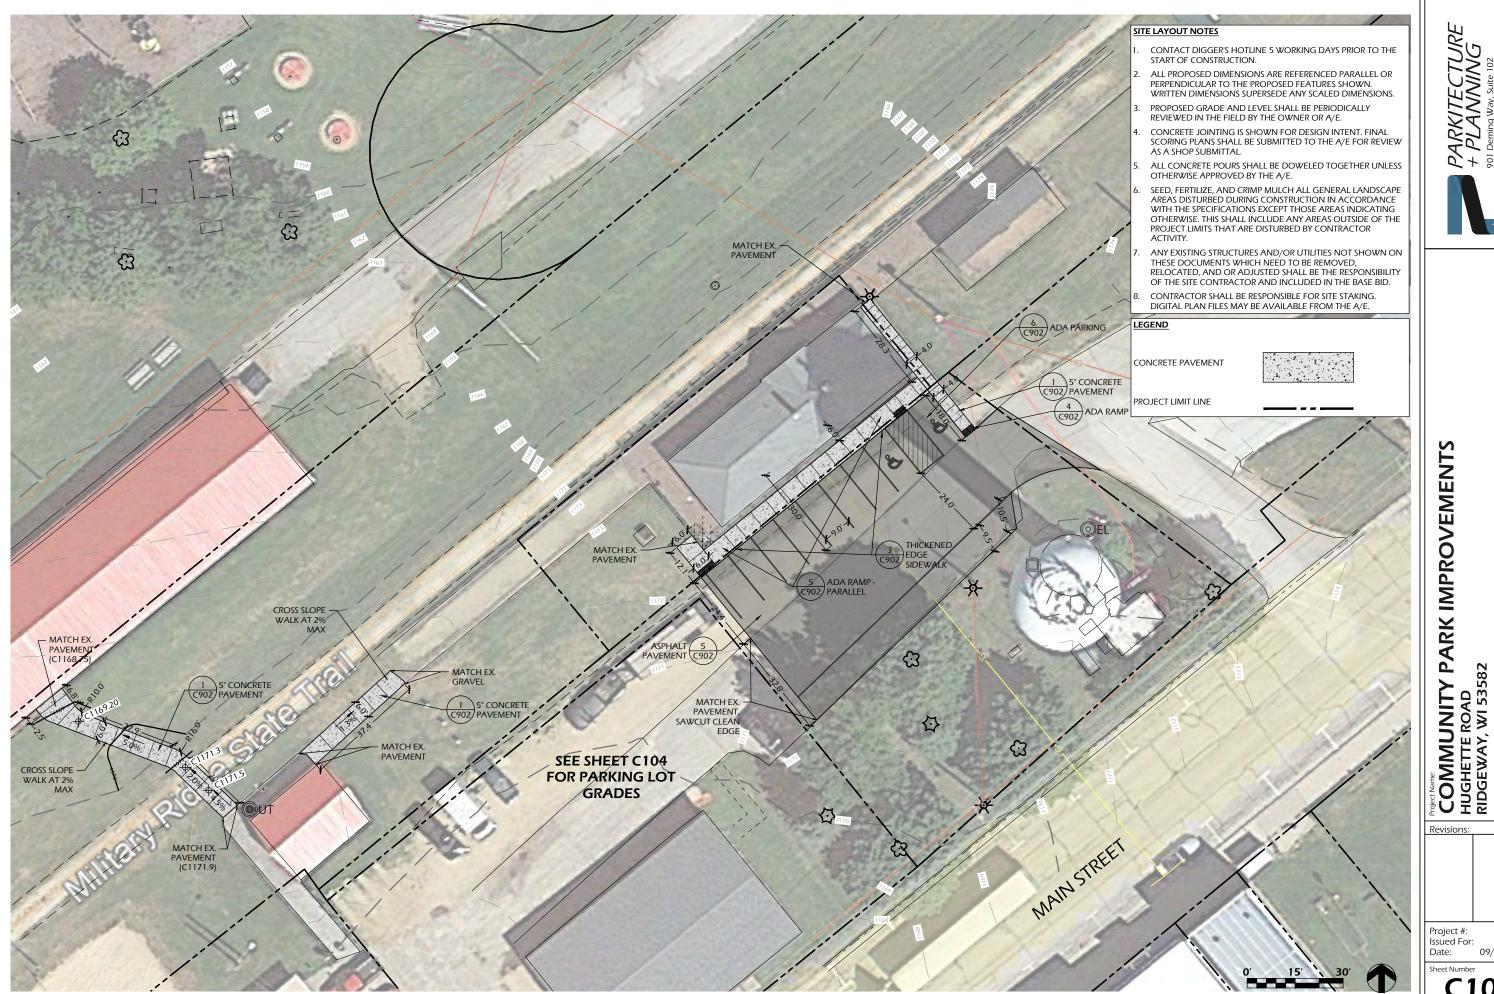

- DEPOT AREA

SITE LAYOUT PLAN

22.055 REVIEW 09/11/2023

Sheet Number

#### SITE LAYOUT NOTES

- CONTACT DIGGER'S HOTLINE 5 WORKING DAYS PRIOR TO THE START OF CONSTRUCTION.
- ALL PROPOSED DIMENSIONS ARE REFERENCED PARALLEL OR PERPENDICULAR TO THE PROPOSED FEATURES SHOWN. WRITTEN DIMENSIONS SUPERSEDE ANY SCALED DIMENSIONS.
- PROPOSED GRADE AND LEVEL SHALL BE PERIODICALLY REVIEWED IN THE FIELD BY THE OWNER OR A/E.
- CONCRETE JOINTING IS SHOWN FOR DESIGN INTENT. FINAL SCORING PLANS SHALL BE SUBMITTED TO THE A/E FOR REVIEW AS A SHOP SUBMITTAL.
- ALL CONCRETE POURS SHALL BE DOWELED TOGETHER UNLESS OTHERWISE APPROVED BY THE A/E.
- SEED, FERTILIZE, AND CRIMP MULCH ALL GENERAL LANDSCAPE AREAS DISTURBED DURING CONSTRUCTION IN ACCORDANCE WITH THE SPECIFICATIONS EXCEPT THOSE AREAS INDICATING OTHERWISE. THIS SHALL INCLUDE ANY AREAS OUTSIDE OF THE PROJECT LIMITS THAT ARE DISTURBED BY CONTRACTOR
- ANY EXISTING STRUCTURES AND/OR UTILITIES NOT SHOWN ON THESE DOCUMENTS WHICH NEED TO BE REMOVED, RELOCATED, AND OR ADJUSTED SHALL BE THE RESPONSIBILITY OF THE SITE CONTRACTOR AND INCLUDED IN THE BASE BID.
- CONTRACTOR SHALL BE RESPONSIBLE FOR SITE STAKING. DIGITAL PLAN FILES MAY BE AVAILABLE FROM THE A/E.

### LEGEND

CONCRETE PAVEMENT



PROJECT LIMIT LINE



### **IMAGE 1**



**IMAGE 2** 







COMMUNITY PARK IMPROVEMENTS HUGHETTE ROAD RIDGEWAY, WI 53582

- DIAMOND DRAINAGE AREA SITE LAYOUT PLAN

22.055 : REVIEW 09/11/2023 Project #: Issued For: Date:

Sheet Number C102

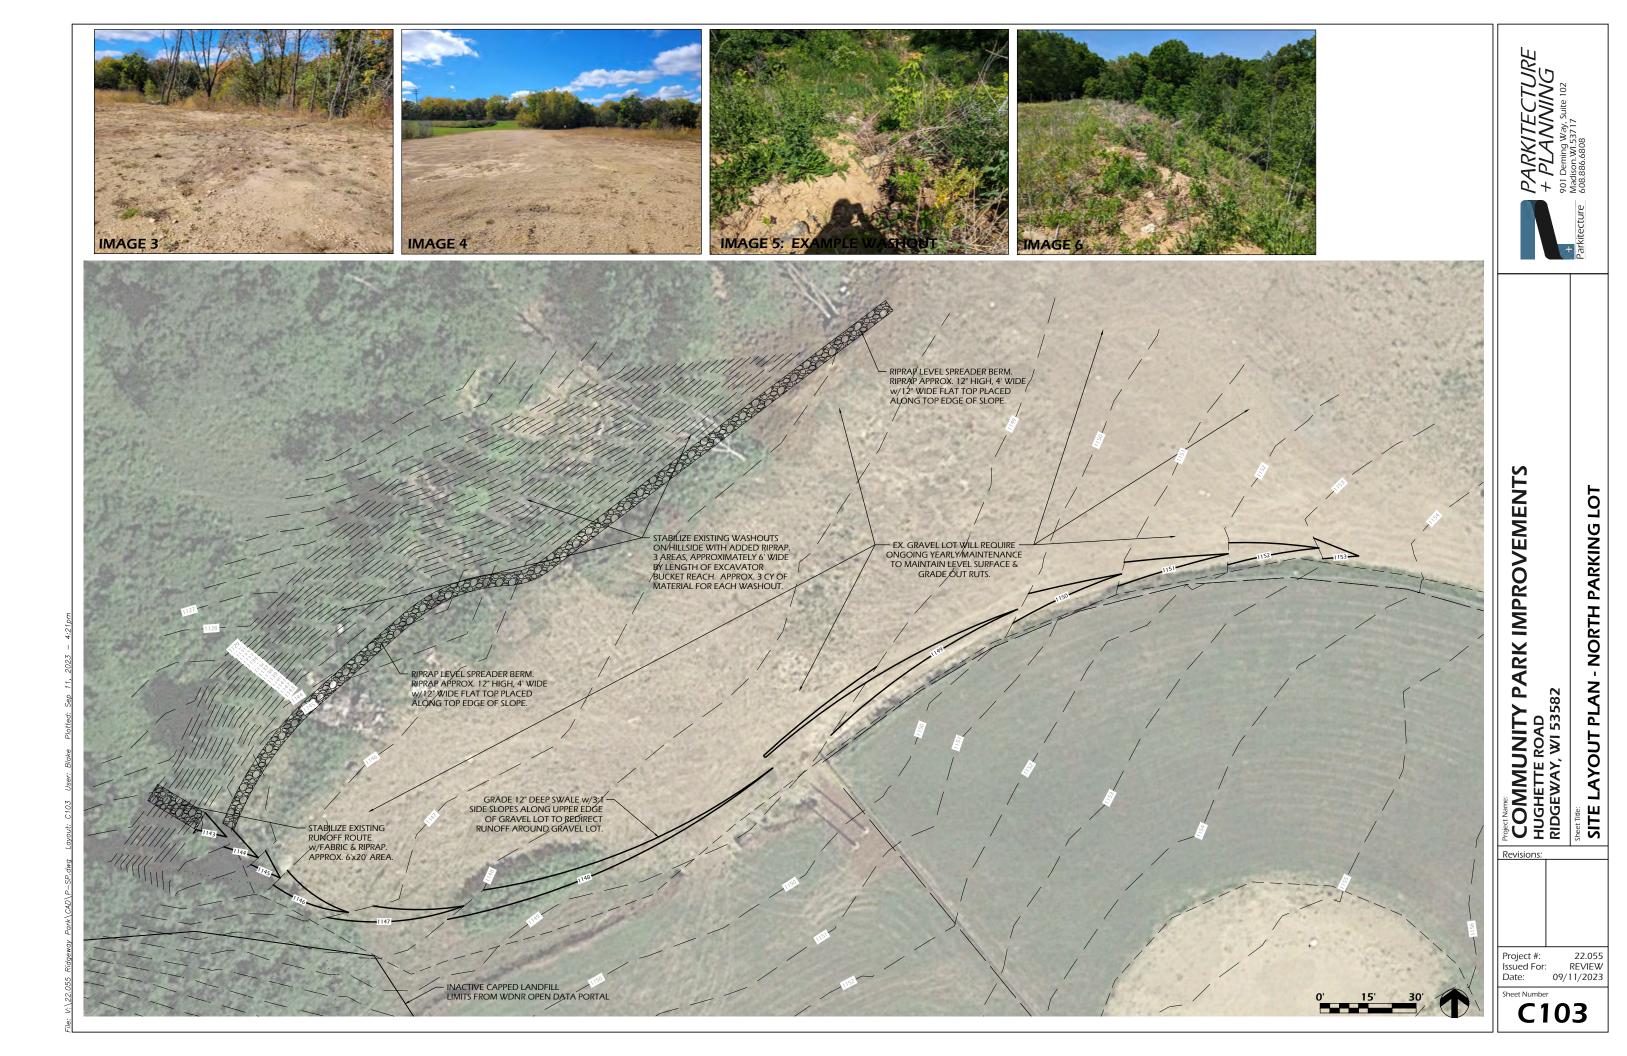

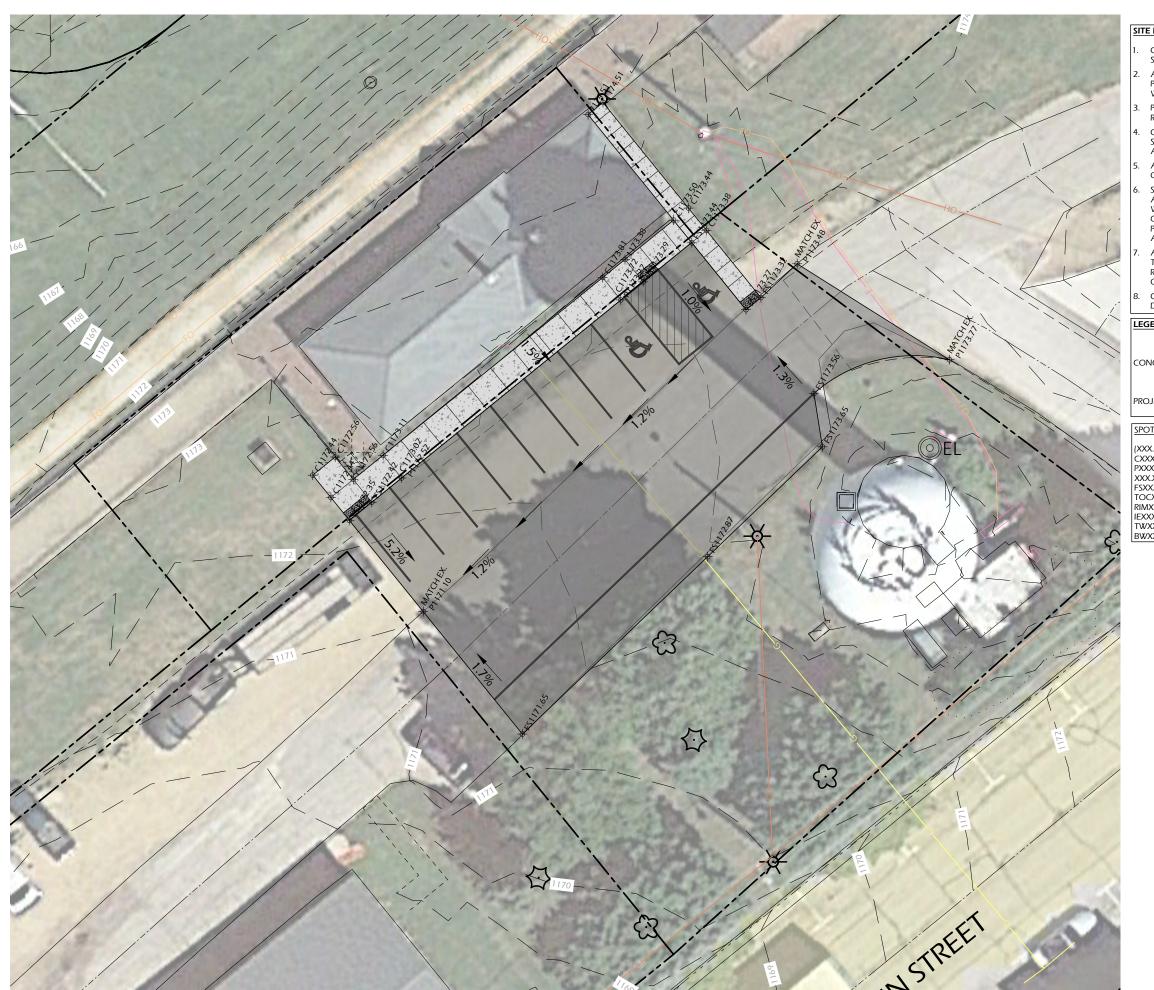

#### SITE LAYOUT NOTES

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- CONTRACTOR SHALL BE RESPONSIBLE FOR SITE STAKING. DIGITAL PLAN FILES MAY BE AVAILABLE FROM THE A/E.

#### LEGEND

CONCRETE PAVEMENT



PROJECT LIMIT LINE

#### SPOT GRADE ABBREVIATIONS:

= EXISTING GRADE = PROPOSED CONCRETE = PROPOSED PAVEMENT (XXX.XX) CXXX.XX

= PROPOSED FINISH SURFACE FSXXX.XX = PROPOSED FINISH SURFACE TOCXXX.XX = PROPOSED TOP OF CURB

RIMXXX.XX = RIM

TWXXXXX = INVERT ELEVATION
TWXXXXX = TOP OF WALL ELEVATION
BWXXXXX = BOTTOM OF WALL ELEVATION





COMMUNITY PARK IMPROVEMENTS HUGHETTE ROAD RIDGEWAY, WI 53582

- DEPOT AREA


SITE GRADING PLAN


22.055 : REVIEW 09/11/2023 Project #: Issued For: Date:

Sheet Number


C104


### JOINING TWO LENGTHS OF SILT FENCE (TWIST METHOD)

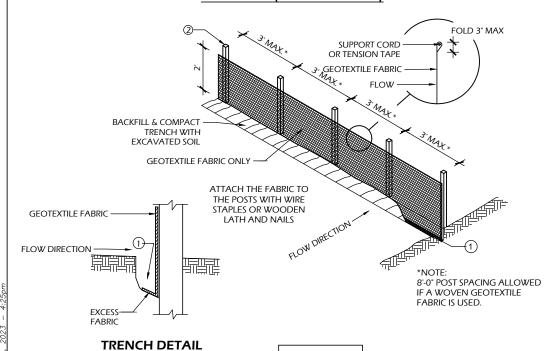

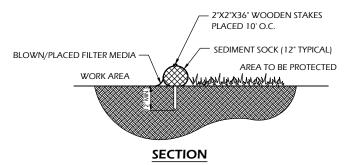



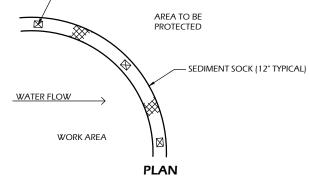

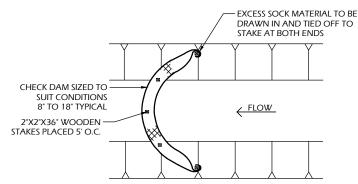

SEDIMENT SOCK NOTES:

1. ALL MATERIAL TO MEET SPECIFICATIONS.

- SEDIMENT SHOULD BE REMOVED FROM BEHIND CHECK DAM ONCE THE ACCUMULATED HEIGHT HAS REACHED 1/2 THE HEIGHT OF THE CHECK DAM.
- CHECK DAM CAN BE DIRECT SEEDED AT THE TIME OF INSTALLATION. FILTER MEDIA FILL TO MEET APPLICATION REQUIREMENTS.
- COMPOST MATERIAL TO BE DISPERSED ON SITE. AS DETERMINED BY ENGINEER.

### SEDIMENT SOCK


#### SILT FENCE GENERAL NOTES

FOR MANUAL INSTALLATIONS THE TRENCH SHALL BE A MINIMUM OF 4" WIDE & 6" DEEP TO BURY AND ANCHOR THE GEOTEXTILE FABRIC. FOLD MATERIAL TO FIT TRENCH AND BACKFILL & COMPACT TRENCH WITH EXCAVATED SOIL.


**SILT FENCE** 

- 2. WOOD POSTS SHALL BE A MINIMUM SIZE OF 3' LENGTH OF OAK OR HICKORY
- 3. ADDITIONAL POST DEPTH OR TIE BACKS MAY BE REQUIRED IN UNSTABLE SOILS
- DETAILS OF CONSTRUCTION NOT SHOWN ON THIS DRAWING SHALL CONFORM TO THE PERTINENT REQUIREMENTS OF THE SPECIFICATIONS
- 5. 8" OF FENCE FABRIC REQUIRED BELOW GRADE IN TRENCH PER DNR TECH STD. 1056
- MANUFACTURED ALTERNATIVES APPROVED AND LISTED ON THE WISDOT PRODUCT ACCEPTABILITY LIST (PAL) MAY BE SUBSTITUTED.
- FINISHED SIZE, INCLUDING FLAP POCKETS WHERE REQUIRED, SHALL EXTEND A MINIMUM OF 10" AROUND THE PERIMETER TO FACILITATE MAINTENANCE OR REMOVAL
- 8. FLAP POCKETS SHALL BE LARGE ENOUGH TO ACCEPT WOOD 2"X4"


- 9. EROSION CONTROL SHALL BE PROVIDED IN ACCORDANCE WITH WDNR TECHNICAL STANDARD AND TECHNICAL SPECIFICATIONS.
- 10. CROSS BRACE WITH 2" X 4" WOODEN FRAME OR EQUIVALENT AT TOP OF POSTS AS DIRECTED
- 11. MINIMUM 14 GAUGE WIRE REQUIRED, FOLD FABRIC 3" OVER THE WIRE AND STAPLE OR PLACE WIRE RINGS ON 12" C.C.
- 12. WIRE SUPPORT FENCE SHALL BE 14 GAUGE MINIMUM WOVEN WIRE WITH A MAXIMUM MESH SPACING OF 6". SECURE TOP OF GEOTEXTILE FABRIC TO TOP OF FENCE WITH STAPLES OR
- 13. GEOTEXTILE FABRIC SHALL BE REINFORCED WITH AN INDUSTRIAL POLYPROPYLENE NETTING WITH A MAXIMUM MESH SPACING OF 3/4" OR EQUAL. A HEAVY DUTY NYLON TOP SUPPORT CORD OR EQUIVALENT IS REQUIRED. (TYPE A)
- 14. STEEL POSTS SHALL BE STUDDED "TEE" OR "U" TYPE WITH A MINIMUM WEIGHT OF 1.28 LBS./LIN. FT. (WITHOUT ANCHOR) FIN ANCHORS SUFFICIENT TO RESIST POST MOVEMENT ARE REQUIRED. WOOD POSTS SHALL BE A MINIMUM SIZE OF 1 1/8" X 1 1/8" OF OAK OR HICKORY.
- 15. CONSTRUCT SILT FENCE FROM A CONTINUOUS ROLL, IF POSSIBLE, BY CUTTING LENGTHS TO AVOID JOINTS. IF A JOINT IS NECESSARY, USE ONE OF THE FOLLOWING TWO METHODS: A.J TWIST METHOD OVERLAP THE END POSTS AND TWIST, OR ROTATE, AT LEAST 180 DEGREES, B:) HOOK METHOD - HOOK THE END OF EACH SILT FENCE LENGTH.

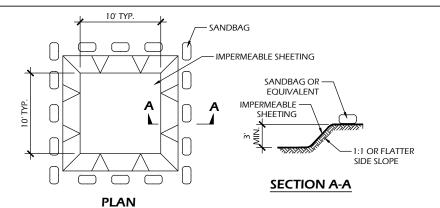

## **EXCAVATED WASHOUT STRUCTURE**

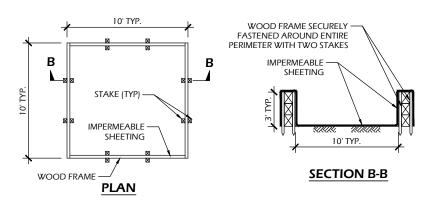

### WASHOUT STRUCTURE WITH WOOD PLANKS

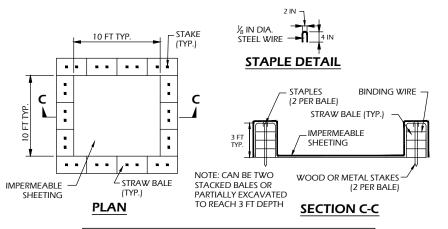

### **WASHOUT STRUCTURE WITH STRAW BALES**

### **CONSTRUCTION SPECIFICATIONS**

- TEMPORARY CONCRETE WASHOUT STRUCTURE SHALL BE USED TO WASH DOWN CONCRETE TRUCK CHUTES AND OTHER EQUIPMENT AFTER USE TO PREVENT WASHDOWN WATER FROM POLLUTING THE SITE.
- 2. LOCATE WASHOUT STRUCTURE A MINIMUM OF 50 FEET AWAY FROM OPEN CHANNELS, STORM DRAIN INLETS, SENSITIVE AREAS, WETLANDS, BUFFERS AND WATER COURSES AND AWAY FROM CONSTRUCTION
- 3. SIZE WASHOUT STRUCTURE FOR VOLUME NECESSARY TO CONTAIN WASH WATER AND SOLIDS AND MAINTAIN AT LEAST 4 INCHES OF FREEBOARD. TYPICAL DIMENSIONS ARE 10 FEET X 10 FEET X 3 FEET DEEP.
- 4. PREPARE SOIL BASE FREE OF ROCKS OR OTHER DEBRIS THAT MAY CAUSE TEARS OR HOLES IN THE LINER. FOR LINER, USE 10 MIL OR THICKER UV RESISTANT, IMPERMEABLE SHEETING, FREE OF HOLES AND TEARS OR OTHER DEFECTS THAT COMPROMISE IMPERMEABILITY OF THE MATERIAL.
- 5. PROVIDE A SIGN FOR THE WASHOUT IN CLOSE PROXIMITY TO THE FACILITY
- KEEP CONCRETE WASHOUT STRUCTURE WATER TIGHT. REPLACE IMPERMEABLE LINER IF DAMAGED (E.G., RIPPED OR PUNCTURED). EMPTY OR REPLACE WASHOUT STRUCTURE THAT IS 75 PERCENT FULL, AND DISPOSE OF ACCUMULATED MATERIAL PROPERLY. DO NOT REUSE PLASTIC LINER. WET-VACUUM STORED LIQUIDS THAT HAVE NOT EVAPORATED AND DISPOSE OF IN AN APPROVED MANNER. PRIOR TO FORECASTED RAINSTORMS, REMOVE LIQUIDS OR COVER STRUCTURE TO PREVENT OVERFLOWS. REMOVE HARDENED SOLIDS, WHOLE OR BROKEN UP, FOR DISPOSAL OR RECYCLING. MAINTAIN RUNOFF DIVERSION AROUND EXCAVATED WASHOUT STRUCTURE UNTIL STRUCTURE IS REMOVED.



**CONCRETE WASHOUT STRUCTURE (TEMP)** 


PARK IMPROVEMENT OMMUNITY


DETAIL CONSTRUCTION ₹ 8 HUGHETTE R RIDGEWAY, V

Issued For: REVIEW 09/11/2023

Sheet Numbe **C900** 

Date:

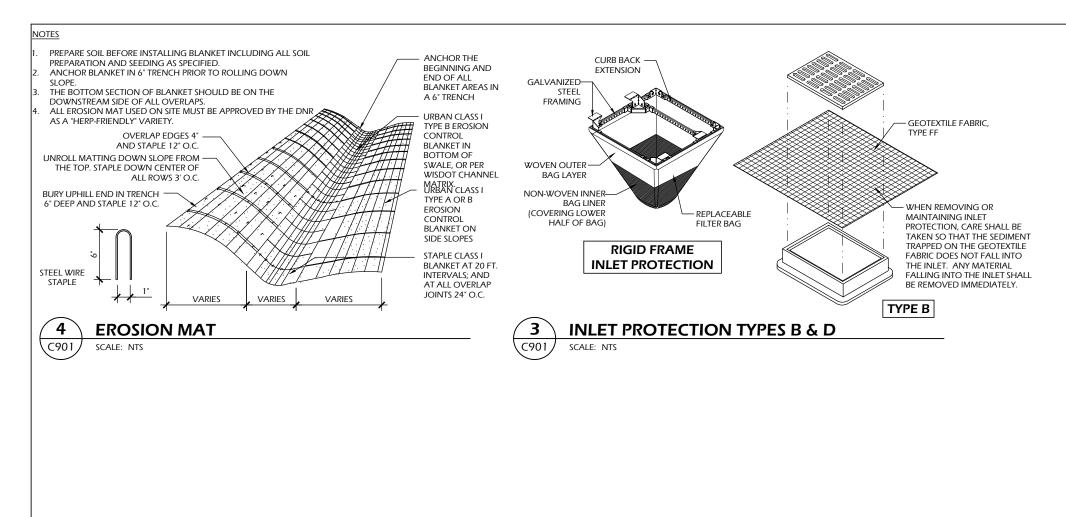


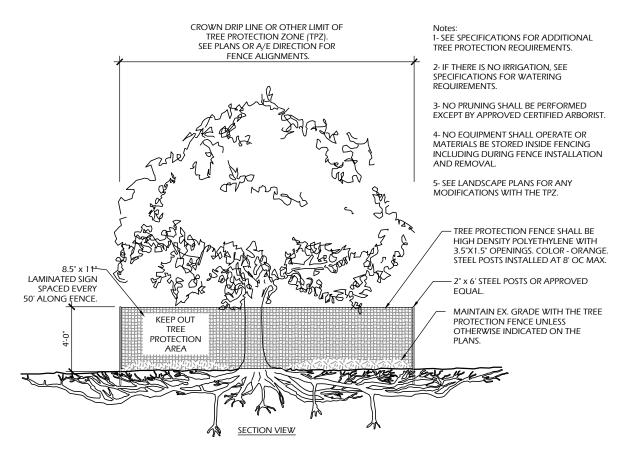

TREE PROTECTION

C901

SCALE: NTS

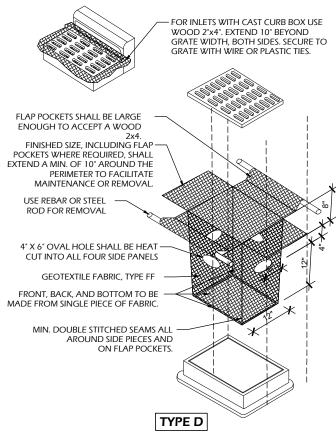

### **INLET PROTECTION NOTES:**

- 1. INSTALL PER WDNR STORM WATER CONSTRUCTION TECHNICAL STANDARD 1060.
- 2. INLET PROTECTION TYPE B SHALL BE USED ON STRUCTURES 30" OR LESS IN DEPTH.
- 3. RIGID FRAME OR TYPE D INLET PROTECTION MAY BE USED AT THE DISCRETION OF THE CONTRACTOR UNLESS OTHERWISE NOTED.
- 4. ROUTINELY INSPECT FOR INTEGRITY AND NEEDED MAINTENANCE.
- 5. EMPTY SEDIMENT WHEN THE BAG IS HALF FULL OR SEDIMENT IS WITHIN 6 INCHES OF THE OVERFLOW HOLES, OR AS DIRECTED BY THE OWNER OR A/E.
- 6. IMMEDIATELY REMOVE ANY SEDIMENT FALLING INTO THE INLET DURING MAINTENANCE ACTIVITIES.
- 7. INLET PROTECTION SHALL BE REMOVED AFTER THE SITE HAS ACHIEVED 80% STABILIZATION OR AT THE END OF THE PROJECT.

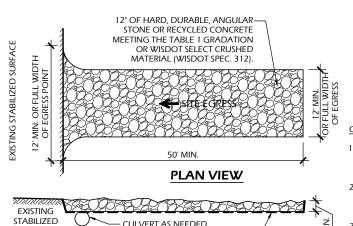


TABLE T				
AGGREGATE GRADATION				
SIEVE	PERCENT PASSING			
SIZE	BY WEIGHT			
3"	100			
2 1/2"	90 - 100			
1 1/2"	25 - 60			
3/4"	0 - 20			
3/8"	0 - 5	ı		

#### OPERATION & MAINTENANCE:

- I. MONITOR TRACKING PADS FOR COMPACTION, SOIL DEPOSITS, AND MIXING OF UNDERLYING SOILS AND STONE LAYERS.
- 2. MAINTAIN A LOOSENED, ROUGH SURFACE BY SCRAPING, LOOSENING, OR TOP-DRESSING WITH ADDITIONAL AGGREGATE.
- 3. REPLACE GEOTEXTILE AND STONE IF LESS-INTENSIVE MAINTENANCE EFFORTS FAIL TO REESTABLISH EFFECTIVENESS.
- 4. ADD STONE AS NEEDED TO MAINTAIN THE MINIMUM PAD THICKNESS.
- 5. REPLACE DAMAGED OR CRUSHED CULVERTS UNDER TRACKING PAD.

STONE TRACKING PAD C901 SCALE: NTS

**PROFILE VIEW** 

— CULVERT AS NEEDED

GEOTEXTILE FABRIC LINER (AS NEEDED) SELECT FABRIC TYPE BASED ON SOIL

CONDITIONS & VEHICLE LOADING

SURFACE

22.055 Issued For: REVIEW 09/11/2023 Date:

PARK IMPROVEMENT


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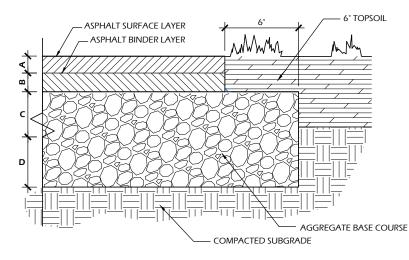
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**DETAIL!** 

CONSTRUCTION

Sheet Number C901



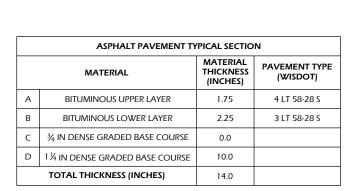

## **ASPHALT PAVEMENT - PARKING LOT**

SCALE: NTS

C902

SCALE: NTS

C902 USE ONLY DURASLOPE CLASS "A" & "B" GRATES WITH THIS APPLICATION. MIN. SAW CUT SECTION AT DURASLOPE CHANNEL NEW CONCRETE **NEW CONCRETE** SLAB SLAB ... EXISTING SOIL NDS PRO DURA SLOPE TRENCH DRAIN OR EQUAL #3 or #4 rebar stake suspension 🔟 PART #DS-095 w/(2) DS-224 END CAPS FLOW RATE = 131 GPM METHOD. LENGTH OF STAKE WILL SECTION VARY WITH SLOPE OF DRAIN. 4" BOTTOM OUTLET

CHANNELS TO BE INSTALLED WITH BLANK GRATE. GRATE TO BE PROTECTED FROM CONCRETE POUR (COVER HOLES WITH TAPE). . INSTALLATION TO BE COMPLETED IN ACCORDANCE WITH MANUFACTURER'S SPECIFICATIONS. TRENCH DRAIN

C902

C902

SCALE: NTS

## **ADA RAMP**

SCALE: NTS

ADA PARKING SIGN STEEL & POST CENTER ON POST PARKING STALL **B**ÉACKETS PER SIGN 3" WIDE PAINTED PARKING STALL LINES GÁLVANIZED BOLTS PER **BRACKET** PAINTED SYMBOL 3" WIDE 2 3/8" O.D. ROUND STEEL POST, 13 GAUGE, 11'-3" LONG, HOT DIPPED GALVANIZED ZINC WITH TOP CAP DRIVE AISLE -ADA PARKING - COLOR AS SHOWN ON PLANS

6" CONCRETE SIDEWALK 1" TOOLED -PIP OR EWF RADIUSED EDGE W/LIGHT BROOM FINISH 2 - #4 CONTINUOUS REBARS 6" COMPACTED SAND OR BASECOURSE STONE DRAINAGE LAYER **GENERAL NOTES** PROVIDE 1/4" PER FOOT CROSS SLOPE ACROSS WALK MESH REOURED PROVIDE TOOLED JOINTS @ +/- 5'-0" O.C. U.N.O.


THICKENED EDGE SIDEWALK C902 SCALE: NTS

SIDEWALK AREA NON-WALK SURFACE DETECTABLE WARNING PLATES SHALL BE NATURAL PATINA, CAST IN PLACE TILES, ARMOR TILE, CAST INTACT, NEENAH DETECTABLE WARNING FIELDS OR APPROVED EQUAL DETECTABLE WARNING SURFACE LANDING WIDTH 5'-0" MINIMUM 1) 7.0% (14:1) MAX RAMP SLOPE (2) CROSS SLOPE: 1.50% TYP, 2.00% MAX. - SIDEWALK WIDTH 3 CURB RAMPS REQUIRE A 4 FOOT MINIMUM LANDING WITH A MAXIMUM CROSS SLOPE AND LONGITUDINAL SLOPE OF 2.00% WHERE PEDESTRIANS PERFORM TURNING MANEUVERS. 5'-0" MIN. CURB AND GUTTER OR THICKENED SLOPE TO DRAIN TO CURB. **EDGE WALK** 


**ADA RAMP - PARALLEL** C902

SCALE: NTS

**NOT USED** C902 SCALE: NTS

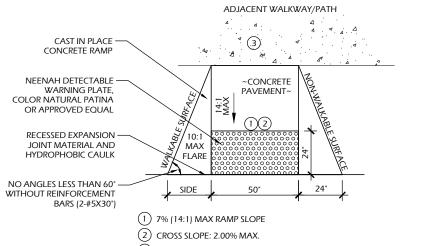

(3) CURB RAMPS REQUIRE A 4 FOOT MINIMUM LANDING WITH A MAXIMUM CROSS SLOPE AND LONGITUDINAL SLOPE OF 2.00% WHERE PEDESTRIANS PERFORM TURNING MANEUVERS. SLOPE TO DRAIN TO CURB.

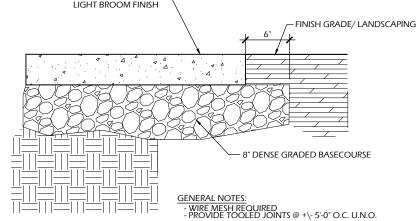

**CONCRETE PAVEMENT** C902 SCALE: NTS

5" CONCRETE SIDEWALK WITH


OMMUNITY PARK IMPROVEMENT Revisions


22.055 Project #: REVIEW Issued For: 09/11/2023 Date:

CONSTRUCTION DETAILS

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Sheet Number **C902** 



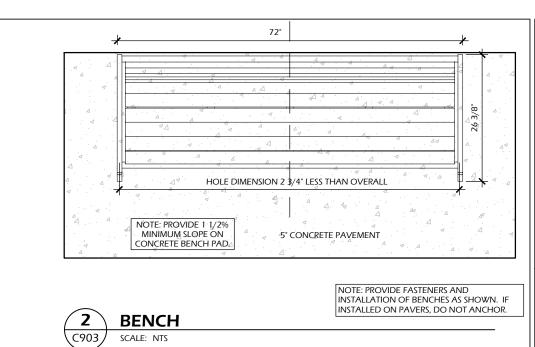

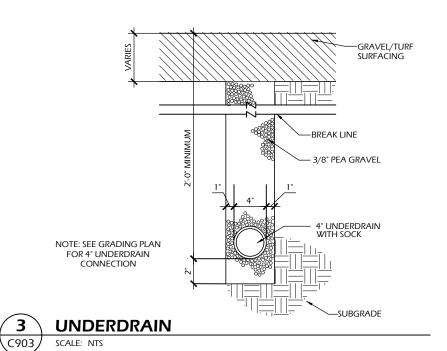C903 SCALE: NTS

**NOT USED** 

Sheet Number C903

22.055 REVIEW 09/11/2023

COMMUNITY PARK IMPROVEMENTS
HUGHETTE ROAD
RIDGEWAY, WI 53582 Project #: Issued For: Date:

CONSTRUCTION DETAILS

## **ELECTRICAL SYMBOLS, ABBREVIATIONS AND NOTES:**

- SYMBOLS INDICATED HERE AND NOT USED IN THE CONTRACT DOCUMENTS DO NOT APPLY TO THIS PROJECT. ADDITIONAL SYMBOLS MAY BE INDICATED IN
- THE CONTRACT DOCUMENTS.

  EXISTING TO REMAIN IS SHOWN WITH SOLID LIGHT LINES, NEW WORK IS SHOWN WITH SOLID HEAVY LINES.
- EXISTING TO REMAIN IS SHOWN WITH SOULD LIGHT LIES. NEW WORM IS SHOWN WITH SOULD HEAVT LINES.

  SEE PROJECT SPECIFICATIONS AND DRAWINGS FOR DEVICE/EQUIPMENT RATINGS.

  ALL MOUNTING HEIGHTS LISTED BELOW OR SHOWN ON DETAIL SHEETS ARE FOR STANDARD INSTALLATIONS. DEVIATIONS TO THE STANDARD MOUNTING HEIGHT MAY OCCUR AS REQUIRED BASED ON FIELD CONDITIONS. IN ALL INSTANCES COORDINATE WITH ARCHITECT AND ENGINEER.

  ALL DIMENSIONS ARE TO THE CENTER OF BOX.

  COORDINATE WORK SHOWN IN THIS DRAWING SET WITH ALL PROJECT DRAWINGS.

## **EQUIPMENT AND WIRING**

Т	TRANSFORMER	GEN	REMOTE GENERATOR ANNUNCIATOR
	GROUND CONNECTION	0	PUSH BUTTON
	GROUND BAR		
4	NON FUSED DISCONNECT SWITCH	EGS	ENGINE GENERATOR SET
4	FUSED DISCONNECT SWITCH		AUTOMATIC TRANSFER SWITCH
4	STARTER/DISCONNECT SWITCH	ATS	AUTUMATIC TRANSFER SWITCH
	CIRCUIT BREAKER DISCONNECT	6	MOTOR CONNECTION
MMS \$	MANUAL MOTOR STARTER W/OVERLOAD PROTECTION F = FLUSH MOUNT S = SURFACE MOUNT		BRANCH CIRCUIT PANEL DISTRIBUTION PANEL ROARD

# LIGHTING CONTROL DEVICES

©	LIGHTING CONTACTOR MOUNTING LOCATION: WALL MOUNTING HEIGHT: AS NOTED
\$ <sub>D</sub>	DIMMER MOUNTING LOCATION: WALL MOUNTING HEIGHT: 4'-0"
\$ <sub>P</sub>	PILOT LIGHT SWITCH MOUNTING LOCATION: WALL MOUNTING HEIGHT: 4'-0"

J JUNCTION BOX

- SINGLE POLE SWITCH MOUNTING LOCATION: WALL MOUNTING HEIGHT: 4'-0"
- TWO POLE SWITCH MOUNTING LOCATION: WALL MOUNTING HEIGHT: 4'-0"
- THREE WAY SWITCH MOUNTING LOCATION: WALL MOUNTING HEIGHT: 4'-0"
- FOUR WAY SWITCH MOUNTING LOCATION: WALL MOUNTING HEIGHT: 4'-0"
- OS CEILING MOUNTED OCCUPANCY SENSOR
- DS CEILING MOUNTED DAYLIGHT SENSOR

DISTRIBUTION PANELBOARD

MOUNTING LOCATION: WALL MOUNTING HEIGHT: 4'-0"

MOMENTARY CONTACT SWITCH MOUNTING LOCATION: WALL MOUNTING HEIGHT: 4'-0"

LOW VOLTAGE SWITCH MOUNTING LOCATION: WALL MOUNTING HEIGHT: 4'-0" a,b = SWITCH DESIGNATION(S)

MOUNTING LOCATION: WALL MOUNTING HEIGHT: 4'-0"

MOUNTING LOCATION: WALL MOUNTING HEIGHT: 4'-0" SINGLE POLE

WEATHERPROOF SWITCH

MOUNTING LOCATION: WAL MOUNTING HEIGHT: 4'-0"

OCCUPANCY SENSOR SWITCH MOUNTING LOCATION: WALL MOUNTING HEIGHT: 4'-0"

SECTION REFERENCE TOP DESIGNATES SECTION NUMBER BOTTOM DESIGNATES ON WHICH SHEET SECTION APPEARS

SINGLE POLE FIRE PLACE GAS SOLENOID SWITCH

REMOTE CONTROL FOR MOTORIZED DAMPER MOUNTING LOCATION: WALL MOUNTING HEIGHT: 4'-0"

SINGLE POLE FIRE PLACE CHIMNEY FAN PROVING SWITCH

JUNCTION BOX - WALL

## RECEPTACLES

DUPLEX RECEPTACLE MOUNTING LOCATION: WALL MOUNTING HEIGHT: 1'-6" DUPLEX RECEPTACLE

MOUNTING LOCATION: WALL +XX = MOUNTING HEIGHT (IN INCHES) DUPLEX RECEPTACLE WEATHERPROOF MOUNTING LOCATION: WALL MOUNTING HEIGHT: 1'-6"

SINGLE RECEPTACLE MOUNTING HEIGHT: 1'-6"

DOUBLE DUPLEX RECEPTACLE MOUNTING LOCATION: WALL MOUNTING HEIGHT: 1'-6"

DUPLEX RECEPTACLE - CEILING MOUNTED

FLOOR BOX (OR POKE THROUGH) MOUNTING LOCATION: FLOOR


DUPLEX RECEPTACLE, UPPER HALF SWITCHED, LOWER HALF HOT MOUNTING LOCATION: WALL

TV OUTLET WITH 120V DUPLEX RECEPTACLE IN COMMON 2 GANG BOX WITH LOW VOLTAGE BARRIER AND COMMON PLATE. TV BY OWNER.

NOUNTING LOCATION: WALL +XX = MOUNTING HEIGHT (IN INCHES)


## LIGHTING

D-	FIXTURE TYPE
EL1DPHB 15	CIRCUIT TAG
b <del>-</del>	SWITCH DESIGNATION

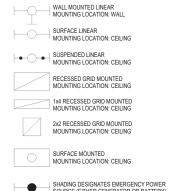





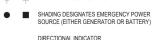

TO DESIGNATE AIMING DIRECTION EXIT DIRECTIONAL ARROW


SINGLE FACE EXIT FIXTURE MOUNTING LOCATION: CEILING


SINGLE FACE EXIT FIXTURE MOUNTING LOCATION: WALL MOUNTING LOCATION: WALL

DOUBLE FACE EXIT FIXTURE

DOUBLE HEAD EMERGENCY FIXTURE WITH BATTERY PACK

## SHEET SYMBOLS

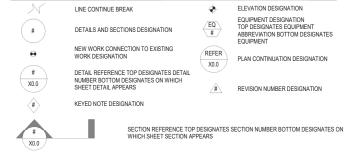

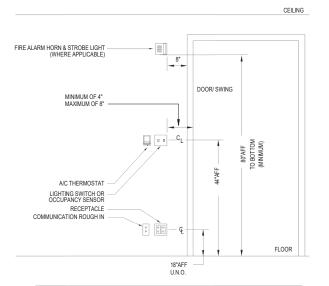

GENERAL NOTES:
1) ALL DEVICES SHALL BE ALLIGNED TO BE AN EQUAL DISTANCE FROM DOORWAY, DOOR SWING, WALL, ETC.

### **ABBREVIATIONS**

		ABBREVIATIONS		ABBRE		
t	Abbreviati		Abbreviati			
ŀ	on	Description	on	FIVELIDE		
ŀ		AMPRES ABOVE COUNTER TOP		AT FLOOR LINE		
t		ACOUSTICAL CEILING TILE		FLOOR(ING)		
İ		AMERICANS WITH DISABILITIES ACT		FULL LOAD AMPRES		
I		AMPERE FRAME		FLEXIBLE		
ŀ		ABOVE FINISHED FLOOR		FLOURESCENT		
ŀ		ABOVE FINISHED GRADE  AMP INTERRUPTING CAPACITY		FLOW SWITCH FUSED SAFETY SWI		
ł		ALTERNATIVE / ALTERNATE		FUSED SAFETT SWI		
İ		ALUMINUM	GA	GAUGE		
İ		ACCESS PANEL		GALVANIZED		
ļ		ARCHITECT / ARCHITECTURAL		GENERAL CONTRAC		
ŀ		ABOVE SUSPENDED CEILING AMPERE TRIP		GARBAGE DISPOSE GROUND FAULT CIF		
ŀ		AUTOMATIC		GROUND FAULT INT		
				GROUND FAULT PR		
		BYPASS AUTOMATIC TRANSFER SWITCH		GREASE INTERCEP		
ŀ		BARE COPPER		GROUND		
ŀ		BELOW FINISHED CEILING BELOW FINISHED FLOOR		GALLONS PER MINU GALVANIZED RIGID		
ł		BELOW FLOOR LEVEL		GROUND TERMINAL		
t		BUILDING				
İ		BLOCKING	HB	HOSE BIBB		
ļ		BOTTOM OF		HVAC CONTRACTO		
ŀ		BREAKER BATH TUB		HUB DRAIN HARDWARE		
L	DI	BAIRTOB		HANDHOLE		
Γ	СВ	CIRCUIT BREAKER		HAND OFF AUTOMA		
İ	CCT	CIRCUIT	-	HORSE POWER		
I		CEILING DIFFUSER		HEIGHT/HEAT TRAC		
ŀ		CONTRACTOR FURNISHED / OWNER INSTALLED		HIGH VOLTAGE		
ŀ		CONTRACTOR FURNISHED / CONTRACTOR INSTALLED CENTER LINE		HOT WATER SUPPL HOT WATER RECIR		
ł		CEILING		HOT WATER FIXTUR		
t		CLEAR(ANCE)		no manana		
İ	CMU	CONCRETE MASONRY UNIT	ID	INSIDE DIAMETER		
		CONDUIT		INVERT ELEVATION		
ŀ		CLEAN OUT		ISOLATED GROUND		
ŀ		CONCRETE CONTINUOUS / CONTINUE		INTERMEDIATE MEA		
ł		CONTRACTOR		INSULATION		
t		CONTROL RELAY		INTERIOR		
		CURRENT TRANSFORMER				
ŀ		COLD WATER SUPPLY	JB	JUNCTION BOX		
L	CWFU	COLD WATER FIXTURE UNITS		KNOCK-OUT		
Γ	DB	DIRECT BURIAL		KITCHEN SINK		
t		DESIGN BUILD CONTACTOR		KILOVOLT		
İ		DIRECT CURRENT		KILOVOLT-AMPRES		
I		DEDICATED		KILOWATT		
ŀ		DETAIL DRINKING FOUNTAIN	KWH	KILOWATT HOURS		
ŀ		DIAMETER		LAVITORY		
ł		DISCONNECT		LOCAL AREA NETW		
t		DIVISION		LIGHT EMITTING DIG		
İ		DOWN	LGT	LIGHT FIXTURE		
		DISTRIBUTION PANEL		LOCAL TEMPERATU		
ŀ		DISCONNECT SWITCH		LIGHTING		
ŀ		DOOR UNDER CUT DRAWINGS		LIGHTS LOW VOLTAGE		
L	DWGG	DIAWINGS	] [ [	LOW VOLINGE		
ſ	(E) /	EXISTING	MAS	MASONRY		
ļ	EXIST			MATERIAL		
-		ELECTRICAL CONTRACTOR ELECTRIC DUCT BANK		MAXIMUM		
ŀ		EQUIPMENT GROUND		MECHANICAL CONT		
ł		EXHAUST GRILLE		MAIN CIRCUIT BREA MOTOR CONTROL O		
İ		ENGINE GENERATOR SET		MOTOR CIRCUIT PR		
İ		EXPANSION JOINT	MDF	MEDIUM DENSITY F		
ļ		ELEVATION		MAIN DISTRIBUTION		
ŀ		ELECTRIC(AL)		MECHANICAL		
ŀ		ELECTRIC/ELECTRICAL EMERGENCY LIFE SAFETY LIGHTING		METAL GRATE MANHOLE		
ł		EMERGENCY LIFE SAFETY POWER		MINIMUM		
İ		EMERGENCY		MAIN LUGS ONLY		
[	EMI	ELECTROMAGNETIC INTERFERENCE		MUSIC AND PAGE T		
ļ		ELECTRICAL METALLIC TUBING	MTD	MOUNTED		
1		EQUAL EQUIDMENT		MOUNTING		
1		EQUIPMENT EQUIPMENT SUPPLIER	MTG HGT	MOUNTING HEIGHT		
1		EXISTING TO REMAIN		METAL		
t		ELECTRICAL WATER COOLER		MOTOR / METER		
t	EWHR	ELECTRIC WATER HEATER		MEDUIM VOLTAGE		
		EXPOSED				
L	EXT	EXTERIOR		NOT APPLICABLE		
Г	E^	FIRE ALARM		NEW CONNECTION/ NON-FUSED DISCOR		
H		FIRE ALARM CONTROL PANEL		NON-FUSED SAFET		
ł		FLOOR CLEANOUT		NOT IN CONTRACT		
İ	FCU	FAN COIL UNIT	NL	NIGHT LIGHT		
		FLOOR DRAIN		NORMALLY OPEN		
ŀ		FEEDER	NTS	NOT TO SCALE		
1	FDS	FUSED DISCONNECT SWITCH	I .			

FDS FUSED DISCONNECT SWITCH
FE / FEC FIRE EXTINGUISHER (CABINET)

FE / FFE FINISH FLOOR (FLEVATION)

FEA FROM FLOOR ABOVE

FFB FROM FLOOR ABOVE
FFB FROM FLOOR BELOW
FI FILM ILLUMINATOR
FIN FINISH

OC ON CENTER(S OD OUTSIDE DIAMETER
OED OPEN ENDED DUCT

OFS OVERFLOW SCUPPER
OH OVERHEAD

OF/CI OWNER FURNISHED / CONTRACTOR INSTALL FD

OF/OI OWNER FURNISHED / OWNER INSTALLED

	ABBREVIATIONS  Abbreviati		ABBREVIA
Abbreviati	Description	Abbreviati	Doore
on FIXT	Description FIXTURE	on O7	OUNCE
	AT FLOOR LINE		CONOL
	FLOOR(ING)	P	POLE
FLA	FULL LOAD AMPRES	PB	PULL BOX / PUSHBUTTON
	FLEXIBLE		PLUMBING CONTRACTOR / PI
	FLOURESCENT		POWER DISTRIBUTION UNIT
	FLOW SWITCH		POWER FACTOR
F55	FUSED SAFETY SWITCH	PLBG	PHASE PLUMBING
GΔ	GAUGE		PLUMBING PLYWOOD
	GALVANIZED		PANEL
	GENERAL CONTRACTOR		POWER OPERATED DAMPER
GD	GARBAGE DISPOSER	PRV	POWER ROOF VENTILATOR
	GROUND FAULT CIRCUIT INTERRUPTER		POTENTIAL TRANSFORMER
	GROUND FAULT INTERRUPTER		POWER TYPE ROOF VENTILA
	GROUND FAULT PROTECTION	PWR	POWER
	GREASE INTERCEPTOR GROUND	OTV	QUANTITY
	GALLONS PER MINUTE		QUANTITY
	GALVANIZED RIGID CONDUIT	R	RISER
	GROUND TERMINAL BOX		RADIUS
		RCP	
HB	HOSE BIBB	RD	ROOF DRAIN
	HVAC CONTRACTOR		RECESSED
	HUB DRAIN		RECEPTACLE
	HARDWARE		REFERENCE / REFER TO
	HANDHOLE HAND OFF AUTOMATIC		RELOCATE REQUIRED
	HORSE POWER		REMOTE GROUND INDICATOR
	HEIGHT/HEAT TRACE		ROUGH OPENING
	HIGH VOLTAGE		ROOF TOP UNIT
HW	HOT WATER SUPPLY		
HWCP	HOT WATER RECIRCULATION PUMP	SD	SUPPLY DIFFUSER
HWFU	HOT WATER FIXTURE UNITS		SQUARE FOOT/FEET
		SH	
	INSIDE DIAMETER		SHEET
	INVERT ELEVATION ISOLATED GROUND		SIGNAL SIMILAR
	INTERMEDIATE MEATL CONDUIT		SUMP PUMP
	INCANDESCENT		SPECIFICATION
	INSULATION	SS	
INT	INTERIOR	STA	STATION
		STR	STARTER
JB	JUNCTION BOX		SUSPENDED
			SWITCH
	KNOCK-OUT		SWITCHBOARD
	KITCHEN SINK KILOVOLT	SWGR	SWITCHGEAR SYSTEM
	KILOVOLT-AMPRES	3131	STOTEM
	KILOWATT	TCC	TEMPERATURE CONTROLS C
	KILOWATT HOURS		TEMPERATURE CONTROL PA
		TEL	TELEPHONE
L	LAVITORY	TFA	TO FLOOR ABOVE
	LOCAL AREA NETWORK		TO FLOOR BELOW
	LIGHT EMITTING DIODE		TRANSFER GRILLE
	LIGHT FIXTURE		TOP OF BEAM
	LOCAL TEMPERATURE CONTROL PANEL LIGHTING		TOP OF CONCRETE TOP OF DECK
	LIGHTS		TOP OF DUCTBANK
	LOW VOLTAGE		TOP OF FOOTING
			TOPP OF MANHOLE
MAS	MASONRY	TOP	TOP OF PARAPET
MATL	MATERIAL		TOP OF STEEL
	MAXIMUM		TOP OF WALL
	MECHANICAL CONTRACTOR		TOILET PARTITION
	MAIN CIRCUIT BREAKER	TS	
	MOTOR CONTROL CENTER MOTOR CIRCUIT PROTECTOR		TELEVISION VOLTAGE SURGE TYPICAL
	MEDIUM DENSITY FIBERBOARD		TTPICAL
	MAIN DISTRIBUTION PANEL	LIC	UNDER COUNTER
	MECHANICAL		UNDER FLOOR
	METAL GRATE		UNDERGROUND
MH	MANHOLE		UNIT HEATER
	MINIMUM		UNLESS NOTED OTHERWISE
	MAIN LUGS ONLY	UPS	UNINTERRUPTED POWER SU
	MUSIC AND PAGE TERMINAL BOX	<b>—</b>	LUCKTAGE (MENT
	MOUNTED MOUNTING		VOLTAGE / VENT
	MOUNTING MOUNTING HEIGHT		VARIABLE FREQUENCY DRIVI VERIFY IN FIELD
HGT	INCOMENS REIGHT		VAPOR PROOF
	METAL		VENT STACK
	MOTOR / METER	_	VENT THROUGH ROOF
	MEDUIM VOLTAGE		
			WIRE
	NOT APPLICABLE		WITH
	NEW CONNECTION/NORMALLY CLOSED		WATER CLOSET
	NON-FUSED DISCONNECT NON-FUSED SAFETY SWITCH		WALL CLEANOUT
	NOT IN CONTRACT		WALL HYDRANT WATER HEATER

	ABBREVIATIONS
1	Description
	OUNCE
	POLE
	PULL BOX / PUSHBUTTON
~	PLUMBING CONTRACTOR / PHOTOCELL POWER DISTRIBUTION UNIT
V	POWER FACTOR
0)	PHASE PLUMBING
	PLYWOOD
	PANEL
	POWER OPERATED DAMPER POWER ROOF VENTILATOR
	POTENTIAL TRANSFORMER
	POWER TYPE ROOF VENTILATOR
	POWER
	RISER
	RADIUS
	RECIRCULATING PUMP
	ROOF DRAIN RECESSED
_	RECEPTACLE
	REFERENCE / REFER TO
	RELOCATE REQUIRED
	REMOTE GROUND INDICATOR PANEL
	ROUGH OPENING ROOF TOP UNIT
	SUPPLY DIFFUSER
	SQUARE FOOT/FEET
	SHOWER SHEET
	SIGNAL
	SIMILAR
	SUMP PUMP SPECIFICATION
S	SAFETY SWITCH / STAINLESS STEEL
Ĕ	STATION
<b>–</b>	STARTER SUSPENDED
	SWITCH
Ш	SWITCHBOARD SWITCHGEAR
<b>IMPROVEMENTS</b>	SYSTEM SYSTEM
ш	TEMPERATURE CONTROLS CONTRACTOR
5	TEMPERATURE CONTROL PANEL
	TELEPHONE TO SI OOR AROVE
U	TO FLOOR ABOVE TO FLOOR BELOW
$\simeq$	TRANSFER GRILLE
0	TOP OF BEAM TOP OF CONCRETE
$\equiv$	TOP OF CONCRETE  TOP OF DECK
$\leq$	TOP OF DUCTBANK
	TOP OF FOOTING TOPP OF MANHOLE
$\succeq$	TOP OF PARAPET
$\sim$	TOP OF STEEL
7	TOP OF WALL TOILET PARTITION
7	TAMPER SWITCH / TIME SWITCH
0	TELEVISION VOLTAGE SURGE SUPRESSION
<b>&gt;</b>	TYPICAL
	UNDER COUNTER
	UNDER FLOOR
Z	UNIT HEATER
=	UNLESS NOTED OTHERWISE
DMMUNITY F	UNINTERRUPTED POWER SUPPLY
2	VOLTAGE / VENT
<b>ا</b> کے نو	VARIABLE FREQUENCY DRIVE VERIFY IN FIELD
Nan	VAPOR PROOF
Project Name	VENT STACK VENT THROUGH ROOF
	WIRE
REVISION	WITH WATER CLOSET
ISSUE D	WALL CLEANOUT
	WALL HYDRANT
	WATER HEATER WEATHERPROOF
	WATER SOFTENER
	WATER TIGHT
Project	TRANSFORMER EXPLOSION PROOF
Issued F Date:	NUMBER / POUND











NOT AND **SYMBOLS** 

HUGHETTE ROAD
RIDGEWAY, WI 53582
Sheet Title
ABBREVIATIONS, 9


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E001

20235700



### **ELECTRICAL GENERAL NOTES:**

- GENERAL NOTES AND KEYED NOTES ARE TYPICAL ACROSS ALL DRAWINGS. KEYED NOTES MAY NOT BE USED OR BE APPLICABLE TO ALL DRAWINGS. REFER TO DRAWING E01 FOR ADDITIONAL NOTES.
- HANDHOLES AND PULL BOXES ARE NOT SPECIFICALLY SHOWN. ELECTRICAL CONTRACTOR SHALL PROVIDE HANDHOLES AND PULL BOXES MOUNTED TO POLES, QUANTITIES AND SIZES AS REQUIRED BY THE NEC AND FOR A COMPLETE AND FUNCTIONAL INSTALLATION. IF HANDHOLES ARE PROVIDED THEY SHALL BE LOCATED OUTSIDE OF THE BALL DIAMOND FENCE LINES TO NOT IMPEDE PLAY.
- ALL CONDUIT ROUTES ON THIS DRAWING ARE SCHEMATIC ONLY, ELECTRICAL CONTRACTOR SHALL PROVIDE ALL CONDUITS, INCLUDING THOSE NOT SPECIFICALLY SHOWN, FOR A COMPLETE AND FUNCTIONAL INSTALLATION.
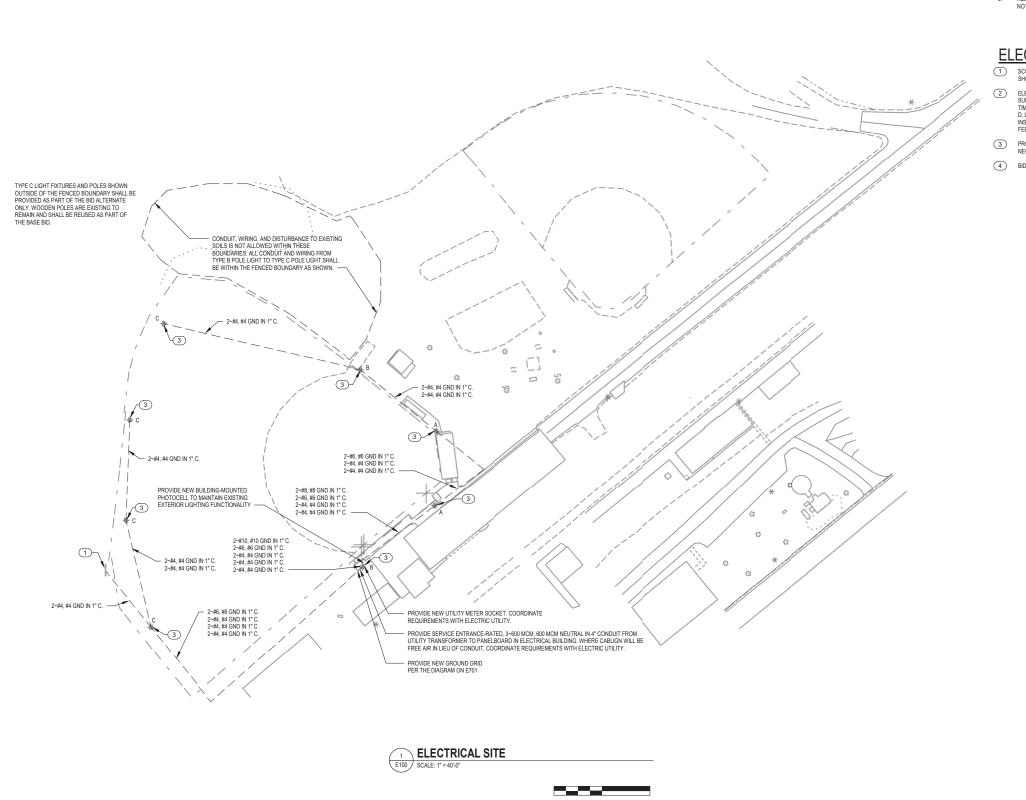
## **ELECTRICAL KEYED NOTES:**

- SCOREBOARD. PROVIDE NEW LOCKABLE DISCONNECTING MEANS IN ACCORDANCE WITH THE NEC. DISCONNECTING MEANS NOT SPECIFICALLY SHOWN.
- ELECTRICAL BUILDING, PROVIDE NEW PANELBOARD AS SCHEDULED ON E701, NEW NEMA 5-20R RECEPTACLE WITH GFCI PROTECTION, SURFACE-MOUNTED STRIP LIGHT (LITHONIA CSS-1.48-4000LM-MYOLT-358-30CR), OR EQUAL), WITH TOGGLE ON-ON-F WALL SWITCH, LIGHTING TIMECLOCK (INTERMATIC TOT), OR EQUAL), TYPE 2 SPD (L-N-700V), L-S: 1000V, L-1: 1000V, L-1: 1000V, L-10 IOA, 20 IA ADVAIRATING, EATON, SOUARE D, LEVITON, LIBERT, ABB, OR EQUAL CONFIRM GIRCUIT BREAKER SIZE IN PANELBOARD WITH SPD MANUFACTURER PRIOR TO ORDERING) AND INSTALL MANUFACTURER PRIVINSHED BALL DIMOND LIGHTING CONTROL PANEL WITH LIGHTING CONTACTORS. EXISTING EQUIPMENT AND FEEDERS SHALL TIE INTO EXISTING CIRCUITS AS SHOWN IN THE PANEL SCHEDULE ON E701.
- 3 PROVIDE GROUND ROD AND #6 GROUND WIRE CONNECTOR TO GROUND ROD AND POLE TO GROUND LIGHT POLE IN ACCORDANCE WITH THE
- 4 BID ALTERNATE: INSTALL OWNER-FURNISHED LIGHT POLES FOR EXTERIOR ATHLETIC LIGHTING.







COMMUNITY PARK IMPROVEMENTS

HUGHETTE ROAD
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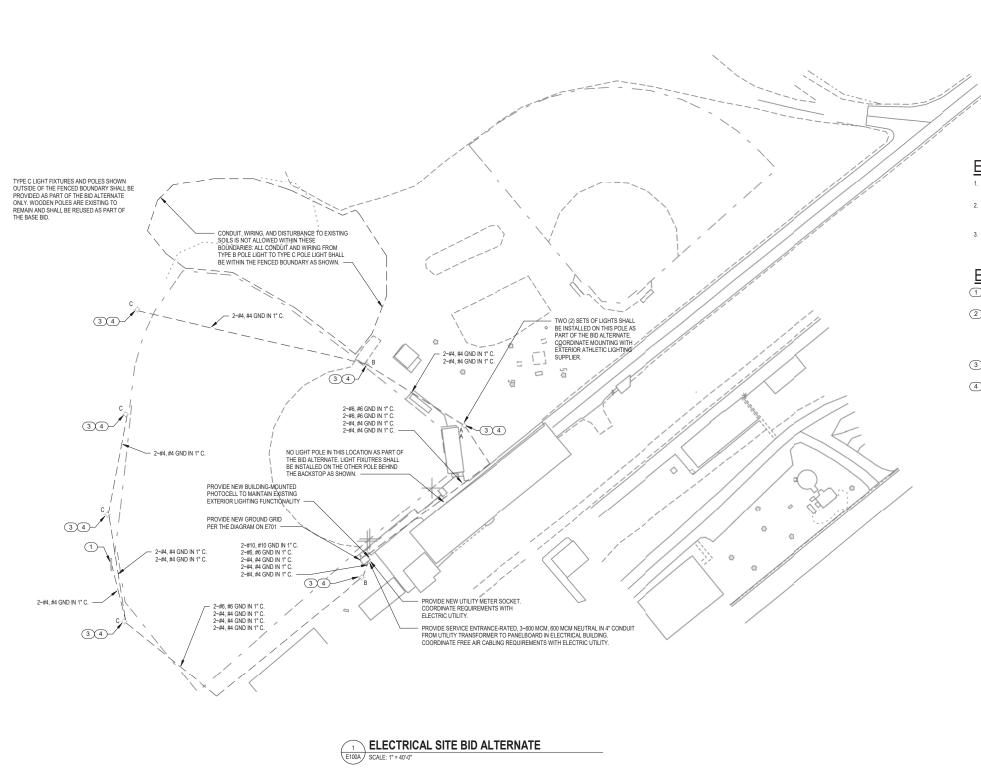
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## **ELECTRICAL GENERAL NOTES:**

- GENERAL NOTES AND KEYED NOTES ARE TYPICAL ACROSS ALL DRAWINGS. KEYED NOTES MAY NOT BE USED OR BE APPLICABLE TO ALL
- HANDHOLES AND PULL BOXES ARE NOT SPECIFICALLY SHOWN. ELECTRICAL CONTRACTOR SHALL PROVIDE HANDHOLES AND PULL BOXES MOUNTED TO POLES, QUANTITIES AND SIZES AS REQUIRED BY THE NEC AND FOR A COMPLETE AND FUNCTIONAL INSTALLATION. IF HANDHOLES ARE PROVIDED THEY SHALL BE LOCATED OUTSIDE OF THE BALL DIAMOND FENCE LINES TO NOT IMPEDE PLAY.
- ALL CONDUIT ROUTES ON THIS DRAWING ARE SCHEMATIC ONLY. ELECTRICAL CONTRACTOR SHALL PROVIDE ALL CONDUITS, INCLUDING THOSE NOT SPECIFICALLY SHOWN, FOR A COMPLETE AND FUNCTIONAL INSTALLATION.

## **ELECTRICAL KEYED NOTES:**

- 1 SCOREBOARD. PROVIDE NEW LOCKABLE DISCONNECTING MEANS IN ACCORDANCE WITH THE NEC. DISCONNECTING MEANS NOT SPECIFICALLY
- ELECTRICAL BUILDING. PROVIDE NEW PANELBOARD AS SCHEDULED ON E701, NEW NEMA 5-20R RECEPTACLE WITH GFCI PROTECTION, SURFACE-MOUNTED STRIP LIGHT (LITHONIA CSS-1.49-4.000LM-MYOLT-35K-4.90CR). OR EQUAL) WITH TOGGLE ON-OFF WALL SWITCH, LIGHTING TIMECLOCK (MTREMATIC TOI), OR EQUAL), TYPE 2 SPD (L-N-TOW). L-G: 1000, V. L-1: 1000, V. CET, 1004, 20 LA NOMINAL RATING, EATON, SQUARE D, LEVITON, LIEBERT, ABB, OR EQUAL CONFIRM GIRCUIT BREAKER SIZE: IN PANELBOARD WITH SPD MANUFACTURER PRIOR TO ORDERING) AND INSTALL MANDFACTURER. PURNISHED BALL DIMOND LIGHTING CONTROL PAREL WITH LIGHTING CONTACTORS. EXISTING EQUIPMENT AND FEEDERS SHALL TIE INTO EXISTING CIRCUITS AS SHOWN IN THE PANEL SCHEDULE ON E701.
- 3 PROVIDE GROUND ROD AND #6 GROUND WIRE CONNECTOR TO GROUND ROD AND POLE TO GROUND LIGHT POLE IN ACCORDANCE WITH THE NEC.
- $\begin{tabular}{ll} \hline \textbf{4} & \textbf{BID ALTERNATE: INSTALL OWNER-FURNISHED LIGHT POLES FOR EXTERIOR ATHLETIC LIGHTING.} \\ \hline \end{tabular}$

COMMUNITY PARK IMPROVEMENT

BID HUGHETTE ROAD
RIDGEWAY, WI 53582
Sheet Title
ELECTRICAL SITE SITE

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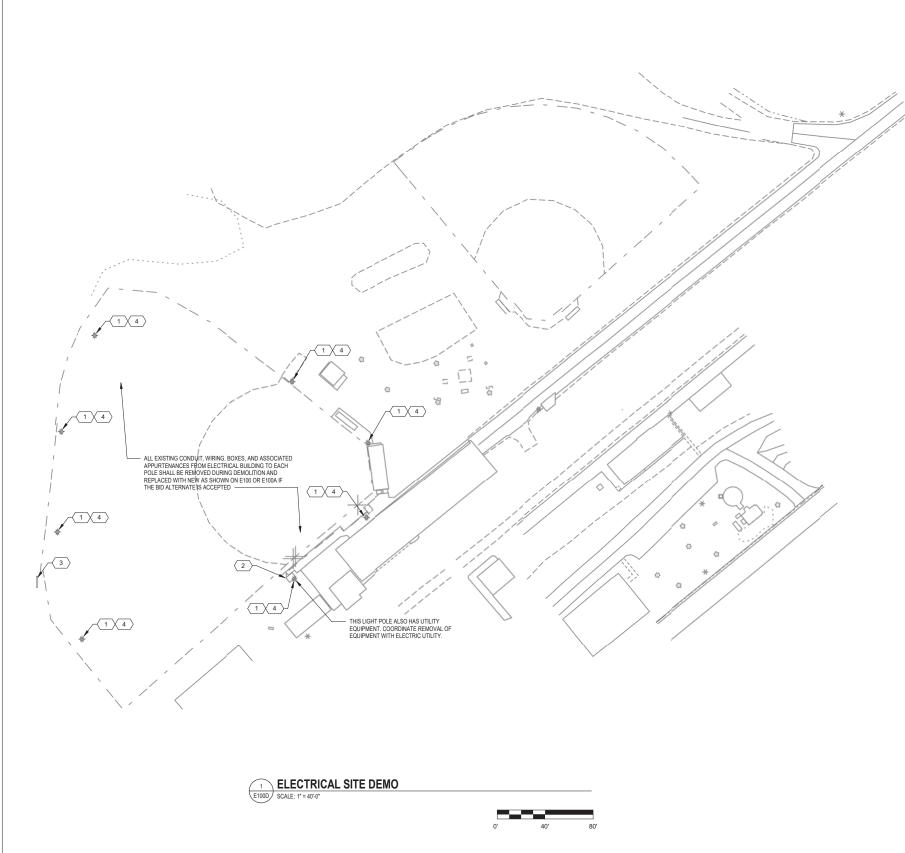
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Date: E100A



## **ELECTRICAL DEMOLITION GENERAL NOTES:**

- REMOVE ALL EXISTING ELECTRICAL EQUIPMENT AND MATERIALS ASSOCIATED WITH THE ITEMS BEING REMOVED AND SHOWN ON THIS DRAWING, AS WELL AS ALL EXISTING ELECTRICAL DEVICES, MATERIALS, AND EQUIPMENT NOT BEING REUSED.
- PATCH ALL STRUCTURE HOLES AND DEFORMATIONS RESULTING FROM DEMOLITION WORK TO MATCH EXISTING INSTALLATION.
- RECONNECT OR ALTER AND EXISTING EXISTING CONDUIT AND WIRING FOR EQUIPMENT AND CIRCUITS EXISTING TO REMAIN TO MAINTAIN EXISTING FUNCTIONALITY.
- THE LOCATIONS AND ELEVATIONS OF EQUIPMENT AND COMPONENTS ARE APPROXIMATE. CONTRACTOR SHALL FIELD VERIFY THE LOCATIONS AND ELEVATIONS OF ALL EXISTING EQUIPMENT AND COMPONENTS IN ORDER TO PERFORM THE CONSTRUCTION SHOWN ON THESE DRAWINGS.
- NOT ALL EXISTING EQUIPMENT, PIPING, OR CONDUIT SHON. EXISTING EQUIPMENT AND COMPONENTS WERE OBTAINED FROM FIELD MEASUREMENTS. CONTRACTOR IS RESPONSIBLE FOR VERIFYING THE ACCURACY OF EXISTING INFORMATION AS REQUIRED FOR NEW CONSTRUCTION.

## **ELECTRICAL DEMOLITION KEYED NOTES:**

- REMOVE LIGHT FIXTURES FROM POLE AND ALL ASSOCIATED APPURTENANCES BACK TO SOURCE. POLE SHALL REMAIN FOR INSTALLATION OF NEW LIGHT FIXTURES AND GROUNDING SYSTEM. (POLE SHALL REMAIN AS PART OF BASE BID, REMOVAL OF POLE AND ASSOCIATED APPURTENANCES SHALL OCCUR IN THE BID ALTERNATE AS NOTED ON THESE DRAWINGS.)
- 2 DELECTRICAL BUILDING, REMOVE PANELBOARD, BALL DIAMOND LIGHTING CONTROL PANEL, GROUND GRID, WALL SWITCH, RECEPTACLE, LIGHTING TIMECLOCK, EXTERIOR PHOTOCELL, AND ALL ASSOCIATED CONDUIT, WIRING, UTILITY METER AND ASSOCIATED APPURTENANCES. COORDINATE UTILITY EQUIPMENT WITH UTILITY COMPANY. EQUIPMENT SHALL BE REPLACED IN KIND AS SHOWN ON E100 OR E100A IF THE BID ALTERNATE IS ACCEPTED.
- 3 SCOREBOARD, REMOVE ASSOCIATED DISCONNECT SWITCH AND CONDUIT AND WIRING BACK TO SOURCE. PREPARE FOR INSTALLATION OF NEW CONDUIT, WIRING, AND DISCONNECT SWITCH AS SHOWN ON E100 OR E100A IF THE BID ALTERNATE IS ACCEPTED.
- BID ALTERNATE: REMOVE LIGHT POLES AND ASSOCIATED APPURTENANACES. PADDING ON LIGHT POLES SHALL BE SAVED FOR REINSTALLATION ON NEW POLES WHERE SHOWN ON E100A.







CONIC

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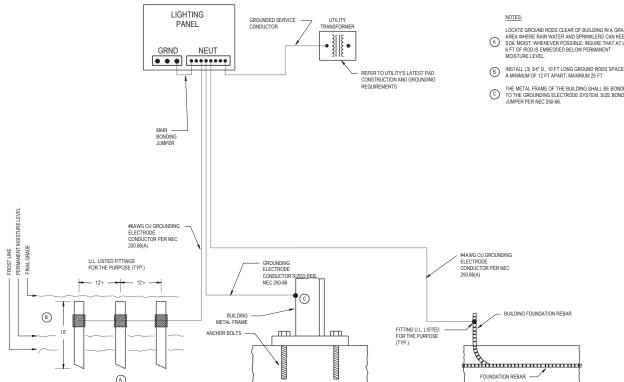
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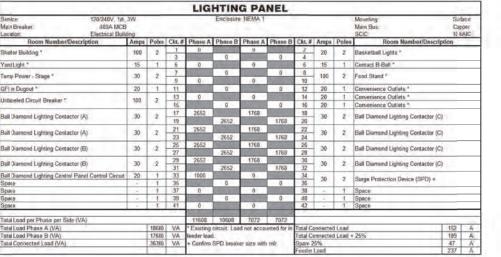
Sheet Number


E100D

LIGHTING FIXTURE SCHEDULE								
TYPE	DESCRIPTION	MANUFACTURER	MODEL NUMBER	VOLTAGE	WATTS	LAMP	WOUNTING	NOTES
A	BALL DIAMOND LIGHTING	WILL - WISCONSIN LIGHTING LAB	WS K88940-67-MV-5N-BK-APY-WHP19IP W WS- PDH & WS-RPCE-8W-X-MV-LG-PBS & NP-A-ACR- BTP-4/2-STUD-188-SBF	240V	5.301 KW	LED	POLE	LIGHT FIXTURES SHALL BE MOUNTED ON ENSTING POLEUSING MANUFACTURES. RECOMMENDED HARDWARE HARDWARE SHALL BE PROVIDED BY ELECTRICAL CONTRACTOR
8	BALL DIAMOND LIGHTING:	WILL - WISCONSIN LIGHTING LAB	WS-K88340-57-MV-SN-BK-APY-WHP15NP w/ WS- PDH & WS-RPCE-BW-X-MV-LIG-PBS & NP-A-ACR- BTP-4/2-STUD-180-SBF	240V	5.768.AW	LED	POLE	LIGHT FIXTURES SHALL BE MOUNTED ON EXISTING POLEUSING MANUFACTURER- RECOMMENDED HARDWARE. HARDWARE SHALL BE PROVIDED BY ELECTRICAL CONTRACTOR
G	BALL DIAMOND LIGHTING	WILL - WISCONSIN LIGHTING LAB	WS-KU0940-67-MV-9N-BK-APY-WHP1MP w/ WS- PDH & WS-RPCE-8W-X-MV-LG-PBS & NP-A-ACR- BTP-4/2-STUD-180-S8F	240V	3 536 kW	LED	POLE	LIGHT FUTURES SHALL BE MOUNTED ON EXISTING POLEUSING MANUFACTURER- RECOMMENDED HARDWARE HARDWARE SHALL BE PROVIDED BY ELECTRICAL CONTRACTOR



GROUNDING SYSTEM DIAGRAM



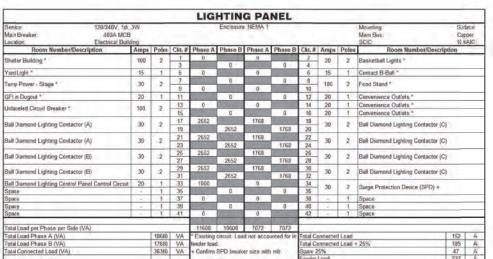



**DIAGRAMS** 

AND



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ELECTRICAL SCHEDULES A

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E701

