

Land Surveyors  
Phone: (972) 589-2302  
Fax: (972) 589-2302  
mcl@webbsurveying.com

Webb Surveying, Inc.  
13300 Preston Road  
Suite 139  
Pleasanton, TX 75023

SURVEY

SITE NAME: DA03931D PROSPER  
SITE NUMBER: DA03931D  
1240 FRONTIER PARKWAY  
PROSPER, TX 75078

T-Mobile®

7668 WARREN PARKWAY  
FRISCO, TEXAS 75034  
OFFICE: (972) 464-3030  
FAX: (972) 464-3180

STATE OF TEXAS  
KURTIS R. WEBB  
4125  
PROFESSIONAL  
LAND SURVEYOR

DRWN KRW  
CK KRW

NO.	DATE:	DESCRIPTION:
1	03/29/2021	DATE OF SURVEY
2	04/05/2021	ISSUED
3	05/28/2021	REVISED LEASE AREA
4	06/09/2021	MISC. REVISIONS
5	03/15/2022	REVISED LEASE AREA
6		
7		

SV-1







FLOOD NOTE:  
THE PROPOSED SITE IS LOCATED IN FLOOD ZONE X, AERA OF MINIMAL FLOOD HAZARD, PER FEMA MAP# 48085C0120J EFFECTIVE ON 06/02/09. IF A PROFESSIONAL CONSULTANT HAS FINDING OF FLOODING/WETLANDS CONTACT ALLPRO CONSULTING GROUP, INC FOR A REDESIGN.

SITE LAYOUT IS BASED ON ZONING DRAWINGS BY ALLPRO CONSULTING GROUP, INC ACGI#21-5315 DATED 03/23/22 AND SITE WALK BY ALLPRO CONSULTING GROUP, INC. ACGI#21-0857 DATED 03/23/21. IF ANY DISCREPANCY IS NOTICED BETWEEN THE ACTUAL SITE LAYOUT AND THESE DRAWINGS, PLEASE NOTIFY ALLPRO CONSULTING GROUP, INC. FOR A REDESIGN.

NOTE:  
ALL INSTALLATIONS SHOULD BE IN COMPLIANCE WITH ANSI/ASSE A10.48 AND ANY OTHER SAFETY STANDARDS.

NOTES:

1. PROPOSED BURIED OR OVERHEAD UTILITIES MUST BE CONTAINED WITHIN A DEDICATED UTILITY EASEMENT. ALL EXISTING AND NEW UTILITY EASEMENTS MUST BE VERIFIED PRIOR TO CONSTRUCTION. NO DIGGING OR TRENCHING SHALL BE ALLOWED WITHOUT PRIOR VERIFICATION OF EXISTING BURIED UTILITIES.
2. POWER & FIBER/TELCO SOURCES AND ROUTING TO BE FIELD VERIFIED.
3. ALL UTILITY RUNS TO BE LOCATED WITHIN EASEMENT

NOTE:  
REFERENCE SURVEY BY WEBB SURVEYING, INC KRW JOB# 221-018 DATED 03/15/22. ALL PROPERTY LINES, UTILITIES AND EASEMENTS TO BE VERIFIED IN FIELD. DUE DILIGENCE SHALL BE DONE BY OTHERS BEFORE THE SITE IS BUILT AS SHOWN. IN CASE OF ANY CONFLICTS DUE TO PROPERTY LINES OR NEW EXPANSION ON AN EXISTING EASEMENTS OR DUE TO LANDLORD PREFERENCE FOR A DIFFERENT DESIGN, PLEASE CONTACT ALLPRO CONSULTING GROUP, INC FOR A REDESIGN BEFORE SITE IS BUILT.


NOTE:  
CMU WALL/FOUNDATION DESIGN IS BY ALLPRO CONSULTING GROUP, INC ACGI# 22-4294 DATED 12/19/22.

LEGEND

- PP - POWER POLE
- TPED - TELEPHONE RISER
- WV- WATER VALVE
- FH - FIRE HYDRANT
- TOWER CENTROID
- LP - LIGHT POLE
- EM - ELECTRIC METER
- GM - GAS METER
- IRS - IRON ROD SET
- IRF - IRON ROD FOUND
- TBM BENCH MARK
- BUILDING LINES
- FENCE LINE
- POWER LINE

Exhibit B

1 OVERALL SITE PLAN

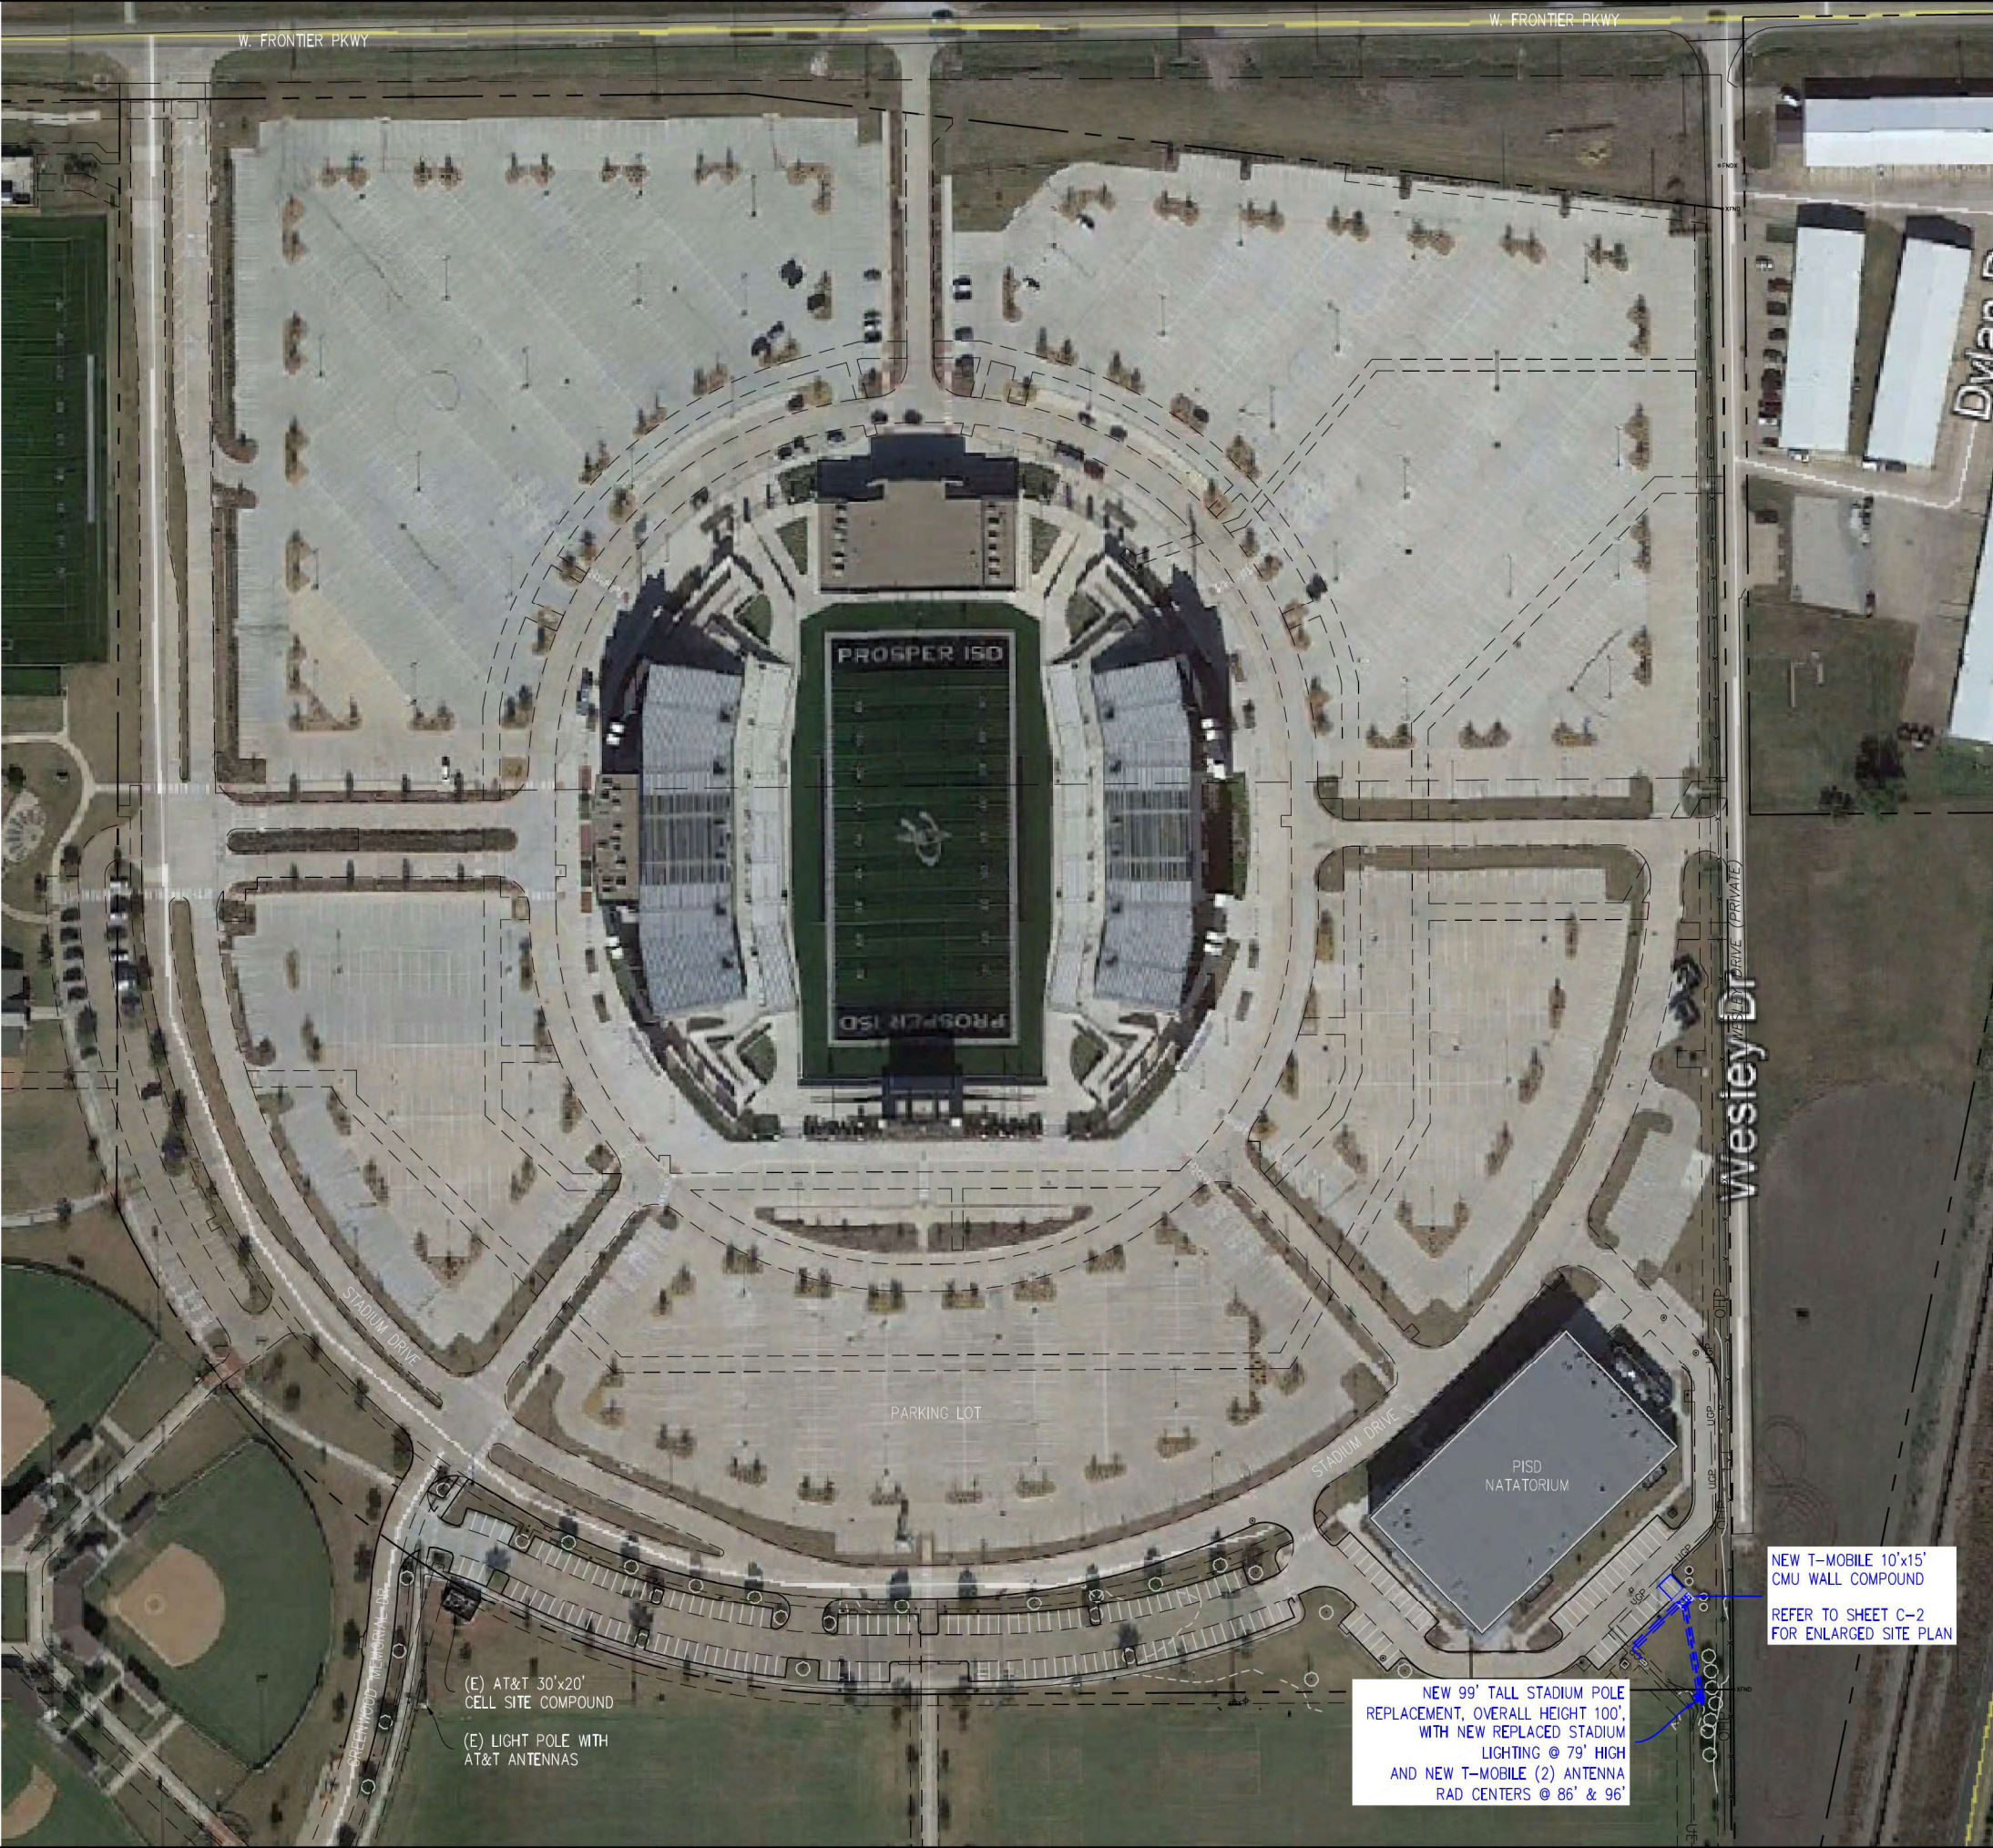

**T-Mobile**  
DUKE BRIDGES CAMPUS  
7668 WARREN PARKWAY  
FRISCO, TX 75034  
OFFICE: (972) 464-3510

**Network Real Estate LLC**  
5055 HIGHWAY "N"  
SUITE 200  
SAINT CHARLES,  
MO 63304  
PHONE: 636-922-3400  
600 E. JOHN  
CARPENTER FWY.  
STE 357  
IRVING, TX 75062  
PHONE: 972-717-7802

ACGI NO: 21-0860

DRAWN BY: DR/TS

CHECKED BY: SZ

REVISIONS			
NO	DATE	DESCRIPTION	BY
A	01/10/23	PRELIM CD	DR
O	01/24/23	FINAL CD	TS

**ALLPRO**  
CONSULTING GROUP, INC.  
9221 LYNDON B JOHNSON FWY  
SUITE 204, DALLAS, TX 75243  
PHONE: 972-231-8893  
FAX: 866-364-8375  
WWW.ALLPROCGI.COM  
FIRM NO. F-8242

STATE OF TEXAS  
SHIQIANG ZHANG  
137482  
LICENSED  
PROFESSIONAL ENGINEER  
01/24/23

DA03931D  
PISD SPORT COMPLEX  
(STADIUM AND NATATORIUM)

1240 W FRONTIER PKWY  
PROSPER, TX 75078  
COLLIN COUNTY

SHEET TITLE  
OVERALL SITE PLAN

SHEET NUMBER  
C-1



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- BUILDING LINES
- FENCE LINE
- POWER LINE

Zoning Case #:  
ZONE-23-0008

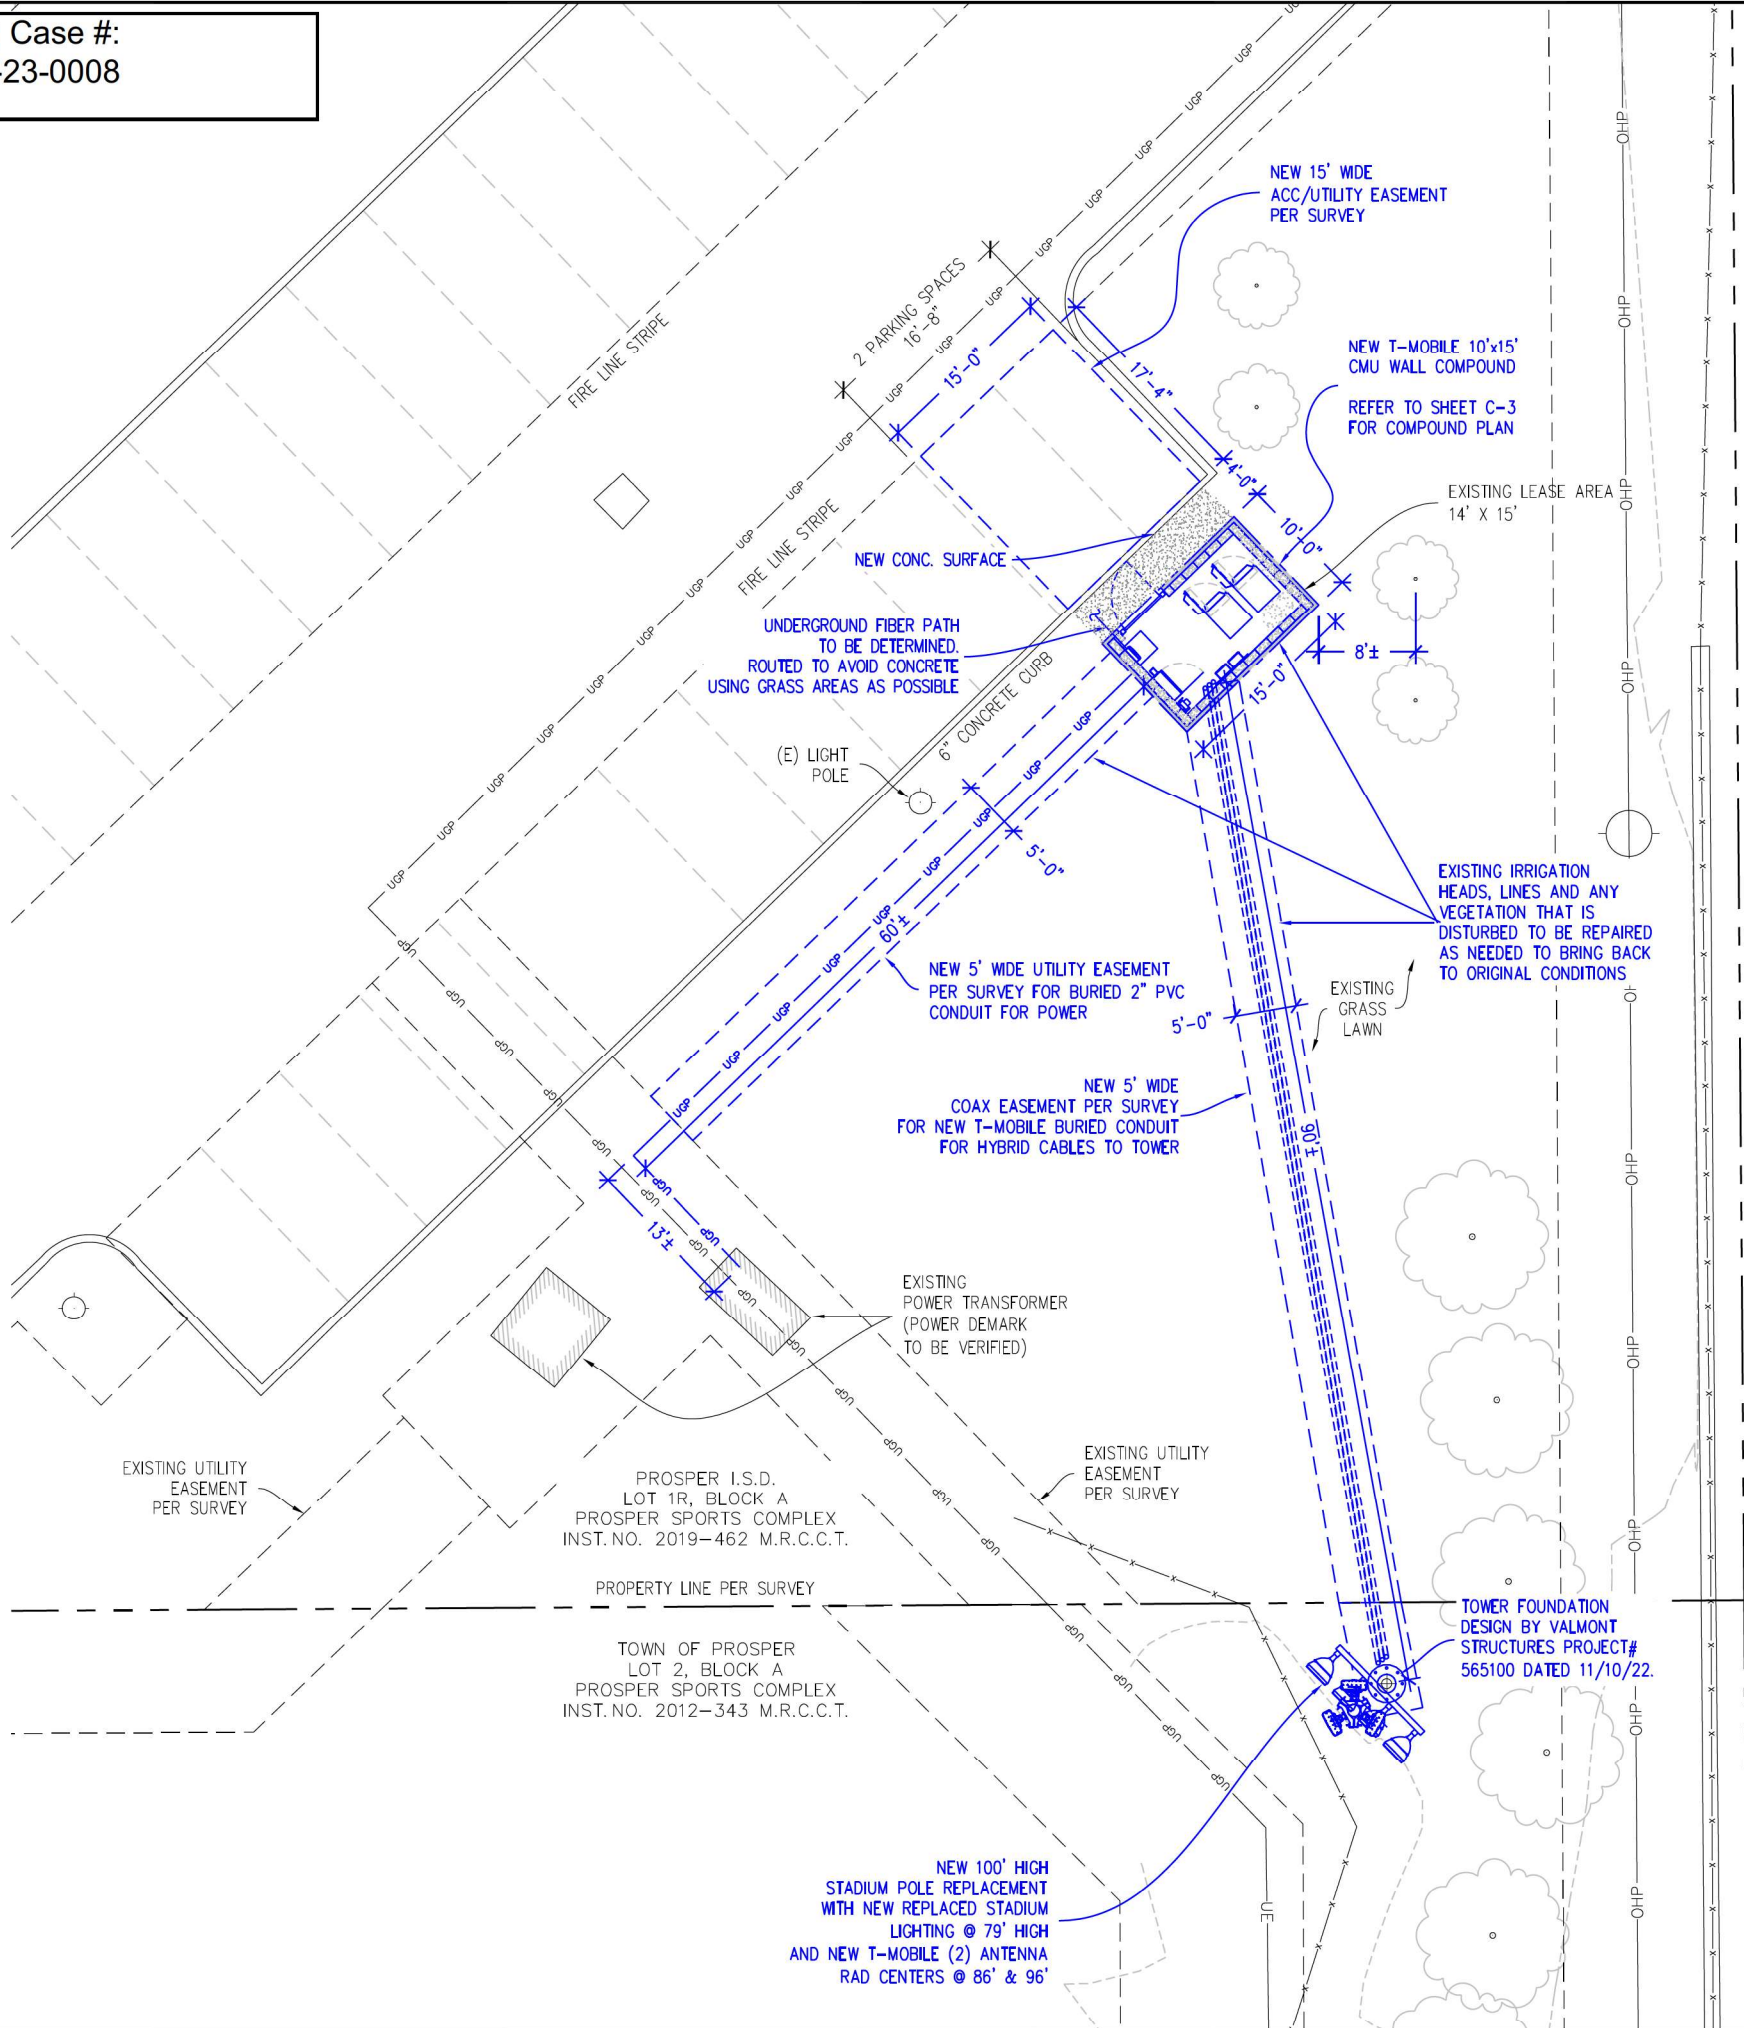


Exhibit B



1 ENLARGED SITE PLAN  
FOR 24" X 36" PLOT - 1/8" = 1' 0' 2' 4' 8' 16'  
FOR 11" X 17" PLOT - 1/16" = 1'

**T-Mobile**  
DUKE BRIDGES CAMPUS  
7668 WARREN PARKWAY  
FRISCO, TX 75034  
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**Network Real Estate LLC**  
5055 HIGHWAY "N"  
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600 E. JOHN  
CARPENTER FWY.  
STE 357  
IRVING, TX 75062  
PHONE: 972-717-7802

ACGI NO: 21-0860

DRAWN BY: DR/TS

CHECKED BY: SZ

REVISIONS			
NO	DATE	DESCRIPTION	BY
A	01/10/23	PRELIM CD	DR
O	01/24/23	FINAL CD	TS

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STATE OF TEXAS  
SHIQIANG ZHANG  
137482  
LICENSED  
PROFESSIONAL ENGINEER  
01/24/23

DA03931D  
PISD SPORT COMPLEX  
(STADIUM AND NATATORIUM)

1240 W FRONTIER PKWY  
PROSPER, TX 75078  
COLLIN COUNTY

SHEET TITLE  
ENLARGED SITE PLAN

SHEET NUMBER  
C-1A



NOTE:  
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A10.48 AND ANY OTHER SAFETY STANDARDS.

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INC ACGI# 22-4294 DATED 12/19/22.

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	IRF - IRON ROD FOUND
	TBM BENCH MARK
	BUILDING LINES
	FENCE LINE
	OHP - POWER LINE

Zoning Case #:  
ZONE-23-0008

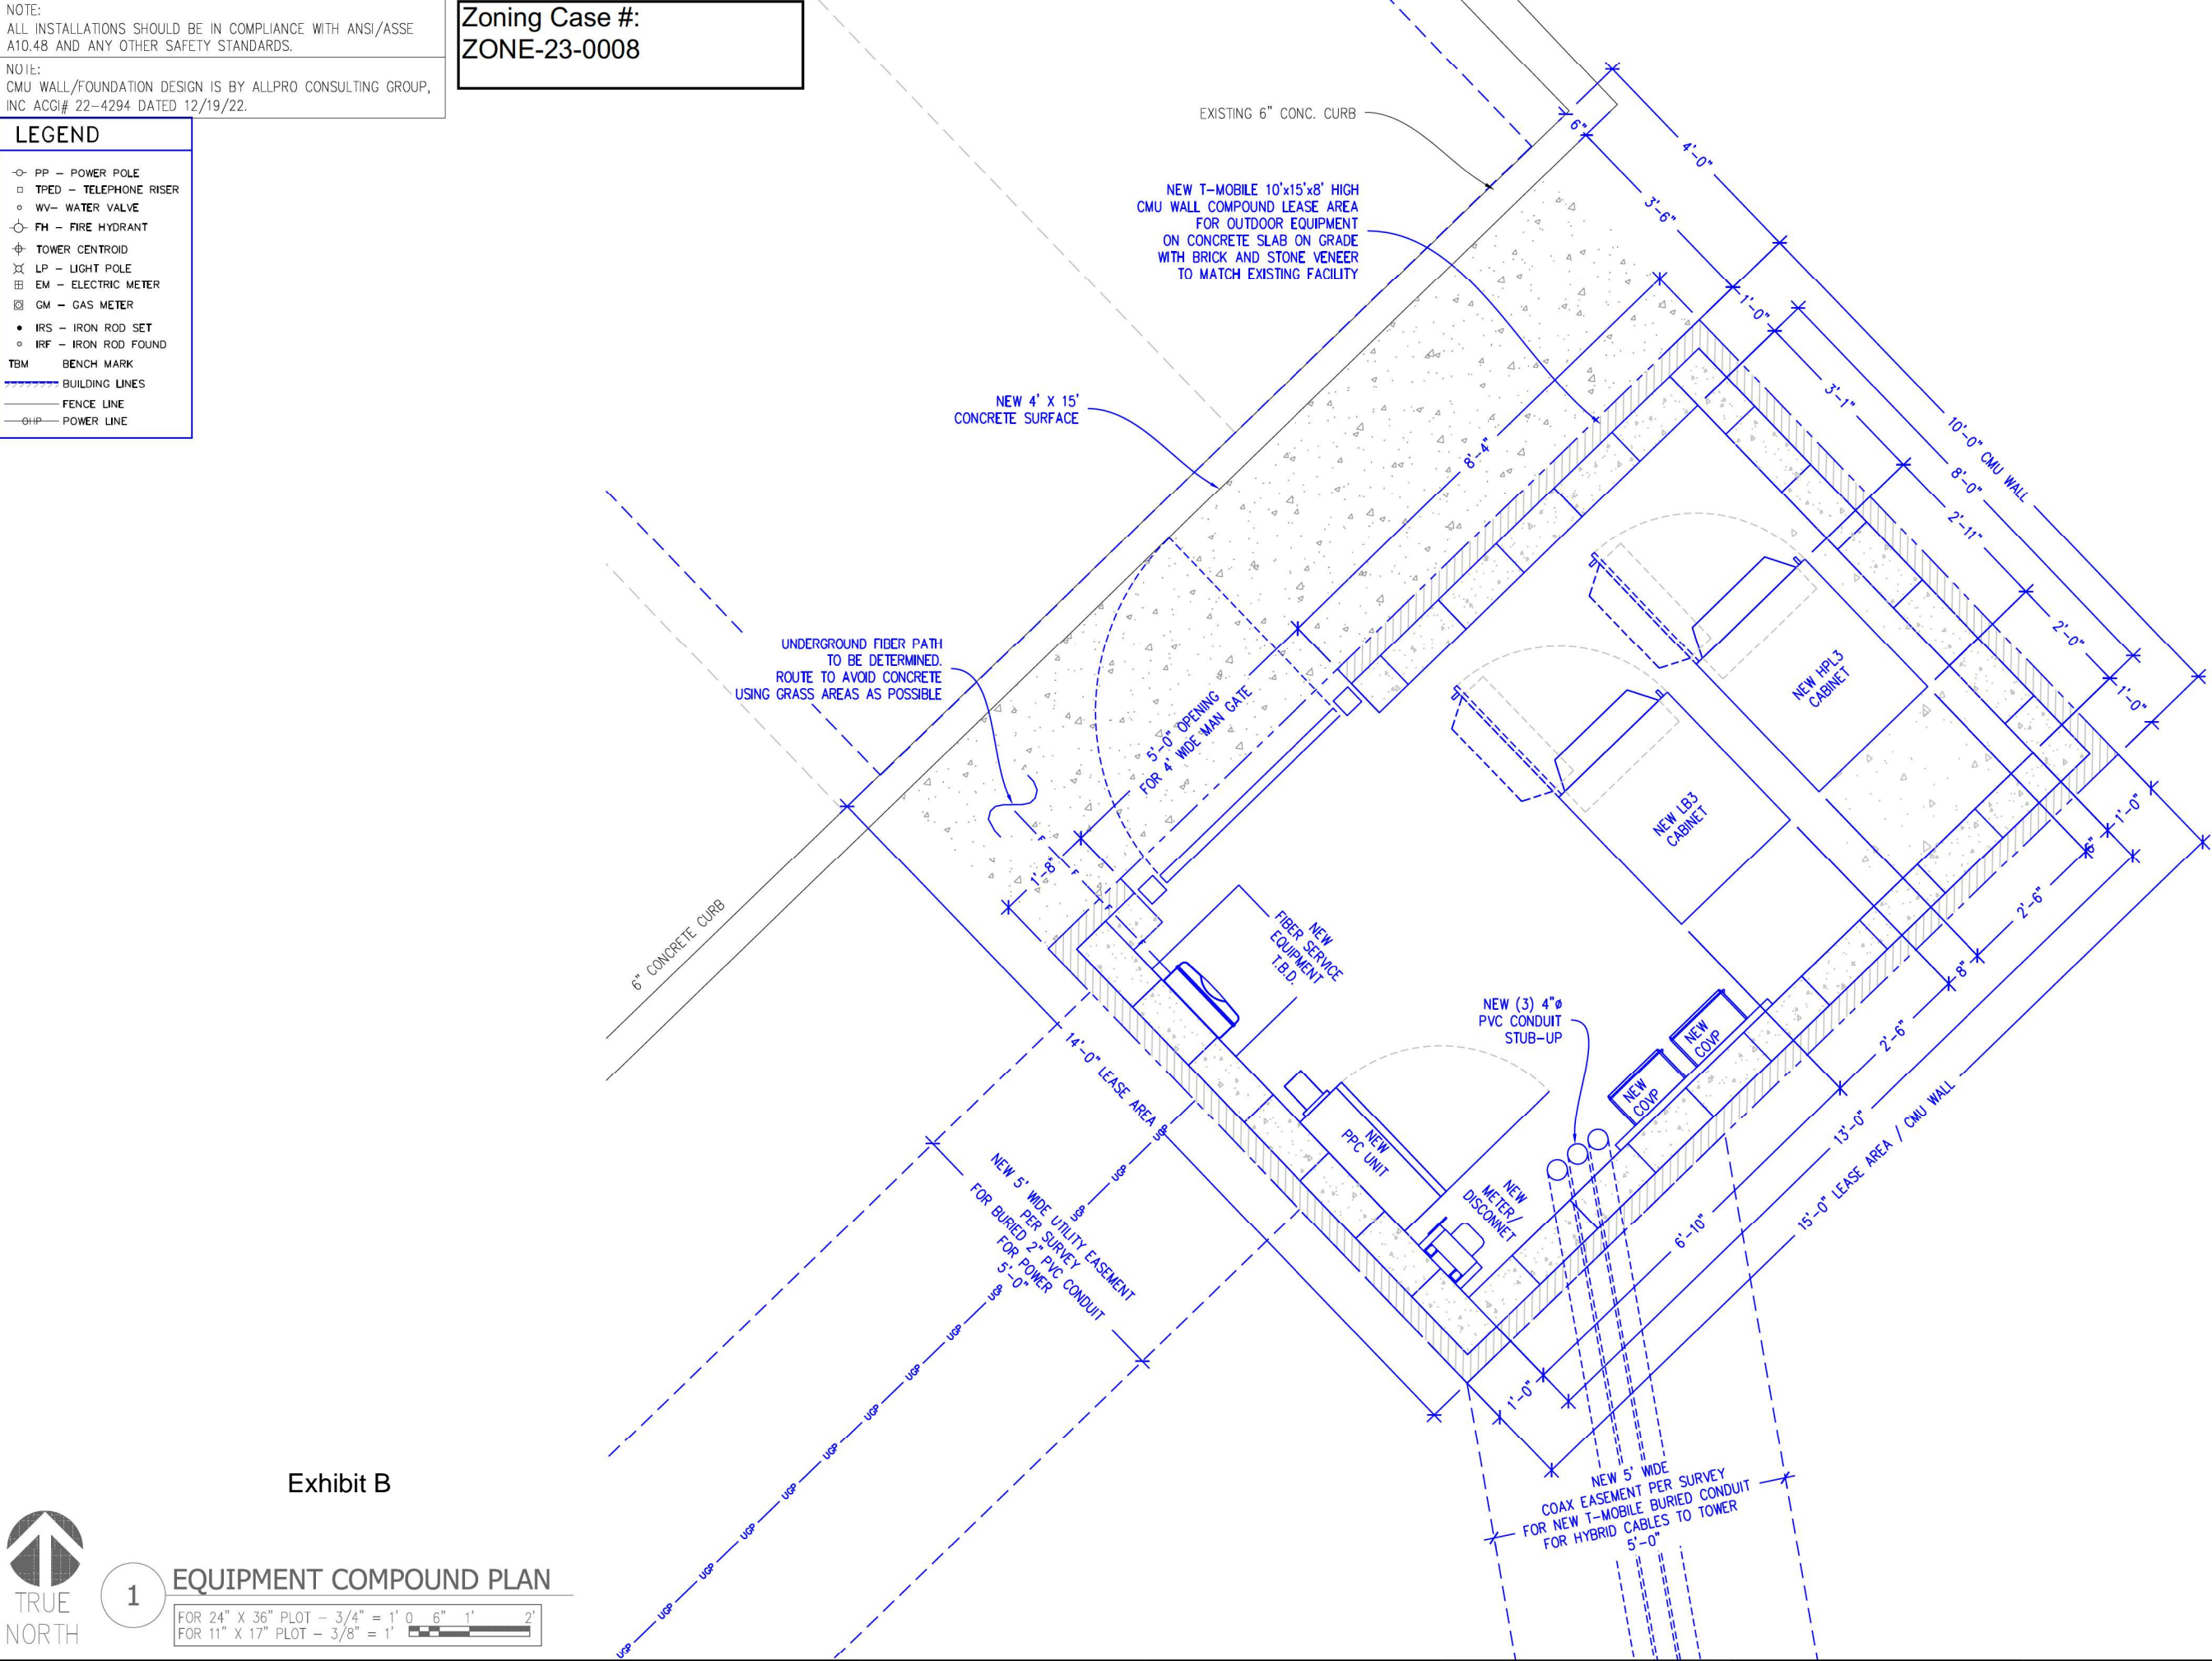


Exhibit B

1

EQUIPMENT COMPOUND PLAN

FOR 24" X 36" PLOT - 3/4" = 1' 0 6" 1' 2"  
FOR 11" X 17" PLOT - 3/8" = 1'

DUKE BRIDGES CAMPUS  
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PHONE: 972-717-7802

ACGI NO: 21-0860

DRAWN BY: DR/TS

CHECKED BY: SZ

REVISIONS			
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O	01/24/23	FINAL CD	TS

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01/24/23

DA03931D  
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(STADIUM AND NATATORIUM)

1240 W FRONTIER PKWY  
PROSPER, TX 75078  
COLLIN COUNTY

SHEET TITLE  
EQUIPMENT  
COMPOUND PLAN

SHEET NUMBER  
C-2



NOTE:  
MOUNT ANALYSIS IS BY OTHERS NO NEW EQUIPMENT TO BE  
INSTALLED WITHOUT THE APPROVAL OF A STRUCTURAL  
ENGINEER.

NOTE:  
STRUCTURAL ANALYSIS IS BY OTHERS NO NEW EQUIPMENT  
TO BE INSTALLED WITHOUT THE APPROVAL OF A  
STRUCTURAL ENGINEER.


NOTE:  
PROPOSED ANTENNA PLACEMENT LOCATION TO BE FIELD  
VERIFIED BY GENERAL CONTRACTOR PRIOR TO CONSTRUCTION  
TO AVOID ANY INTERFERENCE OR SHADOWING OF EXISTING  
ANTENNAS. IF INTERFERENCE OR SHADOWING OF EXISTING  
ANTENNAS IS DISCOVERED DURING FIELD VERIFICATION,  
PLEASE CONTACT ALLPRO CONSULTING GROUP INC. FOR  
DESIGN REVISION PRIOR TO ANY NEW ANTENNA  
INSTALLATION.

NOTE:  
CLIMBERS SHOULD NOT LATCH OR TIE THEIR SUPPORT  
LANYARD OR GEAR ON TO ANTENNAS, RADIOS, ANTENNA  
MOUNTS ETC WITHOUT PROPER EVALUATION. THEY SHOULD  
ONLY TIE TO THEIR SUPPORT LANYARDS OR GEAR TO OR  
ATTACH TO TOWER STRUCTURAL MEMBERS THAT HAVE  
VISIBLE BOLTING AND CONNECTION TO THE LARGER  
STRUCTURE.


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GROUP, INC ACGI# 22-4294 DATED 12/19/22.

Zoning Case #:  
ZONE-23-0008

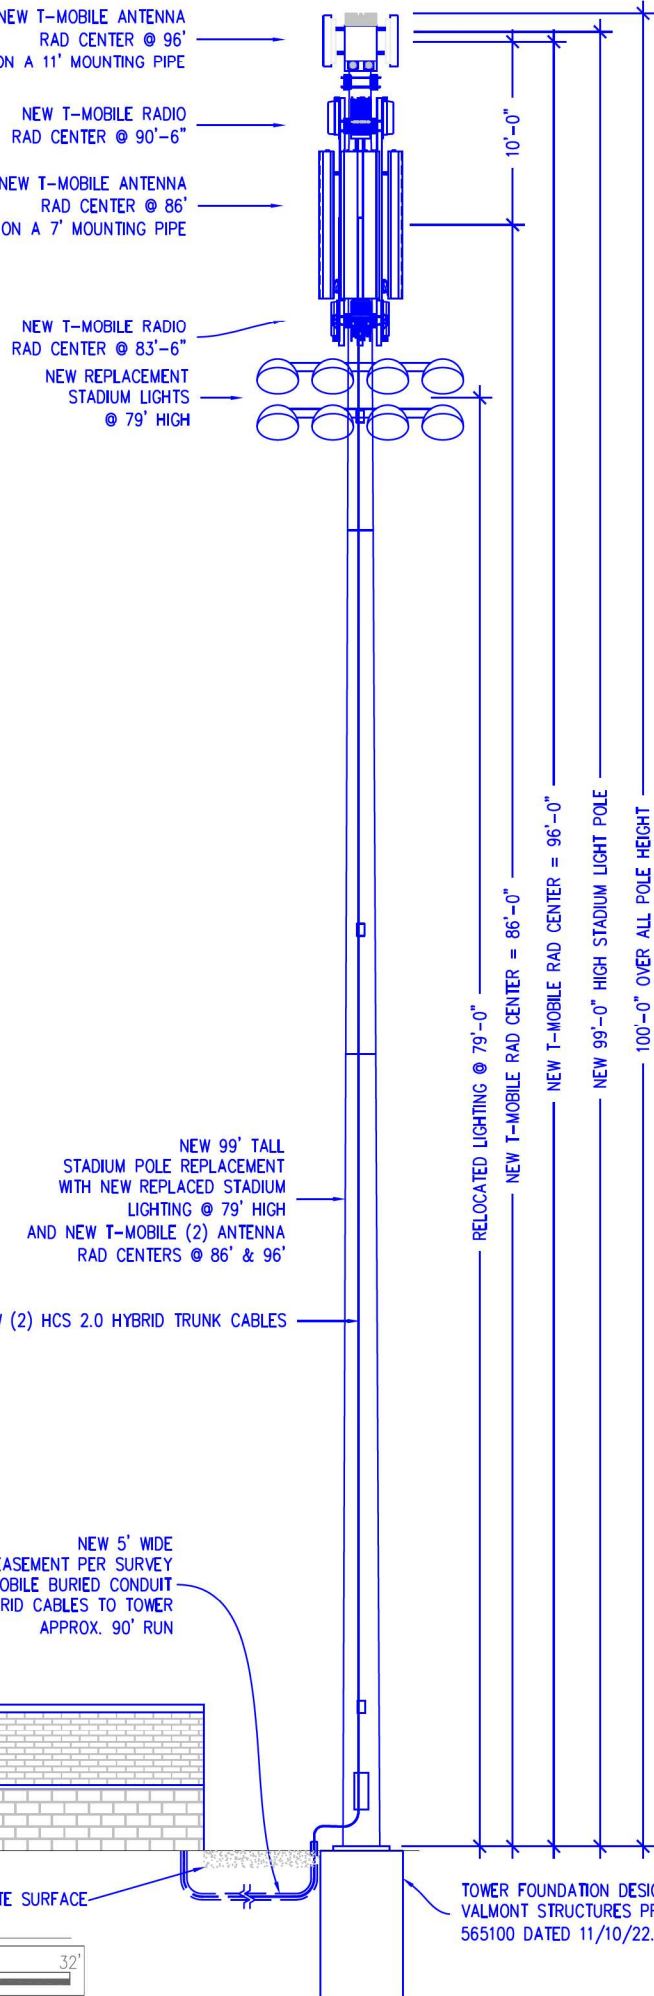

NOTE:  
NEW STADIUM LIGHTS NOT SHOWN FOR CLARITY

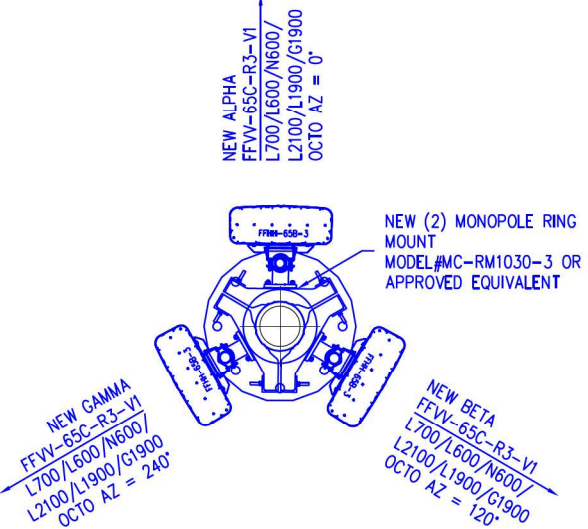


2 ANTENNA LAYOUT @ 86' RAD CENTER

FOR 24" X 36" PLOT - 1/2" = 1' 0 1' 2' 4'

FOR 11" X 17" PLOT - 1/4" = 1' 0 1' 2' 4'

NOTE:  
NEW STADIUM LIGHTS NOT SHOWN FOR CLARITY

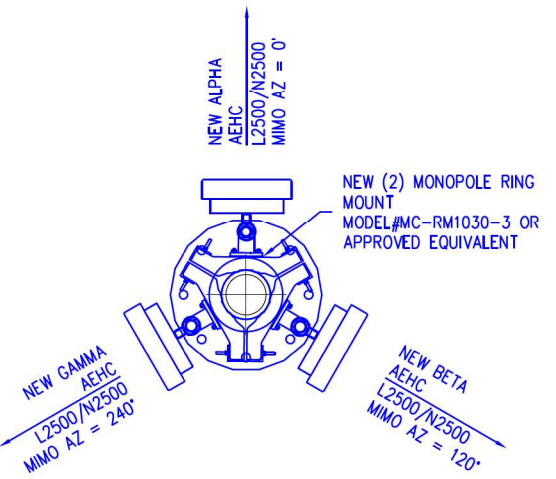


3 ANTENNA LAYOUT @ 96' RAD CENTER


FOR 24" X 36" PLOT - 1/2" = 1' 0 1' 2' 4'

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NOTE:  
NEW STADIUM LIGHTS NOT SHOWN FOR CLARITY

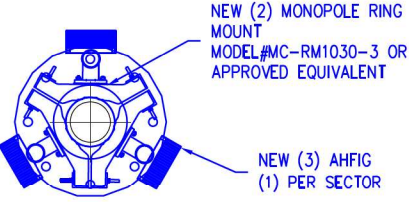


4 AHGIF RADIO LAYOUT

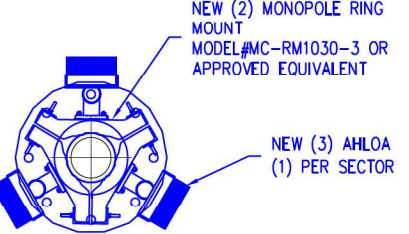

NOTE:  
NEW STADIUM LIGHTS NOT SHOWN FOR CLARITY

5 AHLOA RADIO LAYOUT

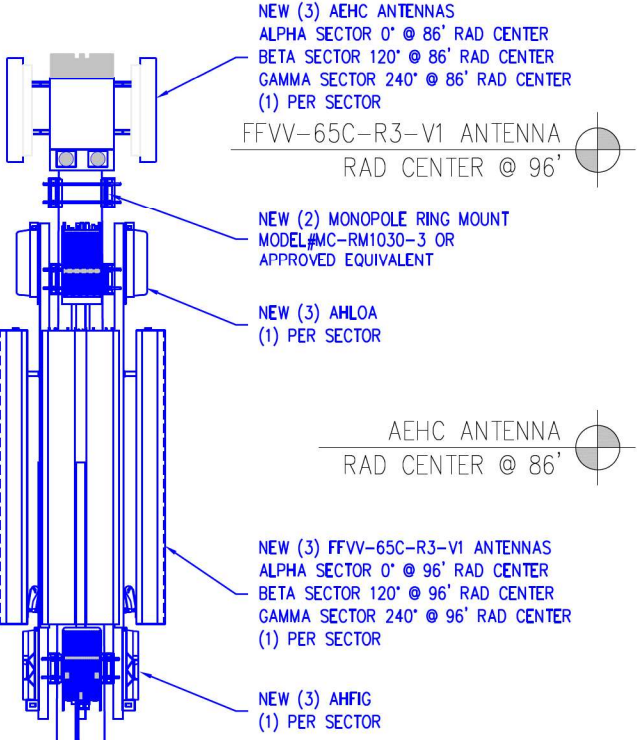

6 ANTENNA MOUNTING DETAIL



Exhibit C

T-Mobile  
DUKE BRIDGES CAMPUS  
7668 WARREN PARKWAY  
FRISCO, TX 75034  
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(STADIUM AND NATATORIUM)  
1240 W FRONTIER PKWY  
PROSPER, TX 75078  
COLLIN COUNTY

SHEET TITLE  
ELEVATION &  
ANTENNA LAYOUT

SHEET NUMBER  
C-3



1. EXISTING CONDITIONS WILL BE CHECKED AND VERIFIED IN FIELD BY THE CONTRACTOR PRIOR TO FABRICATION AND INSTALLATION. IF SIGNIFICANT DEVIATIONS OR DETERIORATION ARE ENCOUNTERED AT THE TIME OF CONSTRUCTION, A REPAIR PERMIT WILL BE OBTAINED AND CONTRACTOR SHALL NOTIFY STRUCTURAL ENGINEER IMMEDIATELY.

3. DO NOT SCALE DRAWINGS.

4"

8"

1'-4"


CONTRACTOR TO USE  
BRICK & STONE FACADE

CMU BRICK

#5 BARS @ 16" SPACING  
REFER TO DETAIL

GROUT-FILLED CMU ALL CELLS  
WITH VERTICAL REBAR  
(SEE DETAIL 1 FOR GROUT LOCATION)

SCALE : 1/2"=1'-0"

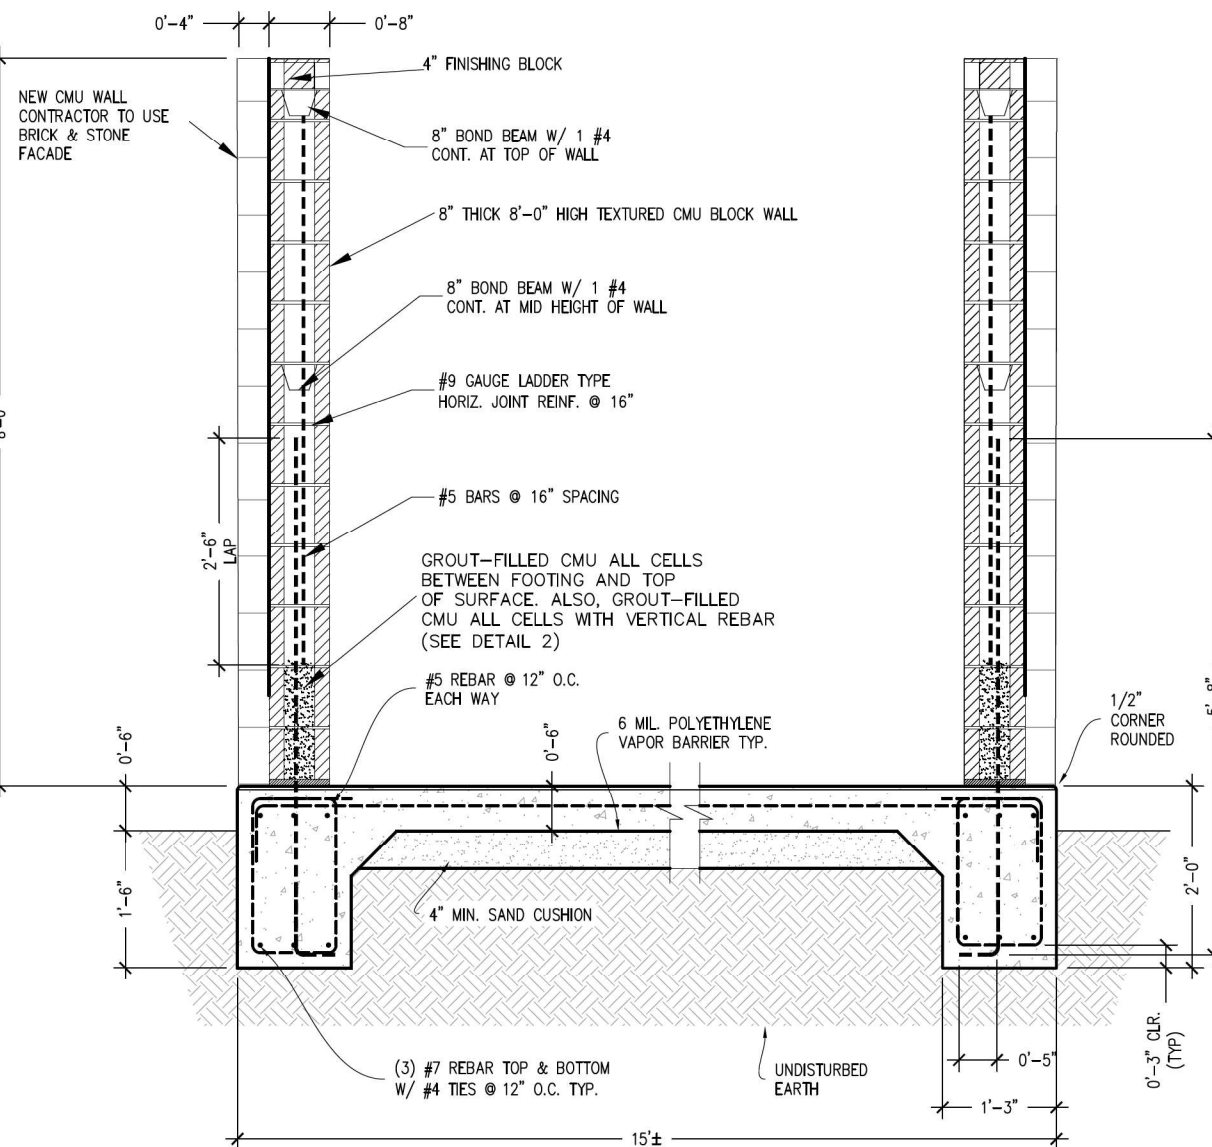

1 CMC WALL  
SCALE : 1/2"=1'-0"

SCALE : 1"=1'-0"

 **ALLPRO**  
CONSULTING GROUP, INC.

9221 Lyndon B Johnson Fwy  
Suite 204, Dallas, TX 75243  
Phone: 972-231-8893  
Fax: 866-364-8375  
[www.allprocgl.com](http://www.allprocgl.com)  
registration no. 8242




**S-2**

Exhibit C



- NOTES:
1. EXISTING CONDITIONS WILL BE CHECKED AND VERIFIED IN FIELD BY THE CONTRACTOR PRIOR TO FABRICATION AND INSTALLATION. IF SIGNIFICANT DEVIATIONS OR DETERIORATION ARE ENCOUNTERED AT THE TIME OF CONSTRUCTION, A REPAIR PERMIT WILL BE OBTAINED AND CONTRACTOR SHALL NOTIFY STRUCTURAL ENGINEER IMMEDIATELY.
  2. "ALLPRO CONSULTING GROUP, INC." WAS NOT PROVIDED WITH A GEOTECHNICAL REPORT. FOUNDATIONS ARE DESIGNED FOR A MINIMUM NET ALLOWABLE BEARING CAPACITY OF 1500 PSF. IT IS RECOMMENDED THAT A GEOTECHNICAL INVESTIGATION BE COMPLETED PRIOR TO CONSTRUCTION.
  3. DO NOT SCALE DRAWINGS.

1. ALL INSTALLATIONS SHALL BE IN COMPLIANCE WITH ANSI/ ASSE 10.48 AND ANY OTHER SAFETY STANDARDS.
2. GENERAL CONTRACTOR TO VERIFY WITH GENERATOR MANUFACTURER FOR FIT PRIOR TO POURING CONCRETE AND INSTALLATION.
3. GENERATOR DESIGN AND DRAWINGS BY OTHERS

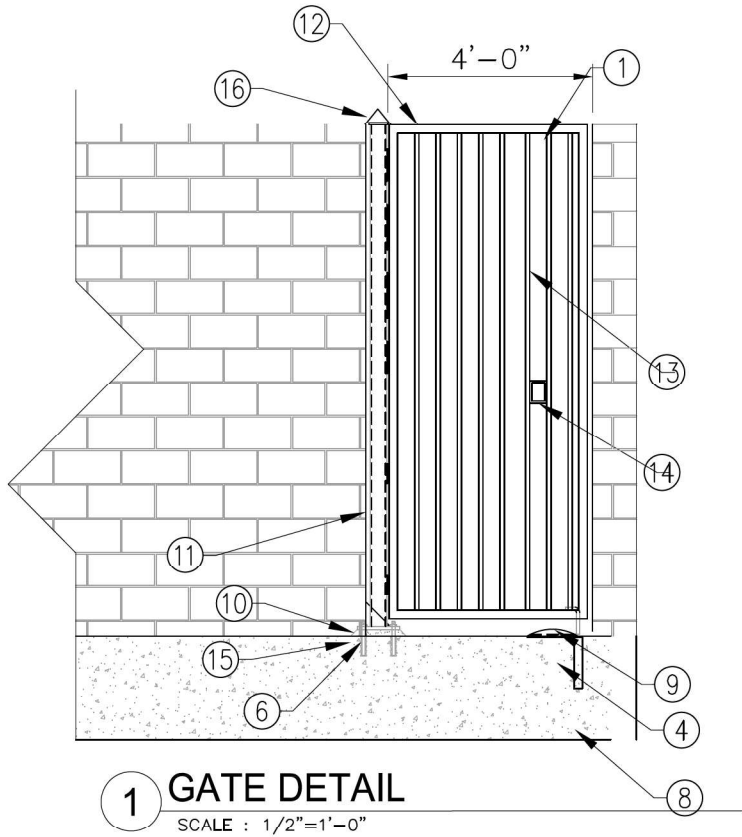


REFERENCE NOTES:

1. MANUFACTURER TO PROVIDE RUST INHIBITIVE PAINT OR GALVANIZATION
2. EXISTING SITE MATERIAL.
3. WELD ON HEAVY DUTY HINGE (4) PER LENGTH OF TUBE WITH FINISH TO MATCH FRAME.
4. (1) GATE STOP
5. HSS4x4x3/8 FINISH TO MATCH GATE FRAME. WELDED TO BASEPLATE W/ 3/16" WELD ALL AROUND.
6. 3/4" BASEPLATE W/ (4) 3/4" DIAMETER BOLTS EMBEDDED 4 1/2" INTO FOUNDATION W/ HILTI HY200 ADHESIVE ANCHOR. 1 1/2" 5000 PSI NON SHRINK GROUT BELOW.
7. 1/2" CAP PLATE. WELD TO TOP OF POST W/ 3/16" WELD ALL AROUND.
8. GATE STOP SUPPORT 12" DIAMETER BY 2'-0" DEEP 3000 PSI CONCRETE W/ MUSHROOM GATE STOP EMBEDDED ON TOP OF CONCRETE.
9. REMOVABLE 1/2" DIAMETER BENT BAR WITH CASING EMBEDDED IN GATE STOP CONCRETE.
10. BASE BLOCK TRIMMED AROUND BASE AND GROUTED FROM TOP W/ 5000 PSI NON SHRINK GROUT OVER BASEPLATE.
11. LAST TWO CELLS FULLY GROUTED. ONE CELL AWAY FROM END TO BE FULLY GROUTED W/ (2) #5 BARS.
12. 2 SQ. IN. STEEL FRAME ALL AROUND.
13. 1 SQ. IN. STEEL PICKETS @ 4" O.C.
14. KNOX BOX
15. 13" TALL BY 12" CONCRETE VERTICAL EXTENSION FROM FOOTING FOR STEEL GATE BASE PLATE ANCHOR

FOUNDATION NOTES:

1. COMPRESSIVE STRENGTH OF CONCRETE SHALL BE 4000-PSI AT 28-DAY CURE, AND SHALL MEET SPECIFICATION FOR READY-MIXED CONCRETE (ASTM C94-96). CONCRETE SHALL BE PLACED AND CURED AS PER ACI-318 "BUILDING CODE REQUIREMENTS FOR REINFORCED CONCRETE".
2. CONCRETE SLUMP SHALL RANGE BETWEEN 4 INCHES TO 6 INCHES.
3. ALL CONCRETE WORK SHALL CONFORM TO ACI 318 BUILDING CODE REQUIREMENTS FOR REINFORCED CONCRETE.
4. THE SURFACE, OVER WHICH THE CONCRETE WILL BE POURED, SHALL BE CLEAN OF LOOSE MATERIAL AND LEVELED PRIOR TO CONCRETE PLACEMENT.
5. CONCRETE SHALL BE PLACED IN A MANNER THAT WILL PREVENT SEGREGATION OF CONCRETE MATERIALS AND OTHER OCCURRENCES THAT MAY DECREASE THE STRENGTH OR DURABILITY OF THE FOUNDATION.
6. MECHANICALLY VIBRATE CONCRETE, PARTICULARLY WHEN POURED IN DIFFERENT LIFTS, TO ENSURE CONSOLIDATION AND TO AVOID JOINTS.
7. ALL REINFORCING STEEL BARS SHALL BE DOMESTIC, NEW BILLET STEEL, ASTM A-615, GRADE 60. REINFORCING SHALL BE DETAILED AND FABRICATED IN ACCORDANCE WITH ACI 315-LATEST EDITION - "MANUAL OF STANDARD FOR DETAILING REINFORCED CONCRETE".
8. ALL LOAD BEARING FOOTING SHALL BEAR ON TOP OF COMPACTED SOIL
9. WELDING OF REINFORCING BARS AND DOWEL BARS IS PROHIBITED UNLESS OTHERWISE APPROVED BY ENGINEER.
10. PRIOR TO THE EXCAVATION, CHECK AREA FOR LOCATION OF UNDERGROUND PIPES, CABLES, ETC.
11. ALLOWABLE SOIL BEARING PRESSURE SHALL BE 1500 PSF MINIMUM. IF DIFFERENT, PLEASE NOTIFY ALLPRO CONSULTING GROUP, INC FOR A REDESIGN.
12. SOIL DATA AS PER PRESUMPTIVE SOIL PARAMETERS FROM IBC 2015 CODE, TABLE 1806.2.

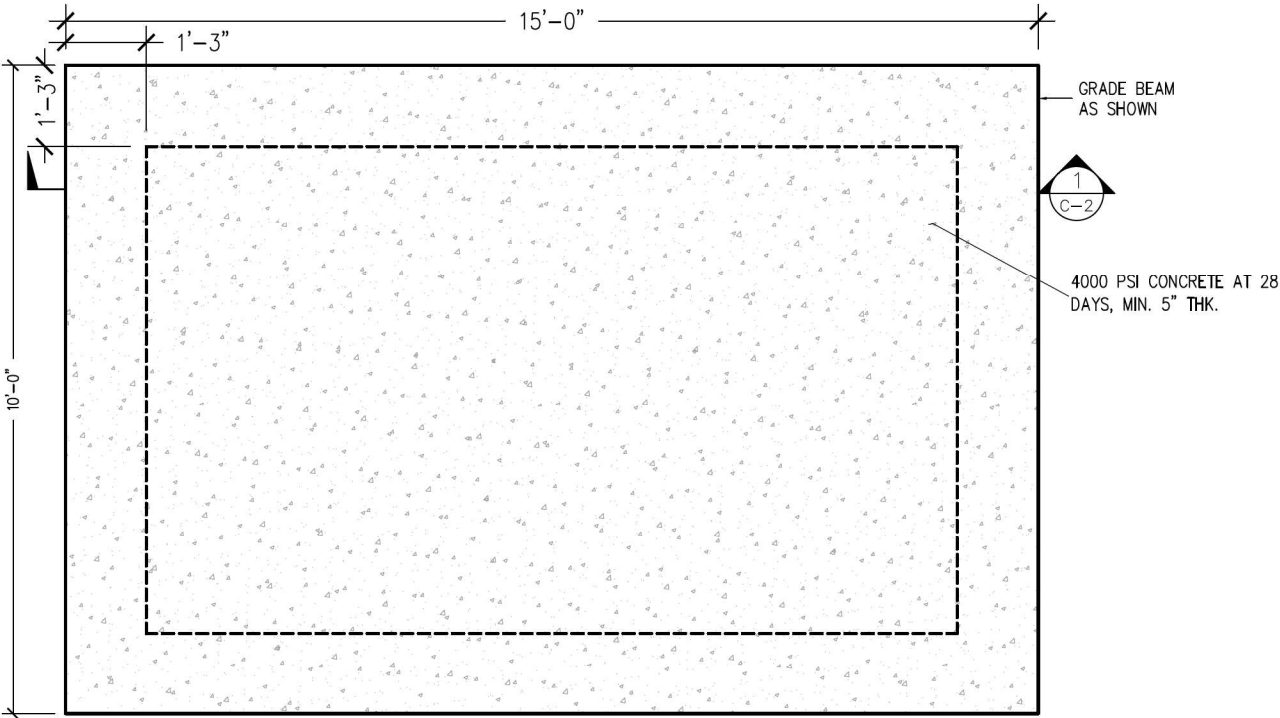

2

CONCRETE FOUNDATION PLAN VIEW

SCALE : 1/2"=1'-0"

Exhibit C

**T-Mobile**  
DUKE BRIDGES CAMPUS  
7668 WARREN PARKWAY  
FRISCO, TX 75034  
OFFICE: (972) 464-3510

ACGI NO: 22-4294

DRAWN BY: SP

CHECKED BY: SZ

012/19/22 CMU WALL DESIGN

**ALLPRO**  
CONSULTING GROUP, INC.  
9221 Lyndon B Johnson Fwy  
Suite 204, Dallas, TX 75243  
Phone: 972-231-8893  
Fax: 866-364-8375  
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registration no. 8242



12/19/22

SITE ID:  
DA0931D  
SITE NAME:  
PISD SPORT  
COMPLEX

1240 FRONTIER PKWY PARK RD,  
PROSPER, TX 75078  
COLLIN COUNTY

SHEET TITLE

PAD DETAILS

SHEET NUMBER

**S-3**



MASONRY

1. MASONRY STRENGTH

A. HOLLOW CONCRETE MASONRY UNITS: GRADE N, LIGHTWEIGHT WITH A COMPRESSIVE STRENGTH OF F = 1500 PSI ON THE NET AREA.

B. GROUT: 2000 PSI, MINIMUM 28 DAY COMPRESSIVE STRENGTH. VIBRATE GROUT IMMEDIATELY AFTER POURING AND AGAIN AFTER 5 MINUTES. GROUT SHALL CONFORM TO TO ASTM C476 AND UBC 2103. MIX GROUT FOR AT LEAST FIVE MINUTES AND UNTIL MIX HAS BEEN ATTAINED. GROUT SHALL HAVE SUFFICIENT WATER ADDED TO PRODUCE A CONSISTENCY FOR POURING WITHOUT SEGREGATION USE GROUT WITHIN 1.5 HOURS OF ADDITION OF MIXING WATER.

C. MORTAR: CEMENT-LIME TYPES, 1800 PSI MINIMUM 28 DAY COMPRESSIVE STRENGTH. CONFORM TO UBC 2103.

D. 4,000 PSI STRENGTH CONCRETE AT 28 DAY 3” TO 5” SLUMP.

LAY UNITS IN RUNNING BOND. CORNERS SHALL HAVE A STANDARD BOND BY OVER- LAPPING UNITS.

MAXIMUM GROUT LIFT WITHOUT CLEAN-OUTS SHALL BE 4’-0”.

TIE VERTICAL REINFORCING AT EACH END OF BAR AND AT 4’-0” MAXIMUM VERTICAL SPACING USING SINGLE WIRE LOOP TYPE TIES AS MANUFACTURED BY A.A. WIRE PRODUCTS COMPANY OR APPROVED ALTERNATE.

SEE ARCHITECTURAL DRAWINGS FOR LOCATIONS OF EXPANSION AND CONTROL JOINTS.

GROUT SOLID ALL WALLS IN CONTACT WITH EARTH, RETAINING WALLS, STEM WALLS, AND AS NOTED ON DRAWINGS.

GROUTED MASONRY SHALL BE CONSTRUCTED IN SUCH A MANNER THAT ALL ELEMENTS OF THE MASONRY ACT TOGETHER AS A STRUCTURAL ELEMENT.

8. PRIOR TO GROUTING, THE CROUT SPACE SHALL BE CLEAN SO THAT ALL SPACES TO BE FILLED WITH GROUT DO NOT CONTAIN MORTAR PROJECTIONS GREATER THAN 1/2 INCH, MORTAR DROPPINGS OR OTHER FOREIGN MATERIAL. GROUT SHALL BE PLACED SO THAT ALL SPACES DESIGNATED TO BE GROUTED SHALL BE FILLED WITH GROUT AND THE GROUT SHALL BE CONFINED TO THOSE SPECIFIC SPACES.

9. GROUT MATERIALS AND WATER CONTENT SHALL BE CONTROLLED TO PROVIDE ADEQUATE FLUIDITY FOR PLACEMENT, WITHOUT SEGREGATION OF THE CONSTITUENTS, AND SHALL BE MIXED THOROUGHLY.

10. THE GROUTING OF ANY SECTION OF WALL SHALL BE COMPLETED IN ONE DAY WITH NO INTERRUPTIONS GREATER THAN ONE HOUR.

12. BETWEEN GROUT POURS, A HORIZONTAL CONSTRUCTION JOINT SHALL BE FORMED BY STOPPING ALL C.M.U. AT THE SAME ELEVATION AND WITH THE GROUT STOPPING A MORTAR DROPPINGS OR OTHER FOREIGN MATERIAL. GROUT SHALL BE PLACED SO THAT WHERE BOND BEAMS OCCUR, THE GROUT POUR SHALL BE STOPPED A MINIMUM OF 1/2 INCH BELOW THE TOP OF THE MASONRY.

13. SEGREGATION OF GROUT MATERIALS AND DAMAGE TO THE MASONRY SHALL BE AVOIDED DURING THE GROUTING PROCESS.

14. GROUT SHALL BE CONSOLIDATED BY MECHANICAL VIBRATION DURING PLACEMENT BEFORE LOSS OF PLASTICITY IN A MANNER TO FILL THE GROUT SPACE. GROUT POURS GREATER THAN 12 INCHES IN HEIGHT WILL BE RECONSOLIDATED BY MECHANICAL VIBRATION TO WHERE BOND BEAMS OCCUR, THE GROUT POUR SHALL BE STOPPED A MINIMUM OF 1/2 MECHANICALLY VIBRATED OR PUDDLED AND RODDED WITH SMOOTH BAR.

15. GROUT SHALL NOT BE HANDLED NOR PUMPED UTILIZING ALUMINUM EQUIPMENT UNLESS IT CAN BE DEMONSTRATED WITH THE MATERIAL AND EQUIPMENT TO BE USED THAT THERE WILL BE NO DELETERIOUS EFFECT ON THE STRENGTH OF THE GROUT.

16. PLACE #4 VERTICAL REINFORCEMENT @ EACH CORNER AND @ EACH SIDE OF AN OPENING

T-Mobile

DUKE BRIDGES CAMPUS  
7668 WARREN PARKWAY  
FRISCO, TX 75034  
OFFICE: (972) 464-3510


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
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012/19/22

CMU WALL DESIGN

ALLPRO  
CONSULTING GROUP, INC.  
9221 Lyndon B Johnson Fwy  
Suite 204, Dallas, TX 75243  
Phone: 972-231-8893  
Fax: 866-364-8375  
www.allproci.com  
registration no. 8242



STATE OF TEXAS  
SHIQIANG ZHANG  
137482  
LICENSED  
PROFESSIONAL ENGINEER

12/19/22

SITE ID:  
DA0931D  
SITE NAME:  
PISD SPORT  
COMPLEX

1240 FRONTIER PKWY PARK RD,  
PROSPER, TX 75078  
COLLIN COUNTY

SHEET TITLE

MASONRY NOTES

SHEET NUMBER

S- 4