CITY OF PORT LAVACA

COUNCIL MI	EETING: DECEMBER 12, 2022	AGENDA ITEM
DATE:	12.07.2022	
TO:	HONORABLE MAYOR AND CITY COUNCIL MEMI	3ERS
FROM:	JODY WEAVER, INTERIM CITY MANAGER	
SUBJECT:	Animal Shelter renovations	

BACKGROUND:

As you recall in November, we were considering a Job Order Contract with Brown & Root to renovate and make various required improvements to the Animal Shelter. The cost for the proposed scope of work was \$440,142.00.

Taking into account discussions during the Council meeting, we asked Brown & Root to revisit the project design and remove the roll up doors in the CMU walls and install louvers in their place. With this design, the CMU block is reduced from 12" to 8" and all the new steel work needed to bird proof the building is removed since the building would now be fully enclosed. The revised cost is \$306,672.00.

The State did come inspect the shelter a couple weeks ago and held off on taking any action against the shelter since this project was projected to begin after the first of the year. We are to notify the inspector once the work begins so he can come inspect and verify that the work is in fact underway.

FINANCIAL IMPACT:

We have budgeted \$250,197.00, so we would now need \$56,475 from general fund reserves.

RECOMMENDATION: It is staff's recommendation to award Buy Board contract #581-19 to Brown & Root for the Base Bid amount of \$306,672.00.

ATTACHMENTS:

- Brown & Root's proposal dated 12.7.2022
- Red-lined renovation plans

December 7, 2022



Brown & Root

Susan Lang Finance Director City of Port Lavaca Port Lavaca, TX77979

Subject: B&R RFP-353-008 – Revision 1 Project Location: Port Lavaca Animal Control Center Project Title: Renovations and Conversion of Kennel from Open Air to Enclosed Facility

Dear Ms. Lang

Enclosed is our firm fixed Pre-Priced proposal for the above subject RFP.

Work to be performed under the terms and conditions of BuyBoard Contract 581-19. Pricing is based on 2022 RS Means Line-item values with CCI and contract Coefficient multipliers per the contract. Any additional items of work requested by the City, not included in this scope, will be handled as a change order.

Base Bid – Renovation of the building and constructing new walls to enclose the structure \$ 306,672.00

The work will take 120 calendar days to complete from NTP.

NOTE: Mobilization and work activities will start once required materials are received and fabrications performed to minimize disruption and down time to the facility. The work will require 9 weeks to complete once materials are received and fabrication is complete, based on good weather. The proposal is valid for 30 days.

Please direct any questions to Dan Croasmun at (832) 503-6292.

Sincelelv

Daniel Croasmun Project General Manager

Attachments: Proposed Scope of Work UPB Line Item Take Off

Brown & Root Industrial Services, LLC Forged from the Past. Engineered for the Future. www.brownandroot.com

RE: Port Lavaca – Animal Control – Renovation – Revision 1 – Convert to Enclosed Facility

RFP NO: 1000353-008

Scope of work

Perform the renovations of the animal control building to convert it from open air to an enclosed facility as detailed below:

Expanded scope of work

- A&E Services:
 - Revise the Architectural drawings to reflect changes made to convert project design from open air to an enclosed facility based on the 11/28/22 marked up red line drawings.
 - Run calculations and revise the structural drawings to change new CMU walls from 12" x
 8" CMU block based on louvers being installed in lieu of original overhead doors.
 - Revise MEP's to be reflective and deleted scope items and to size the louvers going into the new CMU wall for ventilation of the kennels

• Masonry:

- Remove the 3-2'x2' hollow metal windows located on the exterior CMU walls of the office area. Remove the CMU block and saw cut joints as needed to create a full block infill repair without using any cut or segments of blocks. No partial block repairs will be allowed.
- Remove the 4'x4' exhaust fan located on the rear wall of the building. Remove the CMU block and saw cut joints as needed to create a full block infill repair without using any cut or segments of blocks. No partial block repairs will be allowed.
- Remove the 2'3" x 4' louver located on the exterior front wall. Remove the CMU block and saw cut joints as needed to create a full block infill repair without using any cut or segments of blocks. No partial block repairs will be allowed.
- Fill all holes from old and/or previous fasteners in the CMU walls with mortar and fill voids in the mortar along the tops of the wall where metal roof flashing intersects.
- Remove six of the existing hollow metal doors and frames at door locations 101A, 101B, 104, 105A, 106A, and 107. Replace the doors and frames with new 16 gauge knock down frames and 20 gauge hollow metal doors. Install new LCN door closures, zinc coated hinges with bearings and weather stripping and thresholds to match current hardware set up on each door. Reinstall the locksets from the old doors onto the new doors.
- Construct the new 8" CMU wall along with all associated wood bucks, angle iron connectors and metal flashing. Install 6-4'x5' louvers with ¼" galvanized wire screen in the new walls. Remove and reinstall down spouts due to new CMU wall construction. Install 2-new ped doors in new CMU wall with matching hardware and push button lockset. Construct new 8" CMU return wall on southwest corner in lieu of wood and siding wall.
- Fencing / Metals:

- Install new fence post, gate post, top rail, bottom rail, and chain link give gates on southwest corner as shown on sheet A1.0. Install new chain link meshing on repair area and 3 strands of barb wire. All materials to be galvanized and matching in size gauge and thickness.
- Install ¼" galvanized wire mesh on interior of the building's roof vent to prevent entry of birds and other vermin.
- Fabricate new frame for the existing cat quarantine door. Reinstall the door and new frame to the CMU wall using galvanized anchors.
- Remove the chain link walk gate along with a total of 16' of exiting fence next to the propone tank to allow for access to work site in rear of property. Once the work is complete on the rear of the property, replace the removed fence section and walk gate
- Demolish and remove the existing wooden fencing on northwest side of building.
- Demolish and the existing chain link fence, gates and woven 1" mesh that runs along the roof line of the kennels where the new CMU walls will be built
- Remove the existing anchors for the 40 kennel grates and install stainless steel anchors.
 Re-attach the grates.
- Relocate and modify the 20-guillotine door pull handles so that they do not interfere with the kennel doors

• Painting

- Remove flaking and peeling paint from CMU walls. Pressure wash all exterior CMU surfaces using Trisodium Phosphate and 3,000 psi pressure washer. All CMU mortar joints that are currently cracked are to be caulked with acrylic latex sealant once walls are cleaned
- Prep and paint all galvanized gutters, galvanized downspout, and galvanized fascia.
- Prime all new CMU and paint all exterior CMU wall surfaces. Where CMU wall infills occur, ensure interior side of wall is block filled and painted as well. Prep procedures and material usage per the paint manufacture, Sherwin Williams project procedure manual attached.
- Prep all kennel floors, CMU walls, and wire cages to receive new epoxy coating material.
 Preparation to include grinding, sanding, etching, stripping, and pressure washing the concrete, CMU and metal components to ensure proper epoxy adhesion. Follow all protocol by Sherwin Williams as to preparation of the materials and have Sherwin Williams perform site visit during perpetration to ensure proper guidelines are being followed. All epoxy coatings per Sherwin Williams Protocol and material specification, per the mill thicknesses they call out for
- Contact Lee Pullen (361)-484-4138, 1301 N. Virginia St, Port Lavaca TX. For specific material and protocol for new coatings and site visits during project to ensure proper compliance with Sherwin Williams procedures and protocols.

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- Electrical
 - o Remove, clean and reinstall the 9 existing ceiling mounted fans.
 - o Install 6-new 8' enclosed LED lights in the kennel and tie to existing lighting in the room.
- Concrete

- Clear area of all vegetation where the new CMU wall foundation is to be poured.
 Preform subgrade preparation and compaction per engineer's design. Drill piers as designed and pour spread footing per engineer's design drawings
- Level and grade off area around new CMU wall. Place Bermuda sod over disturbed grounds as needed.

BRIS General Clarifications:

- A red line set of as builts drawings, copies of all shop drawings and submittals, warranties, paint codes, MSDS sheets, a statement that no asbestos containing materials were used, Lien release and Consent of Surety will be submitted in the close out package upon completion.
- The price is accepted as a lump sum fixed firm price and this scope of work and the construction drawings become the controlling documents.
- Brown & Root will require complete access to the work during normal hours to perform operations.
- Unless otherwise identified by owner during preproposal discussions; no other contractors or vendors will be able to work in Brown & Root's work area(s) while our work is underway for safety reasons
- Any owner employees and/or contractors will be required to wear proper PPE in Brown & Root work areas.
- Pricing assumes normal working hours of 8:00 AM to 5:00 PM Monday Friday.
- Brown & Root pricing assumes continuous access to the "work" without interruption or any work stoppages for any reason. Direct costs incurred by the need for additional demobilization and remobilization or work stoppages will be handled as a change order.
- Payment and Performance Bonds are included in this proposal.
- Any required building & trade permits are included in this proposal.
- Owner will verify no hazardous material will be encountered by Brown & Root and provide UpToDate/most current ACM surveys.
- All work shall be in accordance with all OSHA Standards, applicable federal, state, and local codes, and regulations and good construction practices.
- Includes all materials, equipment, and labor to complete the above scope of work. Means and methods are best estimate at the time of this proposal, owned by Brown & Root and subject to change without price modifications except for unforeseen/hidden conditions.
- Brown & Root shall remove from site all spoils, equipment and materials during the project progress and after completion of this project.
- If owner takes possession of any part of the Work before final acceptance, the correction period shall continue for a period of one (1) year form date possession is taken.
- Approval of this proposal designates acceptance of the scope of work statement and line-item estimate which has been used only to develop a mutually agreed price. The price is accepted as a lump sum fixed firm price and the incorporated scope of work becomes the controlling document taking precedence over line-item estimate detail.

BRIS Exclusions

- Sales and/or use tax.
- Existing code violations are excluded.
- Handling or removal of any hazardous materials including, but not limited to Mold, Asbestos Containing Materials., Lead, PCB's, Chemicals and/or Contaminated Soils.

- No data/communications work is included in this proposal.
- Hidden or unforeseen conditions
- Any items of work or repairs beyond this scope of work
- Underground existing obstructions
- Warranty of or replacement of Owner supplied materials and equipment.
- Owner and/or 3rd party testing.

Drawings: November 28th red lined drawings of sheets A1.0, A2.0, A3.0, A4.0, E1.0, E1.1, E2.0, E3.0, ESP1.0, P1.0 and P2.0 by Swarts Architects dated 9/14/2022 **Specifications:** Sherwin Williams Product Submittal – Animal Shelter – Pages 1-86 - Dated August 17, 2022

Labor Rate Table	2022 RS Means Facilities Construction with O&P
Equipment Rate Table	2022 RS Means Equipment with O&P

Client	City of Port Lavaca
Project	Convert open air kennel to enclosed structure
Location	Animal Control Center
B&R RFP Number	RFP #008
Contractor	Brown & Root Industrial Services, LLC / On Call Construction
Date	12/7/2022

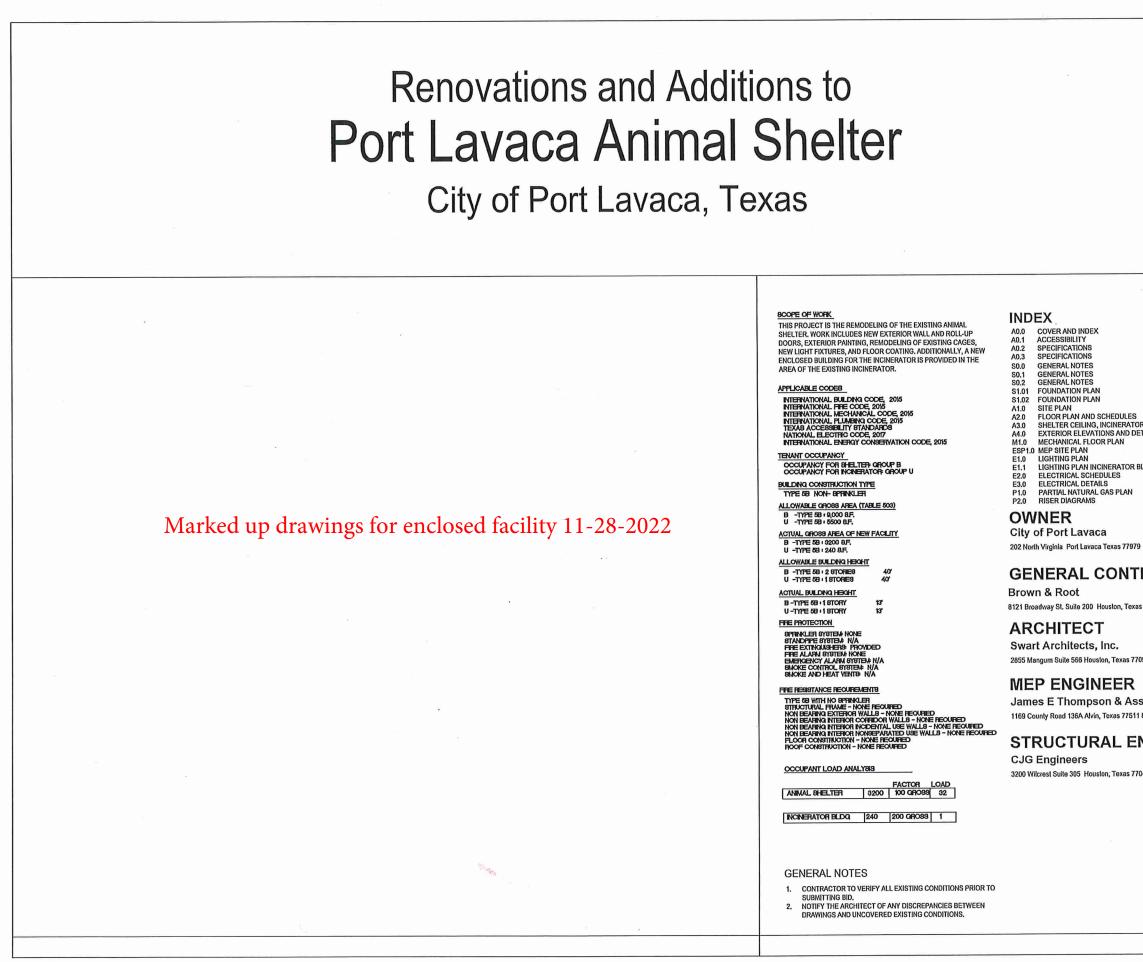
Master Format Code	Item Division Code Code	Item Description	Takeoff Qty Unit Loc	Labor Unit a Price	Labor Total	Mat Unit Price	Mat Total	Equip Unit Price	Grand Total	Equip Total	Subs Total	Other Total	User Total	Total w/CCI & Coef Applied
01 01113110	0100 01	General Conditions Architectural fees, for alteration work, to \$500,000, minimum	175,000.00 %Projec		18,801.42		3,851.40	1	49,654.54 12,862.50	11,461.71		15,540.02 12,862.50		33,919 8,786
01311390	redesign of A&E groups	to take design from open air to closed facility based on marked up drawings Performance Bond, for buildings, minimum	446,253.00 %Job						2,677.52			2,677.52		1,829
	bonding of project. Base	ed on raw number as coefficient is calculated deducted from number.										2,011.52		
01540950	PPE to prep kennel area	Respirator mask only, full face, silicone for coatings	4.00 EA			205.00	820.00		820.00					560
01540950 01540950	0050 01	Respirator cartridges, chemical vapor, 2 req'd per mask Respirator cartridges, combination vapor and dust, 2 req'd per mask	4.00 EA 16.00 EA			5.30 13.40	21.20 214.40		21.20 214.40					14 146
	PPE to prep kennel area	for coatings - 2 per day per mask for 2 days	4.00 pair											
01540950	0320 01 PPE to prep kennel area 0400 01	Over boots, neoprene for coatings				38.00	152.00		152.00					104
01540950	0400 01 PPE to prep kennel area		4.00 pair			119.00	476.00		476.00					325
01541650	0100 01 Equipment to move and	Forklift crew, all-terrain forklift, 45' lift, 35' reach, 9000 lb. capacity, weekly use	1.00 week	3,544.21	3,544.21			3,465.00	7,009.21	3,465.00				4,788
01542370	0090 01 scaffold items for new wa	Scaffolding, steel tubular, regular, labor only to erect & dismantle, building exterior, wall face, 6'-4" x 5' frames, 1 to 5 stories, excludes planks	20.00 Csf	268.51	5,370.18				5,370.18					3,668
01542370	0906 01 2850 01	Scaffolding, steel tubular, regular, rent/month only for complete system for face of walls, 6'-4" x 5' frames, excludes planks Scaffolding, steel tubular, regular, accessory, plank, rent/mo, 2" x 10" x 16' long	20.00 Csf 36.00 EA			83.00 10.05	1,660.00 361.80		1,660.00 361.80					1,134
01542370 01542370	5700 01	Scaffolding, planks, labor only to install & remove, 2"x10"x16', up to 50' high	36.00 EA	29.79	1,072.45	10.05	301.00	0.50	1,072.45					247 733
01543340	access high areas of wal		160.00 hour					3.59	574.40	574.40				392
01543340	0020C 01 access high areas of wal	Rent aerial lift, scissor type, to 20' high, 1200 lb. capacity, electric - Rent per week	6.00 week					375.56	2,253.36	2,253.36				1,539
01543340	0020E 01	Rent aerial lift, scissor type, to 20' high, 1200 lb. capacity, electric - Crew daily cost	30.00 days					103.86	3,115.80	3,115.80				2,128
01543650		Mobilization or demobilization, delivery charge for small equipment, placed in rear of, or towed by pickup truck	6.00 EA	177.60	1,065.60			49.50	1,362.60	297.00				931
01543650	mob and demob small ec 1200 01	uipment and crews for painters, electrician and metals portin of project Mobilization or demobilization, delivery charge for small equipment, placed in rear of, or towed by pickup truck	4.00 EA	177.60	710.40			49.50	908.40	198.00				621
	mob and demob small ec	uipment and crews for CMU and concrete work		693.08	1,386.17				÷					1,293
01543650	mob and demob aerial lif	Mobilization or demobilization, delivery charge for equipment, hauled on 20-ton capacity towed trailer	2.00 EA			L		253.00	1,892.17	506.00				
01543650	1400 01 mob and demob large eq	Mobilization or demobilization, delivery charge for equipment, hauled on 20-ton capacity towed trailer uipment for concrete and CMU work	4.00 EA	693.08	2,772.34			253.00	3,784.34	1,012.00		T		2,585
01712313	1200 01	Boundary & survey markers, crew for building layout, 3 person crew	1.00 days	2,313.03	2,313.03			40.15	2,353.18	40.15				1,607
01712319		Surveyor stakes, hardwood, 1" x 1" x 48" long	1.00 C			90.00	90.00		90.00					61
01931304	0120 01 prep CMU walls for paint	Caulking masonry, cutout and recaulk, polysulfide, excl. staging	100.00 LF	5.67	567.04	0.56	56.00		623.04					426
02 02411360	0700 02	Existing Conditions Fencing demolition, remove snow fence, 4' high	200.00 LF	1.88	8,338.40 375.31		6,358.00	0.36	15,069.73 447.91	373.33 72.60				10,294 306
	remove 2-layers of 1"me	sh wrapped on fence												
02411360	demo chain link fabric wi	Fencing demolition, remove chain link posts & fabric, 8' to 10' high nere wall installs	100.00 LF	4.19	419.46	I		0.81	500.86	81.40				342
02411362		Selective demolition, chain link fences & gates, gates, 10'-12' width t and remove fence in back for access to new work area	2.00 EA	116.69	233.38			22.55	278.48	45.10				190
02411362	1000 02	Selective demolition, chain link fences & gates, fence, posts, steel in concrete	7.00 EA	23.34	163.37			4.52	195.02	31.65				133
02411362	1000 02	t and remove fence in back for access to new work area Selective demolition, chain link fences & gates, fence, posts, steel in concrete	12.00 EA	23.34	280.06			4.52	334.31	54.25				228
02411362	remove fence posts at ne 1100 02	w wall Selective demolition, chain link fences & gates, fence, fabric & accessories, fabric, to 8' high	30.00 LF	2.33	70.02			0.45	83.55	13.53				57
02411362	repair fence fabric in from	t and remove fence in back for access to new work area Selective demolition, chain link fences & gates, fence, fabric & accessories, fence rails	30.00 LF	0.93	27.91			0.18	33.19	5.28				23
	repair fence rails in front	and remove fence in back for access to new work area												
02411362	remove fence top rail at r		100.00 LF	0.93	93.04			0.18	110.64	17.60				76
02411362	1500 02 remove wire along bottor	Selective demolition, chain link fences & gates, fence, fabric & accessories, reinforcing wire n of fence run	100.00 LF	0.38	37.85			0.08	45.55	7.70				31
02411368	0300 02 remove wood screen wal	Selective demolition, wood fences & gates, fence, to 8' high	52.00 LF	3.15	163.58				163.58					112
02411368	0400 02	Selective demolition, wood fences & gates, post in concrete	8.00 EA	23.20	185.57				185.57					127
02411919	0800 02	Selective demolition, rubbish handling, dumpster, 30 C.Y., 7 ton capacity, weekly rental, includes one dump per week, cost to be	8.00 week	<u> </u>		730.00	5,840.00		5,840.00					3,989
	dumpster on site for deb	added to demolition cost ris collection												
02411919	2040 02	Selective demolition, rubbish handling, 0'-100' haul, load, haul, dump and return, hand carried, cost to be added to demolition cost	55.00 CY	69.91	3,844.93				3,844.93					2,626
02411920		Selective demolition, dump charges, typical urban city, building construction materials, includes tipping fees only	7.00 ton	I I		74.00	518.00		518.00					354
02411927	disposal fee of construct 1090 02 torch old steel frames to	Selective demolition, torch cutting, steel, minimum labor/equipment charge	6.00 Job	407.32	2,443.91			7.37	2,488.13	44.22				1,700
02	1.2.1011 Old Older Hames 10				19 040 00		7 204 90		27 025 50	1 594 00				19,076
03111345	5000 03	Concrete C.I.P. concrete forms, footing, spread, plywood, 1 use, includes erecting, bracing, stripping and cleaning	250.00 sfca	8.98	18,949.69 2,244.20	3.13	7,391.89 782.50		27,925.58 3,026.70	1,584.00				2,068
03150512		rade/slab extension beams Chamfer strip, polyvinyl chloride, 3/4" wide with leg	105.00 LF	1.37	143.47	0.89	93.45		236.92	1				162
	strip set in forming for Cl	U brick pocket Tie wire, for reinforcing steel, 16 gauge, black annealed	100 0.00			167.00	167.00		167.00					
03150530	8600 03 tie wire for rebar		1.00 CWL				107.00		107.00					114
03211160	rebar and stirups for grad	Reinforcing steel, in place, slab on grade, #3 to #7, A615, grade 60, incl labor for accessories, excl material for accessories te beams	2,855.00 lb	0.72		0.73	2,084.15		4,137.40					2,826
03211160	1000 03 adder for under 10 tons of	Reinforcing steel, in place, under 10 ton job, #3 to #7, add	3,557.00 %	0.10	355.70	0.25	889.25		1,244.95					850
03211160		Reinforcing steel, unload and sort, add to base	3.00 ton	53.01	159.04			23.10	228.34	69.30				156
03211160	2400 03	Reinforcing steel, in place, dowels, deformed, 2' long, #3, A615, grade 60	69.00 EA	2.92	201.73	0.60	41.40		243.13					166
03211160	2615 03	existing foundation every 18" Dowel sleeve, plastic, 12" long for 5/8" smooth dowel, snap onto plastic base	18.00 EA	1.89	34.05	1.41	25.38		59.43					41
03211160	placing sleeeves onto do		70.00 EA	1.89			112.00		244.42					167
	caps placed on rebar sta	bbed out of the foundation for CMU wall		1.09	132.42									
03311335	0200 03 concrete for spread footi	Structural concrete, ready mix, heavyweight, 3500 psi, includes local aggregate, sand, Portland cement (Type I) and water, delivered, excludes all additives and treatments no and pier case	18.00 CY			161.00	2,898.00		2,898.00					1,980
03311335	1410 03	Structural concrete, ready mix, for mid-range water reducer, add	18.00 CY			4.27	76.86		76.86					53
03311335	concrete add mix 1430 03	Structural concrete, ready mix, for retarder, add	18.00 CY			5.10	91.80		91.80					63
03311370	9000 03	Structural concrete, placing, minimum equipment/labor charge, includes leveling (strike off) & consolidation	1.00 Job	1,777.19	1,777.19			30.80	1,807.99	30.80				1,235
03351330	placing concrete in sprea			957.97	957.97			- 0.00	957.97	50.00				654
00001000		dge once concrete is poured	1.00 JOD	991.97	301.91				951.91					004

Code 03354310 03821310 04 04012020	0210	Code	Description	Qty	Unit	Loca	Unit Price	Labor Total	Unit Price	Mat Total	Unit Price	Grand Total	Equip Total	Subs Total	Other Total	User Total	w/CCI & Coef Applied
04 04012020		03	Polished concrete floors, processing of interior floors, grinding and edging with diamond/metal matrix, 40-grit, includes wet grinding, wet vac pick-up, auto scrubbing between grit changes	3.00	Msf	Kenr wall enck door	1,558.94	4,676.81	37.50	112.50	289.30	5,657.21	867.90				3,864
04 04012020	grind floor of 0100		and walls as needed to receive new coatings Concrete core drilling, core, reinforced concrete slab, 1" diameter, up to 6" thick slab, includes bit cost, layout and set up time	80.00	EA		77.67	6,213.86	0.22	17.60	7.70	6,847.46	616.00				4,677
		r new kenne	grate anchoring and angle iron installation														
	0320		Masonry Pointing masonry, tuck, cut and re-point, hard mortar, common bond	114.00	SF		9.21	53,314.56 1,049.99	0.83	30,089.66 94.62		85,890.22 1,144.61	2,486.00				58,672 782
04012040	0050	04	Iean infill of CMU patches Sawing masonry, brick or block, by hand, per inch depth	34.00	LF		4.64	157.74	0.05	1.70	0.97	192.35	32.91				131
04012050	0720	04	brick patches Toothing masonry, blockwork, hard mortar	30.00	vlft		11.60	347.95				347.95					238
04012050		04	Toothing masonry, minimum labor/equipment charge	5.00	Job		144.58	722.91				722.91					494
04012052		04	Cleaning masonry, new construction, heavy construction dust, drips or stains, by chemical, brush and rinse, excludes scaffolding	1,100.00	SF		2.15	2,361.34	0.12	132.00		2,493.34					1,703
04012052		04	nstruction Cleaning masonry, sandblast, wet system, heavy soil, biological and mineral staining, paint, excludes scaffolding s, coiling and wire cages in kennels for new coating= 12,868 sq ft total surface	4,400.00	SF		3.58	15,745.46	0.76	3,344.00	0.48	21,219.06	2,129.60				14,495
04050510	0200	04	s, cerning and whe cages in kernings for new coaring-12,000 sq it total surface Selective demolition, masony, bond beam, 8° block with #4 bar gs for clean infill	14.00	LF		36.54	511.60				511.60					349
04050510	9000	04	Selective demolition, masonry, minimum labor/equipment charge s, 1-fan and 1-louver and 6-door frames to allow for proper full block infill and new frame installation	11.00	Job		289.16	3,180.81				3,180.81					2,173
04051330	2100 mortar for wa	04 all in fills	Mortar, portland cement and lime, 1:1/4:3 mix, type M	•	CF		4.04	16.15	14.35	57.40		73.55					50
04051330	2100 mortar for wa		Mortar, portland cement and lime, 1:1/4:3 mix, type M	976.00	CF		4.04	3,940.70	14.35	14,005.60		17,946.30					12,259
04051630	0350		Grout, concrete masonry unit (CMU) cores, 12" thick, 0.422 C.F./S.F., pumped, excludes blockwork	976.00	SF		4.02	3,925.21	2.24	2,186.24	0.24	6,347.64	236.19				4,336
04051630	grouting of b 0850	04	Grout, door frames, 6' x 7' opening, 3.5 C.F. per opening	6.00	Opng		57.23	343.36	18.60	111.60	3.39	475.29	20.33				325
04051630	2000	04	oor openings after old frame removed Grout, for bond beams, lintels and concrete masonry unit (CMU) cores, C476, includes material only	100.00	CF		7.34	734.40	5.30	530.00	0.44	1,308.40	44.00				894
04051630	bond beam a 9000	04	valls Grout, minimum labor/equipment charge	6.00	Job		354.00	2,124.00				2,124.00					1,451
04051926	grout new do	04	Masonry reinforcing bars, #3 and #4 reinforcing steel bars, placed vertically, ASTM A615	2,021.00	lb		2.02	4,078.94	0.73	1,475.33		5,554.27					3,794
04221010	2650	04	action to beam, bond beam and verticle ties Concrete block, hollow, normal weight, 3500 psi, 6" x 8" x 16", includes material only	1,211.00	EA				1.97	2,385.67		2,385.67					1,630
04221016	0130	04	blocks - material only - no labor or equipment in line item Concrete block, bond beam, normal weight, 2000 psi, 8" x 8" x 16", includes mortar, excludes scaffolding, horizontal reinforcing, vertical reinforcing and grout	112.00	LF		5.80	649.50	4.72	528.64		1,178.14					805
04221024	0200	04	of the new walls Concrete block, exterior, tooled joints both sides, normal weight, 2000 psi, 8° x 8° x 16°, includes mortar and horizontal joint reinforcing every other course, excludes scaffolding, grout and vertical reinforcing	1,077.00	SF		9.13	9,834.24	4.58	4,932.66		14,766.90					10,087
04221024	9000	04	Diock joints each side of walls Concrete block, exterior, minimum labor and equipment charge	5.00	Job		640.80	3,203.99				3,203.99					2,189
04221032	1700		ws, 1-fan and 1-louver Concrete block, lintel, 2000 psi, 8" x 16" x 12", includes mortar, grout and 2-#5 horizontal reinforcing bars, excludes scaffolding and vertical reinforcing	36.00	LF		10.73	386.28	8.45	304.20	0.64	713.44	22.97				487
	lintels at louv	ver openings															
05 05011051	6270		Metals Metal cleaning, steel surface treatment, 12.0 lb sand per S.F., near white blast, existing coat badly pitted, nodules (SSPC-SP10)	125.00	SF		17.47	29,616.45 2,183.45	2.14	6,065.90 267.50	2.28	38,415.88 2,735.57	2,733.53 284.63				26,242 1,869
05050510	prep metals 1 0030	05	Selective metals demolition, nuts, 7/8" to 1-1/4" diameter, remove nut only, excl shoring, bracing, cutting, loading, hauling, dumping	80.00	EA		3.32	265.39				265.39					181
05050510	2840	05	nnel floor grates for rehabilitation Selective metals demolition, demolish steel bar grating, excl shoring, bracing, outting, loading, hauling, dumping	160.00	SF		6.65	1,063.44			0.52	1,146.16	82.72				783
05051350	removal of th 5900	05	Paints and protective coatings, galvanizing structural steel in shop, under 1 ton, hot dip	1.00	ton				695.00	695.00		695.00				I	475
05051910	hot dip galva 1430	05	Chemical anchor, 3/4" diameter x 9-1/2" L, in concrete, brick or stone, incl layout, drilling, threaded rod & epoxy cartridge top of wall	50.00	EA		49.14	2,457.01	7.70	385.00	4.85	3,084.56	242.55				2,107
05051910	1435	05	Chemical anchor, 1" diameter x 11-3/4" L, in concrete, brick or stone, incl layout, drilling, threaded rod & epoxy cartridge r kennel grate rehab. 2 per kennel	80.00	EA		55.48	4,438.47	15.10	1,208.00	5.47	6,083.83	437.36		1		4,156
05051920	1100	05	Anchor, expansion shield, zinc, 3/4" dia x 3-15/16" L, double, in concrete, brick or stone, excl layout & drilling to wall and 3x3 angle	140.00	EA		11.04	1,545.91	6.45	903.00		2,448.91			1	1	1,673
05052110	9000	05	Cutting, steel, incl prep, torch cutting & grinding, excl staging, minimum labor/equipment charge ver openings	1.00	Job		407.32	407.32			7.37	414.69	7.37				283
05052115	1945	05	Difiling holes in steel for anchors, 1/2" diameter, incl bit & layout, excludes anchor, for each additional 1/4" depth, add to bolt it in to CMU wall and 3x3 angle	140.00	EA		2.77	387.77	0.08	11.20		398.97				I	273
05052190	0300	05	Welding structural steel in field, cost per welder, 1/8" dia, type 6011, incl 1 operating engineer e 3- days to replace bolts and hinge system on grates in 40 kennels to stinless steel hardware and reloacte guillotine door pulls	48.00	hour		190.63	9,150.18	6.40	307.20	20.24	10,428.90	971.52				7,124
05052387	0500	05 cleat to secu	Weld stud, 1/2" dia x 3-1/8" L	124.00	EA		1.57	194.49	0.83	102.92	0.56	366.97	69.56				251
05122340	0468 angle iron fra	05	Angle framing, structural steel, 1-1/2"x1-1/2"x3/16", field fabricated, incl cutting & welding	24.00	LF		24.06	577.36	1.77	42.48	1.62	658.65	38.81		1		450
05122340	0472	05	Angle framing, structural steel, 2-1/2"x2-1/2"x1/4", field fabricated, incl cutting & welding s along ends of new wall	40.00	LF		33.68	1,347.18	4.03	161.20	2.25	1,598.58	90.20				1,092
05122340	0476	05	Angle framing, structural steel, 3"x3"x3/8", field fabricated, incl cutting & welding of wall as called out on detail drawing	112.00	LF		42.50	4,760.03	7.05	789.60	2.85	5,868.72	319.09				4,009
05122365	2210 4" x 1/4" thic	05	Steel plate, 1/4" T, warehouse price, no shop fabrication, welded in place	112.00	SF		7.49	838.45	10.65	1,192.80	1.69	2,220.98	189.73				1,517
06 06111024	5000	06	Wood, Plastics, And Composites Wood framing, miscelaneous, nailers, treated, wood construction, 2" x 4"	90.00	LF		1.80	2,370.03 161.58	0.86	631.40 77.40		3,001.43 238.98					<mark>2,050</mark> 163
06111024	treated 2x4 fr 8100	06	Wood framing, miscellaneous, stair stringers, 2" x 12"		LF		11.04	2,208.45	2.77	554.00		2,762.45					1,887
07	2x12 presure	treated bloc	king on top of wall Thermal and Moisture Protection					2,927.24		1,055.40		3,982.64					2,721
07 07464610	0045		Thermal and Moisture Protection Fiber cement siding, lap siding, rough sawn texture, 5/16" thick x 8" wide, 6-3/4" exposure	160.00	SF		3.37	2,927.24 538.92	1.90	1,055.40 304.00		3,982.64 842.92					2,721 576
07611610	siding on ner 9000	07	Batten seam sheet metal roofing, minimum labor/equipment charge	2.00	Job		420.29	840.58				840.58					574
07651010	0100	07	e ridge for screen installation Sheet metal flashing, aluminum, flexible, mill finish, .032" thick, including up to 4 bends	150.00	SF		4.71	707.23	4.24	636.00		1,343.23				1	918
07712310	cap flashing 0400	07	Aluminum downspouts, enameled, 3" x 4", .024" thick	30.00	LF		6.01	180.26	2.90	87.00		267.26					183
07722310	9000	07	* downspouts Roof vents, minimum labor/equipment charge tall essens and re-attach it	2.00	Job		247.79	495.58				495.58				-	339
	0052	07	tall screen and re-attach it Pre-formed joint seals, backer rod, polyethylene, 1/2" dia rricle angle iron braces	40.00	LF		1.54	61.51	0.16	6.40		67.91				1	46

Master Format Code	Item Division Code Code	ltem Description	Takeoff Qty	Unit	Loca	Labor Unit Price	Labor Total	Mat Unit Price	Mat Total	Equip Unit Price	Grand Total	Equip Total	Subs Total	Other Total	User Total	Total w/CCI & Coef Applied
07921320	1800 07 sealing verticle angles to	Joint sealants, caulking and sealants, butyl based, bulk, 1/2" x 1/2", in place	40.00	LF		2.58	103.16	0.55	22.00		125.16					85
08	# #	Openinas					7,163.62		20,868.00		28,031.62					19,148
08011110	0012 08 removal of doors and fra	Door & window maintenance, remove weatherstripping, door or window	6.00	EA		15.89	95.33	1			95.33					65
08011110	0060 08	Door & window maintenance, remove lockset	12.00	EA		35.75	428.98				428.98					293
08011110	1140 08	d doors, save and then reinstall on 6 new doors Door & window maintenance, remove deadbolt	6.00	EA		51.64	309.82				309.82					212
08050510	removal of doors and fra	Door demolition, exterior door, single, 3' - 6" x 7' high, 1-3/4" thick, remove	6.00	FA		48.46	290.75				290.75					199
	removal of doors and fra	imes to be replaced						L							I	
08050510	removal of doors and fra	Door demolition, door frames, metal, remove		EA		89.77	538.61				538.61					368
08050520	1000 08 remove 3- hollow metal	Window demolition, steel, to 12 S.F., includes aluminum frame windows	3.00	EA		44.49	133.46				133.46					91
08121313	0100 08 new hollow metal frame:	Frames, steel, knock down, hollow metal, single, 16 ga., up to 5-3/4" deep, 3'-0" x 7'-0"	8.00	EA		89.77	718.14	175.00	1,400.00		2,118.14					1,447
08121313		Frames, steel, knock down, hollow metal, for welded frames, add	8.00	EA				124.00	992.00	1	992.00					678
08131325	0560 08	Doors, exterior, steel, commercial, flush, 20 ga., 1-3/4" x 7'-0" x 3'-0" wide	8.00	EA		102.48	819.83	560.00	4,480.00		5,299.83					3,620
08712030	8150 08	Door hardware, door closer, surface mounted, heavy duty, parallel arm, modern	8.00	EA	-	119.16	953.29	355.00	2,840.00		3,793.29					2,591
08712040	new ped door items 3800 08	Door hardware, cipher lockset, with key pad	2.00	EA		54.81	109.63	1,075.00	2,150.00		2,259.63					1,544
	lockset for 2- new ped d	oors going into new CMU wall				54.01	109.03									
08712090	1480 08 new ped door items	Door hardware, hinges, full mortise, high frequency, brass base, US10B, 4-1/2" x 4-1/2"	12.00	pair				126.00	1,512.00		1,512.00					1,033
08712510	2700 08 new ped door items	Weatherstripping, doors, metal frame, extruded sections, aluminum, for 3' x 7' door	8.00	Opng		238.32	1,906.57	33.50	268.00		2,174.57					1,485
08712510	3650 08	Weatherstripping, for thresholds, door sweep, flush mounted, aluminum	8.00	EA		28.60	228.79	22.00	176.00		404.79					277
08911910	new ped door items 3180 08	Wall louvers, aluminum, fixed blades, commercial grade, 60" x 48"	6.00	EA		105.07	630.43	1,175.00	7,050.00		7,680.43					5,247
	louvers on new CMU wa	Il for ventilation														
09 09019092	0510 00	Finishes	1 000 00	C T			05,125.49		22,270.28		127,395.77					87,024
	0510 09 protect ground and slab		1,000.00	SF		0.09	94.90				94.90					65
09019093	0080 09 prep new ped doors for	Surface preparation, exterior, doors, per side, wire brush, metal, flush, excl. frames or trim	336.00	SF		0.95	318.85				318.85					218
09019093	1320 09 clean kennel wire walls	Surface preparation, exterior, chain link fence, two sides, wire brush	2,880.00	SF		2.42	6,969.12				6,969.12					4,761
09019093	1400 09	Surface preparation, exterior, existing galvanized surface, prep for painting, clean and prime	3,344.00	SF		1.60	5,341.73	0.13	434.72		5,776.45					3,946
09911360	prep galvinized wire on 0800 09	kennels, metal flashing, steel columns and gutters for paint Paints & coatings, siding, exterior, alkyd (oil base), paint 2 coats, brushwork	1,230.00	SF		0.93	1,147.76	0.32	393.60		1,541.36					1,053
09911360	cut in primer and top co	at of paint on CMU walls Paints & coatings, siding, exterior, stucco, rough, oil base, paint 2 coats, roller	3,036.00	SE		0.74	2,256.80	0.34			3,289.04					2,247
	roll filler and top coats of	n CMU walls		JF												
09911370	paint 8 new door frames	Paints & coatings, exterior door frames & trim only, brushwork, primer + 2 coats, exterior latex at 17L' ea x 8 = 136'	136.00	LF		2.28	309.74	0.39	53.04		362.78					248
09911370	0190 09 paint 6 new metal door s	Paints & coatings, exterior doors, flush, both sides, roll & brush, primer + 2 coats, exterior latex, incl. frame & trim	8.00	EA		120.99	967.93	29.50	236.00		1,203.93					822
09911380	0220 09	Paints & coatings, trim, exterior, gutters, metal, zinc chromate paint, first coat, brushwork, 5"	192.00	LF		0.95	182.20	0.81	155.52		337.72					231
09911380	primer galv flashing, gut 0320 09	Paints & coatings, trim, exterior, gutters, wood, primer + 2 coats exterior latex, brushwork, 5"	192.00	LF		1.87	358.33	0.39	74.88		433.21					296
09911390	paint galv mertal fascia, 0500 09	gutter & downspouts Paints & coatings, walls, concrete masonry units (CMU), porous, first coat, latex, brushwork	924.00	SF		0.95	876.83	0.12	110.88		987.71					675
09911390	cut in base/block fill coa	t on both sides of CMU walls	462.00	SF		0.63	292.28	0.06	27.72		320.00					219
	cut in base/primer coat	Paints & coatings, walls, concrete masonry units (CMU), porous, second coat, latex, brushwork on CMU exterior side of walls														
09911390	0540 09 prime both sides of new	Paints & coatings, walls, concrete masonry units (CMU), porous, first coat, latex, roller CMU walls	1,044.00	SF		0.41	429.31	0.09	93.96		523.27					357
09911390	0550 09 paint exterior side of ne	Paints & coatings, walls, concrete masonry units (CMU), porous, second coat, latex, roller	522.00	SF		0.33	173.37	0.06	31.32		204.69					140
09965620	1900 09	Wall coating, high build epoxy, water based, 50 mil	12,868.00	SF		6.37	82,018.16	1.46	18,787.28		100,805.44					68,860
09965620	1900 09	CMU walls and kennel wire frame system - total 12,868 sq ft surface to coat Wall coating, high build epoxy, water based, 50 mil	522.00	SF		6.37	3,327.13	1.46	762.12		4,089.25					2,793
09971323	2-coats epoxy on kenne 6100 09	I side of new CMU wall Paints and protective coatings, cold galvanizing in field, brush	100.00	SF		0.61	61.07	0.77	77.00		138.07					94
	field prime any touch up															
23		Heating, Ventilating, and Air-Conditioning (HVAC)					6,956.80				6,956.80					4,752
23050510	2124 23	Fans, 1-1/2 thru 10 HP or 20,000 CFM, selective demolition	18.00	EA	Kenr wall	286.40	5,155.12				5,155.12					3,521
					enck door											
00050540		nnel area, clean them and then reinstall them. Material costs are removed. 9 fans x 2 useages =18	4.00			4 700 00	4 700 00				4 700 00					1.10
23050510	3000 23 Remove 4'x4' wall fan ur		1.00	ton		1,733.20	1,733.20			I	1,733.20					1,184
23050510	7450 23	Relief vent, up thru 24" x 96", selective demolition	1.00	EA	Kenr wall	68.49	68.49				68.49					47
					enclo door											
	remove louver on front	vall	I		3001		1				1	1	I	I		
26		Electrical					3,792.37		10,245.26		14,037.63					9,589
26050520	6510 26 disconnect the circulation	Equipment connection, to 15 to 30 HP, electrical demolition, remove	9.00	EA		45.32	407.88				407.88					279
26051935	0045 26	Wire connector, screw type, insulated, #12 to #6	27.00	EA		4.52	121.95	0.48	12.96		134.91					92
26051990	1200 26	Wire, copper, stranded, 600 volt, #12, type THWN-THHN, normal installation conditions in wireway, conduit, cable tray	3.00	Clf		73.74	221.22	35.00	105.00		326.22					223
26052920	0800 26	LED lights and piping in kennel area Strap, steel, 2 holes, EMT, 3/4" diameter	21.00	EA		1.84	38.71	0.23	4.83		43.54					30
26052920 26052920	1450 26 1950 26	Hanger, steel, 3/4" diameter, incl bolt Riser clamps, steel, conduit, 3/4" diameter	12.00	EA		4.29	51.43 271.00	0.58	6.96		58.39 342.40					40
26052920	2500 26	Threaded rod, steel, painted, 1/4" diameter	12.00	LF		3.13	37.61	1.56	18.72		56.33					234 38 11
26052920 26052920	3000 26 3250 26	Nuts, galvanized steel, 1/4" diameter Washers, galvanized steel, 1/4" diameter	1.00	C C				15.95 16.00	15.95 16.00		15.95 16.00					11
26052920 26052920	3775 26 5600 26	Metal channel, aluminum, 10' length, 12GA, 1-5/8" x 1-5/8" Beam clamp, large	1.00	EA		162.84 20.36	162.84 244.26	48.00 31.00	48.00 372.00		210.84 616.26					144
26052920 26053313	5900 26	Beam clamp, raterial only, 3/8" clamp, 3/8" threaded drop rod Electric metallic tubing (EMT), 3/4" diameter, to 10' high, incl 2 terminations, 2 field bend elbows, 11 beam clamps, and 11	12.00	EA		25.43	305.10 625.26	7.15	85.80		390.90					267
20000313	5020 26	couplings per 100 LF	100.00	LF		6.25		1.23	123.00		748.26					511
	5220 26	Electric metallic tubing (EMT), field bends, 45 Deg. to 90 Deg., 3/4" diameter EMT offsets, 3/4" diameter, to 15' H	10.00	EA EA		10.14 13.13	101.39 131.35				101.39 131.35					69 90 46
26053313 26053313	5340 26															
26053313 26053313 26053313 26053313	5340 26 6520 26 8320 26	EMT boxes connectors, set screw, steel, 3/4" diameter, to 15' H EMT boxes connectors, set screw, steel, 3/4" diameter, to 15' H	8.00	EA		7.39	59.12 20.83	0.96	7.68 2.40		66.80 23.23					46

Master Format Code	Item Division Code Code	Item Description	Takeoff Qty	Unit Loc	Labor Unit Price	Labor Total	Mat Unit Price	Mat Total	Equip Unit Price	Grand Total	Equip Total	Subs Total	Other Total	User w/0 Total	Total CCI & Coef Applied
		•	8.00	EA	15.36		1.57	12.56							93
26053316 26562355	0450 26 0300 26	Outlet boxes, pressed steel, covers, blank, 4-11/16" square Exterior LED fixture, modular, type IV, 120 V, 50 watt, incl lamps	6.00	EA	90.64	122.90 543.83	1,550.00	9,300.00		135.46 9,843.83					6,724
31		Earthwork				18.660.71		12,274.35		35.675.59	4.740.53				24 370
31066015	0520 31	Mobilization, to 36", set up and remove drill rig, for caissons, maximum	1.00	EA	7,589.22	7,589.22		12,214.00	1,732.50	9,321.72	1,732.50				24,370 6,368
01001000	set up for pier drilling		1.00	EA 1	077.00	077.00				077.00					
31221320	0100 31 final hand grade beams	Rough grading sites, 400 S.F. or less, hand labor	1.00	EA	877.08	877.08				877.08	I				599
31221320	0130 31	Rough grading sites, 1,100-3,000 S.F., skid steer & labor	1.00	EA	1,245.77	1,245.77			192.50	1,438.27	192.50				982
01001010	rough grade after piers a	and beam poured with backhoe	1.00	Lab Kan	000.40	000.40				000.40					100
31221610	9000 31	Fine grading, hand grading, includes compaction, minimum labor/equipment charge	1.00	Job Keni wall encli door	289.16	289.16				289.16					198
24224640	hand grading once area 9100 31	is graded with equipment	1.00	lab	667.77	667.77			400.50	1,091.27	423.50				745
31221610		Fine grading, machine grading, includes compaction, minimum labor/equipment charge s with bobcat after pouring concrete	1.00	Job	007.77	007.77			423.50	1,091.27	423.50				745
31231616	0100 31	Structural excavation for minor structures, bank measure, heavy soil or clay, pits to 6' deep, by hand	18.00	B.C.Y.	144.58	2,602.48				2,602.48					1,778
24020242	excavation of grade bea 0100 31	ms	1.00	L.C.Y.	50.42	200 72				209.72					142
31232313	back fill after beams pou	Backfill, heavy soil, by hand, no compaction	4.00	L.U.T.	52.43	209.72				209.72					143
31232313	0300 31	Backfill, 6" layers, compaction in layers, hand tamp, add	4.00		28.12	112.49				112.49					77
31232315	1840 31	Borrow, delivery charge, minimum 20 tons, 2 hour round trip, add	60.00	ton Ken wall encl door	10.44	626.36			12.98	1,405.16	778.80				960
01000015	haul off spoils from site		01.00	DOX	4.00	50.04	00.50	005 50	4.00	700.00	50.40				500
31232315	7000 31 load spoils excavated for	Borrow, topsoil or loam, 1 C.Y. bucket, loading and/or spreading, from stockpile, shovel or foundation, on to dump truck for removal	31.00	D.U.Y.	1.63	50.64	20.50	635.50	1.62	736.26	50.13				503
31232317 31232323	0100 31	Fill, dumped material, spread, by hand, excludes compaction	4.00	L.C.Y.	48.46	193.84				193.84					132 99
31232323	9900 31 compaction of area exca	Compaction, minimum labor/equipment charge	1.00	Job	144.58	144.58				144.58					99
31632913	1400 31	Uncased drilled concrete piers, end bearing, fluted constant diameter, steel, 4,000 psi concrete, 7 ga., 50' long, 18" diameter, priced using 200 piles, 60' long, unless specified otherwise, excludes pile caps, mobilization, or reinforcing	150.00	vlft	12.48	1,871.79	47.50	7,125.00	4.82	9,719.49	722.70				6,639
31632920	10-15' deep x 18" diame 1500 31	Cast in place adds for drilled concrete piers, for reinforcing steel, add	2,713.00	lb			1.45	3,933.85		3,933.85					2,687
04000000	rebar in piers	A set to be a data for della di seconda set en forstalli seconda del and a di	1.00	01/	544.95	2,179.81	445.00	580.00	210.10	0.000.04	840.40				0.450
31632920	1700 31 drill our bells	Cast-in place adds for drilled concrete piers, for ball or pedestal end, add	4.00	Cr	544.95	2,179.81	145.00	580.00	210.10	3,600.21	840.40				2,459
32 32311320	0500 00	Exterior Improvements	44.00	15 1/	7.54	3,246.37	07.50	8,973.28	4 70	12,904.16	684.51				8,815
	0500 32	Fence, chain link industrial, galvanized steel, 6 ga. wire, 2" posts @ 10' OC, 6' high, includes excavation, & concrete	44.00	LF Ken wall encl door	7.51	330.29	27.50	1,210.00	1.78	1,618.70	78.41				1,106
32311320	0920 32	Fence, chain link industrial, galvanized steel, 6 ga. wire, 2-1/2" posts @ 10' OC, 8' high, includes excavation, in concrete,	44.00	LF	10.02	440.86	38.50	1,694.00	2.38	2,239.40	104.54				1,530
	replacement fence at dri	excludes barbed wire ive gate location and at propane tank location				I	I				I				
32311320	1400 32	Fence, chain link industrial, gate, galvanized steel, 6' high fence, 1-5/8" frame, 3' wide, 6' high, includes excavation, in concrete	1.00	EA	179.71	179.71	225.00 22.50	225.00	42.90	447.61	42.90				306 900
32311320	2100 32	Fence, chain link industrial, no barbed wire, galvanized steel, 2" line post, 10' OC, 1-5/8" top rail, 5' - 0" high, includes excavation, in concrete	44.00	LF	6.01	264.51	22.50	990.00	1.43	1,317.43	62.92				900
32311320	5060 32	Perce, chain link industrial, double swing gates, 6' high, 12' opening, includes excavation, posts & hardware in concrete	1.00	Opng Ken wall encl	564.59	564.59	490.00	490.00	134.20	1,188.79	134.20				812
	new gate at the front as	reflected on drawings		1000	I				I						
32311320	7055 32	Fence, chain link industrial, braces, galvanized steel, 6 ga. wire	44.00	LF Keni wall encli	1.81	79.70	3.12	137.28	0.43	235.85	18.88				161
	replacement fence at dri	ive gate and walk gate													
32311330	6660 32	Fence, chain link, gates & posts, end posts, chain link fence, galvanized steel, 3" OD, 4', set in concrete, includes excavation	4.00	EA Ken wall encl door	37.02	148.08	35.50	142.00	8.74	325.06	34.98				222
	new end and gate posts														
32311330	7780 32	Chain link fence gates and posts, chain link fence gates and posts, 6' high, excludes excavation	5.00	LF Ken wall encl	87.67	438.37	137.00	685.00	22.55	1,236.12	112.75	T			844
32311330	7925 32	Chain link fence gates and posts, auger fence post hole, medium soil, 3' deep, by machine, includes excavation	9.00	EA Ken wall encl door	14.41	129.72			3.41	160.41	30.69				110
000000000	drill post holes	Ordeling have more and as have more ANOF		Mid	400.00	070 5	050.00	0.400.00	40.00						
32922310	1100 32 repair sod from new wal	Sodding, bent grass sod, on level ground, 3 M.S.F.	4.00	Msf	167.63	670.54	850.00	3,400.00	16.06	4,134.78	64.24				2,824
		(Unassigned)													
		Grand Total				279,263.14		130,074.82		448,941.59	24,063.61		15,540.02		306,672

CSI	Division	Labor	Mat	Subs	Equip	Other	User	Total
01	General Requirements	18,801	3,851		11,462	15,540		49,655
02	Site Construction	8,338	6,358		373			15,070
03	Concrete	18,950	7,392		1,584			27,926
04	Masonry	53,315	30,090		2,486			85,890
05	Metals	29,616	6,066		2,734			38,416
06	Wood & Plastics	2,370	631					3,001
07	Thermal & Moisture Protection	2,927	1,055					3,983
08	Doors & Windows	7,164	20,868					28,032
09	Finishes	105,125	22,270					127,396
23	Heating, Ventilating, and Air Conditioning (HVAC)	6,957						6,957
26	Electrical	3,792	10,245					14,038
31	Earthwork	18,661	12,274		4,741			35,676
32	Exterior Improvements	3,246	8,973		685			12,904
					Cit	y Cost Index C	Qrt 1-2022	-4,489
							Subtotal	444,452
					Standa	ard Hour Coef	ficient .69	-137,780
							Subtotal	306,672
						Other Norr		
						Total	Estimate	306,672



SITE PLAN FLOOR PLAN AND SCHEDULES SHELTER CEILLING, INCINERATOR BLDG PLAN AND CEILING PLAN EXTERIOR ELEVATIONS AND DETAILS MECHANICAL FLOOR PLAN LIGHTING PLAN INCINERATOR BLDG

GENERAL CONTRACTOR

8121 Broadway St. Suite 200 Houston, Texas 77061 713-980-3250

2855 Mangum Suite 566 Houston, Texas 77092 713-823-1660

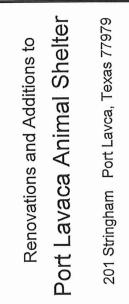
James E Thompson & Associates 1169 County Road 136A Alvin, Texas 77511 832-526-0160

STRUCTURAL ENGINEER

3200 Wilcrest Suite 305 Houston, Texas 77042 713-780-3345

	ISSUE DATES
DATE	DESCRIPTION
09/14/22	ISSUED FOR PERMITTING
MEP ENGNEER:	PROJECT TEAM James E Thompson & Associates
NUP DAVINEDIC	1169 County Road 136A
	Alvin, Texas 77511
	832.526.0160
STRUCTURAL ENGINEER	CJG Engineers
	3200 Wilcrest Dr. Suite 305
	Houston, Texos 77042 713.780.3345
011:	/13./00.3343

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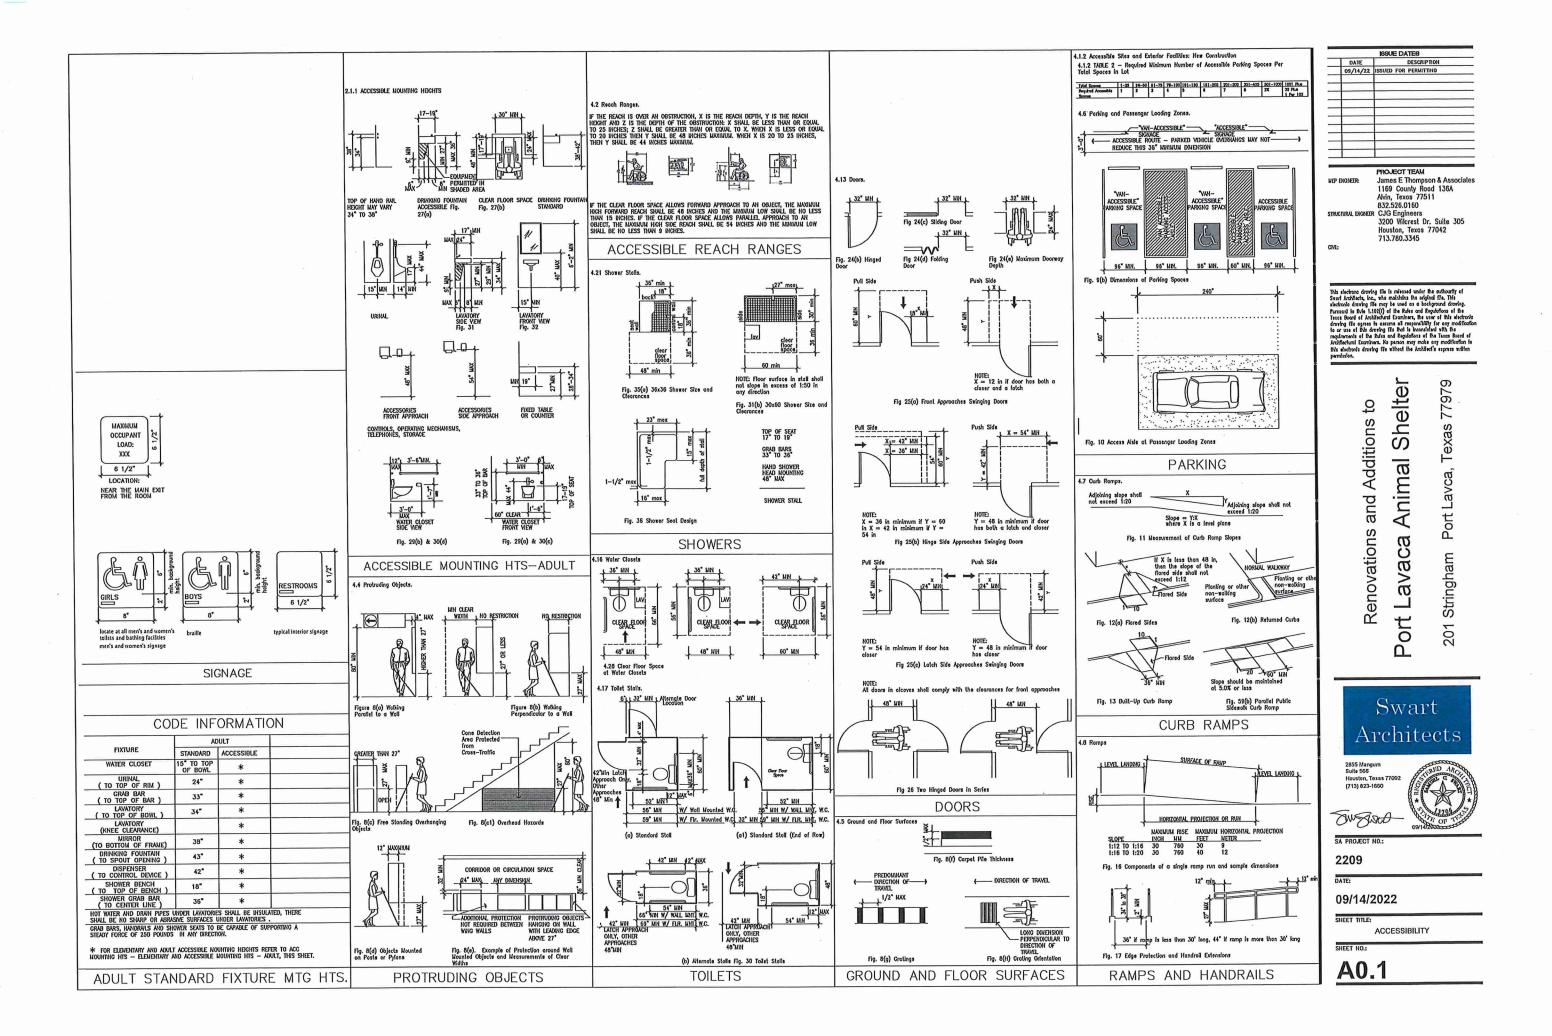
2209

DATE:

09/14/2022

SHEET TITLE:

SHEET NO .: A 0.0



1. Delete the 6-OH doors in new wall and install 6-louvers instead for ventilation.

southwest corner and install 8" CMU block instead. Tie the block into the existing 8" CMU wall. Install a ped. door in this wall.

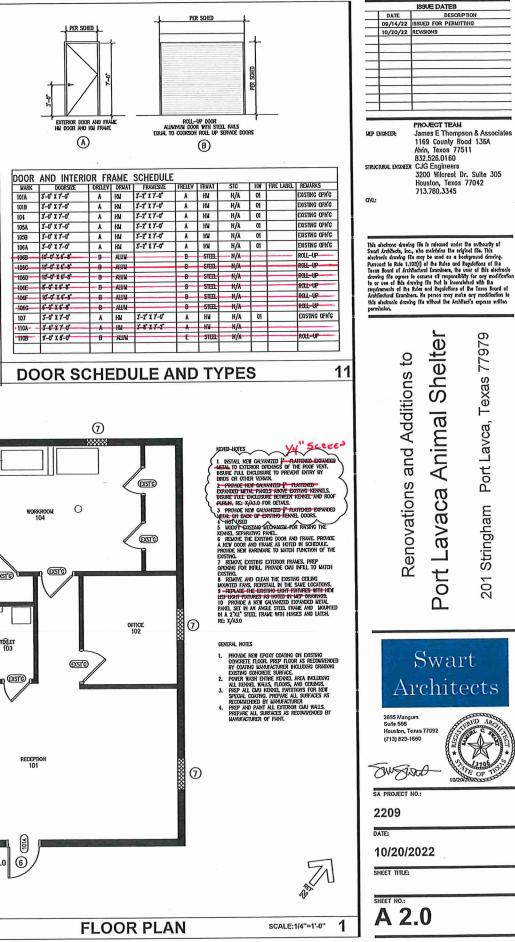
3. install 1-ped door on new north CMU wall.

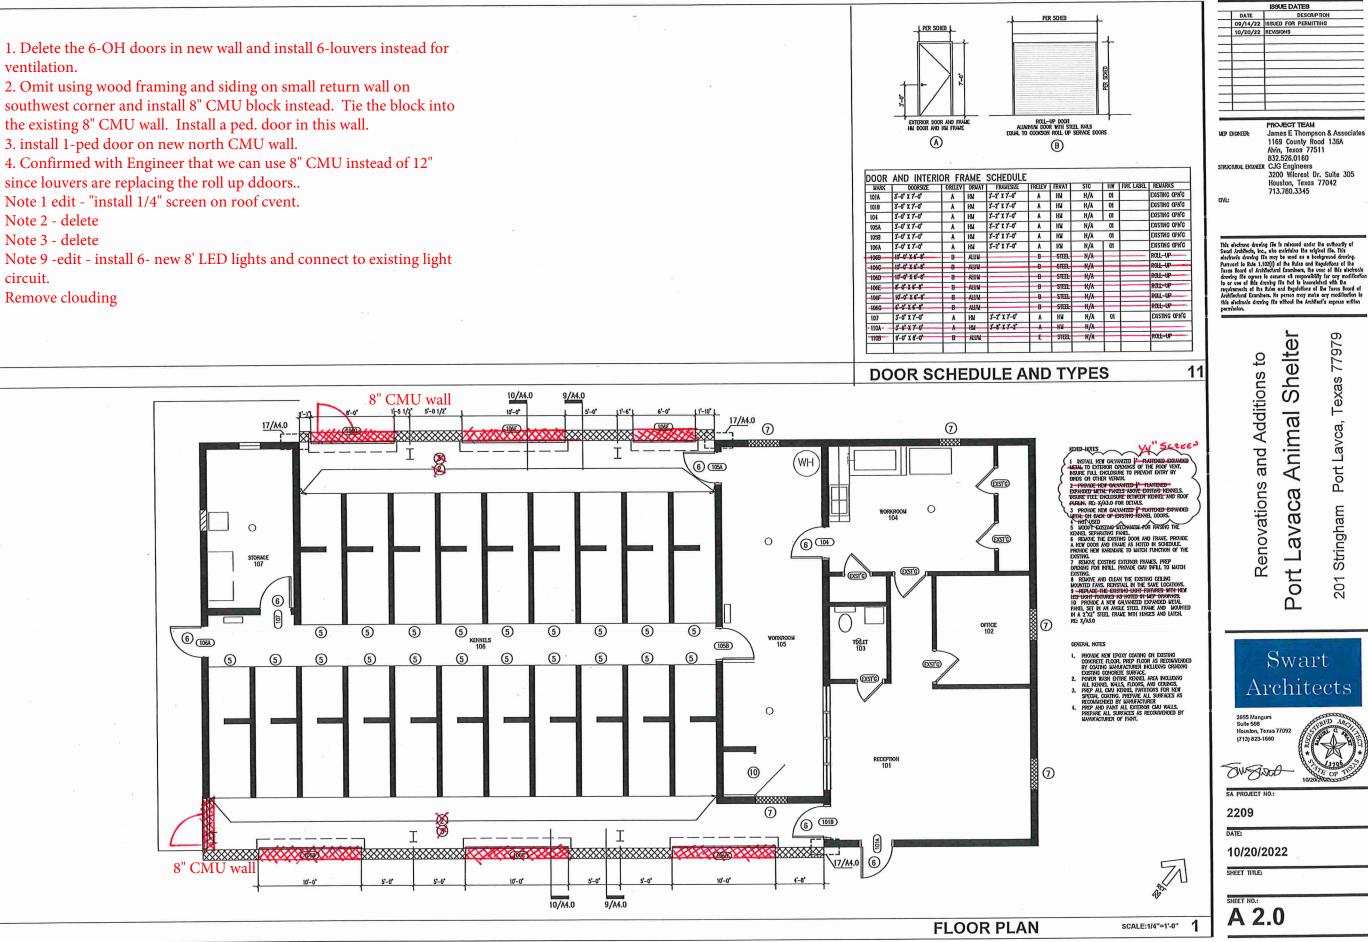
Note 2 - delete

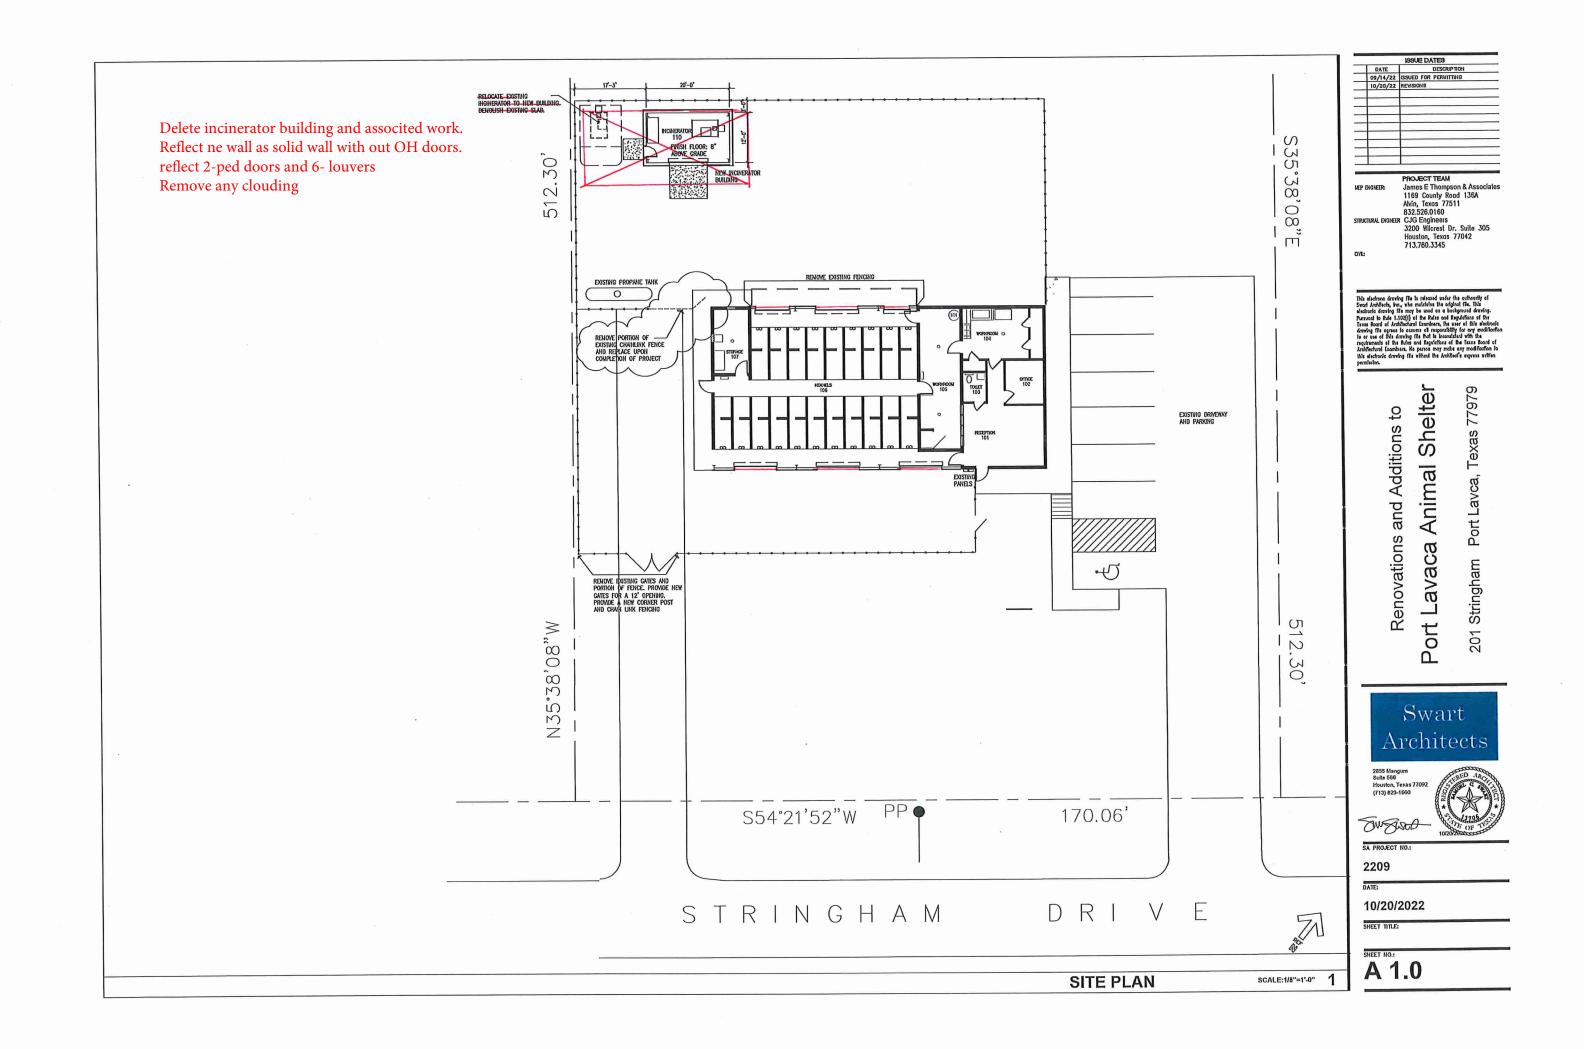
Note 3 - delete

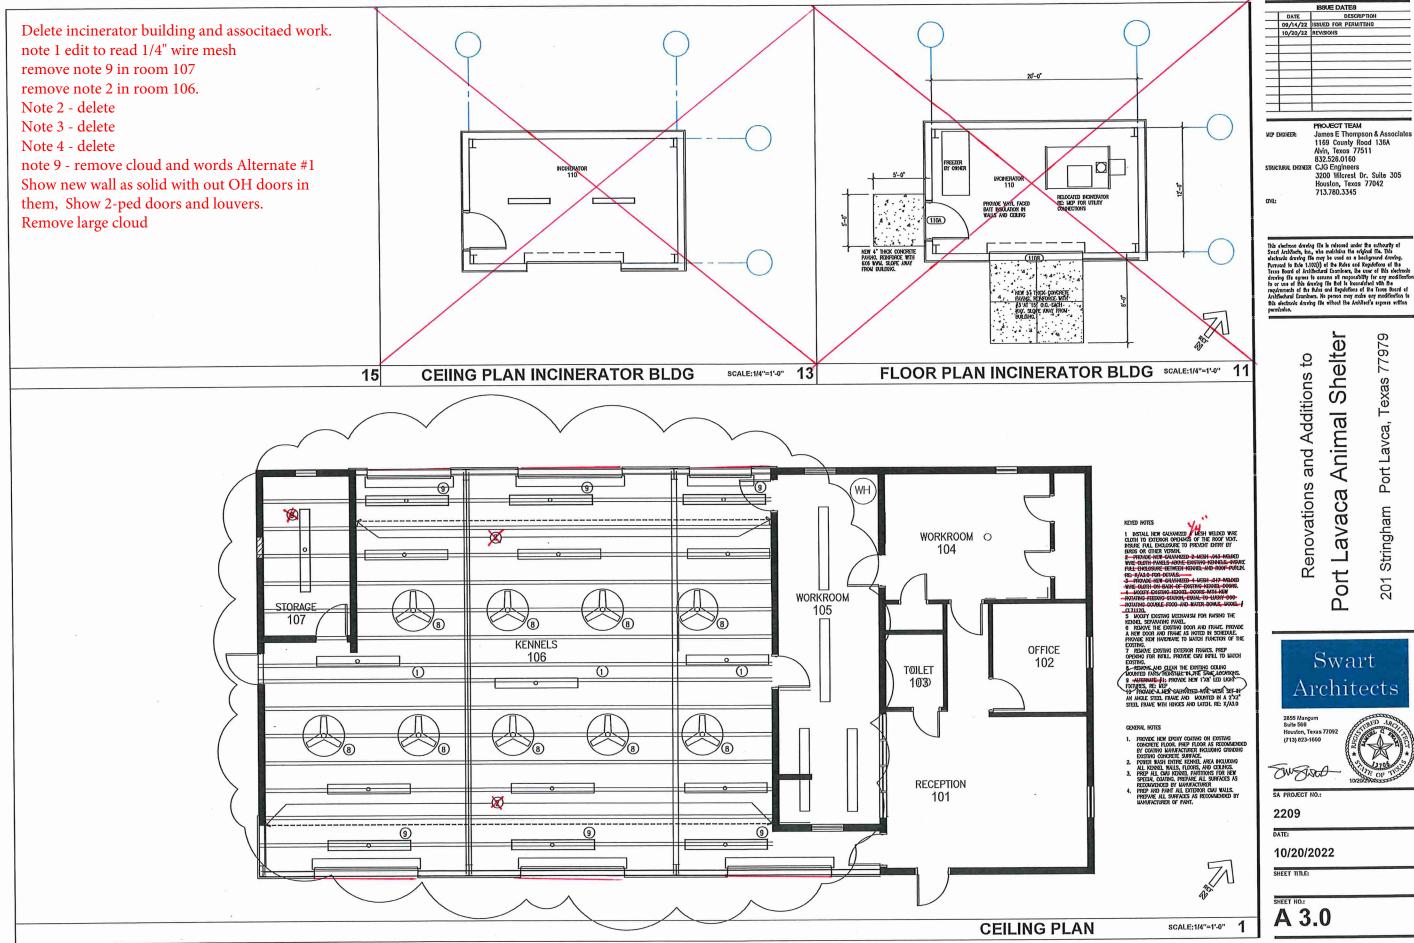
circuit.

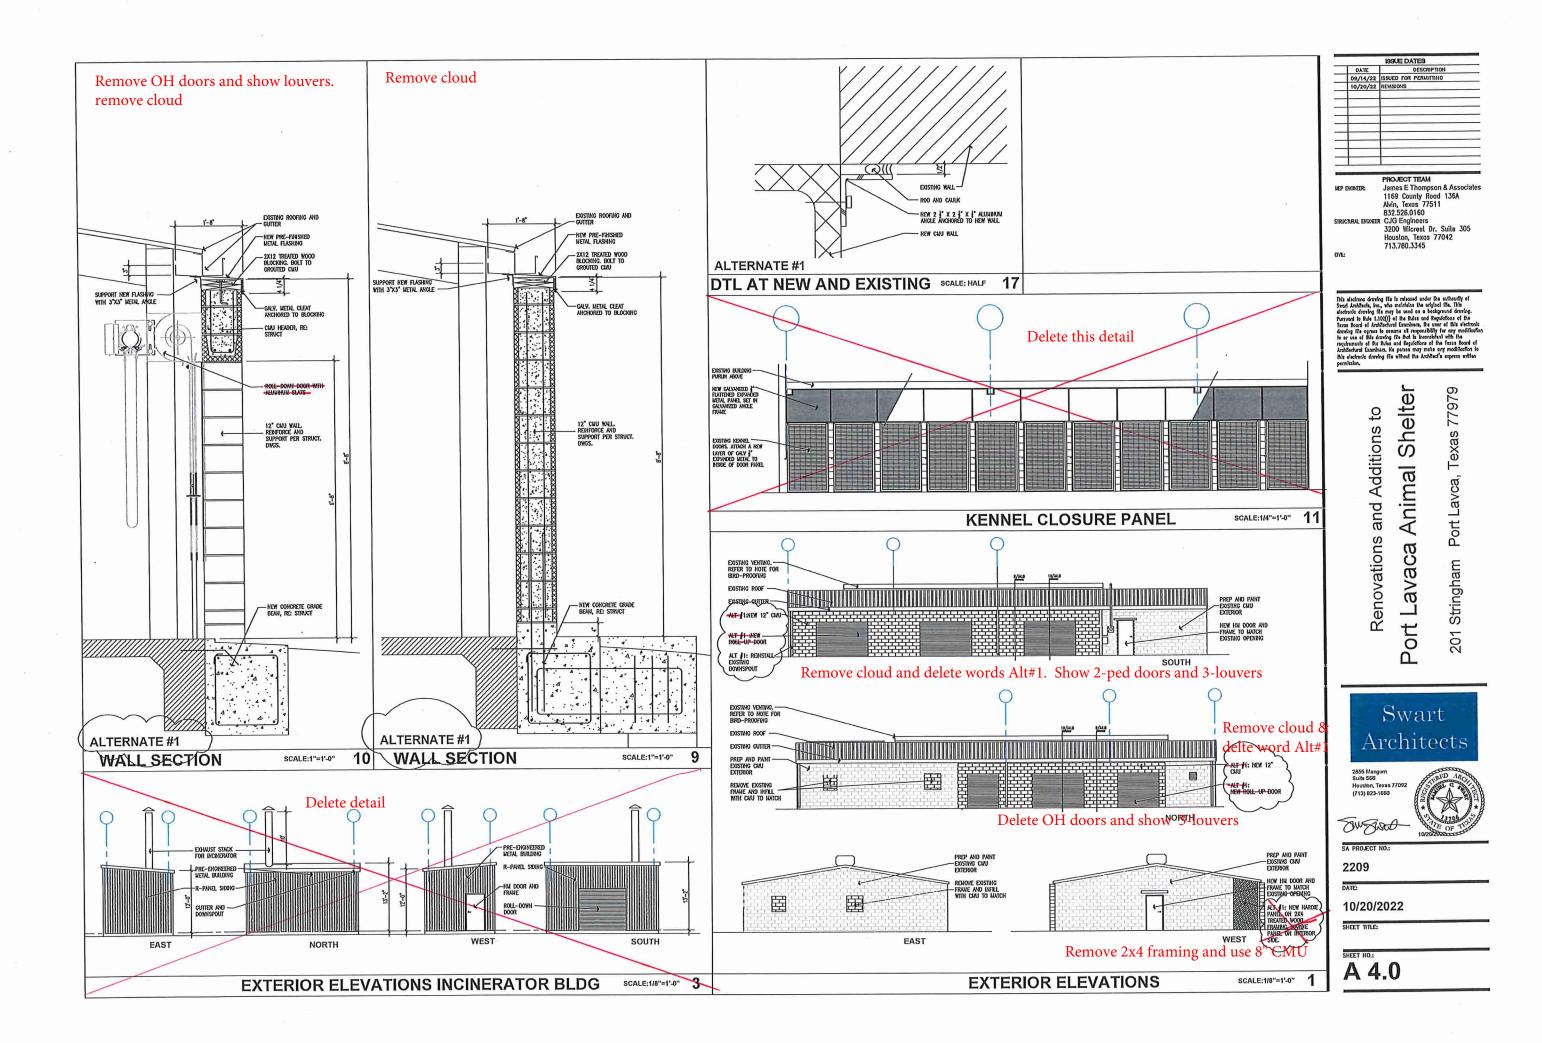
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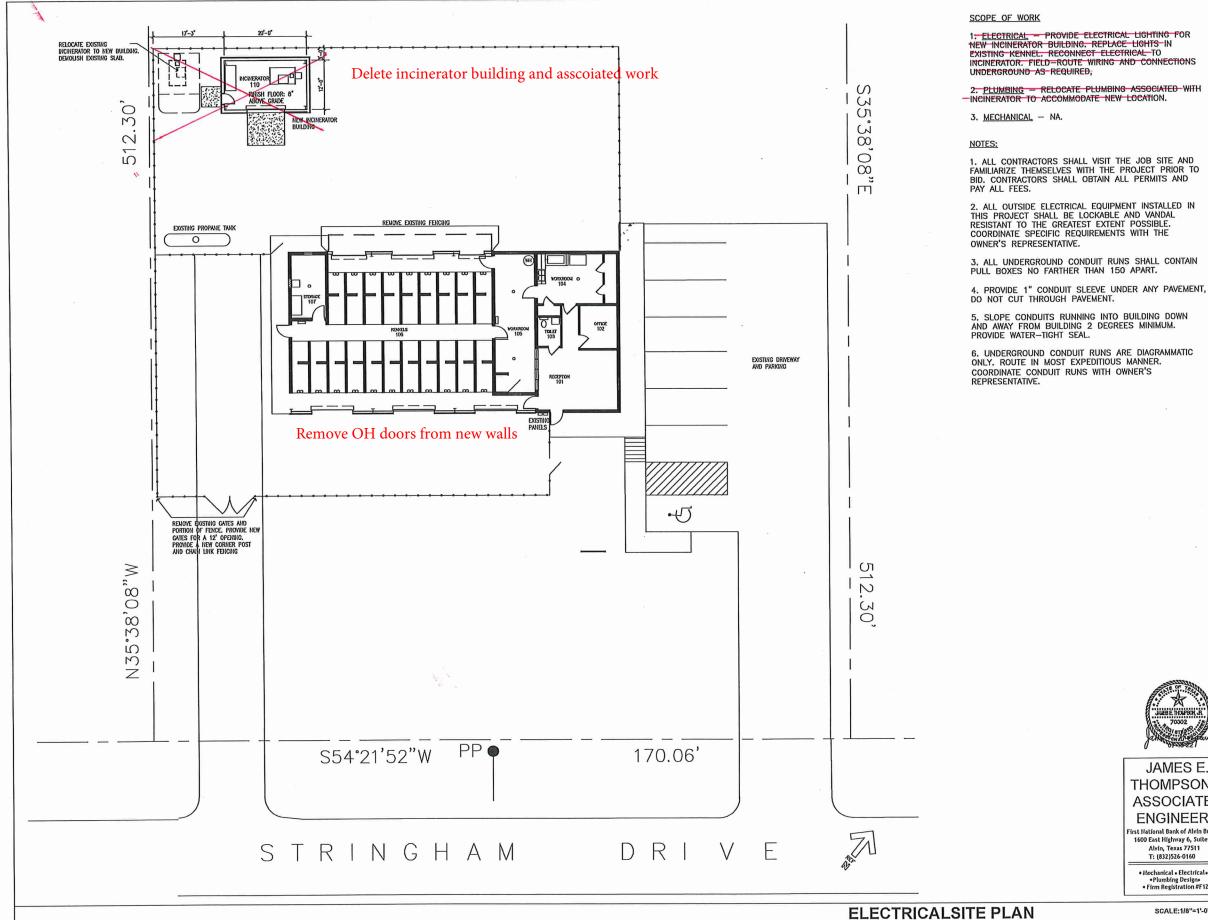


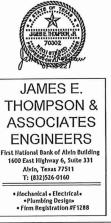








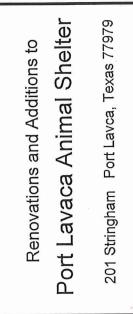


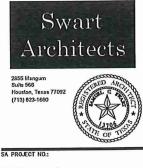


SCALE:1/8"=1'-0" 1

	ISSUE DATES
DATE	DESCRIPTION
05/03/22	REVIEW SET
NEP EXCINEER:	PROJECT TEAM James E Thompson & Associates 921 Blume Drive
	Galveston, Texas 77554 832.526.0160
STRUCTURAL ENGINEER	CJG Engineers 3200 Wilcrest Dr. Suite 305
	Houston, Texas 77042 713.780.3345
CVI:	

The decirace develog like is released under his evibourity of Svert AcaNets, Inc., who mobilizes his optical file. This electroic deriving file may be used as a bockground deriving. Pursuad is hule 1,102(1) of the Roiss and Regulations of the lectroic Bock of a Underliving Linears, Has user al link schernele deriving file optical derives (in Buschart, Has user al link schernele deriving file optical derives (in Buschart, Has user al link schernele deriving file optical derives (in Buschart, Has user al link schernele deriving file optical derives (in Buschart, Has user al link schernele deriving file optical derives (in Buschart) and Buschart regularization of the Roiss and Regulations of the Texas Board on Purdisdeval Decirators. No press nor main organ modification is Bus electroic deriving file without the Architeck express written permission.





2209

DATE

05/03/2022

ELECTRCIAL SITE PLAN

SHEET NO .: **ESP1.0**

Delete all notes stricken through

SCOPE OF ELECTRICAL WORK:

1. PROVIDE AND INSTALL NEW ELECTRICAL EQUIPMENT AS REQUIRED, LIGHTS, AND POWER PER PLANS AND SPECIFICATIONS, EXISTING FIXTURES IN KENNEL AREA ARE TO REMAIN. 2. PROVIDE NEW EXTERIOR (BATTERY) EMERGENCY EGRESS LIGHTS AS REQUIRED BY

3.FIELD VERIFY AVAILABLE FAULT CURRENT AND MARK ON PLANS., DATE AND SIGN PER CITY OF HOUSTON CODE REQUIREMENTS.

GENERAL NOTES

1.CONTACT POWER COMPANY CONSULTANT PRIOR TO DOING ANY WORK. PURCHASE ALL PERMITS AND PAY-ALL FEES.

ELECTRICAL NOTES:

1. LIGHT FIXTURES TO BE SERVED BY CONDUIT AND JUNCTION BOXES.

2. COORDINATE LIGHT FIXTURE LOCATIONS WITH MECHANICAL REQUIREMENTS. COORDINATE WITH OWNER/ARCHITECT.

3. EXACT LOCATIONS OF SWITCHES SHALL BE AS PER EXISTING OR AS DIRECTED BY THE -OWNER-

-4. SEE ES.O FOR DETAILS REGARDING CONNECTION OF BATTERY AND NIGHT LIGHTING CIRCUITS. ALL BATTERY POWERED LIGHTS TO BE CONNECTED TO NORMAL POWER CIRCUIT - PER-NEC -700,12(F)-

5. SAFETY DISCONNECTS TO BE MOUNTED ON OUTSIDE OF HVAC UNIT.

-(30/240/2P/3R/HD/NF) DUPLEX OFCI CONVENIENCE RECEPTACLE OUTLET TO BE MOUNTED (30/240/2P/3R/HD/NF) DUPLEX OFCI CONVENIENCE RECEPTACLE OUTLET TO BE MOUNTED ON SIDE OF EACH HVAC UNIT IN CAST FD BOX WITH HINGED, GASKETED, WEATHERPROOF COVER PLATE.

6.-SWITCHING IS SHOWN DIAGRAMMATICALLY, CONSULT WITH OWNER'S REPRESENTATIVE TO EXACT FUNCTIONALITY OF SWITCHING, PROVIDE ADDITIONAL SWITCHES AND/OR RECEPTACLES IF REQUIRED BY OWNER.

7. COORDINATE LOCATION OF HVAC UNIT WITH OWNER'S REPRESENTATIVE PRIOR TO ISTALLATION

SPECIAL INSTRUCTIONS

drawn in

1. EXISTING LIGHTS IN SHELTER ARE TO REMAIN. PROVIDE AND INSTALL SIX (6) ADDITIONAL LED STRIP FIXTURES.AS.ALTERNATE #1. FIXTURE TO BE LITHONIA MODEL #ZLINA 4000K, 3600 LU, 25 WATTS, 1200 VOLTS,

Remove cloud and words As alternate #1

ELECTRICAL NOTES: (CONTINUED)

1.- CEILING- GRID-NOT-SHOWN-FOR CIRCUIT CLARITY. FOR EXACT LOCATION OF CEILING GRIDS. REFER TO ARCHITECTUAL PLANS.

2. COORDINATE ALL HVAC SUPPLY AND RETURN REGISTER LOCATIONS WITH MECHANICAL DRAWINGS. LIGHT AND OR HVAC DIFFUSER LOCATIONS SHOWN TO BE MODIFIED AS REQUIRED TO ACCOMMODATE HVAC DROPS.

3. ALL PANELS TO BE MARKED FOR ARC FLASH HAZARD PER NEC 110.16.

4. FAULT CURRENT SHOWN ON E3:0 IS BASED ON EXISTING PHYSICAL TRANSFORMER CONFIGURATION, EQ TO VERIFY EXACT AVAILABLE SHORT CIRCUIT CURRENT AND PROVIDE FOR FULLY RATED EQUIPMENT.

5. ALL WORK TO BE IN COMPLIANCE WITH NEC 2020.

LIGHTING PLAN KEYED NOTES (FOR 1/E1.0 ONLY)

EXHAUST FANS, BROAN MODEL 509, 120V, 180 CFM. EXHAUST FANS ARE TO BE VENTED OUT THROUGH OUTSIDE WALL OR ROOF AS REQUIRED BY OWNER'S REPRESENTATIVE. (SEE M1.0)

(2) ADJUSTMENTS TO LIGHT LOCATIONS REQUIRED FOR HVAC

(3) MOUNT LIGHT SWITCHES IN ACCESSIBLE LOCATION. COORDINATE EXACT LOCATION WITH OWNER'S REPRESENTATIVE.

(4)-EGRESS LIGHT TO BE EQUIPPED TO OPERATE UPON LOSS OF BUILDING POWER, BE CONNECTED THROUGH EXIT LIGHT, AND HAVE 90 MINUTE BATTERY BACK-UP.

SPECIAL INSTRUCTIONS:

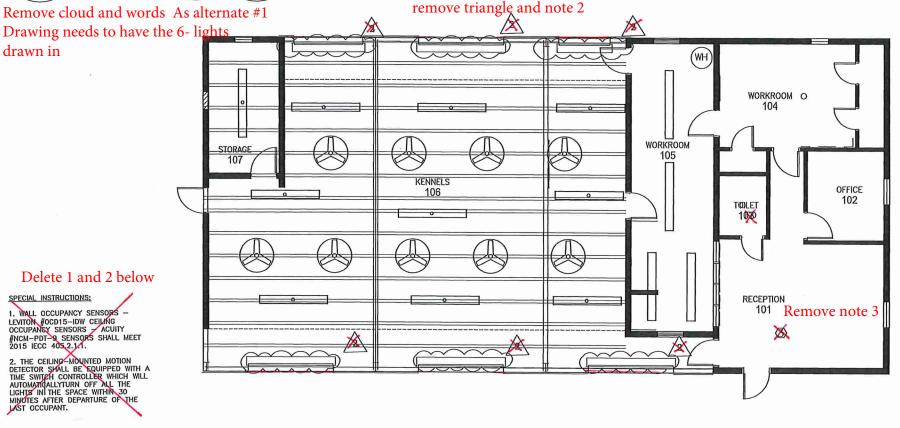
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1.-WALL OCCUPANCY SENSORS - LEVITON #OCD15-IDW CEILING OCCUPANCY SENSORS ACUITY #NCM-PDT-9 SENSORS SHALL MEET 2015 IECC 405.2.1.1.

-2. THE CEILING-MOUNTED MOTION DETECTOR SHALL BE EQUIPPED WITH A TIME SWITCH CONTROLLER WHICH WILL AUTOMATICALLY TURN OFF ALL THE LIGHTS IN THE SPACE WITHIN 30 MINUTES AFTER DEPARTURE OF THE LAST OCCUPANT.

3. PROVIDE CIRCUITIING SO THAT LIGHTING MAY BE REDUCED BY AT LEAST 50% VIA





Delete 1 and 2 below

SPECIAL INSTRUCTIONS:

1. WALL OCCUPANCY SENSORS -LEVITON #OCD15-IDW CEILANG OCCUPANCY SENSORS - ACUITY #NCM-PDT-9 SENSORS SHALL MEET 2015 IECC 405.2.1.1.

2. THE CEILING-MOUNTED MOTION DETECTOR SHALL BE EQUIPPED WITH A TIME SWITCH CONTROLLER WHICH WILL AUTOMATIGALLYTURN OFF ALL THE LIGHTS INI THE SPACE WITHIN 30 MINUTES AFTER DEPARTURE OF THE LAST OCCUPANT.

(1) ELECTRICAL LIGHTING PLAN

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JAMES E. **THOMPSON &** ASSOCIATES ENGINEERS irst National Bank of Alvin Buildin 1600 East Highway 6, Suite 331 Alvin, Texas 77511 T: (832)526-0160

•Nechanical • Electrical • •Plumbing Designe • Firm Registration #F1288

	ISSUE DATES
DATE	DESCRIPTION
05/03/22	
10/15/22	OWNER REMSIONS
_	
NEP ENONEER:	PROJECT TEAM James E Thompson & Associates
	1169 County Road 136A Avin, Texos 77511 832.526.0160
structurul excaneer	CJG Engineers 3200 Wilcrest Dr. Suite 305
	Houston, Texas 77042 713.780.3345
TVL:	

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Shelter 77979 <u>р</u> Additions Texas a Lavca, Anim and Port Renovations Sa Stringham ava to 201

Swart Architects 2855 Mangum Suite 566 Houston, Texas 7709 (713) 823-1660



SA PROJECT NO.

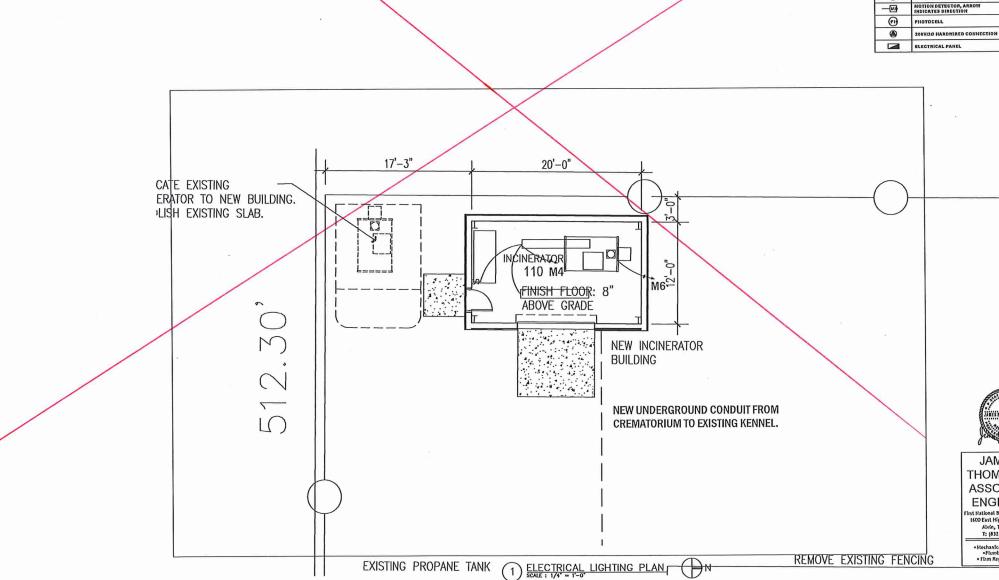
2209

SHEET NO.

05/03/2022

IGHTING PLAN

E1.0



4. SWITCHING IS SHOWN DIAGRAMMATICALLY, CONSULT WITH OWNER'S REPRESENTATIVE TO EXACT FUNCTIONALITY OF SWITCHING. PROVIDE ADDITIONAL SWITCHES AND/OR RECEPTACLES IF REQUIRED BY OWNER.

3. EXACT LOCATIONS OF SWITCHES SHALL BE AS PER EXISTING OR AS DIRECTED BY THE OWNER.

OWNER/ARCHITECT.

1. LIGHT FIXTURES TO BE SERVED BY CONDUIT AND JUNCTION BOXES.

1. PROVIDE AND INSTALL NEW LIGHT FIXTURES IN CREMATORIA AREA AS REQUIRED, LIGHTS, AND POWER PER PLANS AND SPECIFICATIONS.

2. FIELD VERIFY AVAILABLE FAULT CURRENT AND MARK ON PLANS., DATE AND SIGN PER CITY OF HOUSTON CODE REQUIREMENTS.

SCORE OF ELECTRICAL WORK:

GENERAL NOTES

ELECTRICAL NOTES:

2. COORDINATE LIGHT FIXTURE LOCATIONS WITH OTHER REQUIREMENTS. COORDINATE WITH

1. IF REQUIRED, CONTACT POWER COMPANY CONSULTANT PRIOR TO DOING ANY WORK. PURCHASE ALL PERMITS AND PAY ALL FEES.

7. ALL WORK TO BE IN COMPLIANCE WITH NEC 2020. B. RUN 1"C., PVC SCHEDULE 80, 3/10, 1#12G UNDERGROUND FROM NEW CREMATORIUM BUILDING TO EXISTING PANEL 'M IN KENNEL AREA. DO NOT CUT ANY EXISTING PAVEMENT, BORE UNDER,

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5. ALL PANELS TO BE MARKED FOR ARC FLASH HAZARD PER NEC 110.16. 6. FAULT CURRENT SHOWN ON E3.0 IS BASED ON EXISTING PHYSICAL TRANSFORMER CONFIGURATION, EC TO VERIFY EXACT AVAILABLE SHORT CIRCUIT CURRENT AND PROVIDE FOR FULLY RATED EQUIPMENT.

ELECTRICAL NOTES: (CONTINUED)

ELECTRICAL LEC MARK DESCRIPTION FLUORESCENT FIXTURE . FLUORESCENT FIXTURE Q WALL BRACKET FIXTURE -\$-FLUORESCENT FIXTURE S EXIT LIGHT • SINGLE RECEPTACLE DUPLEX CONVENIENCE OF FLOOR MOUNTED DUPLEX Ø 240V OUTLET OUTLET WITH GROUND F ¢... 中. 中. 中. RECEPTACLE WITHISOLAT # QUAD PLEX CONVIENIEN WALL SWITCH \$. 3-WAY SWITCH SWITCH WPILOT LIGHT PASSIVE INFRARED WALL WIMANUAL ON OFF CONT \$.a ÷. MOTOR RATED SWITCH Ø MOTOR \frown CIRCUIT HOME-RUH TO P. SWITCHLEG \frown TELEPHONE OUTLET 1'C ∇ DISCONNECT SWITCH 00 JUNCTION BOX 0 120V HARDWIRED CONH 201V/IC HARDWIRED COL

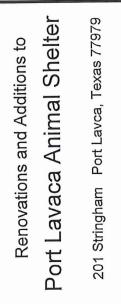
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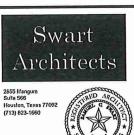


JAMES E. THOMPSON & ASSOCIATES ENGINEERS itst National Bank of Alvin Building 1600 East Highway 6, Suite 331 Alvin, Texas 77511 T: (832)526-0160 • Mechanical • Electrical • • Plumbing Design• • Firm Registration 4F 1288

_		
		ISSUE DATES
	DATE	DESCRIPTION
	05/03/22	REMEW SET
_		
		PROJECT TEAM
PE	NONEER	James E Thompson & Associales
		921 Blume Drive
		Golveston, Texas 77554
		832.526.0160
NC	TURAL ENONEER	CJG Engineers
		3200 Wilcrest Dr. Suite 305
		Houston, Texos 77042
		713.780.3345

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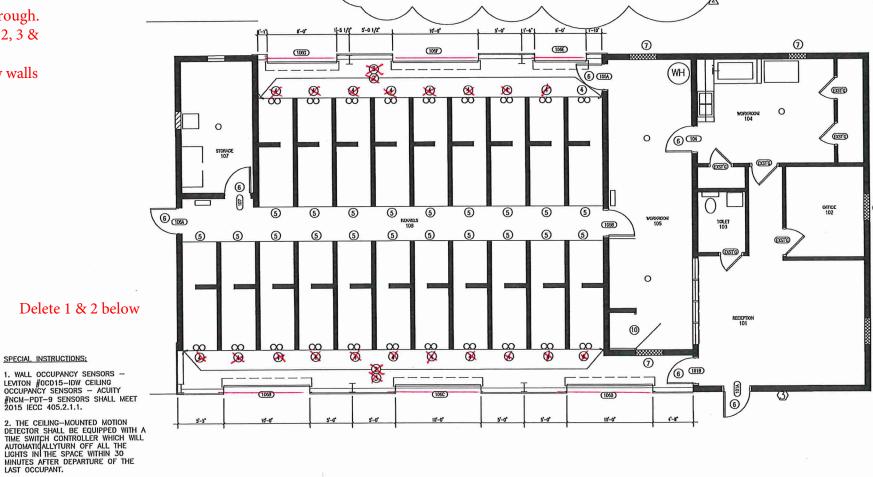


PROJECT NO .:

2209

05/03/2022 LIGHTING PLAN SHEET NO .: E1.1

Remove all notes stricken through. Remove circles and all notes 2, 3 & 4 in room 106 Remove OH doors from new walls and show 2-ped doors. Remove cloud



ELECTRICAL NOTES: (CONTINUED)

WNER'S REPRESENTATIVE.

SPECIAL INSTRUCTIONS:

EXISTING WIREWAY TO PANEL.

1. CEILING GRID NOT SHOWN FOR CIRCUIT CLARITY. FOR EXACT LOCATION OF CEILING GRIDS, REFER TO ARCHITECTUAL PLANS.

4. FAULT CURRENT SHOWN ON E3.0 IS BASED ON EXISTING PHYSICAL TRANSFORMER CONFIGURATION, EC TO VERIFY EXACT AVAILABLE SHORT CIRCUIT CURRENT AND PROVIDE FOR FULLY RATED EQUIPMENT.

(1) EXHAUST FANS, BROAN MODEL 509, 120V, 180 CFM. EXHAUST FANS ARE TO BE

(3) MOUNT LIGHT SWITCHES IN ACCESSIBLE LOCATION, COORDINATE EXACT LOCATION WITH

(4) EGRESS LIGHT TO BE EQUIPPED TO OPERATE UPON LOSS OF BUILDING POWER, BE CONNECTED THROUGH EXIT LIGHT, AND HAVE 90 MINUTE BATTERY BACK-UP.

1. WALL OCCUPANCY SENSORS - LEVITON #OCD15-IDW CEILING OCCUPANCY SENSORS - - ACUITY #NCM-PDT-9 SENSORS SHALL MEET 2015 IECC 405.2.1.1.

2.-THE-CEILING-MOUNTED MOTION DETECTOR SHALL BE EQUIPPED WITH A TIME SWITCH CONTROLLER WHICH WILL AUTOMATICALLY TURN OFF ALL THE LIGHTS IN THE SPACE WITHIN

4 PROVIDE AND INSTALL A NEW DUPLEX RECEPTACLE OUTLET IN THE INCINERATOR SHED

FOR THE FREEZER CONNECTION. ROUTE 3"C. 3-#12AWG THHN CONDUCTORS THROUGH THE

(1) ELECTRICAL LIGHTING PLAN

3. PROVIDE CIRCUITING SO THAT LIGHTING THAY BE REDUCED BY AT LEAST 50% VA

3. ALL PANELS TO BE MARKED FOR ARC FLASH HAZARD PER NEC 110.16

VENTED OUT THROUGH OUTSIDE WALL OR ROOF AS REQUIRED BY OWNER'S REPRESENTATIVE. (SEE M1.0)

(2) ADJUSTMENTS TO LIGHT LOCATIONS REQUIRED FOR HVAC

30-MINUTES AFTER DEPARTURE OF THE LAST OCCUPANT

5. ALL WORK TO BE IN COMPLIANCE WITH NEC 2020.

LIGHTING PLAN KEYED NOTES O(FOR 1/E1.0 ONLY)

JINATE ALL HYAC SUPPLY AND RETURN REGISTER LOCATIONS WITH MECHANICA S. LIGHT AND OR HYAC DIFFUSER LOCATIONS SHOWN TO BE MODIFIED AS 10 ACCOMMODATE HYAC DROPS.

1. CONTACT POWER COMPANY CONSULTANT PRIOR TO DOING ANY WORK. PURCHASE ALL PERMITS AND PAY ALL FEES. ELECTRICAL NOTES:

3. EXACT LOCATIONS OF SWITCHES SHALL BE AS PER EXISTING OR AS DIRECTED BY THE

-4, SEE E5.0 FOR DETAILS REGARDING CONNECTION OF BATTERY AND NICHT LIGHTING -CIRCUITS, ALL BATTERY POWERED LIGHTS TO BE CONNECTED TO NORMAL POWER CIRCUIT

5. SAFETY DISCONNECTS TO BE MOUNTED ON OUTSIDE OF HVAC-UNIF. (30/240/2P/3R/HD/NF) DUPLEX GFGI CONVENIENCE RECEPTACLE OUTLET TO BE MOUNTED ON SIDE OF FACH HVAC UNIT IN CAST FD BOX WITH HINGED, GASKETED, WEATHERPROOF COVER PLATE.

6. SWITCHING IS SHOWN DIAGRAMMATICALLY. CONSULT WITH OWNER'S REPRESENTATIVE TO EXACT FUNCTIONALITY OF SWITCHING. PROVIDE ADDITIONAL SWITCHES AND/OR RECEPTACLES

7. COORDINATE LOCATION OF HVAC UNIT WITH OWNER'S REPRESENTATIVE PRIOR TO INSTALLATION.

1. PROVIDE_AND-INSTALL NEW ELECTRIGAL EQUIPMENT AS REQUIRED, LIGHTS, AND POWER PER PLANS AND SPECIFICATIONS.

3.FIELD VERIFY AVAILABLE FAULT CURRENT AND MARK ON PLANS., DATE AND SIGN PER

2: PROVIDE-NEW-EXTERIOR-(BATTERY) EMERGENCY EGRESS LIGHTS AS REQUIRED-BY CURRENT CODES.

1. LIGHT FIXTURES TO BE SERVED BY CONDUIT AND JUNCTION BOXES.

SCOPE OF ELECTRICAL WORK:

GENERAL NOTES

WITH OWNER/ARCHITECT.

PER NEC 700.12(F)

IF REQUIRED BY OWNER.

OWNER

2. COORDINATE LIGHT FIXTURE LOCATIONS WITH MECHANICAL REQUIREMENTS. COORDINATE

EL	ECTRICAL LEGEND
к	DESCRIPTION
	FLUORESCENT FIXTURE
	FLUDRESCENT FIXTURE WITH BATTERY PACK
	WALL BRACKET FIXTURE
-	FLUORESCENT FIXTURE
	EXITLIOHT
	SINGLE RECEPTACLE
	DUPLEX CONVENIENCE OUTLET
	FLOOR MOUNTED DUPLEX OUTLET
Į.	240V OUTLET
-	OUTLET WITH GROUND FAULT CIRCUIT INTERRUPTER
. 4.	RECEPTACLE WITH ISOLATED GROUND
:	QUAD PLEX CONVIENIENCE OUTLET
	WALLSWITCH
	3-WAY SYNTCH
	SWITCH WIPILOT LIGHT
	PASSIVE INFRARED WALL SWITCH/SENSOR WEMANUAL ON/OFF CONTROL
	MOTOR RATED SWITCH
y	NOTOR
1	CIRCUIT HOME-RUN TO PANEL
1	SMITCH LEG
7	TELEPHONE OUTLET 1°C TO ABOVE CEILING WITH WIRE TO TELEPHONE TERMINAL BOARD
Ъ	DISCONNECT SYNTCH
٦	JUNCTION BOX
)	120Y HARDWIRED CONNECTION
0	208V/10 HARDWIRED CONNECTION
3	MOTION DETECTOR, ARROY INDICATES DIRECTION
9	PHDYOCELL
9	2084/30 HARDYARED CONNECTION
	ELECTRICAL PANEL

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FLOOR MOUNTED DUPLEX

中、中、中、 RECEPTACLE WITH ISOLA

AT QUAD PLEX CONVIENIEN

TELEPHONE OUTLET 1"C WITH WIRE TO TELEPHON DISCONNECT SYNTCH

ELECTRICAL PANEL

JUNCTION BOX

240V OUTLET OUTLET WITH GROUND FA



JAMES E. THOMPSON & ASSOCIATES ENGINEERS rst National Bank of Alvin Buildin 1600 East Highway 6, Suite 331 Alvin, Texas 77511 T: (832)526-0160 Nechanical • Electrical •
 • Plumbing Design •
 • Firm Registration #F1288

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		ISSUE DATES
	DATE	DESCRIPTION
	05/03/22	REVIEW SET
凶	10/24/22	OWNER REVISION
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-		
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-		NO FOT TEAL
		PROJECT TEAM
IP C	HONER:	James E Thompson & Associates
		1169 County Road 136A
		Alvin, Texas 77511
		832.526.0160
TRUC	TURAL ENCANEER	CJG Engineers
		3200 Wilcrest Dr. Suite 305
		Houston, Texos 77042
		713.780.3345

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Shelter 77979 5 Additions Texas Animal Lavca, and Port Renovations Ca Stringham ava ヒ 201 0



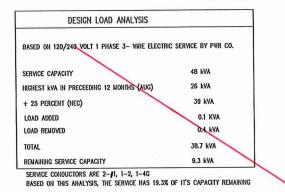


PROJECT

2209

05/03/2022 POWER PLAN SHEET NO.

E2.0



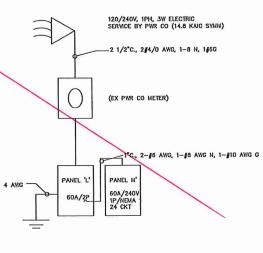
	EL "L" EXIS BUS	TING			120/24	40V 1PH 3W		URFACE	MOUNT
10 KA	dC.		1		125A M	ICB, 125A BUS	NE	UTRAL	GND BUS
NO.	DESCRIPTION	LOAD	WIRE	OCP	NO.	DESCRIPTION	LOAD	WIRE	OCP
1	OFFICE LTS	900	12	20	2	CAT PLUGS	3000	3	100
3	OFFICE LTS	900	12	2P	4			3	2P
5	OFFICE LTS	900	12	20	6	RECEPTS OFF	360	12	20
7	RECEP KENNE	720	12	2P	8	LTS OFFICE	360	12	2P
9	OUTSIDE LTS	360 360	12	20 20	10	LTS OFFICE	360	12	20
11	KENNEL LTS	360 360	12 12	20 20	12	WATER HEATER	2000	10	30
13	MISC	4000	10	50	14	-	-	10	2P
15			10	2P	16	MISC	300	6	60
17	MISC	3000	10	30	18			6	2P
19			10	2P	20	MISC	300	12	20
21	MISC	3000	10	30	22	SUBFEED	300	6	60
23			10	2P	24		300	6	2P

	LIGHT FIXTURE	E SCHEDULE		
TYPE	MANUFACTURER & MODEL	FINISH	MOUNTING	NO., SIZE & TYPE
A	2x4 LED, PLT SOLNS PLT-90093	WHITE	CHAIN	1-16W LED

		14860 AMPA	CITY R	EQ'D=	15460/2	40 X 1.25=80.5	6980 AMPS		
PAN CU 10 KA	IEL "M" EXI BUS	STING				40V 1PH 3W LO, 60A BUS	300 N	URFACE EMA 3R EUTRAL+	
NO.	DESCRIPTION	LOAD	WIRE	OCP	NO.	DESCRIPTION	LOAD	WIRE	OCP
1	MISC		12	20	2	MISC		12	20
3	MISC		12	20	4	LTS	80	12	20
5	MISC		12	20	6				
7	MISC		12	20	8				

ES BEFORE ORDE 2. ALL FIXTURES TO BE "OR EQUAL".

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ONE LINE DIAGRAM NTS



	188UE DATES					
DATE	DESCRIPTION					
05/03/22	REVIEW SET					
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_						
	PROJECT TEAM					
MEP EXCINETE	James E Thompson & Associates					
	921 Bloom Drive					
	Galveston Texas 77554					
	832.526.0160					
STRUCTURAL ENGINEER	CJG Engineers					
	3200 Wilcrest Dr. Suite 305					
	Houston, Texas 77042					
	713.780.3345					

tions was a neuronal content, to the of this section deriving its operate to exame a limpositibility (for ony modificity is at use at 85s deriving file that is inconsistent with the reprintments of the Mete and Regulations of the Term Board of the Addacted Content, his period may make any modification is this section deriving file without the Architel's express within permission.

201 Stringham Port Lavca, Texas 77979 Port Lavaca Animal Shelter and Additions to Renovations

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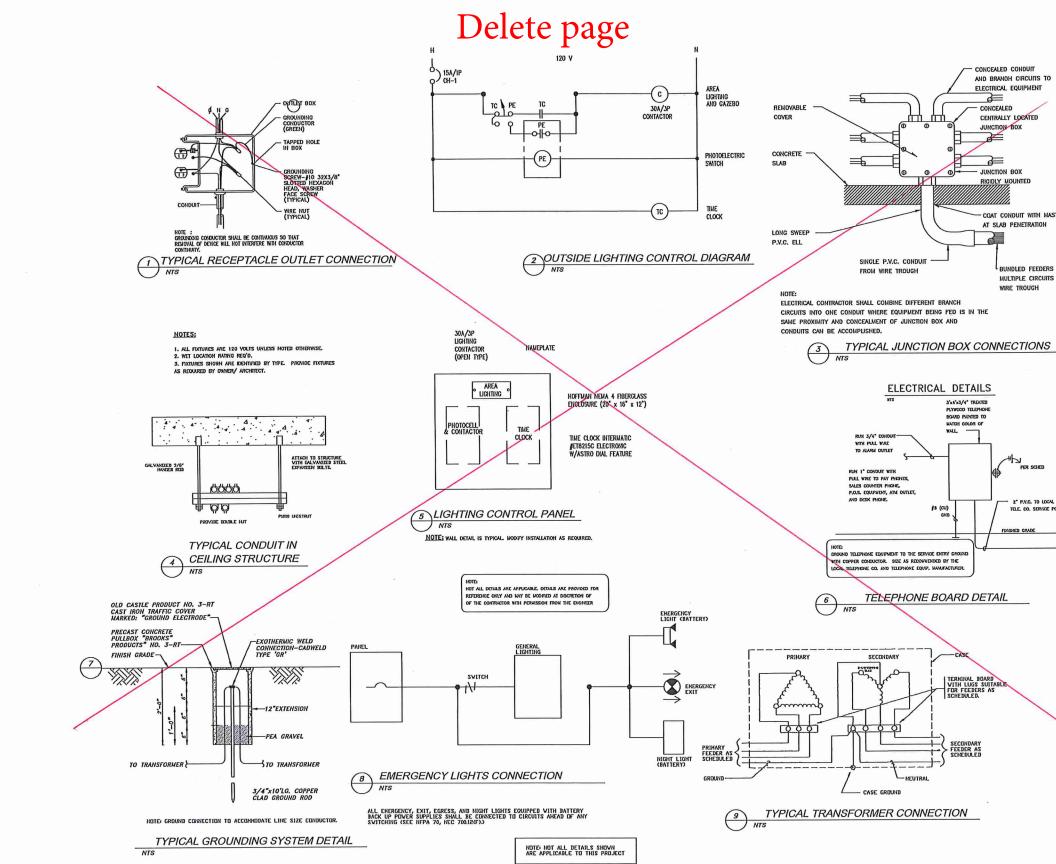
Architects

2855 Mangum Suite 566 Houslon, Texas 77092 (713) 823-1660

SA PROJECT NO .:



2209 DATE: 05/03/2022 SHEET TITLE: ELEC SCHEDULES/ONE LINE SHEET NO .: E2.0



- COAT CONDUIT WITH MASTIC

BUNDLED FEEDERS FOR MULTIPLE CIRCUITS FROM WIRE TROUGH

PER SCHED

2" P.Y.C. TO LOCAL TELE, CO. SERVICE PONT



JAMES E. **THOMPSON &** ASSOCIATES ENGINEERS First National Bank of Alvin Buildin 1600 East Highway 6, Suile 331 Alvin, Texas 77511 T: (832)526-0160

Mechanical • Electrical •
 • Plumbing Design•
 • Firm Registration #F1288

DATE	DESCRIPTION
05/03/22	Review set
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_	
	PROJECT TEAM
VEP DKRNEDR	
VEP DIGNEDR:	James E Thompson & Asso 921 Blume Drive
NEP DKINEDR	James E Thompson & Asso 921 Blume Drive Galveston, Texas 77554
VEP DIGNEDIC	James E Thompson & Asso 921 Blume Drive Galveston, Texas 77554 832.526.0160
VEP DIGNEDE	James E Thompson & Asso 921 Blume Drive Galveston, Texas 77554 832.526.0160 CJG Engineers
	James E Thompson & Asso 921 Blume Drive Galveston, Texas 77554 832:526.0160 CJG Engineers 3200 Wilcrest Dr. Suite 30
	James E Thompson & Asso 921 Blume Drive Galveston, Texas 77554 832.526.0160 CJG Engineers 3200 Wilcrest Dr. Suite 30 Houston, Texas 77042
	James E Thompson & Asso 921 Blume Drive Galveston, Texas 77554 832:526.0160 CJG Engineers 3200 Wilcrest Dr. Suite 30
	James E Thompson & Asso 921 Blume Drive Galveston, Texas 77554 832.526.0160 CJG Engineers 3200 Wilcrest Dr. Suite 3 Houston, Texas 77042

199 E DATES

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Architects 2855 Mangum Suite 566 Houston, Texas 770 (713) 823-1650

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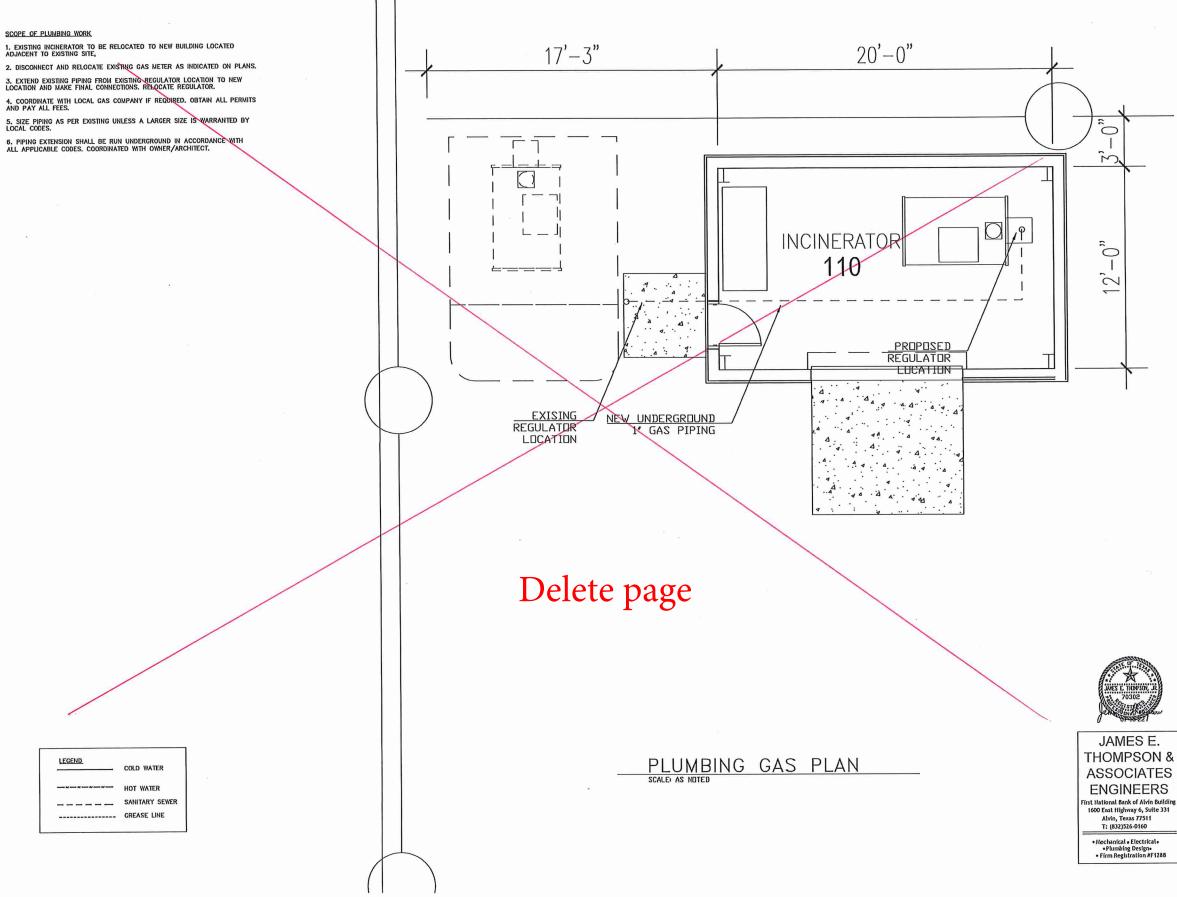
2209 DATE:

05/03/2022

SHEET TITLE ELECTRICAL DETAILS

SHEET NO .:

E3.0



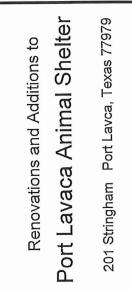
5. SIZE PIPING AS PER EXISTING UNLESS A LARGER SIZE IS WARRANTED BY LOCAL CODES.

3. EXTEND EXISTING PIPING FROM EXISTING REGULATOR LOCATION TO NEW LOCATION AND MAKE FINAL CONNECTIONS. RELOCATE REGULATOR.

SCOPE OF PLUMBING WORK

	ISSUE DATES
DATE	DESCRIPTION
05/03/22	REVIEW SET
	PROJECT TEAM
NEP ENGNEEDE	James E Thompson & Associates 921 Blume Drive
	Galveston, Texas 77554 832.526.0160
STRUCTURAL ENGINE	R CJG Engineers
	3200 Wilcrest Dr. Suite 305
	Houston, Texos 77042 713.780.3345

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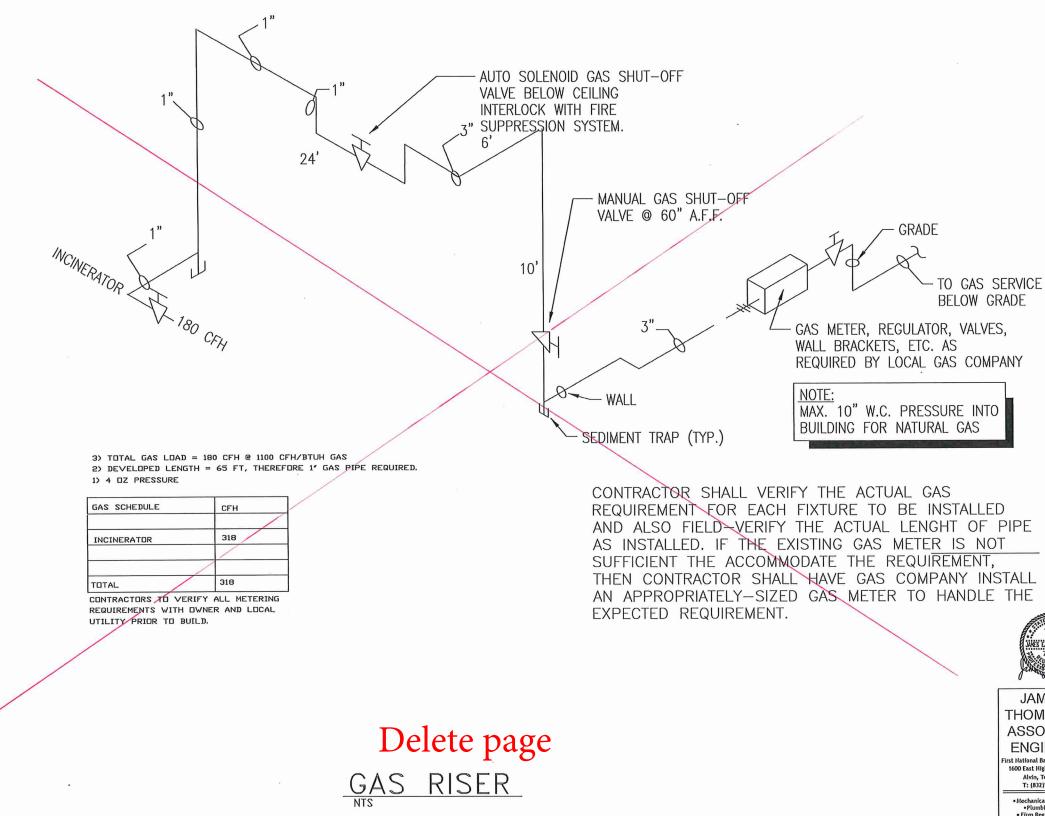


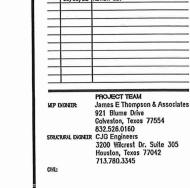
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SHEET TITLE: PLUNBING FLOOR PLANS

SHEET NO .:

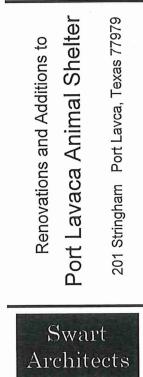
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DATE 05/03/22

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