


PRIMARY FACADE

SECONDARY FACADES

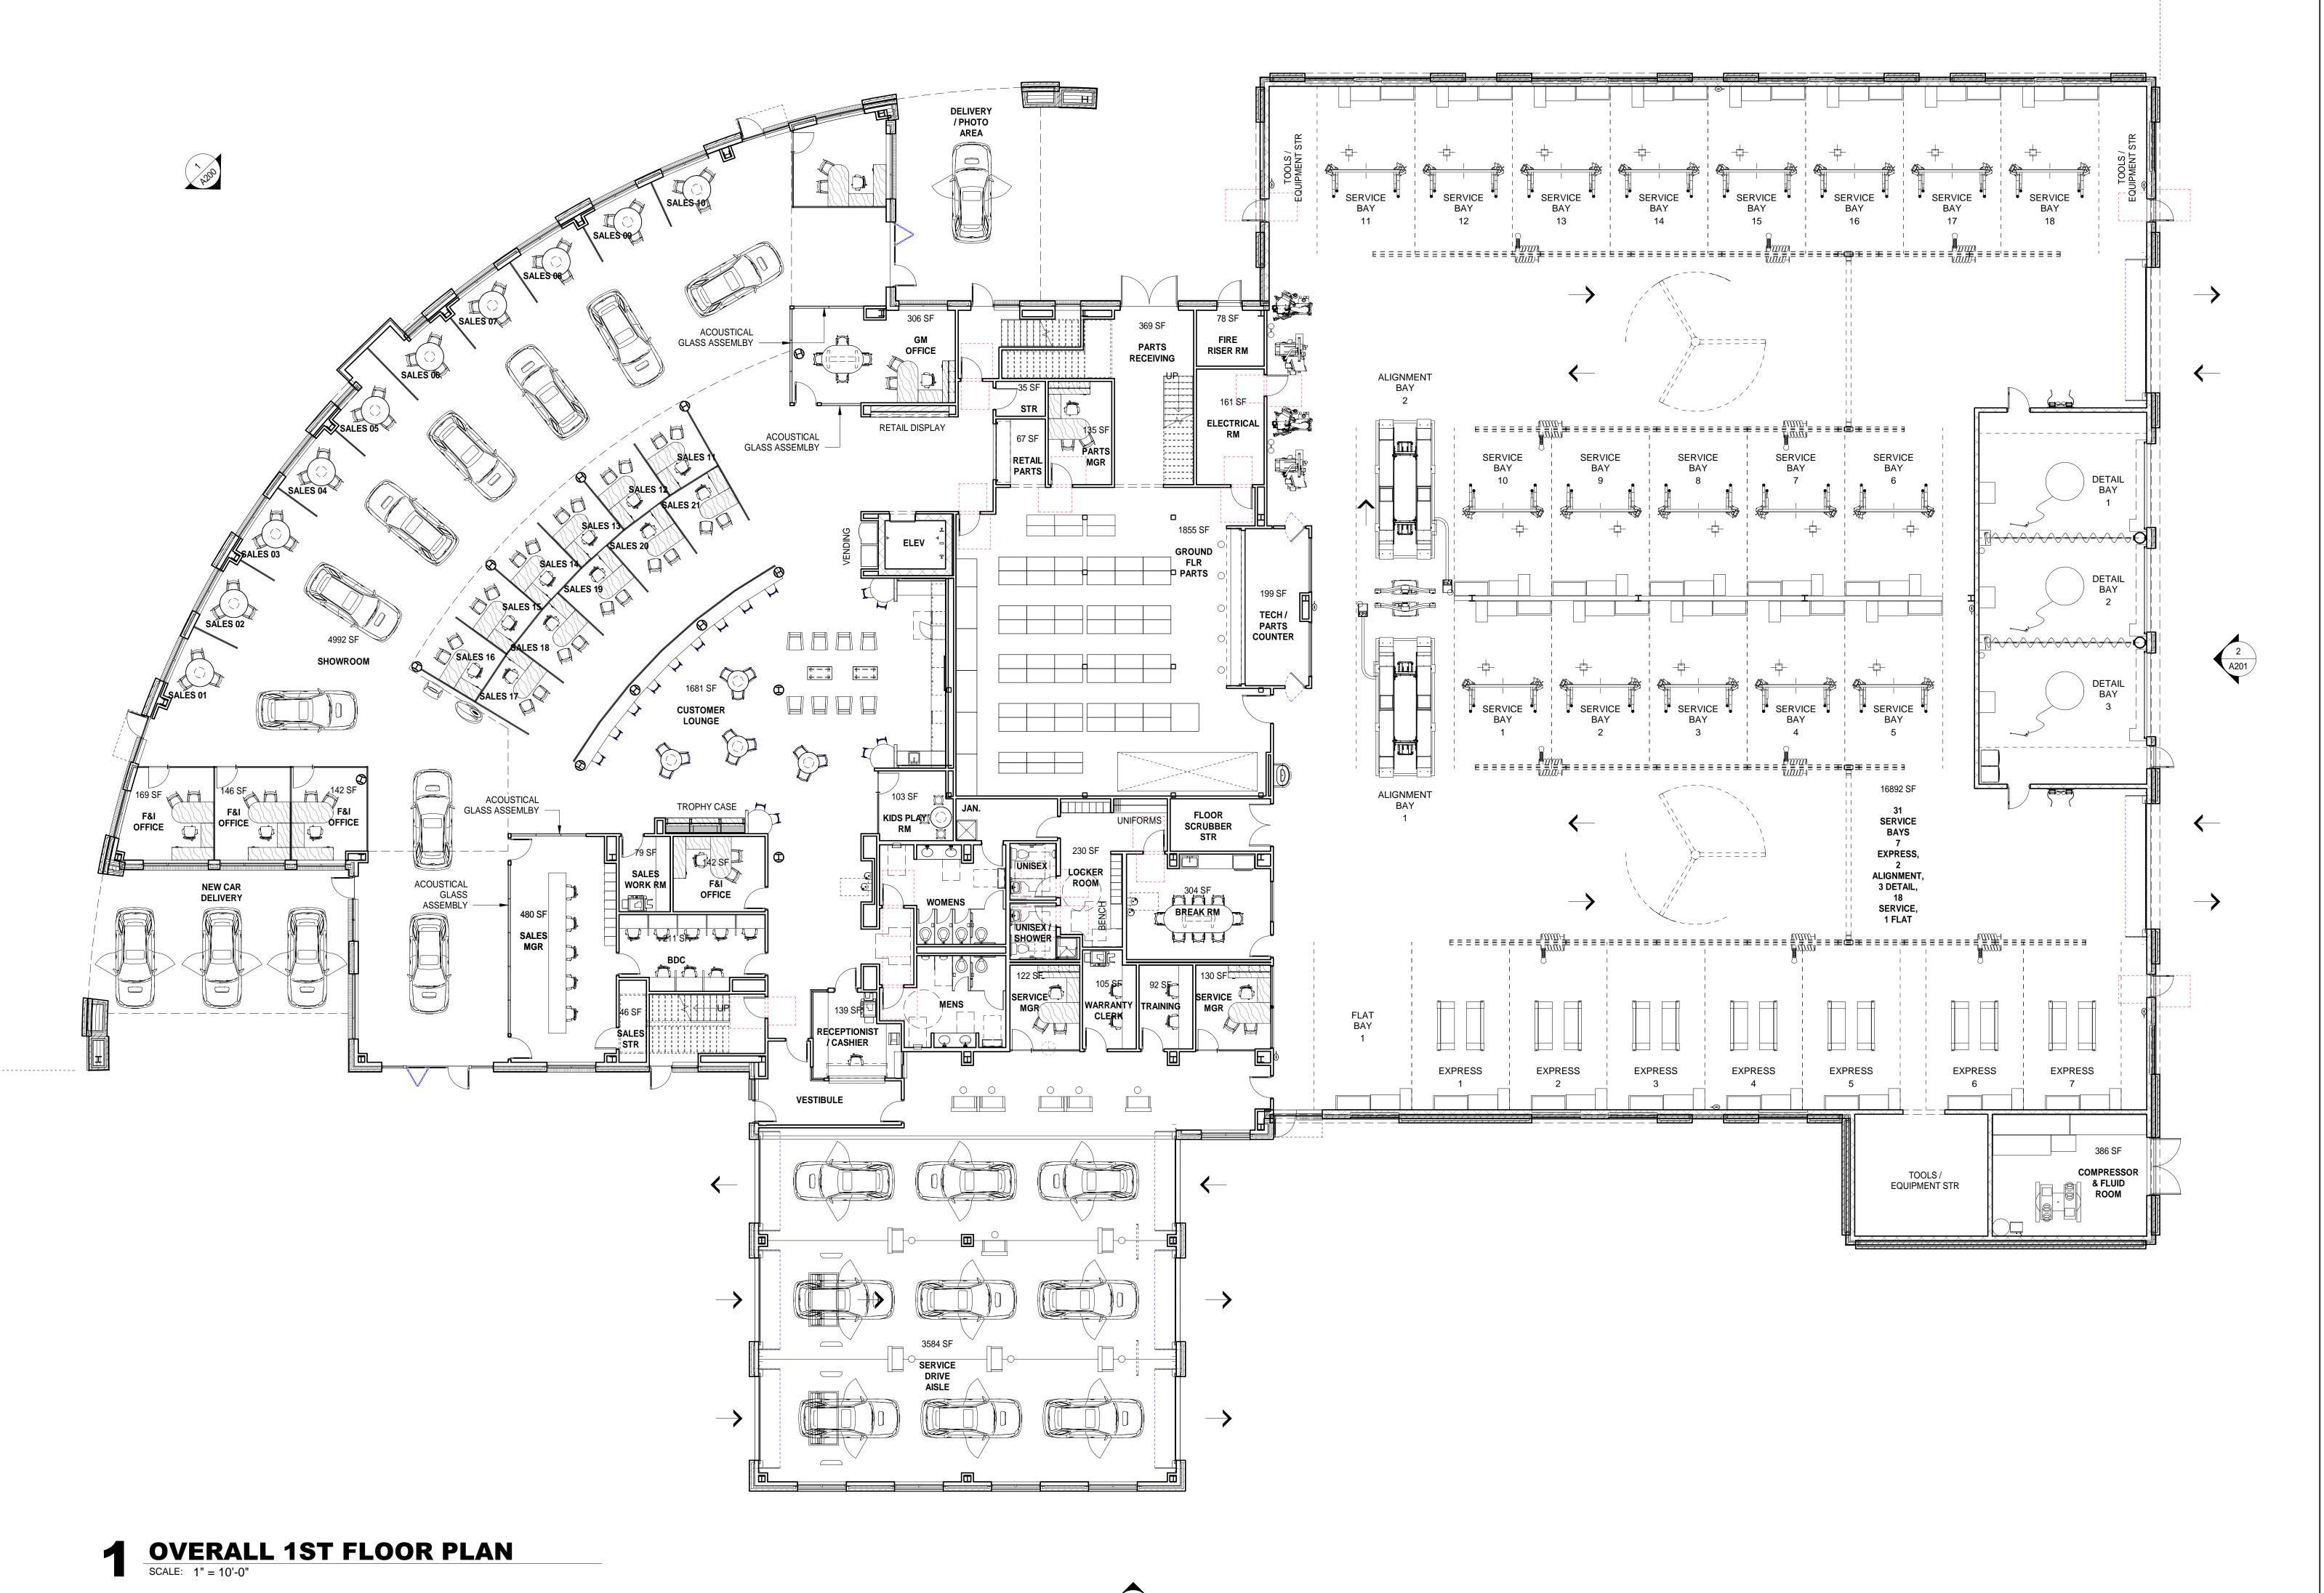





SUBARU SOUTH CHARLOTTE

10400 CADILLAC ST PINEVILLE, NC 28134 KEY PLAN

Revisions
Date Description

Project Number: 20116
Issued for: PRELIMINARY V11
Issue Date: 2021-05-19

1ST FLOOR PLAN

SHEET NUMBER
A 1 0 1

PRIMARY FACADE

SECONDARY FACADES

5/19/2021 2:07:40 PM







10400 CADILLAC ST PINEVILLE, NC 28134 KEY PLAN

Revisions
Date Description

COLOR: TAYLOR BRICK "FRENCH GRAY WIRECUT" MORTAR COLOR: HOLCIM MORTAMIX "TYPE S" SEALANT COLOR: BASF NP1/NP2 "GRAY"	
BRICK: 3-5/8" x 2-1/4" x 7-5/8" MODULAR WIRECUT PATTERN: SOLDIER COURSE COLOR: TAYLOR BRICK "FRENCH GRAY WIRECUT" MORTAR COLOR: HOLCIM MORTAMIX "TYPE S" SEALANT COLOR: BASF NP1/NP2 "GRAY"	
BRICK: 3-5/8" x 2-1/4" x 7-5/8" MODULAR WIRECUT PATTERN: SOLDIER/ROWLOCK/HEADER COURSE (SEE DETAILS) COLOR: TAYLOR BRICK "BLACK ONYX WIRECUT" MORTAR COLOR: HOLCIM MORTAMIX "TYPE S" SEALANT COLOR: BASF NP1/NP2 "GRAY"	
BRICK: 3-5/8" x 2-1/4" x 7-5/8" MODULAR WIRECUT PATTERN: RUNNING BOND COLOR: TAYLOR BRICK "BLACK ONYX WIRECUT" MORTAR COLOR: HOLCIM MORTAMIX "TYPE S" SEALANT COLOR: BASF NP1/NP2 "GRAY"	
BRICK: 3-5/8" x 3-5/8" x 11-5/8" NOM. UTILITY WIRECUT PATTERN: RUNNING BOND COLOR: TAYLOR BRICK "BLACK ONYX WIRECUT" MORTAR COLOR: HOLCIM MORTAMIX "TYPE S" SEALANT COLOR: BASF NP1/NP2 "GRAY"	
BRICK: 3-5/8" x 2-1/4" x 7-5/8" MODULAR WIRECUT PATTERN: RUNNING BOND COLOR: TAYLOR BRICK "#323 GRAY WIRECUT" MORTAR COLOR: HOLCIM MORTAMIX "TYPE S" SEALANT COLOR: BASF NP1/NP2 "GRAY"	
BRICK: 3-5/8" x 2-1/4" x 7-5/8" MODULAR WIRECUT	

PATTERN: SOLDIER/ROWLOCK/HEADER COURSE (SEE DETAILS)

PATTERN: SOLDIER/ROWLOCK/HEADER COURSE (SEE DETAILS)

EXPOSED METAL / STEEL: PRIMER SHERWIN WILLIAMS KEM KROMIK

WILLIAMS PRO INDUSTRIAL WATERBASED ALKYD URETHANE SEMI-

KAWNEER MEDIUM-STILE ALUMINUM STOREFRONT WITH

UNIVERSAL METAL PRIMER B50WZ1 WITH 2 COATS SHERWIN

MORTAR COLOR: HOLCIM MORTAMIX "TYPE S" SEALANT COLOR: BASF NP1/NP2 "GRAY"

BRICK: 3-5/8" x 2-1/4" x 7-5/8" MODULAR WIRECUT
PATTERN: RUNNING BOND
COLOR: TAYLOR BRICK "PEBBLE GRAY SMOOTH"
MORTAR COLOR: HOLCIM MORTAMIX "TYPE S"
SEALANT COLOR: BASF NP1/NP2 "GRAY"

BRICK: 3-5/8" x 2-1/4" x 7-5/8" MODULAR WIRECUT

MORTAR COLOR: HOLCIM MORTAMIX "TYPE S"

"#40 DARK BRONZE" FINISH PER AA-M10C21A44

GLOSS B53-1150, COLOR "SW6991 BLACK MAGIC"

ACM METAL PANEL "SILVER" (NON-REFLECTIVE)

ACM METAL PANEL "AWARD BLUE" (NON-REFLECTIVE)

SEALANT COLOR: BASF NP1/NP2 "GRAY"

BR4S COLOR: TAYLOR BRICK "PEBBLE GRAY SMOOTH"


THIN VENEER SLATE

Project Number: 20116
Issued for: PRELIMINARY V11
Issue Date: 2021-05-19


DRAWING TITLE
PRIMARY STREET
FACING

ELEVATIONS

SHEET NUMBER
A200

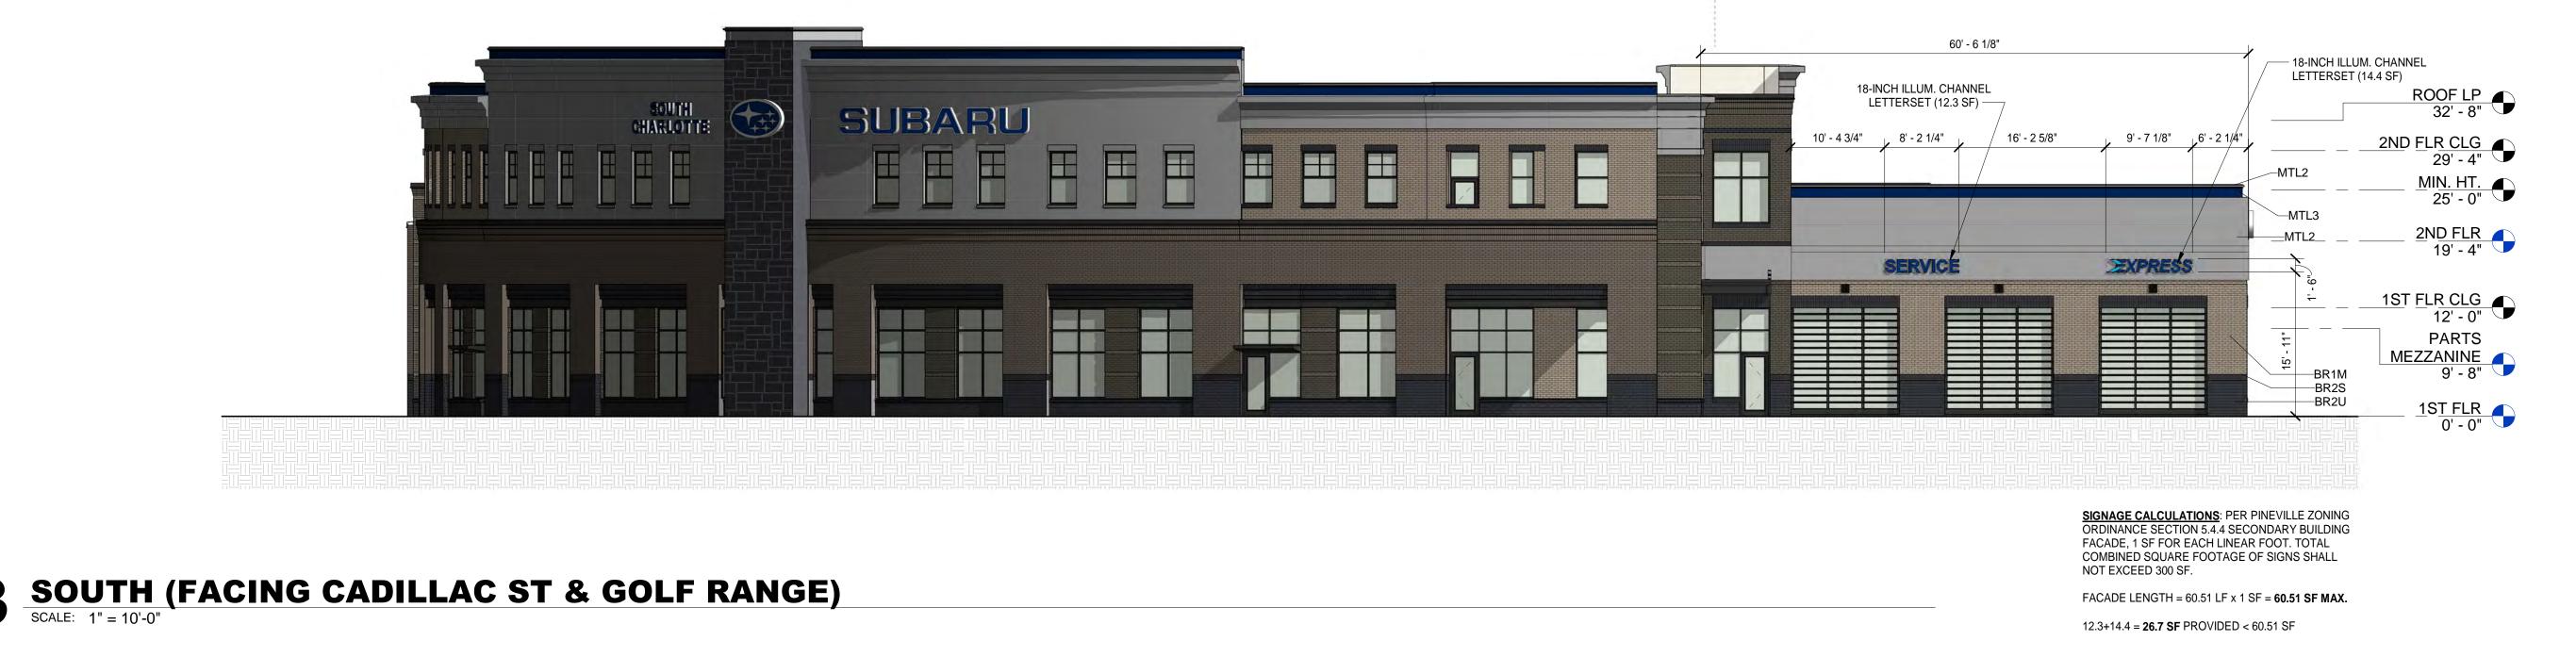

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SUBARU SOUTH **CHARLOTTE**

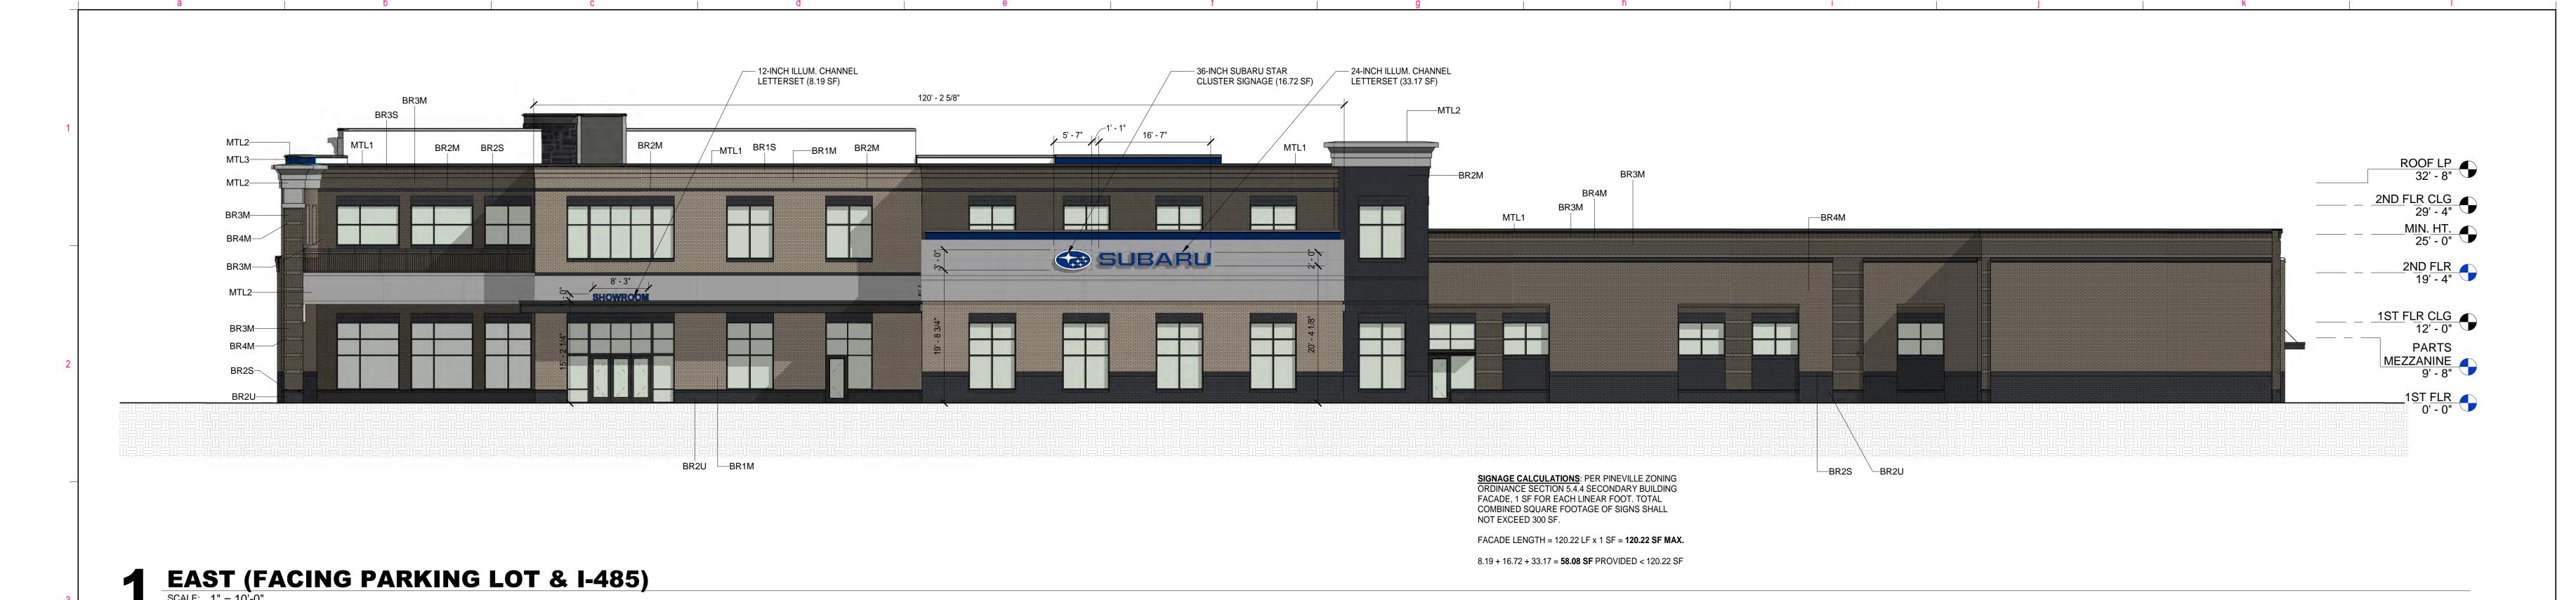10400 CADILLAC ST PINEVILLE, NC 28134 **KEY PLAN**

Revisions # Date Description

EXTERIOR MATERIALS

DESCRIPTION

BRICK: 3-5/8" x 2-1/4" x 7-5/8" MODULAR WIRECUT

COLOR: TAYLOR BRICK "FRENCH GRAY WIRECUT" MORTAR COLOR: HOLCIM MORTAMIX "TYPE S"

BRICK: 3-5/8" x 2-1/4" x 7-5/8" MODULAR WIRECUT

MORTAR COLOR: HOLCIM MORTAMIX "TYPE S" SEALANT COLOR: BASF NP1/NP2 "GRAY"

BRICK: 3-5/8" x 2-1/4" x 7-5/8" MODULAR WIRECUT

BRICK: 3-5/8" x 2-1/4" x 7-5/8" MODULAR WIRECUT

COLOR: TAYLOR BRICK "BLACK ONYX WIRECUT"

BRICK: 3-5/8" x 3-5/8" x 11-5/8" NOM. UTILITY WIRECUT

MORTAR COLOR: HOLCIM MORTAMIX "TYPE S"

COLOR: TAYLOR BRICK "BLACK ONYX WIRECUT"

BRICK: 3-5/8" x 2-1/4" x 7-5/8" MODULAR WIRECUT

COLOR: TAYLOR BRICK "#323 GRAY WIRECUT"

MORTAR COLOR: HOLCIM MORTAMIX "TYPE S" SEALANT COLOR: BASF NP1/NP2 "GRAY"

BRICK: 3-5/8" x 2-1/4" x 7-5/8" MODULAR WIRECUT

MORTAR COLOR: HOLCIM MORTAMIX "TYPE S" SEALANT COLOR: BASF NP1/NP2 "GRAY"

BRICK: 3-5/8" x 2-1/4" x 7-5/8" MODULAR WIRECUT

COLOR: TAYLOR BRICK "PEBBLE GRAY SMOOTH"

MORTAR COLOR: HOLCIM MORTAMIX "TYPE S"

BRICK: 3-5/8" x 2-1/4" x 7-5/8" MODULAR WIRECUT

MORTAR COLOR: HOLCIM MORTAMIX "TYPE S"

"#40 DARK BRONZE" FINISH PER AA-M10C21A44

GLOSS B53-1150, COLOR "SW6991 BLACK MAGIC"

ACM METAL PANEL "AWARD BLUE" (NON-REFLECTIVE)

ACM METAL PANEL "SILVER" (NON-REFLECTIVE)

SEALANT COLOR: BASF NP1/NP2 "GRAY"

SEALANT COLOR: BASF NP1/NP2 "GRAY"

PATTERN: SOLDIER/ROWLOCK/HEADER COURSE (SEE DETAILS)

PATTERN: SOLDIER/ROWLOCK/HEADER COURSE (SEE DETAILS)

EXPOSED METAL / STEEL: PRIMER SHERWIN WILLIAMS KEM KROMIK UNIVERSAL METAL PRIMER B50WZ1 WITH 2 COATS SHERWIN

WILLIAMS PRO INDUSTRIAL WATERBASED ALKYD URETHANE SEMI-

KAWNEER MEDIUM-STILE ALUMINUM STOREFRONT WITH

MORTAR COLOR: HOLCIM MORTAMIX "TYPE S"

SEALANT COLOR: BASF NP1/NP2 "GRAY"

COLOR: TAYLOR BRICK "BLACK ONYX WIRECUT" MORTAR COLOR: HOLCIM MORTAMIX "TYPE S"

SEALANT COLOR: BASF NP1/NP2 "GRAY"

SEALANT COLOR: BASF NP1/NP2 "GRAY"

PATTERN: SOLDIER/ROWLOCK/HEADER COURSE (SEE DETAILS)

SEALANT COLOR: BASF NP1/NP2 "GRAY"

PATTERN: RUNNING BOND

PATTERN: SOLDIER COURSE

BR1S COLOR: TAYLOR BRICK "FRENCH GRAY WIRECUT"

PATTERN: RUNNING BOND

PATTERN: RUNNING BOND

PATTERN: RUNNING BOND

BR3S COLOR: TAYLOR BRICK "#323 GRAY WIRECUT"

PATTERN: RUNNING BOND

BR4S COLOR: TAYLOR BRICK "PEBBLE GRAY SMOOTH"

THIN VENEER SLATE


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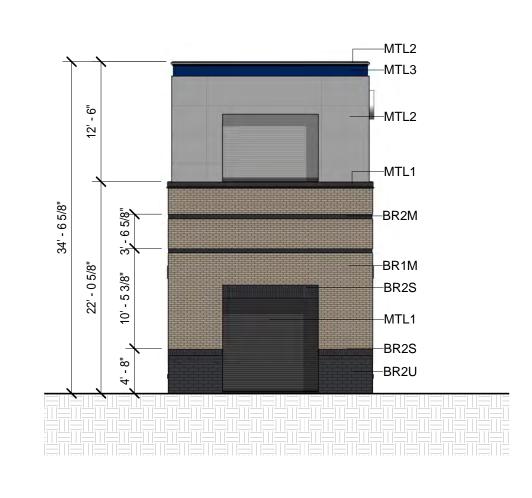
PRELIMINARY V11 Issued for: Issue Date: 2021-05-19 SECONDARY & CAR WASH **ELEVATIONS**

SHEET NUMBER

NORTH (FACING I-485)

SCALE: 1" = 10'-0"



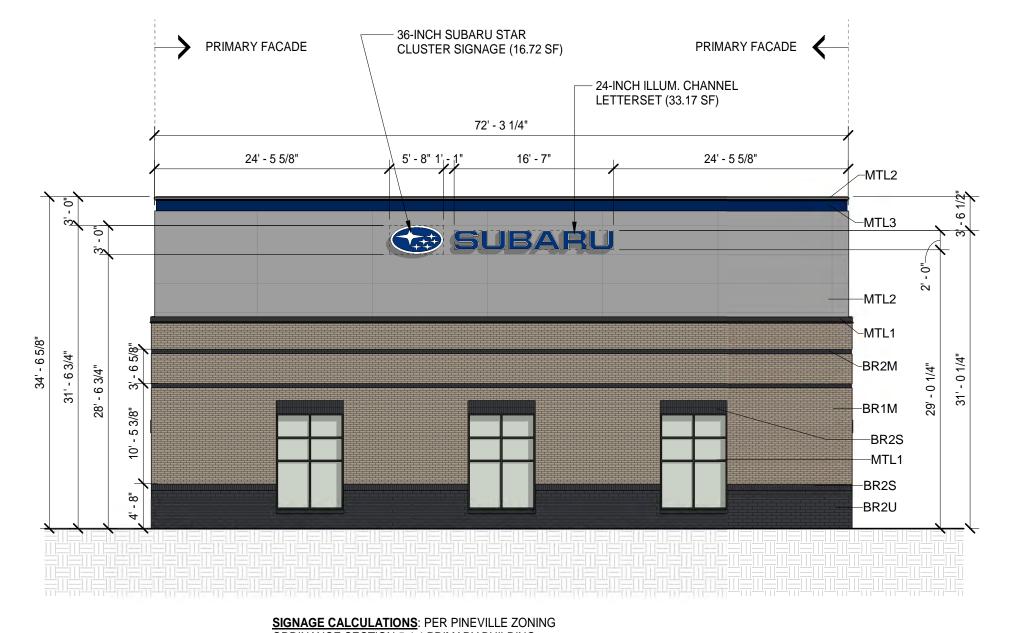



2ND FLR CLG 29' - 4"

-BR3M

BR4M

-BR2S

−BR2M

-BR2S

-BR2U

25' - 0"

2ND FLR 19' - 4"

1ST FLR CLG

12' - 0"

PARTS

9' - 8"

MEZZANINE _

ORDINANCE SECTION 5.4.4 PRIMARY BUILDING FACADE, 2 SF FOR LINEAR FOOT OF WALL FRONTAGE OR 5% OF WALL WHICHEVER IS GREATER. TOTAL COMBINED SQUARE FOOTAGE OF SIGNS SHALL NOT EXCEED 300 SF. FACADE AREA = 2,497 SF x 5% = 125 SF FACADE LENGTH = 72.27 LF x 2 SF = 145 SF MAX. 16.72 + 33.17 = **49.89 SF** PROVIDED < 145 SF

MTL2-

BR1M-

BR2S-

BR2U-

CAR WASH (FACING I-485)

SCALE: 1" = 10'-0"

5/19/2021 2:09:04 PM

4 CAR WASH (ENTER / EXIT)

SCALE: 1" = 10'-0"

5 CAR WASH (FACING PARKING LOT)
SCALE: 1" = 10'-0"





2 3D PERSPECTIVE (LOOKING DOWN CADILLAC ST)
SCALE:



SUBARU SOUTH CHARLOTTE

10400 CADILLAC ST PINEVILLE, NC 28134

Revisions

Project Number: Issued for: Issue Date:

3D AXON &
PERSPECTIVE
FROM CADILLAC

ST SIDE
SHEET NUMBER

A300

1 3D AXON (CADILLAC ST SIDE)
SCALE:







SUBARU SOUTH CHARLOTTE

10400 CADILLAC ST PINEVILLE, NC 28134 KEY PLAN

Revisions

Date Description

Date Description

Project Number: Issued for: Issue Date:

20116 PRELIMINARY V11 2021-05-19

3D AXON &
PERSPECTIVE
VIEWS FROM
PARKING LOT

SHEET NUMBER
A301


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1 3D AXON (I-485 SIDE)
SCALE:

5/19/2021 2:10:02 PM

2 3D PERSPECTIVE (LOOKING FROM PARKING LOT SIDE)
SCALE:



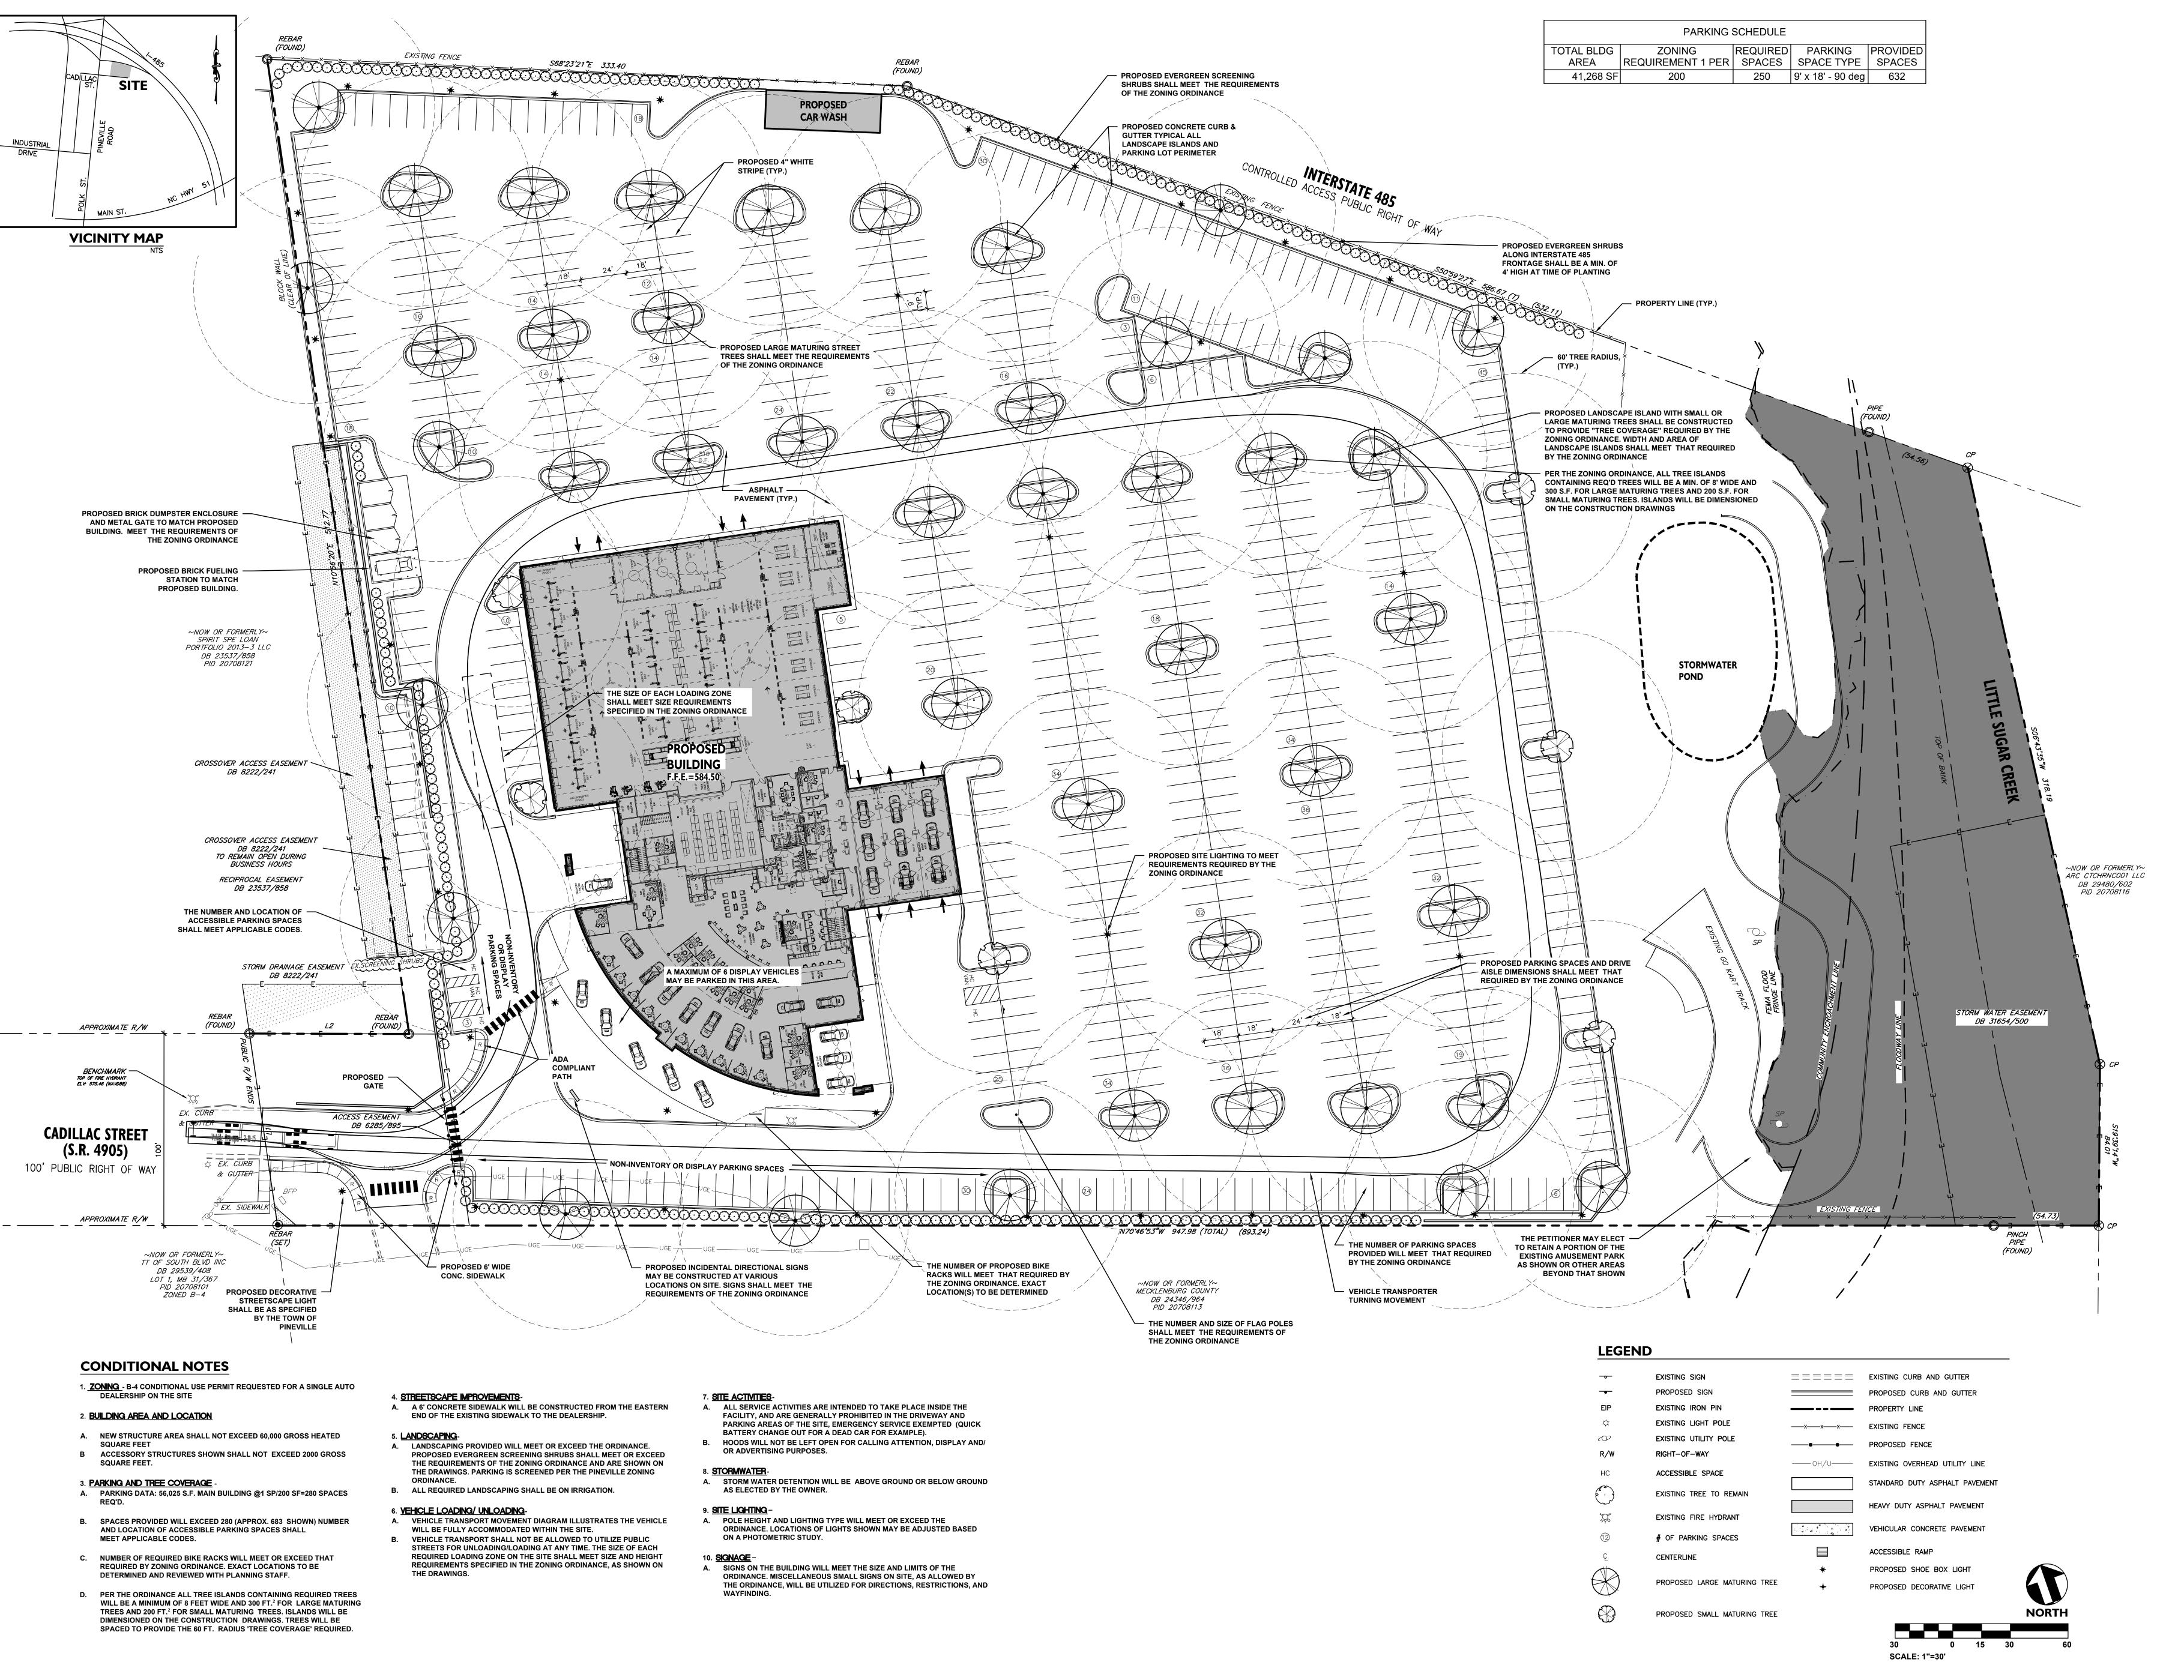

Seals:

PRELIMINARY NOT FOR

Corp. NC License: F-1320



17.000438 Project No:

Date: Revisions:


Sheet Title:

Conditional Use Plan

Sheet No:



Page 1 of 2

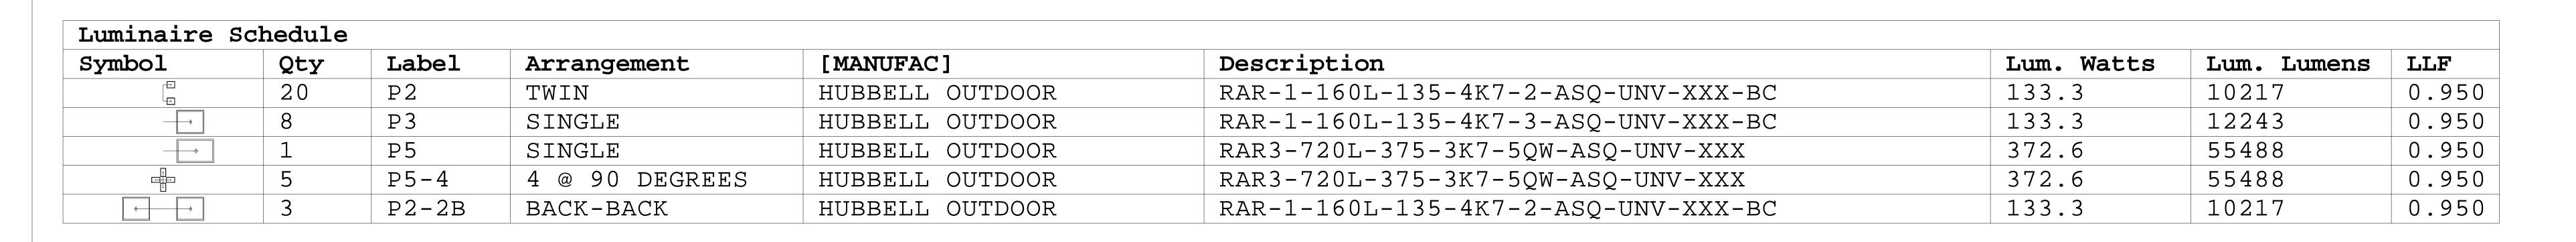

Calculation Summary							
Label	CalcType	Units	Avg	Max	Min	Avg/Min	Max/Min
PARKING LOT	Illuminance	Fc	4.99	30.0	0.0	N.A.	N.A.
PROPERTY LINE	Illuminance	FC	0.36	7.2	0.0	N.A.	N.A.
FRONT ROW PARKING	Illuminance	Fc	16.05	30.0	4.9	3.28	6.12
INTERIOR ROW PARKING SOUTH	Illuminance	Fc	14.10	29.2	6.2	2.27	4.71
INTERIOR ROW PARKING WEST	Illuminance	Fc	13.75	28.1	3.9	3.53	7.21
INVENTORY LOT	Illuminance	Fc	5.16	11.2	0.3	17.20	37.33

NOTES:

- 1) ALL CALCULATIONS TAKEN AT GROUND LEVEL.
- 2) MOUNTING HEIGHTS MARKED ON PLAN ARE FROM GROUND TO TOP OF FIXTURE.
- 3) PHOTOMETRIC TARGETS ARE BASED ON RECOMMENDED PRACTICE FOR AUTOMOTIVE DEALERSHIPS. SEE ACCOMPANYING DOCUMENT. SUBJECT TO CHANGE BASED ON FINAL APPROVAL FROM LOCAL AHJ.

DISCLAIMER:

Photometric calculations are performed in accordance with IESNA standards. Some differences between measured values and calculated results may occur due to tolerances in calculation methods, testing procedures, component performance, measurement techniques, and field conditions such as voltage and temperature variations. Input data used to generate the attached calculations such as room dimensions, reflectances, furniture and architectural elements significantly affect the lighting calculations. If the real environment conditions do not match the input data, differences will occur between measured and calculated values.



Comments	Note #1	Note #2	Note #3	Note #4	Note #5	
Date	mm/dd/yy Note #1	mm/dd/yy Note #2	mm/dd/yy Note #3	mm/dd/yy Note #4	mm/dd/yy Note #5	
#	01	02	03	04	0.5	
Revisions						