



SEAL



PROJECT

# PINEVILLE TOWNHOMES

PINEVILLE, NC

EZONING #2020-XXX

LANDDESIGN PROJ.# 1020037

## REVISION / ISSUANCE

[illegible]

DESIGNED BY: JRY  
DRAWN BY: JRY  
CHECKED BY: KST

SCALE

ERT: N/A  
ORZ: 1"=60'


SHEET TITLE

COVER

SHEET NUMBER

RZ-1



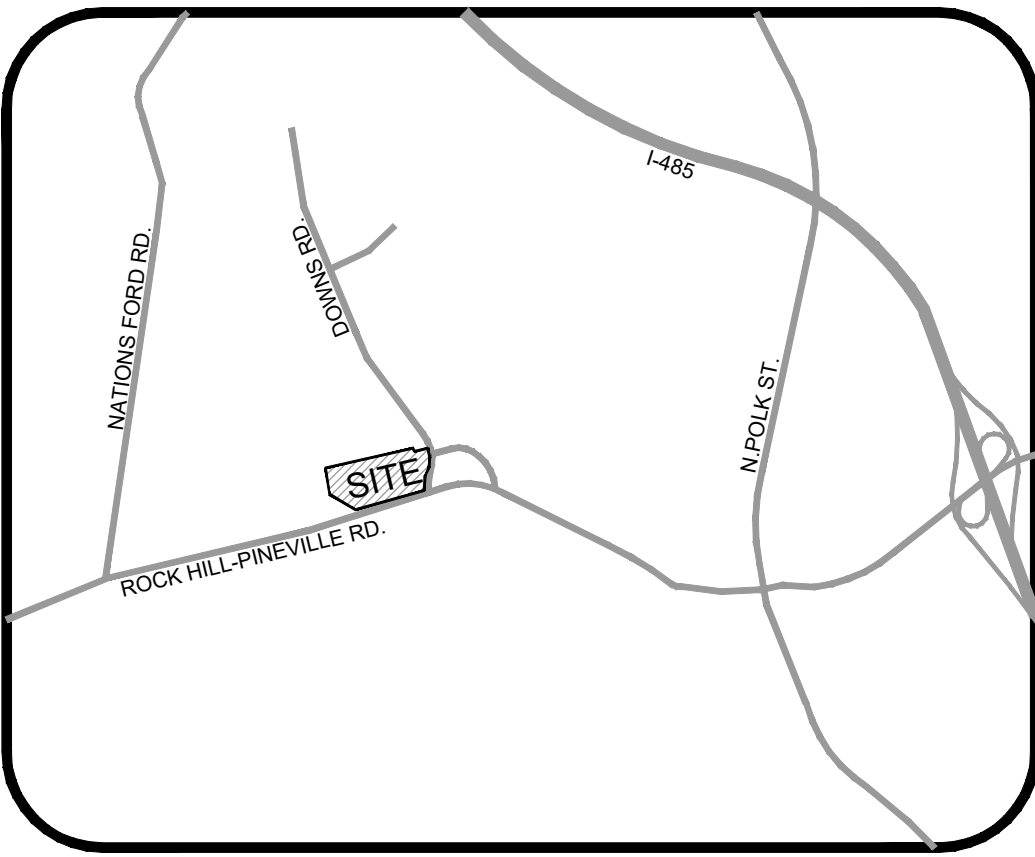

VICINITY MAP  
NTS

SITE DEVELOPMENT DATA

ACREAGE: ± 26.8 ACRES

TAX PARCEL #S: 205-041-02, 05-041-15, 05-041-16, 205-041-01,  
05-041-03, 05-041-04, 05-041-19

EXISTING ZONING: R-44, G-I

PROPOSED ZONING: R-MX (CORRIDOR OVERLAY DISTRICT)

EXISTING USES: INDUSTRIAL

PROPOSED USES: USES PERMITTED BY RIGHT AND UNDER  
PRESCRIBED CONDITIONS TOGETHER WITH ACCESSORY  
USES AS ALLOWED IN THE R-MX ZONING DISTRICT

MAX. DENSITY PROVIDED: 166 UNITS (6.19 UNITS PER ACRE)

MAX. BUILDING HEIGHT REQUIRED: 3 STORIES, 3+ WITH  
APPROVAL FROM TOWN COUNCIL

MAX. BUILDING HEIGHT PROVIDED: 40'

MIN. SETBACK REQUIRED: BUILD-TO-LINE FROM STREET  
SECTIONS

MIN. SETBACK PROVIDED: 10'

MIN. SIDE YARD REQUIRED: 0'

MIN. SIDE YARD PROVIDED: 5' FOR CORNER LOTS

MIN. REAR YARD PROVIDED: 20' DRIVEWAY

PARKING REQUIRED: SPACES TOTAL

3+ BEDROOMS PER UNIT: 3.25 SPACES/UNIT

166 UNITS X 3.25 SPACES = 540 SPACES REQ.

PARKING PROVIDED: 816 SPACES TOTAL (4.92 SPACES/UNIT)

135 ON-STREET SPACES

332 GARAGE SPACES

332 DRIVEWAY SPACES

17 AMENITY SPACES

KEY MAP

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NO.	DESCRIPTION	DATE
1	REZONING SUBMITTAL	09.23.20
2	REZONING SUBMITTAL	10.20.20
3	REZONING SUBMITTAL	11.19.20
4	REZONING SUBMITTAL	12.18.20

DESIGNED BY: JRY  
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SCALE

VERT: N/A  
HORZ: 1"=100'

SHEET TITLE

TECHNICAL DATA




SHEET NUMBER

RZ-2








20' LANDSCAPE AREA

6 TREES PER 100 LF PROVIDED  
100% EVERGREEN / LARGE MATURING  
30 EVERGREEN SHRUBS PER 100 LF PROVIDED

PLANT SCHEDULE								
TREES	CODE	QTY	BOTANICAL NAME	COMMON NAME	MIN. CONT.	MIN. CAL.	MIN. HT.	REMARKS
	THGG	6	THUJA 'GREEN GIANT'	ARBOVITAE, 'GREEN GIANT'	B&B	2"	10-12'	MATCH SPECIMEN, FULL TO BASE
SHRUBS	CODE	QTY	BOTANICAL NAME	COMMON NAME	MIN. CONT.	SPACING	MIN. HT.	REMARKS
	PLJA	20	PIERIS JAPONICA	LILY OF THE VALLEY BUSH	3 GAL	AS SHOWN	24-36"	MATCH SPECIMEN, FULL TO BASE
	RHIM	10	RHAPHIOLEPIS INDICA 'MONTO'	INDIAN PRINCESS INDIAN HAWTHORN	3 GAL	AS SHOWN	24-36"	MATCH SPECIMEN, FULL TO BASE

NOTE: ADDITIONAL PLANTING TO BE PROVIDED/SUPPLEMENTED AS THE BUFFER AREA IS GRADED OR VOID OF EXISTING PLANT MATERIAL. PLANT MATERIAL MAY REMAIN IN AREAS WHERE BUFFER IS UNDISTURBED.

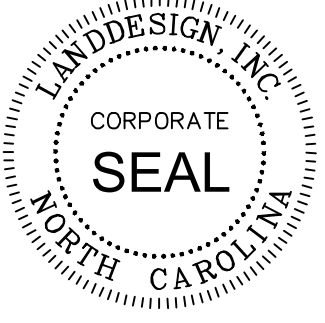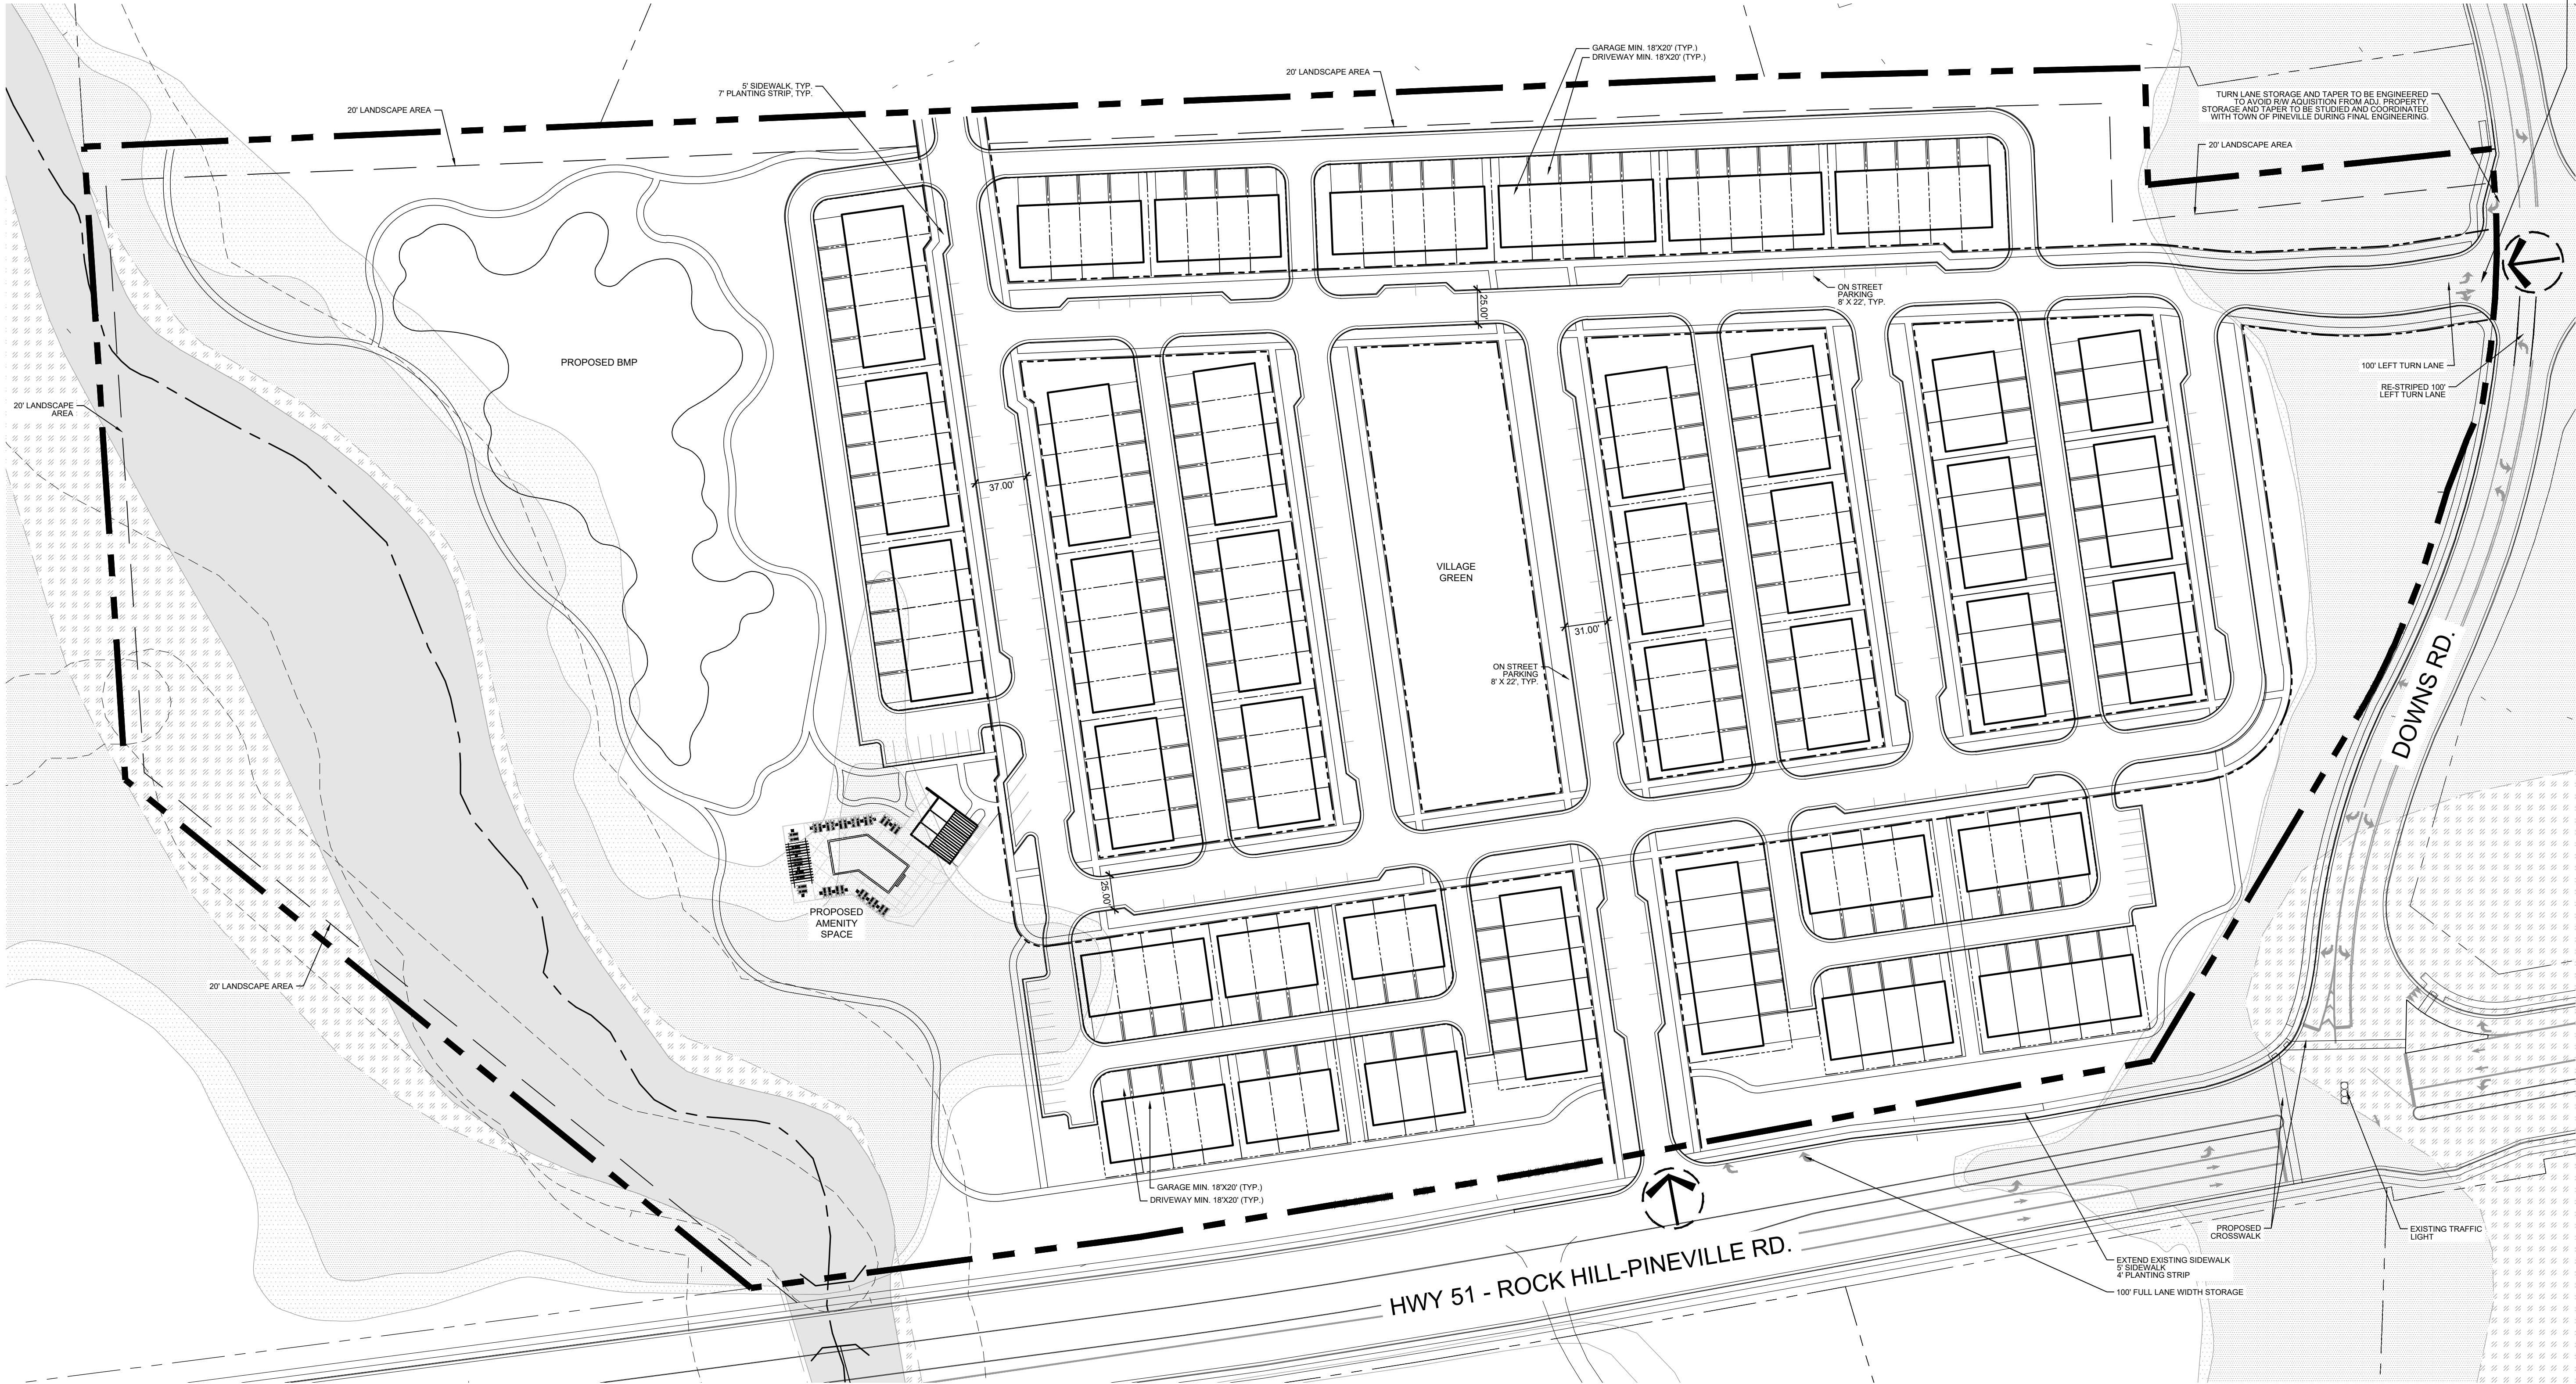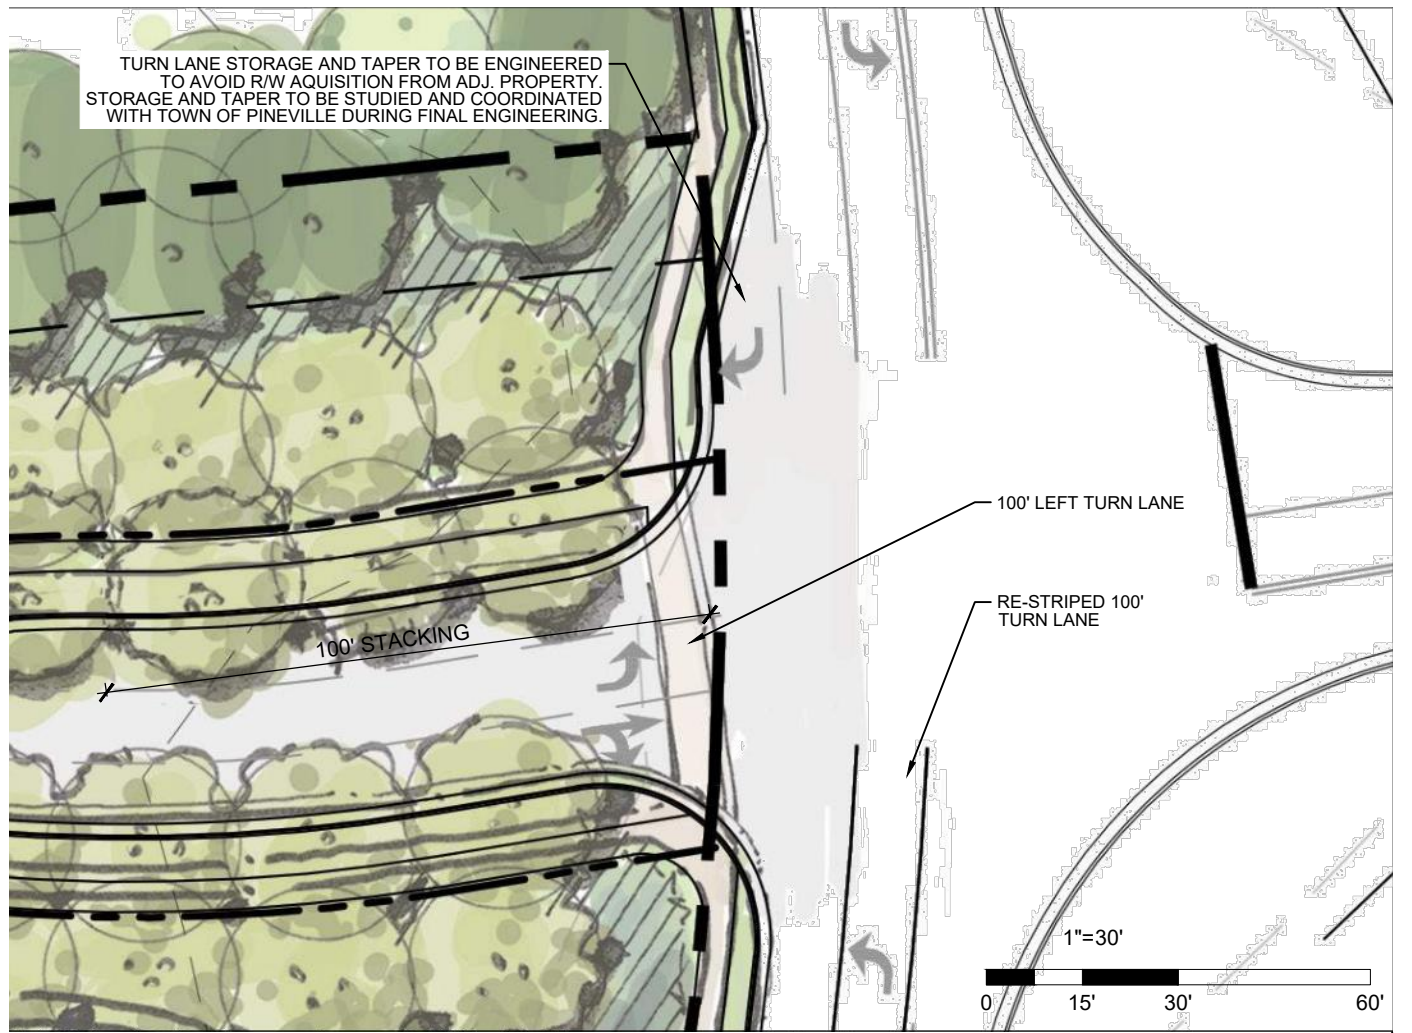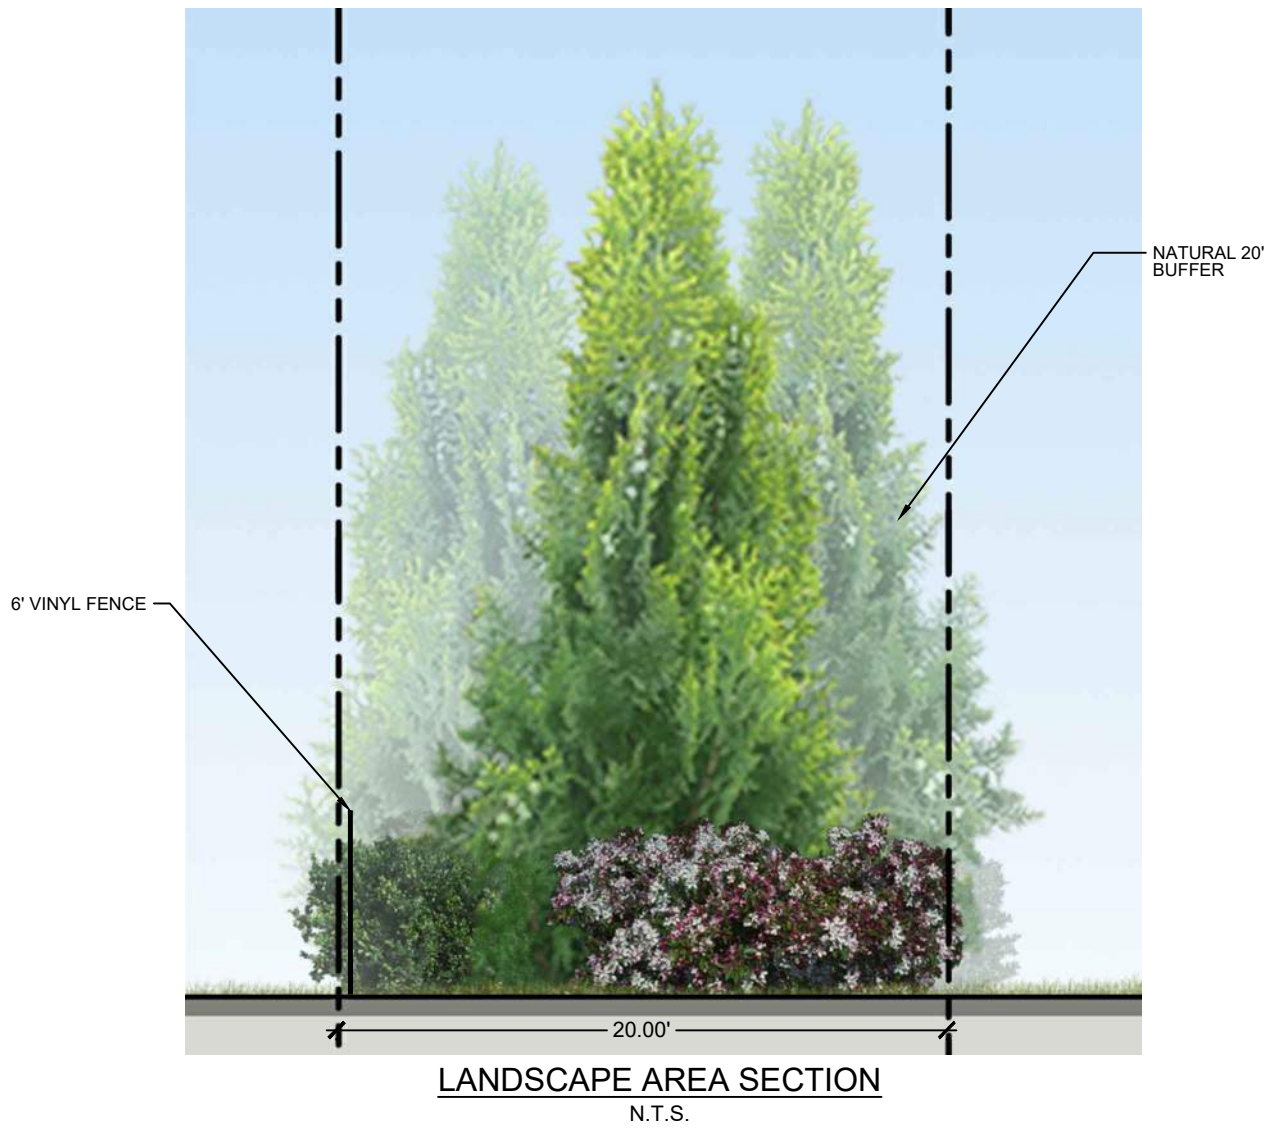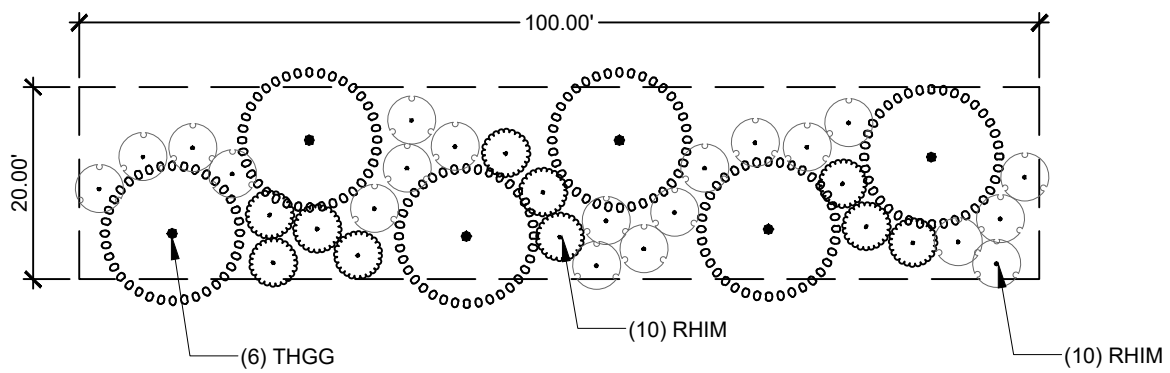

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HORZ: 1"=60'

SCHEMATIC SITE PLAN

RZ-3








Architectural drawing of a two-story house with a porch, showing dimensions and material specifications.

**Dimensions:**

- Overall width: 4'-0" MIN.
- Overall height: 8'-0"
- Roof pitch: 4:12
- Upper level height: 8'-11 1/8"
- Lower level height: 8'-0"
- Overall height including porch: 16'-11 1/8"
- Overall width including porch: 12'-0"

**Materials and Details:**

- FIBERGLASS ROOF SHINGLES (DOL. GLASS CL. TYP.)
- ALUM. GUTTER OVER 8" PASCAL W/ST. SCOTT 4 DOWNSPUTS, TYP.
- 4" GREEN ROLLED OVER 8" FREEZE TRIM, TYP.
- 24X12 1/2 THEN 14" 4" TYP.
- CORNER TRIM, TYP.
- HORIZONTAL SIDING, TYP.
- FLASH VENT MIN. 12" FROM EITHER SIDE
- SEE DETAIL A SHEET A-3A
- 5:12
- FIBERGLASS ROOF SHINGLES (OPT. METAL PORCH ROOF, OPT. BOSS)
- 5'8" HIGH - STD. SQUARE COLUMN, 4 TYP.
- 10' SQUARE COLUMN, 4 TYP.
- MAIN LVL. SUPPLR
- UPPER LVL. SUPPLR
- ROOF OF JOIST
- BRICK RO-BLOCK SILL, TYP.
- 4" BRICK VENEER
- 12" SQUARE COLUMN, 4 TYP.
- SUGGESTED HOUSE B BLOCK LOCATION

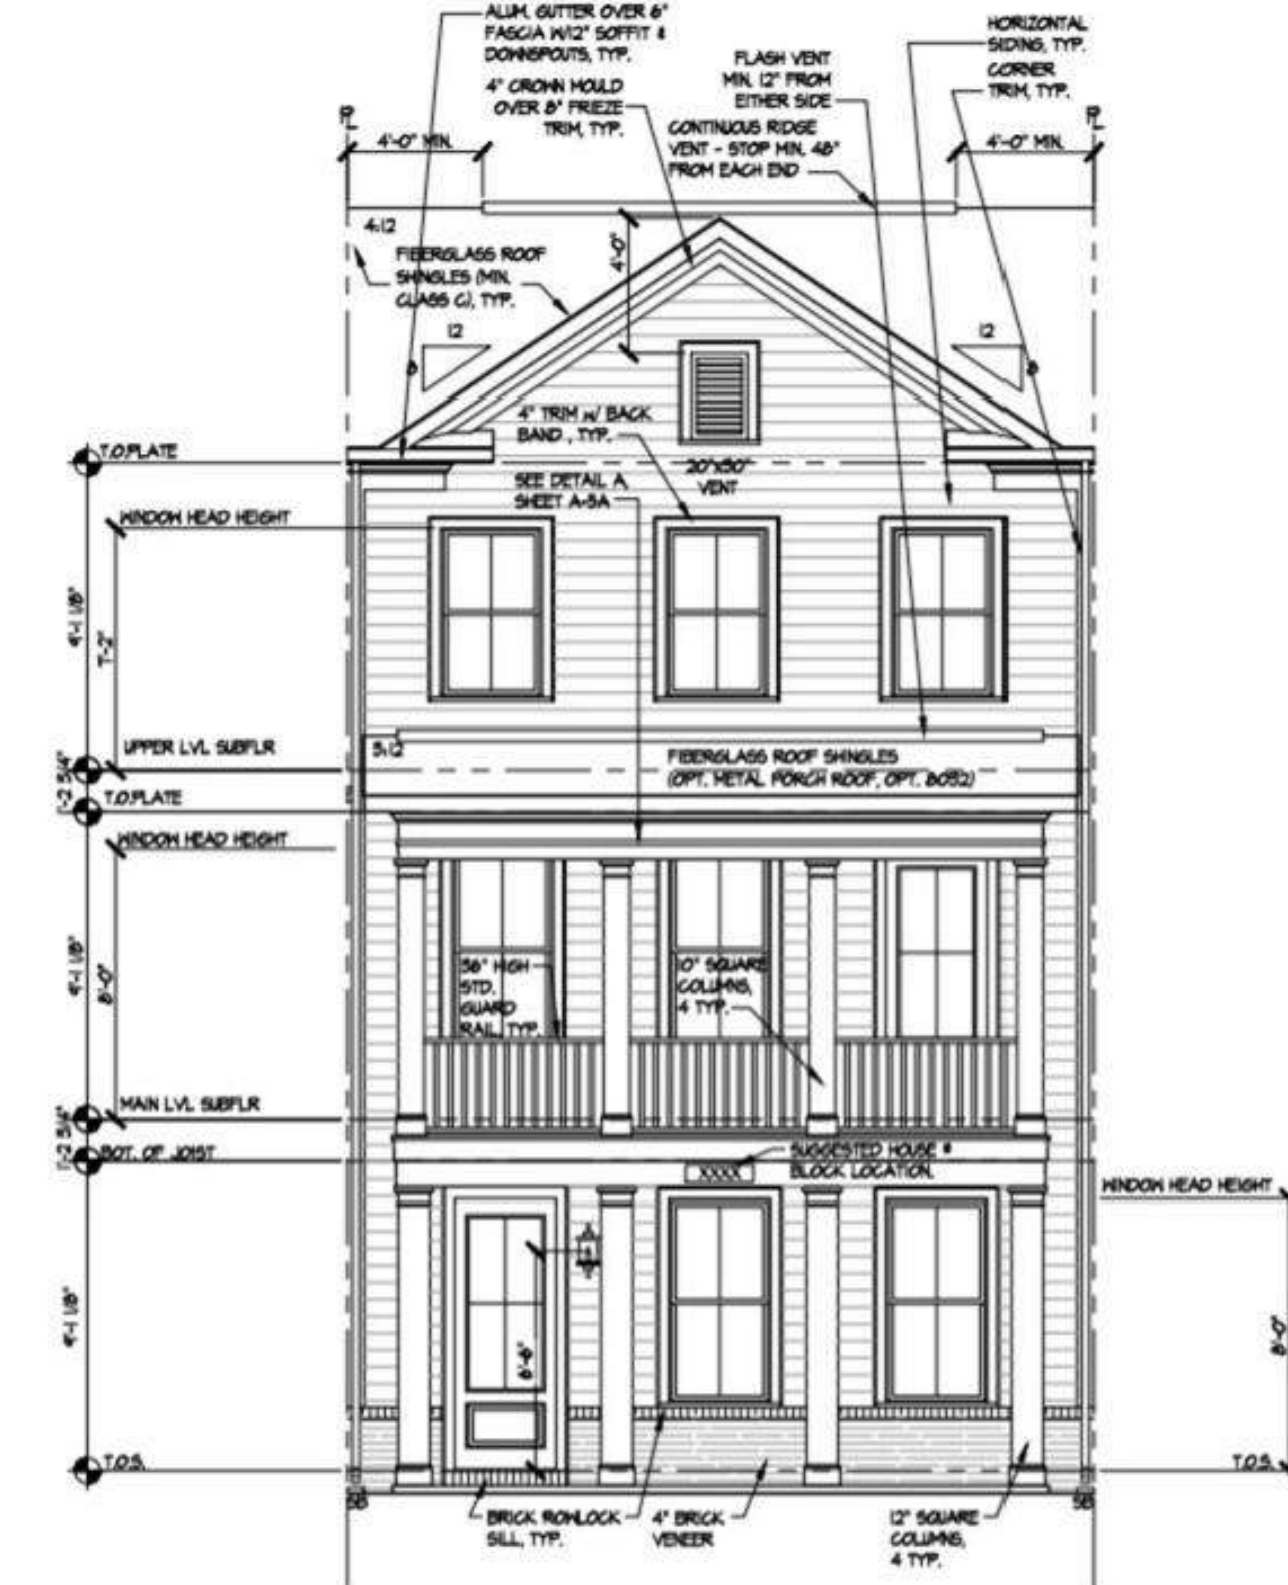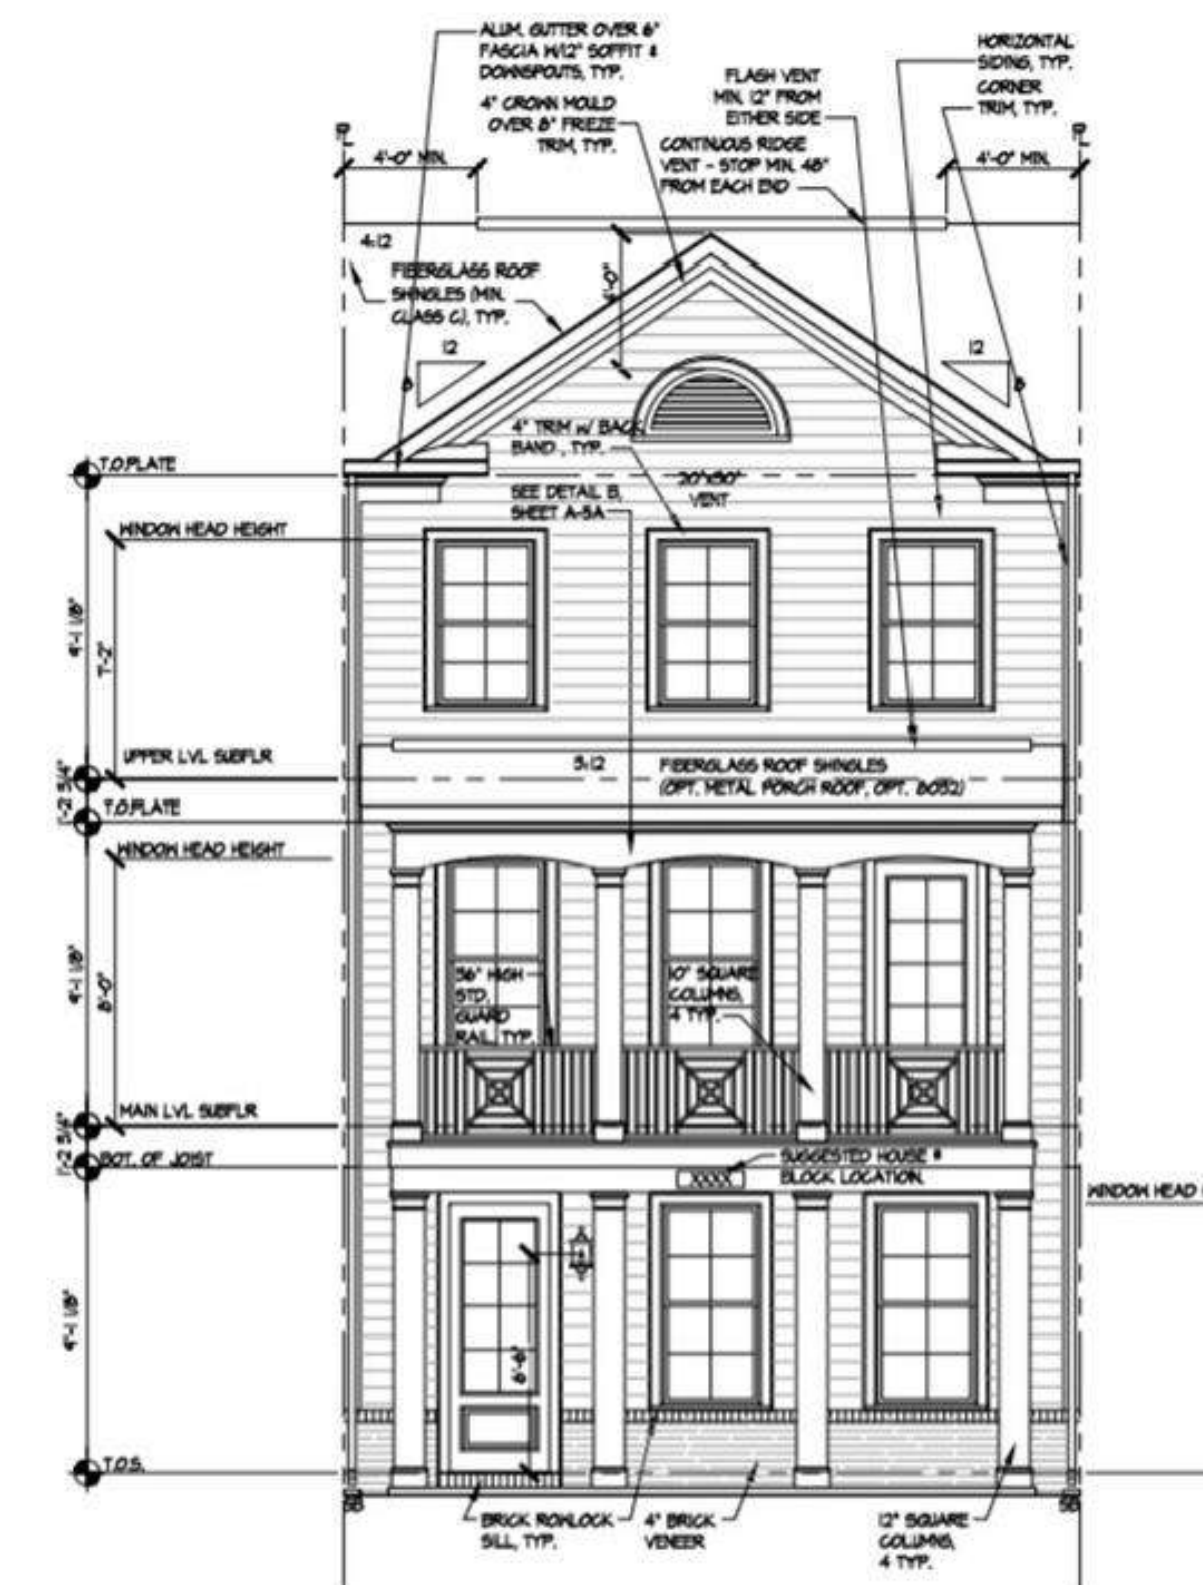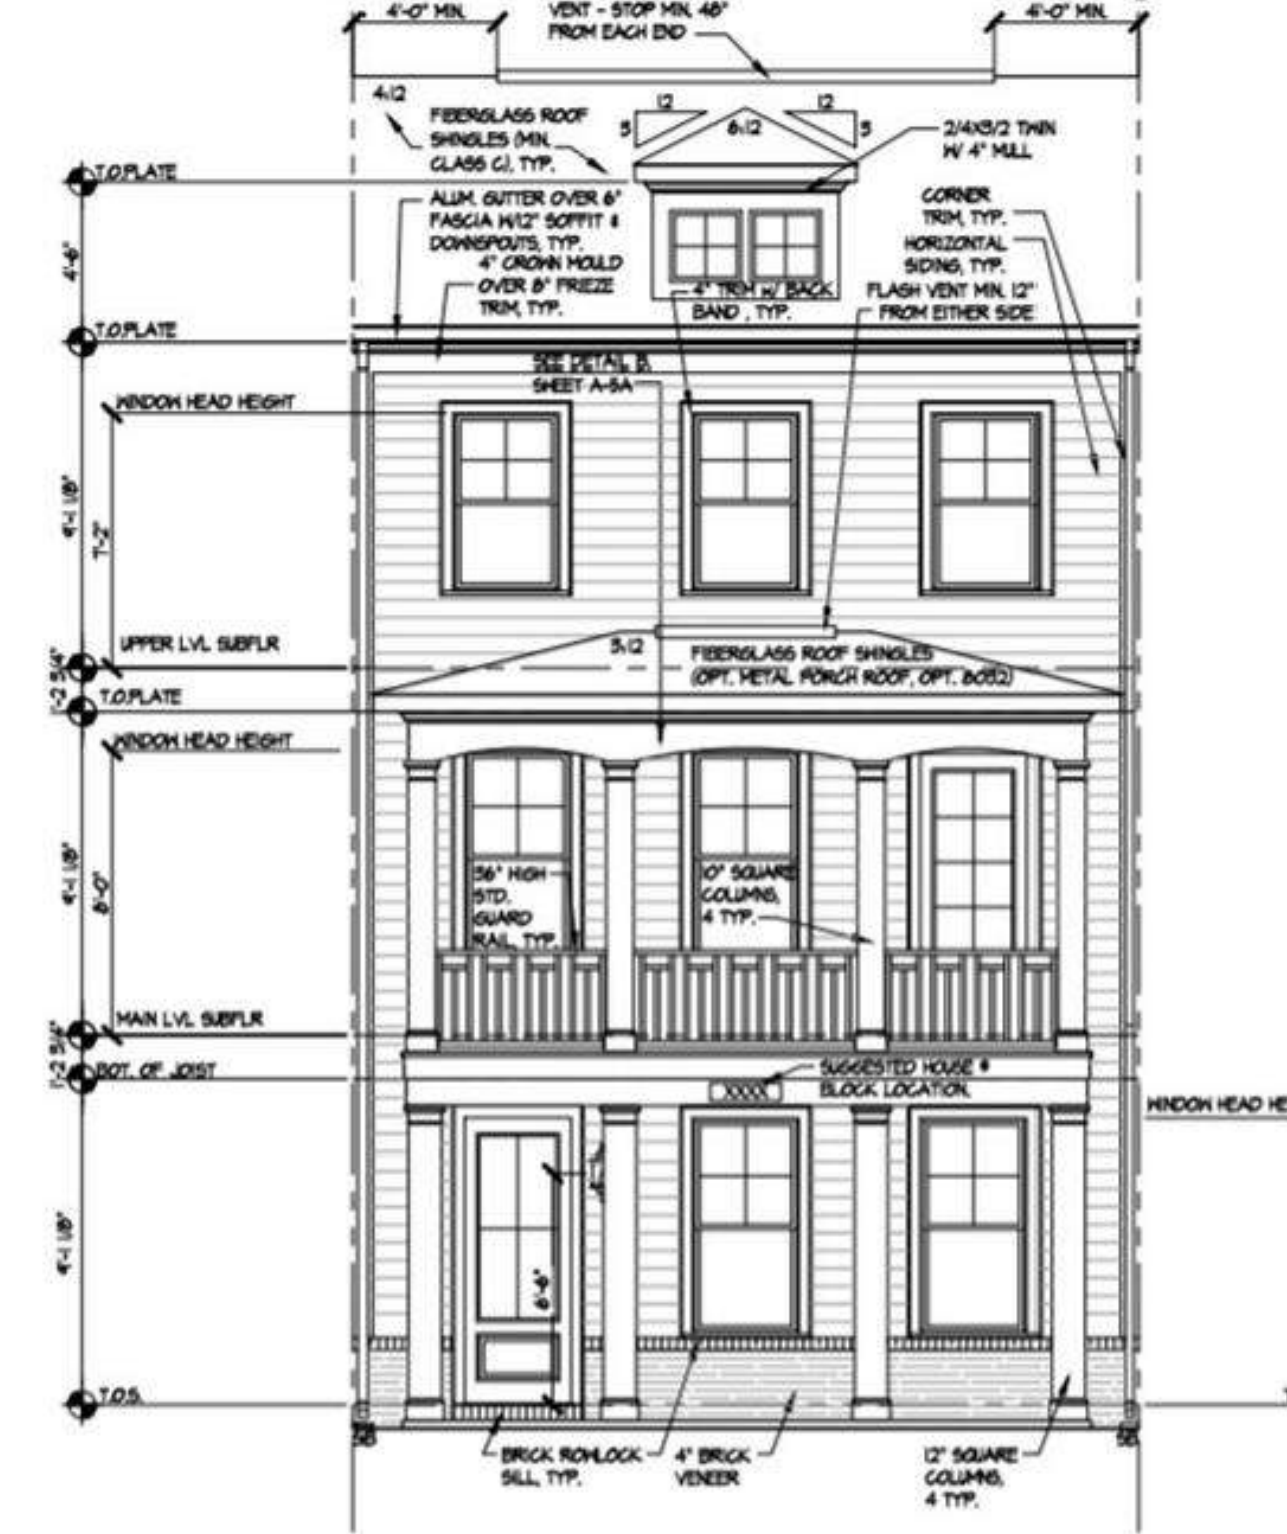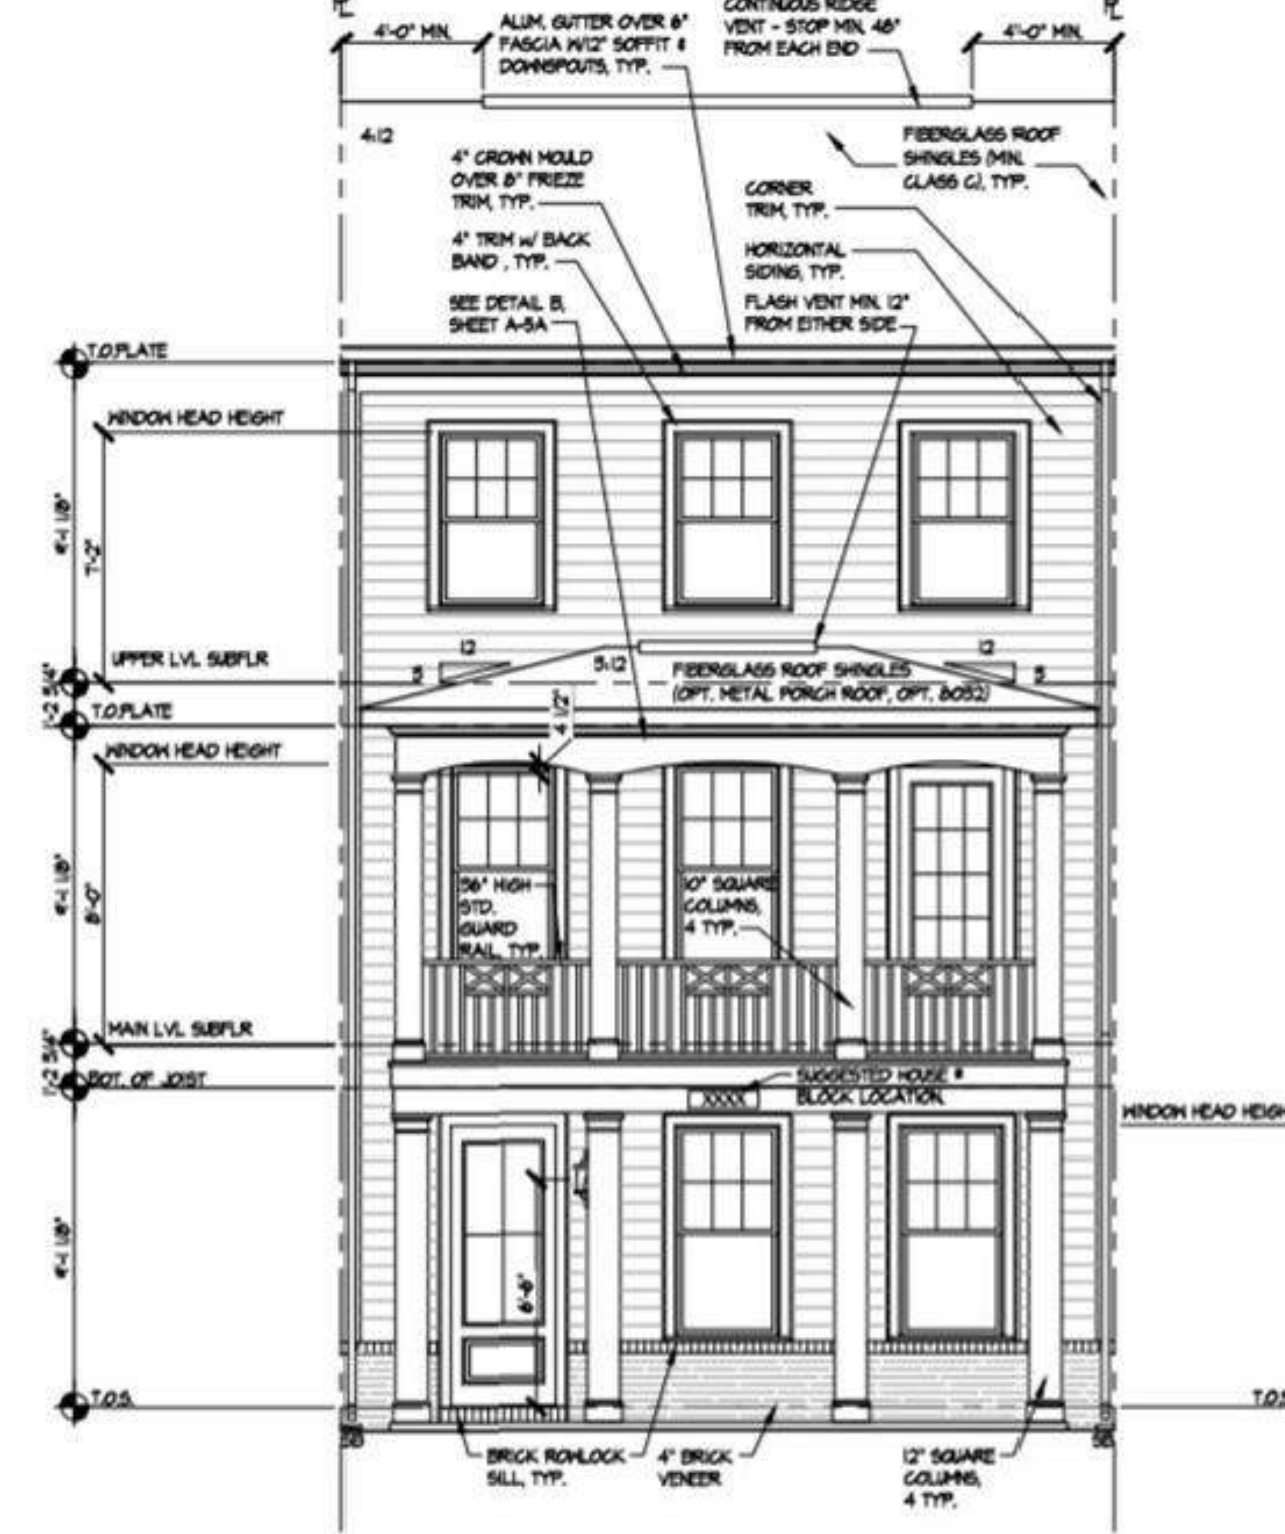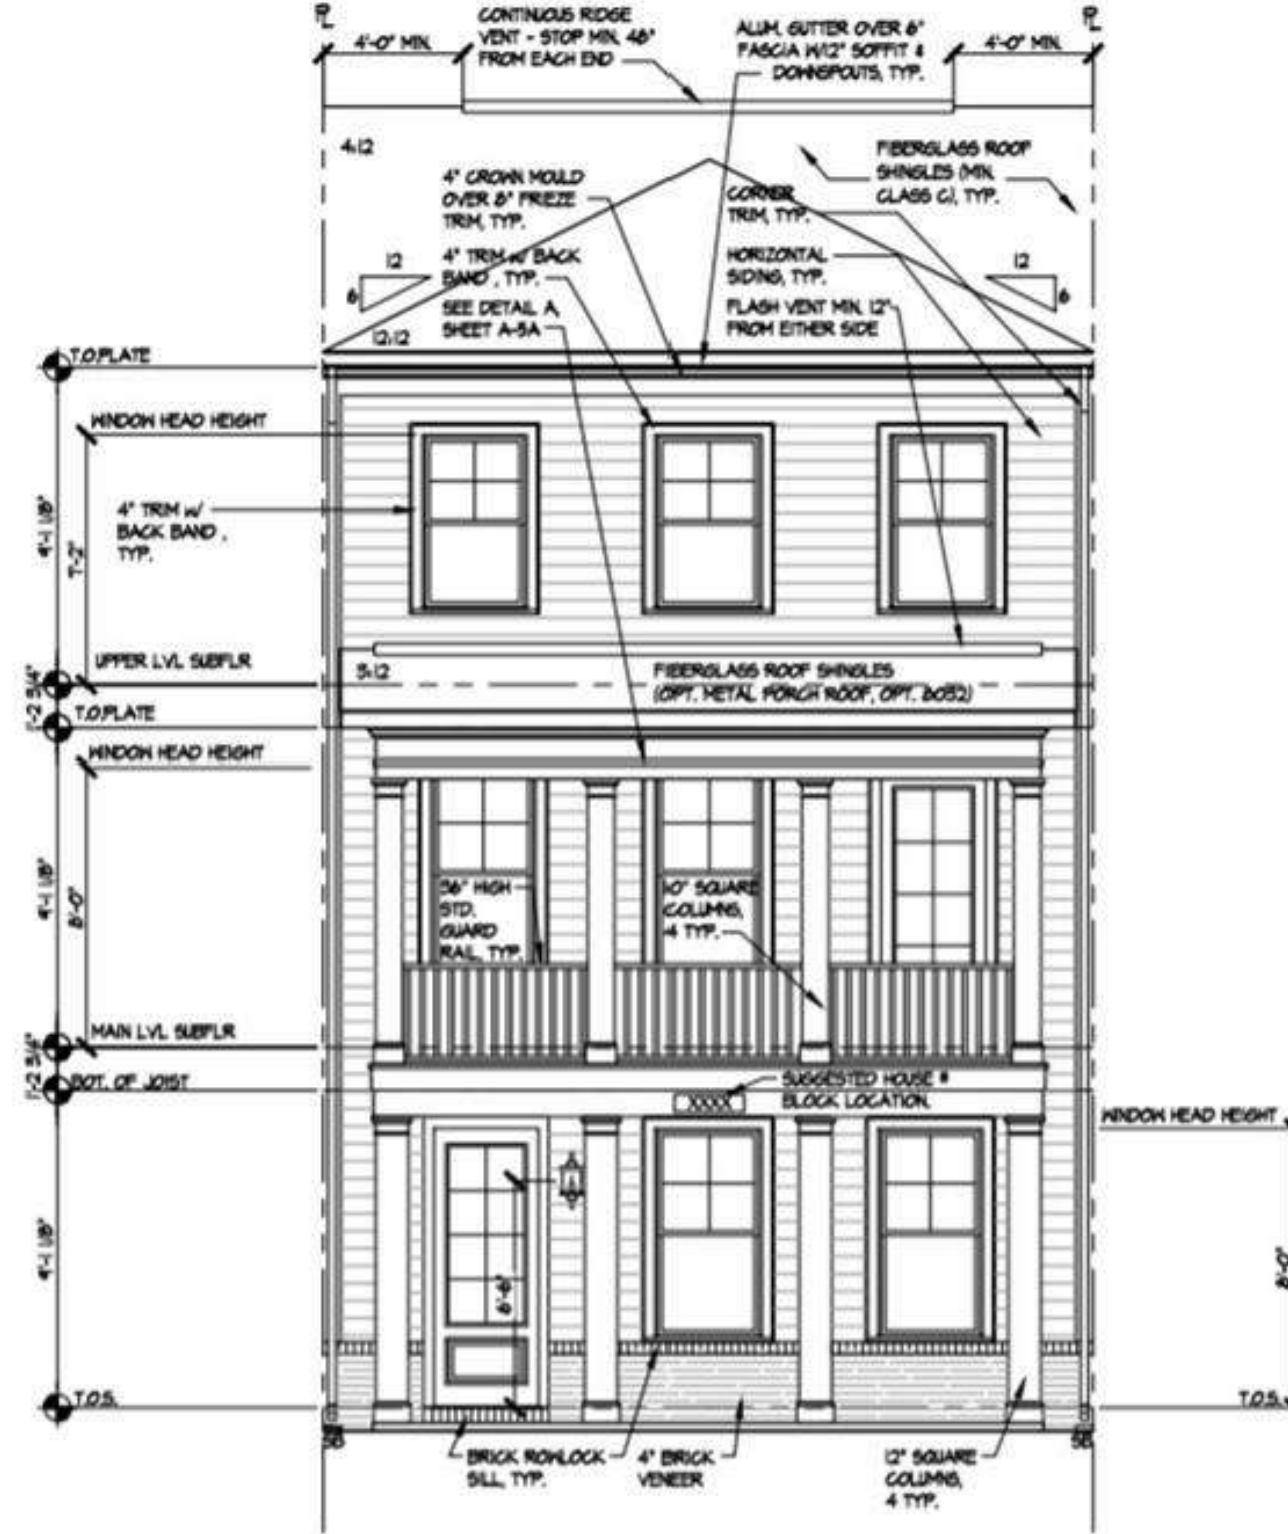

## KEY MAP

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PINEVILLE, NC  
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[illegible]

DESIGNED BY: JRY  
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SCALE NORTH

VERT: N/A  
HORZ: NTS


(NOT TO SCALE)

ARCHITECTURAL ELEVATION

SHEET NUMBER

RZ-4



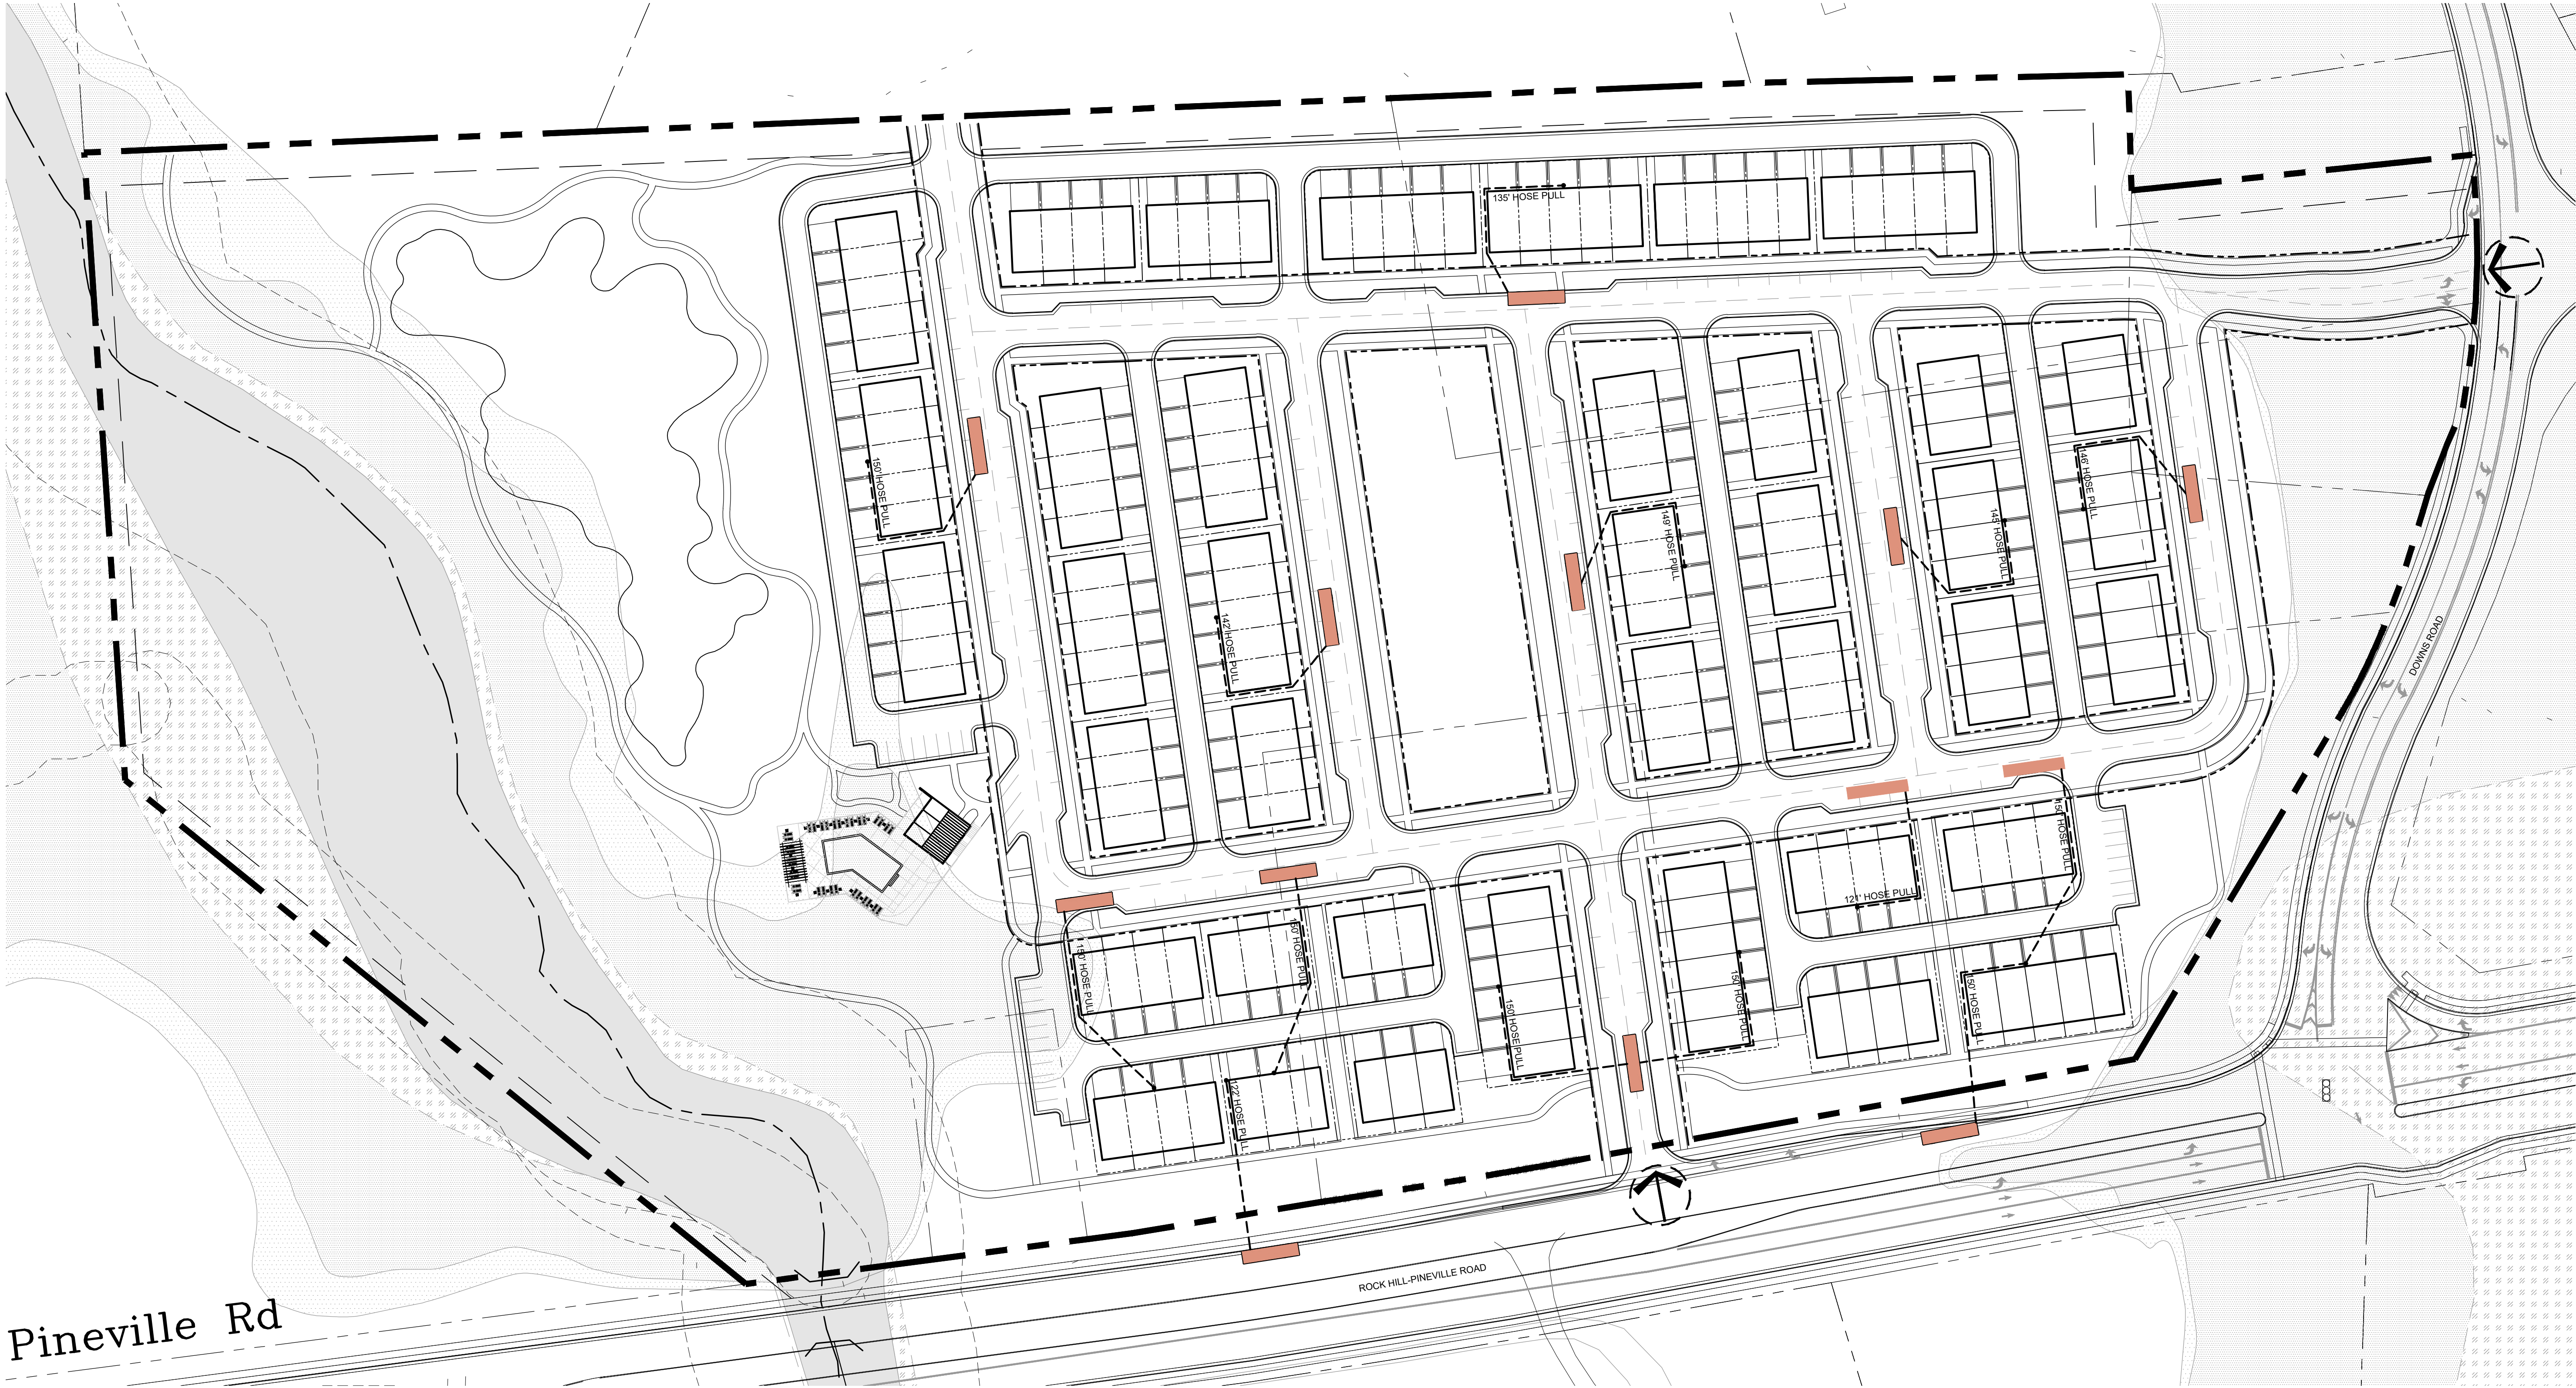


Pineville Rd

ROCK HILL-PINEVILLE ROAD

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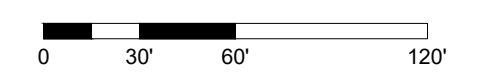
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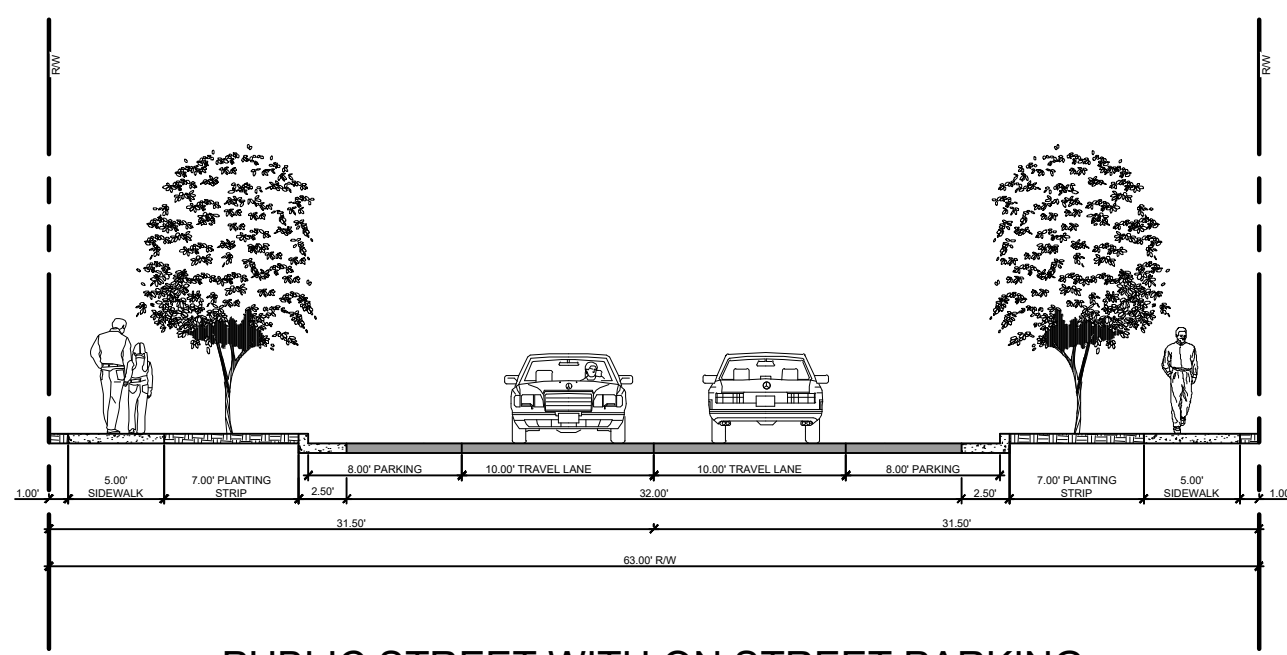


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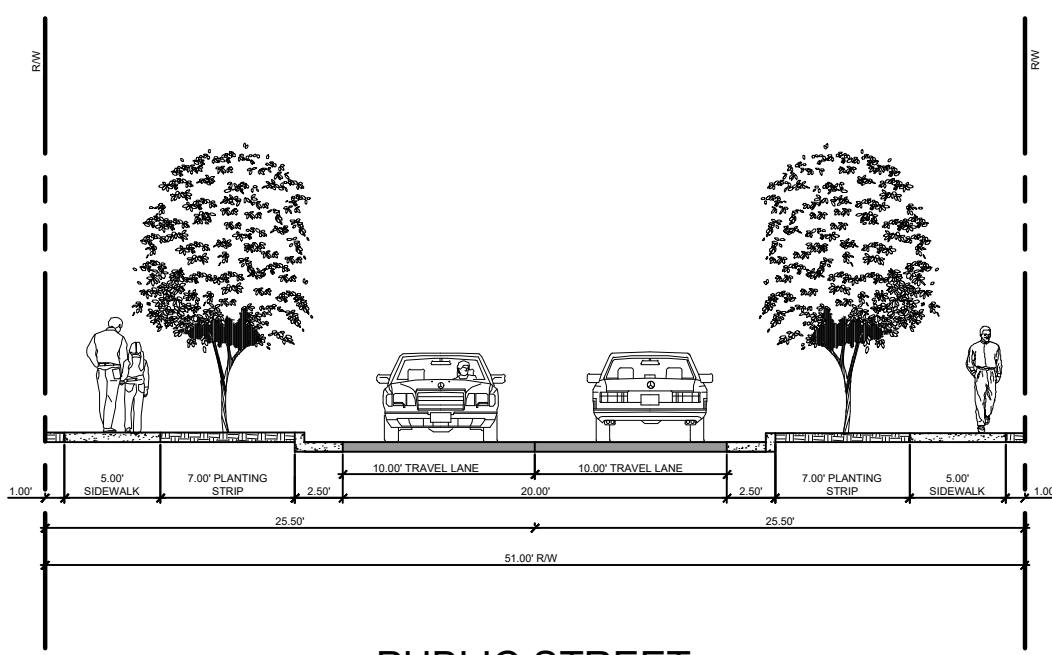
**FIRE - TURNING  
MOVEMENTS**

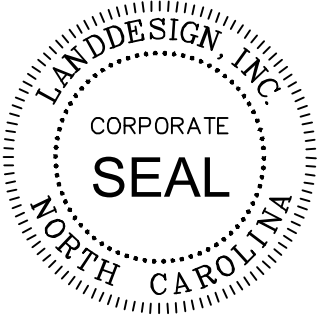SHEET NUMBER


**RZ-5**



**PUBLIC STREET WITH ON STREET PARKING**  
1"=10'



**PUBLIC STREET**  
1"=10'

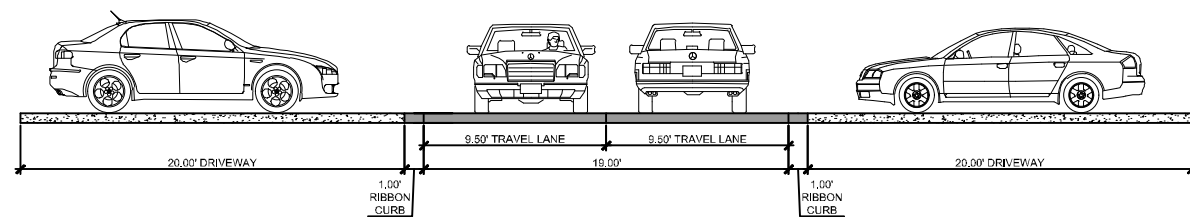

**\*PRIVATE ALLEY**  
1"=10'

\*ALLEY LANE MAY BE REDUCED TO 16' PER PINEVILLE  
TYP. SECTIONS DURING FINAL ENGINEERING, UNLESS  
FIRE ACCESS IS NEEDED, THEN ALLEY MUST REMAIN  
AT 20' WIDE MIN.



GENERAL NOTES

- BUILDINGS ON THE SITE WILL BE 3 STORY TOWNHOUSE BUILDINGS WITH AN AVERAGE HEIGHT IN FEET OF APPROXIMATELY 34 FEET AT THE FRONT BUILDING LINE.
- TOWN HOUSE UNITS WILL BE INDIVIDUALLY PARCELED/PLATTED.
- THE BUILDINGS ABUT A NETWORK OF REQUIRED PUBLIC OR PRIVATE STREETS WITH EACH HAVING A MAIN PEDESTRIAN ENTRANCE FRONTING THESE STREETS. ALL GARAGE ENTRANCES WILL BE LOCATED OFF THE BACK OF THE BUILDINGS FROM AN ALLEY.
- UNITS WILL HAVE PORCHES OR COVERED STOOPS WITH WALKWAYS PROVIDED TO CONNECT THEM TO THE SIDEWALK LOCATED ALONG THE ADJACENT PUBLIC OR PRIVATE STREET.
- BUILDING ELEVATIONS HAVE BEEN DESIGNED WITH ARTICULATED FAÇADE FEATURES INCLUDING WALL OFFSETS, PROJECTIONS, AND CHANGES IN MATERIALS AND COLORS TO HELP BREAK UP THE MASS OF THE BUILDING. BUILDINGS HAVE ALSO BEEN DESIGNED WITH A RECOGNIZABLE ARCHITECTURAL BASE OF MASONRY OR STONE. NO VINYL SIDING WILL BE USED. SIDE ELEVATIONS OF THE BUILDINGS WILL BE CONSISTENT IN ARCHITECTURAL CHARACTER AND MATERIALS AS THE FRONT OF THE BUILDINGS.
- ELEVATIONS ARE COMPOSED OF A COMBINATION OF FIBER CEMENT PANELS AND TRIM, FIBER CEMENT LAP SIDING, OR FIBER CEMENT VERTICAL BOARD & BATTEN SIDING. BUILDINGS WILL ALSO HAVE A BASE OF BRICK OR STONE VENEER (INCLUDING PRECAST STONE OR SYNTHETIC STONE)
- WINDOWS TO BE VINYL, ALUMINUM OR WOOD MATERIAL.
- BUILDINGS WILL HAVE ARCHITECTURAL FIBERGLASS COMPOSITE SHINGLES AND ALL ROOF VENTS WILL BE PAINTED TO MATCH THE ROOF COLOR.
- ROLL OUT TRASH AND RECYCLING BINS WILL BE PROVIDED FOR EACH UNIT FOR PRIVATE TRASH AND RECYCLING COLLECTION. TRASH AND RECYCLING WILL BE SCREENED FROM ALLEY WHEN BEING STORED.

NOTE: THE ATTACHED CONCEPTUAL RENDERINGS ARE SOLELY FOR THE PURPOSE OF ILLUSTRATING THE DESIGN.

ARCHITECTURAL NOTES

ARCHITECTURAL COMPOSITION:

(REFER TO ARCHITECTURAL ELEVATIONS ON RZ-4)

NOTE: THE PROVIDED ARCHITECTURAL ELEVATIONS ARE INTENDED TO CONVEY DESIGN INTENT AND ARE SUBJECT TO FINAL DESIGN. THE DESIGN COMMITMENTS BELOW ARE BASED ON THE PROVIDED IMAGERY FOR THE REZONING OF THIS PROJECT. ELEVATIONS SHOWN TO MATCH APPROVED DESIGN CONCEPT, MATERIALS, SPACING, AND WINDOWS.

- IN AN EFFORT TO ENHANCE THE ARCHITECTURAL COMPATIBILITY, SCALE AND STREETScape PRESENCE FOR THE PROJECT, THE PETITIONER COMMITS TO THE FOLLOWING REQUIRED ARCHITECTURAL DETAILS THAT WILL APPLY TO ALL UNITS:
- MAXIMUM 6 UNITS IN A RUN (PER BUILDING)
- MINIMUM ROOF PITCH: 4:12
- MINIMUM 6" OVERHANG FOR GABLE ROOF OR MINIMUM 12" OVERHANG FOR EVE
- WINDOW MULLIONS ALONG FRONT FAÇADE WILL BE PROVIDED
- ARCHITECTURAL ROOF SHINGLES WILL BE PROVIDED
- VARIED UNIT PLACEMENT ALONG THE FAÇADE (PER BUILDING) TO BREAK THE ROOF LINE
- FIBER CEMENT BOARD, BOARD + BATTEN OR MASONRY FACADES (VINYL ACCEPTABLE FOR SOFFITS, WINDOWS AND OTHER ACCESSORY ARCHITECTURAL FEATURES)
- ANY PORCHES OR STOOPS WILL HAVE RAILINGS
- IDENTICAL INDIVIDUAL UNIT ELEVATIONS WILL NOT BE ALLOWED IMMEDIATELY ADJACENT TO ONE ANOTHER

ARCHITECTURAL COMPOSITION FOR EACH BUILDING FAÇADE (MULTIPLE UNITS - 6 MAX). ALL BUILDINGS WILL FEATURE ONE OF EACH OF THE FOLLOWING ARCHITECTURAL FEATURES


- FRONT PORCHES
- GABLE ROOF - FRONT OR SIDE FACING (FRONT FACING GABLE ROOF TO HAVE DECORATIVE VENT OR DECORATIVE TYPE BRACKETS)
- MASONRY FAÇADE FOR FULL UNIT FRONT ELEVATION (INDIVIDUAL UNIT ALONG A BUILDING FACE)
- A MINIMUM OF 2 STEPS (12" THRESHOLD) FROM SIDEWALK APPROACHING UP TO THE STOOP OR THE FRONT PORCH (HEIGHT DEPENDS ON FINAL GRADING & ENGINEERING FOR THE SITE)

IN ADDITION TO THE REQUIREMENTS OF THE 3 ARCHITECTURAL FEATURES ABOVE, THE FOLLOWING OPTIONAL ARCHITECTURAL DETAILS MAY BE INCORPORATED INTO THE BUILDING FAÇADES TO PROVIDE VARIATION AND SCALE ALONG THE STREETScape. THESE MAY BE USED AT THE PETITIONER'S DISCRETION THROUGHOUT THE PROJECT:


- ROOF VARIATION (GABLE/ FLAT/ DORMER WINDOWS)
- MASONRY FACADES
- BRICK OR MASONRY CLAD THE SLAB (IN THE CASE OF ELEVATED SLABS) AND HAVE CLAPBOARD OVERHANG THE BRICK.

ADDITIONAL LOT REQUIREMENTS:

- MIN LOT SIZE: 1,100 SF SUBLOTS (PER UNIT)
- MIN FRONT SETBACK: 10'
- MIN REAR YARD: 20' DRIVEWAY
- MIN SIDE YARD/SETBACK: 5' FOR CORNER LOTS
- 1' OVERHANG FOR EAVES AND ARCHITECTURAL FEATURES

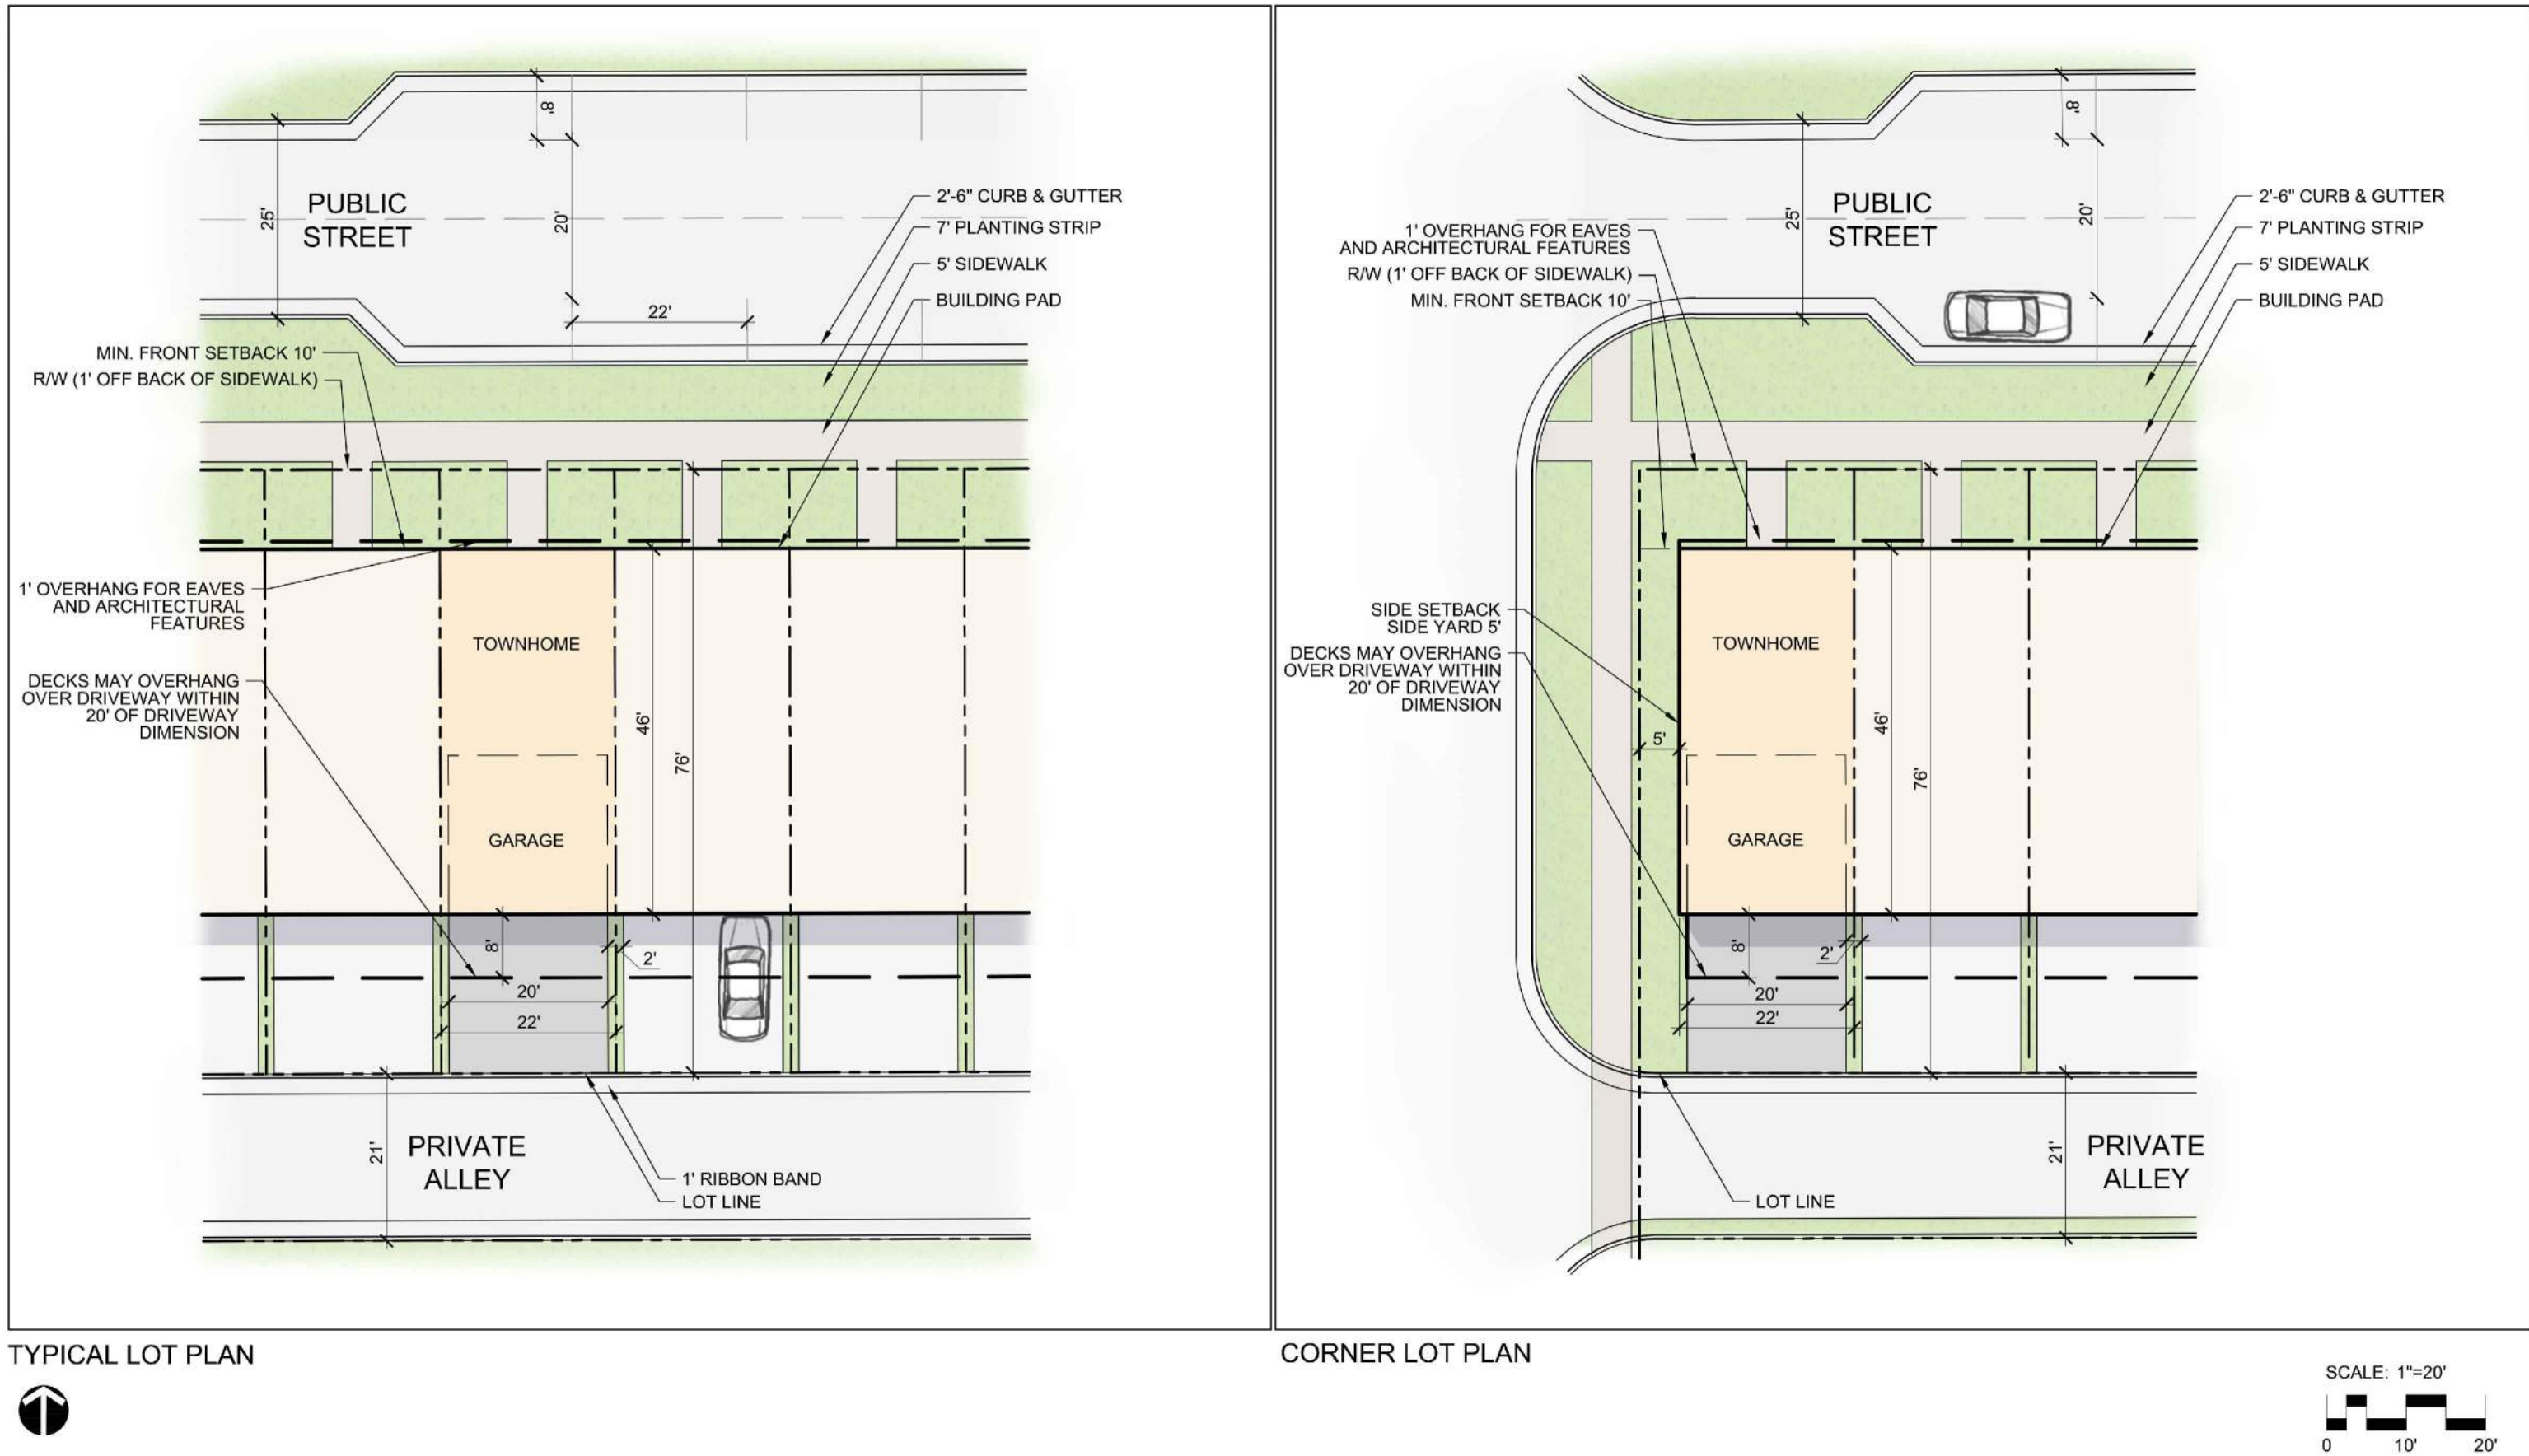


POTENTIAL LANEAGE

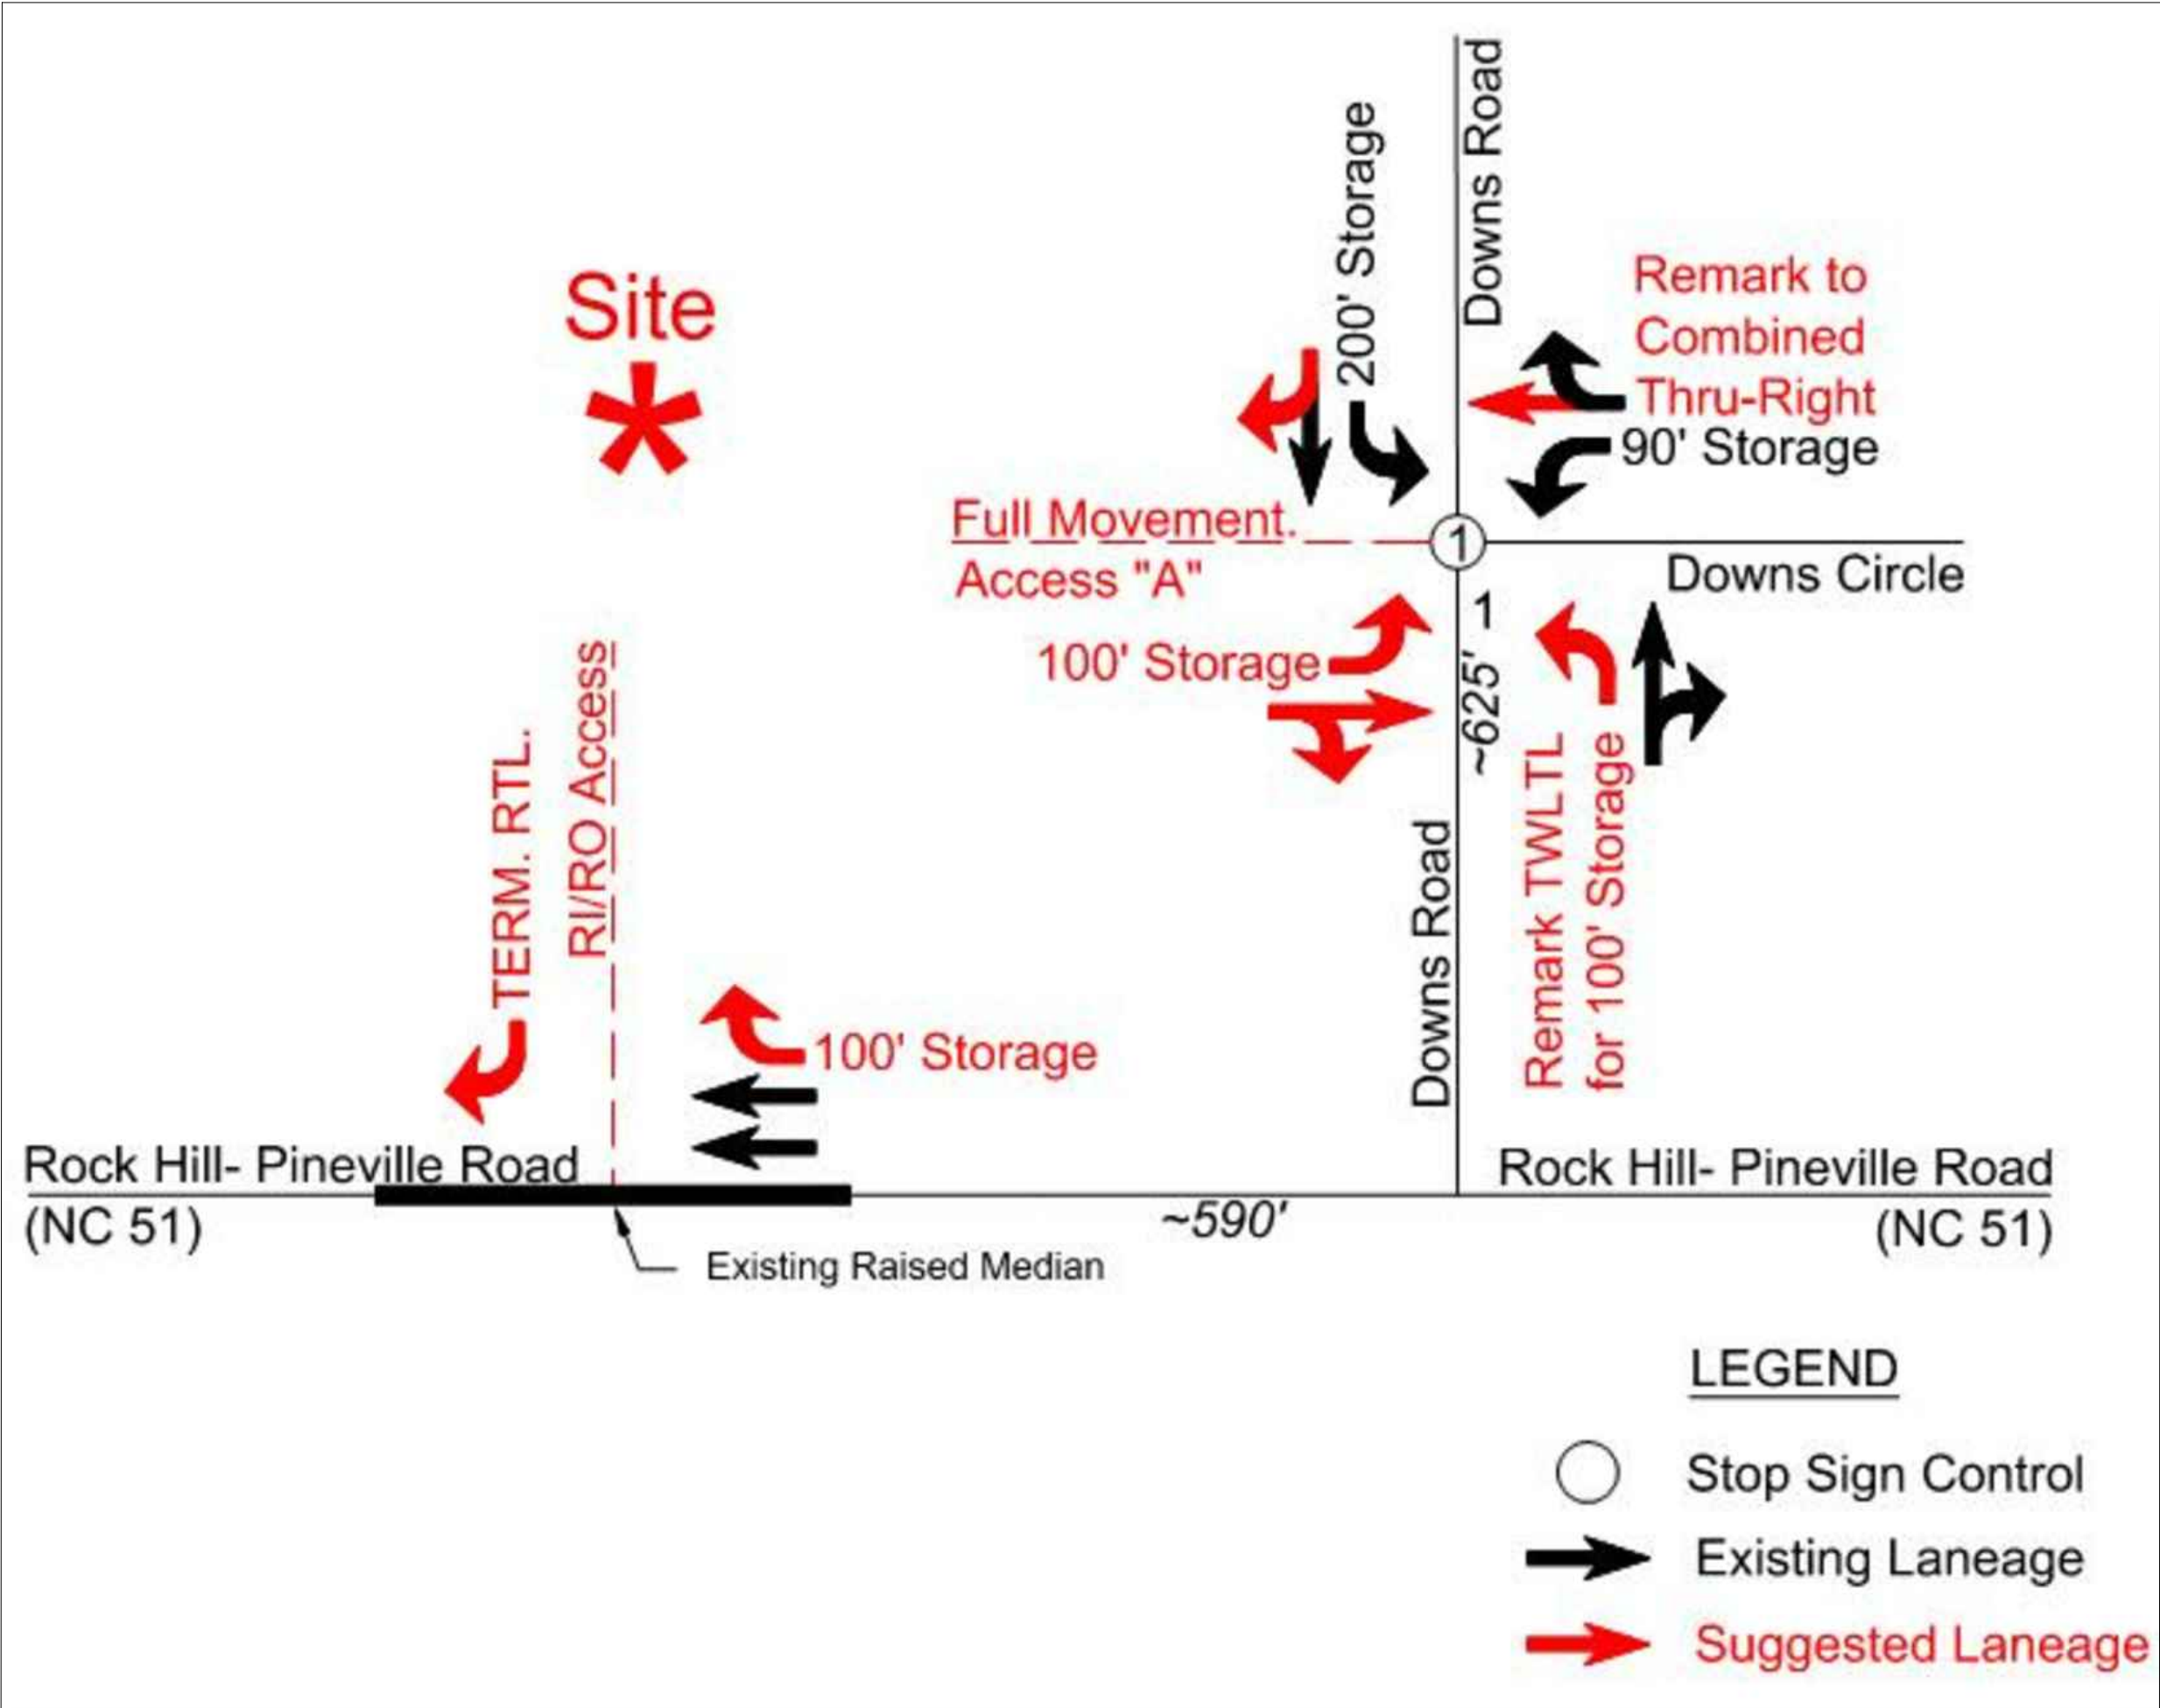

KEY MAP

SEAL

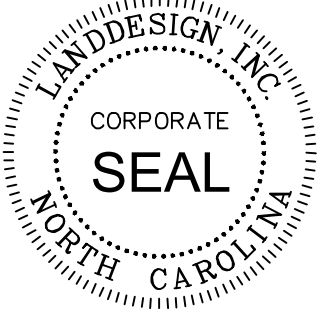

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SCALE

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HORZ: N/A

SHEET TITLE

DEVELOPMENT STANDARDS

SHEET NUMBER

RZ-6