



GENERAL

THE CONSTRUCTION DRAWINGS AND SPECIFICATIONS ARE INTERRELATED WHEN PERFORMING THE WORK. EACH CONTRACTOR MUST REFER TO ALL DRAWINGS. COORDINATION IS THE RESPONSIBILITY OF THE GENERAL CONTRACTOR.

DIVISION 1: GENERAL REQUIREMENTS

SECTION 01700 - PROJECT CLOSEOUT

PART 1 - GENERAL

- OBTAIN AND SUBMIT RELEASES ENABLING THE OWNER UNRESTRICTED USE OF THE WORK AND ACCESS TO SERVICES AND UTILITIES. INCLUDE OCCUPANCY PERMITS, OPERATING CERTIFICATES, AND SIMILAR RELEASES.
- SUBMIT RECORD DRAWINGS, DAMAGE, OR SETTLEMENT SURVEY, PROPERTY SURVEY, AND SIMILAR FINAL RECORD INFORMATION.
- COMPLETE FINAL CLEAN-UP REQUIREMENTS, INCLUDING TOUCH-UP PAINTING. TOUCH-UP AND OTHERWISE REPAIR AND RESTORED MARRED EXPOSED FINISHES.

PART 2 - FINAL CLEANING/PROJECT CLOSEOUT

- COMPLETE THE FOLLOWING OPERATIONS BEFORE REQUESTING INSPECTION FOR CERTIFICATE OF COMPLETION:
  - CLEAN THE PROJECT SITE, YARD AND GROUNDS IN AREAS DISTURBED BY CONSTRUCTION ACTIVITIES, INCLUDING LANDSCAPE DEVELOPMENT, AREAS OF RUBBISH, WASTE MATERIALS, LITTER AND FOREIGN SUBSTANCES. SWEEP PAVED AREAS BROOM CLEAN. REMOVE PETRO-CHEMICAL SPILLS, STAINS AND OTHER FOREIGN DEPOSITS. RAKE GROUNDS THAT ARE NEITHER PLANTED NOR PAVED TO A SMOOTH, EVEN-TEXTURED SURFACE.
  - REMOVE TOOLS, CONSTRUCTION EQUIPMENT, MACHINERY, AND SURPLUS MATERIAL FROM THE SITE.
  - REMOVE SNOW AND ICE TO PROVIDE SAFE ACCESS TO THE SITE AND EQUIPMENT BUILDING.
  - CLEAN EXPOSED EXTERIOR AND INTERIOR HARD-SURFACED FINISHES TO A DIRT-FREE CONDITION, FREE OF STAINS, FILMS AND SIMILAR FOREIGN SUBSTANCES. AVOID DISTURBING NATURAL WEATHERING OF EXTERIOR SURFACES.
  - REMOVE DEBRIS FROM LIMITED ACCESS SPACES, INCLUDING ROOFS, EQUIPMENT BUILDING, MANHOLES AND SIMILAR SPACES.
  - REMOVE LABELS THAT ARE NOT PERMANENT LABELS.
  - TOUCH-UP AND OTHERWISE REPAIR AND RESTORE MARRED EXPOSED FINISHES AND SURFACES. REPLACE FINISHES AND SURFACES THAT CAN NOT BE SATISFACTORILY BE REPAIRED OR RESTORED, OR THAT SHOW EVIDENCE OF REPAIR OR RESTORATION. DO NO PAINT OVER "UL" AND SIMILAR LABELS, INCLUDING ELECTRICAL NAME PLATES.
  - LEAVE THE PROJECT CLEAN AND READY FOR OCCUPANCY.
  - DUST OFF ALL EQUIPMENT, INCLUDING BATTERY PACKS, WITHIN EQUIPMENT BUILDING.
  - GENERAL CONTRACTOR TO CLEAN AND APPLY STATIC-FREE WAX TO THE FLOORS ONCE FINAL SHELTER EQUIPMENT AND ACCESSORIES ARE COMPLETED.
- REMOVAL OF PROTECTION

REMOVE TEMPORARY PROTECTION AND FACILITIES INSTALLED DURING CONSTRUCTION TO PROTECT PREVIOUSLY COMPLETED INSTALLATIONS DURING THE REMAINDER OF THE CONSTRUCTION PERIOD.

DIVISION 2: SITE WORK

SECTION 02200 - EARTHWORK AND DRAINAGE

PART 1 - GENERAL

- WORK INCLUDED - SEE SITE PLAN

2. DESCRIPTIONS

ACCESS DRIVE WITH TURN-AROUND AREA, LEASE AREA, AND, IF APPLICABLE, UNDERGROUND UTILITY EASEMENTS ARE TO BE CONSTRUCTED TO PROVIDE A WELL-DRAINED, EASILY MAINTAINED, EVEN SURFACE FOR MATERIAL AND EQUIPMENT DELIVERIES AND MAINTENANCE PERSONNEL ACCESS.

3. QUALITY ASSURANCE

- APPLY SOIL STERILIZER IN ACCORDANCE WITH MANUFACTURER'S RECOMMENDATIONS (AS NEEDED).
- APPLY AND MAINTAIN GRASS SEED AS RECOMMENDED BY THE SEED PRODUCER (AS NEEDED).
- PLACE AND MAINTAIN VEGETATION LANDSCAPING, IF INCLUDED WITHIN THE CONTRACT, AS RECOMMENDED BY NURSERY INDUSTRY STANDARDS.

4. SEQUENCING

- CONFIRM SURVEY STAKES AND SET ELEVATIONS STAKES PRIOR TO ANY CONSTRUCTION.
- COMPLETELY GRUB THE ACCESS DRIVE WITH TURN-AROUND, UNDERGROUND UTILITY EASEMENTS (IF APPLICABLE), AND LEASE AREA PRIOR TO FOUNDATION CONSTRUCTION, PLACEMENT OF BACKFILL AND SUB-BASE MATERIAL.
- CONSTRUCT TEMPORARY CONSTRUCTION AREA ALONG ACCESS DRIVE.
- BRING THE LEASE AREA AND ACCESS DRIVE WITH TURN-AROUND TO BASE COURSE ELEVATION PRIOR TO INSTALLING FOUNDATION.
- APPLY SOIL STERILIZER PRIOR TO PLACING BASE MATERIALS SUCH THAT THE STERILIZER ONLY COMES IN CONTACT WITH PROPOSED GRAVEL SURFACES
- GRADE, SEED, FERTILIZE, AND MULCH ALL AREAS DISTURBED BY CONSTRUCTION (INCLUDING UNDERGROUND UTILIY EASEMENTS) IMMEDIATELY AFTER BRINGING LEASE AND ACCESS DRIVE WITH TURN-AROUND TO BASE COURSE ELEVATION. WATER TO ENSURE GROWTH.
- REMOVE GRAVEL FROM TEMPORARY CONSTRUCTION ZONE TO AN AUTHORIZED AREA OR AS DIRECTED BY THE PROJECT MANAGER.
- AFTER APPLICATIONS OF FINAL SURFACES, APPLY SOIL STERILIZER TO STONE SURFACES.

5. SUBMITTALS

- BEFORE CONSTRUCTION
  - IF LANDSCAPING IS APPLICABLE TO THE CONTRACT, SUBMIT TWO (2) COPIES OF THE LANDSCAPE PLAN UNDER NURSERY LETTERHEAD. IF LANDSCAPE ALLOWANCE WAS INCLUDED IN THE CONTRACT, PROVIDE AN ITEMIZED LISTING OF PROPOSED COSTS ON NURSERY LETTERHEAD. REFER TO PLANS FOR LANDSCAPING REQUIREMENTS.
- PLACE FILL OR STONE IN SIX (6) INCH MAXIMUM LIFTS, AND COMPACT BEFORE PLACING NEXT LIFT.
- AFTER CONSTRUCTION
  - MANUFACTURER'S DESCRIPTION OF PRODUCT AND WARRANTY STATEMENT ON SOIL STERILIZED.
  - MANUFACTURER'S DESCRIPTION OF PRODUCT ON GRASS SEED AND FERTILIZER.
  - LANDSCAPING WARRANTY STATEMENT.

6. WARRANTY

- IN ADDITION TO THE WARRANTY ON ALL CONSTRUCTION COVERED IN THE CONTRACT DOCUMENTS, THE CONTRACTOR SHALL REPAIR ALL DAMAGE AND RESTORE AREA AS CLOSE TO ORIGINAL CONDITION AS POSSIBLE AT SITE AND SURROUNDINGS.
- SOIL STERILIZATION APPLICATION TO GUARANTEE VEGETATION FREE ROAD AND SITE AREAS FOR ONE YEAR FOM DATE OF FINAL INSPECTION.
- DISTURBED AREAS WILL REFLECT GROWTH OF NEW GRASS PRIOR TO FINAL INSPECTION.
- LANDSCAPING, IF INCLUDED WITHIN THE SCOPE OF THE CONTRACT, WILL BE GUARANTEED FOR ONE YEAR FROM THE DATE OF FINAL INSPECTION.

DIVISION 2: SITE WORK (CONTINUED)

SECTION 02200 - EARTHWORK AND DRAINAGE (CONTINUED)

PART 2 - PRODUCTS

1. MATERIALS

SOIL STERILIZER SHALL BE AN EPA REGISTERED, PRE-EMERGENCE LIQUID:  
TOTAL KILL PRODUCT 910  
EPA 10292-7  
PHASAR CORPORATION  
P.O. BOX 5123  
DEARBORN, MI 48128  
313.563.8000

AMBUSH HERBICIDE  
EPA REGISTERED  
FRAMAR INDUSTRIAL PRODUCTS  
1435 MORRIS AVENUE  
UNION, NJ 07083  
800.526.4924

ROAD AND SITE MATERIALS SHALL CONFORM TO DOT SPECIFICATIONS (UNLESS OTHERWISE NOTED). ACCEPTABLE SELECT FILL SHALL BE IN ACCORDANCE WITH STATE DEPARTMENT OF HIGHWAY AND TRANSPORTATION STANDARD SPECIFICATIONS.

SOIL STABILIZED FABRIC SHALL BE MIRAFI - 500X.

PART 3 - EXECUTION

1. PREPARATION

- CLEAR TREES, BRUSH AND DEBRIS FROM LEASE AREA, ACCESS DRIVE WITH TURN-AROUND, AND UNDERGROUND UTILITY EASEMENTS AS REQUIRED FOR CONSTRUCTION.
- PRIOR TO OTHER EXCAVATION AND CONSTRUCTION, GRUB ORGANIC MATERIAL TO A MINIMUM OF SIX (6) INCHES BELOW GRADE.
- UNLESS OTHERWISE INSTRUCTED BY LEASEE, TRANSPORT ALL REMOVED TREES, BRUSH AND DEBRIS FROM THE PROPERTY TO AN AUTHORIZED LANDFILL.
- PRIOR TO PLACEMENT OF FILL OR BASE MATERIALS, ROLL THE SOIL.
- WHERE UNSTABLE SOIL CONDITIONS ARE ENCOUNTERED, LINE THE AREAS WITH A STABILIZED MAT PRIOR TO PLACEMENT OF FILL OR BASE MATERIAL.
- PRIOR TO PLACEMENT OF FILL OR BASE MATERIALS, REMOVE SOFT SPOTS, PLACE SELECT FILL, AND COMPACT TO 95% MODIFIED PROCTOR.

2. INSTALLATION

- GRADE OR FILL THE LEASE AREA AND ACCESS DRIVE WITH TURN-AROUND AS REQUIRED IN ORDER THAT UPON DISTRIBUTION OF SPOILS RESULTING FROM EXCAVATIONS, THE RESULTING GRADE WILL CORRESPOND WITH SAID SUB-BASE COURSE. ELEVATIONS ARE TO BE CALCULATED FROM BENCHMARK, FINISHED GRADES, OR INDICATED SLOPES.
- CLEAR EXCESS SPOILS, IF ANY, FROM JOB SITE AND DO NOT SPREAD BEYOND THE LIMITS OF PROJECT AREA UNLESS AUTHORIZED BY PROJECT MANAGER AND AGREED TO BY LANDOWNER.
- BRING THE ACCESS DRIVE WITH TURN-AROUND TO BASE COURSE ELEVATION TO FACILITATE CONSTRUCTION AND OBSERVATION DURING CONSTRUCTION OF THE SITE.
- AVOID CREATING DEPRESSIONS WHERE WATER MAY POND.
- THE CONTRACT SHALL INCLUDE GRADING, BANKING, AND DITCHING, UNLESS OTHERWISE NOTED.
- WHEN IMPROVING AN EXISTING ACCESS DRIVE, GRADE THE EXISTING DRIVE TO REMOVE ANY ORGANIC MATTER AND SMOOTH THE SURFACE BEFORE PLACING FILL OR STONE.
- THE TOP SURFACE COURSE SHALL EXTEND A MINIMUM OF ONE (1) FOOT BEYOND THE SITE FENCE, UNLESS OTHERWISE NOTED, AND SHALL COVER THE AREA AS INDICATED.
- NO SLOPES ARE TO BE GREATER THAN 3:1.
- APPLY RIP-RAP TO THE SIDES OF DITCHES AND DRAINAGE SWALES WHERE INDICATED ON THE DRAWINGS.
- RIP-RAP ENTIRE DITCH FOR SIX (6) FEET IN ALL DIRECTIONS AT CULVERT OPENINGS. (WHEN APPLICABLE)
- APPLY SEED, FERTILIZER, AND STRAW COVER TO ALL OTHER DISTURBED AREAS, DITCHES, AND DRAINAGE SWALES, NOT OTHERWISE RIP-RAPPED.
- UNDER NO CIRCUMSTANCES WILL DITCHES, SWALES, OR CULVERTS BE PLACED SO THAT THEY DIRECT WATER TOWARDS, OR PERMIT STANDING WATER IMMEDIATELY ADJACENT TO SHELTER OR EQUIPMENT. IF DESIGNS OR ELEVATIONS ARE IN CONFLICT WITH THIS, ADVISE CONSTRUCTION MANAGER IMMEDIATELY.

CONSULTANT:



**Edge**  
Consulting Engineers, Inc.

624 WATER STREET  
PRAIRIE DU SAC, WI 53578  
608.644.1449 VOICE  
608.644.1549 FAX  
www.edgeconsult.com

CLIENT:



**verizon**

10801 BUSH LAKE RD  
BLOOMINGTON, MN 55438

ENGINEER SEAL:

NOT - PRELIMINARY -  
FOR CONSTRUCTION

I HEREBY CERTIFY THAT THIS PLAN SET WAS PREPARED BY ME OR UNDER MY DIRECT SUPERVISION OTHER THAN THE EXCEPTIONS NOTED IN THE SHEET INDEX, AND THAT I AM A DULY LICENSED PROFESSIONAL ENGINEER UNDER THE LAWS OF THE STATE OF IOWA.

GENERAL SPECIFICATIONS  
IA12 DT OELWEIN  
OELWEIN, IOWA

SUBMITTAL:

INT.	DATE:	DESCRIPTION:
TJT	07/16/25	REV. A
BSS	08/07/25	REV. B

CHECKED BY:	PER
EDGE SITE ID	S8464
EDGE PROJ. #	44517
SET TYPE	DRAFT
SHEET NUMBER	G-002

DIVISION 2: SITE WORK (CONTINUED)

SECTION 02200 - EARTHWORK AND DRAINAGE (CONTINUED)

PART 2 - PRODUCTS (CONTINUED)

2. INSTALLATION (CONTINUED)

- N. IN DITCHES WITH SLOPES GREATER THAN 10%, MOUND DIVERSIONARY HEADWALLS IN THE DITCH AT AN ANGLE NO GREATER THAN 60° OFF THE DITCH LINE. RIP-RAP THE UPSTREAM SIDE OF THE HEADWALL AS WELL AS THE DITCH FOR SIX (6) FEET ABOVE THE CULVERT ENTRANCE.
- O. APPLY SEED AND FERTILIZER TO SURFACE CONDITIONS WHICH WILL ENCOURAGE ROOTING. RAKE AREAS TO BE SEEDED TO EVEN THE SURFACE AND LOOSEN THE SOIL.
- P. SOW SEED IN TWO DIRECTIONS IN TWICE THE QUANTITY RECOMMENDED BY THE SEED PRODUCER.
- Q. ENSURE GROWTH OF SEEDED AND LANDSCAPED AREAS BY WATERING UP TO THE POINT OF RELEASE FROM THE CONTRACT. CONTINUE TO REWORK THE BARE AREAS UNTIL COMPLETE COVERAGE IS OBTAINED.

3. FIELD QUALITY CONTROL

COMPACT SOILS TO MAXIMUM DENSITY IN ACCORDANCE WITH ASTM D-1557. AREAS OF SETTLEMENT WILL BE EXCAVATED AND REFILLED AT CONTRACTOR'S EXPENSE. INDICATE PERCENTAGE OF COMPACTION ACHIEVED ON AS-BUILT DRAWINGS.

4. PROTECTION

- A. PROTECT SEEDED AREAS FROM EROSION BY SPREADING STRAW TO A UNIFORM LOOSE DEPTH OF 1-2 INCHES, STAKE AND TIE DOWN AS REQUIRED. USE OF EROSION CONTROL MESH OR MULCH NET WILL BE AN ACCEPTABLE ALTERNATE.
- B. ALL TREES PLACED IN CONJUNCTION WITH A LANDSCAPE CONTRACT WILL BE WRAPPED, TIED WITH HOSE PROTECTED WIRE, AND SECURED TO 2" x 2" x 4' - 0" WOODEN STAKES EXTENDING TWO-FEET INTO THE GROUND ON FOUR SIDES OF THE TREE.
- C. PROTECT ALL EXPOSED AREAS AGAINST WASHOUTS AND SOIL EROSION. ALL EROSION CONTROL METHODS SHALL CONFORM TO APPLICABLE BUILDING CODE REQUIREMENTS.

DIVISION 16: UTILITY

SECTION 16050 - BASIC UTILITY MATERIALS AND METHODS

1. CONTRACTOR SHALL REVIEW THE CONTRACT DOCUMENTS PRIOR TO ORDERING THE UTILITY EQUIPMENT AND STARTING THE ACTUAL CONSTRUCTION. CONTRACTOR SHALL ISSUE A WRITTEN NOTICE OF ALL FINDINGS TO THE ARCHITECT/ENGINEER LISTING ANY DISCREPANCIES OR CONFLICTING INFORMATION.
2. UTILITY PLANS, DETAILS AND DIAGRAMS ARE DIAGRAMMATIC ONLY. VERIFY EXACT LOCATIONS AND MOUNTING HEIGHTS OF UTILITY EQUIPMENT WITH OWNER PRIOR TO INSTALLATION.
3. EACH CONDUCTOR OF EVERY SYSTEM SHALL BE PERMANENTLY TAGGED IN EACH PANELBOARD, PULLBOX, JUNCTION BOX, SWITCH BOX, ETC. THE TYPE OF TAGGING METHODS SHALL BE IN COMPLIANCE WITH OCCUPATIONAL SAFETY AND HEALTH ADMINISTRATION (O.S.H.A.).
4. ALL MATERIALS AND EQUIPMENT SHALL BE NEW AND IN GOOD WORKING CONDITION WHEN INSTALLED AND SHALL BE OF THE BEST GRADE AND OF THE SAME MANUFACTURER THROUGHOUT FOR EACH CLASS OR GROUP OF EQUIPMENT. MATERIALS SHALL BE LISTED "J" WHERE APPLICABLE. MATERIALS SHALL MEET WITH APPROVAL OF ALL GOVERNING BODIES HAVING JURISDICTION. MATERIALS SHALL BE MANUFACTURED IN ACCORDANCE WITH APPLICABLE STANDARDS ESTABLISHED BY ANSI, NEMA, NBFU AND "UL" LISTED.
5. ALL CONDUIT SHALL HAVE A PULL CORD.
6. PROVIDE PROJECT MANAGER WITH ONE SET OF COMPLETE UTILITY "AS INSTALLED" DRAWINGS AT THE COMPLETION OF THE JOB, SHOWING ACTUAL DIMENSIONS, ROUTINGS, AND CIRCUITS.

THIS SPACE INTENTIONALLY LEFT BLANK

CONSULTANT:



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GENERAL SPECIFICATIONS  
IA12 DT OELWEIN  
OELWEIN, IOWA

SUBMITTAL:

INT.	DATE:	DESCRIPTION:
TJT	07/16/25	REV. A
BSS	08/07/25	REV. B

CHECKED BY:	PER
EDGE SITE ID	S8464
EDGE PROJ. #	44517
SET TYPE	DRAFT
SHEET NUMBER	G-003



**SCHEDULE "B" EXHIBITS:**(per U.S. Title Solutions File No. UST75130, dated May 23, 2023)  
1-3.) Not related to the survey.

4.1)Resolution by City Council of the City of Oelwein, Iowa Dated February 28, 1966, Recorded May 06, 1966, in Book 13, Page 298.  
This document vacates a part of 4th Street SW and the Alley North of Block 1. The vacated alley is as shown the survey.

5.1)Plat of Survey Recorded December 20, 2007, in Book 2007, Page 3927.  
The portion of this plat related to the surveyed area is shown on the survey.

5.2)Survey and Plat Recorded July 28, 1981, in Book 6, Page 127.  
This survey does not affect the surveyed area and is not shown on the survey.

5.3)Ordinance Dated November 09, 1970, Recorded June 21, 1979, in Book 23, Page 67.  
Not a plottable matter of survey.

5.4)Ordinance Dated February 26, 1927, Recorded March 01, 1927, in Book 3, Page 33.  
Not a plottable matter of survey.

5.5)Plat of Miles Addition to Oelwein, Iowa Recorded May 22, 1899, in Book 2, Page 64.  
The portion of this plat related to the surveyed area is shown on the survey.

5.6)B. H. Bennett's Addition to Oelwein Dated August 04, 1875, Recorded August 10, 1875, in Book 1, Page 81.  
The portion of this plat related to the surveyed area is shown on the survey.

6.)Not related to the survey.

# SITE SURVEY


**PROPERTY DESCRIPTION:**(per U.S. Title Solutions File No. UST75130, dated May 23, 2023)  
(Per Tax Sale Deed in Book 79, Page 257)  
Lots 1 to 11, inclusive, Block 1, MILES ADDITION to Oelwein

(per Tax Sale Deed in Book 79, Page 259)  
Lot 5 and the West 34.3 feet of Lot 4, Block 5, BENNETTS ADDITION to Oelwein



(per Town Lot Deed No. 31, Page 211)  
Lot Four (4), Block Five (5) of BENNETTS ADDITION to Oelwein, Iowa

(per Town Lot Deed No. 24, Page 73)  
Lots One (1) and Two (2), Block Five (5), BENNETTS ADDITION, Oelwein, as shown on the recorded plat thereof

Per Town Lot Deed No. 18, Page 329)  
Lot Three (3) in Block Five (5) in BENNETTS ADDITION to the Village of Oelwein, Iowa

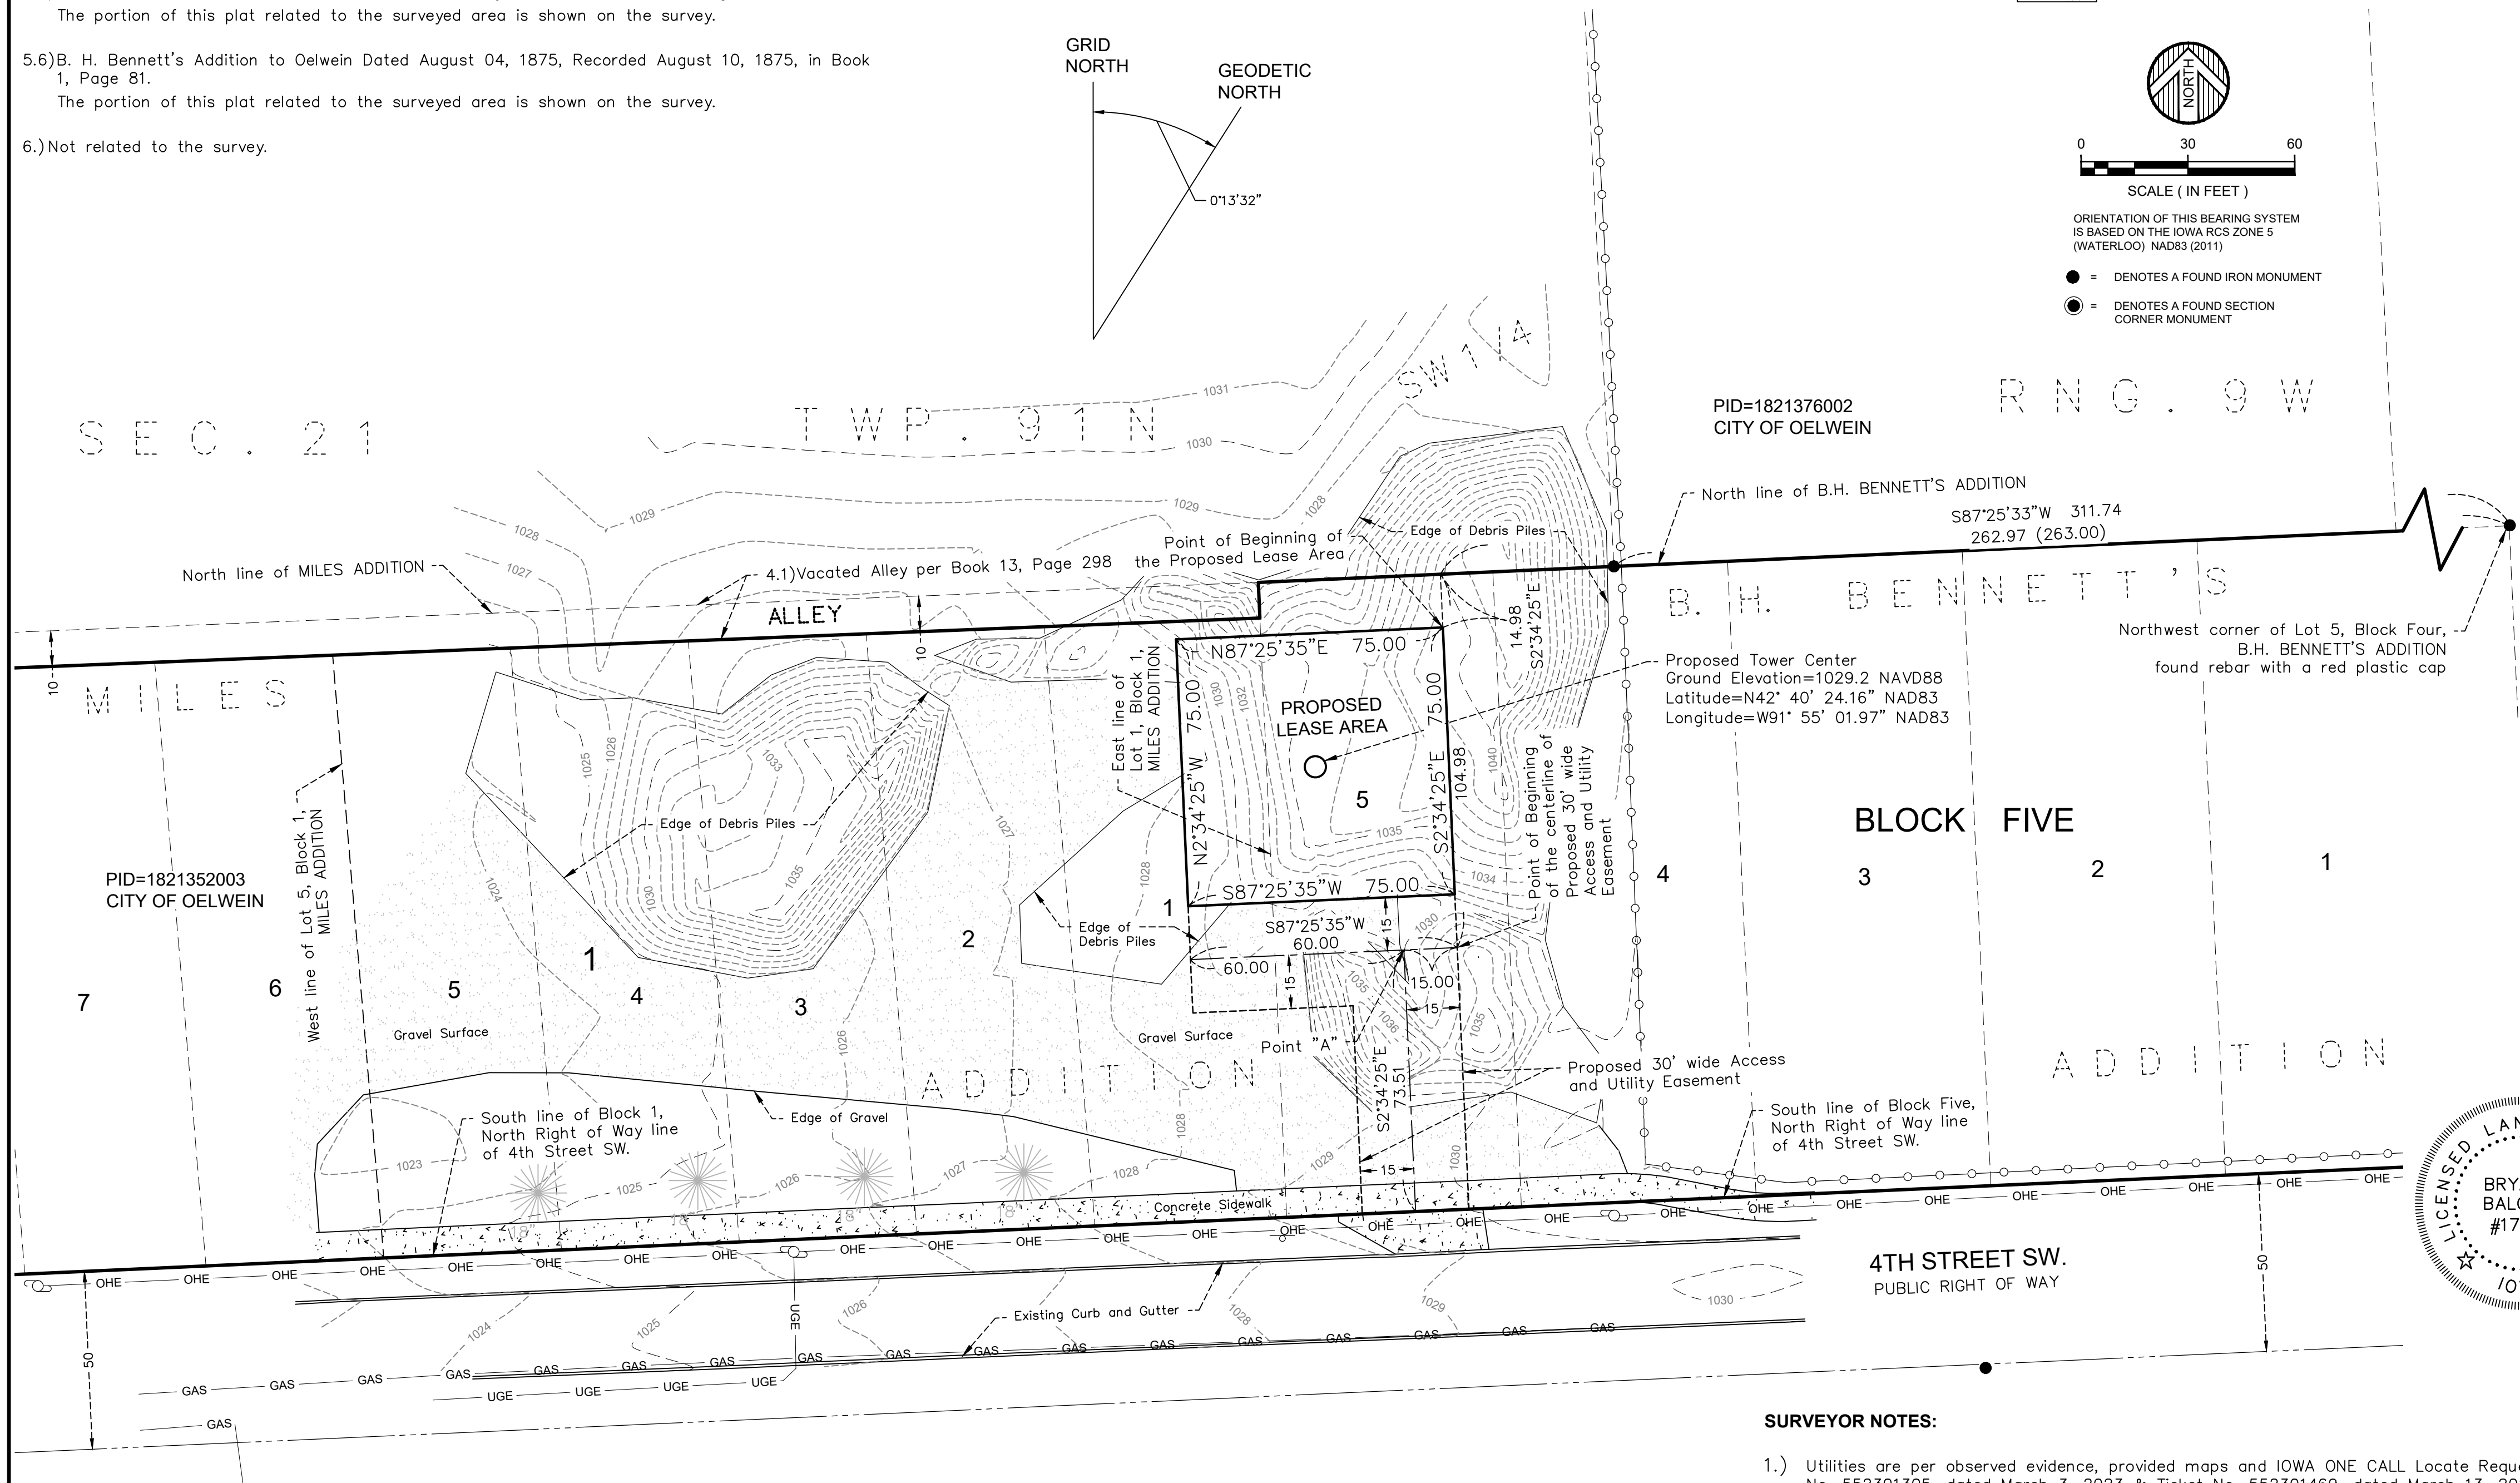


## LEGEND

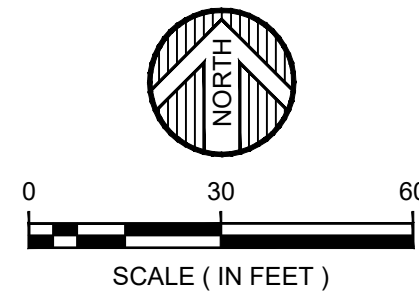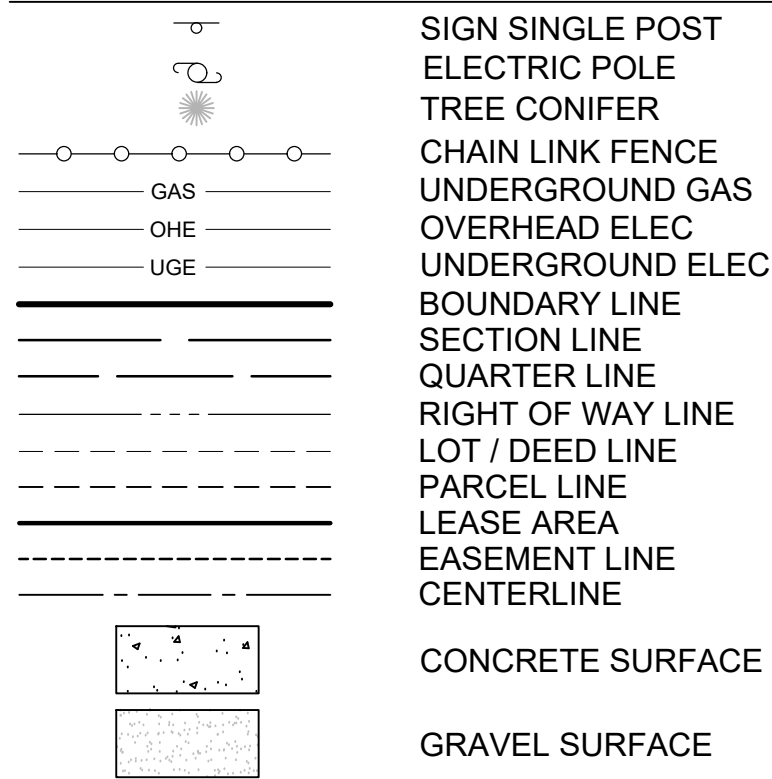

ORIENTATION OF THIS BEARING SYSTEM  
IS BASED ON THE IOWA RCS ZONE 5  
(WATERLOO) NAD83 (2011)

● = DENOTES A FOUND IRON MONUMENT  
⊙ = DENOTES A FOUND SECTION  
CORNER MONUMENT

## VICINITY MAP

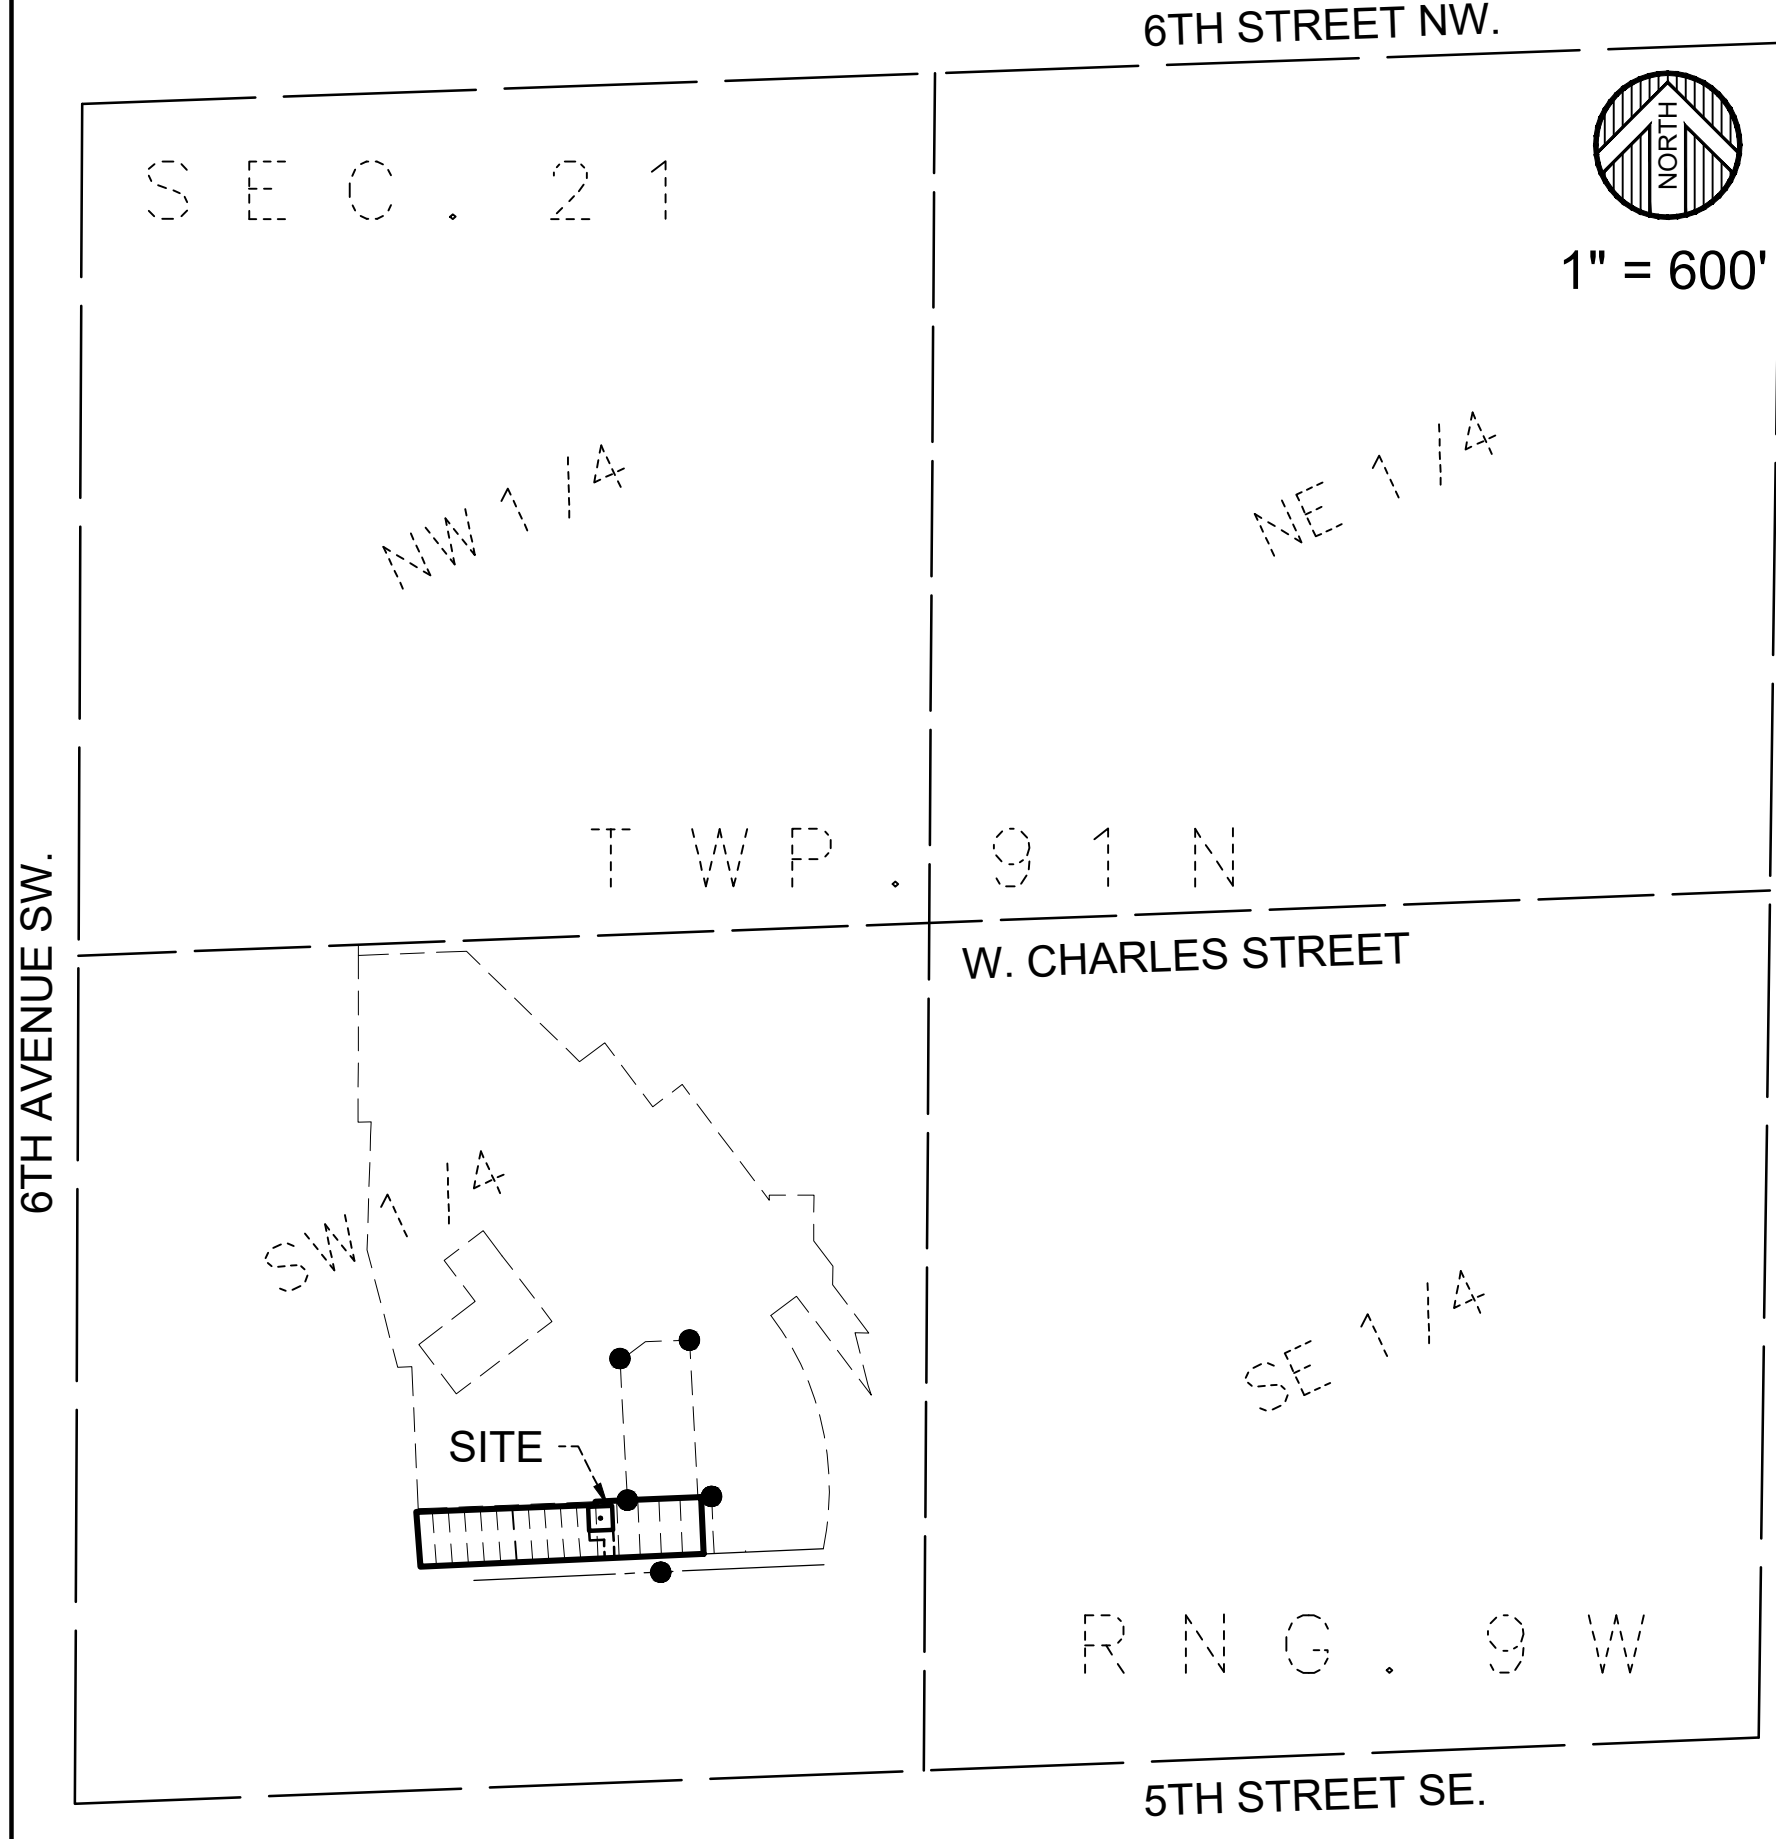

### PROPOSED LEASE AREA DESCRIPTION:

That part of Lot 5, Block Five, B.H. BENNETT'S ADDITION and Lot 1, Block 1, MILES ADDITION, according to the recorded plats thereof, Fayette County, Iowa, described as follows:

Commencing at the northwest corner of Lot 5, Block Four, said B.H. BENNETT'S ADDITION; thence South 87 degrees 25 minutes 33 seconds West along the North line of said B.H. BENNETT'S ADDITION, a distance of 311.74 feet; thence South 2 degrees 34 minutes 25 seconds East, a distance of 14.98 feet to the Point of Beginning of the lease area to be described; thence continue South 2 degrees 34 minutes 25 seconds East, a distance of 75.00 feet; thence South 87 degrees 25 minutes 35 seconds West, a distance of 75.00 feet; thence North 2 degrees 34 minutes 25 seconds East, a distance of 75.00 feet to the Point of Beginning.

### PROPOSED ACCESS AND UTILITY EASEMENT DESCRIPTION:

A 30.00 foot wide easement for ingress, egress and utility purposes over, under and across Lot 5, Block Five, B.H. BENNETT'S ADDITION and Lot 1, Block 1, MILES ADDITION, according to the recorded plats thereof, Fayette County, Iowa, the centerline of said easement is described as follows:

Commencing at the northwest corner of Lot 5, Block Four, said B.H. BENNETT'S ADDITION; thence South 87 degrees 25 minutes 33 seconds West along the North line of said B.H. BENNETT'S ADDITION, a distance of 311.74 feet; thence South 2 degrees 34 minutes 25 seconds East, a distance of 104.98 feet to the Point of Beginning of the centerline to be described; thence South 87 degrees 25 minutes 35 seconds West, a distance of 15.00 feet to a point hereinafter referred to as Point "A"; thence continue South 87 degrees 25 minutes 35 seconds West, a distance of 60.00 feet and said centerline there terminating.

TOGETHER WITH

A 30.00 foot wide easement for ingress, egress and utility purposes over, under and across said Lot 5, the centerline of said easement is described as follows:

Beginning at the previously described Point "A"; thence South 2 degrees 34 minutes 25 seconds East, a distance of 73.51 feet to the North right of way line of 4th Street Southwest and said centerline there terminating.

The sidelines of said easement shall be shortened or lengthened to terminate at said North right of way line of 4th Street Southwest.

### SURVEYOR NOTES:

- Utilities are per observed evidence, provided maps and IOWA ONE CALL Locate Request Ticket No. 552301305, dated March 3, 2023 & Ticket No. 552301469, dated March 13, 2023.
- This survey was completed for Edge Consulting Engineers Inc.



SITE NAME: IA12 DT OELWEIN

Fayette County, IA

No.	Date	REVISIONS	By	CHK	APP'D
1	3/21/23	FIELD WORK	BTB		JMB
2		CHECKED BY	BTB		JMB
3		DRAWN BY	JMB		JMB

I HEREBY CERTIFY THAT THIS LAND SURVEYING DOCUMENT WAS PREPARED AND THE RELATED SURVEY WORK WAS PERFORMED BY ME OR UNDER MY DIRECT PERSONAL SUPERVISION AND THAT I AM A DULY LICENSED LAND SURVEYOR UNDER THE LAWS OF THE STATE OF IOWA

SIGNATURE: *Bryan T. Balcome*  
BRYAN T. BALCOME, L.S.  
DATE: 6/28/23  
LICENSE # 17677  
MY LICENSE RENEWAL DATE IS DECEMBER 31, 2024

FULL SCALE ON 22"x34"  
HALF SCALE ON 11"x17"  
2023-10340

**WIDSETH**  
ARCHITECTS ■ ENGINEERS ■ SCIENTISTS ■ SURVEYORS

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CLIENT:

**verizon**  
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BLOOMINGTON, MN 55438

ENGINEER SEAL:

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**SITE PLAN**  
**IA12 DT OELWEIN**  
**OELWEIN, IOWA**



SUBMITTAL:

INT.	DATE:	DESCRIPTION:
TJT	07/16/25	REV. A
BSS	08/07/25	REV. B

CHECKED BY	PER
EDGE SITE ID	S8464
EDGE PROJ. #	44517
SET TYPE	DRAFT

SHEET NUMBER **C-101**

NOTE:  
1. FIBER COORDINATION IS NOT COMPLETE (PENDING FIBER CONTACT). PRIOR TO CONSTRUCTION, CONTACT DESIGNER FOR UPDATE.

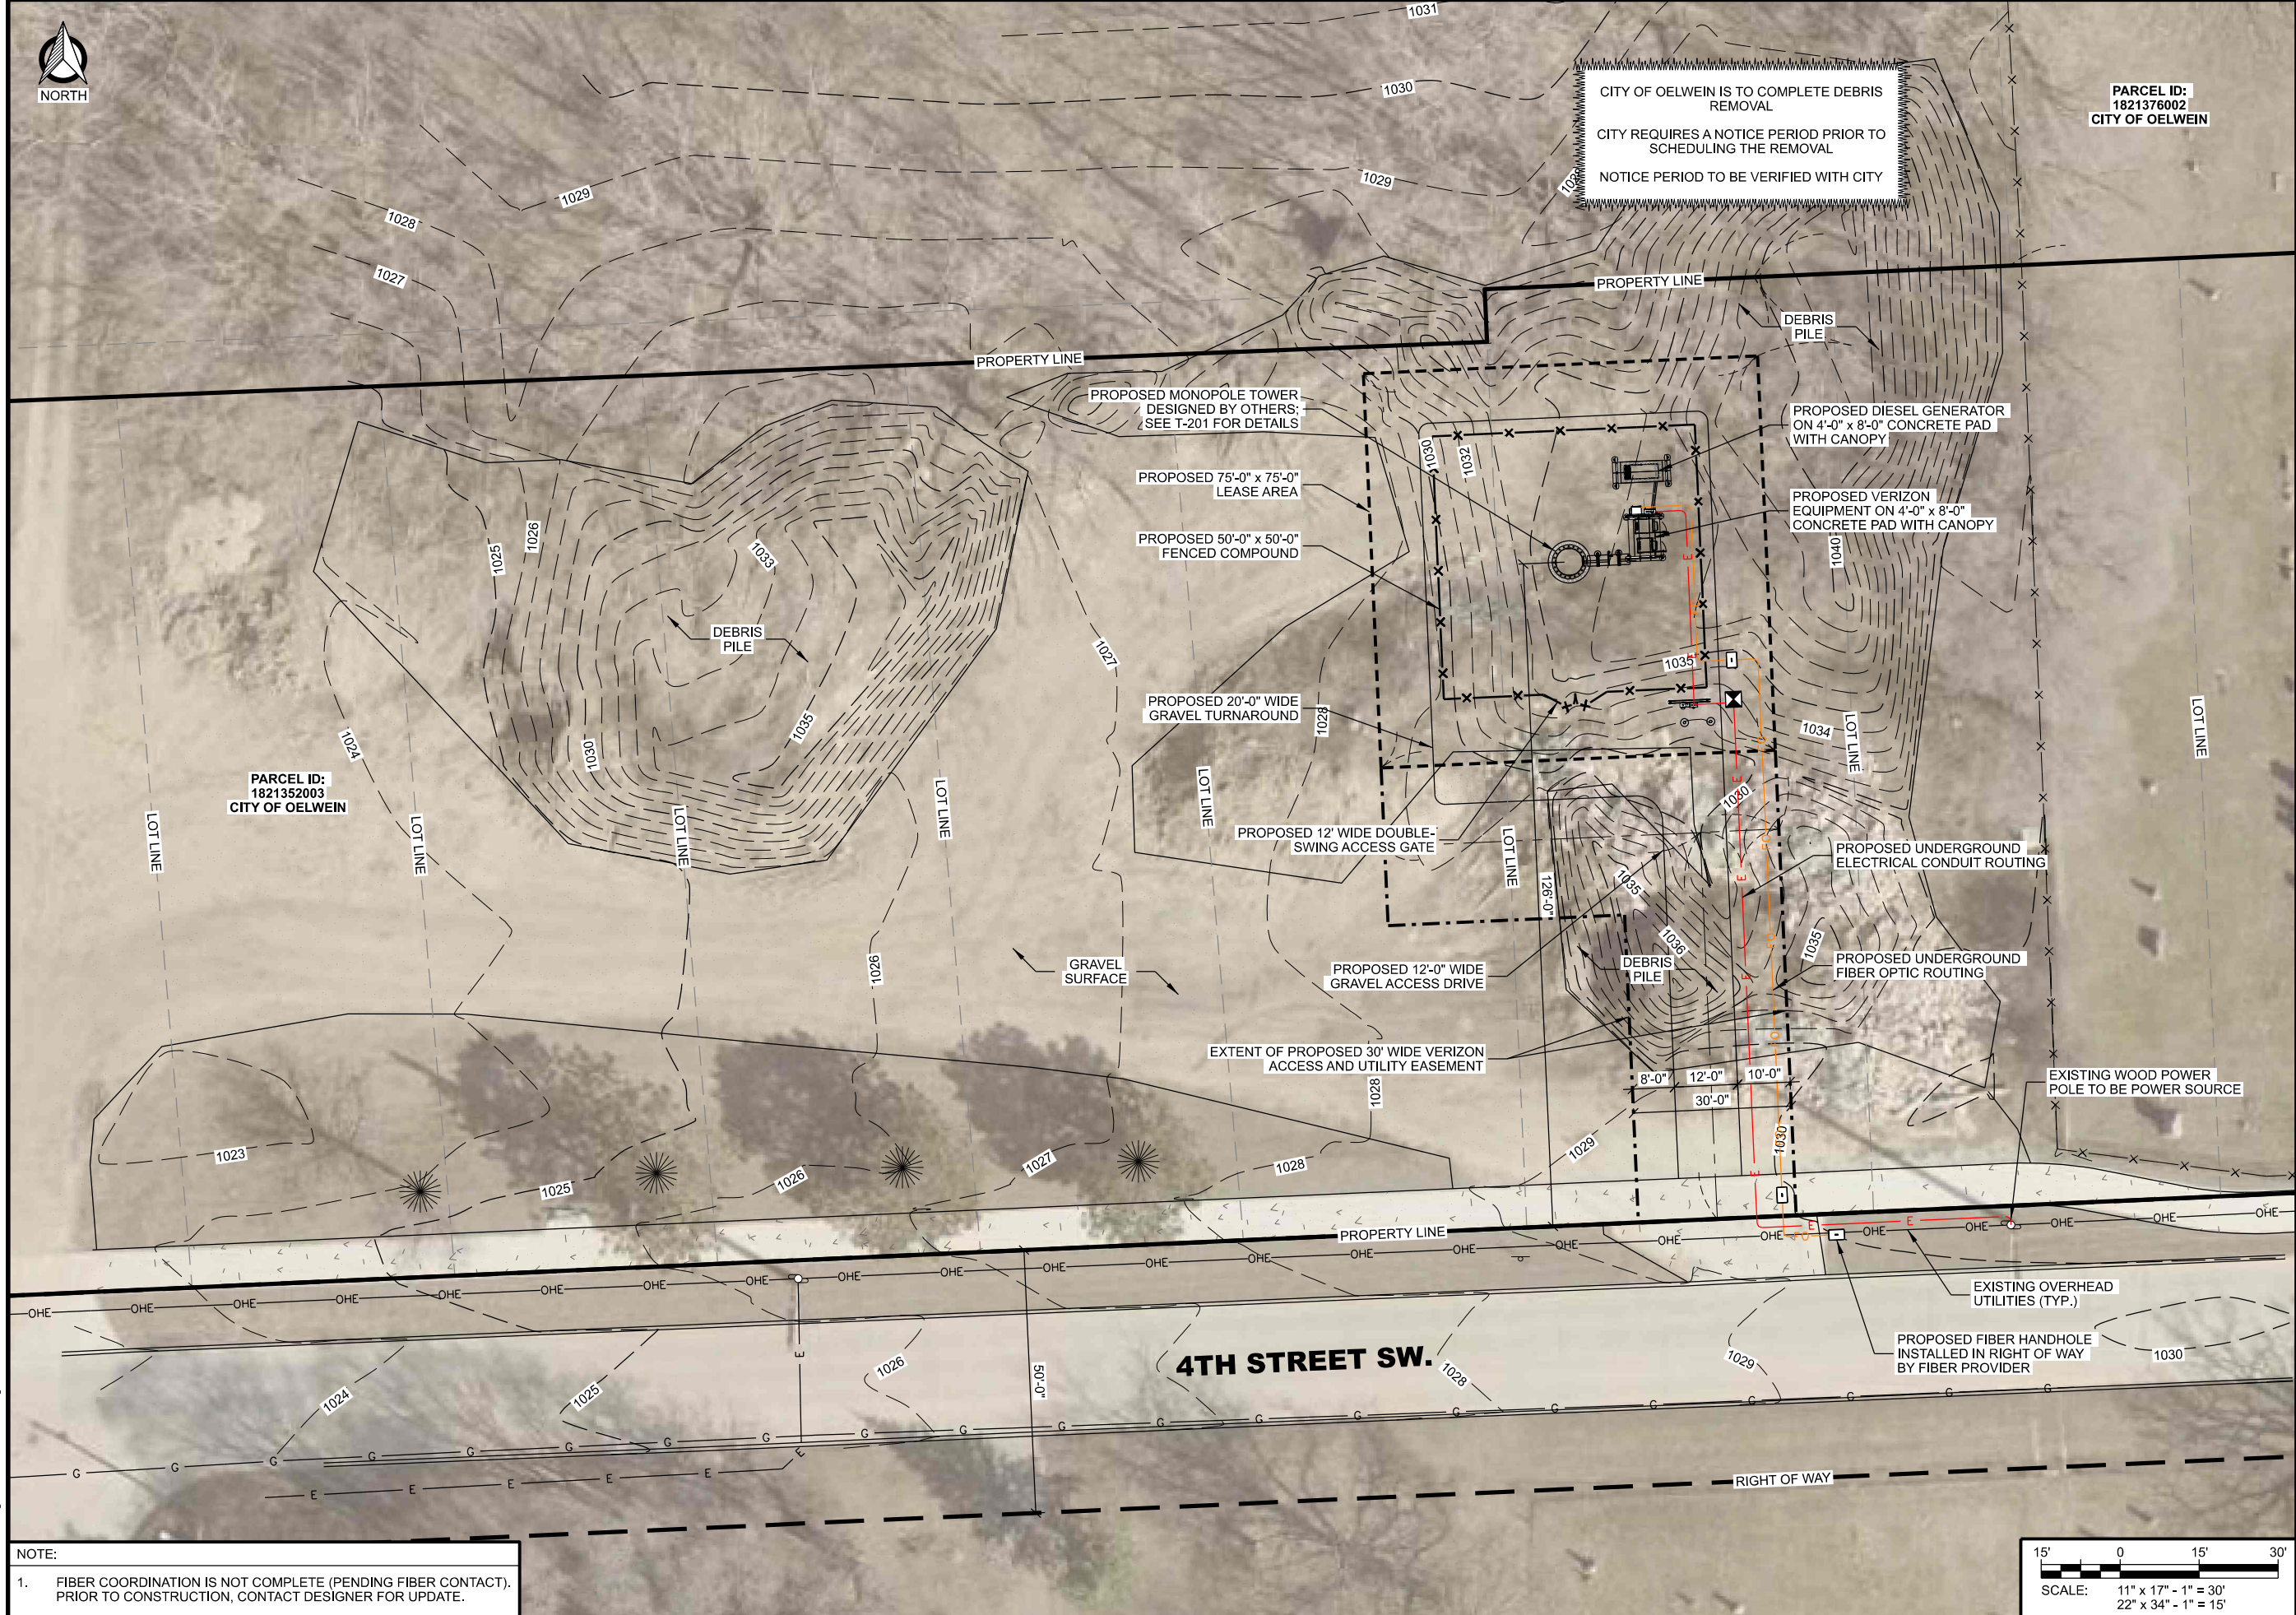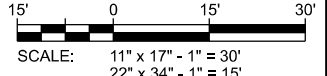

L:\44500\44517\Design\CADD\CD\IP\et\c-101.dgn





NORTH

PROPERTY LINE

75'-0" LEASE AREA

PROPOSED  
75' x 75' LEASE AREA

50'-0" FENCED COMPOUND

PROPOSED 50'-0" x 50'-0"  
FENCED COMPOUND

PROPOSED VERIZON DIESEL GENERATOR  
ON 4'-0" x 8'-0" CONCRETE PAD;  
SEE E-001 & E-002 FOR DETAILS

PROPOSED VERIZON OVERHEAD  
GENERATOR CANOPY TO BE  
INSTALLED BY VERIZON CONTRACTOR;  
SEE E-003 FOR DETAILS

(3) PROPOSED BURIED CONDUITS  
FROM GENERATOR TO ILC;  
SEE E-102 FOR DETAILS  
PROPOSED VERIZON  
INTEGRATED LOAD CENTER (ILC);  
SEE E-505 FOR DETAILS

PROPOSED VERIZON EQUIPMENT  
CABINETS ON 4'-0" x 8'-0" CONCRETE PAD;  
SEE 'A' SERIES FOR DETAILS

PROPOSED VERIZON OVERHEAD  
EQUIPMENT CANOPY TO BE INSTALLED  
BY VERIZON CONTRACTOR;  
SEE A-201 FOR DETAILS

PROPOSED VERIZON CHARLES  
CUBE FIBER JUNCTION BOX;  
SEE E-505 FOR DETAILS

PROPOSED MONOPOLE  
DESIGNED BY OTHERS;  
SEE T-201 FOR DETAILS

PROPOSED 8'-0" ± ICE BRIDGE;  
SEE C-501 FOR DETAILS

GRAVEL COMPOUND

PROPOSED VERIZON COMPOUND  
FIBER VAULT TO BE INSTALLED BY  
VERIZON CONTRACTOR;  
SEE E-102 FOR DETAILS

PROPOSED MULTI-METER RACK

PROPOSED  
TRANSFORMER

PROPOSED 12' WIDE DOUBLE-  
SWING ACCESS GATE

PROPOSED CONCRETE-FILLED  
BOLLARD (TYP.)

PROPOSED UNDERGROUND  
UTILITY CONDUIT ROUTING,  
APPROX. 100' FROM R.O.W.;  
SEE E-102 FOR DETAILS

GRAVEL  
TURNAROUND

- NOTE:
- FIBER COORDINATION IS NOT COMPLETE (PENDING FIBER CONTACT).  
PRIOR TO CONSTRUCTION, CONTACT DESIGNER FOR UPDATE.



B

PROPOSED LEASE AREA

CONSULTANT:

**Edge**  
Consulting Engineers, Inc.  
624 WATER STREET  
PRAIRIE DU SAC, WI 53578  
608.644.1449 VOICE  
608.644.1549 FAX  
www.edgeconsult.com

CLIENT:

**verizon**  
10801 BUSH LAKE RD  
BLOOMINGTON, MN 55438

ENGINEER SEAL:

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SET WAS PREPARED BY ME OR  
UNDER MY DIRECT SUPERVISION  
OTHER THAN THE EXCEPTIONS  
NOTED IN THE SHEET INDEX, AND  
THAT I AM A DULY LICENSED  
PROFESSIONAL ENGINEER  
UNDER THE LAWS OF THE  
STATE OF IOWA.

**ENLARGED SITE PLAN**  
**1A12 DT OELWEIN**  
**OELWEIN, IOWA**

SUBMITTAL:

INT.	DATE:	DESCRIPTION:
TJT	07/16/25	REV. A
BSS	08/07/25	REV. B

CHECKED BY:

PER

EDGE SITE ID

S8464

EDGE PROJ. #


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SET TYPE

DRAFT


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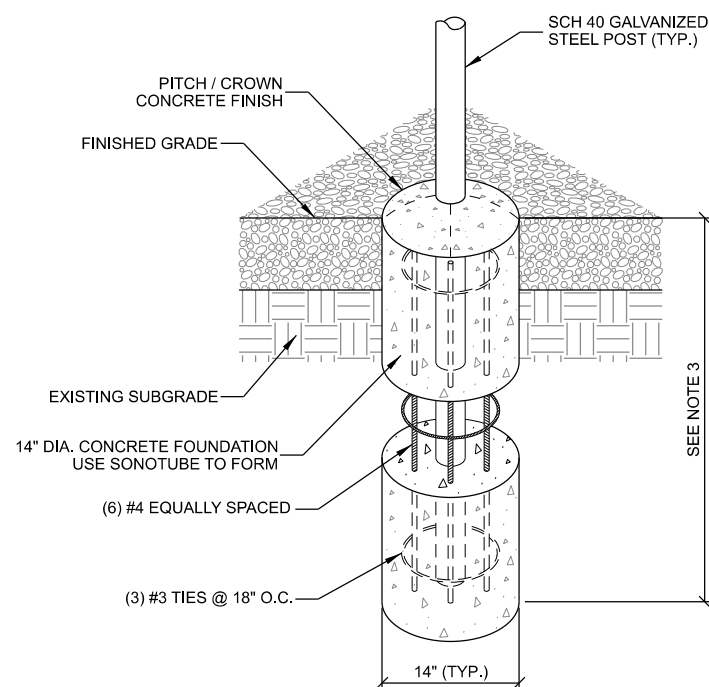
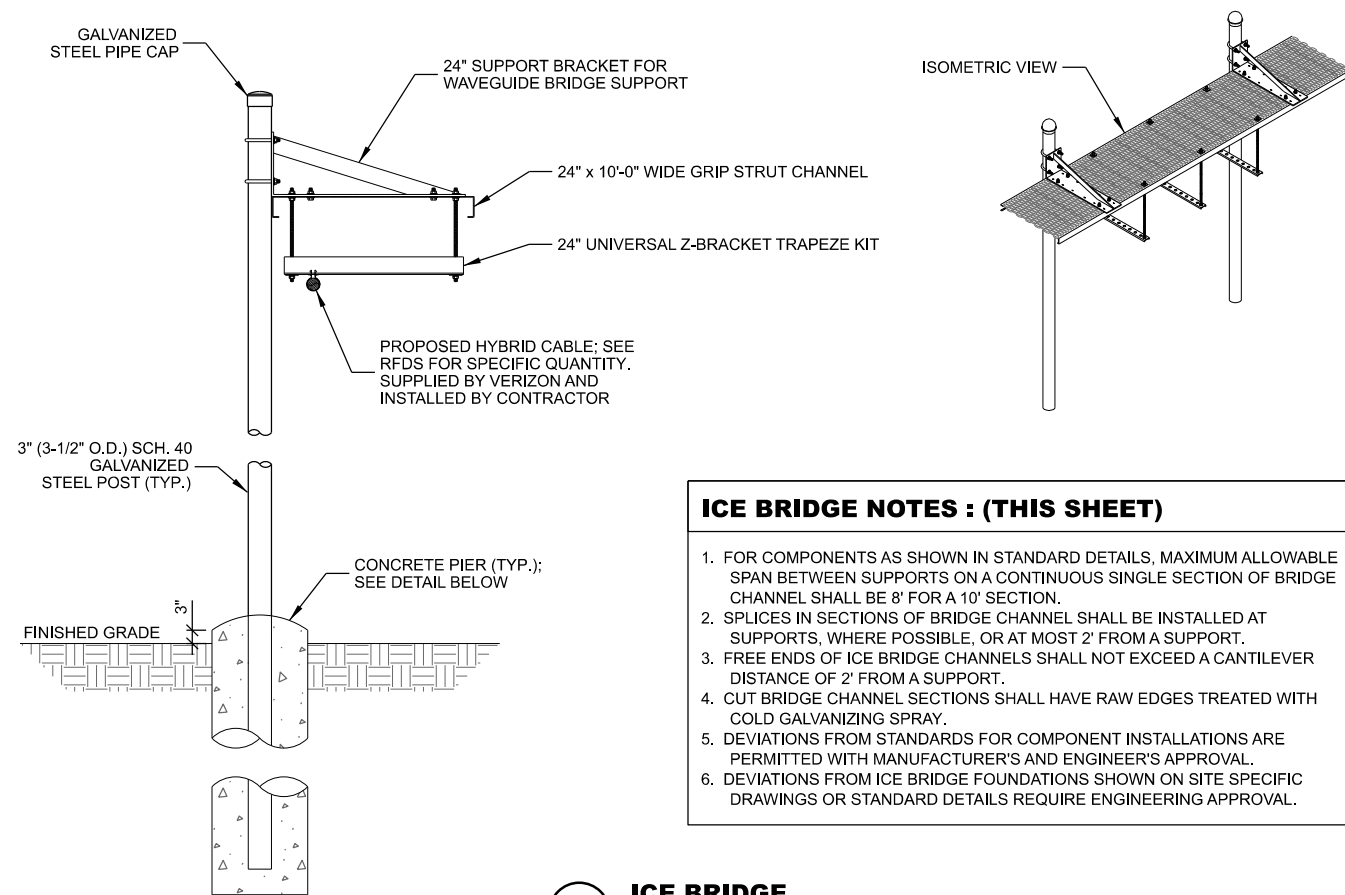


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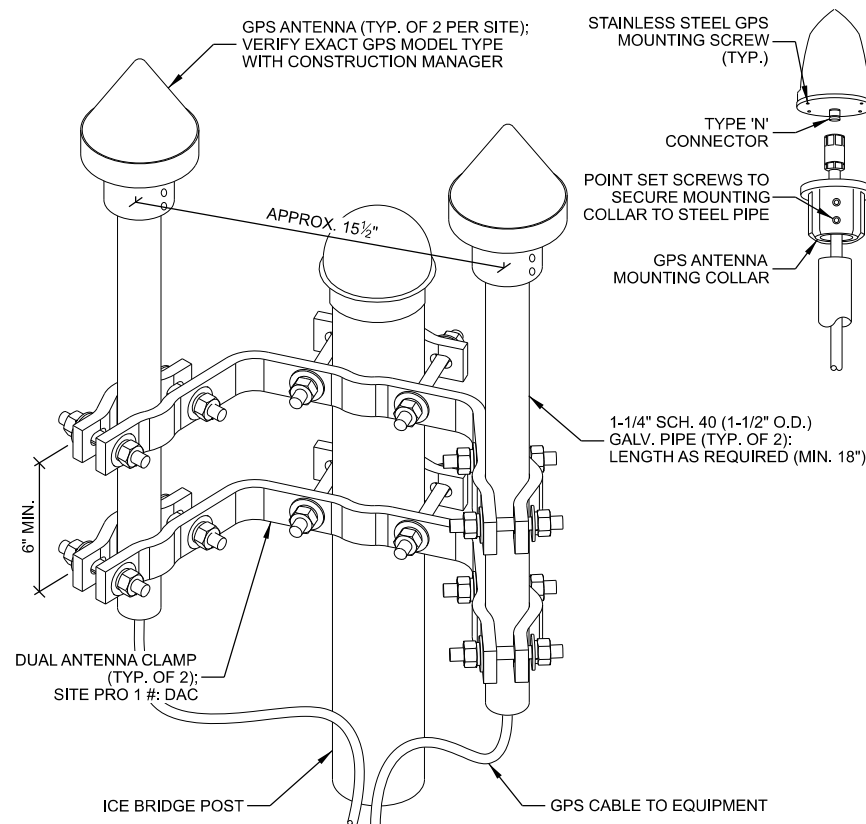


## **A ICE BRIDGE INSTALLATION**

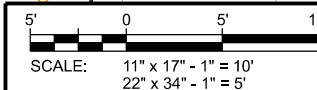

- |        |  |
|--------|--|
| NOTES: |  |
| 1.     | MAINTAIN 3" MINIMUM REBAR COVER WITH CONCRETE IN ALL DIRECTIONS. |
| 2.     | CONCRETE MIX TO BE 4,000 PSI @ 28 DAYS.                          |
| 3.     | FOUNDATION DEPTH TO EXCEED LOCAL FROST DEPTH, OR 48" MINIMUM.    |
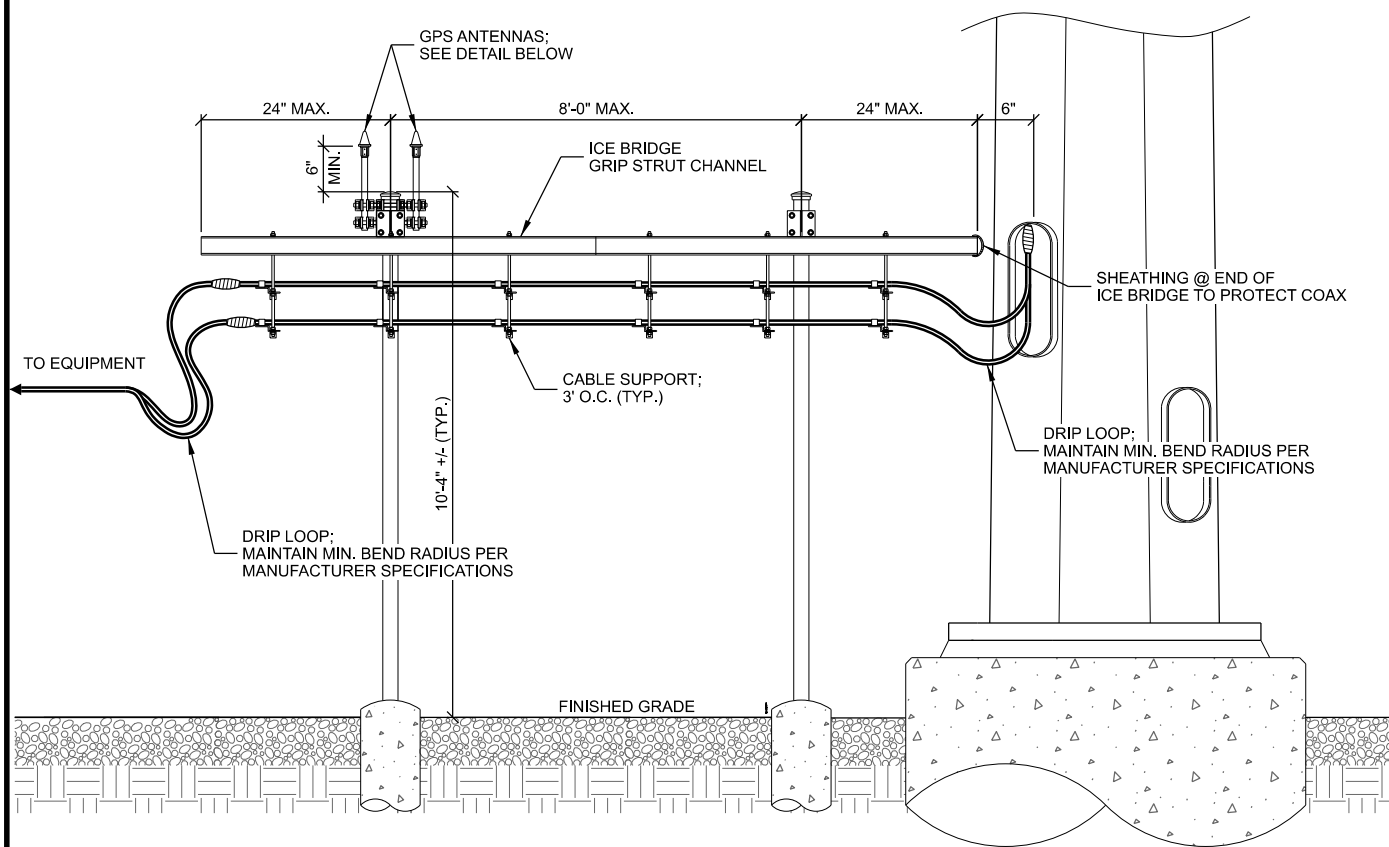
## C ICE BRIDGE POST PIER FOUNDATION



## D GPS ANTENNA MOUNTING

**THIS SPACE INTENTIONALLY LEFT BLANK**

CONSULTANT:



**CLIENT:**



ENGINEER SEAL:

**- PRELIMINARY -  
NOT FOR CONSTRUCTION**

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# ICE BRIDGE AND GPS DETAILS

## IA12 DT OELWEIN

### OELWEIN, IOWA

SUBMITTAL:

[illegible]

CHECKED BY	PER
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EDGE SITE ID	S8464
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EDGE PROJ. #	44517
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SET TYPE	DRAFT
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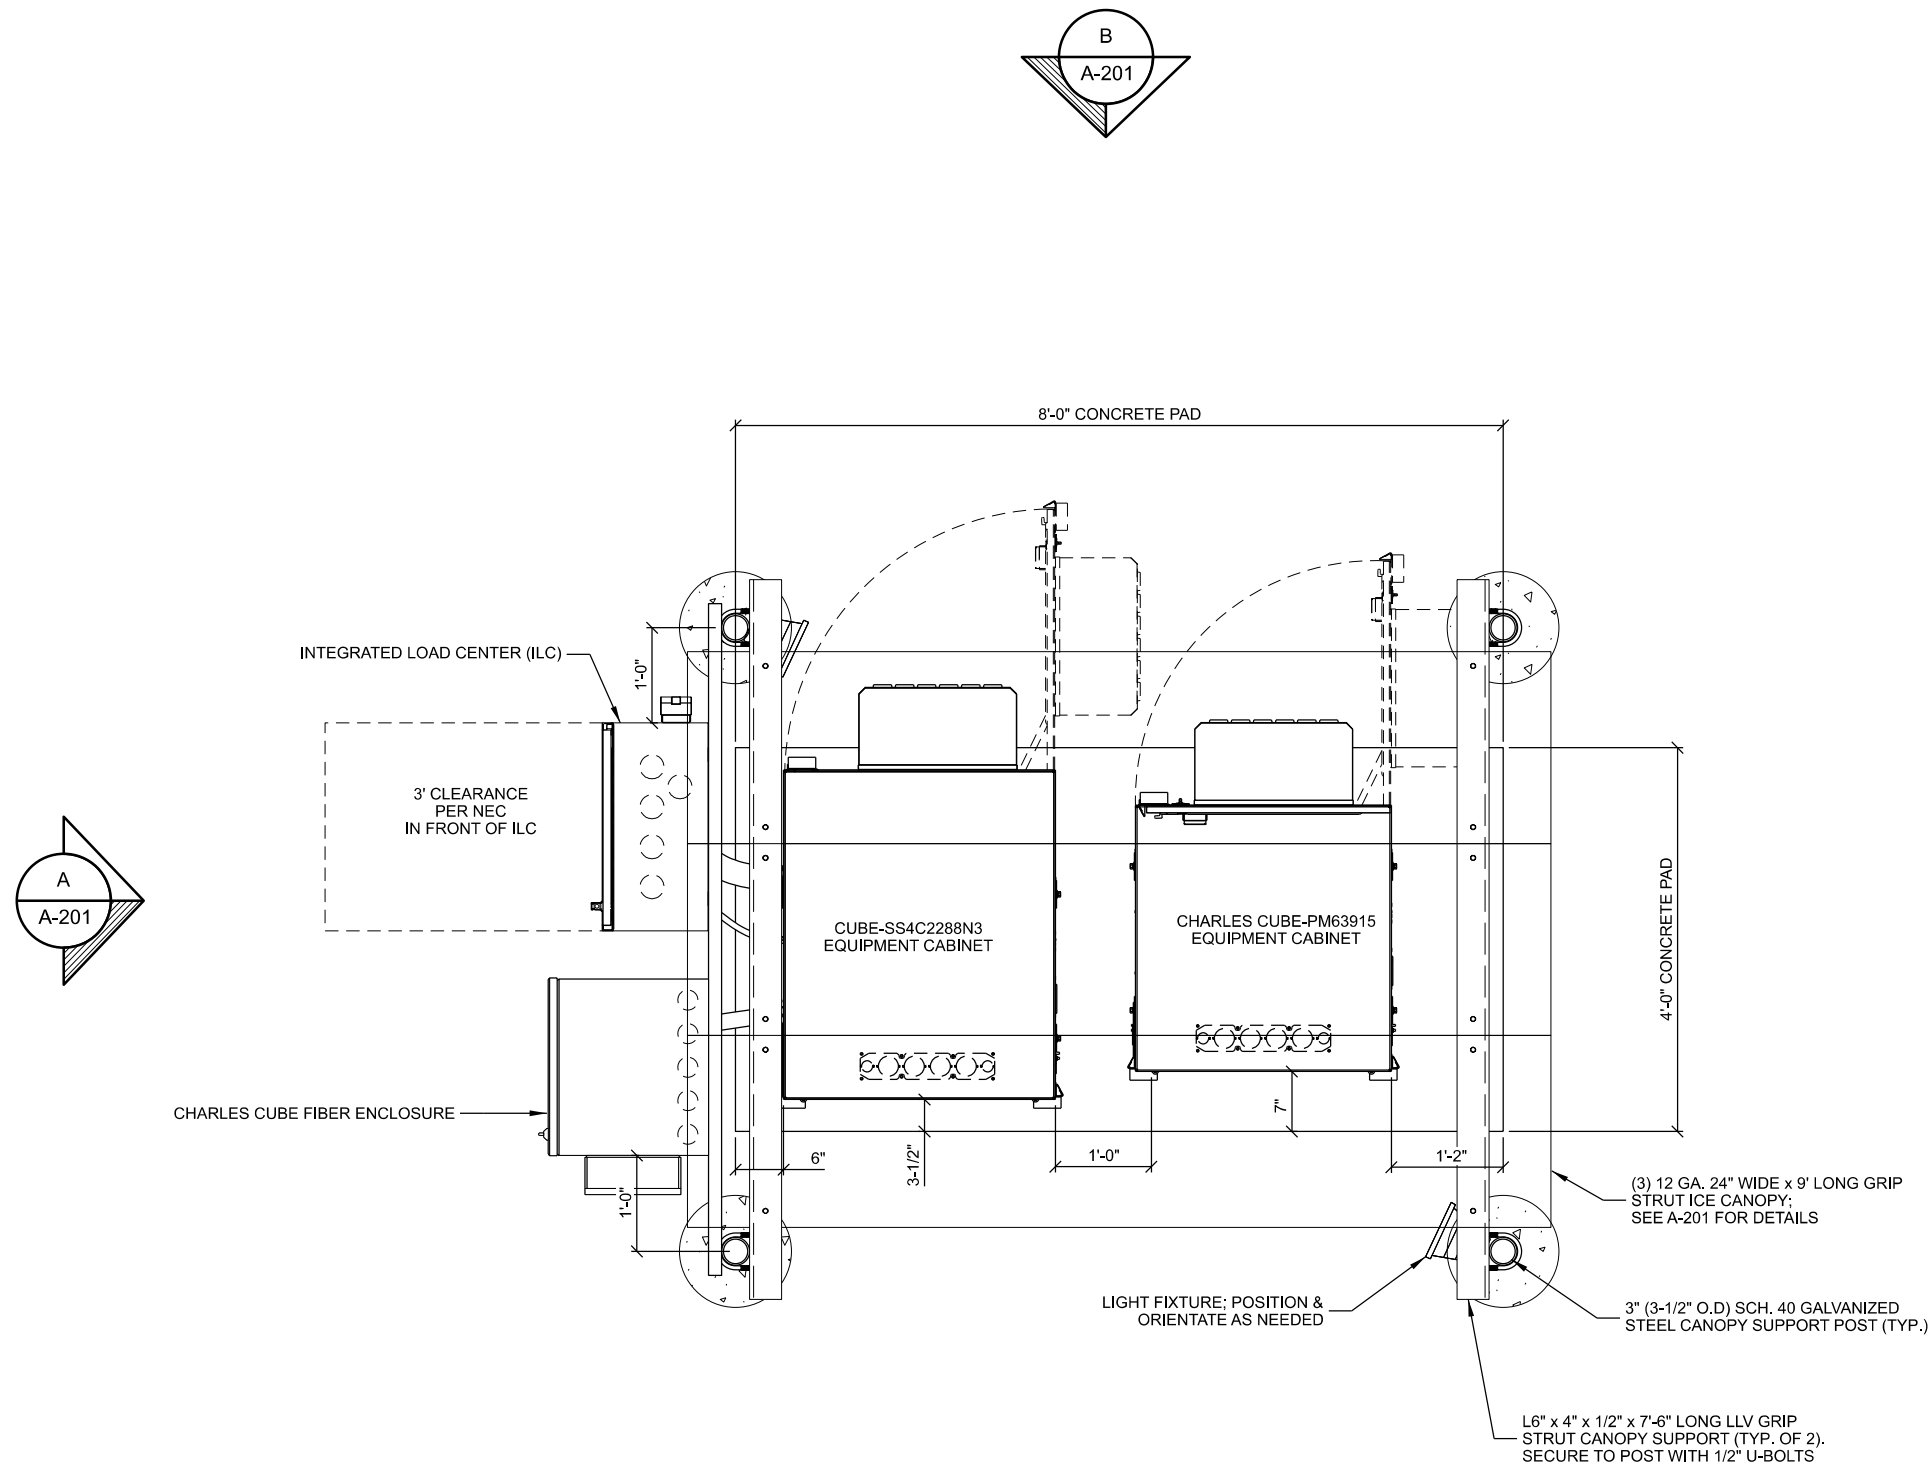
SHEET  
NUMBER

**C-501**





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**A** **EQUIPMENT PAD LAYOUT**  
SCALE: 11" x 17" - 1/2" = 1'-0"  
22" x 34" - 1" = 1'-0"

CONSULTANT:  
**Edge**  
Consulting Engineers, Inc.  
624 WATER STREET  
PRAIRIE DU SAC, WI 53578  
608.644.1449 VOICE  
608.644.1549 FAX  
www.edgeconsult.com

CLIENT:  
**verizon**  
10801 BUSH LAKE RD  
BLOOMINGTON, MN 55438

ENGINEER SEAL:  
**NOT FOR CONSTRUCTION**


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**EQUIPMENT PAD LAYOUT**  
**IA12 DT OELWEIN**  
**OELWEIN, IOWA**


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INT.	DATE:	DESCRIPTION:
TJT	07/16/25	REV. A
BSS	08/07/25	REV. B

CHECKED BY:	PER
EDGE SITE ID	S8464
EDGE PROJ. #	44517
SET TYPE	DRAFT
SHEET NUMBER	<b>A-101</b>

REBAR SCHEDULE		
SIZE	LENGTH	QTY
#4	7'-6"	8
#4	3'-6"	12
#5	2'-0"	4

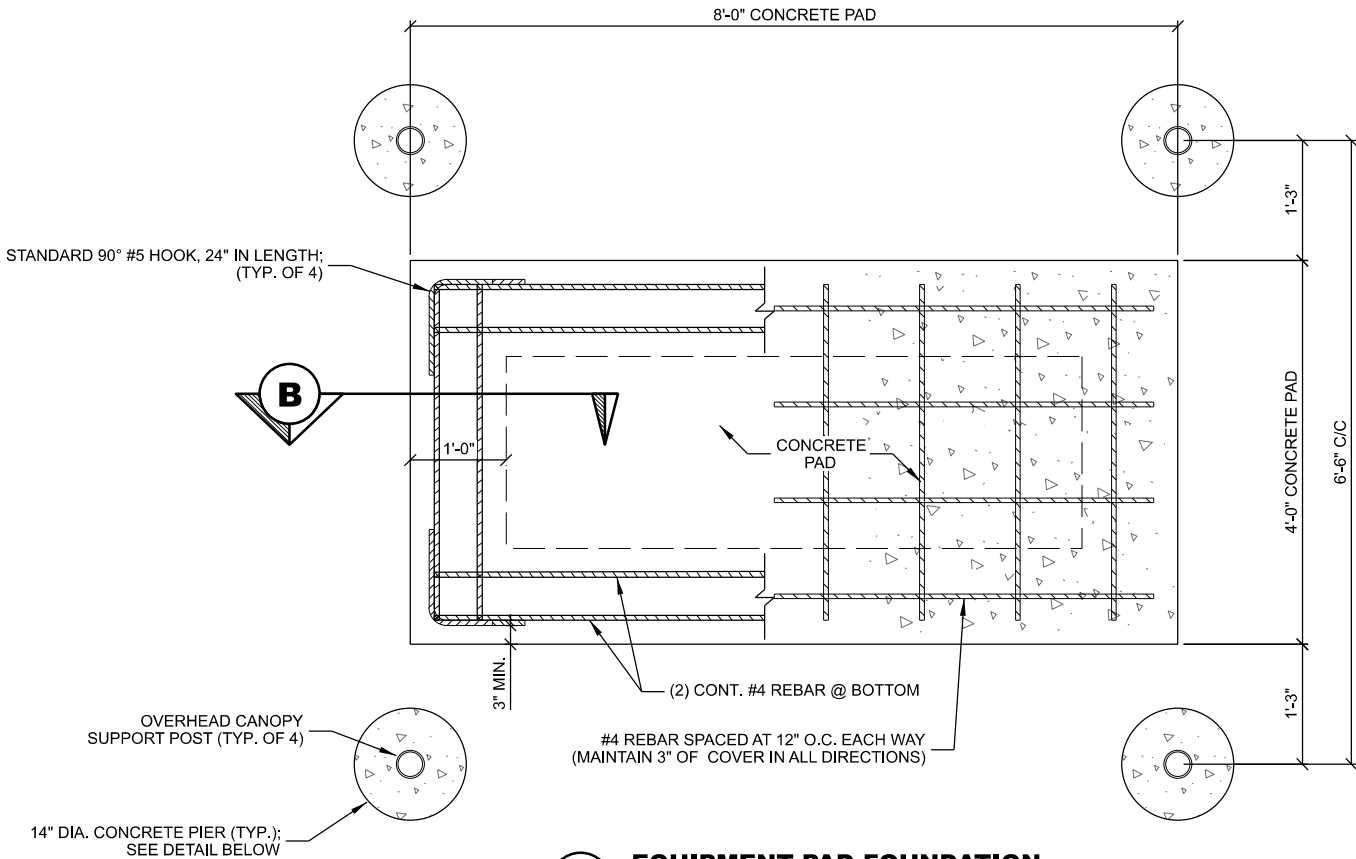


**A EQUIPMENT PAD FOUNDATION**  
SCALE: 11" x 17" - 1/2" = 1'-0"  
22" x 34" - 1" = 1'-0"

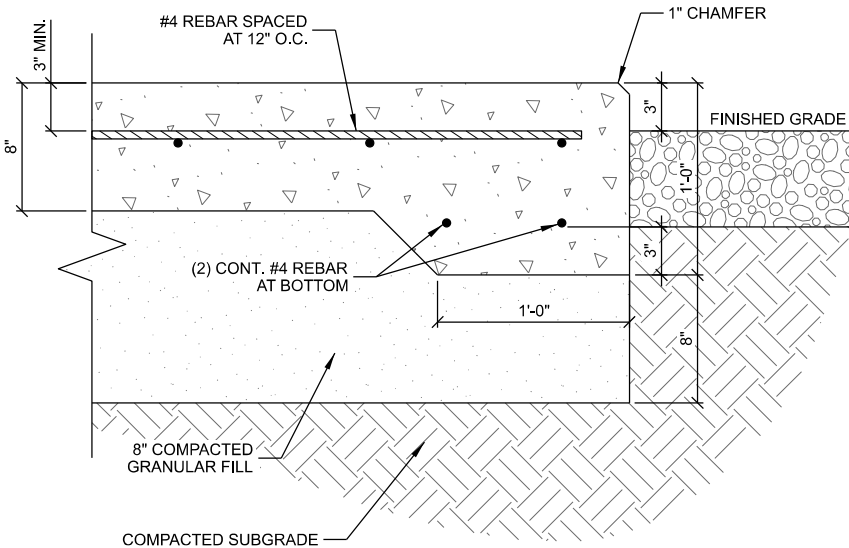

NOTE:  
1. 3" MIN. CONCRETE COVER OVER BAR AND WIRE.

**B THICKENED SLAB FOUNDATION**

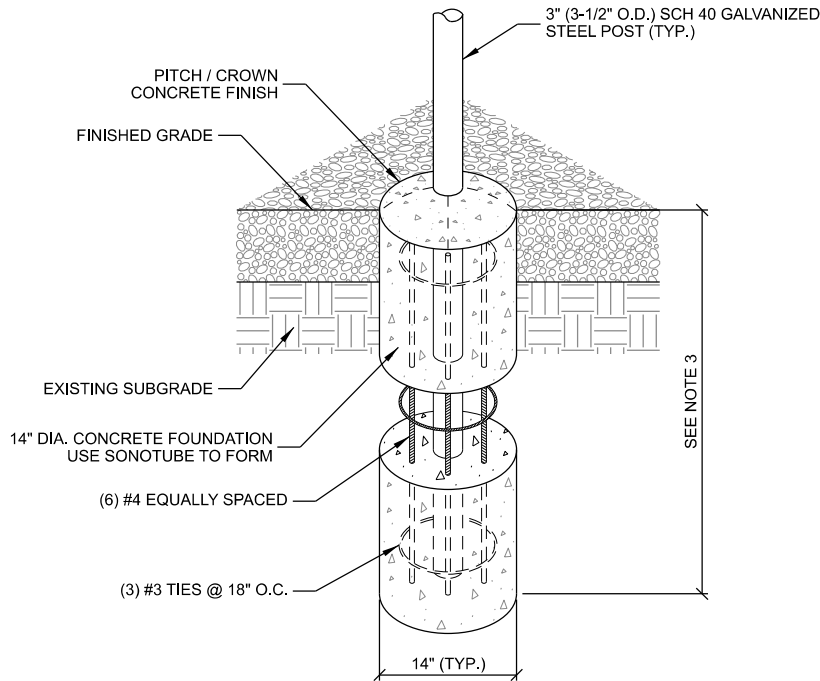

NOTES:  
1. MAINTAIN 3" MINIMUM REBAR COVER WITH CONCRETE IN ALL DIRECTIONS.  
2. CONCRETE MIX TO BE 4,000 PSI @ 28 DAYS.  
3. FOUNDATION DEPTH TO EXCEED LOCAL FROST DEPTH, OR 48" MINIMUM.

**C CANOPY POST PIER FOUNDATION**

**CONCRETE AND REINFORCING NOTES:**

- ALL CONCRETE CONSTRUCTION SHALL BE IN ACCORDANCE WITH LOCAL CODE REQUIREMENTS AND MOST CURRENT VERSION OF ACI STANDARDS.
- ALL EXPOSED CONCRETE SURFACES EXPOSED TO VIEW SHALL HAVE A SURFACE FINISH SF-2.0 IN ACCORDANCE WITH ACI 301.
- ALL CONCRETE UNLESS SPECIFICALLY NOTED SHALL BE NORMAL WEIGHT (145 PCF) AND SHALL ACHIEVE A 28-DAY COMPRESSIVE STRENGTH (f<sub>c</sub>) OF 4,000 PSI. EXPOSED EXTERIOR CONCRETE TO BE AIR ENTRAINED WITH 6% AIR CONTENT. CONTRACTOR TO PERFORM CONCRETE SLUMP TEST (4" MAX SLUMP). NO WATER TO BE ADDED AFTER SLUMP HAS BEEN MEASURED.
- ALL CONCRETE REINFORCING SHALL BE ASTM A615 GRADE 60 AND PLACED IN ACCORDANCE WITH ACI STANDARDS W/ 3" MIN COVERAGE IF CAST AGAINST EARTH AND 2" MIN COVERAGE OTHERWISE.
- REMOVE ALL ORGANIC MATERIAL, SOFT AREAS, AND POOR SOILS BENEATH FOUNDATION TO A DEPTH OF AT LEAST 2'-0" BELOW FOUNDATION.
- SLAB NOT SUITABLE AT SITES WITH ORGANIC SOIL, UNCOMPACTED FILL, EXPANSIVE SOIL, OR SOILS SUSCEPTIBLE TO FROST HEAVE.
- CONTRACTOR TO ENSURE POSITIVE DRAINAGE FROM ALL FOUNDATIONS.
- DESIGN BASED ON A PRESUMPTIVE SOIL BEARING CAPACITY OF 2000 PSF. NO GEOTECHNICAL REPORT FOR THE EQUIPMENT PAD HAS BEEN COMPLETED.

CONSULTANT:

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CLIENT:

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ENGINEER SEAL:

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**EQUIPMENT PAD DETAILS**  
IA12 DT OELWEIN  
OELWEIN, IOWA


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INT.	DATE:	DESCRIPTION:
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BSS	08/07/25	REV. B

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EDGE PROJ. #	44517
SET TYPE	DRAFT
SHEET NUMBER	<b>A-102</b>




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- NOTES:
1. CONDUITS AND CABLING NOT SHOWN FOR CLARITY.
  2. ELEVATIONS PROVIDED FOR CONVENIENCE ONLY.
  3. SECURE CABINET(S) TO CONCRETE PAD PER MANUFACTURERS SPECIFICATIONS

**A EQUIPMENT PAD SIDE ELEVATION**

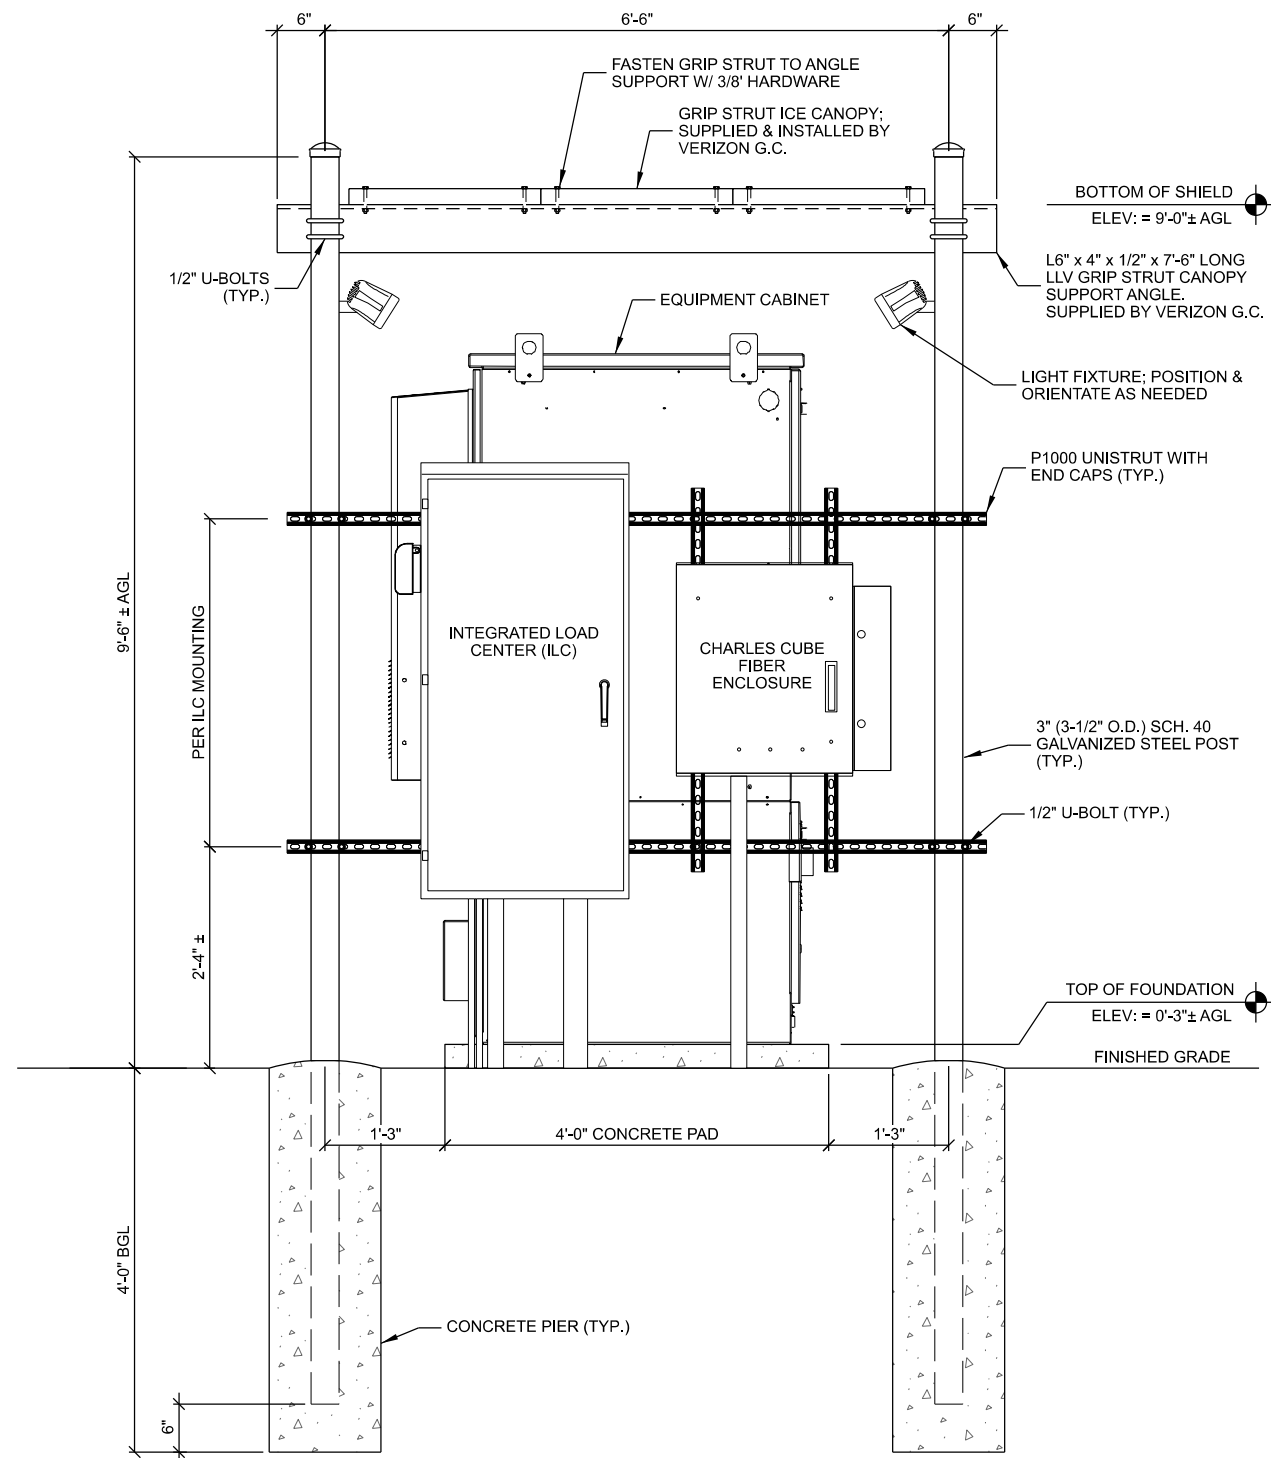

- NOTES:
1. CONDUITS AND CABLING NOT SHOWN FOR CLARITY.
  2. ELEVATIONS PROVIDED FOR CONVENIENCE ONLY.
  3. SECURE CABINET(S) TO CONCRETE PAD PER MANUFACTURERS SPECIFICATIONS

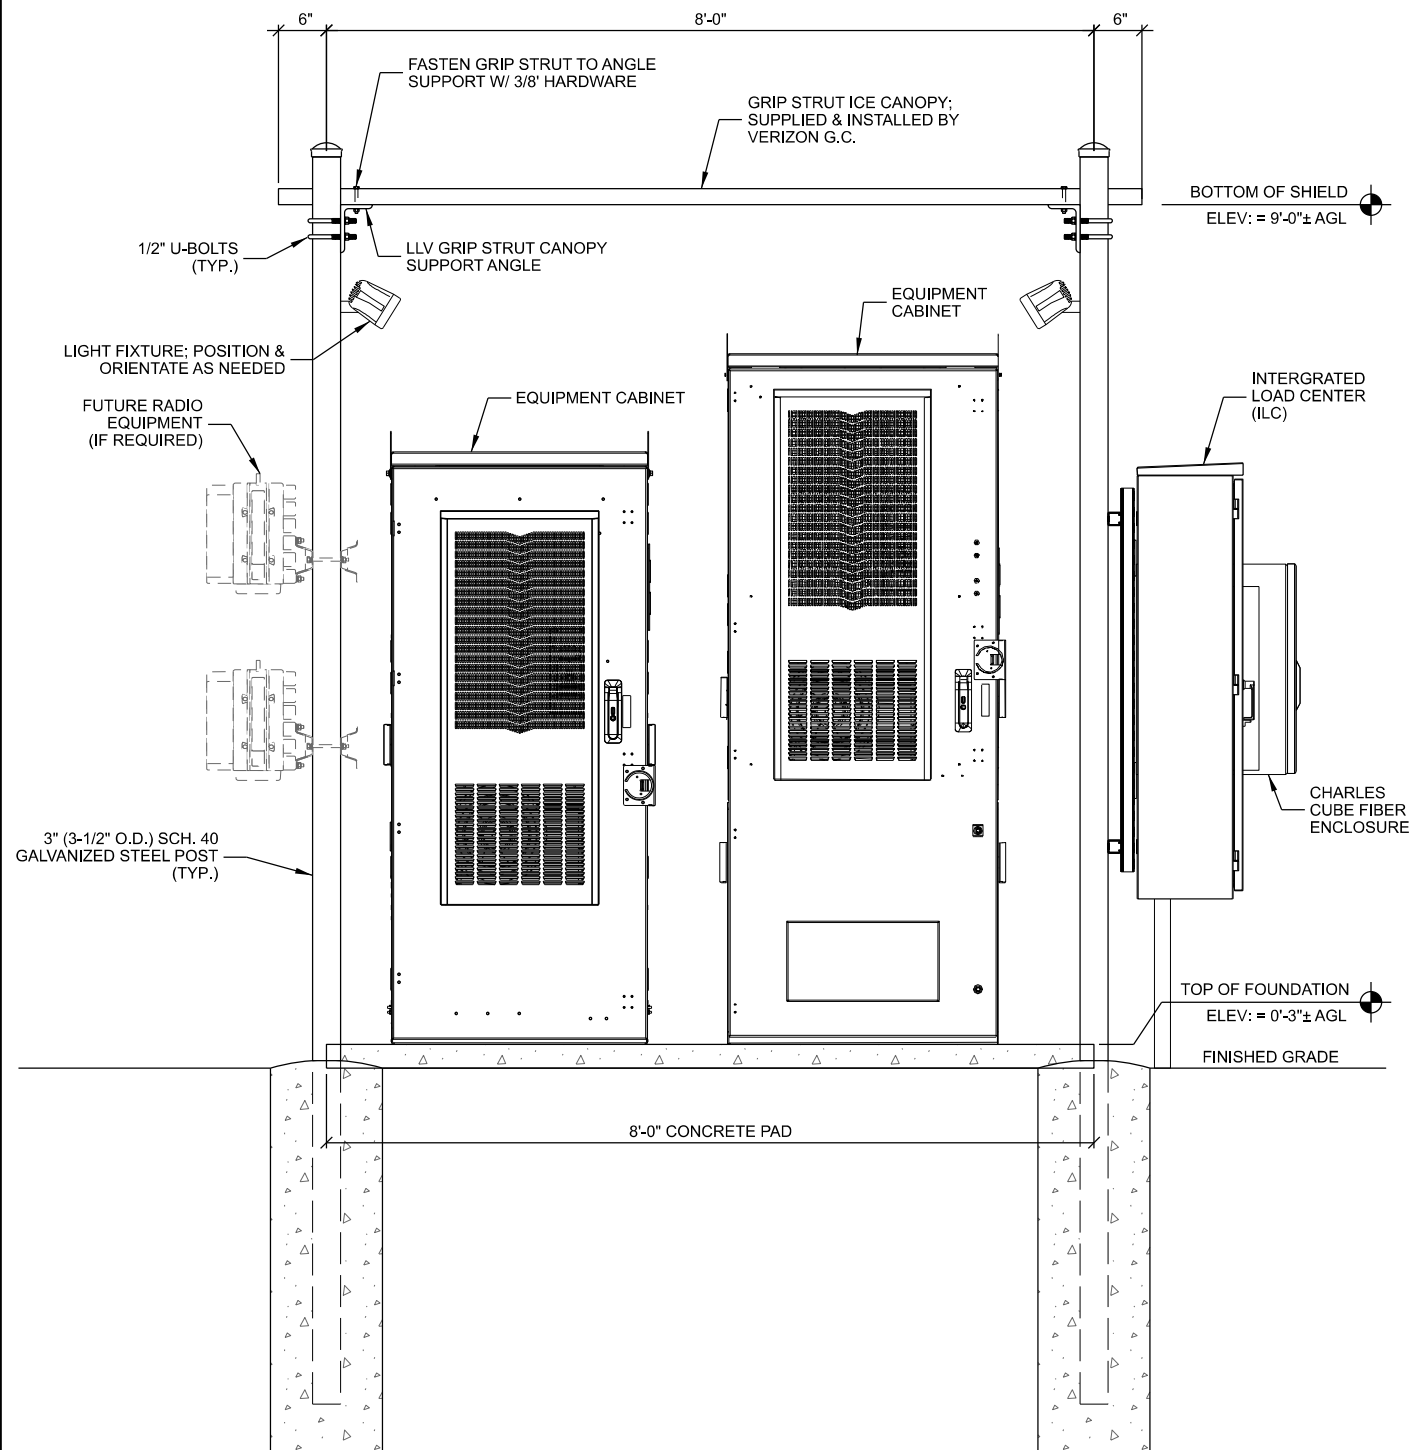**B EQUIPMENT PAD FRONT ELEVATION**

CONSULTANT:

**Edge**  
Consulting Engineers, Inc.  
624 WATER STREET  
PRAIRIE DU SAC, WI 53578  
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**EQUIPMENT PAD ELEVATIONS**  
**IA12 DT OELWEIN**  
**OELWEIN, IOWA**

SUBMITTAL:		
INT.	DATE:	DESCRIPTION:
TJT	07/16/25	REV. A
BSS	08/07/25	REV. B

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EDGE SITE ID	S8464
EDGE PROJ. #	44517
SET TYPE	DRAFT
SHEET NUMBER	<b>A-201</b>



### X-Pol 8-Port 8 ft, 65° Form In Tighter High Gain (FHG) with Smart Bias Ts, 698-4200 MHz:

**4 ports 698-894 MHz and 4 ports 3400-4200 MHz**

- High efficiency macro panel antenna with optimized 4T4R MIMO performance for low and high band with industry-leading high gain for extended coverage
- Enhanced pattern performance with superior cross-pol performance and front-to-back ratio
- Fully integrated (iRETs) with independent RET control for low band and high band
- Optimized CBRS radiation patterns for improved RSRP and maximum EIRP
- Excellent passive intermodulation (PIM) performance reduces harmful interference.
- Suitable for 4G and 5G interface technologies
- Integrated Smart Bias-Ts reduce leasing costs
- Optimized form factor for reduced wind loading



Electrical specification (minimum/maximum)	Ports 1, 2, 3, 4	
Frequency bands, MHz	698-806	806-894
Polarization	± 45°	
Maximum gain over all tilts, dBi	17.0	17.3
Average gain over all tilts, dBi	16.7 ± 0.3	17.0 ± 0.3
Horizontal beamwidth (HBW), degrees <sup>1</sup>	67	64
Front-to-back ratio, co-polar power @180°± 30°, dB	>28.0	>28.0
SPR (Sector Power Ratio), %	5	4.5
X-Pol discrimination (CPR) at boresight, dB	>20.0	>20.0
Vertical beamwidth (VBW), degrees <sup>1</sup>	9	8
Electrical downtilt (EDT) range, degrees	0-10	
First upper side lobe (USLS) suppression, dB <sup>1</sup>	≤-18.0	≤-16.0
Cross-polar isolation, port-to-port, dB <sup>1</sup>	25	25
Max VSWR / return loss, dB	1.5:1 / -14.0	
Max passive intermodulation (PIM), 2x20W carrier, dBc	-153	
Max input power per any port, watts	300	
Total composite power all ports, watts	1500	

<sup>1</sup> Typical value over frequency and tilt

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04/03/25 V1.0

Page1



Electrical specification (minimum/maximum)	Ports 5, 6, 7, 8		
Frequency bands, MHz	3400-3550	3550-3980	3980-4200
Polarization	± 45°		
Maximum gain over all tilts, dBi	14.7	14.9	15.1
Average gain over all tilts, dBi	14.5 ± 0.2	14.7 ± 0.2	14.9 ± 0.2
Horizontal beamwidth (HBW), degrees	71	69	67
Front-to-back ratio, co-polar power @180°± 30°, dB	>25	>25	>25
Vertical beamwidth (VBW), degrees <sup>1</sup>	16.7	15.9	15.1
Electrical downtilt (EDT) range, degrees	2-12		
First upper side lobe (USLS) suppression, dB <sup>1</sup>	≤-15	≤-15	≤-15
Cross-polar isolation, port-to-port, dB <sup>1</sup>	25	25	25
Max VSWR / return loss, dB	1.5:1 / -14.0		
Max passive intermodulation (PIM), 2x20W carrier, dBc	-145		
Max input power per any port, watts	150		

## Ordering information


Antenna model	Description
MX08FHG865-BHG	8F X- Pol 8 PORT FIT 65° 0-10°/2-12°, 4.3-10 & SBT
<b>Optional accessories</b>	
<a href="#">AISG cables</a>	M/F cables for AISG connections
<a href="#">PCU-1000 RET controller</a>	Stand-alone controller for RET control and configurations
<a href="#">91900314-03</a>	Dual Mount Bracket (see 91900314 bracket document for details)

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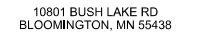
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Page 2

CONSULTANT:



CLIENT:

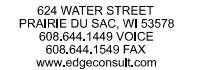

ENGINEER SEAL:

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## ANTENNA SPECIFICATIONS

[illegible]

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EDGE SITE ID	S8464
EDGE PROJ. #	44517
SET TYPE	DRAFT
SHEET NUMBER	<b>T-001</b>


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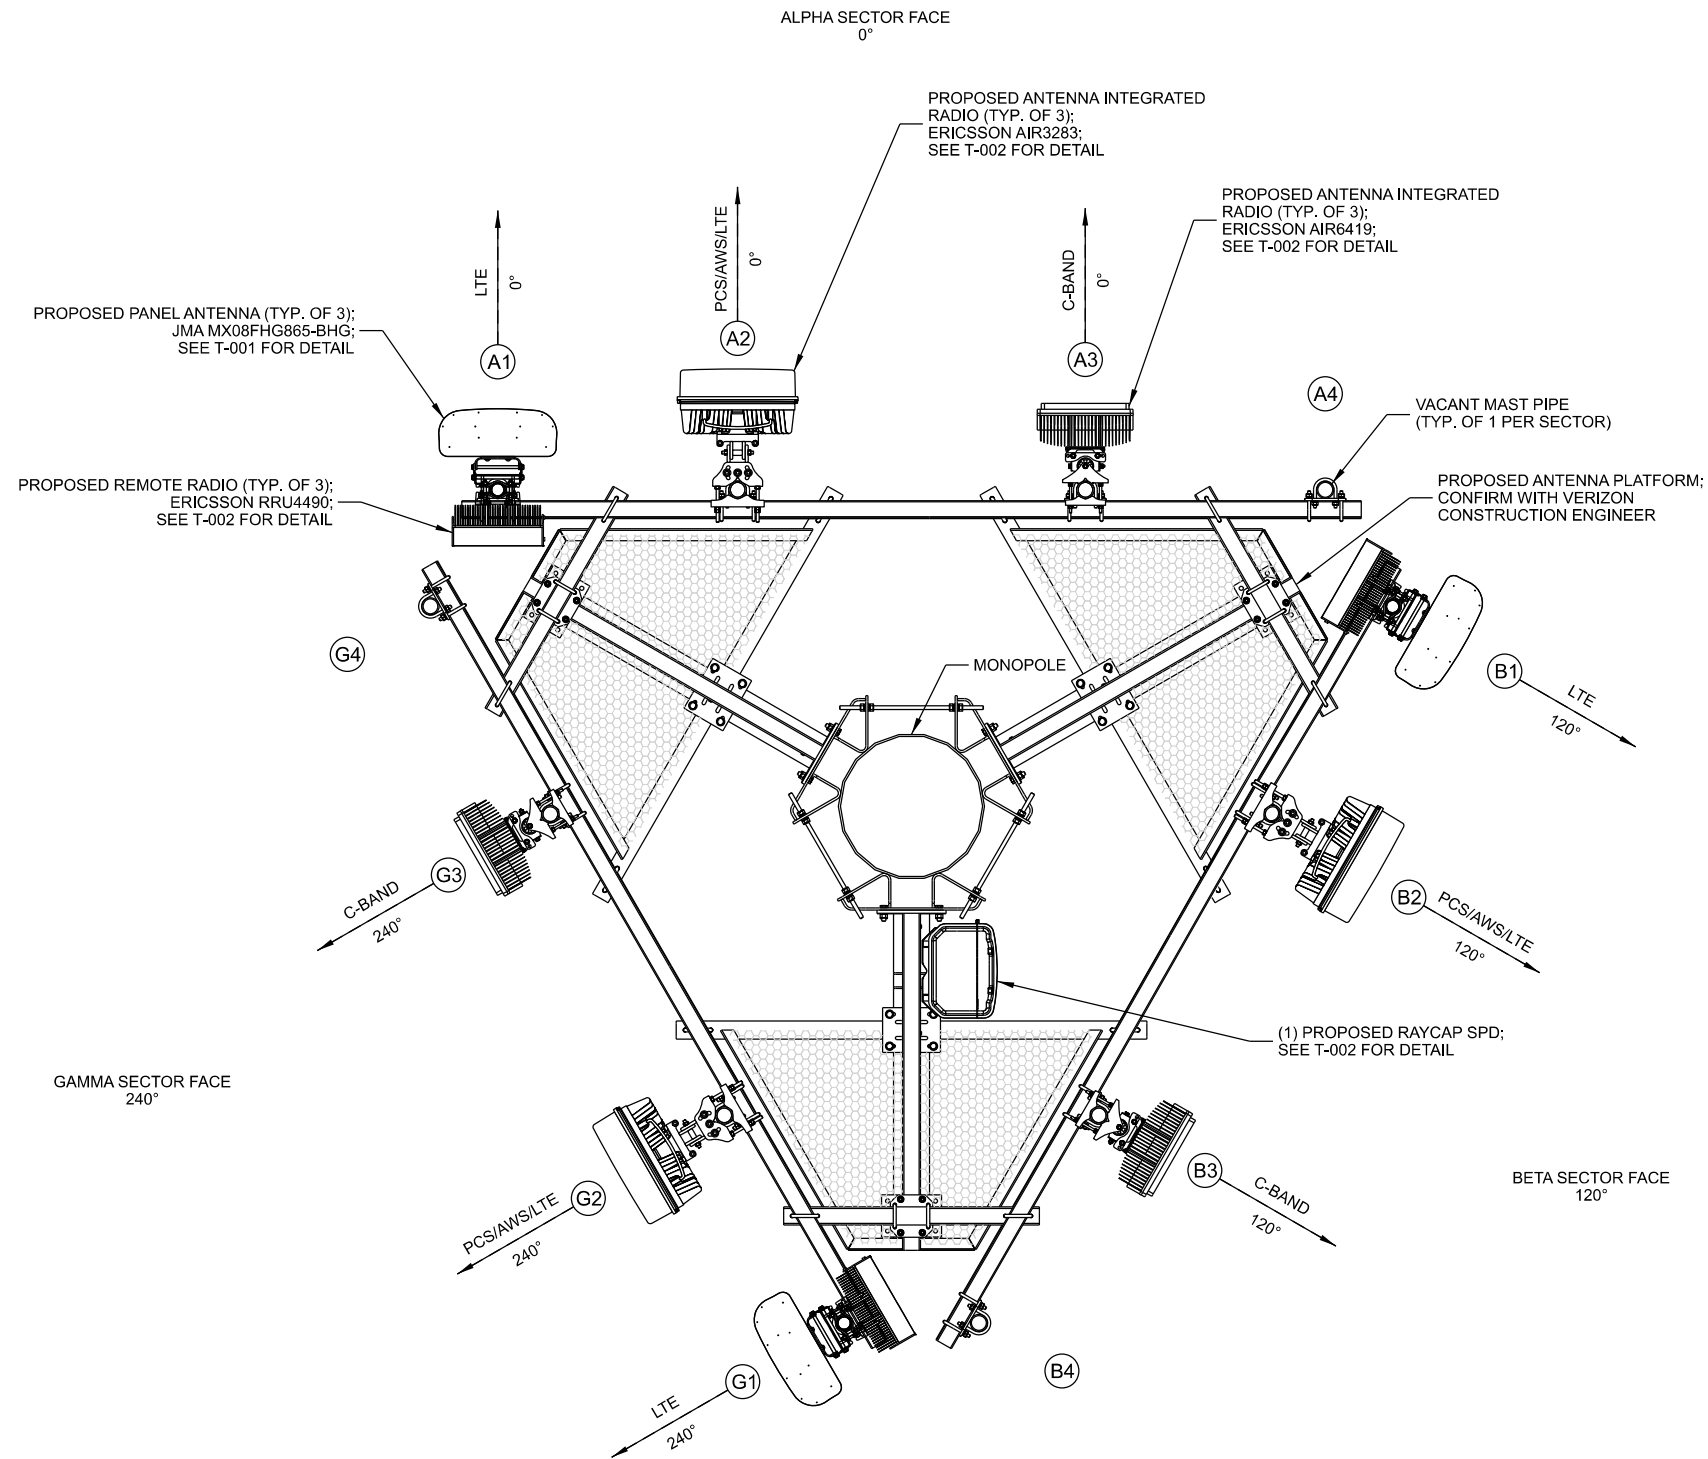










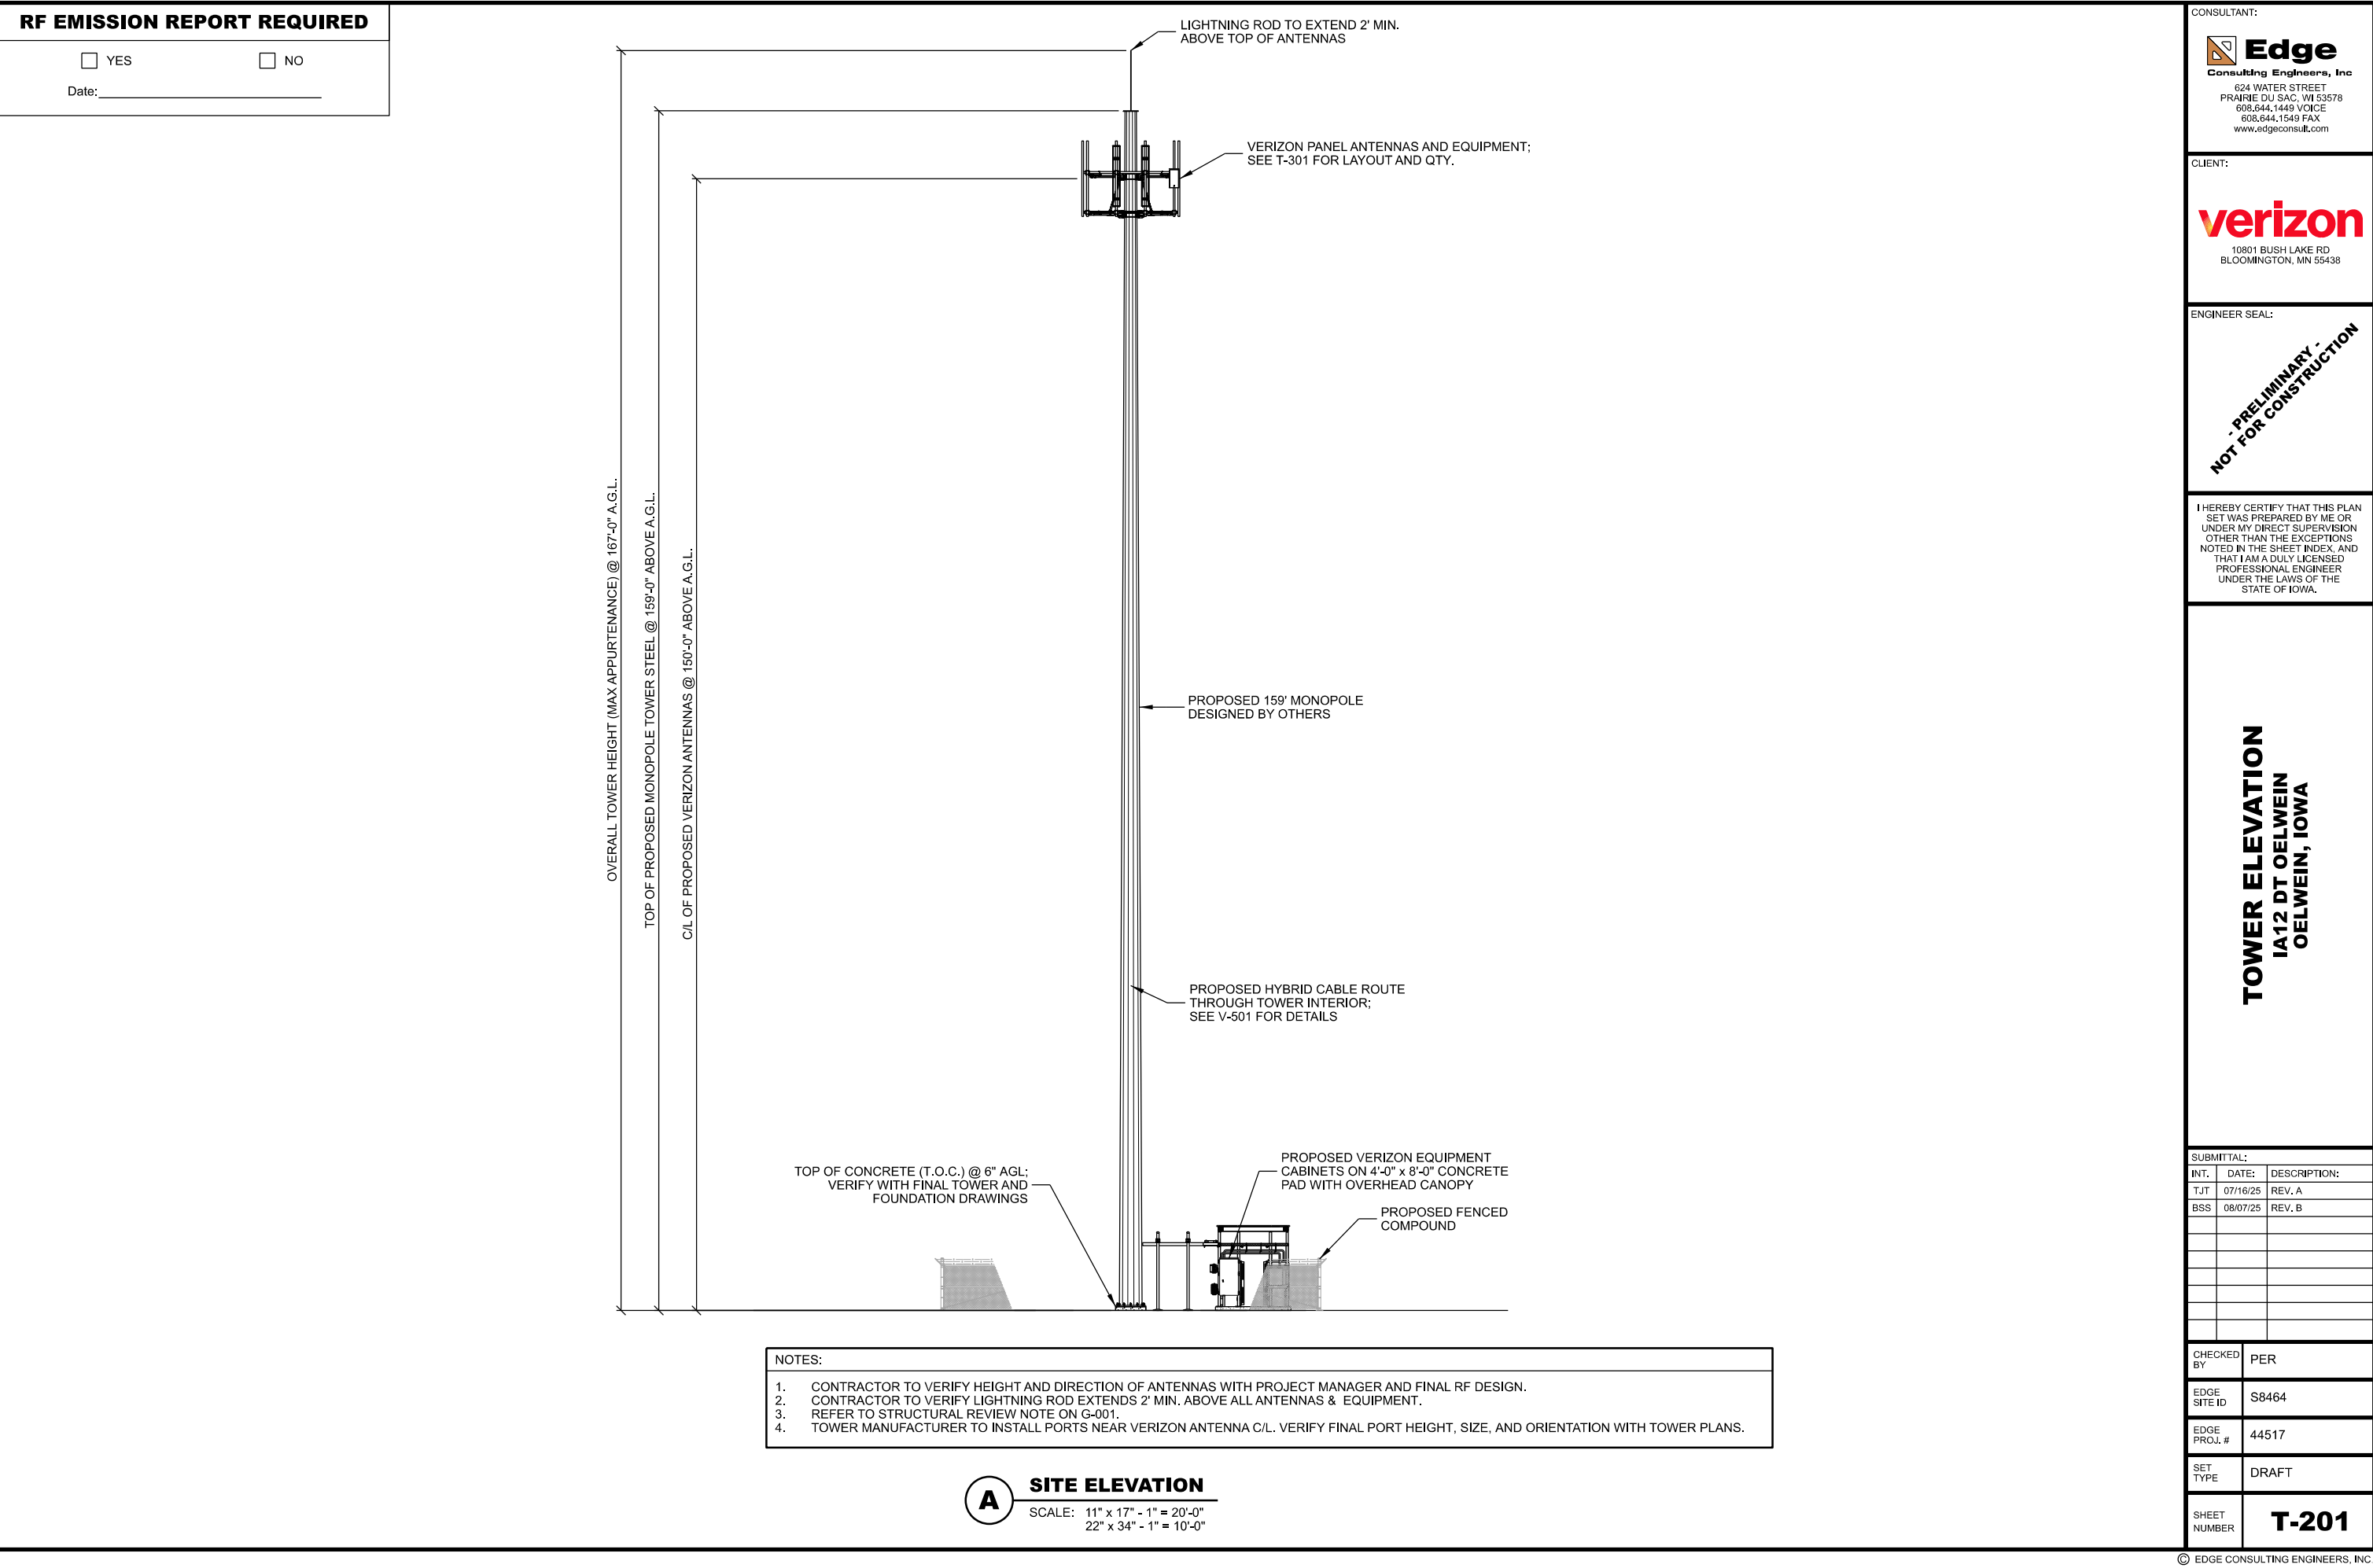

- NOTES:
- ALL ANTENNA AZIMUTHS TO BE FROM TRUE NORTH.
  - SEE MOUNT ANALYSIS FOR INSTALLATION REQUIREMENTS OF ANTENNAS AND EQUIPMENT.

**A ANTENNA AND EQUIPMENT LAYOUT**

NOTE:

- CONTRACTOR SHALL RECORD ALL DIMENSIONS AND MEMBER SIZES REQUESTED IN THE MOUNT GEOMETRY VERIFICATION REQUIREMENTS SECTION OF THE MOUNT ANALYSIS REPORT. CONTRACT EOR IF THESE DOCUMENTS ARE NOT AVAILABLE TO THE GENERAL CONTRACTOR.
- CONTRACTOR SHALL INSPECT CLIMBING FACILITIES AND SAFETY CLIMB, IF PRESENT, AND ENSURE THEY ARE IN GOOD CONDITION. CONTRACTOR SHALL INSTALL SAFETY CLIMB WIRE ROPE GUIDES IN LOCATIONS WHERE WIRE ROPE IS RUBBING AGAINST THE MOUNT OR MOUNT-TO-TOWER CONNECTION STEEL. WIRE BRUSH CLEAN ANY OBSERVED CORROSION AND PROTECT WITH TWO (2) COATS OF COLD GALVANIZATION (ZINGA OR ZINC KOTE). CONTRACTOR SHALL PROVIDE PHOTOS OF WIRE ROPE GUIDE INSTALLATION AS PART OF PMI DOCUMENTS. CONTRACT EOR IF ADDITIONAL GUIDANCE IS REQUIRED.
- CONTRACTOR TO PROVIDE AND INSTALL ALL RRU AND ANTENNA MOUNTING HARDWARE AS REQUIRED.
- CONTRACTOR TO ENSURE MOUNT DOES NOT IMPEDE SAFETY CLIMB
- VERIZON WIRELESS TO PROVIDE PROPOSED MOUNT. PROPOSED MOUNT TO MEET VERIZON MOUNT STANDARD NSTD-445. GC TO REQUEST MOUNT CLASSIFICATION DOCUMENTATION PRIOR TO CONSTRUCTION TO CONFIRM THE MOUNT MEETS NSTD-445. GC TO BRING ANY CONCERNS OR DISCREPANCIES TO THE ATTENTION OF THE CONSTRUCTION ENGINEER AND ENGINEER OF RECORD.

CONSULTANT:

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PRAIRIE DU SAC, WI 53578  
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BLOOMINGTON, MN 55438

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**ANTENNA CONFIGURATION**  
**IA12 DT OELWEIN**  
**OELWEIN, IOWA**

SUBMITTAL:

INT.	DATE:	DESCRIPTION:
TJT	07/16/25	REV. A
BSS	08/07/25	REV. B

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EDGE SITE ID	S8464
EDGE PROJ. #	44517
SET TYPE	DRAFT
SHEET NUMBER	<b>T-301</b>

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FINAL ANTENNA SCHEDULE												
LOCATION			ANTENNA SUMMARY							NON ANTENNA SUMMARY		
SECTOR	RAD	AZ	POS	QTY.	ANTENNA	BAND	ELEC D-TILT	MECH D-TILT	STATUS	QTY.	ADDITIONAL TOWER MOUNTED EQUIPMENT	STATUS
ALPHA	150'	0°	A1	1	JMA MX08FHG865-BHG	700/850	2°	0°	INSTALL	1	ERICSSON RRU4490	INSTALL
	150'	0°	A2	1	ERICSSON AIR3283	1900/AWS	3°	0°	INSTALL	-	-	-
	150'	0°	A3	1	ERICSSON AIR6419	C-BAND	3°	0°	INSTALL	-	-	-
	-	-	A4	-	-	-	-	-	-	-	-	-
BETA	150'	120°	B1	1	JMA MX08FHG865-BHG	700/850	2°	0°	INSTALL	1	ERICSSON RRU4490	INSTALL
	150'	120°	B2	1	ERICSSON AIR3283	1900/AWS	3°	0°	INSTALL	-	-	-
	150'	120°	B3	1	ERICSSON AIR6419	C-BAND	3°	0°	INSTALL	-	-	-
	-	-	B4	-	-	-	-	-	-	-	-	-
GAMMA	150'	240°	C1	1	JMA MX08FHG865-BHG	700/850	2°	0°	INSTALL	1	ERICSSON RRU4490	INSTALL
	150'	240°	C2	1	ERICSSON AIR3283	1900/AWS	3°	0°	INSTALL	-	-	-
	150'	240°	C3	1	ERICSSON AIR6419	C-BAND	3°	0°	INSTALL	-	-	-
	-	-	C4	-	-	-	-	-	-	-	-	-
ANTENNA TOTAL:				9	NON ANTENNA TOTAL:					3		

PROPOSED HARDWARE					
QTY	MANUFACTURER	MODEL	DESCRIPTION	LOCATION	STATUS
1	RAYCAP	RVZDC-4520-RM-48	DISTRIBUTION BOX	ON ICE BRIDGE POST	INSTALL
1	RAYCAP	RVZDC-6627-PF-48	DISTRIBUTION BOX	ON TOWER	INSTALL
1	RAYCAP	RTF-4575	FIBER MANAGEMENT TRAY	CABINETS	INSTALL
2	HUBER+SUHNER	HFT1206	HYBRID	TRUNK CABLE	INSTALL
5	COMMSCOPE	-	UP-CONVERTER MODULES	CABINETS	INSTALL
1	COMMSCOPE	-	DC-DC UP-CONVERTER	CABINETS	INSTALL

NOTE:	
1.	RF DESIGN DETAILED ON THIS SHEET PROVIDED BY VERIZON AND IS INCLUDED FOR CONVENIENCE ONLY. FINAL RF DESIGN TO BE VERIFIED WITH VERIZON PRIOR TO CONSTRUCTION. IF SIGNIFICANT CHANGES OR DISCREPANCIES ARE IDENTIFIED, CONTACT ENGINEER PRIOR TO INSTALLATION.
2.	IF CABLING LENGTH EXCEEDS MAXIMUM ALLOWED LENGTH CONTRACTOR SHALL CONTACT CLIENT AND ENGINEER TO RESOLVE PRIOR TO CONSTRUCTION.

A

PROPOSED ANTENNA SUMMARY

HYBRID CABLE LENGTH	
QUANTITY	2
LENGTH FROM GROUND SURGE PROTECTOR TO TOWER	15 FT
LENGTH FROM T.O.C. TO TOWER TOP SURGE PROTECTOR C/L	150 FT
TOTAL LENGTH OF HYBRID CABLE(S)	165 FT
** HYBRID CABLE LENGTH NOT TO EXCEED 367'	

JUMPER CABLE LENGTH CHECK	
IS THE DISTANCE FROM SURGE PROTECTOR TO RADIO UNIT LESS THAN 30'?	
ALPHA SECTOR	YES
BETA SECTOR	YES
GAMMA SECTOR	YES

CONSULTANT:

Edge

Consulting Engineers, Inc.

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CLIENT:

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ENGINEER SEAL:

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NOT FOR CONSTRUCTION


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ANTENNA & EQUIPMENT SUMMARY


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BSS	08/07/25	REV. B
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EDGE SITE ID	S8464	
EDGE PROJ. #	44517	
SET TYPE	DRAFT	
SHEET NUMBER	T-501	

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**A** **PROPOSED CABINET COAX PORT (EXTERIOR VIEW)**



**B** **PROPOSED TOWER CABLE LAYOUT**

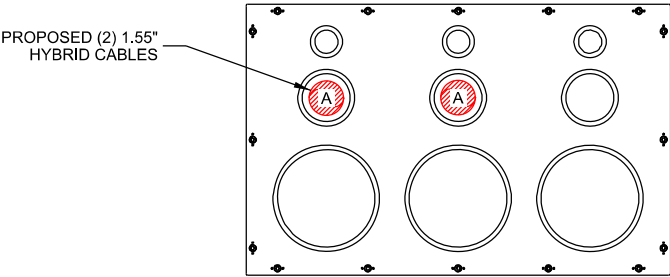

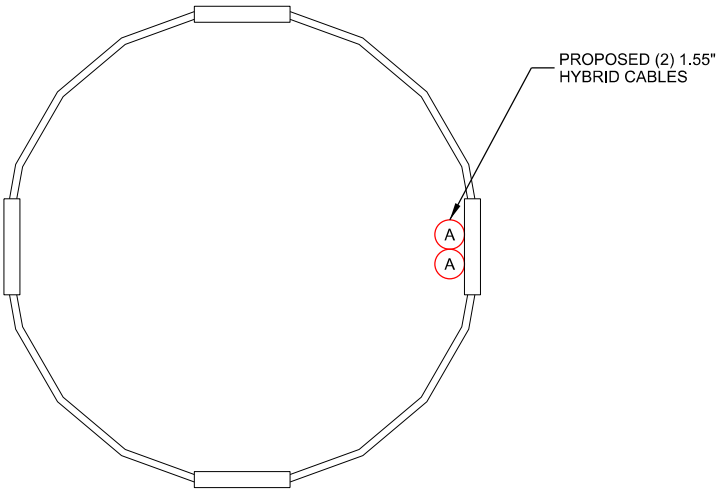COAX SYMBOL	(#) SIZE	MOUNTING TYPE	CARRIER / OWNER	TECHNOLOGY	MOUNT HEIGHT
A	(2) 1.55"	TOWER INTERIOR	VERIZON	HYBRID	150'

CONTRACTOR TO PROVIDE AND INSTALL ALL ENTRY PORT BOOTS FOR PROPOSED HYBRID TRUNK CABLE AND CAPS.

CONTRACTOR TO PROVIDE AND INSTALL ALL ICE BRIDGE HARDWARE REQUIRED FOR PROPOSED COAX/HYBRID TRUNK CABLE

CONTRACTOR TO PROVIDE AND INSTALL ALL COAX/HYBRID TRUNK CABLE ATTACHMENT TO TOWER HARDWARE

CONSULTANT:

**Edge**  
Consulting Engineers, Inc  
624 WATER STREET  
PRAIRIE DU SAC, WI 53578  
608.644.1449 VOICE  
608.644.1549 FAX  
www.edgeconsult.com

CLIENT:

**verizon**  
10801 BUSH LAKE RD  
BLOOMINGTON, MN 55438

ENGINEER SEAL:

**NOT FOR CONSTRUCTION**  
**PRELIMINARY**

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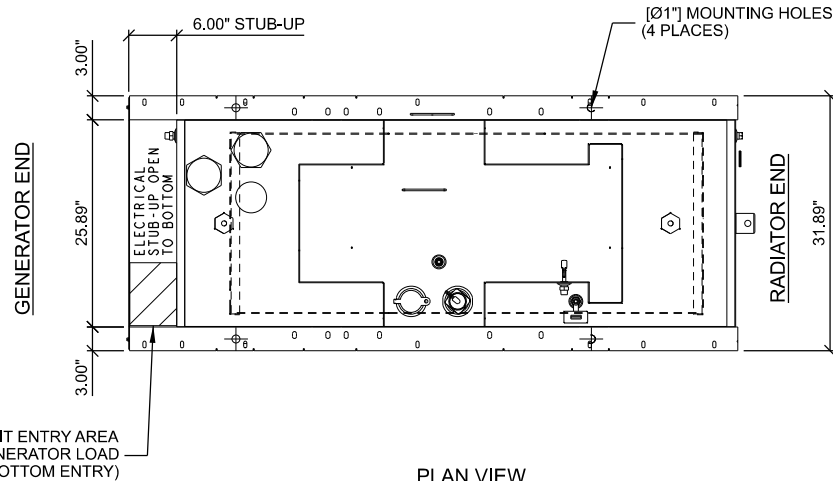
**CABLE ROUTING**  
**IA12 DT OELWEIN**  
**OELWEIN, IOWA**

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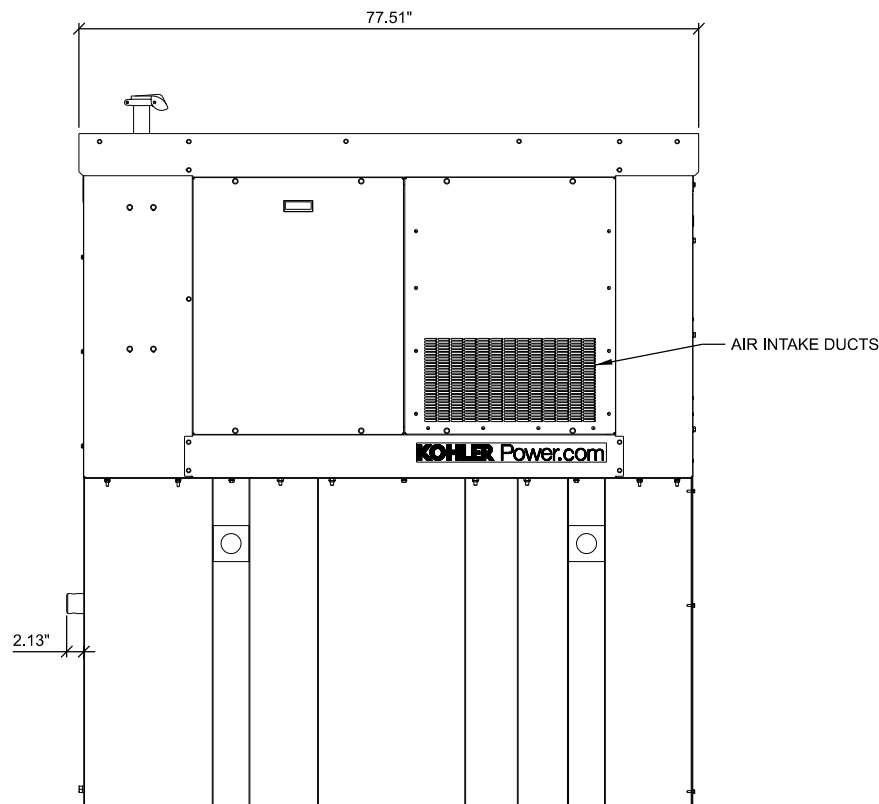
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TJT	07/16/25	REV. A
BSS	08/07/25	REV. B

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EDGE PROJ. #	44517
SET TYPE	DRAFT
SHEET NUMBER	<b>V-501</b>







PLAN VIEW




RIGHT VIEW

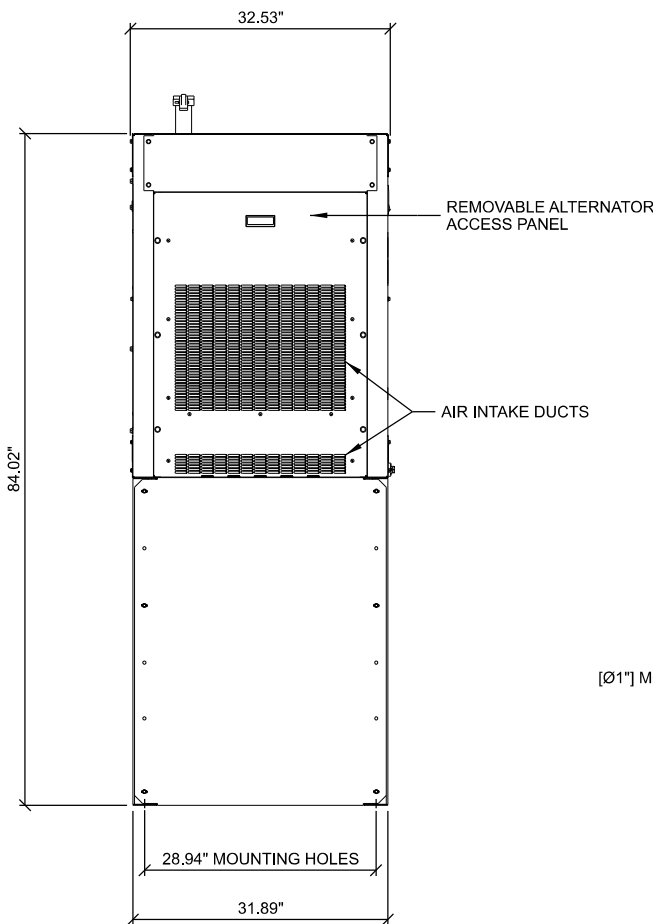

REAR VIEW

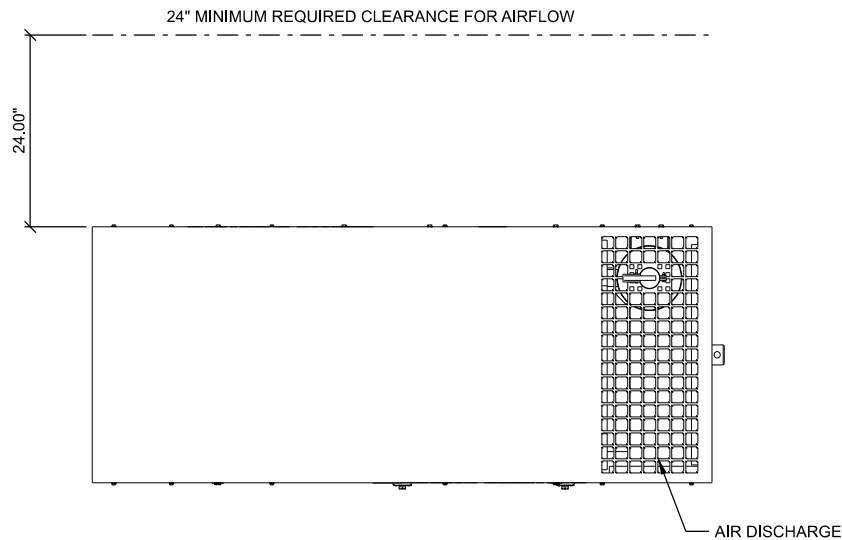

PLAN VIEW W/ ENCLOSURE

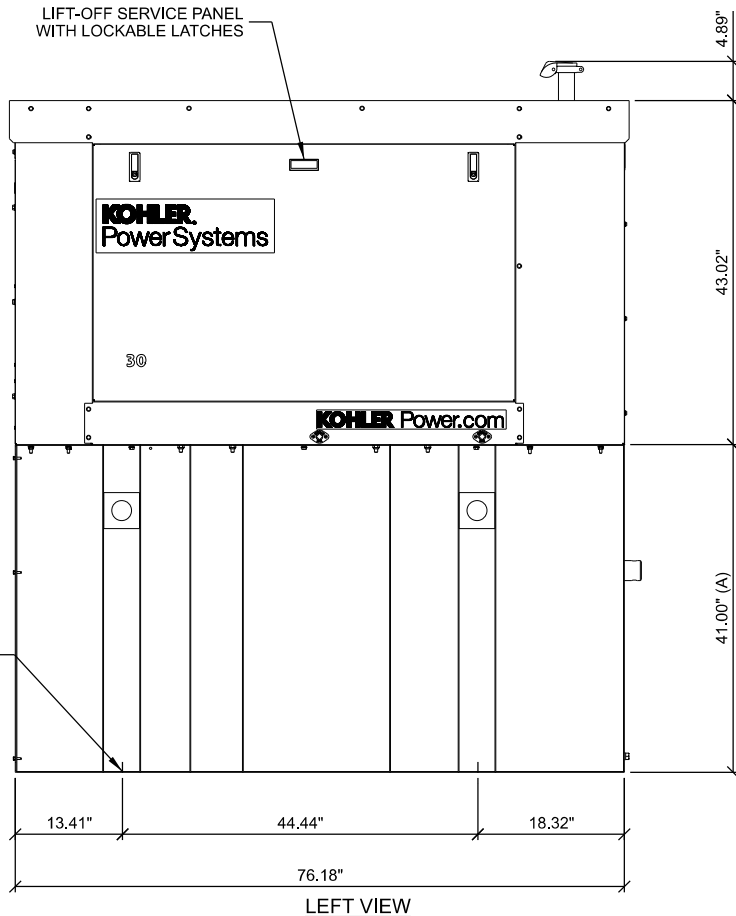

LEFT VIEW

- NOTES:
1. THE RIGHT SIDE OF THE GENERATOR IS SERVICE ACCESSIBLE.
  2. 6 AMP BATTERY CHARGER.
  3. 120VAC ENGINE BLOCK HEATER.
  4. GENERATOR MUST BE GROUNDED.
  5. SOUND ATTENUATED ENCLOSURE STANDARD WITH GENERATOR.
  6. MUST ALLOW FREE FLOW OF DISCHARGE AIR AND EXHAUST.
  7. MUST ALLOW FREE FLOW OF INTAKE AIR.
  8. EASE ACCESS SERVICE PANEL IS LOCATED ON THE RIGHT SIDE OF GENERATOR ONLY.
  9. BASE TANK REQUIRES ALL STUB-UPS TO BE IN RREAR TANK STUB-UP AREA.
  10. SEE TABLE FOR SUBBASE FUEL TANK CAPACITY.
  11. TANK EQUIPPED WITH FIRE SAFETY VALVE ON FUEL SUPPLY LINE.
  12. IT IS THE RESPONSIBILITY OF THE INSTALLATION TECHNICIAN TO ENSURE THAT THE GENERATOR INSTALLATION COMPLIES WITH ALL APPLICABLE CODES, STANDARDS, AND REGULATIONS.
  13. GENERATOR IS INSTALLED ON A UL-142 RATE DOUBLE WALL SUBBASE FUEL TANK.

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**GENERATOR SPECIFICATIONS**  
**IA12 DT OELWEIN**  
**OELWEIN, IOWA**


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SHEET NUMBER	<b>E-001</b>

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GENSET	TANK P/N	TANK HT (A) IN	DESCRIPTION	ASSY WEIGHT
30REOZK	GM97093-MA2	41.0"	SKID/TANK 203 GAL	2114 LBS
30REOZK	GM97093-MA1	32.0"	SKID/TANK 148 GAL	1969 LBS

**A** **KOHLER 30REOZK DIESEL GENERATOR**




STUB-UP REINFORCEMENT

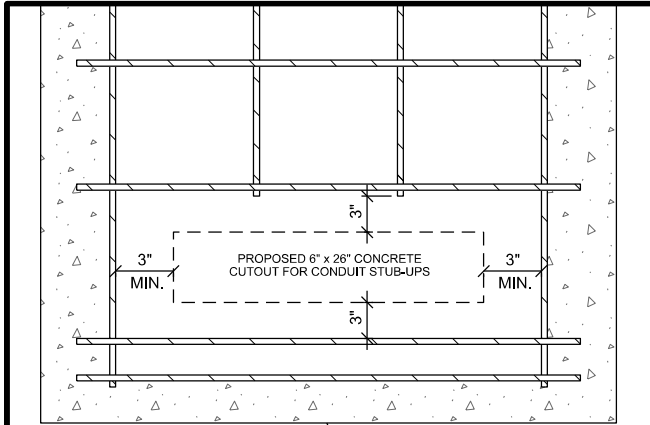NOTE:  
VERIFY EXACT CONDUIT STUB-UP  
LOCATIONS WITH GENSET PLANS

GENERATOR CLEARANCE NOTE:  
- MINIMUM OF 10' OF CLEARANCE FROM COMBUSTIBLE WALL  
- MINIMUM OF 5' OF CLEARANCE FROM A NON-COMBUSTIBLE WALL  
- MINIMUM OF 20' OF CLEARANCE FROM AN OUTDOOR ELECTRICAL TRANSFORMER OR NORMAL POWER DISTRIBUTION EQUIPMENT


NOTE:  
SEE GENERATOR MANUFACTURER'S DRAWINGS FOR PHYSICAL LOCATION OF FUEL LINES, CONTROL AND POWER INTERCONNECTIONS AND OTHER INTERFACES THAT ARE TO BE CAST INTO THE CONCRETE. THE PREFERRED METHOD IS TO BRING THE CONDUIT THROUGH THE CONCRETE PAD TO THE UNDERSIDE OF THE GENERATOR (MINIMIZES RODENT DAMAGE). FINISH CONNECTIONS WITH FLEXIBLE CONDUIT PER GENERATOR MANUFACTURER'S SPECIFICATIONS. RIGID CONDUITS SHALL BE SECURED TO THE EXISTING SLAB, THEN BURIED BETWEEN SLAB AND PLATFORM

NOTE:  
SLAB NOT SUITABLE AT SITES WITH ORGANIC SOIL, UNCOMPACTED FILL, EXPANSIVE SOIL, OR SOILS SUSCEPTIBLE TO FROST HEAVE  
  
REMOVE ALL ORGANIC MATERIAL, SOFT AREAS, AND POOR SOILS BENEATH CONCRETE PAD TO A DEPTH OF ATLEAST 2'-0" BELOW CONCRETE PAD

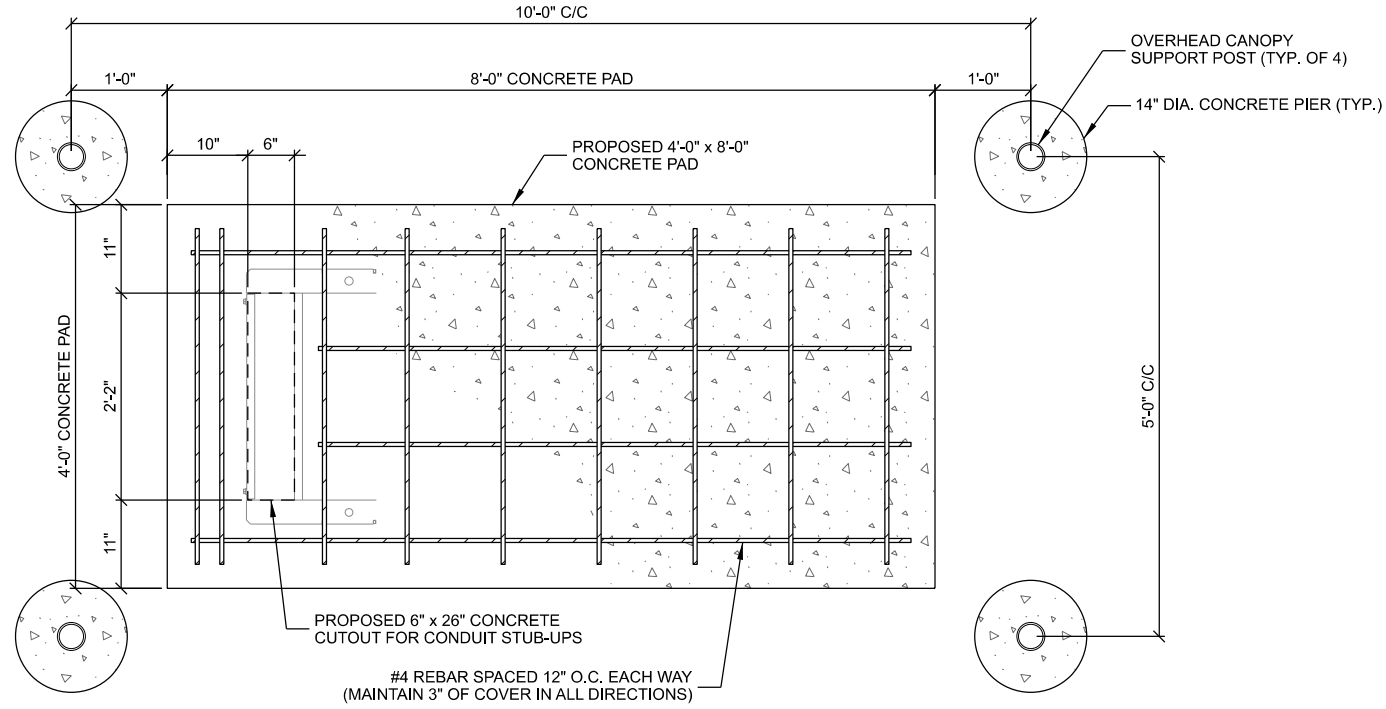

REBAR SCHEDULE		
SIZE	LENGTH	QTY
#4	7'-6"	2
#4	3'-6"	9
#4	6'-2"	2

**A** KOHLER 30REOZK DIESEL GENERATOR FOUNDATION LAYOUT

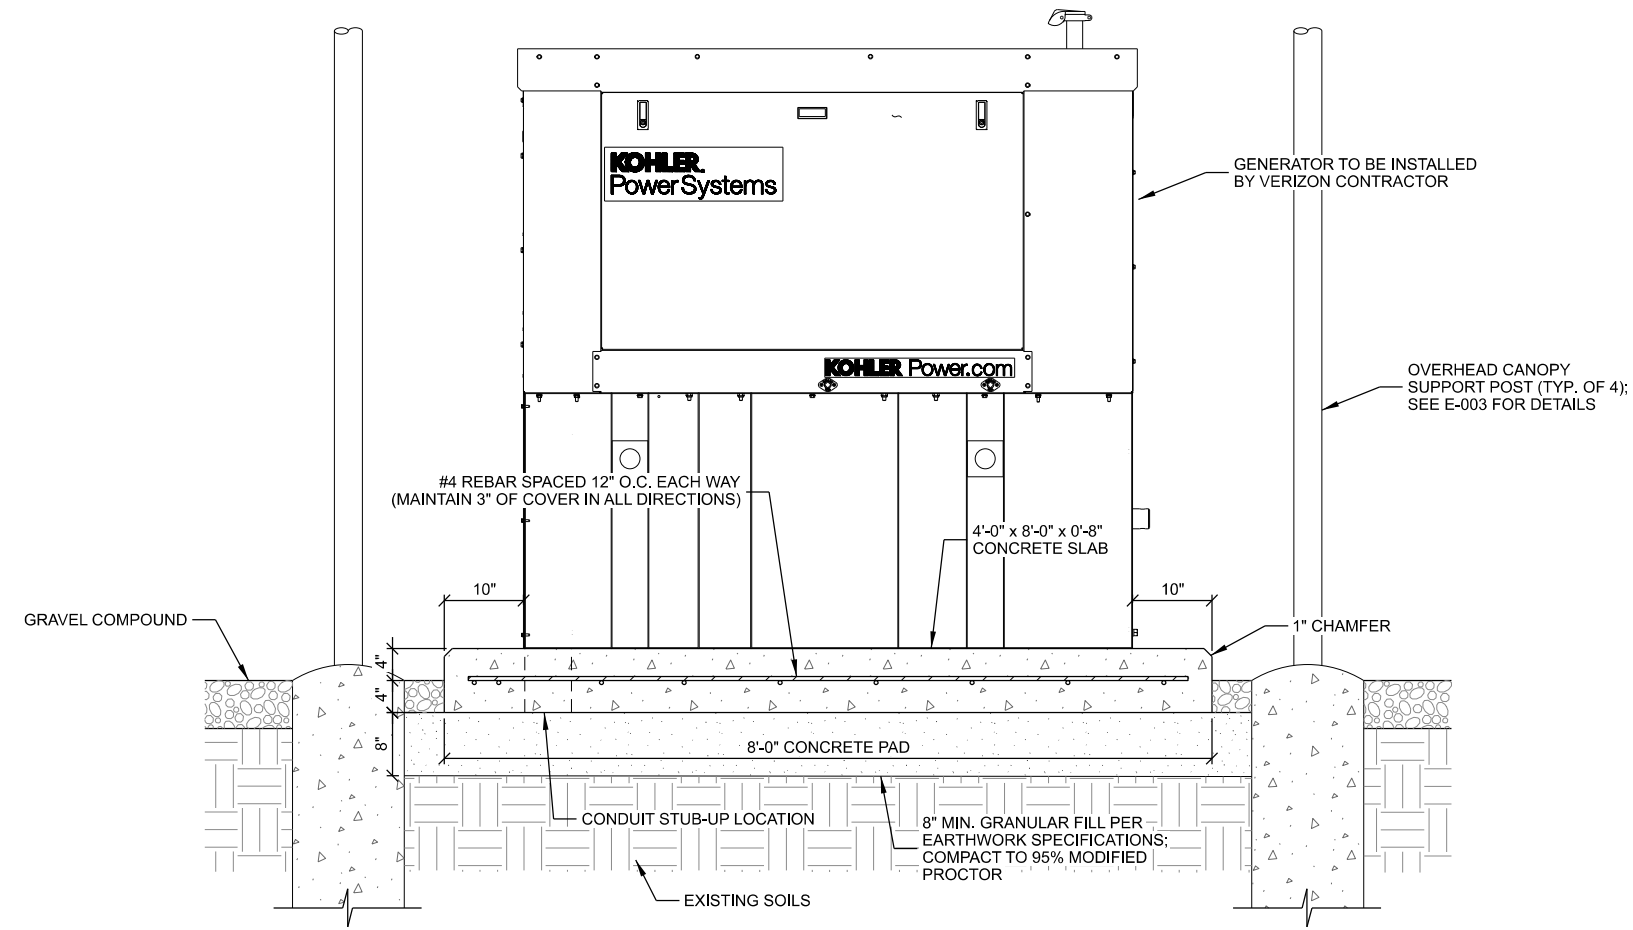

**B** KOHLER 30REOZK DIESEL GENERATOR FOUNDATION DETAIL

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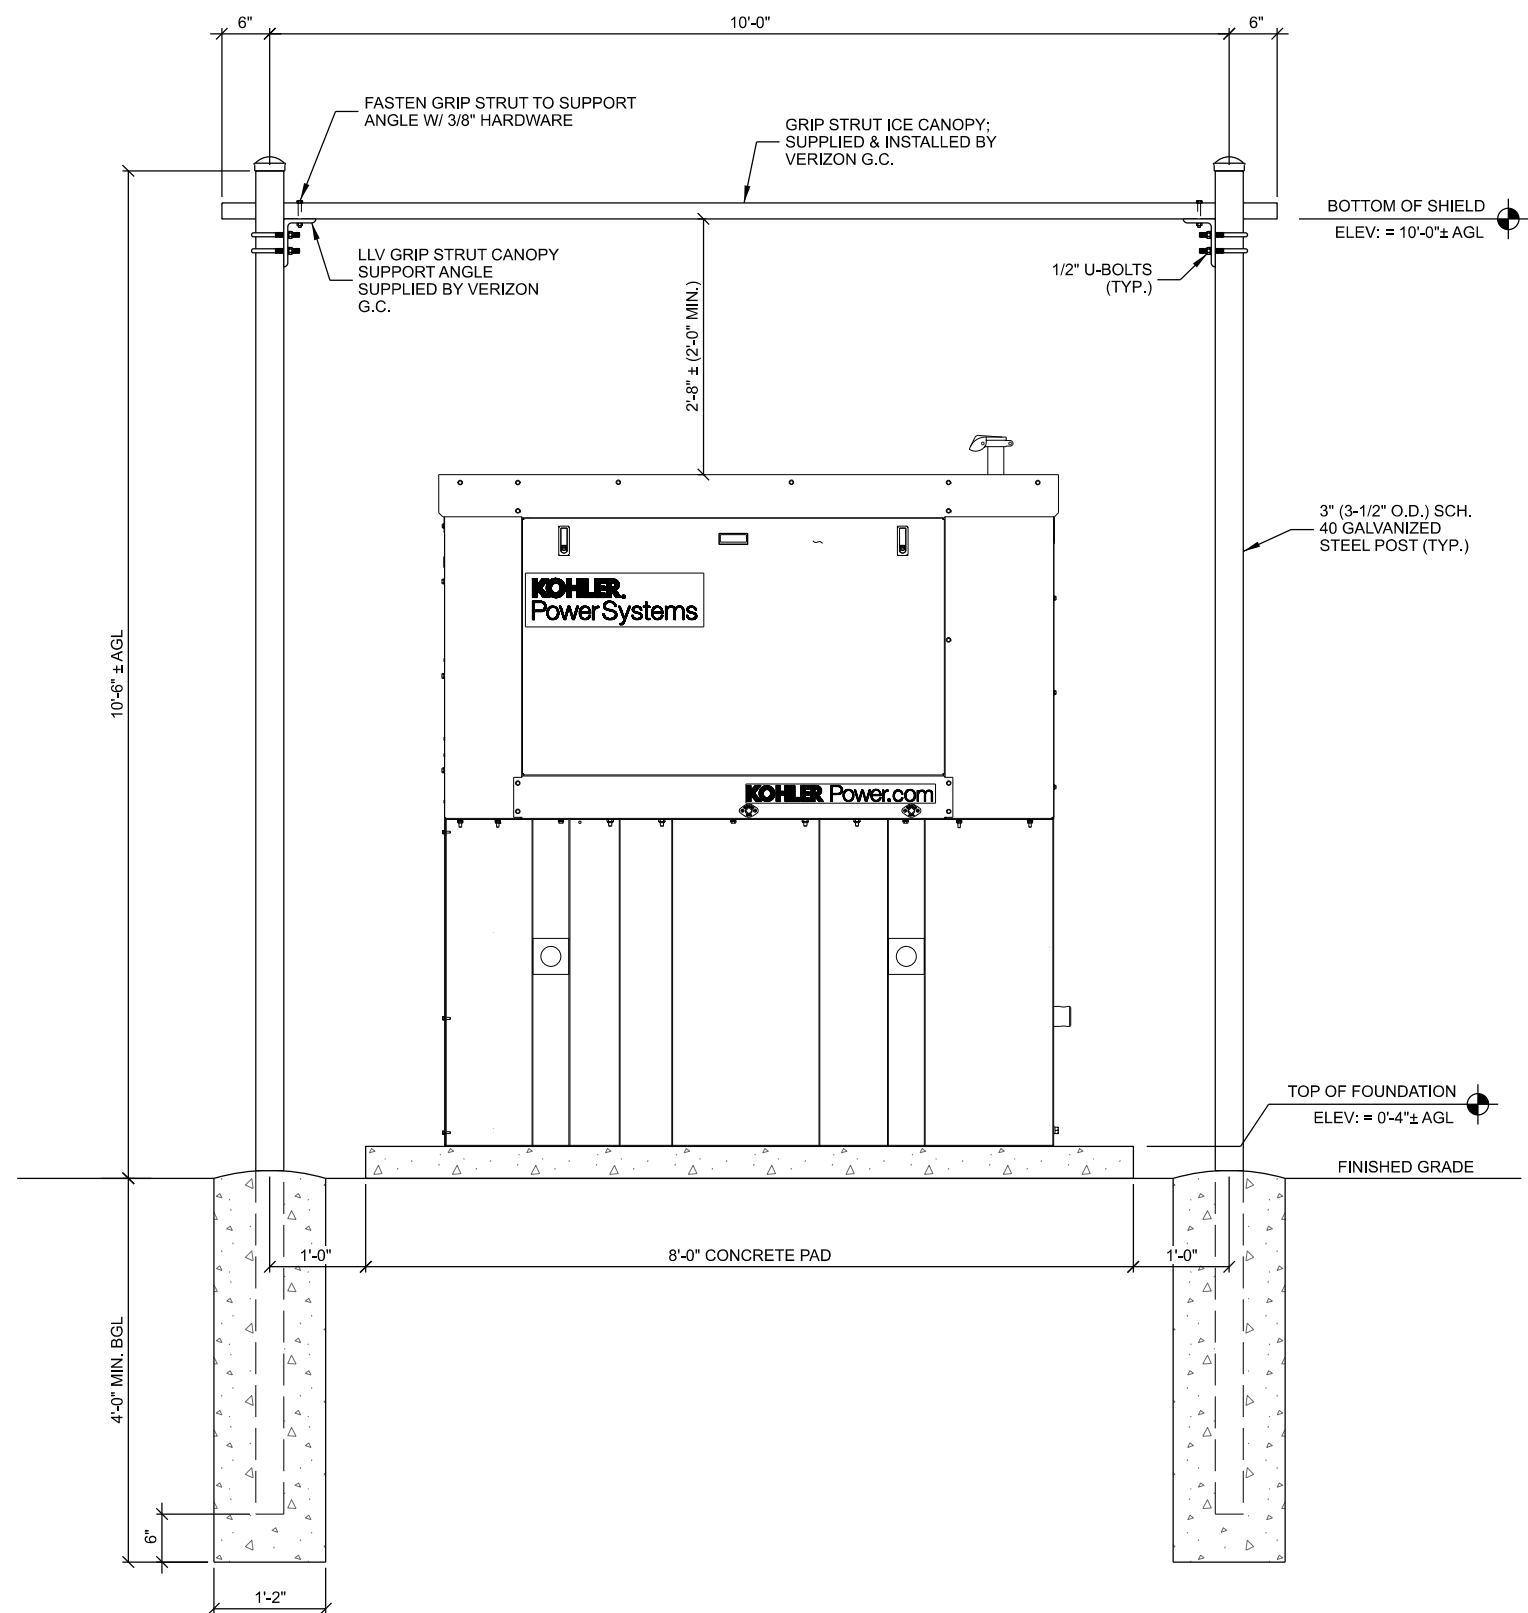
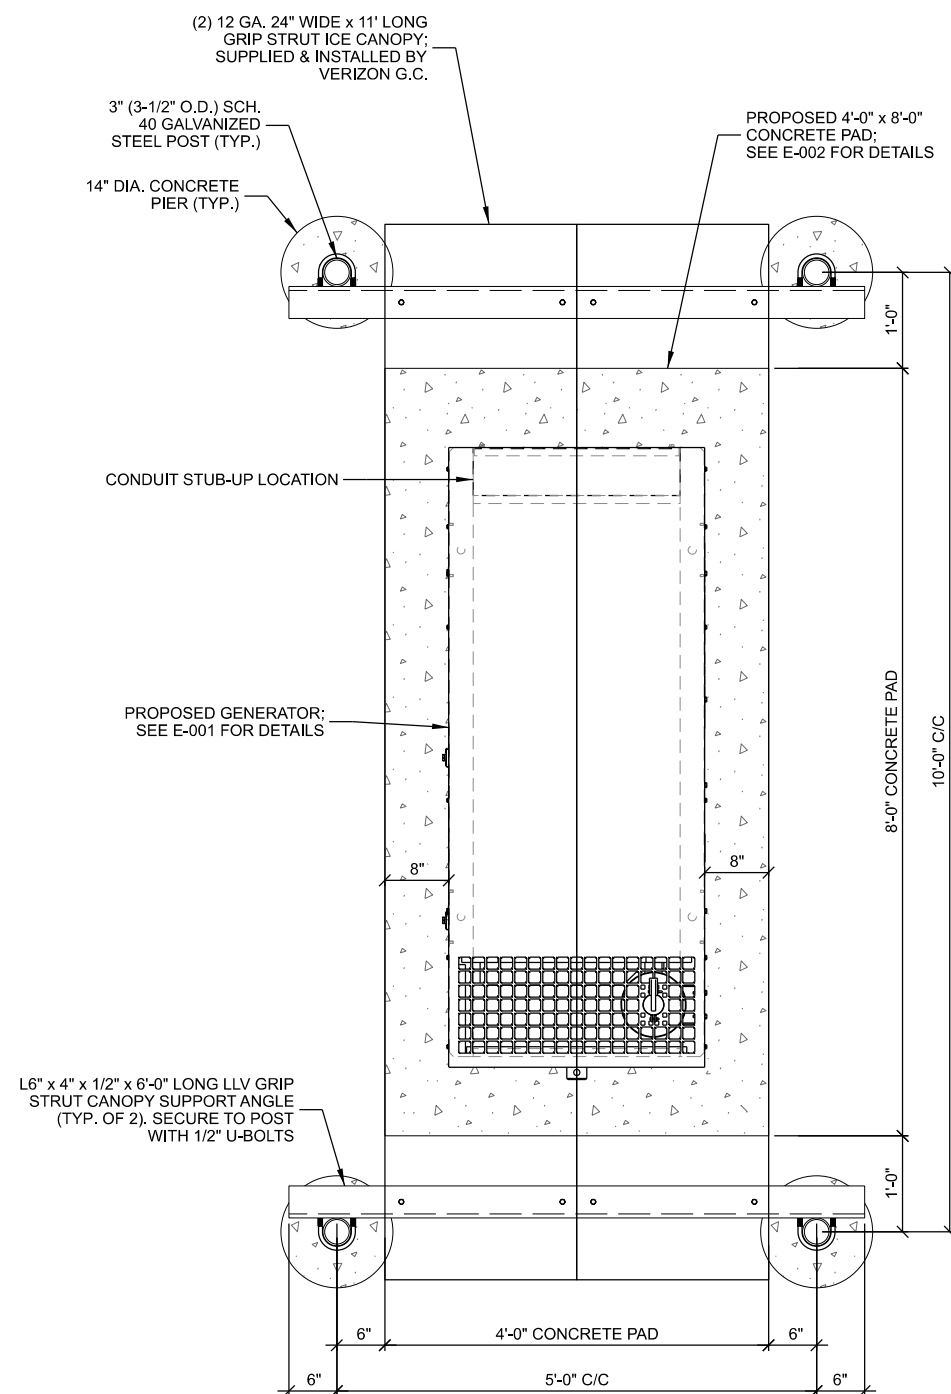
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**GENERATOR SPECIFICATIONS**  
IA12 DT OELWEIN  
OELWEIN, IOWA

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SHEET NUMBER	<b>E-002</b>





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## GENERATOR CANOPY DETAILS

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EDGE SITE ID	S8464
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EDGE PROJ. #	44517
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SET TYPE	DRAFT
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SHEET  
NUMBER

**E-003**

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KEYNOTES: (THIS SHEET)


- (A) EQUIPMENT GROUND RING #2 AWG SOLID TINNED COPPER GROUND LEAD MIN. 4'-6" BURY OR 6" BELOW FROST WHICH EVER IS GREATER
- (B) MAINTAIN 2'-FOOT CLEARANCE FROM ALL STRUCTURES
- (C) MASTER GROUND BAR (MGB) MOUNTED VERTICALLY TO FIRST ICE BRIDGE POST ON INSULATORS
- (D) 5/8" DIAMETER x 10'-0" LONG COPPER CLAD GROUND ROD; SPACED AT 8' O.C.
- (E) BOND EQUIPMENT GROUND RING TO THE TOWER GROUND RING WITH (2) #2 SOLID BARE TINNED COPPER GROUND LEADS
- (F) EQUIPMENT CABINET GROUND; SEE E-501 FOR DETAILS
- (G) INTEGRATED LOAD CENTER (ILC) GROUND; SEE E-501 FOR DETAILS
- (H) FIBER ENCLOSURE GROUND; SEE E-501 FOR DETAILS
- (I) GENERATOR GROUND; SEE E-501 FOR DETAILS
- (J) EQUIPMENT PAD REBAR GROUND; SEE E-502 FOR DETAILS
- (K) GPS GROUND TO ICE BRIDGE POST; SEE E-501 FOR DETAILS
- (L) ICE BRIDGE POST GROUND; SEE E-501 FOR DETAILS
- (M) ICE BRIDGE SECTION GROUND; SEE E-501 FOR DETAILS
- (N) ICE BRIDGE SECTION TO POST; SEE E-501 FOR DETAILS
- (O) GROUND FENCE POSTS WITHIN 6-FEET OF EQUIPMENT
- (P) INSPECTION WELL (TYP.); SEE E-503 FOR DETAILS
- (Q) TOWER GROUND BAR (TGB) INSTALLED ON TOWER; SEE E-501 FOR DETAILS
- (R) 4" x 12" x 1/4" GROUND BAR INSIDE HAND HOLE; CONTRACTOR TO DRIVE 10' GROUND ROD & CLAMP TO GROUND BAR (IF APPLICABLE)
- (S) GROUND ELECTRIC METER TO (2) INDEPENDENT GROUND RODS, SPACED 10' O.C. WITH #2 AWG SOLID TINNED COPPER (IF APPLICABLE)
- (T) RAYCAP SPD GROUND (TYP.). SEE E-501 FOR DETAILS

NOTES:

1. THE GROUNDING SHALL BE TESTED PRIOR TO FINAL BACKFILLING. DOCUMENTATION OF 5 OHM OR LESS RESISTANCE TO BE PROVIDED TO PROJECT MANAGER.
2. ALL NON-INSULATED GROUND LEADS EXTENDING ABOVE GROUND LEVEL SHALL BE ENCASED IN 3/4" PVC & SEALED WITH SILICONE. PVC SHALL BE MIN. 16" INTO EARTH & EXTEND MIN. 6" ABOVE GROUND.
3. INSTALL 18" X 18" COPPER PLATES IN LIEU OF GROUND RODS WHEN INSTALLING OVER TOWER FOUNDATION OR WHERE DRIVING GROUND RODS IS NOT FEASIBLE.

GROUNDING LEGEND: (THIS SHEET)

- ▲ EXOTHERMIC OR UL RATED IRREVERSIBLE CONNECTION
- MECHANICAL CONNECTION
- - - GROUND LEAD
- ⊗ INSPECTION WELL
- ⊗ 5/8" DIA. x 10'-0" LONG, STEEL CLAD W/ A PURE COPPER JACKET (10' MAX SEPARATION); TOP OF EACH GROUND ROD SHALL EXTEND NO MORE THAN 6" ABOVE BOTTOM OF TRENCH
- ⊗ 18" X 18" X .032" THK COPPER PLATE (10' MAX SEPARATION)

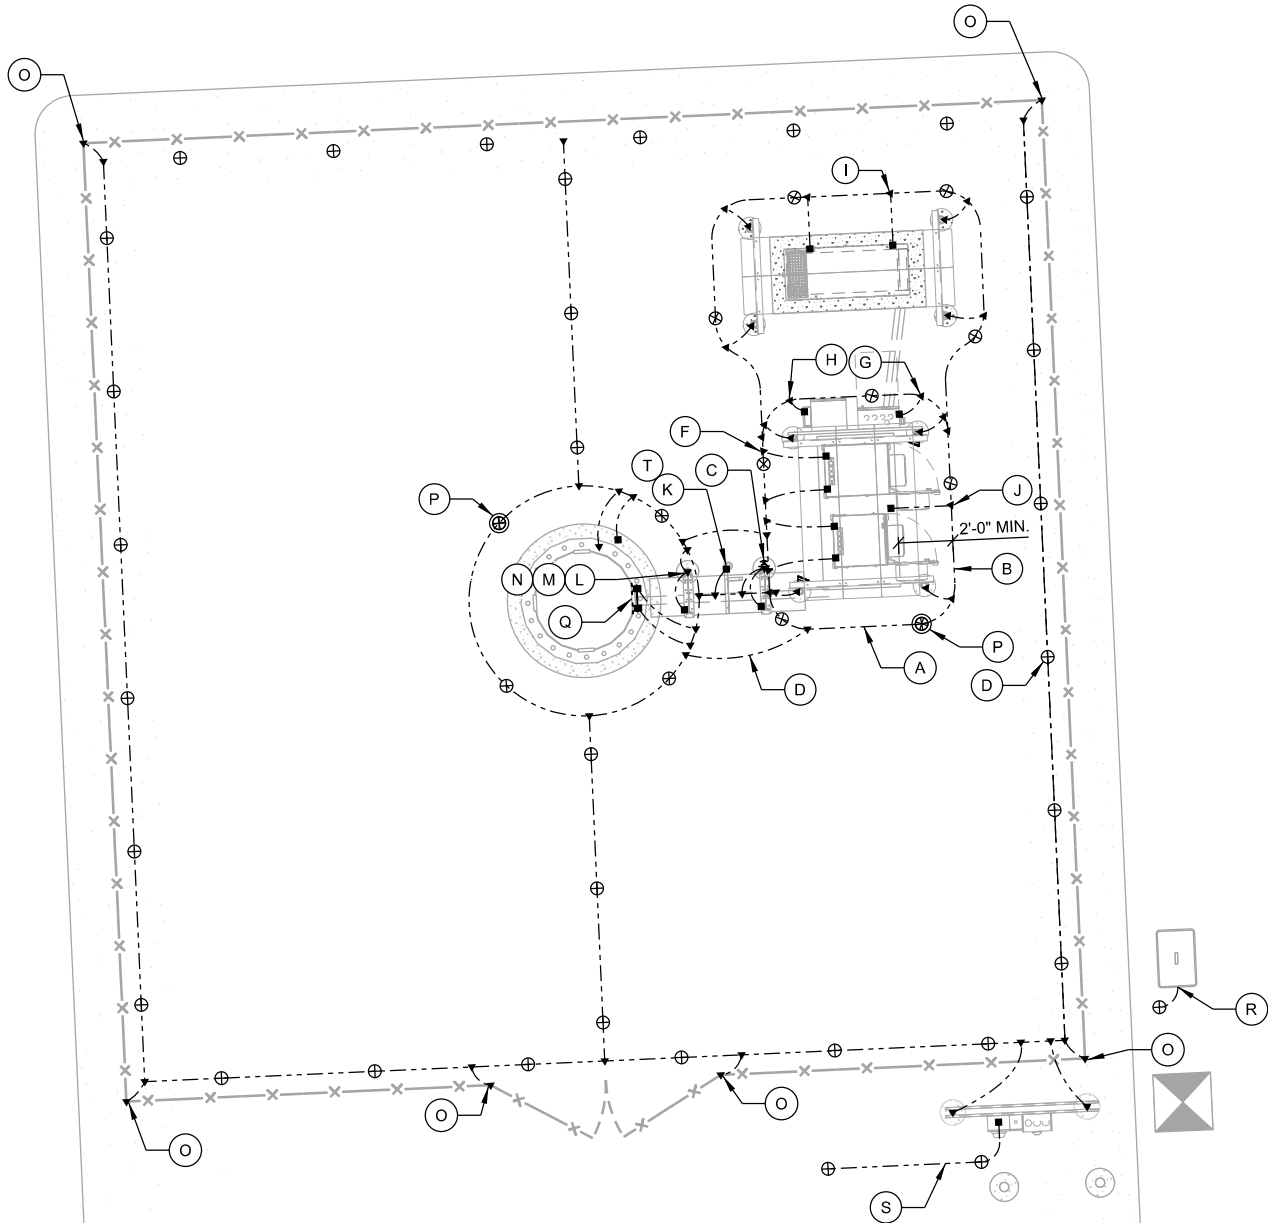

GROUNDING ELECTRODE SYSTEM NOTES:

1. CONNECTIONS:  
ALL CONNECTIONS SHALL BE EXOTHERMICALLY CONNECTED UNLESS NOTED OTHERWISE. CONTRACTOR TO FOLLOW ALL MANUFACTURER'S GUIDELINES & RECOMMENDATIONS.
2. ALL ELECTRICAL AND MECHANICAL GROUND CONNECTIONS SHALL HAVE ANTI-OXIDANT COMPOUND APPLIED TO CONNECTION.
3. FENCE/GATE:  
GROUND FENCE POSTS WITHIN 6-FEET OF ENCLOSURE AND 25-FEET OF TOWER. GROUND EACH GATE POST AND CORNER POST. GROUND CONNECTIONS TO FENCE POSTS SHALL BE MADE BY THE EXOTHERMIC PROCESS AND INSTALLED PER MANUFACTURER'S RECOMMENDATIONS AND PROCEDURES.
4. CONTRACTOR SHALL SUBMIT THE GROUND RESISTANCE TEST REPORT AS FOLLOWS:  
A. ONE (1) COPY TO THE OWNER REPRESENTATIVE  
B. ONE (1) COPY TO THE ENGINEER  
C. ONE (1) COPY TO KEEP INSIDE EQUIPMENT ENCLOSURE

GROUNDING NOTE:

1. THIS GROUNDING PLAN WAS PREPARED PRIOR TO THE COMPLETION OF THE GEOTECHNICAL REPORT AND RECEIPT OF THE TOWER FOUNDATION DESIGN. THE LAYOUT OF RADIALS AND GROUND RODS ARE APPROXIMATE IN NATURE AND MAY NEED TO BE ADJUSTED IN THE FIELD. GROUND RODS SHOULD NOT EXTEND THROUGH THE TOWER FOUNDATION OR OTHER STRUCTURAL ELEMENTS WITHOUT PRIOR APPROVAL FROM THE DESIGN ENGINEER. IN ADDITION, SOME ADJUSTMENT TO THE GROUND METHOD MAY BE REQUIRED IN INSTANCES WHERE SHALLOW BEDROCK OR OTHER UNIQUE CIRCUMSTANCES ARE ENCOUNTERED. CONTRACTOR SHALL CONSULT GEOTECHNICAL REPORT FOR FURTHER DESIGN AND CONSTRUCTION RECOMMENDATIONS.

CONSULTANT:



CLIENT:



ENGINEER SEAL:

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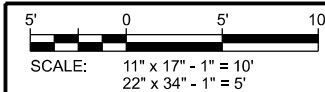
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**GROUNDING PLAN**  
**IA12 DT OELWEIN**  
**OELWEIN, IOWA**

SUBMITTAL:

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TJT	07/16/25	REV. A
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EDGE PROJ. #	44517
SET TYPE	DRAFT
SHEET NUMBER	<b>E-101</b>








KEYNOTES: (THIS SHEET)

- (A) 1/4" x 4" x 12" COLLECTOR GROUND BAR (CGB) FOR CONNECTION OF MULTIPLE GROUND KITS AT ONE LEVEL
- (B) CGB GROUND #2 AWG GREEN-INSULATED STRANDED COPPER LEAD WITH 2 HOLE LONG BARREL AND UL LISTED BONDING CLAMP TO TOWER STEEL AND/OR MOUNT STEEL
- (C) ANCILLARY EQUIPMENT GROUND KIT #2 AWG STRANDED INSULATED LEAD TO GROUND BAR WITH 2 HOLE LONG BARREL LUG (TYP.)
- (D) CABLE GROUND #2 AWG STRANDED INSULATED TO GROUND BAR WITH 2 HOLE LONG BARREL LUG (TYP.)
- (E) 1/4" x 4" x 20" MASTER GROUND BAR (MGB) MOUNTED VERTICALLY TO FIRST ICE BRIDGE POST ON INSULATORS
- (F) EQUIPMENT CABINET GROUND #2 AWG SOLID TINNED COPPER LEAD ENCASED IN LIQUID-TIGHT FLEXIBLE NON-METALLIC CONDUIT TO 24" BELOW GRADE TO EQUIPMENT PAD GROUND RING (TYP. OF 2 PER CABINET)
- (G) INTEGRATED LOAD CENTER (ILC) GROUND #2 AWG SOLID TINNED COPPER LEAD ENCASED IN LIQUID-TIGHT FLEXIBLE NON-METALLIC CONDUIT TO 24" BELOW GRADE TO EQUIPMENT PAD GROUND RING
- (H) FIBER ENCLOSURE GROUND #2 AWG SOLID TINNED COPPER LEAD ENCASED IN LIQUID-TIGHT FLEXIBLE NON-METALLIC CONDUIT TO 24" BELOW GRADE TO EQUIPMENT PAD GROUND RING
- (I) GENERATOR GROUND #2 AWG SOLID TINNED COPPER LEAD ENCASED IN LIQUID-TIGHT FLEXIBLE NON-METALLIC CONDUIT TO 24" BELOW GRADE TO EQUIPMENT PAD GROUND RING (TYP. OF 2)
- (J) CANOPY POST GROUND #2 AWG SOLID TINNED COPPER LEAD ENCASED IN LIQUID-TIGHT FLEXIBLE NON-METALLIC CONDUIT TO 24" BELOW GRADE (TYP. OF 4)
- (K) CANOPY TO POST GROUND #2 AWG GREEN-INSULATED STRANDED COPPER LEAD WITH 2 HOLE LONG BARREL ON EACH END (TYP.);
- (L) EQUIPMENT PAD REBAR GROUND #2 AWG SOLID TINNED COPPER LEAD ENCASED IN LIQUID-TIGHT FLEXIBLE NON-METALLIC CONDUIT TO 24" BELOW GRADE
- (M) CONDUIT GROUND #2 AWG SOLID TINNED COPPER LEAD

- (N) GPS GROUND TO ICE BRIDGE POST #2 AWG GREEN-INSULATED STRANDED COPPER LEAD
- (O) ICE BRIDGE POST GROUND #2 AWG SOLID TINNED COPPER LEAD ENCASED IN LIQUID-TIGHT FLEXIBLE NON-METALLIC CONDUIT TO 24" BELOW GRADE (TYP.)
- (P) ICE BRIDGE SECTION GROUND #2 AWG GREEN-INSULATED STRANDED COPPER LEAD WITH 2 HOLE LONG BARREL ON EACH END (TYP.)
- (Q) ICE BRIDGE SECTION TO POST GROUND #2 AWG SOLID TINNED COPPER LEAD (TYP.); ORIENT LEAD WITH HIGH SIDE TOWARDS TOWER
- (R) 1/4" x 4" x 20" TOWER GROUND BAR (TGB) INSTALLED ON TOWER; FOR LATTICE TOWERS, MOUNT TGB DIAGONALLY AT 12" ABOVE ICE BRIDGE FOR EASIER HOOK-UP OF GROUNDING KIT LEADS
- (S) TGB GROUND #2 AWG SOLID TINNED COPPER LEAD ENCASED IN LIQUID-TIGHT FLEXIBLE NON-METALLIC CONDUIT TO 24" BELOW GRADE FROM TGB TO TOWER GROUND RING (TYP. OF 2)
- (T) TBG GROUND #2 AWG GREEN-INSULATED STRANDED COPPER LEAD WITH 2 HOLE LONG BARREL AND UL LISTED BONDING CLAMP TO FLAT METAL
- (U) SECURE GROUND LEADS TO TOWER WITH BAND STRAPS OR SNAP-IN HANGERS AT GENERAL CONTRACTOR'S DISCRETION. USE MULTIPLE LEVELS OF ATTACHMENT IF GROUND BAR IS ATTACHED HIGH ABOVE GRADE.

GROUNDING LEGEND: (THIS SHEET)

- ▲ EXOTHERMIC OR UL RATED IRREVERSIBLE CONNECTION
- MECHANICAL CONNECTION
- GROUND LEAD

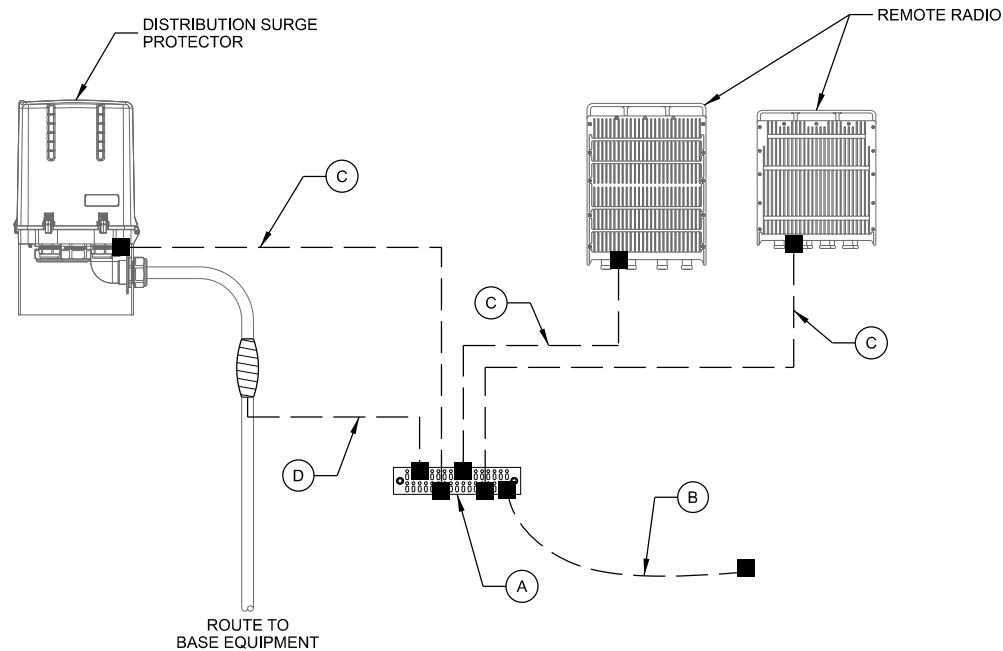


NOTES:

1. ALL CABLING AND/OR GROUNDING RUNS SHALL BE INSTALLED IN A NEAT AND ORDERLY FASHION.
2. CONTRACTOR SHALL INSTALL PER LATEST EDITION OF THE N.E.C.
3. SCHEMATIC DETAIL ONLY. REFER TO ANTENNA AND EQUIPMENT CONFIGURATION FOR EQUIPMENT QUANTITY AND LOCATION.
4. ALL GROUND LEADS TO BE ROUTED IN A DOWNWARD FASHION.

A ANTENNA LEVEL GROUNDING

NOTES: (THIS SHEET)

1. ALL BELOW-GRADE CONNECTIONS ARE TO BE EXOTHERMICALLY WELDED A MINIMUM OF 48" BELOW GRADE.
2. ALL LEADS EXTENDING ABOVE GRADE TO BE ENCASED IN 3/4" CONDUIT AND EXTEND A MINIMUM OF 6" ABOVE FINISHED GRADE AND 24" BELOW FINISHED GRADE.
3. APPLY COLD GALVANIZATION TO ALL ABOVE-GROUND EXOTHERMICALLY WELDED CONNECTIONS.
4. APPLY ANTI OXIDANT COMPOUND TO ALL MECHANICAL CONNECTIONS.
5. UPPER AND LOWER TOWER GROUND BARS TO BE BONDED DIRECTLY TO TOWER STEEL WITH #2 CONDUCTORS.
6. AIR TERMINAL TO EXTEND 2' ABOVE HIGHEST ANTENNA MIN. ON MAST PIPE MECHANICALLY FASTEN AIR TERMINAL TO MAST PIPE, MAST PIPE TO BE MECHANICALLY CONNECTED TO TOWER STEEL

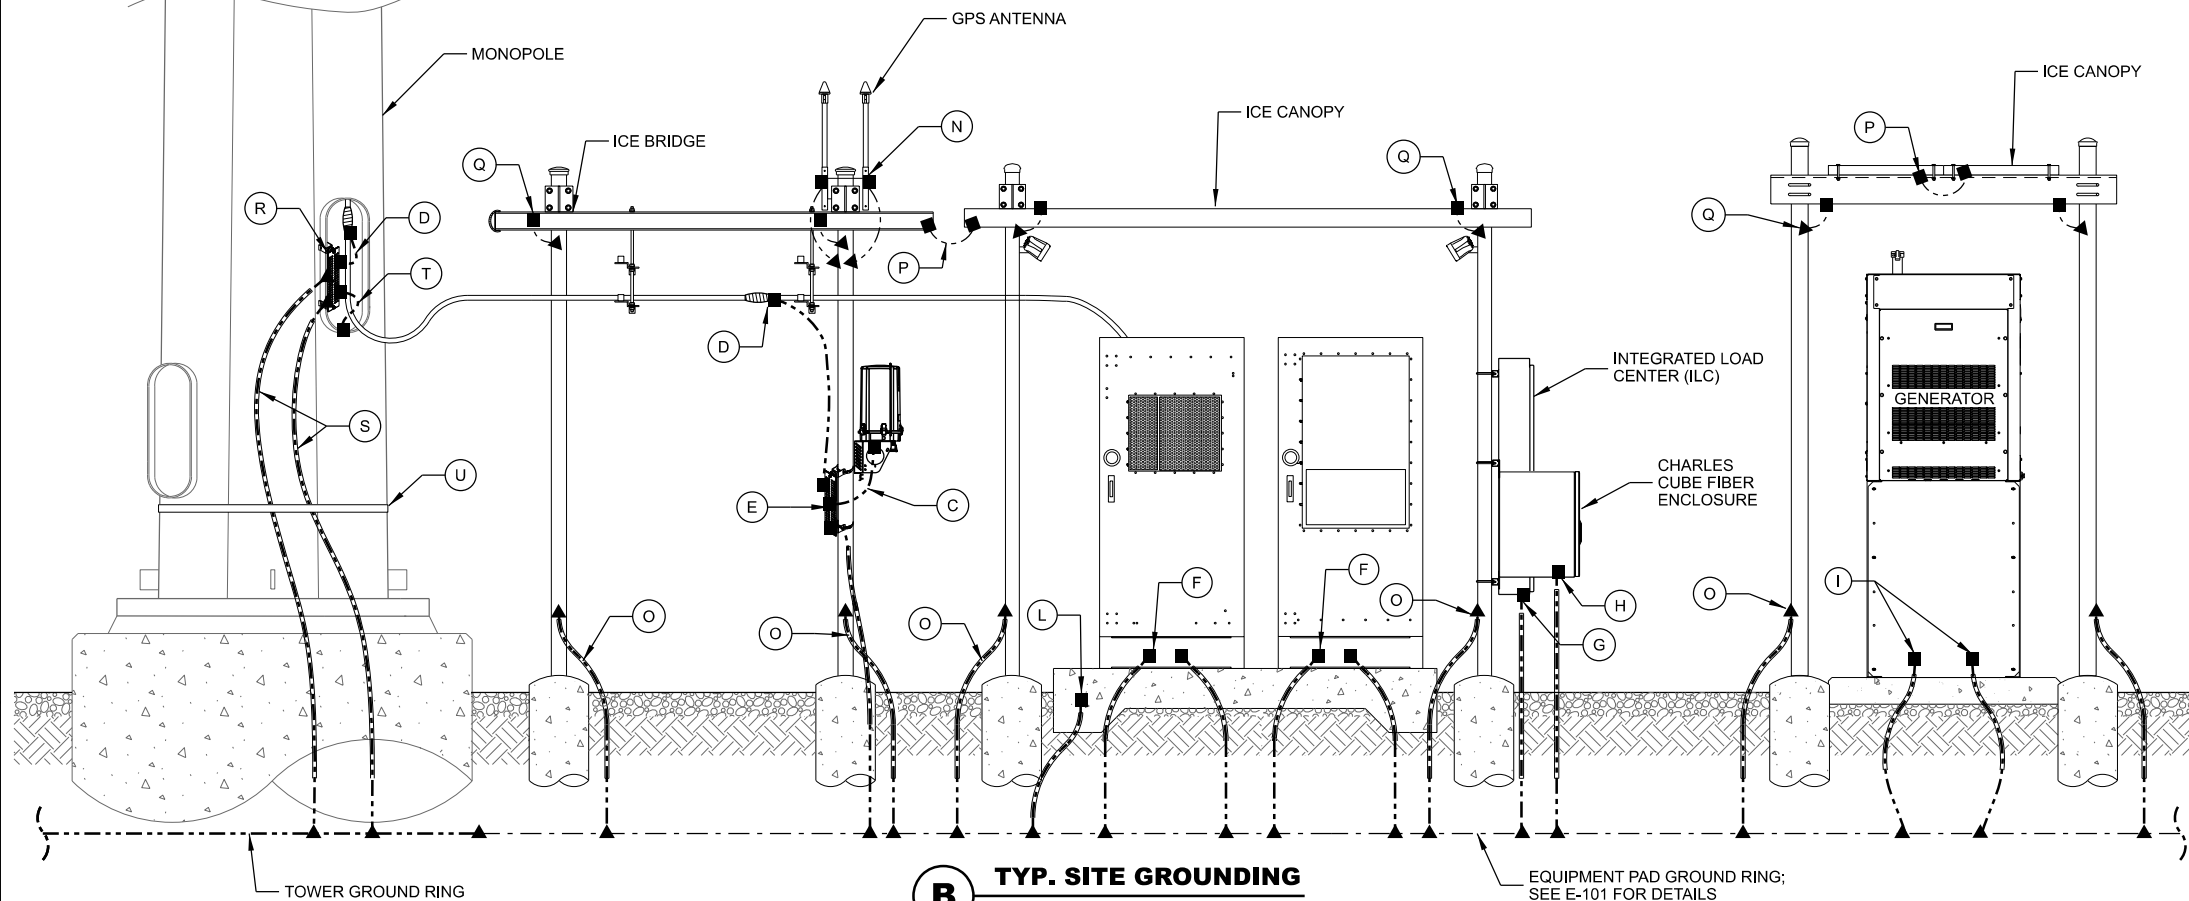

B TYP. SITE GROUNDING

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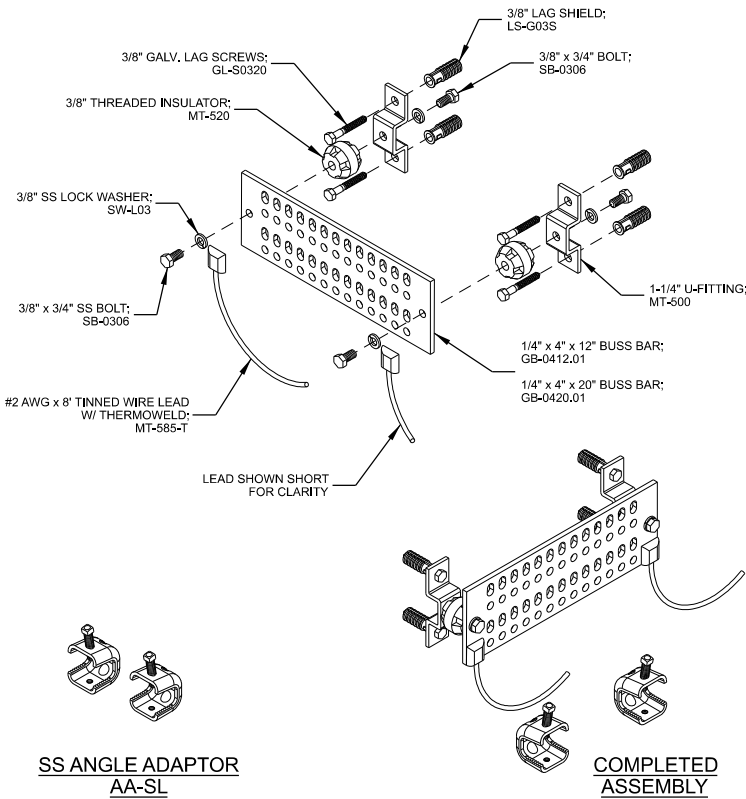
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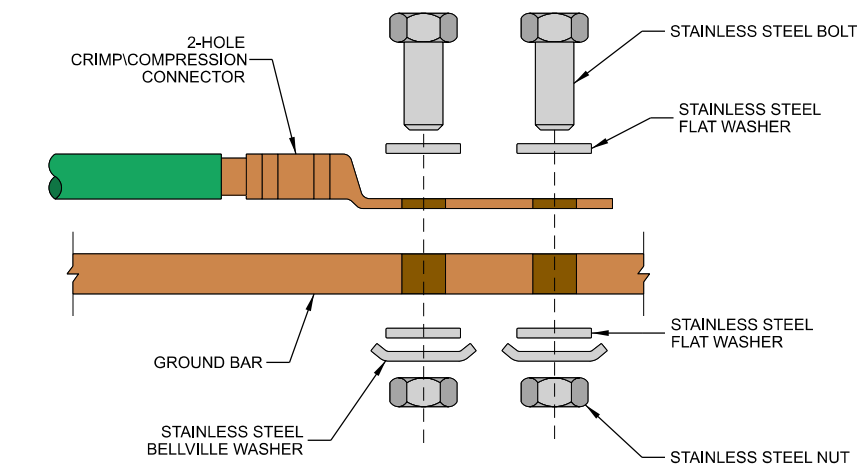
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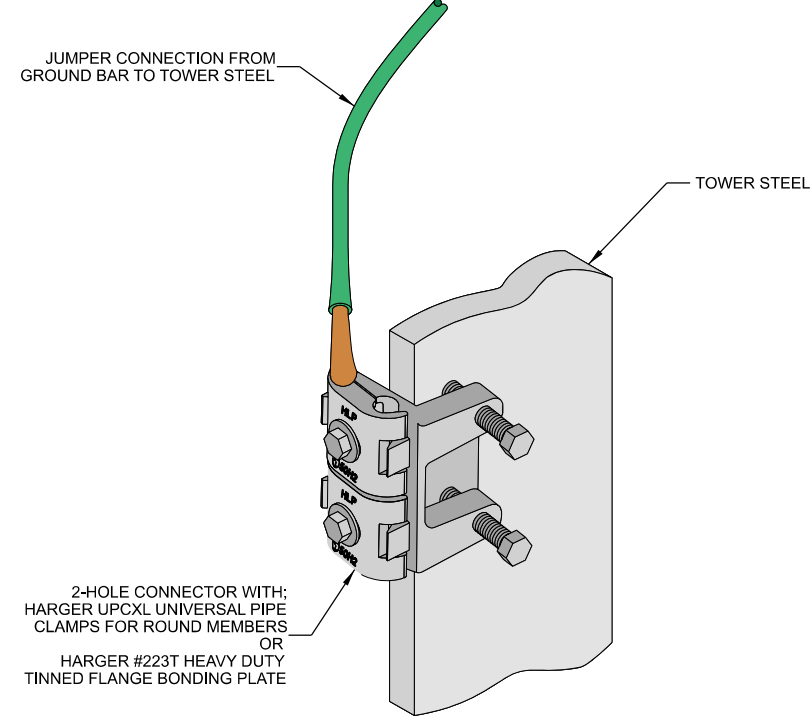


**A** GROUND AND BUSS BAR



- NOTES:
1. ALL OUTDOOR HARDWARE (BOLTS, SCREWS, NUTS, WASHERS) SHALL BE 18-8 STAINLESS STEEL TYPE GRADE. INDOORS, GRADE 5 STEEL HARDWARE MAY BE USED.
  2. CHOOSE BOLT LENGTH TO ALLOW THE EXPOSURE OF AT LEAST TWO THREADS.
  3. BACK TO BACK LUG CONNECTIONS ARE AN ACCEPTABLE PRACTICE WHEN BONDED TO A GROUND BAR OR STEEL OBJECTS.
  4. AT CONNECTIONS MADE TO STEEL OR ANY OTHER DISSIMILAR METALS, A DRAGON TOOTH WASHER MEETING VZW PRACTICES SHALL BE USED BETWEEN THE CONNECTOR AND STEEL.
  5. IF NOT USING DRAGON TOOTH WASHERS, THOROUGHLY REMOVE A SECTION OF PAINT OR COATING APPROXIMATELY THE SAME SIZE AS CONNECTOR. REMOVE THE PAINT FROM SURFACE USING A DREMEL TYPE TOOL.
  6. USE AN APPROVED ANTI-OXIDATION COMPOUND ON ALL GROUNDING CONNECTIONS. A COPPER COSMOLINE GREASE BASED COMPOUND (NO OX-ID) SHALL BE USED ON ALL COPPER TO COPPER CONNECTIONS. A ZINC BASED (GREY COLORED) COMPOUND SHALL BE USED ON ALL COPPER TO STEEL CONNECTIONS.
  7. WHEN BONDING TO A METALLIC OBJECT WHERE ACCESS IS LIMITED TO ONLY ONE SURFACE, DRILLING & TAPPING OR SELF DRILLING SCREWS ARE THE PREFERRED AND ACCEPTABLE MEANS OF CONNECTION. SHEET METAL SCREWS SHALL NOT BE USED.

**B** GROUNDING LUG




**C** GROUND BAR CONNECTION TO TOWER STEEL

MANUFACTURER: SITE PRO 1  
MODEL: VARIES (SEE TABLE BELOW)

KIT INCLUDES UNIVERSAL SLOTTED 3/8" TWO-HOLE LUG, HARDWARE, BUTYL, AND ELECTRICAL TAPE.


COMPLIES WITH MIL-STD-188-124A AND WITHSTANDS LIGHTNING STRIKES IN EXCESS OF 200kA.

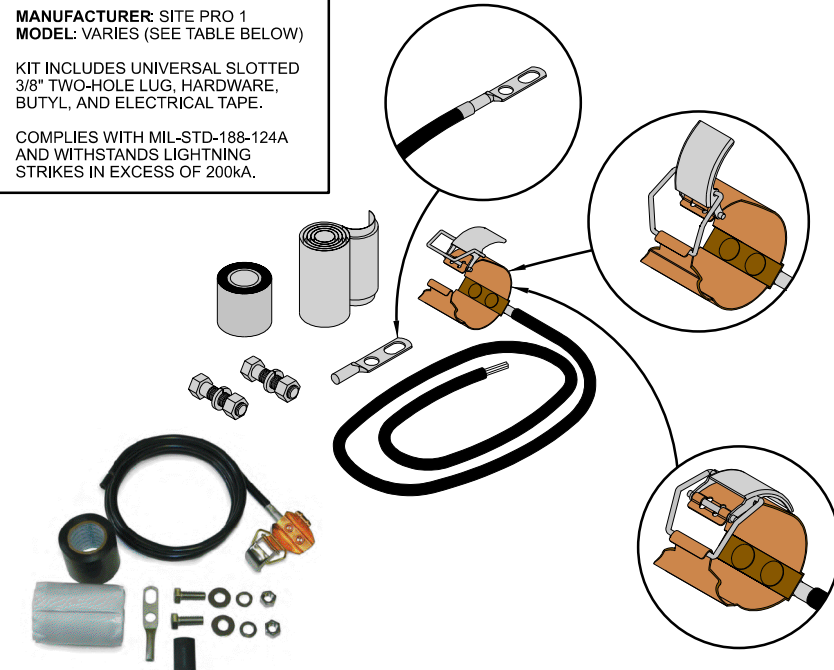

PART #	CABLE SIZE & TYPE	LENGTH	LUG	WEIGHT
GK-C12	1/2" CORRUGATED	5'	UNATTACHED	1.50 LB.
GK-C78	7/8" CORRUGATED	5'	UNATTACHED	1.65 LB.
GK-C114	1-1/4" CORRUGATED	5'	UNATTACHED	1.70 LB.
GK-C158	1-5/8" CORRUGATED	5'	UNATTACHED	1.70 LB.
GK-C214	2-1/4" CORRUGATED	5'	UNATTACHED	1.80 LB.


**D** CLIP ON GROUND KIT

MANUFACTURER: HARGER  
MODEL: VARIES (SEE BELOW)

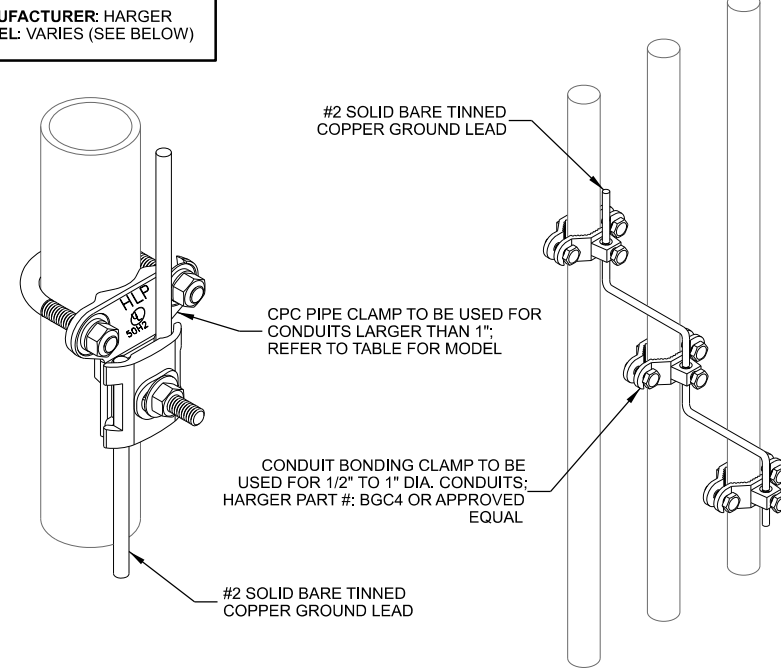

PART #	NOMINAL PIPE SIZE RANGE	PIPE OUTSIDE DIAMETER
CPC1/1.25	1" - 1.25"	0.9375" - 1.7"
CPC1.5/2	1.5" - 2"	1.25" - 2.4"
CPC2.5/3	2.5" - 3"	2.5" - 3.5"
CPC3.5/4	3.5" - 4"	3.375" - 4.5"
CPC5/6	5" - 6"	4.75" - 6.63"

**E** CONDUIT GROUNDING

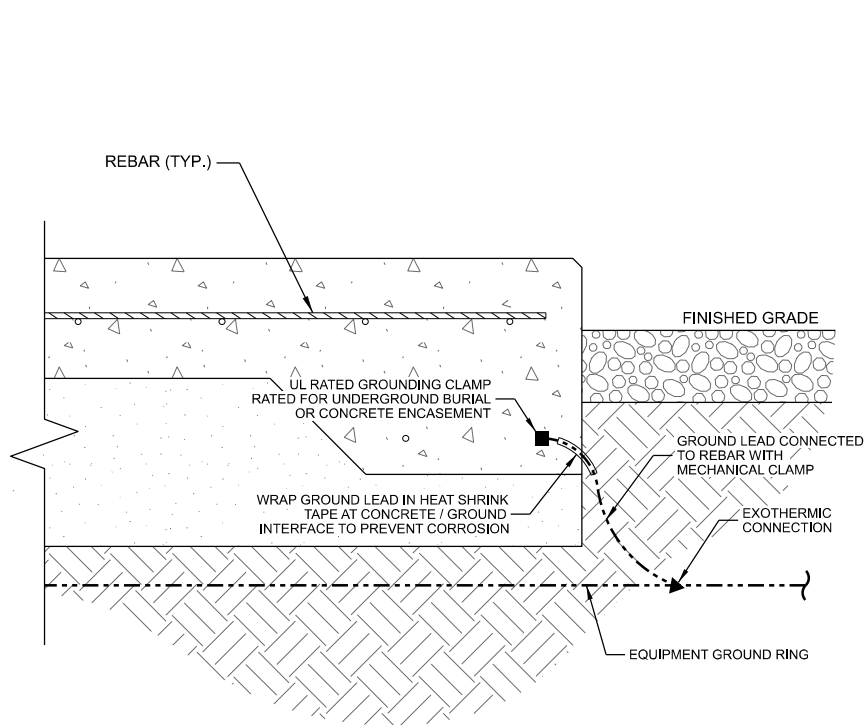

- NOTES:
1. FOUNDATION SHOWN IS TYPICAL. SEE TOWER FOUNDATION PLANS FOR REINFORCEMENT DETAILS.
  2. FOUNDATION GROUNDING PER NEC 250.52(3)(A). GROUNDING CONNECTIONS TO BE COVERED BY A MINIMUM OF 3" CONCRETE AND BE MADE TO A MIN. 20' CONTINUOUS REBAR, IF POSSIBLE.

**F** EQUIP. PAD FOUNDATION GROUNDING

CONSULTANT:  
**Edge**  
Consulting Engineers, Inc.  
624 WATER STREET  
PRAIRIE DU SAC, WI 53578  
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www.edgeconsult.com

CLIENT:  
**verizon**  
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BLOOMINGTON, MN 55438

ENGINEER SEAL:  
**NOT FOR CONSTRUCTION**





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**GROUNDING DETAILS**  
**IA12 DT OELWEIN**  
**OELWEIN, IOWA**

SUBMITTAL:		
INT.	DATE:	DESCRIPTION:
TJT	07/16/25	REV. A
BSS	08/07/25	REV. B

CHECKED BY:	PER
EDGE SITE ID	S8464
EDGE PROJ. #	44517
SET TYPE	DRAFT
SHEET NUMBER	<b>E-502</b>



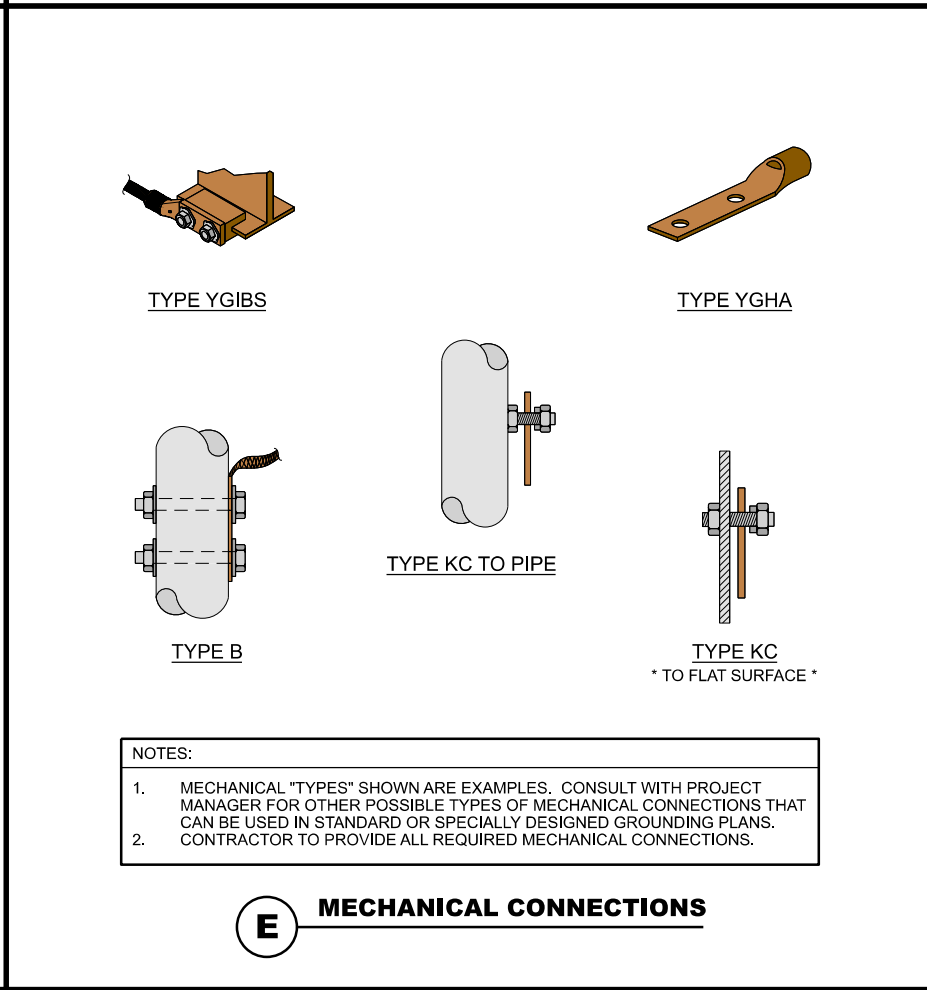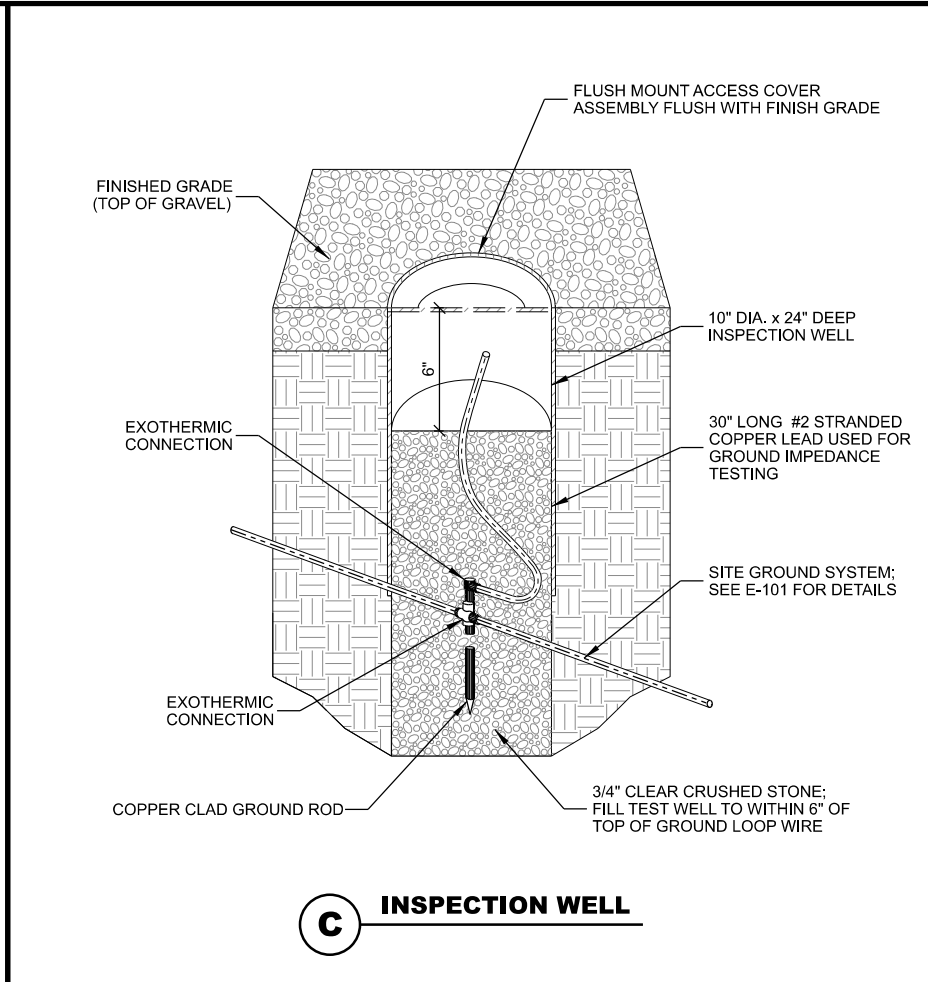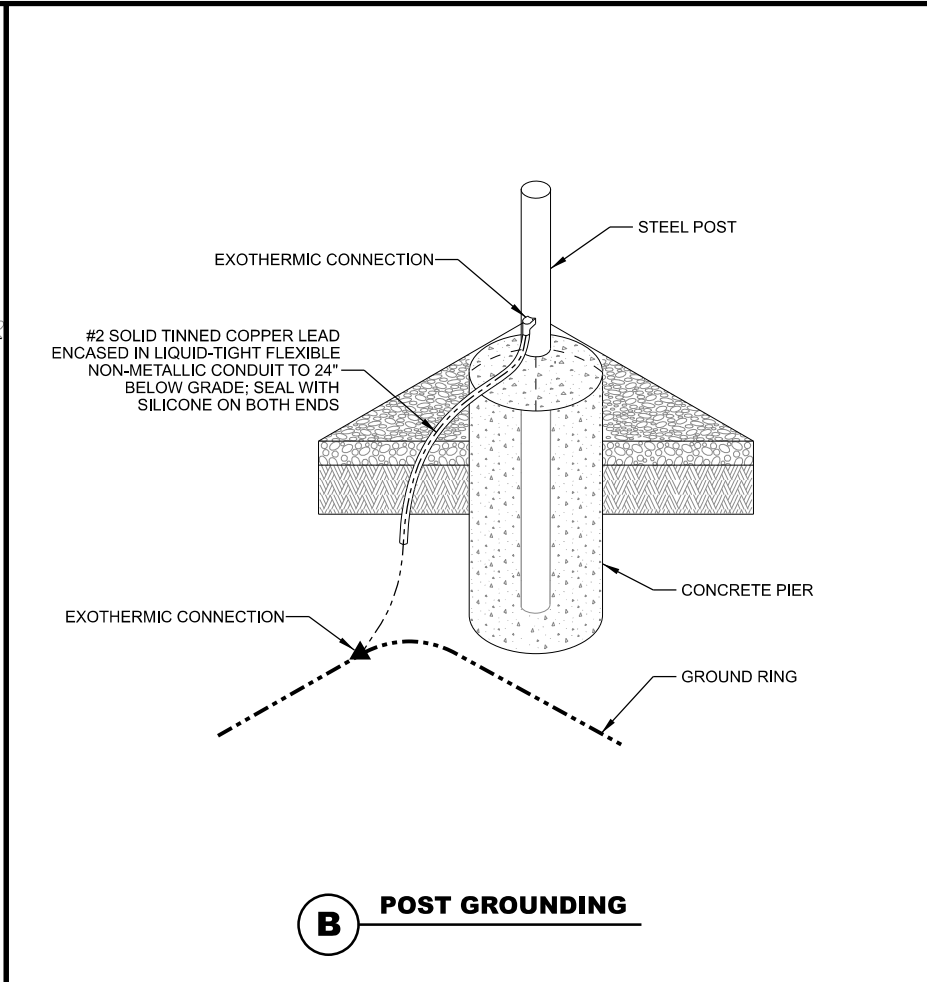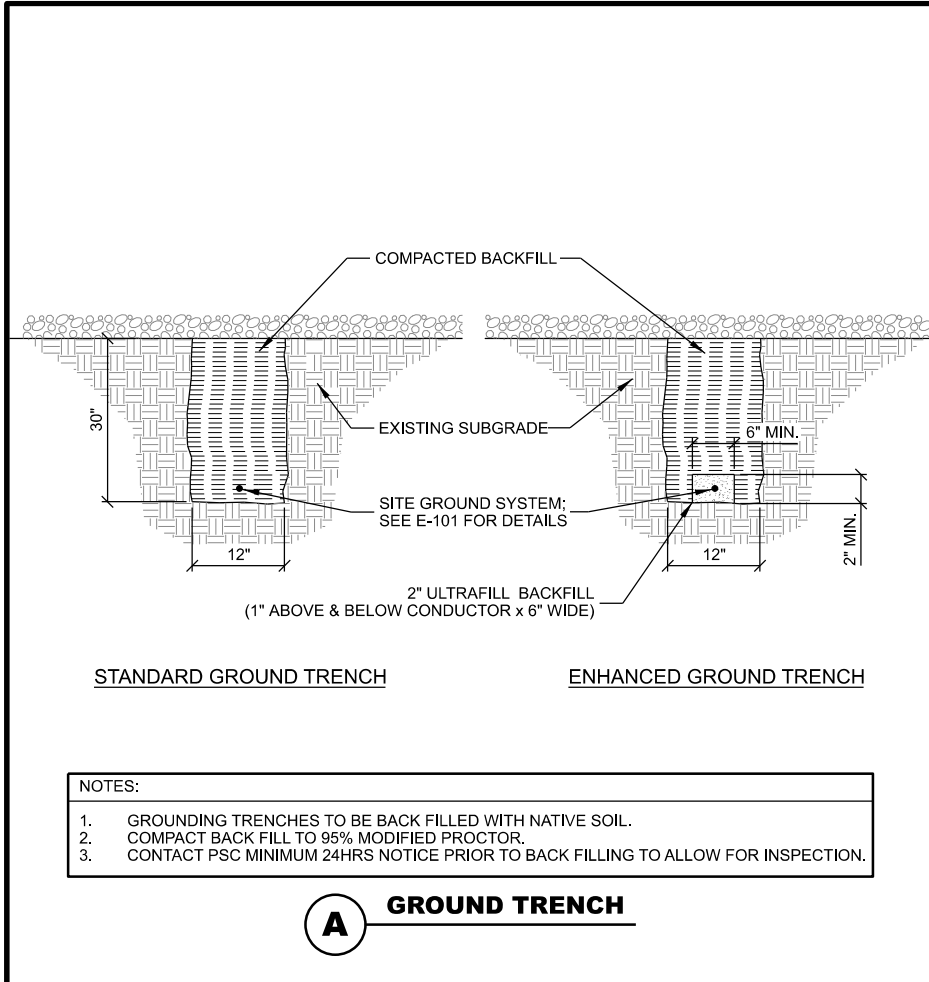

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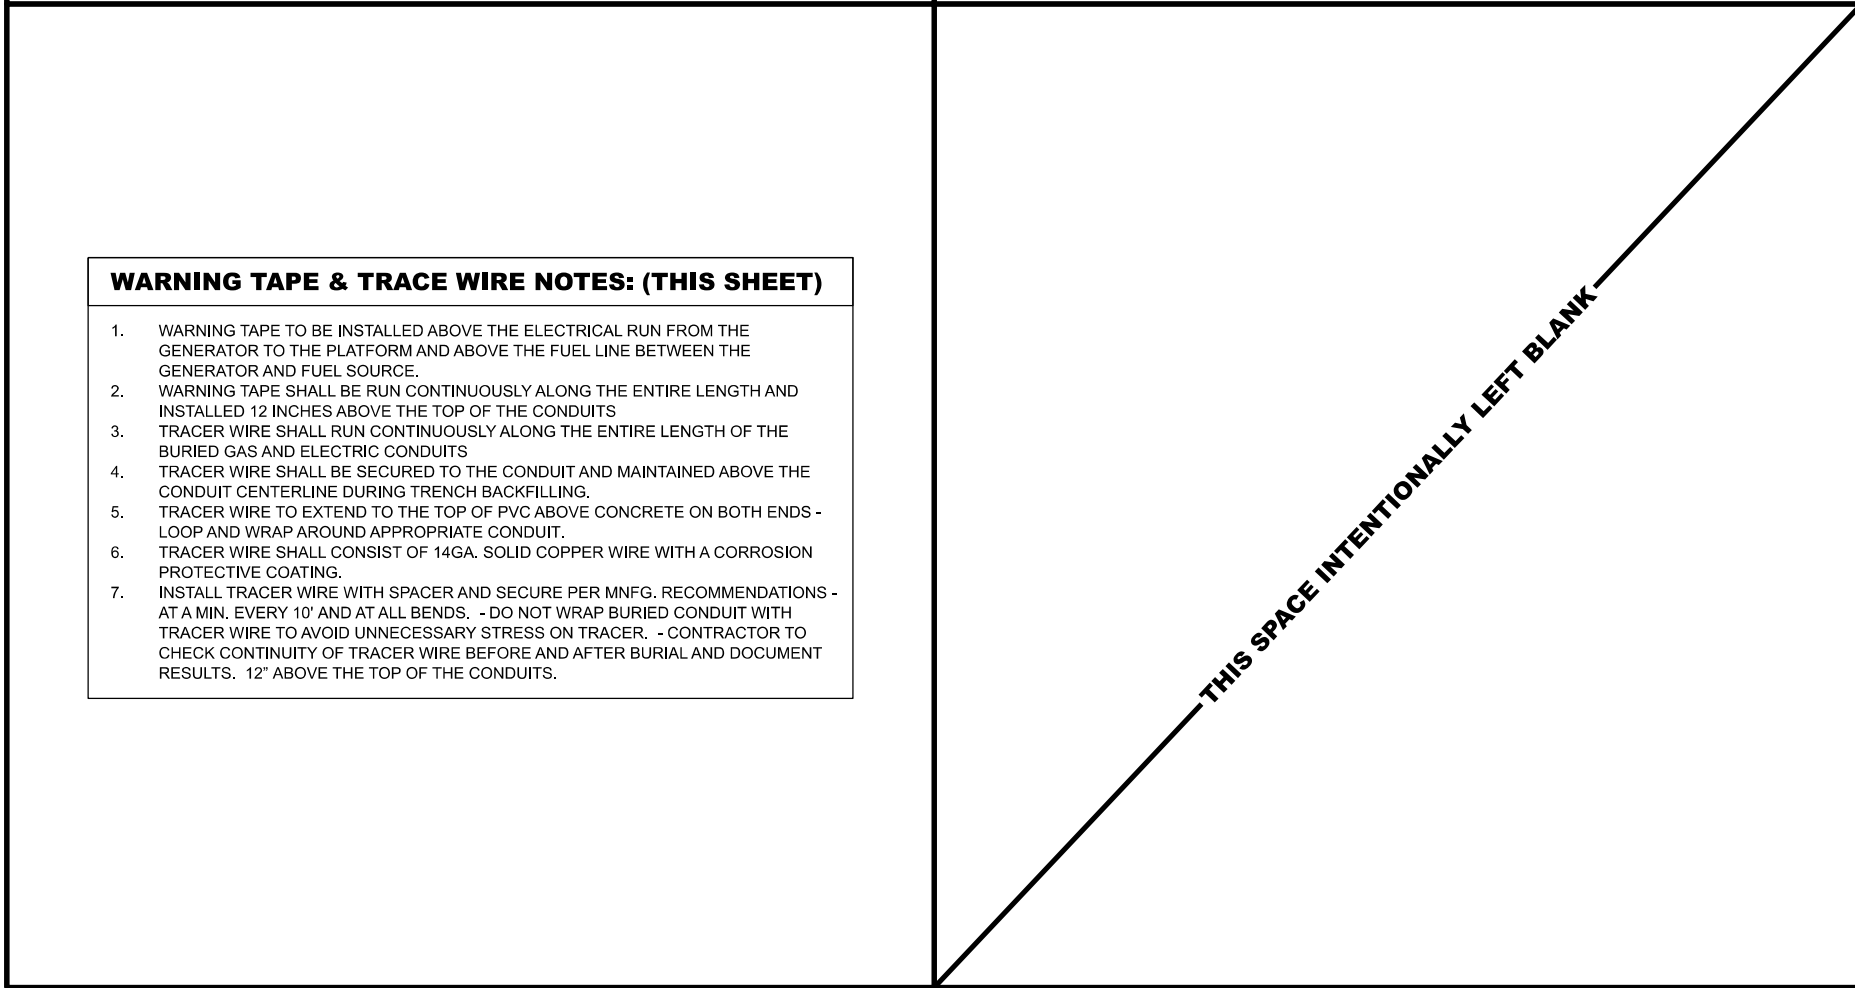
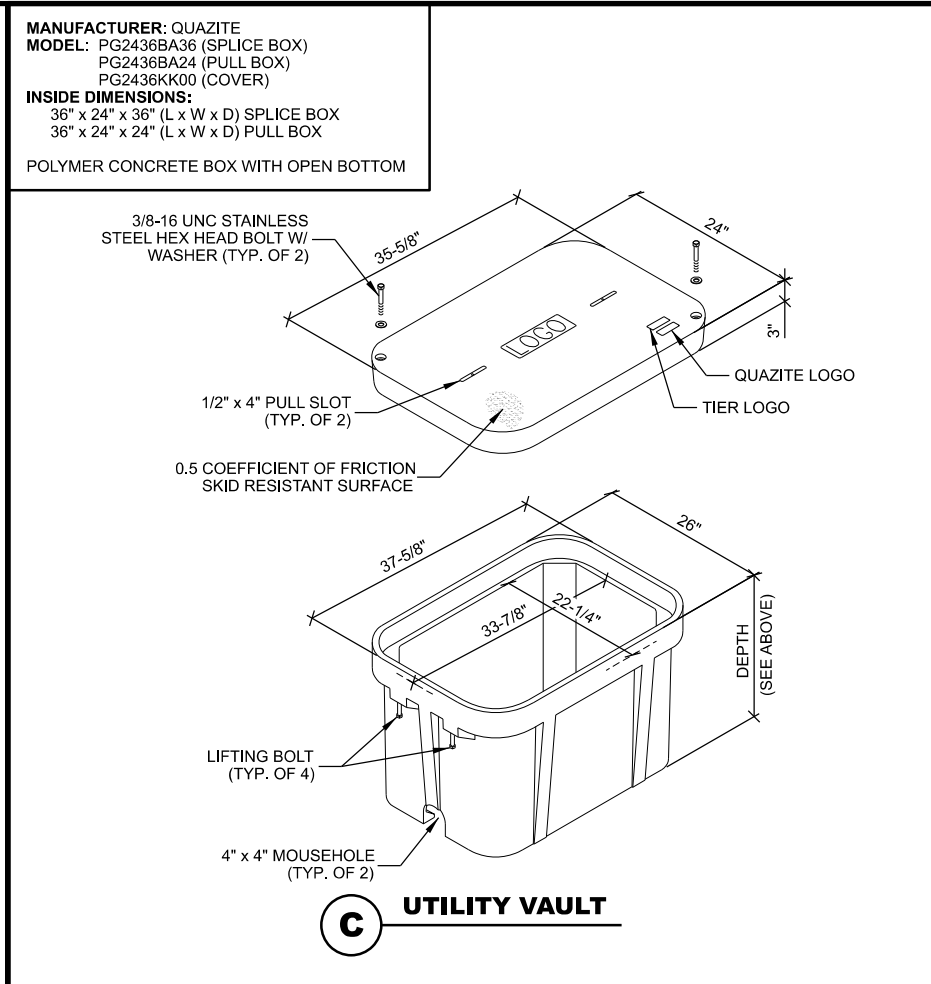
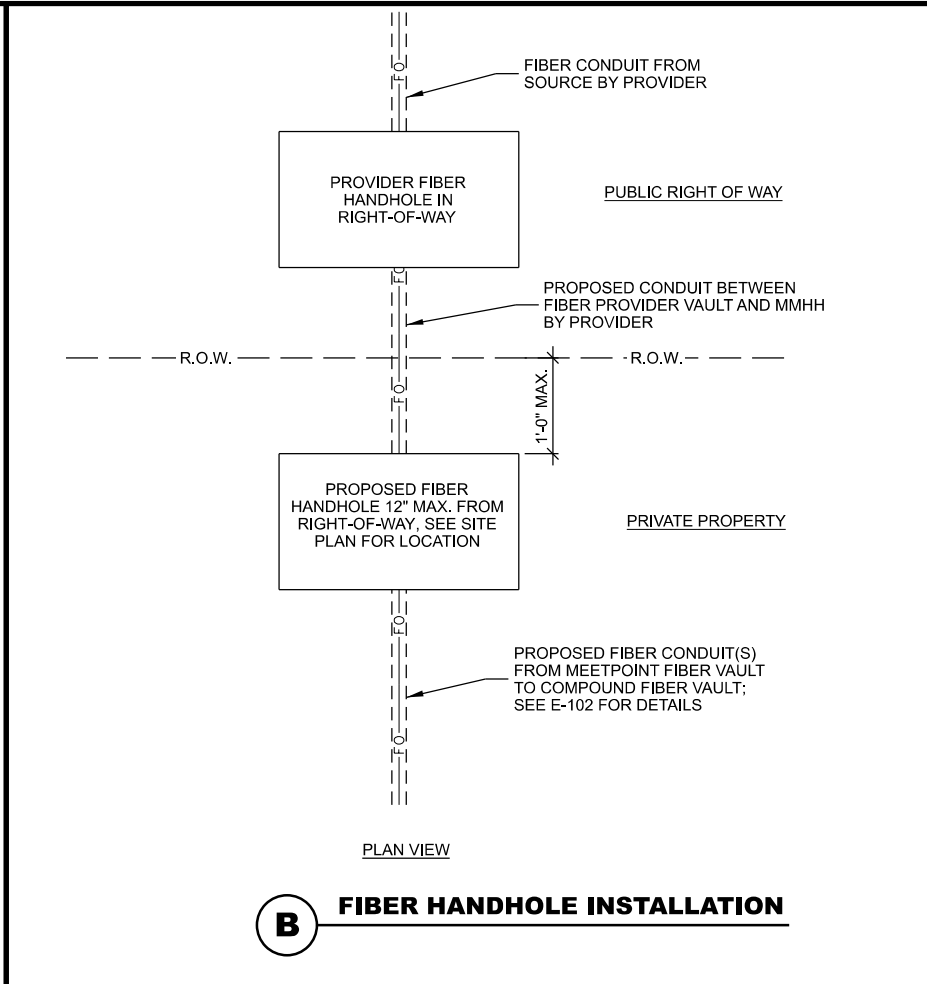
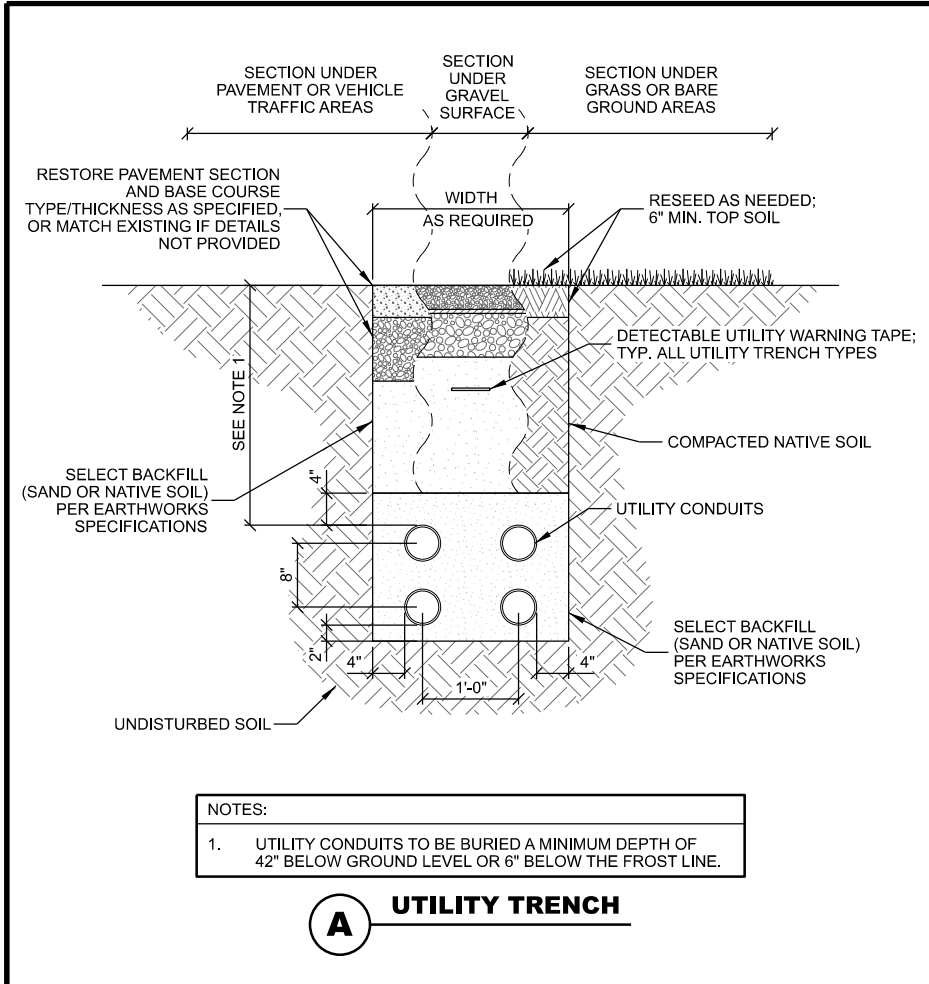
CHECKED BY: PER

EDGE SITE ID: S8464

EDGE PROJ. #: 44517

SET TYPE: DRAFT

SHEET NUMBER: **E-503**



**WARNING TAPE & TRACE WIRE NOTES: (THIS SHEET)**

1. WARNING TAPE TO BE INSTALLED ABOVE THE ELECTRICAL RUN FROM THE GENERATOR TO THE PLATFORM AND ABOVE THE FUEL LINE BETWEEN THE GENERATOR AND FUEL SOURCE.
2. WARNING TAPE SHALL BE RUN CONTINUOUSLY ALONG THE ENTIRE LENGTH AND INSTALLED 12 INCHES ABOVE THE TOP OF THE CONDUITS
3. TRACER WIRE SHALL RUN CONTINUOUSLY ALONG THE ENTIRE LENGTH OF THE BURIED GAS AND ELECTRIC CONDUITS
4. TRACER WIRE SHALL BE SECURED TO THE CONDUIT AND MAINTAINED ABOVE THE CONDUIT CENTERLINE DURING TRENCH BACKFILLING.
5. TRACER WIRE TO EXTEND TO THE TOP OF PVC ABOVE CONCRETE ON BOTH ENDS - LOOP AND WRAP AROUND APPROPRIATE CONDUIT.
6. TRACER WIRE SHALL CONSIST OF 14GA. SOLID COPPER WIRE WITH A CORROSION PROTECTIVE COATING.
7. INSTALL TRACER WIRE WITH SPACER AND SECURE PER MNFG. RECOMMENDATIONS - AT A MIN. EVERY 10' AND AT ALL BENDS. - DO NOT WRAP BURIED CONDUIT WITH TRACER WIRE TO AVOID UNNECESSARY STRESS ON TRACER. - CONTRACTOR TO CHECK CONTINUITY OF TRACER WIRE BEFORE AND AFTER BURIAL AND DOCUMENT RESULTS. 12" ABOVE THE TOP OF THE CONDUITS.

- NOTES:
1. MAINTAIN 3" MINIMUM REBAR COVER IN ALL DIRECTION
  2. PIER FOUNDATION DEPTH TO BE A MINIMUM OF 48";
  3. DEPTH TO EXCEED LOCAL FROST DEPTH
  - CONCRETE TO BE A MINIMUM OF 4,000 PSI AT 28 DAYS

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**UTILITY DETAILS**  
**IA12 DT OELWEIN**  
**OELWEIN, IOWA**

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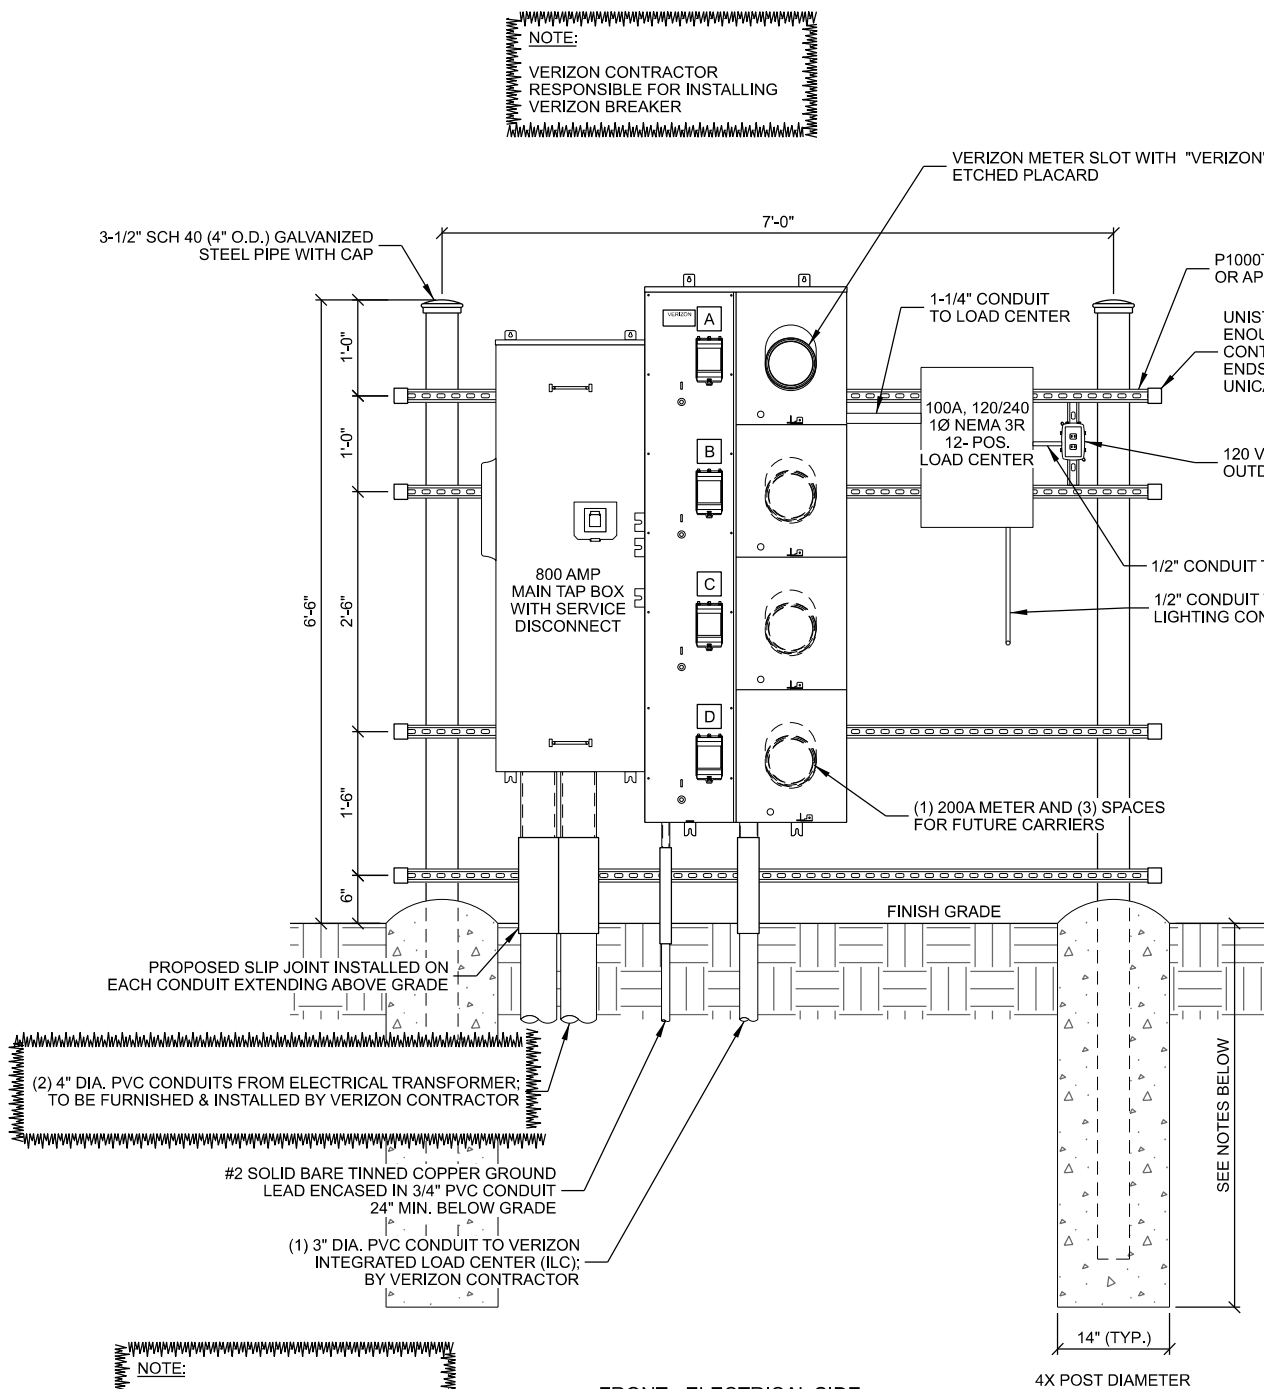
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EDGE SITE ID	S8464
EDGE PROJ. #	44517
SET TYPE	DRAFT
SHEET NUMBER	<b>E-504</b>

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NOTE:

A TEMPORARY 200AMP SUB-PANEL  
MAY BE REQUIRED IF VERIZON ILC IS  
NOT INSTALLED

NOTE:

1. INSTALL PVC CONDUITS FOR SERVICE LATERAL CONNECTION TO UTILITY.
2. EXTEND SERVICE LATERAL CONDUITS UNDERGROUND BEYOND FENCELINE, CAP ENDS (NO DUCT TAPE ALLOWED) AND STAKE, EQUIP WITH PULL CORD, VERIFY REQUIREMENTS W/UTILITY PROVIDER.
3. MARK CARRIER METER SLOT @ BREAKER OR SOCKET EXTERIOR WITH PLACARD.
4. SOD EZ METER PAK, 120/240 VAC 1 PHASE, 3 WIRE OR EQUIV., VERIFY REQUIREMENTS WITH UTILITY PROVIDER
5. FINAL LAYOUT AND DESIGN DETERMINED BY CONTRACTOR/UTILITY & MEET NEC 2020 CODE REQUIREMENTS OR LATEST NEC. VERIFY FINAL DESIGN WITH THE CARRIER.
6. CONCRETE FOR PIER TO BE A MINIMUM OF 2,500 PSI AT 28 DAYS.
7. MAINTAIN 3" MINIMUM REBAR COVER IN ALL DIRECTIONS.
8. PIER FOUNDATION DEPTH TO BE A MINIMUM OF 48"; DEPTH TO EXCEED LOCAL FROST DEPTH.


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**MULTI-METER UTILITY RACK**

SCALE: 11" x 17" - 1/2" = 1'-0"  
22" x 34" - 1" = 1'-0"

LIGHTING NOTE:

LIGHTING CONTROLS AND SOW DICTATED BY FLASH  
"NEW CONSTRUCTION TELECOM STRUCTURES FAA  
LIGHTING INSTALLATIONS GUIDELINES". THIS WILL  
BE PROVIDED WITH BID DOCUMENTS

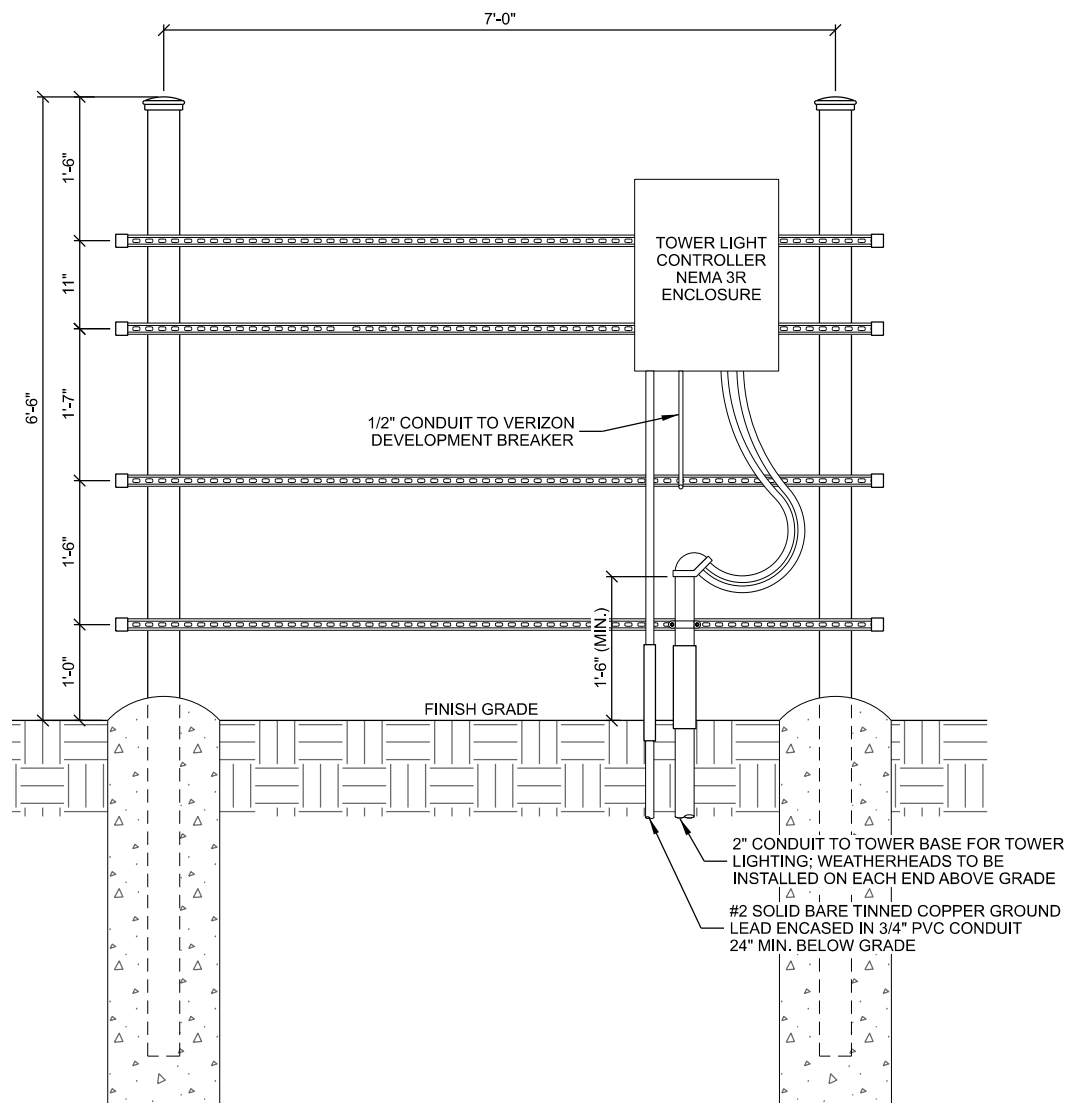

NOTES:

- VERIZON CONTRACTOR TO ENSURE LOCAL ELECTRIC CODE REQUIREMENTS ARE MET
- VERIZON CONTRACTOR TO CONTACT ELECTRIC UTILITY TO CONFIRM ALL REQUIREMENTS
- VERIZON CONTRACTOR RESPONSIBLE FOR INSTALLING VERIZON BREAKER
- SQUARE D PRODUCTS SHOWN FOR CLARITY. APPROVED EQUIVALENTS ARE ACCEPTABLE. VERIFY FINAL ELECTRIC EQUIPMENT WITH APPROVED UTILITY LIST
- VERIZON CONTRACTOR TO VERIFY ELECTRIC UTILITY WILL ACCEPT A MAIN TAP BOX WITH SERVICE DISCONNECT INCLUDED

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**UTILITY RACK DETAILS**  
**IA12 DT OELWEIN**  
**OELWEIN, IOWA**

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CHECKED BY	PER
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EDGE PROJ. #	44517
SET TYPE	DRAFT
SHEET NUMBER	<b>E-506</b>