OELWEIN EVENT CENTER PARKING LOT IMPROVEMENTS


FOR

CITY OF OELWEIN OELWEIN, IOWA

23-500

FAYETTE COUNTY

JULY 2023

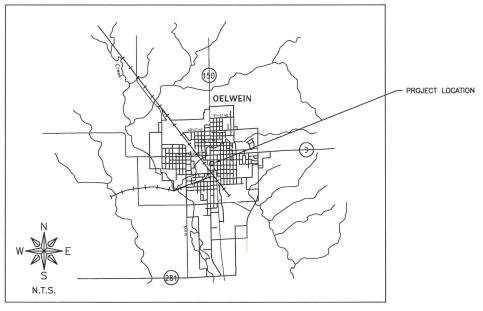

LOCATION MAP

FEHR GRAHAM


ENGINEERING & ENVIRONMENTAL

ILLINOIS

IOWA

WISCONSIN

WEST UNION, IOWA 128 S VINE STREET WEST UNION, IA 52175 P# (563) 422-5131

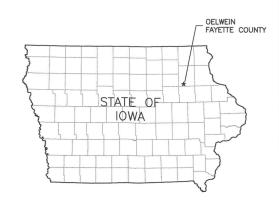

THE 2023 VERSION OF THE STATEWIDE URBAN STANDARD SPECIFICATIONS FOR PUBLIC IMPROVEMENTS, ALSO KNOWN AS SUDAS (2023), PLUS FEHR GRAHAM SUPPLEMENTAL SPECIFICATION AND SPECIAL PROVISIONS SHALL APPLY TO CONSTRUCTION WORK ON THIS PROJECT.



Date

DATE

1-800-292-8989

www.iowaonecall.com

JON S. BIEDERMAN 13868

BID SET

I hereby cextry that this engineering document was prepared by me or under my direct personal supervision and that I am a duly licensed Professional Engineer under the laws of the State of Iowa

Jon S. Biederman, P.E.

License Number 13868 My license renewal date is December 31, 2024. Pages or sheets covered by this seal: All

> ORIGINAL SET FOR PROJECT: 23-500 DATE CREATED: JULY 2023 REVISIONS DESCRIPTION

COMMON NAME OELWEIN, CITY OF WATER & SEWER ELECTRIC TELEPHONE CENTURY LINK ALLIANT CABLE MEDIACOM

OWNER/DEV CITY OF OELWEIN ADDRESS 20 2ND AVE. SW

COUNCIL MEMBERS.

CITY ADMINISTRATOR

CITY CLERK.

OELWEIN, IOWA 50662 P# 319-283-5440 F# 319-283-4032

CITY ADMINISTRATION

BRETT DEVORE

DAVE LENZ

LYNDA PAYNE

TOM STEWART

MATT WEBER

KAREN SEEDERS

DYLAN MULTINGER

BARBARA RIGDON

DAVID GARRIGUS

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AND REMOVAL PLANS

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NORTH PARKING LOT GRADING AND PAVING PLAN

EAST PARKING LOT GRADING AND PAVING

NORTH PARKING LOT STORMWATER PLAN & PROFILE

EAST PARKING LOT EXISTING CONDITION AND REMOVAL PLANS

LEGEND

Sheet Number A.01 A.02

C.01

C.02

C.03

D.01

D.02


D.03

D.04

м.01

(CONTRACTOR TO BE RESPONSIBLE FOR COORDINATING ANY ADJUSTMENTS TO BE MADE.)

G:\C3D\23\23-500\Plans\23-500 Plans.dwg, A.01

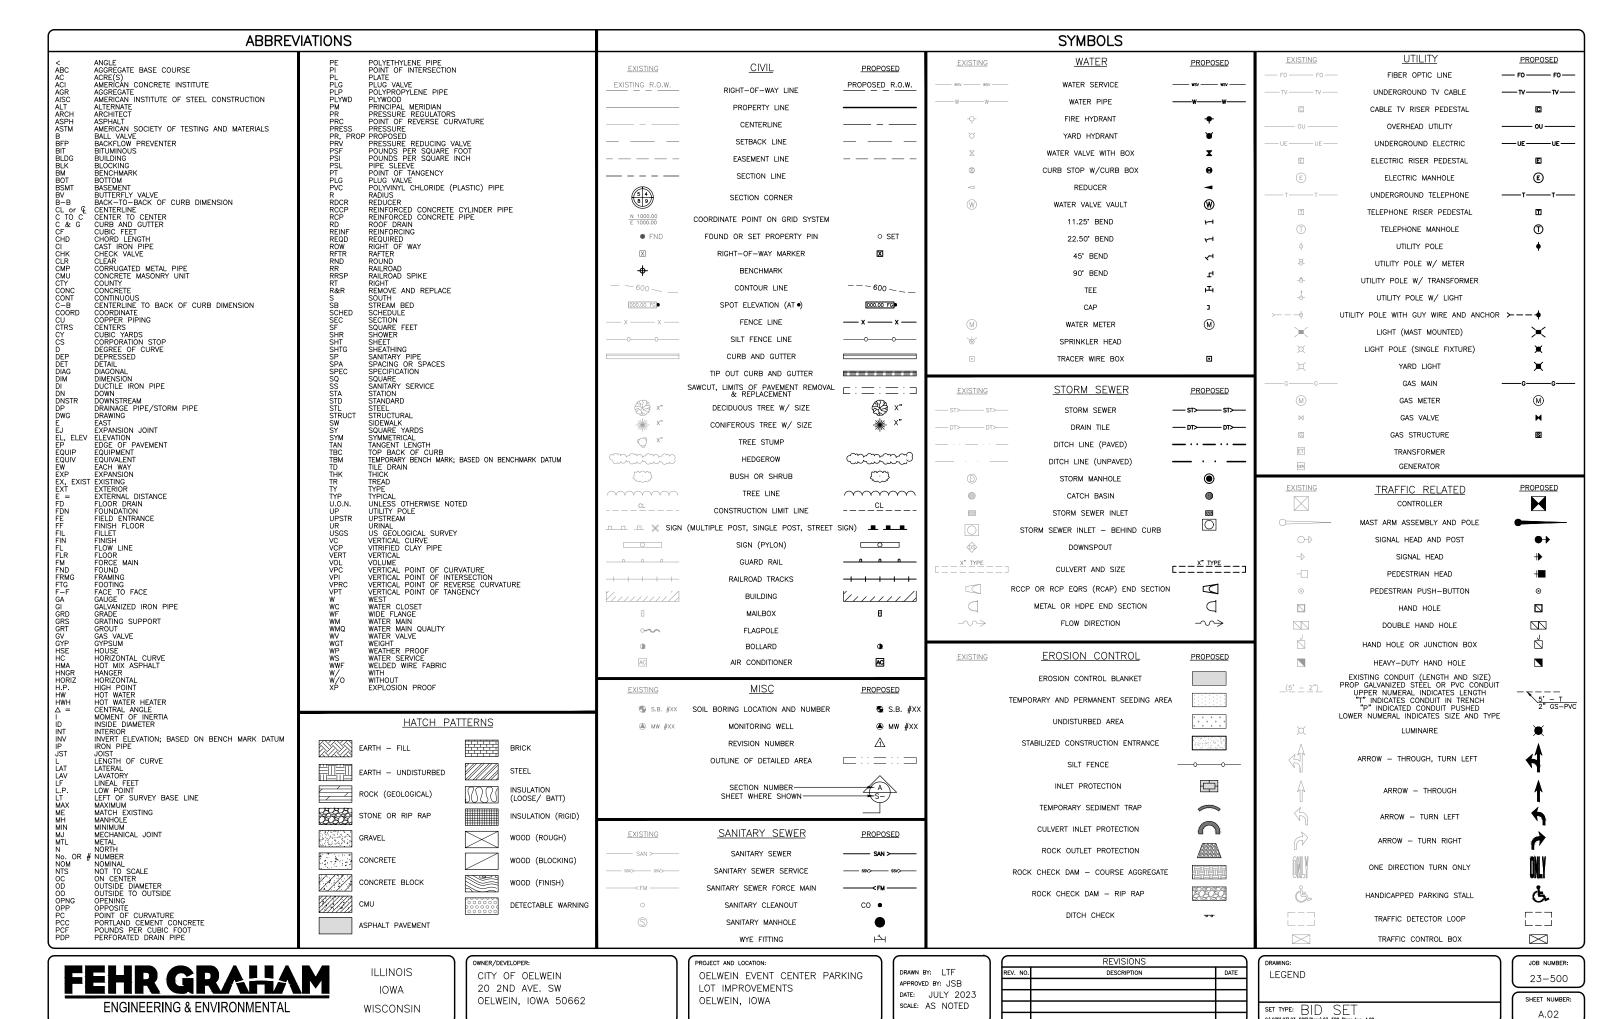

GENERAL NOTES

- ALL WORK SHALL CONFORM TO AND BE PERFORMED IN ACCORDANCE WITH ALL APPLICABLE CODES AND ORDINANCES.
- 2. THE URBAN STANDARD SPECIFICATIONS FOR PUBLIC IMPROVEMENTS (SUDAS), 2023 EDITION PLUS SUPPLEMENTAL SPECIFICATIONS AND SPECIAL PROVISIONS AS PREPARED BY FEHR GRAHAM SHALL BE CONSIDERED A PART OF THESE DOCUMENTS AS IF BOUND LEGEN
- 3. THE QUANTITIES INDICATED ON THE PROPOSAL FORM ARE APPROXIMATE ONLY, AND DO NOT CONSTITUTE A WARRANTY OR GUARANTEE BY THE JURISDICTION AS TO THE ACTUAL QUANTITIES INVOLVED IN THE WORK. SUCH QUANTITIES ARE TO BE USED FOR THE PURPOSE OF COMPARISON OF BIDS AND DETERMINING THE AMOUNT OF BID SECURITY, CONTRACT, AND PERFORMANCE, PAYMENT, AND MAINTENANCE BOND. IN THE EVENT OF DISCREPANCIES BETWEEN UNIT PRICES AND UNIT PRICE EXTENSIONS LISTED IN A BIDDER'S PROPOSAL, UNIT PRICES SHALL GOVERN AND UNIT PRICE EXTENSIONS SHALL BE CORRECTED, AS NECESSARY, FOR AGREEMENT WITH UNIT PRICES. THE JURISDICTION EXPRESSLY RESERVES THE RIGHT TO INCREASE OR DECREASE THE QUANTITIES DURING CONSTRUCTION, AND TO MAKE REASONABLE CHANGES IN DESIGN, PROVIDED SUCH CHANGES DO NOT MATERIALTY CHANGE THE INTENT OF THE CONTRACT. THE AMOUNT OF WORK TO BE PAID FOR SHALL BE BASED UPON THE ACTUAL QUANTITIES PERFORMED.
- 4. CONSTRUCTION SURVEY FOR THIS PROJECT TO BE PROVIDED BY THE OWNER. THE CONTRACTOR IS REQUIRED TO PROVIDE MINIMUM OF TWO BUSINESS DAYS' NOTICE TO THE ENGINEER WHEN REQUESTING STAKES.
- 5. THE CONTRACTOR SHALL NOTIFY ALL APPROPRIATE ENGINEERING DEPARTMENTS AND UTILITY COMPANIES PRIOR TO CONSTRUCTION. ALL NECESSARY PRECAUTIONS SHALL BE TAKEN TO AVOID DAMAGE TO ANY EXISTING UTILITY. IOWA CODE 480, UNDERGROUND FACILITIES INFORMATION, REQUIRES NOTICE TO IOWA ONE CALL (1-800-28-898) NOT LESS THAN 48 HOURS BEFORE EXCAVATION, EXCLUDING WEEKENDS AND LEGAL HOLIDAYS.
- 6. THE LOCATION OF EXISTING UNDERGROUND UTILITIES AND ROCK ELEVATIONS ARE SHOWN IN AN APPROXIMATE WAY ONLY AND HAVE NOT BEEN INDEPENDENTLY VERIFIED BY THE OWNER OR ITS REPRESENTATIVE. THE CONTRACTOR SHALL DETERMINE THE EXACT LOCATION OF ALL EXISTING UTILITIES AND ROCK ELEVATIONS BEFORE COMMENCING WORK, AND AGREES TO BE FULLY RESPONSIBLE FOR ANY AND ALL DAMAGES WHICH MIGHT BE OCCASIONED BY THE CONTRACTOR'S FAILURE TO LOCATE AND PRESERVE ANY AND ALL UNDERGROUND UTILITIES AND ROCK ELEVATIONS.
- 7. THE CONTRACTOR SHALL VISIT THE SITE AND INSPECT THE PROJECT AREA AND BECOME THOROUGHLY FAMILIAR WITH THE ACTUAL JOB CONDITIONS PRIOR TO BIDDING AND THE START OF ANY WORK. FAILURE TO VISIT THE SITE SHALL NOT RELIEVE THE CONTRACTOR FROM PERFORMING THE WORK IN ACCORDANCE WITH THESE DRAWINGS.
- 8. THE CONTRACTOR SHALL VERIFY AT THE SITE, ALL DIMENSIONS AND CONDITIONS SHOWN ON THE DRAWINGS, AND SHALL NOTIFY THE ENGINEER OF ANY DISCREPANCIES, OMISSIONS, AND/OR CONFLICT PRIOR TO PROCEEDING WITH THE WORK.
- 9. THE CONTRACTOR SHALL NOT SCALE DRAWINGS. DIMENSIONS SHALL GOVERN. LARGE SCALE DRAWINGS SHALL GOVERN OVER SMALL SCALE DRAWINGS. NOTES AND DETAILS ON THE DRAWINGS SHALL APPLY TO ALL SIMILAR CONDITIONS WHETHER THEY ARE REPEATED OR NOT.
- 10. THE CONTRACTOR SHALL BE RESPONSIBLE FOR ANY DAMAGE TO EXISTING FACILITIES OUTSIDE THE CONSTRUCTION LIMITS RESULTING FROM NEGLIGENCE.
- 11. CONTRACTOR SHALL PROTECT EXISTING FACILITIES, BUILDINGS, AND OTHER APPURTENANCES NOT TO BE REMOVED FROM THE SITE DURING THE CONSTRUCTION ACTIVITIES.
- 12. CONTRACTOR SHALL CONFINE HIS WORK TO THE CONSTRUCTION LIMITS AND EASEMENTS. IF THE CONTRACTOR OBTAINS ADDITIONAL EASEMENT FOR THE STORAGE OF EQUIPMENT AND MATERIALS, COPIES OF THE AGREEMENTS WITH THE PROPERTY OWNERS SHALL BE PROVIDED TO THE OWNER.
- 13. CONTRACTOR SHALL SUBMIT A DETAILED CONSTRUCTION SCHEDULE AND STAGING PLAN A MINIMUM OF TWO (2) DAYS PRIOR TO THE PRECONSTRUCTION MEETING.
- 14. CONTRACTOR SHALL BE RESPONSIBLE TO MAINTAIN ACCESS TO INDIVIDUAL PROPERTIES DURING CONSTRUCTION WHENEVER PRACTICAL. CONTRACTOR SHALL NOTIFY RESIDENTS OF ACCESS RESTRICTIONS MINIMUM OF 24 HOURS PRIOR TO REMOVAL OF EXISTING ACCESS.
- 15. CONTRACTOR SHALL SUBMIT FOR ACCEPTANCE WORK PLANS AND SCHEDULES FOR ACCOMPLISHMENT OF TEMPORARY AND PERMANENT EROSION CONTROL PRIOR TO THE START OF CONSTRUCTION.
- 16. CONTRACTOR SHALL COORDINATE TEMPORARY DISRUPTION OF UTILITY SERVICES WITH THE CITY OF OELWEIN, AFFECTED UTILITY COMPANIES AND/OR AFFECTED PROPERTY OWNERS WHEN RELOCATING EXISTING FACILITIES, CONNECTING TO EXISTING FACILITIES AND PLACING NEW SERVICES.

ESTIMATED QUANTITIES

NO.	CODE	DESCRIPTION	QUANTITY	UNIT
1	2010-D-3	TOPSOIL, OFF-SITE, 10" THICK	68.00	CY
2	2010-E	EXCAVATION, CLASS 10	1565.00	CY
3	2010-I	SUBGRADE TREATMENT, ENGINEERING FABRIC	189.50	SY
4	2010-J	SUBBASE, CRUSHED STONE, MODIFIED	1810.75	TON
5	2010-999-A	CRUSHED STONE, SALVAGE AND PLACE	120.00	TON
6	2010-999-B	LANDSCAPE ROCK, 3/4" DIA	42.00	TON
7	4020-A-1	STORM SEWER, TRENCHED, DUAL WALL HDPE, 8" DIA.	36.00	LF
8	4020-A-1	STORM SEWER, TRENCHED, DUAL WALL HDPE, 10" DIA.	85.00	LF
9	6010-B	INTAKE, SW-512, 24" DIA, WITH PCC BOXOUT	1.00	EA
10	6010-B	INTAKE, SW-512, 12" DIA	1.00	EA
11	6010-G	CONNECTION TO EXISTING INTAKE	1.00	EA
12	7010-A	PAVEMENT, PCC, REINFORCED, 8" THICK	40.60	SY
13	7010-A	PAVEMENT, PCC, REINFORCED, 7" THICK	93.30	SY
14	7010-E	CURB AND GUTTER, PCC, 2'+/- WIDE, 8" THICK	162.50	LF
15	7020-В	PAVEMENT, ASPHALT, 4" THICK	2785.20	SY
16	7030-A	REMOVAL OF SIDEWALK	211.10	SY
17	7030-E	SIDEWALK, PCC, REINFORCED, 6" THICK	301.90	SY
18	7030-F	BRICK/PAVER SIDEWALK BAND, SALVAGE AND REPLACE	1.00	LS
19	7030-G	DETECTABLE WARNING	22.00	SF
20	7040-H	PAVEMENT REMOVAL	2605.60	SY
21	7040-I	CURB AND GUTTER REMOVAL	15.00	LF
22	7999-A	WHEEL STOP	29.00	EA
23	8020-B	PAINTED PAVEMENT MARKINGS, SOLVENT/WATERBORNE	1.00	LS
24	8030-A	TEMPORARY TRAFFIC CONTROL	1.00	LS
25	8040-A	TRAFFIC SIGNS	6.00	EA
26	9010-A	CONVENTIONAL SEEDING, FERTILIZING, AND MULCHING	0.09	AC
27	11,020-A	MOBILIZATION	1.00	LS

FEHR GRAHAM

ENGINEERING & ENVIRONMENTAL

ILLINOIS IOWA WISCONSIN

OWNER/DEVELOPER:

CITY OF OELWEIN

20 2ND AVE. SW

OELWEIN, IOWA 50662

PROJECT AND LOCATION:

OELWEIN EVENT CENTER PARKING
LOT IMPROVEMENTS

OELWEIN, IOWA

DRAWN BY: LTF
APPROVED BY: JSB
DATE: JULY 2023
SCALE: AS NOTED

`		DE 4010110	
1		REVISIONS	
	REV. NO.	DESCRIPTION	DATE

GENERAL NOTES AND ESTIMATED QUANTITIES

SET TYPE: BID SET 6:\C30\23\23-500\Plans\23-500 Plans.dwg, C.01 JOB NUMBER: 23-500
SHEET NUMBER:

C.01

PLOT DATE: 7/18/23 © 2023 FEHR GRAHAM

SECTION 1010

1.03 — DEFINITIONS AND TERMS
JURISDICTION: THE JURISDICTION IS THE CITY OF OELWEIN. ANY REFERENCE TO EITHER SHALL BE CONSIDERED ONE IN
THE SAME.
SECTION 1020

1.14 — OPENING OF PROPOSALS
ONLY BID TOTALS WILL BE MADE PUBLICLY AVAILABLE AT AND IMMEDIATELY AFTER THE BID OPENING AN ITEMIZED BID.

1.14 — OPENING OF PROPOSALS
ONLY BID TOTALS WILL BE MADE PUBLICLY AVAILABLE AT AND IMMEDIATELY AFTER THE BID OPENING. AN ITEMIZED BID
TABULATION WILL BE MADE PUBLICLY AVAILABLE FOR INTERESTED PARTIES AFTER THE PROJECT HAS BEEN AWARDED BY

TABULATION WILL BE WADE. 1921.
THE OWNER.
SECTION 1030

1.02 — RELEASE OF BID SECURITY
A. THE JURISDICTION SHALL RETAIN THE BID SECURITY OF THE LOWEST THREE BIDDERS. THE BID SECURITIES OF THE
THREE LOWEST BIDDERS WILL BE RELEASED AFTER THE JURISDICTION'S APPROVAL OF THE CONTRACT EXECUTED BY THE
LOWEST RESPONSIVE, RESPONSIBLE BIDDER.

SOUND PRICES OF BID SECURITY
A. THE JURISDICTION SHALL RETAIN THE BID SECURITY OF THE LOWEST THREE BIDDERS. THE BID SECURITIES OF THE
THREE LOWEST RESPONSIVE, RESPONSIVE RESPONSIVE, RESPONSIVE R

COOPERATION BY THE CONTRACTOR - SPECIAL ATTENTION TO THIS SECTION IS REQUESTED OF ALL BIDDING

CONTRACTORS

1.10 - LINE AND GRADE STAKES

1.10 - LINE AND GRADE STAKES

A. THE CONTRACTOR IS REQUIRED TO PROVIDE MINIMUM OF TWO BUSINESS DAYS' NOTICE TO THE ENGINEER WHEN REQUESTING STAKES.

1.12 - SALVAGE

1.12 — SALVAGE

A. ALH ASPHALT SURFACING SHALL BE HAULED TO THE CITY OF OELWEIN PUBLIC WORKS FACILITY AT 4TH STREET SW AND 7 HAVENUE SW. ALL OTHER MATERIALS REMOVED SHALL BECOME PROPERTY OF THE CONTRACTOR TO PROPERLY DISPOSE OF.

SECTION 1060

1.04 — STORAGE OF MATERIALS
THE PROJECT LOCATION MAY BE USED AS A STAGING AREA FOR STORAGE OF EQUIPMENT AND MATERIALS FOR THIS PROJECT. OTHER AREAS USED BY THE CONTRACTOR SHALL BE RETURNED TO A CONDITION SIMILAR TO THAT PRIOR TO CONSTRUCTION. THIS INCLUDES, BUT IS NOT LIMITED TO: SMOOTHING ANY REMOVING ALL TRASH AND DEBRIS, RESEEDING THE AREA, AND REPLACING ANY DAMAGED SURFACING. NO PAYMENT WILL BE MADE FOR WORK OR MATERIALS REQUIRED TO RETURN STAGING AREA TO PRECONSTRUCTION CONDITION.

REQUIRED TO RETURN STAGING AREA TO PRECONSTRUCTION CONDITION.

REQUIRED TO RETURN STAGING AREA TO PRECONSTRUCTION CONDITION.

2.02 — CONVENIENCE AND SAFETY — SPECIAL ATTENTION TO THIS SECTION IS REQUESTED OF ALL BIDDING CONTRACTORS C. WORK SHALL BE COMPLETED IN A MANNER THAT WILL CAUSE THE LEAST INCONVENIENCE AND ANNOYANCE TO THE PUBLIC AND PROPERTY OWNERS ABUTTING THE WORK AREA AND SHALL PROVIDE ACCESS TO THE ABUTTING PROPERTY TO THE GREATEST EXTENT PRACTICABLE. CONTRACTOR SHALL NOTIFY PROPERTY OWNERS A MINIMUM OF 48 HOURS IN ADVANCE WHEN ACCESS WILL BE RESTRICTED TO THEIR PROPERTIES.

2.06 — TRAFFIC CONTROL

A. 3. TRAFFIC CONTROL SHALL BE PAID FOR BY LUMP SUM AS SPECIFIED IN SECTION 8030 AND SHALL INCLUDE ANY AND ALL TRAFFIC CONTROL USED ON THE PROJECT AS OUTLINED IN SECTION 8030, INCLUDING BUT NOT LIMITED TO FLAGGERS, PILOT CARS, SIGNS, BARRICADES, SAFETY CLOSURES, ETC., IF NECESSARY. THE CONTRACTOR SHALL TAKE FULL RESPONSIBILITY FOR TRAFFIC CONTROL AND HOLD BOTH THE JURISDICTION AND THE JURISDICTIONAL ENGINEER HARMLESS.

2.13 — BORROW AND WASTE SITES

A. CONTRACTOR SHALL SECURE AND OPERATE, AT ITS OWN EXPENSE, SITES FOR DISPOSAL OF CLASS 12 ROCK EXCAVATION, STRUCTURES, PCC, AND RUBBISH AND DEBRIS. CONTACT FOR POSSIBLE ACCEPTANCE OF PCC: GREG BRYAN, CELL 319.239.1336. GREG WILL HAVE A DISPOSAL FEE, DISCUSS WITH HIM PRIOR TO PREPARING BID.

3.01 — PERFORMANCE, PAYMENT, AND MAINTENANCE BOND

B. PRODUCTS AND COMPLETED OPERATIONS SHALL BE MAINTAINED FOR THE DURATION OF THE WORK; AND SHALL BE FURTHER MAINTAINED FOR A MINIMUM PERIOD OF TWO (2) YEARS AFTER FINAL ACCEPTANCE AND PAYMENT.

3.02 — INSURANCE REQUIREMENTS

FURTHER MAINTAINED FOR A MINIMUM PERIOD OF TWO (2) YEARS AFTER FINAL ACCEPTANCE AND PAYMENT.
3.02 — INSURANCE REQUIREMENTS
C. 2. J. NOT APPLICABLE.
6. ADDITIONAL INSURED ENDORSEMENTS —
c. SEE SECTION 1070, PART 3.06 FOR INFORMATION ON ALL REQUIRED ENDORSEMENTS WHICH INCLUDE NAMING OF THE JURISDICTION AS AN ADDITIONAL INSURED, CANCELLATION AND MATERIAL CHANGE ENDORSEMENT, AND NONWAIVER OF GOVERNMENTAL IMMUNITY.
3.05 — PROPERTY INSURANCE — NOT APPLICABLE
SECTION 1080

1.02 — CONTRACT TIME
A. 3. CONTRACTOR SHALL FULLY COMPLETE THE PROJECT BY OCTOBER 27, 2023.
SECTION 1090
1.05 — PROGRESS PAYMENTS
D. PARTIAL PAY ESTIMATES SHALL BE SUBMITTED BY THE CONTRACTOR TO THE ENGINEER BY THE THURSDAY FOLLOWING THE LAST SATURDAY OF THE MONTH FOR WORK COMPLETED THROUGH THE LAST SATURDAY OF THE MONTH.

DIVISION 2 - EARTHWORK

SECTION 2010

1.03 - SUBMITTALS
A. THE JURISDICTIONAL ENGINEER HEREBY REQUESTS THAT ALL MATERIALS TO BE INCORPORATED INTO THE WORK HAVE CERTIFICATIONS FURNISHED WHICH SHOW THAT .THE MATERIALS COMPLY WITH SPECIFICATIONS PRIOR TO ANY CONSTRUCTION.

CONSTRUCTION.

1.08 — MEASUREMENT AND PAYMENT
D. 3.A. THICKNESS SHALL BE AS SPECIFIED ON PLANS.
E. 1.B. NO ADDITIONAL MEASUREMENTS WILL BE MADE; PAYMENT QUANTITY SHALL BE PLAN QUANTITY.
1.c. ESTIMATES OF EARTHWORK FOR THE PROJECT ARE AS FOLLOWS: FILL REQUIRED (SHRINKAGE FACTOR OF 1.3 USED IN CALCULATING) — 0 CY; CUT MATERIAL — 1565 CY; BALANCE — 1565 CY EXCESS (WASTE). CONTRACTOR SHALL BE RESPONSIBLE FOR THE PROPER REMOVAL AND DISPOSAL OF THE EXCESS EXCAVATED MATERIAL. THE VOLUME IS CALCULATED BETWEEN THE DATUM SURFACE AND THE EXISTING SURFACE WITH THE EXISTING PAVEMENT VOLUME DEDUCTED. THE DATUM SURFACE IS THE TOP OF PROPOSED SUBGRADE.
3. E. NO ADDITIONAL PAYMENT WILL BE MADE FOR HAULING OF SALVAGED EXCAVATED MATERIAL, AS NOTED IN SECTION 1050, 1.12, AS IT SHALL BE INCIDENTAL TO CLASS 10 EXCAVATION.
3. F. EXCAVATION SHALL INCLUDE SUBGRADE PREPARATION AT NO ADDITIONAL COST.
3. G. CONTRACTOR TO COMPLETE PROOF ROLLING AS REQUIRED IN PART 3.06, B. NO ADDITIONAL PAYMENT WILL BE MADE FOR PROOF ROLLING, AS IT SHALL BE INCIDENTAL TO THE EXCAVATION BID ITEM.
G. 2. NO SEPARATE PAYMENT SHALL BE MADE FOR SUBGRADE PREPARATION AS IT SHALL BE INCIDENTAL TO THE EXCAVATION.
IS UBGRADE TREATMENT:

EXUAVATION.
SUBGRADE TREATMENT:
MEASUREMENT: THE FOOTPRINT AREA OF THE LANDSCAPE ROCK WILL BE MEASURED IN SQUARE YARDS.
INCLUDES: ALSO INCLUDES ANCHORS FOR FABRIC.
SUBBASE:

3. INCLUDES: ALSO INCLUDES ANCHORS FOR FABRIC.

J. SUBBASE:

1. MEASUREMENT SHALL BE BY THE TON OF MATERIAL PLACED BASED ON WEIGHT TICKETS. PLACEMENT BEYOND THAT INDICATED IN THE PLANS OR AS DIRECTED BY THE ENGINEER WILL BE MEASURED AND CONVERTED TO TONS USING A FACTOR OF 140 LBS./CU.FT. AND DEDUCTED FROM THE WEIGHT INDICATED BY THE TICKET TOTALS. MODIFIED SUBBASE, IDOT GRADATION #14. SHALL BE USED.

999—A CRUSHED STONE, SALVAGE AND PLACE

0. MEASUREMENT: CRUSHED STONE SALVAGED AND PLACED SHALL BE MEASURED IN TONS BASED ON AREA AND THICKNESS AND UNIT WEIGHT OF 140 LB/CUBIC FOOT.

10. PAYMENT: PAYMENT WILL BE AT THE UNIT PRICE PER TON FOR THE FOR THE QUANTITY OF CRUSHED STONE SALVAGED AND PLACED.

10. INCLUDES: WORK INCLUDES, BUT IS NOT LIMITED TO, REMOVAL OF CRUSHED STONE, STOCKPILE ON SITE, PLACEMENT AND COMPACTION AS PAVING BASE.

999—B LANDSCAPE ROCK, ¾* DIA.

10. MEASUREMENT: MEASUREMENT WILL BE IN TONS FOR THE QUANTITY OF GRANULAR STABILIZATION MATERIAL REQUIRED FOR THE AREA AND THICKNESS INDICATED ON THE PLANS.

10. PAYMENT: PAYMENT WILL BE AT THE UNIT PRICE PER TON FOR THE FOR THE QUANTITY OF LANDSCAPE ROCK FURNISHED AND PLACED.

11. INCLUDES: WORK INCLUDES, BUT IS NOT LIMITED TO, FURNISHING AND PLACING LANDSCAPE ROCK TO FINISHED GRADE. PRODUCT SHALL BE ATTHE UNIT PRICE PER TON FOR THE FOR THE QUANTITY OF LANDSCAPE ROCK FURNISHED AND PLACED.

12. INCLUDES: WORK INCLUDES, BUT IS NOT LIMITED TO, FURNISHING AND PLACING LANDSCAPE ROCK TO FINISHED GRADE. PRODUCT SHALL BE RIVER ROCK, DECORATIVE, WITH NO STONES LARGER THAN ¾** DIAMETER. MATERIAL SHALL BE APPROVED BY OWNER PRIOR TO DELIVERY. PROVIDE MINIMUM 10 LB. SAMPLE FOR APPROVAL.

12. OLD THE ARBITC BELOWED AND ALABISCAPE POOCY.

13. CSUDERVILLES: COMPLY WITH IDOT STANDARD SPEC. TABLE 4196.01—3 (FABRIC FOR USE AS EMBANKMENT EROSION CONTENT).

C. SUBGRADE TREATMENT:

6. GEOTEXTILES: COMPLY WITH IDOT STANDARD SPEC. TABLE 4196.01-3 (FABRIC FOR USE AS EMBANKMENT EROSION CONTROL) FOR FABRIC BELOW LANDSCAPE ROCK.

3.04 - EMBANKMENT CONSTRUCTION

E. TYPE A COMPACTION REQUIRED FOR ALL EMBANKMENT CONSTRUCTION AND SUBGRADE PREPARATION.

3.06 - SUBGRADE PREPARATION

A. A DISK OF THE SIZE INDICATED IN SECTION 2010, PART 3.04, C. 4 SHALL BE USED TO TURN AND MIX ALL SOILS IN CUT OR FILL SECTIONS. TYPE A COMPACTION REQUIRED FOR ALL SUBGRADE PREPARATION.

DIVISION 3 - TRENCH AND BACKFILL

DIVISION 3 — TRENCH AND BACKFILL

SECTION 3010

1.03 — SUBMITTALS

B. RESULTS OF STANDARD PROCTOR AND IN-PLACE DENSITY TESTS WILL NOT BE REQUIRED.

2.02 — BEDDING MATERIAL

A. 1. USE CLEAN STONE FOR PIPE ENVELOPE IN WET TRENCH OR AS DIRECTED BY THE ENGINEER. IOWA DOT GRADATION NO. 11, 12 OR 31 SHALL BE USED FOR PIPE ENVELOPE IN DRY TRENCH UNLESS OTHERWISE DIRECTED BY THE ENGINEER. CONTRACTOR SHALL NOTE ON WEIGH TICKETS USE OF MATERIAL AND SHALL STOCKPILE SEPARATE FROM STREET SUBBASE.

3.05 — PIPE BEDDING AND BACKFILL
PIPE EMBEDMENT REQUIREMENTS FOR RIGID GRAVITY PIPE:
RCP: CLASS R-1

RCAP AND RCEP: CLASS R-5
PIPE EMBEDMENT REQUIREMENTS FOR FLEXIBLE GRAVITY PIPE:
DIP: CLASS F-1,
PVC TRUSS PIPE AND DR18: CLASS F-2
HDPE SINGLE & DUAL WALL, PVC GRAVITY PIPE (SDR 23.5, 26, 35): CLASS F-3
PIPE EMBEDMENT REQUIREMENTS FOR PRESSURE PIPE:
DIP: CLASS P-1

PVC DR18: CLASS P-3

3.07 — DRAINAGE TILE FEPAIR
CONTRACTOR SHALL REPAIR ANY DRAINAGE TILE DAMAGED BY TRENCHING OPERATIONS. DAMAGED DRAINAGE TILE SHALL BE REPAIRED WITH SCHEDULE 40 PVC OF THE SAME NOMINAL INTERIOR DIAMETERS AT THE EXISTING DRAINAGE TILE. A MINIMUM 2' LENGTH OF PIPE ON EACH SIDE OF THE TRENCH SHALL BE PLACED ON UNDISTURBED GROUND. PVC REPAIR SECTION SHALL BE ABUTTED TO EXISTING TILE ENDS WITH 1/8" MAXIMUM JOINT SPACING AND JOINT WRAPPED WITH SENGING FRANCE TILE SHALL BE REPAIRED. TRENCH BACKFILL BELOW TILE REPAIR SHALL BE PLACED ON UNDISTURBED GROUND. PVC REPAIR SECTION SHALL BE ABUTTED TO EXISTING TILE ENDS WITH 1/8" MAXIMUM JOINT SPACING AND JOINT WRAPPED WITH ENCINEERING FABRIC. TRENCH BACKFILL BELOW TILE REPAIR SHALL BE COMPACTED TO 95% STANDARD PROCTOR DENSITY. GRANULAR PIPE ENVELOPE WILL NOT BE REQUIRED FOR TILE REPAIR. DRAINAGE TILE SHALL BE REPLACED SO THAT THE FRONCH PREPENDICULAR PLUS OR MINUS 70 DEGREES TO THE TRENCH BACK FILL BELOW TILE REPAIRS WITH TILE CROSSING TRENCH PERPENDICULAR PLUS OR MINUS 70 DEGREES TO THE TRENCH AND ALIGNMENT IS RESTORED. CONTRACTOR DASINAGE TILE CROSSING WITHIN 20 DEGREES OF PARALLEL TO THE TRENCH SHALL HAVE A SEPAR

DIVISION 4 - SEWERS AND DRAINS

SECTION 4020

1.03 — SUBMITTALS
A. THE JURISDICTIONAL ENGINEER HEREBY REQUESTS THAT ALL MATERIALS TO BE INCORPORATED INTO THE WORK HAVE CERTIFICATIONS FURNISHED WHICH SHOW THAT THE MATERIALS COMPLY WITH SPECIFICATIONS PRIOR TO ANY CONSTRUCTION.

1.08 — MEASUREMENT AND PAYMENT
A. 1. A. MEASURE EACH SIZE AND TYPE OF PIPE INSTALLED FROM INSIDE WALL OF INTAKE/MANHOLE TO INSIDE WALL OF INTAKE/MANHOLE.

INTAKE, MAINTIOLE.

2.01 — STORM SEWERS

A. 2. STORM SEWER MAIN TO BE DUAL WALL HDPE.

DIVISION 6 - STRUCTURES FOR SANITARY AND STORM

SECTION 6010

1.03 — SUBMITTALS
THE JURISDICTIONAL ENGINEER HEREBY REQUESTS THAT ALL MATERIALS TO BE INCORPORATED INTO THE WORK HAVE CERTIFICATIONS FURNISHED WHICH SHOW THAT THE MATERIALS COMPLY WITH SPECIFICATIONS PRIOR TO ANY CONSTRUCTION.

1.08 — MEASUREMENT AND PAYMENT
B. 3. ALSO INCLUDES 5' X 5' PCC BOXOUT PER SUDAS DETAIL PV-103 FOR ONE INTAKE AS SPECIFIED AND PER BID ITEM. OTHER INTAKE DOES NOT REQUIRE PCC BOXOUT.

DIVISION 7 - STREETS & RELATED WORK

SECTION 7010 1.03 - SUBMITTALS

CITY OF OELWEIN 20 2ND AVE. SW OELWEIN, IOWA 50662 PROJECT AND LOCATION

OELWEIN EVENT CENTER PARKING LOT IMPROVEMENTS OELWEIN, IOWA

DRAWN BY: LTF APPROVED BY: JSB DATE: JULY 2023 SCALE: AS NOTED

REVISIONS DATE SUPPLEMENTAL SPECIFICATIONS

ALL SUBMITTALS LISTED IN THE STANDARD SPECIFICATIONS SHALL BE PROVIDED.

D. CERTIFIED PLANT INSPECTION BY THE CONTRACTOR IS NOT REQUIRED ON THIS PROJECT.

STANDARD IOWA DOT PLANT REPORT FORMS SHALL BE COMPLETED BY THE CONTRACTOR/SUPPLIER AND SUBMITTED TO THE JURISDICTIONAL ENGINEER WEEKLY, IOWA DOT STANDARD FORM 830212 FOR READY MIX CONCRETE (LOAD TICKETS) SHALL BE COMPLETED FOR EACH LOAD FOR COLLECTION AT THE GRADE.

1.08 — MEASUREMENT AND PAYMENT

E. 3. INCLUDES RT JOINT FOR CONNECTION TO ADJACENT PCC.

1. 1. CONTRACTOR WILL NOT BE REQUIRED TO PERFORM PLASTIC CONCRETE TESTING. AIR, SLUMP, CYLINDERS, AND/OR BEAMS TO BE COMPLETED BY THE JURISDICTIONAL ENGINEER. CONTRACTOR SHALL PROVIDE MATERIALS FOR THESE TESTS.

2. NO ADDITIONAL PAYMENT WILL BE MADE FOR MATURITY TESTING, AS THIS SHALL BE INCIDENTAL TO THE PCC PAYEMENT BID ITEM.

3. JURISDICTIONAL ENGINEER RESERVES THE RIGHT TO REQUIRE THICKNESS CORES IF PAYING OPERATIONS OR EDGE THICKNESS INDICATE A THICKNESS DEFICIENCY. IF CORES NOT REQUIRED, THIS BID ITEM WILL BE DELETED.

THICKNESS INDICATE A THICKNESS DEFICIENCY. IF CORES NOT REQUIRED, THIS BID ITEM WILL BE DELETED.

2.01 - MATERIALS

J. 1. CLASS 3 DURABILITY ONLY FOR THIS PROJECT.
H. ALL METALLIC BARS SHALL BE EPOXY COATED WITH CUT ENDS SEALED.

2.02 - MIX DESIGN
A. 1. MINIMUM COMPRESSIVE STRENGTH SHALL BE 4,500 PSI AT 28 DAYS. CONTRACTOR MAY USE CLASS M, C-SUD, OR CV-SUD MIXES, BUT NO ADDITIONAL PAYMENT SHALL BE MADE FOR THESE MIXES.

SECTION 7020

1.03 - SUBMITTALS
ALL SUBMITTALS
ALL SUBMITTALS
ALL SUBMITTALS
ALL SUBMITTALS
ALL SUBMITTALS

A. 1. MINIMUM COMPRESSIVE STRENGTH SHALL BE 4.500 PSI AT 28 DAYS. CONTRACTOR MAY USE CLASS M, C-SUD, OR CV-SUD MIXES, BUT NO ADDITIONAL PAYMENT SHALL BE MADE FOR THESE MIXES.

SECTION 7020

1.03 - SUBMITTALS

ALL SUBMITTALS LISTED IN THE STANDARD SPECIFICATIONS SHALL BE PROVIDED.

2.01 - ASPHALT MATERIALS

A. USE THE FOLLOWING MATERIALS FOR THE BASE AND SURFACE COURSE:

1. BASE (2.5° THICK): HMA STANDARD TRAFFIC (ST), 3/4", PG 58-28S

2. SURFACE (1.5" THICK): HMA STANDARD TRAFFIC (ST), ½", PG 58-28S

SECTION 7030

1.08 - MEASUREMENT AND PAYMENT

E. 3. INCLUDES FORY COATED REBAR AT DIMENSIONS SPECIFIED ON PLANS.

F. 1. MEASUREMENT SAND PAYMENT

E. 3. INCLUDES: UNIT PRICE INCLUDES, BUT IS NOT LIMITED TO, REMOVAL OF BRICKS IN GOOD CONDITION, STORAGE UNTIL REPLACED, FORMING OF NEW PCC FOR BRICK PATTERN (PCC BASE BELOW BRICK PAID WITH SIDEWALK ITEM), BRICK PLACEMENT, SAND JOINT FILL.

1. CONTRACTOR WILL NOT BE REQUIRED TO PERFORM PLASTIC CONCRETE TESTING. AIR, SLUMP, CYLINDERS, AND/OR BEAMS TO BE COMPLETED BY THE JURISDICTIONAL ENGINEER. CONTRACT CLOY SHALL PROVIDE MATERIALS FOR THESE TESTS WITH NO ADDITIONAL PAYMENT.

2.01 - PORTLAND CEMENT CONCRETE MIX

A. CLASS C, 4,560 PSI AT 28 DAYS COMPRESSIVE STRENGTH REQUIRED.

2.07 - DETECTABLE WARNINGS

A. DETECTABLE WARNINGS

B. S. ALL LENGALY, TO ALLOW SAWING WITHOUT RAVELING, MOVING OF AGGREGATE, OR SCUFFING THE FINISHED SURFACE, BUT WITHIN 24 HOURS OF PLACEMENT, JOINTS MAY BE SAWED AS SOON AS CONCRETE HAS HARDENED SUFFICIENTLY TO ALLOW SAWING WITHOUT RAVELING, MOVING OF AGGREGATE, OR SCUFFING THE FINISHED SURFACE, BUT WITHIN 24 HOURS OF PLACEMENT, JOINTS MAY BE SAWED WITH A 1/8 INCH BLADE SAW TO A DEPTH OF 1/3 THE PAYEMENT THICKNESS. USE A STRAIGHTEDGE IF JOINTS ARE SAWED WITH A HAND-HELD SAW.

B. B. S. ALL LINARDVERSE CONTRACTION JOINTS SHALL BE SAWED. JOINTS MAY BE SAWED WITH A 1/8 INCH BLADE TO A DEPTH OF 1/3 THE PAYEMENT THICKNESS. USE A STRAIGHTE

PLANS.

1. 3. INCLUDES ALSO FULL DEPTH SAW CUT 2' FROM BACK OF CURB AND AT BEGINNING AND END OF REMOVAL.

SECTION 7999

1.08 — MEASUREMENT AND PAYMENT

A. WHEEL STOP:

1. MEASUREMENT: EACH WHEEL STOP FURNISHED AND PLACED WILL BE COUNTED.

2. PAYMENT: PAYMENT WILL BE MADE AT THE CONTRACT UNIT PRICE FOR EACH WHEEL STOP PLACED.

3. INCLUDES: UNIT PRICE INCLUDES, BUT IS NOT LIMITED TO, PLACING AND ANCHORING WHEEL STOP. SHALL BE LOPE PLASTIC, INTEGRALLY COLORED YELLOW, 6' LONG (MIN.) X 5.75" WIDE (MIN.) X 4" TALL (MIN.).

ANCHORS SHALL BE MINIMUM 14" LONG GALVANIZED STEEL SPIKES.

SECTION 8020 — PAVEMENT MARKINGS

1.08 — MEASUREMENT AND PAYMENT

B. 1. MEASUREMENT: LUMP SUM MEASUREMENT; NO MEASUREMENT WILL BE MADE.

2. PAYMENT: PAYMENT WILL BE AT THE CONTRACT LUMP SUM PRICE.

3. INCLUDES: UNIT PRICE INCLUDES, BUT IS NOT LIMITED TO, LAYOUT, SURFACE PREPARATION, AND APPLICATION OF PAINT FOR PARKING STRIPES AND HANDICAP ACCESSIBLE PARKING SPACES AND NO PARKING AISLES/AREAS. PAINT COLOR SHALL BE WHITE.

SECTION 8040

1.08 — MEASUREMENT AND PAYMENT
A. TRAFFIC SIGNS BY EACH
1. MEASUREMENT: EACH SIGN LOCATION INSTALLED, REGARDLESS OF NUMBER OR SIZE OF SIGN, WILL BE COUNTED.
2. PAYMENT: PAYMENT WILL BE AT THE UNIT PRICE PER EACH SIGN LOCATION.
3. INCLUDES: UNIT PRICE INCLUDES, BUT IS NOT LIMITED TO, SIGN BLANK, APPLICATION OF REFLECTIVE SHEETING
(DIAMOND GRADE OR EQUAL) WITH SYMBOL/MESSAGE, ALL MOUNTING HARDWARE, PLACEMENT OF SIGN. SIGN POST SHALL BE SQUARE PERFORATED STEEL WITH BREAKAWAY BASE ANCHOR AND HARDWARE.

DIVISION 9 - SITE WORK & LANDSCAPING

SECTION 9010

1.02 - DESCRIPTION OF WORK
COMPLETED INSTALLATION SHALL INCLUDE PREPARATION OF THE SEEDBED, FURNISHING AND INSTALLING SEED, FERTILIZER
AND MULCH, MAINTENANCE, AND GUARANTEE FOR COMPLETED SEEDED AREAS.
1.07 - SPECIAL REQUIREMENTS
A. WARRANTY IS REQUIRED AND IS INCIDENTAL TO THE SEEDING BID ITEM. NO SEPARATE BID ITEM IS ALLOWED, WARRANTY
IS FOR ONLY PERMANENT SEEDING WITHIN THE DATES FOR EACH VARIETY SPECIFIED PER SECTION 9010, 2.02.
B. WARRANTY PERIOD IS TWO FULL YEARS FROM ACCEPTANCE.
1.08 - MEASUREMENT AND PAYMENT
A. 1. SEEDING FOR A COMPLETED INSTALLATION SHALL BE MEASURED IN ACRES, OF ACCEPTED SEEDING WITHIN THE
CONTRACT OR EASEMENT LIMITS. SEEDING ITEM INCLUDES SUPPLYING AND APPLYING PROPER SEED, FERTILIZER, AND
MULCH. DIFFERENT PAYMENT FOR METHOD OF APPLICATION WILL NOT BE ALLOWED. AT THE CONTRACTOR'S OPTION,
HYDRAULIC OR PNEUMATIC SEEDING MAY BE USED, BUT WILL NOT BE PAID SEPARATELY.
4. FERTILIZING SHALL BE INCIDENTAL TO THE SEEDING BID ITEM AND WILL NOT BE PAID SEPARATELY.
5. MULCHING SHALL BE INCIDENTAL TO THE SEEDING BID ITEM AND WILL NOT BE PAID SEPARATELY.
6. WARRANTY FOR SEEDING, FERTILIZING, AND MUHCHING IS REQUIRED BUT IS INCIDENTAL TO THE SEEDING BID ITEM.
WARRANTY PERIOD SHALL BE FOR TWO FULL YEARS FROM THE DATE OF ACCEPTANCE. NO SEPARATE BID ITEM IS
ALLOWED.
2.02 - SEED MIXTURES
ALL SEEDING SHALL BE TYPE 1 (PERMANENT LAWN MIXTURE).
3.08 - RE-SEEDING
A. WHEN ALL WORK RELATED TO SEEDING ON AN AREA HAS BEEN COMPLETED BUT IS WASHED OUT OR DAMAGED PRIOR
TO FINAL ACCEPTANCE OF THE SEEDING AREA, THE AREA SHALL BE RESECEDED, REFERTILIZED, AND REMULCHED
WITHOUT ADDITIONAL COMPENSATION.
3.10 - ACCEPTANCE AND WARRANTY.
B. TREQUIRED BUT INCIDENTAL TO THE SEEDING BID ITEM AND SHALL BE PAID SEPARATELY.
2. THE WARRANTY PERIOD IS TWENTY-FOUR MONTHS BEGINNING ON THE DATE OF ACCEPTANCE.

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ILLINOIS IOWA


WISCONSIN

SET TYPE: BID SET

SHEET NUMBER

JOB NUMBER

23-500

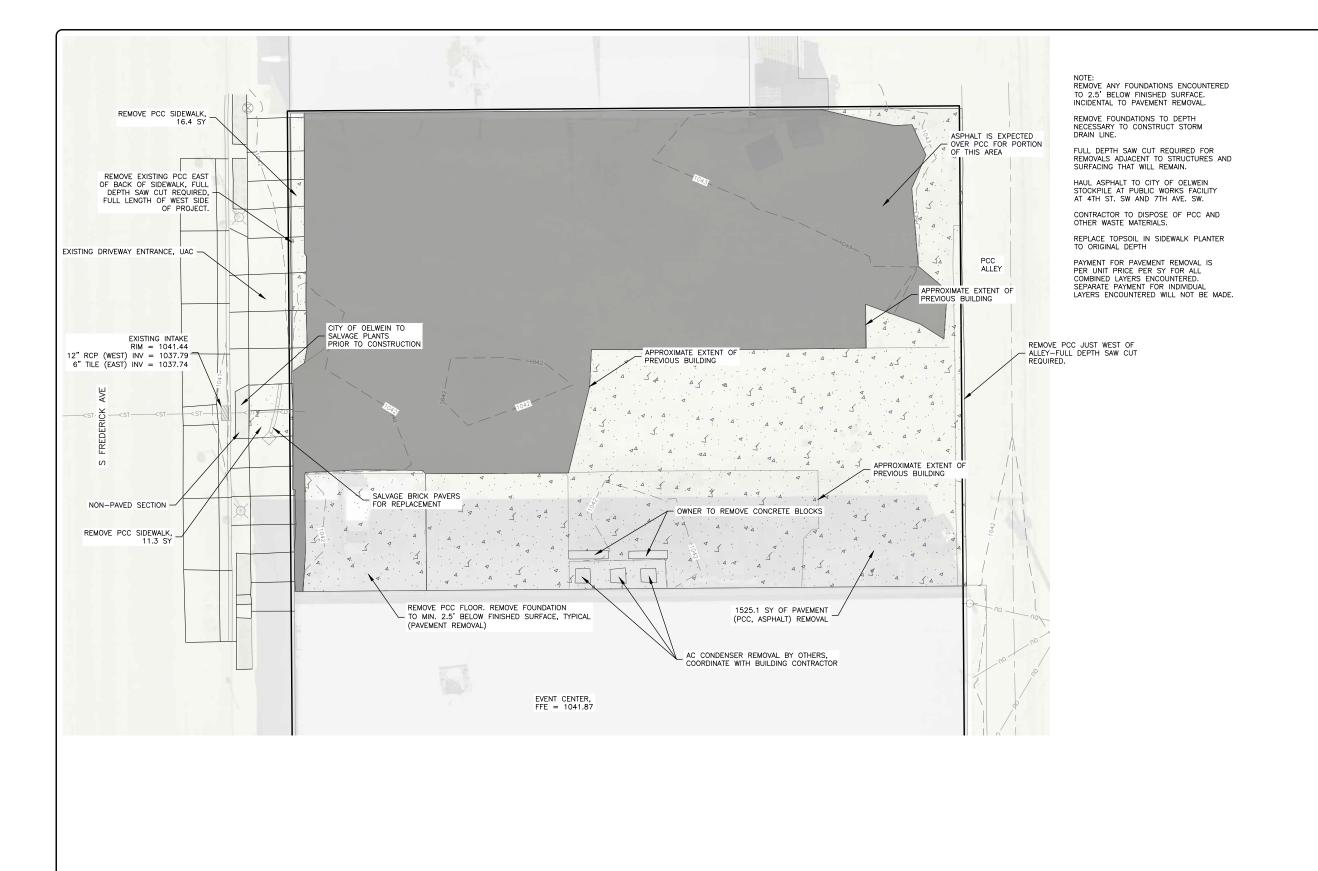

30 FEET 20

BM1♦

BM1 = 104+TOP NW BOLT LUM BASE (CP 1380) N-3713190.17, E-5348098.57, ELEV-1042.47

BM2 = $105+CUT \times TBC \text{ (CP1381)}$ N-3713370.86, E-5348081.52, ELEV-1042.96

BM3 = $105+CUT \times PCC \text{ (CP1382)}$ N-3713351.91, E-5347849.52, ELEV-1041.35

BM4 = 104+NW BOLT FH NOT BURY TAG (CP1666) N-3713252.61, E-5347898.71, ELEV-1042.42

FEHR GRAHA **ENGINEERING & ENVIRONMENTAL**

ILLINOIS IOWA WISCONSIN OWNER/DEVELOPER: CITY OF OELWEIN 20 2ND AVE. SW OELWEIN, IOWA 50662 PROJECT AND LOCATION: OELWEIN EVENT CENTER PARKING LOT IMPROVEMENTS OELWEIN, IOWA

DRAWN BY: LTF APPROVED BY: JSB DATE: JULY 2023 SCALE: AS NOTED

	REVISIONS	`
REV. NO.	DESCRIPTION	DATE


NORTH PARKING LOT EXISTING CONDITION AND REMOVAL PLANS

SET TYPE: BID SET

23-500 SHEET NUMBER:

JOB NUMBER:

C.03

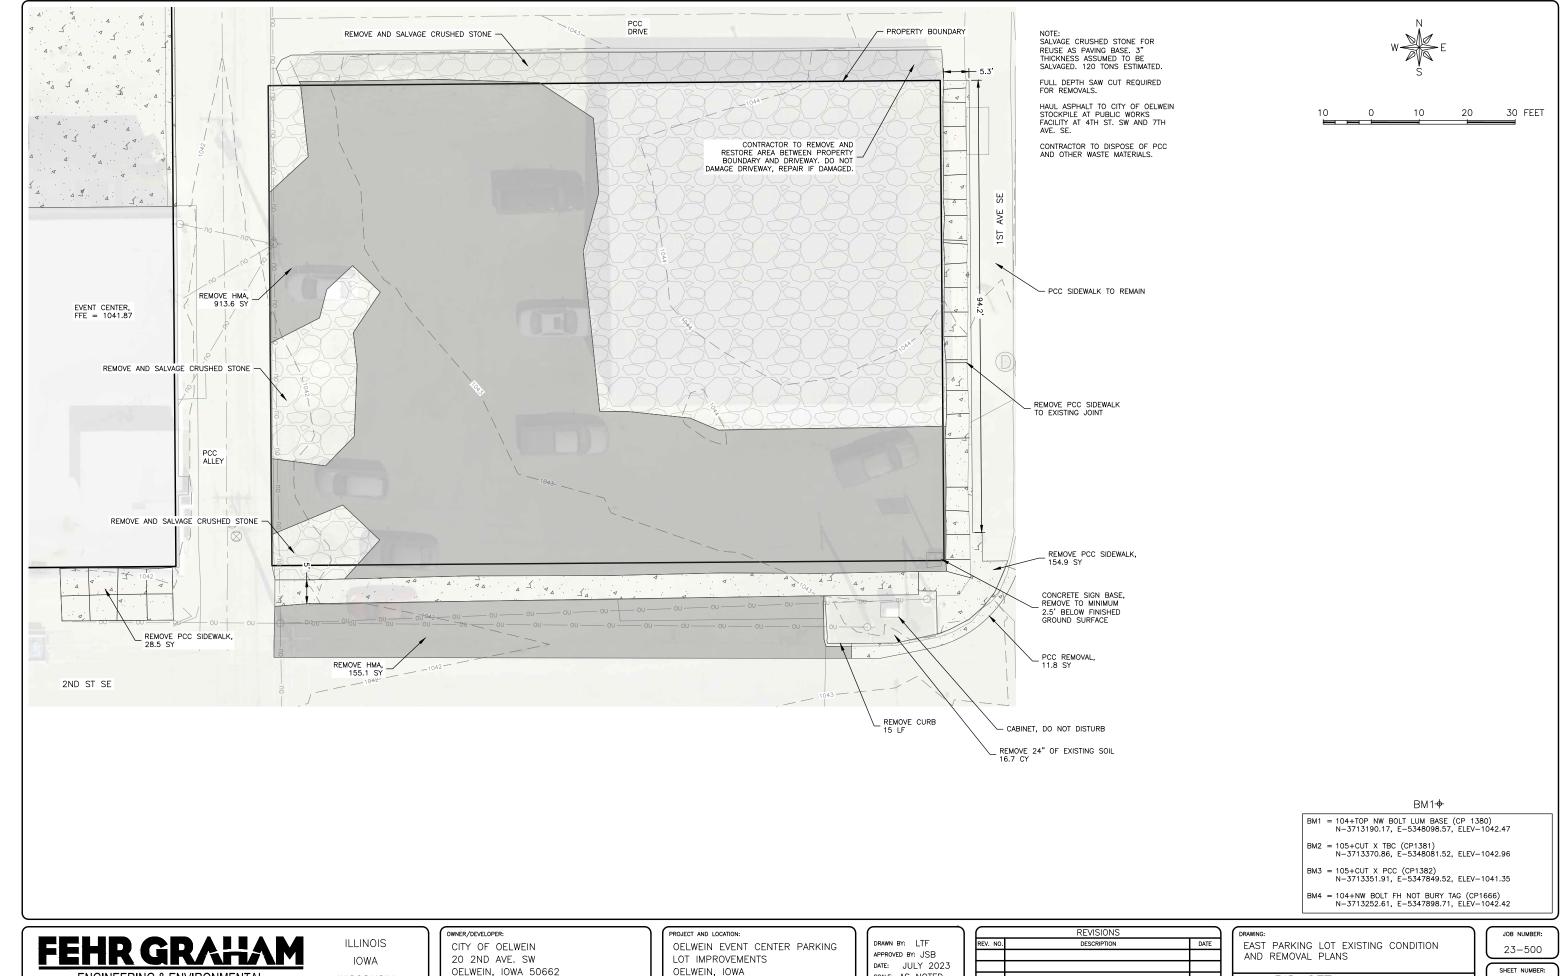

PLOT DATE: 7/18/23 © 2023 FEHR GRAHAM

ENGINEERING & ENVIRONMENTAL

WISCONSIN


OELWEIN, IOWA

DATE: JULY 2023 SCALE: AS NOTED

	REVISIONS					
REV. NO.	DESCRIPTION	DATE				

SET TYPE: BID SET

C.04

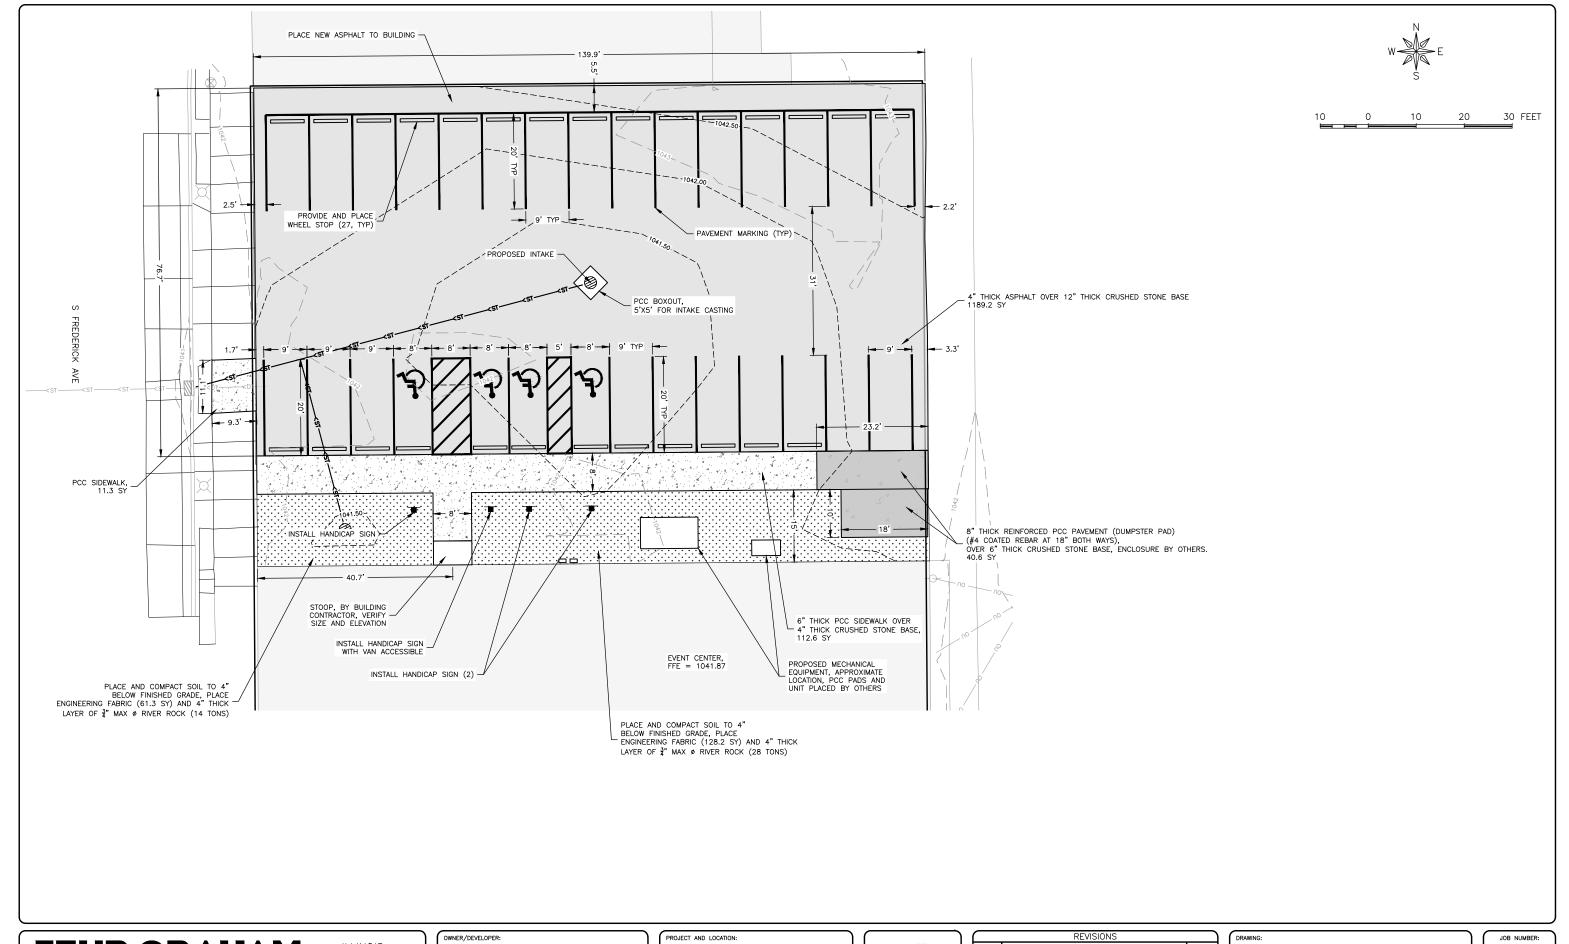

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ENGINEERING & ENVIRONMENTAL

ILLINOIS IOWA WISCONSIN OWNER/DEVELOPER:

CITY OF OELWEIN

20 2ND AVE. SW

OELWEIN, IOWA 50662

PROJECT AND LOCATION:

OELWEIN EVENT CENTER PARKING
LOT IMPROVEMENTS

OELWEIN, IOWA

DRAWN BY: LTF
APPROVED BY: JSB
DATE: JULY 2023
SCALE: AS NOTED


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NORTH PARKING LOT SITE PLAN


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23-500 SHEET NUMBER:

D.01



PLOT DATE: 7/18/23 © 2023 FEHR GRAHAM

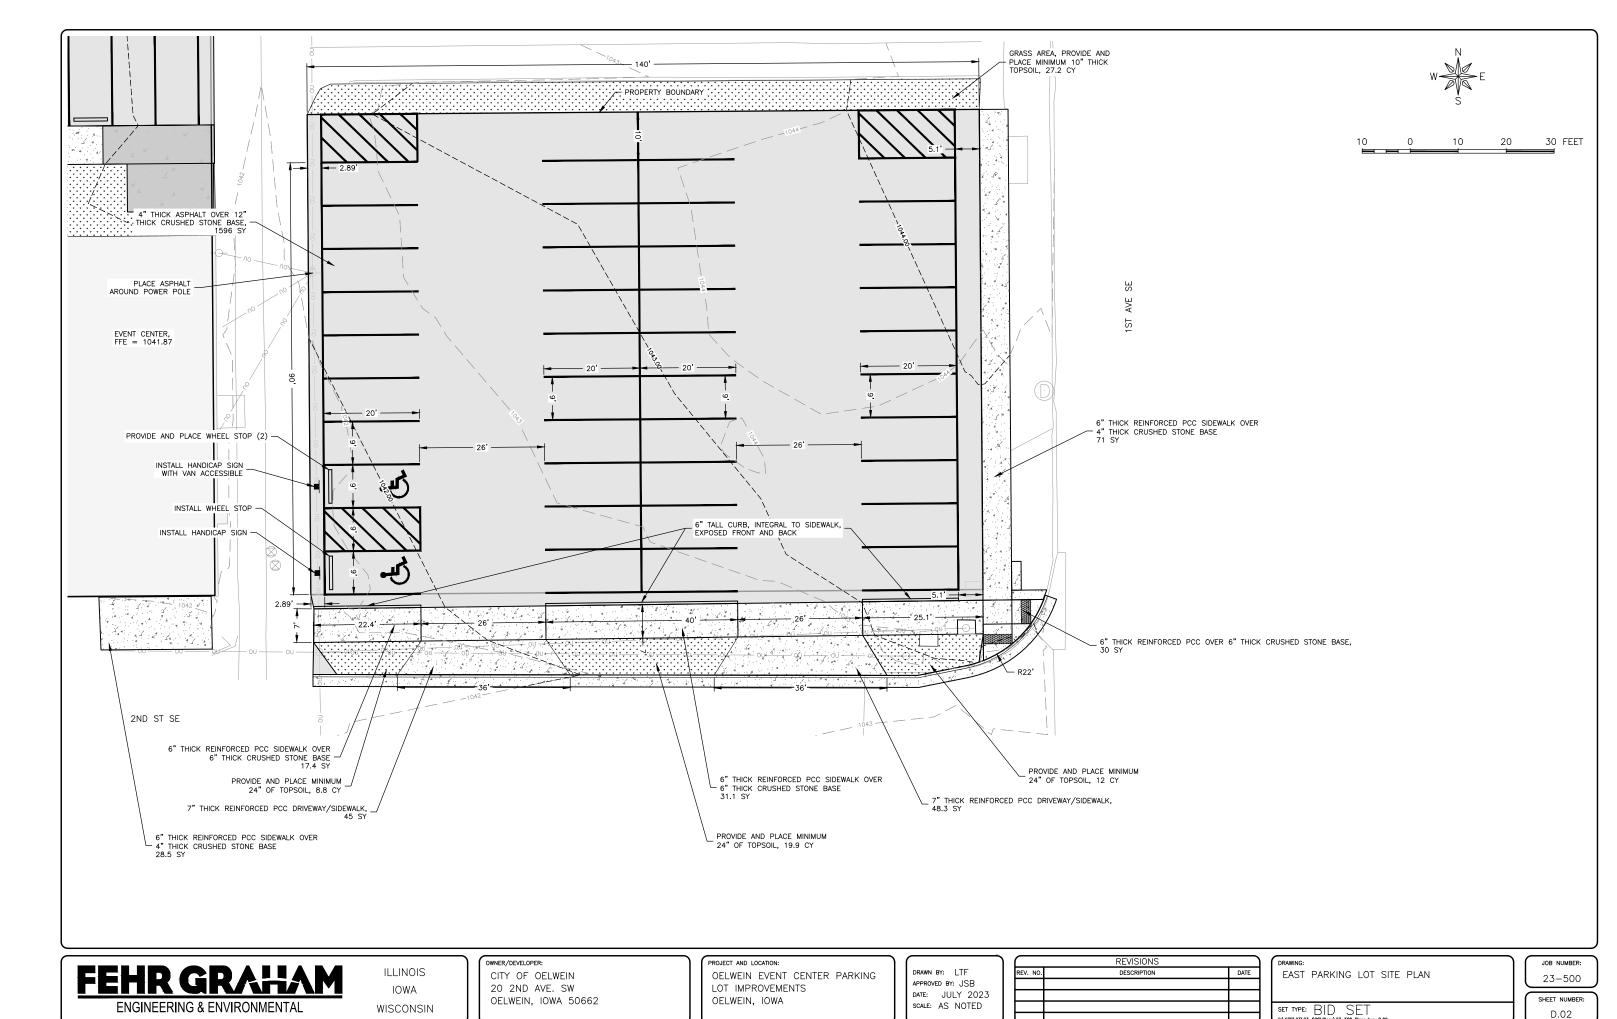

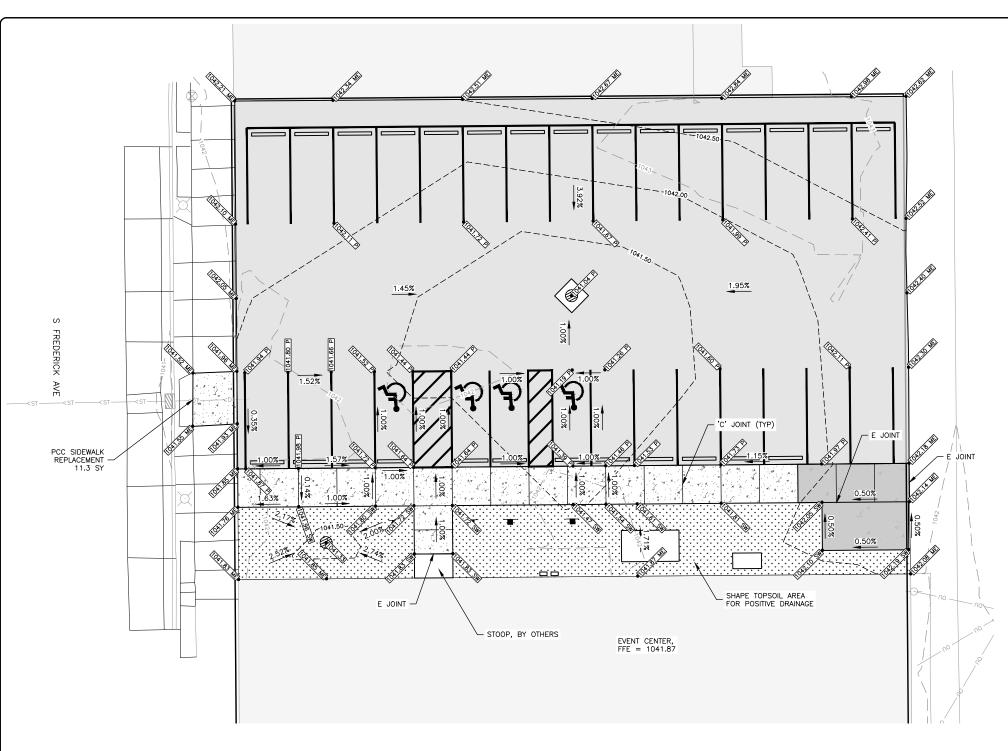NOTES: CLASS C, 4,500 PSI MIX REQUIRED, WITH CURING COMPOUND.

WALKWAY SHALL BE 6" THICK PCC, REINFORCED WITH #4 REBAR AT 24" BOTH WAYS.

PROVIDE AND PLACE 4" THICK ASPHALT, 2.5" BASE COURSE, 1.5" SURFACE COURSE OVER 10" OF COMPACTED CRUSHED STONE, MODIFIED SUBBASE, IDOT GRADATION #14.

SEAL ALL EXPANSION JOINTS.

PAVEMENT MARKINGS SHALL BE WHITE.



0 0 10 20 30 FEET

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ENGINEERING & ENVIRONMENTAL

ILLINOIS IOWA WISCONSIN OWNER/DEVELOPER:

CITY OF OELWEIN

20 2ND AVE. SW

OELWEIN, IOWA 50662

PROJECT AND LOCATION:

OELWEIN EVENT CENTER PARKING
LOT IMPROVEMENTS
OELWEIN, IOWA


DRAWN BY: LTF
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DATE: JULY 2023
SCALE: AS NOTED

	REVISIONS				
REV. NO.	DESCRIPTION	DATE			

DRAWING:
NORTH PARKING LOT GRADING AND PAVING
PLAN

SET TYPE: BID SET G:\C30\23\23-500\Plans\23-500 Plans.dwa. D.03 JOB NUMBER: 23-500
SHEET NUMBER:

D.03

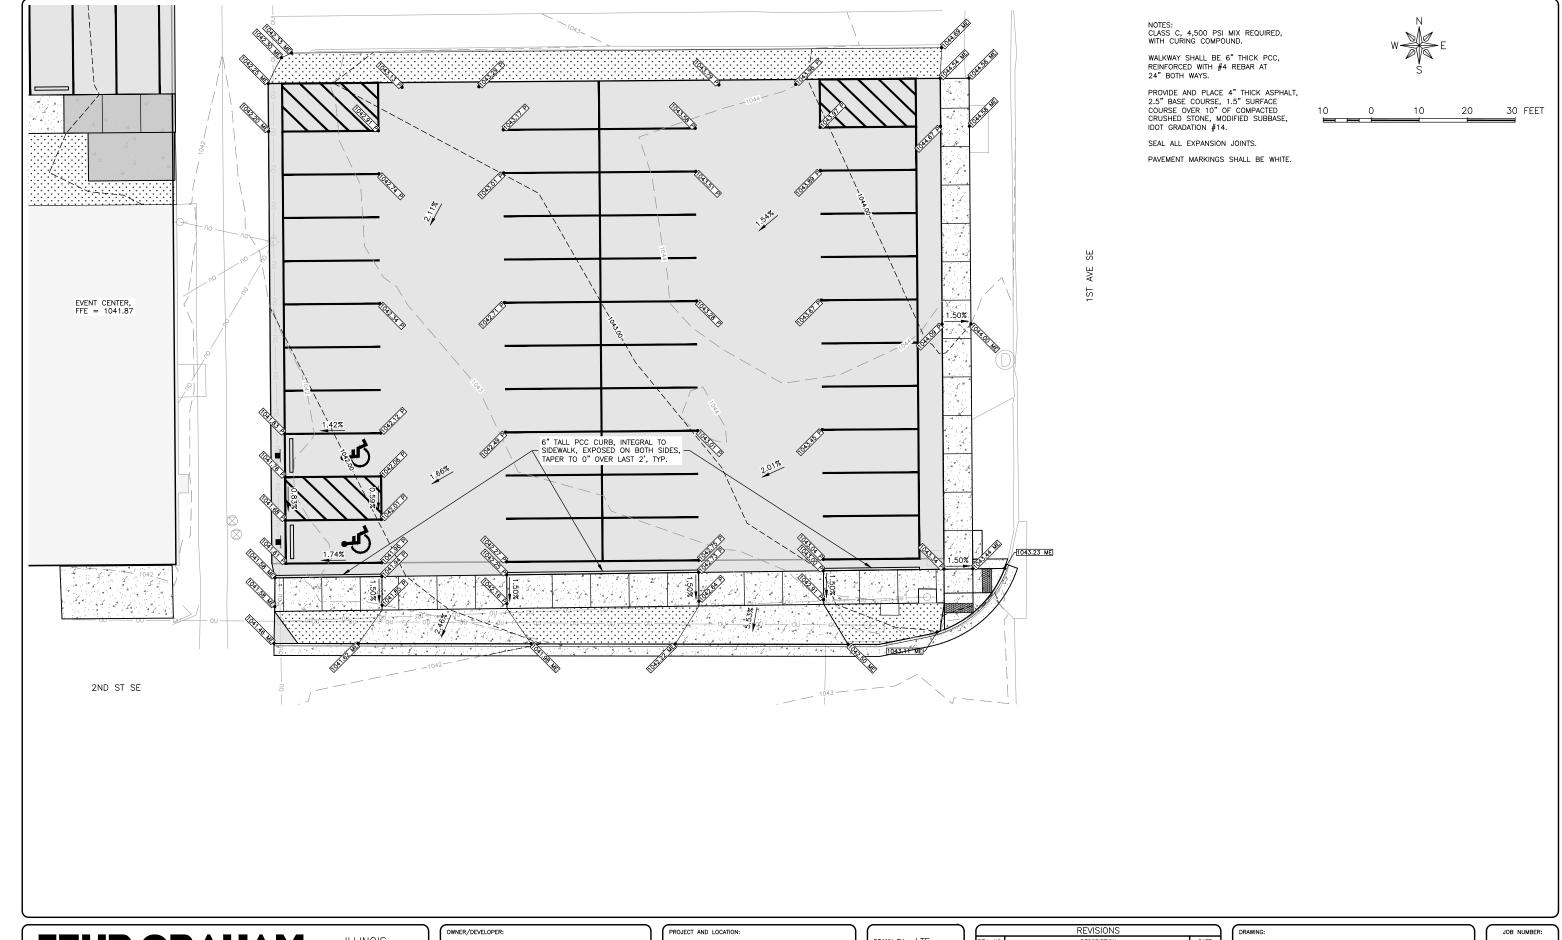

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ILLINOIS IOWA WISCONSIN CITY OF OELWEIN 20 2ND AVE. SW OELWEIN, IOWA 50662

OELWEIN EVENT CENTER PARKING
LOT IMPROVEMENTS
OELWEIN, IOWA


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APPROVED BY: JSB
DATE: JULY 2023
SCALE: AS NOTED

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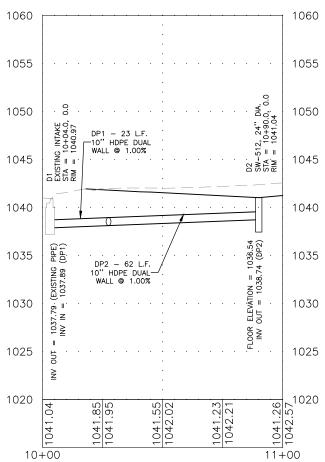
EAST PARKING LOT GRADING AND PAVING PLAN


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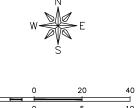
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NOTES: BACKFILL FULL STORM LINE TRENCH WITH POROUS BACKFILL, IDOT GRADATION #29, PROVIDE CONTACT WITH MODIFIED SUBBASE.





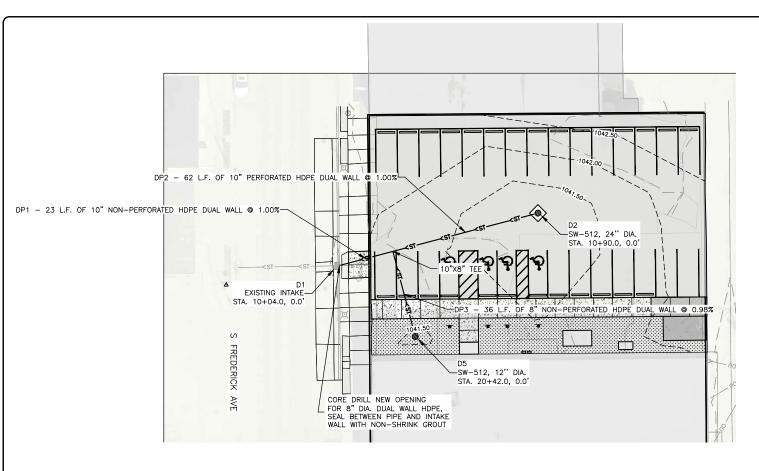

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ILLINOIS IOWA WISCONSIN owner/developer:
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PROJECT AND LOCATION:

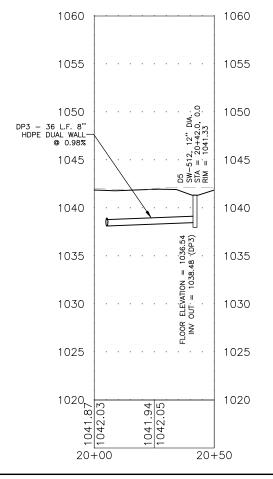OELWEIN EVENT CENTER PARKING
LOT IMPROVEMENTS
OELWEIN, IOWA

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DATE: JULY 2023
SCALE: AS NOTED

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REV. NO.	DESCRIPTION	DATE
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DRAWING:

NORTH PARKING LOT STORMWATER PLAN & PROFILE


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23-500

SHEET NUMBER:

M.01



PLOT DATE: 7/18/23 © 2023 FEHR GRAHAM
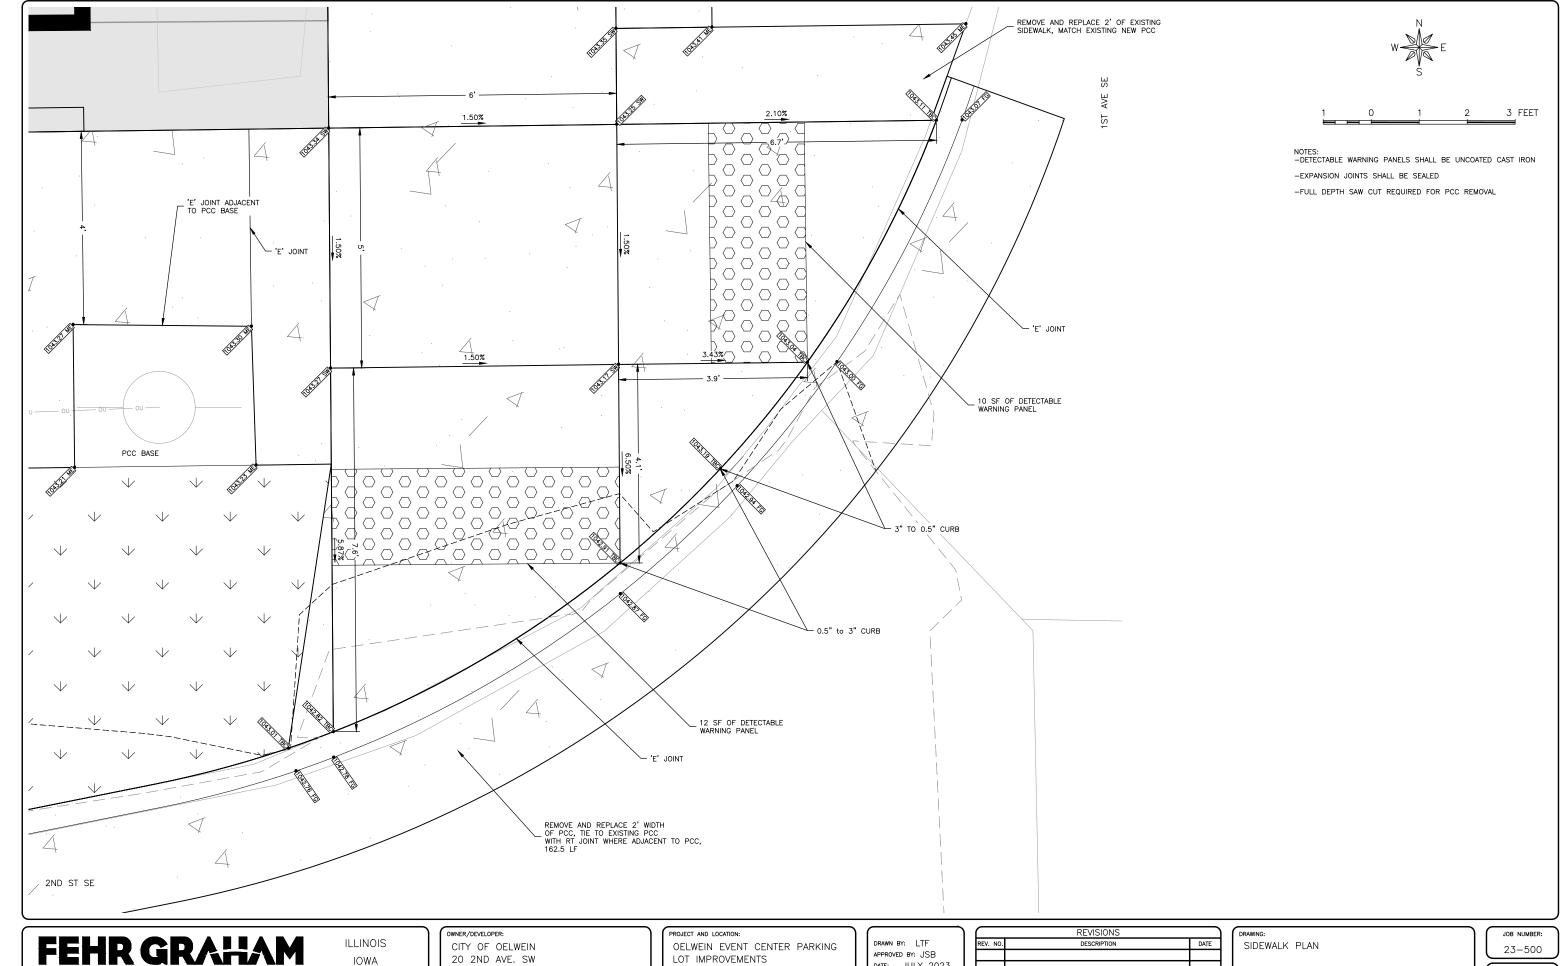
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20 2ND AVE. SW OELWEIN, IOWA 50662

WISCONSIN

LOT IMPROVEMENTS OELWEIN, IOWA

APPROVED BY: JSB
DATE: JULY 2023 SCALE: AS NOTED

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REV. NO.	DESCRIPTION	DATE	

1	DRAWING:			
I	SIDEWALK	PLAN		
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SHEET NUMBER: S.01

SET TYPE: BID SET