

BOARD OF ALDERMEN AGENDA ITEM

06/04/25

ISSUE:	WB BRAWLEY CONSTRUCTION CHANGE DIRECTIVE-01
PRESENTED BY:	Alice Derian, Town Manager
DEPARTMENT:	Fire Station #2 Fund - 50
Background:	Fire Station #2 Fund 50 This Construction Change Directive-01 for Fire Station #2 by WB Brawley is to confirm the work that must be completed. There is no Change Order that increases the Contract Sum.
	Attachments: WB Brawley Construction Change Directive-01
Recommendation:	Approve the WB Brawley Construction Change Directive-01 as recommended.
Action Needed:	Yes
Suggested Motion:	"I,, make a motion to approve the WB Brawley Construction Change Directive #1"

Funds:

Follow Up:

50

Town Manager



Construction Change Directive

PROJECT: (name and address)
North Topsail Beach Fire Station #2
3304 Gray Street

North Topsail Beach, North Carolina 28460

OWNER: (name and address)
Town of North Topsail Beach
2008 Loggerhead Court
North Topail Beach, North Carolina
28460

CONTRACT INFORMATION:

Contract For: General Construction Date: March 5, 2024

ARCHITECT: (name and address)
Becker Morgan Group, Inc.
333 Jeckle Drive, Suite 120
Wilmington, North Carolina 28403

CCD INFORMATION:

Directive Number: 01 Date: May 20, 2025

CONTRACTOR: (name and address)
WB Brawley Company
3314 Jaeckle Drive, Suite 120
Wilmington, North Carolina 28403

The Contractor is hereby directed to make the following change(s) in this Contract: (Insert a detailed description of the change and, if applicable, attach or reference specific exhibits.)

See attached Exhibit A.

PROPOSED ADJUSTME	'NI 1 3

- - As follows: See attached Exhibit B.
- The Contract Time is proposed to remain unchanged; please refer to the discussion in Exhibit B concerning the lack
 of substantiation for the Contractor's contended increase in the Contract Time. The proposed adjustment, if any, is
 Zero.

NOTE: The Owner, Architect and Contractor should execute a Change Order to supersede this Construction Change Directive to the extent they agree upon adjustments to the Contract Sum, Contract Time, or Guaranteed Maximum price for the change(s) described herein.

When signed by the Owner and Architect and received by the Contractor, this document becomes effective IMMEDIATELY as a Construction Change Directive (CCD), and the Contractor shall proceed with the change(s) described above.

with the proposed adjustments in Contract Sum and Contract Time set forth in this CCD.

Becker Morgan Group, Inc.

ARCHITECT (Firm name)

Town of North Topsail Beach
OWNER (Firm name)

WB Brawley Company
CONTRACTOR (Firm name)

SIGNATURE
Ernest W. Olds, AIA / V.P.

SIGNATURE
Alice Derian, Town Manager

PRINTED NAME AND TITLE

SIGNATURE

PRINTED NAME AND TITLE

PRINTED NAME AND TITLE

May 20, 2025

May 20, 2025 DATE

DATE

DATE

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User Notes:

(3B9ADA4C)

EXHIBIT A (Construction Change Directive Number 01)

The Contractor is hereby directed to perform the Work described in the responses to Request for Information ("RFI") numbers 100, 101, and 107, including the Drawings and Specifications referenced in the response to each such RFI, such Work generally involving the following:

- (1). Installation of a 2.5" distribution header on top of the track on the exterior wall and additional drywall.
- (2). Removal of two hollow metal door frames, modification of masonry at the two hollow metal door frames and at three openings at the second floor, and replacement of two hollow metal door frames.


For ease of reference the response to RFI number 100 is appended as Attachment 1, the response to RFI number 101 is appended as Attachment 2, and the response to RFI number 107 is appended as Attachment 3.



REQUEST FOR INFORMATION



CONTRACT NUMBER:					<u> </u>		
2021025.02 NTBFS				RFI NUMBER:	100		
CONTRACT TITLE:				-			
North Topsail Beach Fire Station #2							
PRIME CONTRACTOR:		CLIENT:					
WB Brawley Company Matt Ribakow		Kim Wilson	kwileen@beeke	morgan com l			
mribakow@brawley.net			kwilson@becker oreid@beckermo				
SUBJECT/TITLE OF RFI: URGENT	Γ- Joist Bearing Eleva		<u> </u>	- gameem			
DRAWING(S): A510, S2.02, S2.03	DETAIL(S) A510-2	052100	FICATION:	CPM ACTIVITY	NUMBER:		
Cost Effect: ⊠ Increase ⊠ Increase			BD BD				
INFORMATION REQUESTED &	RECOMMENDED S	OLUTION					
	_						
The joist bearing elevations (J.B.E.)							
of the steel joists. This includes the	top of the bearing plate	es for all loc	ations of joists be	earing on masonry	′·		
We have determined that the joist be to achieve the correct finished floor joist flange thickness or b) instead d	elevation, and that they	should hav					
		,					
As a result, if we move forward using the joist bearing plates at their currently installed height, our finished floor elevation will now be 27'-10.5", which is 2.5" above the 27'-8" shown on the plans.							
Please provide direction for moving forward.							
	URGENT	0.10.4.10	- 0: 1	M ((D))			
Date Response Required By: RESPONSE:	3/9/25 Dat	e: 3/31/2	5 Signature	: Matt Ribakov	V		
JBE has installed will remain increased by 2.5". See attack				•	e e		
Contractor will need to coord manuf.	inate door heights	and new f	oor stop eleva	ation with eleva	tor		
Please confirm first floor structural studs are cut to correct height.							
From: BMR	Date: 04-0	2-2025	Signature				
The RFI system is intended to provide an effi authorize the contractor to proceed with work changed condition, written notice to the Cont	c - to do so, the contractor pro	oceeds at his o	wn risk. If the contrac				
DISTRIBUTION: Original to File via R	OICC PL/DM ET	☐ A/E ☐] PC# vi	a ROICC/CONTRACT	ING OFFICER		

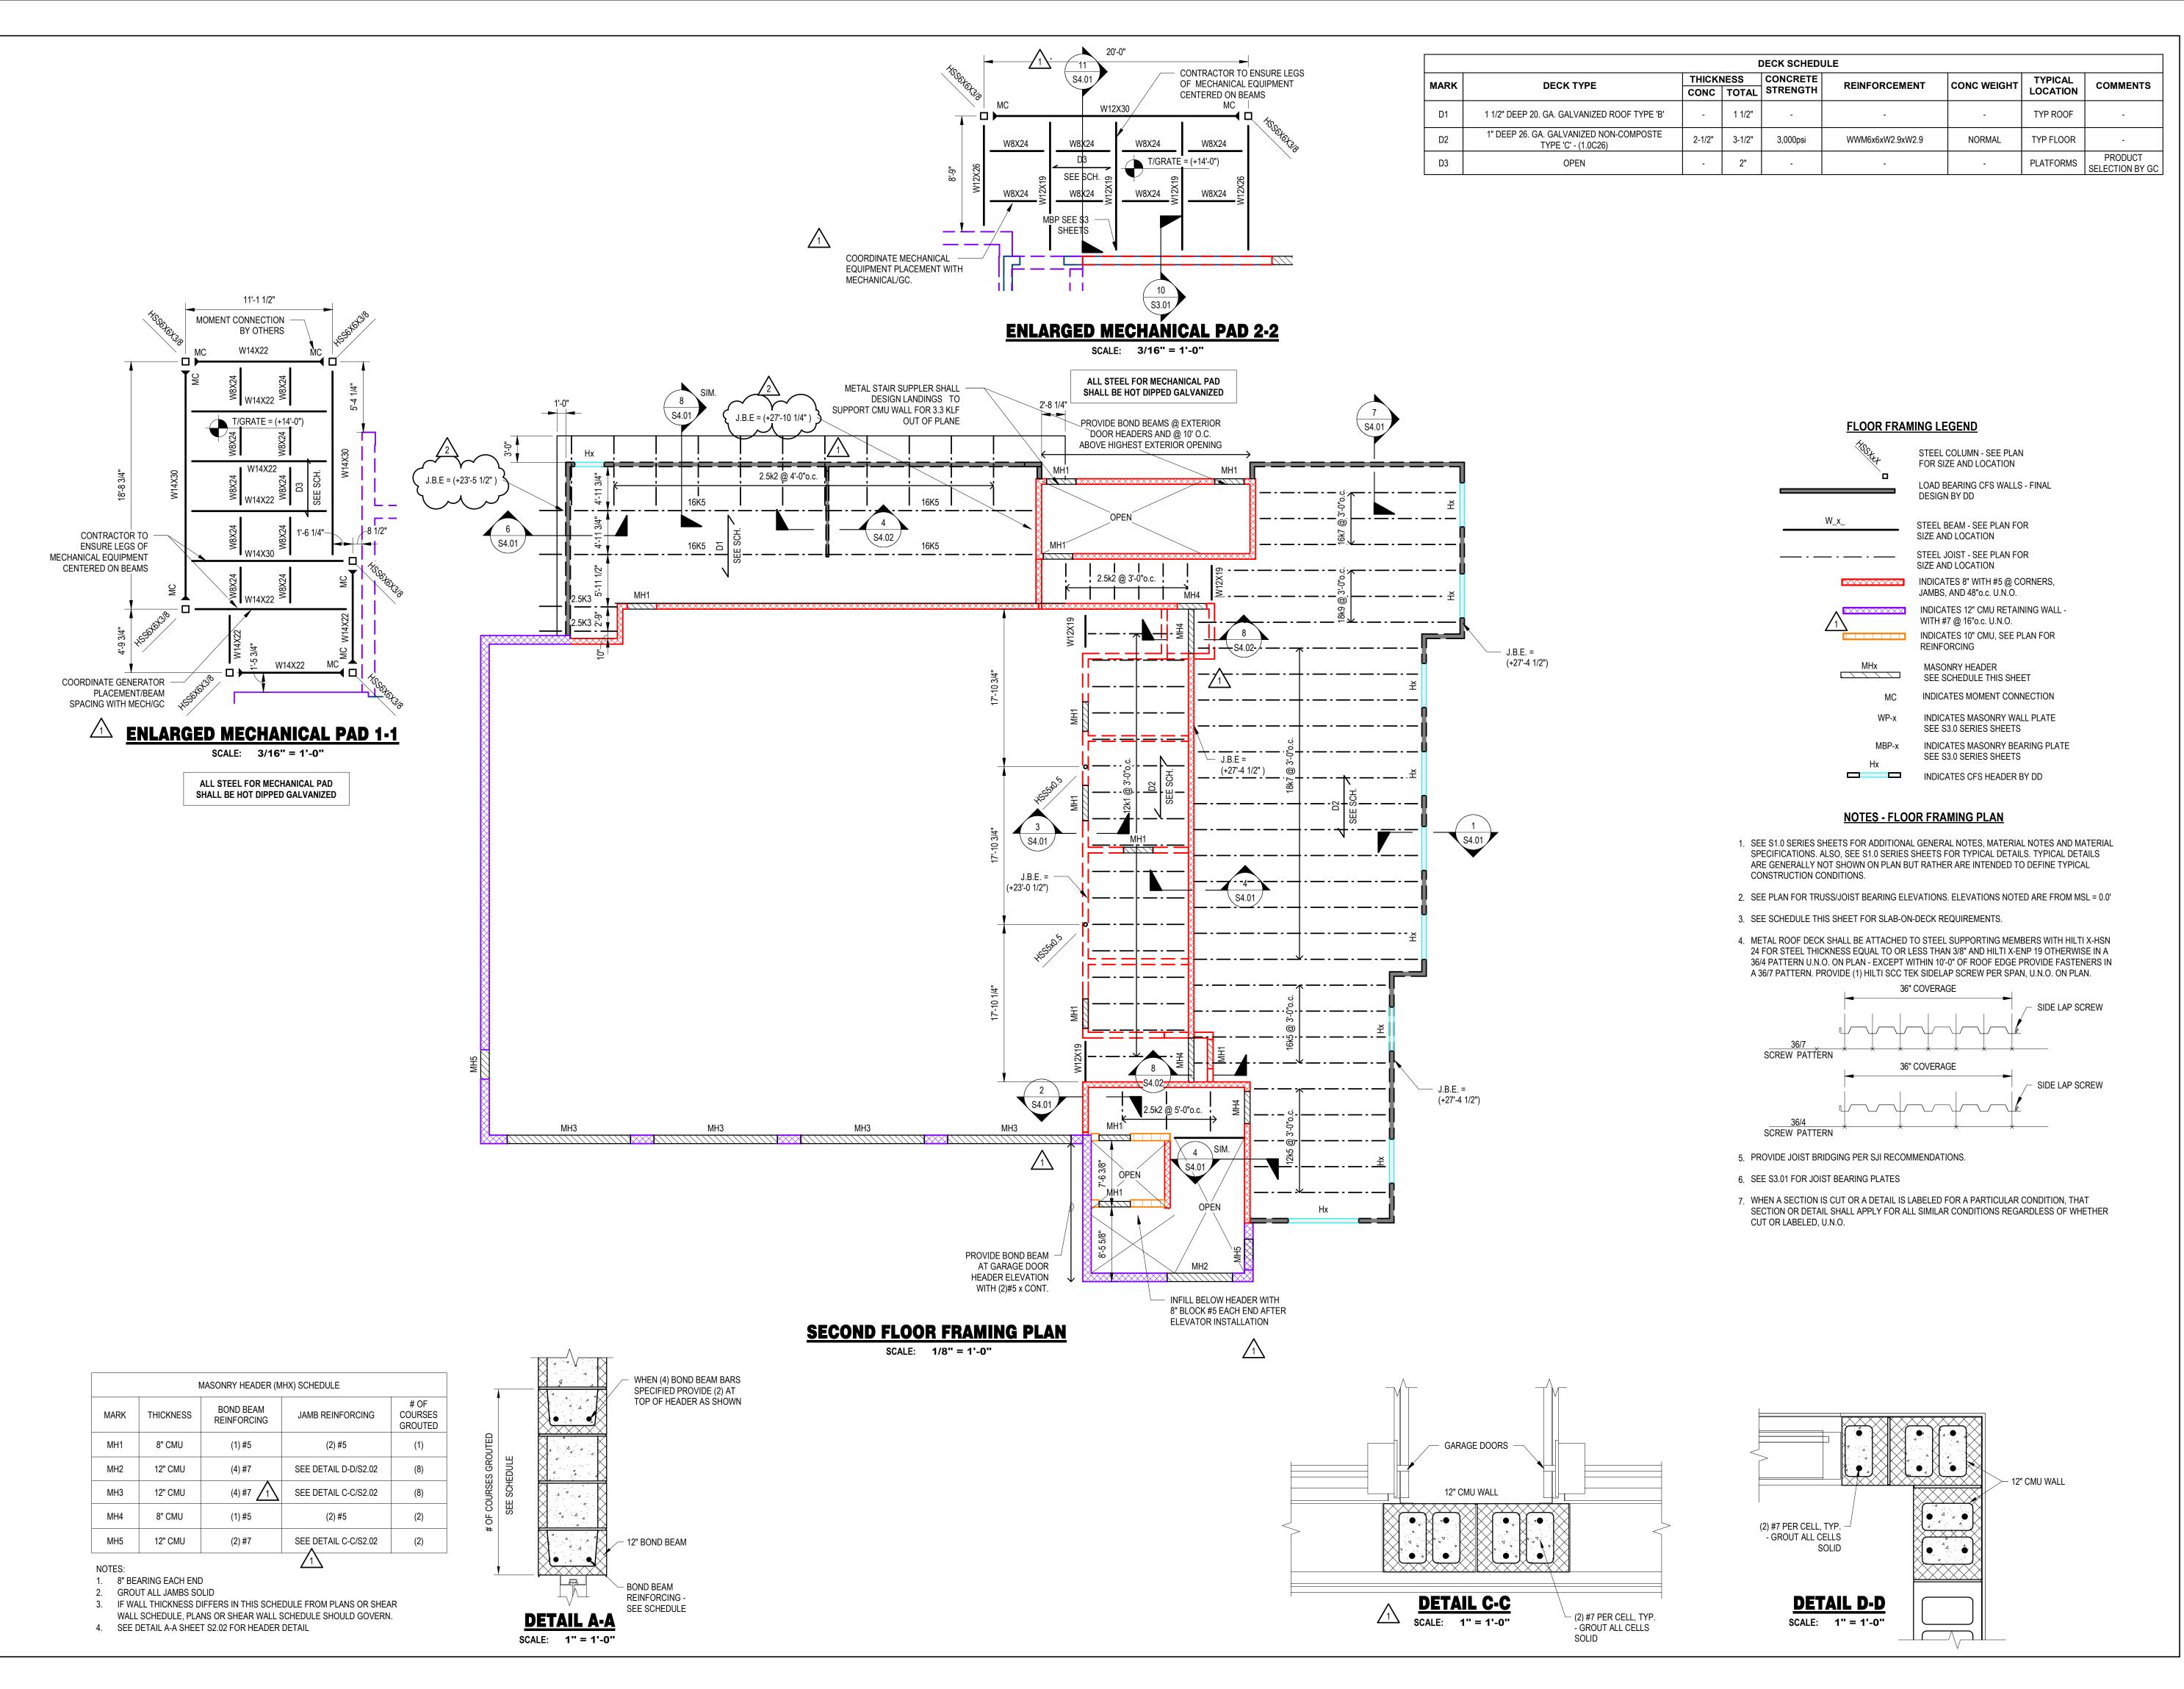



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PARAMOUNTE ENGINEERING, INC.

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WOODS ENGINEERING
STRUCTURAL ENGINEERING
254 N. FRONT STREET, SUITE 201

WILMINGTON, NC 28401

ph 910-343-8007 fax 910-343-8088





OJECT TITLE

NORTH TOPSAIL BEACH FIRE STATION #2

3304 GRAY STREET NORTH TOPSAIL BEACH, NC 28460

> ISSUED FOR PERMIT

> > 03.08.2024

SECOND FLOOR FRAMING PLAN

SUE BLO	CK		
2	04/02/2025	RFI100	
1	03/25/2025	ASI-008	
Mark	Date		Description
PROJ	ECT NO:		2021025.02


DATE: 03.08.2024

SCALE: As indicated


DRAWN BY:Author PROJ MGRChecker

S2.02

	DECK SCHEDULE								
MARK	DECK TYPE	THICK		CONCRETE STRENGTH	REINFORCEMENT	CONC WEIGHT	TYPICAL LOCATION	COMMENTS	
D1	1 1/2" DEEP 20. GA. GALVANIZED ROOF TYPE 'B'	-	1 1/2"	-	-	-	TYP ROOF	-	
D2	1" DEEP 26. GA. GALVANIZED NON-COMPOSTE TYPE 'C' - (1.0C26)	2-1/2"	3-1/2"	3,000psi	WWM6x6xW2.9xW2.9	NORMAL	TYP FLOOR	-	
D3	OPEN	-	2"	-	-	-	PLATFORMS	PRODUCT SELECTION BY GC	

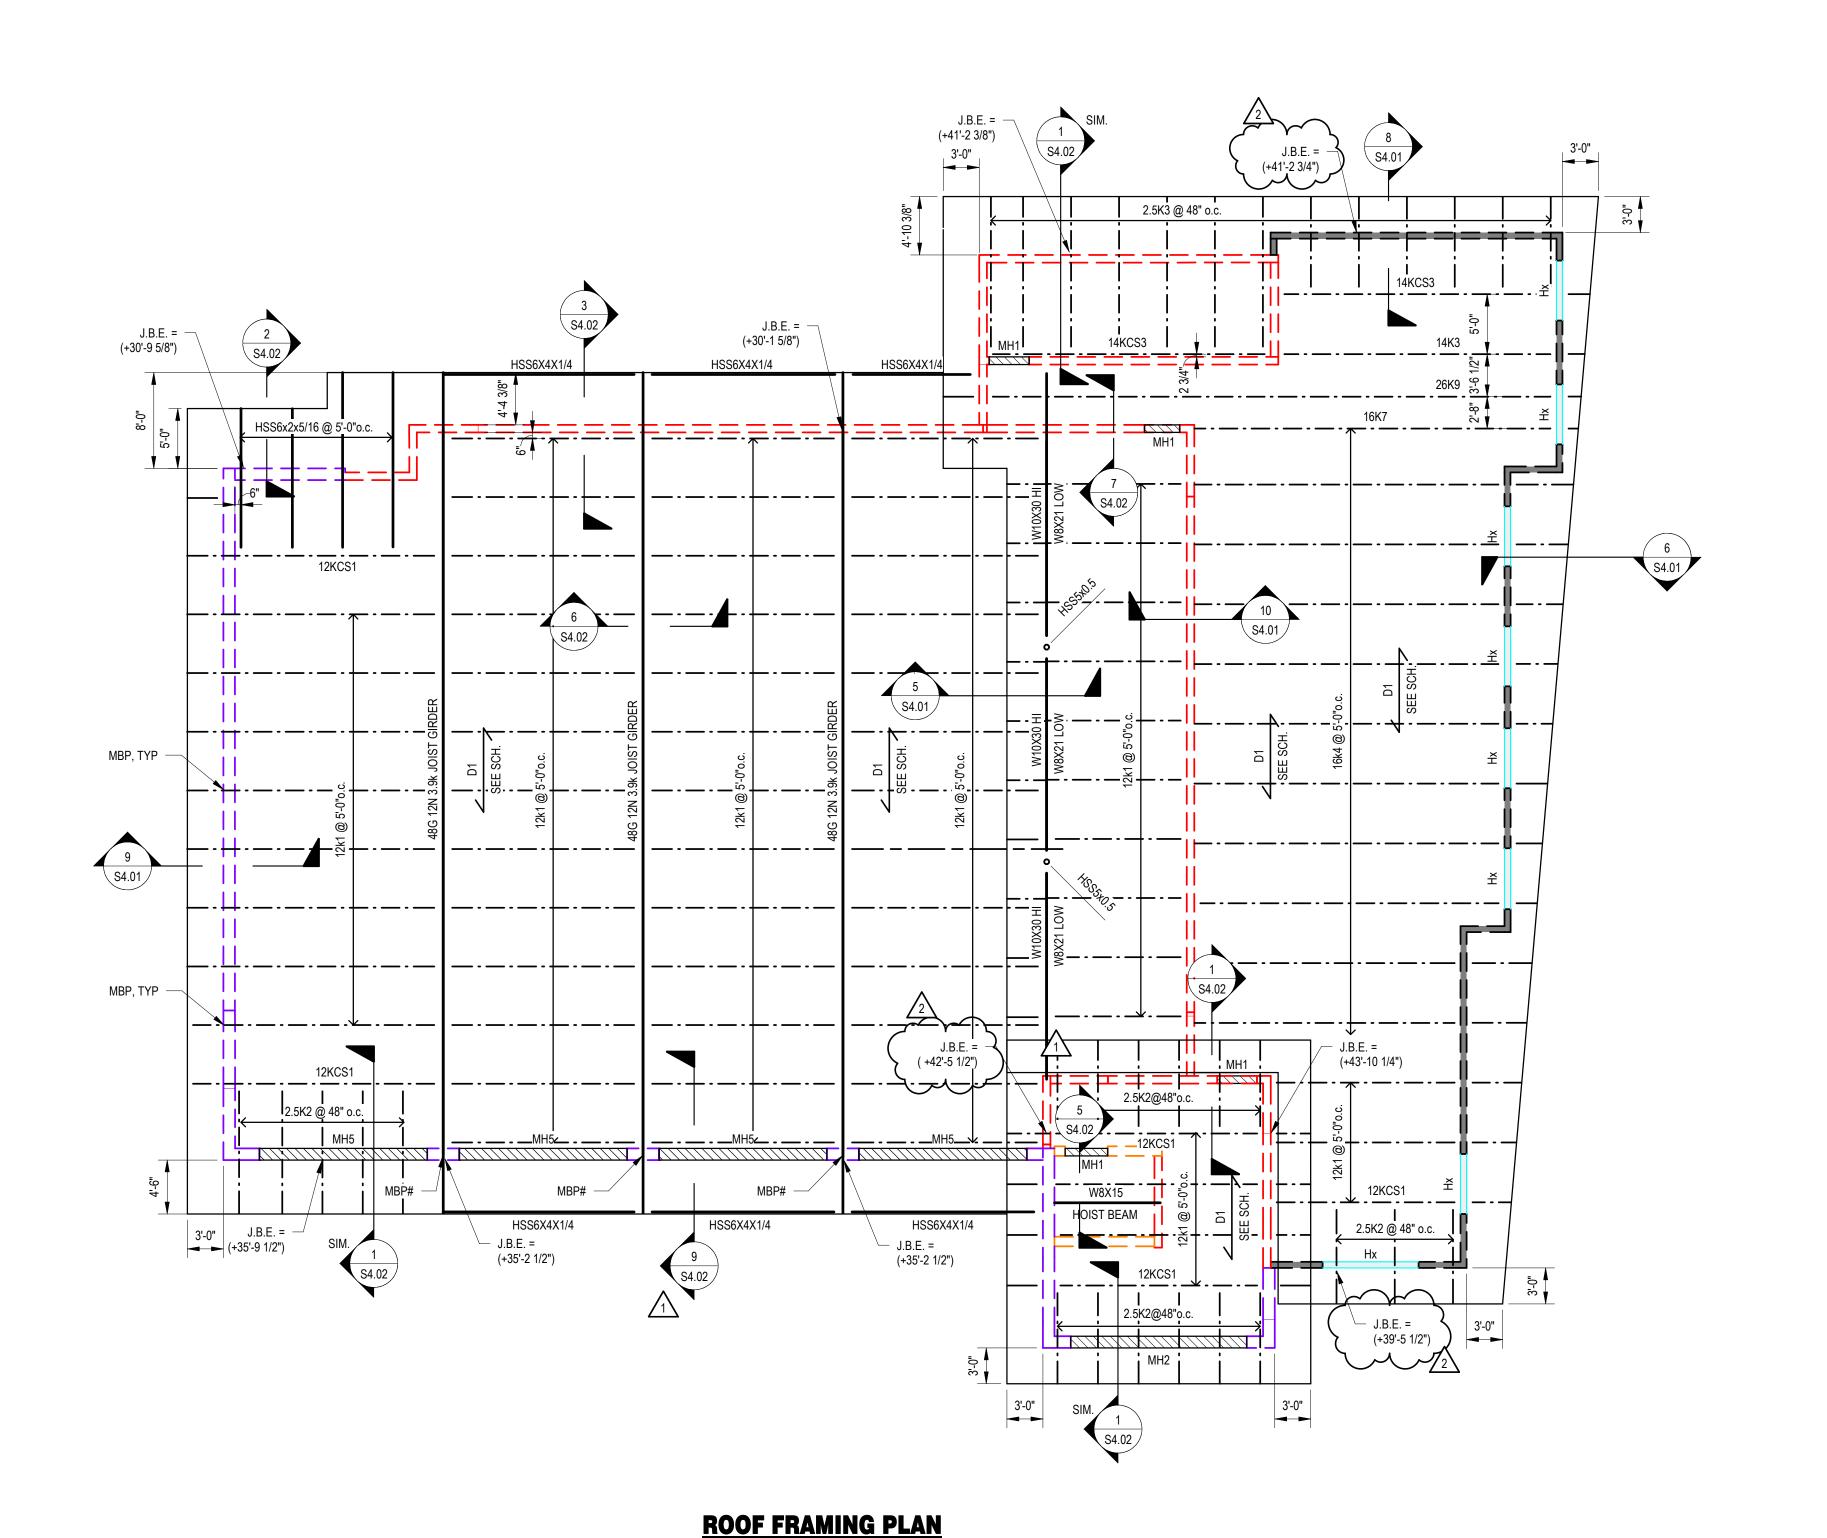

ROOF FRAMING LEGEND

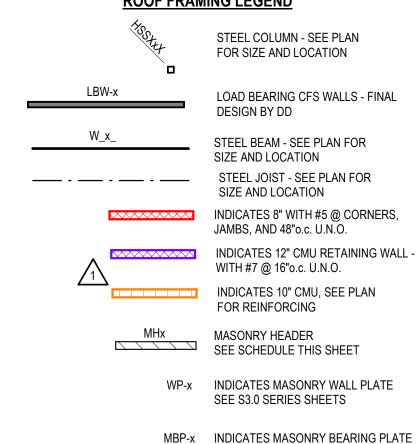


NOTES - ROOF FRAMING

1. SEE SHEET S1.0 SERIES SHEETS FOR GENERAL STEEL, JOIST, DECK, LIGHT GAUGE FRAMING NOTES AND TYPICAL DETAILS NOT SHOWN ON PLAN.

SEE S3.0 SERIES SHEETS

2. METAL ROOF DECK SHALL BE ATTACHED TO STEEL SUPPORTING MEMBERS WITH HILTI X-HSN 24 FOR STEEL THICKNESS EQUAL TO OR LESS THAN 3/8" AND HILTI X-ENP 19 OTHERWISE IN A 36/4 PATTERN EXCEPT IN CORNER ZONES (ZONE 3 - SEE S1.0 SERIES SHEETS) - PROVIDE

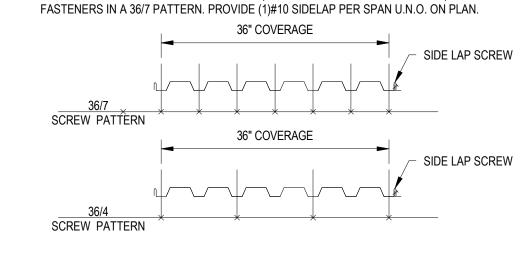

- 3. ALL JOISTS SHALL BE DESIGNED FOR A NET UPLIFT PRESSURE OF 30 psf.
- 4. PROVIDE JOIST BRIDGING PER SJI RECOMMENDATIONS.
- 5. ALL BEAMS, GIRDERS AND COLUMNS SHALL BE ASTM A992, GRADE 50.



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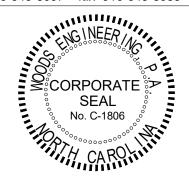
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ph 910-343-8007 fax 910-343-8088





NORTH TOPSAIL BEACH FIRE STATION #2

3304 GRAY STREET NORTH TOPSAIL BEACH, NC 28460

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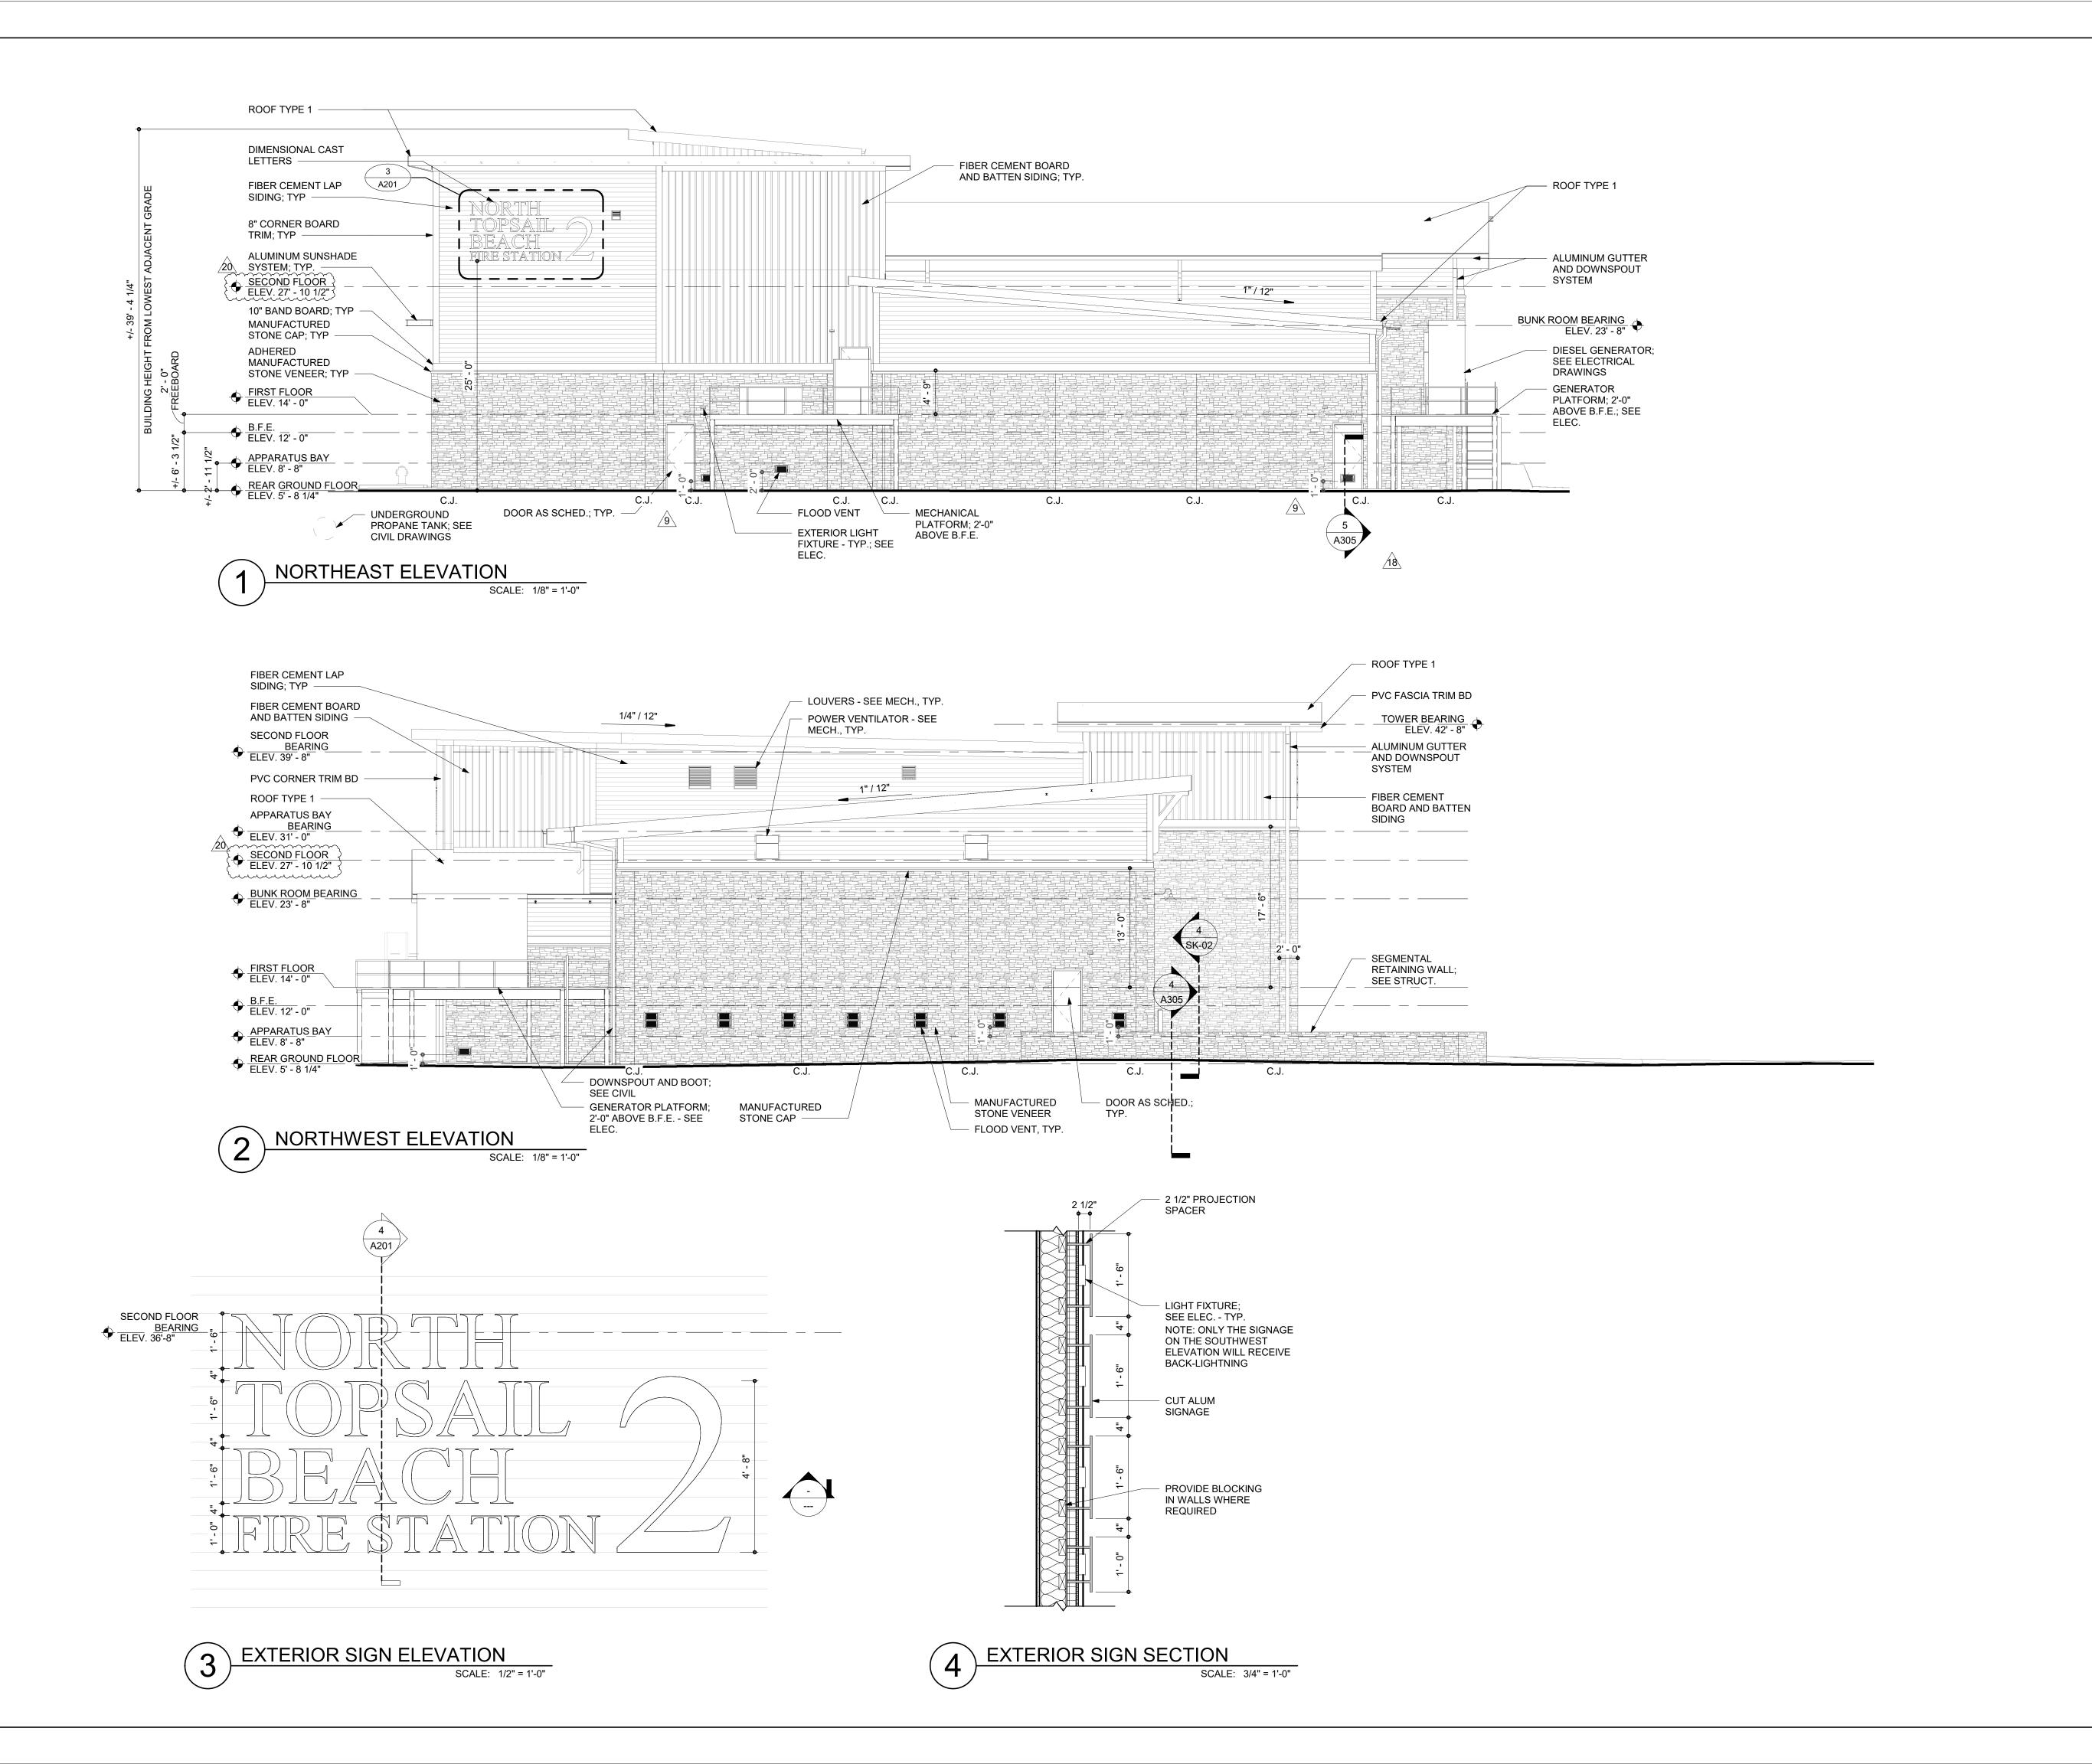
03.08.2024

ROOF FRAMING PLAN

ISSUE BLOCK

2 04/02/2025 RFI100 1 03/25/2025 ASI-008 PROJECT NO: 2021025.02 DATE:

03.08.2024 SCALE: As indicated DRAWN BY:Author PROJ MGRChecker





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PROJECT TITLE

NORTH TOPSAIL BEACH FIRE STATION #2

3304 GRAY STREET NORTH TOPSAIL BEACH, NC 28460

> ISSUED FOR PERMIT 03.08.2024

EXTERIOR ELEVATIONS

20 04.02.2025 RFI 100
18 03.11.2025 RFI 94
9 09.03.2024 RFI 53
Mark Date Description

9 09.03.2024 RF13
Mark Date
PROJECT NO:


DATE:

SCALE: As indicated
DRAWN BY: EJS PROJ MGR: BMR

A201

2021025.02

03.08.2024

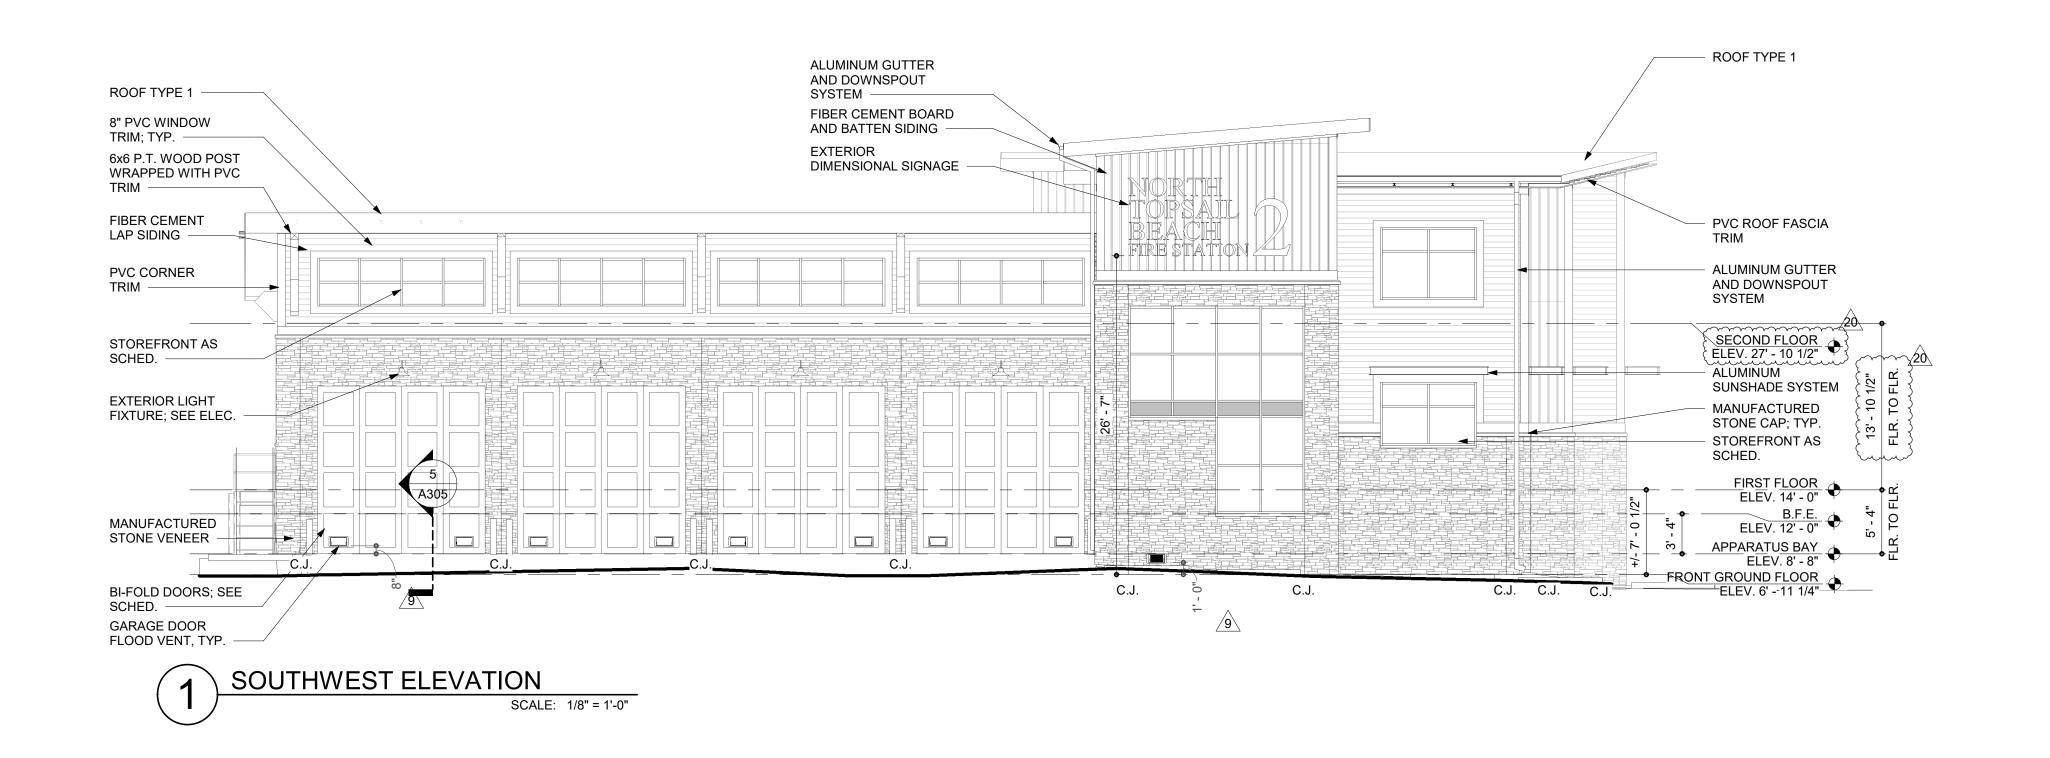





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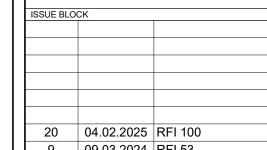


NORTH TOPSAIL BEACH FIRE STATION #2

3304 GRAY STREET NORTH TOPSAIL BEACH, NC

ISSUED **FOR PERMIT** 03.08.2024

EXTERIOR ELEVATIONS



9 09.03.2024 RFI 53 Mark Date


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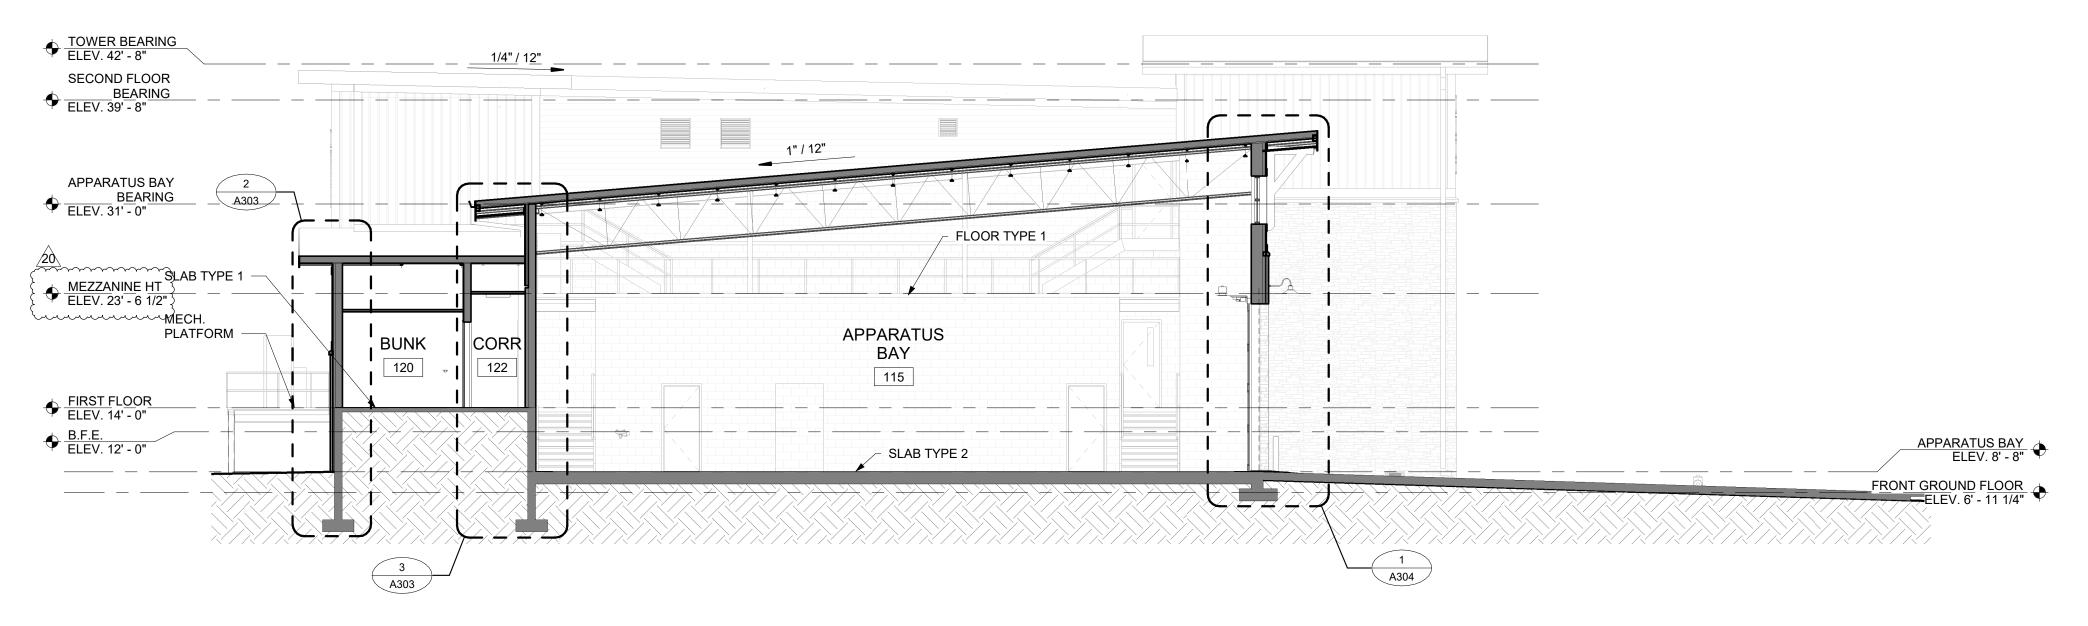
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2021025.02

03.08.2024

A202



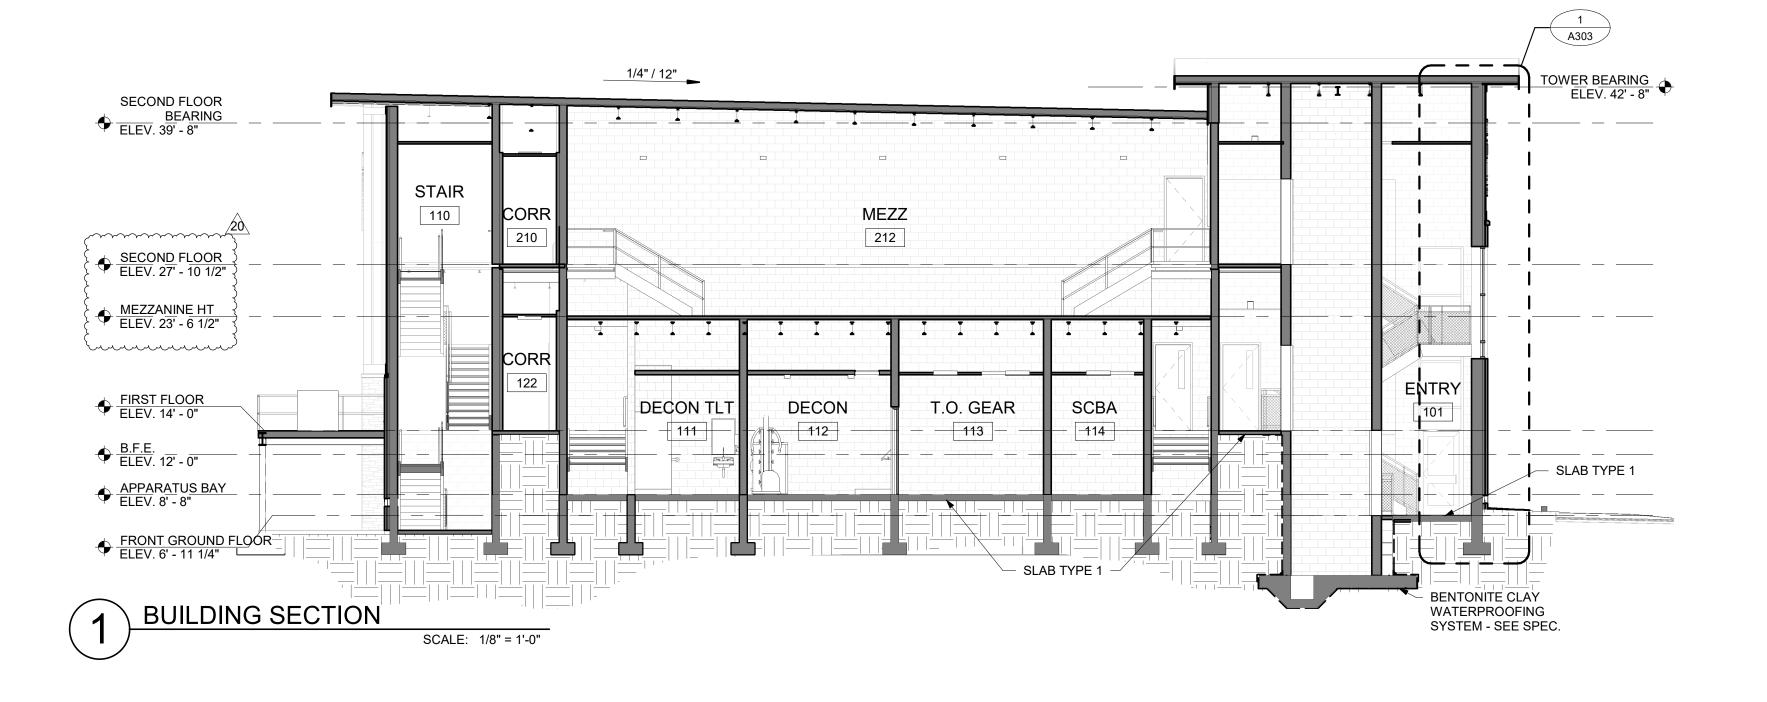

BUILDING SECTION

SCALE: 1/8" = 1'-0"



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NORTH TOPSAIL
BEACH FIRE
STATION #2

3304 GRAY STREET NORTH TOPSAIL BEACH, NC 28460

> ISSUED FOR PERMIT 03.08.2024

LE

BUILDING SECTIONS

ISSUE BLOCK

 20
 04.02.2025
 RFI 100


 Mark
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 Description

 PROJECT NO:
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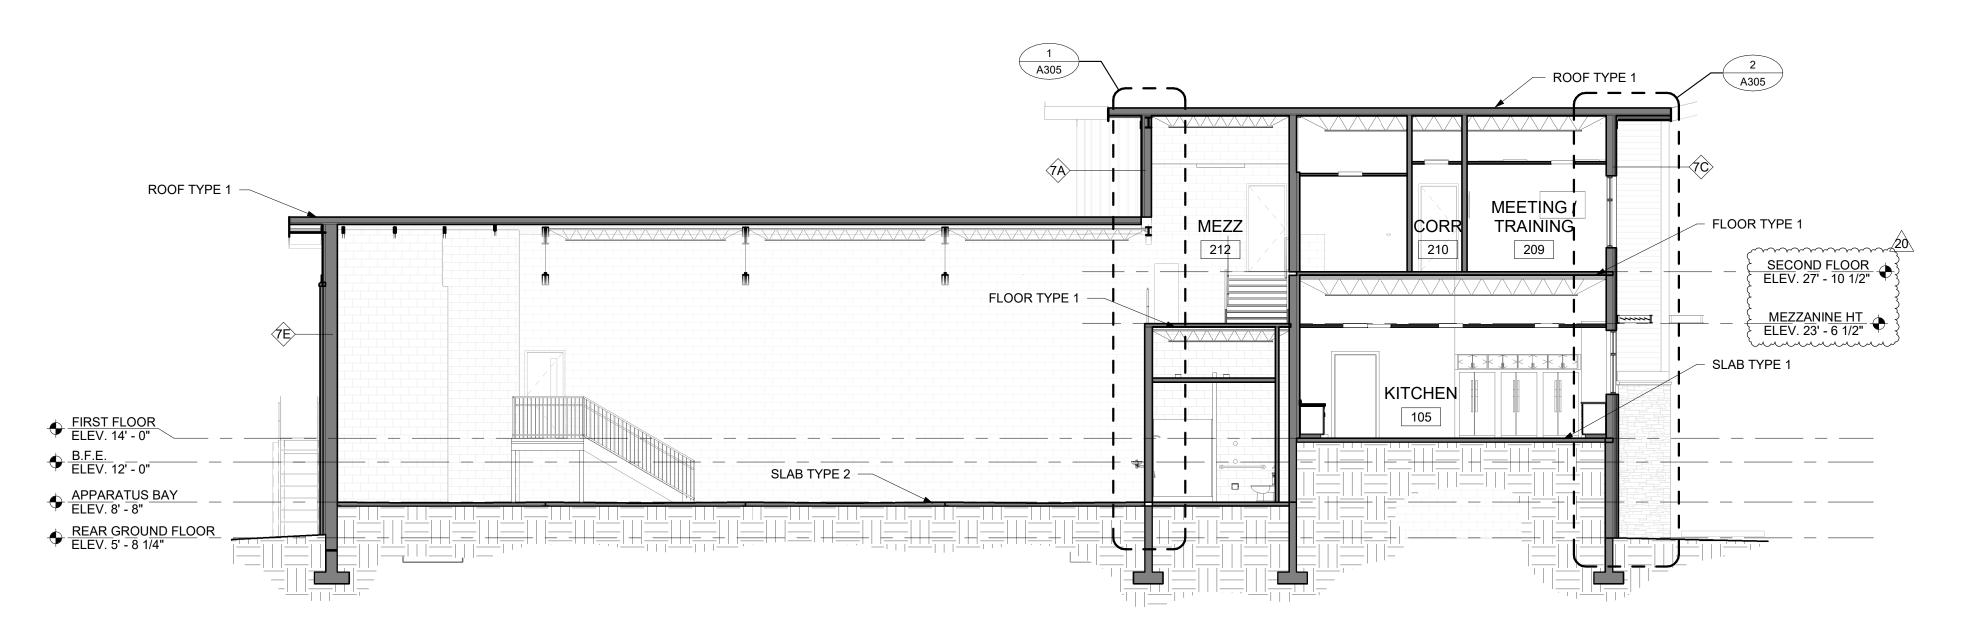
DATE: 03.08.2024 SCALE: 1/8" = 1'-0"

DRAWN BY: EJS PROJ MGR: BMR

A301



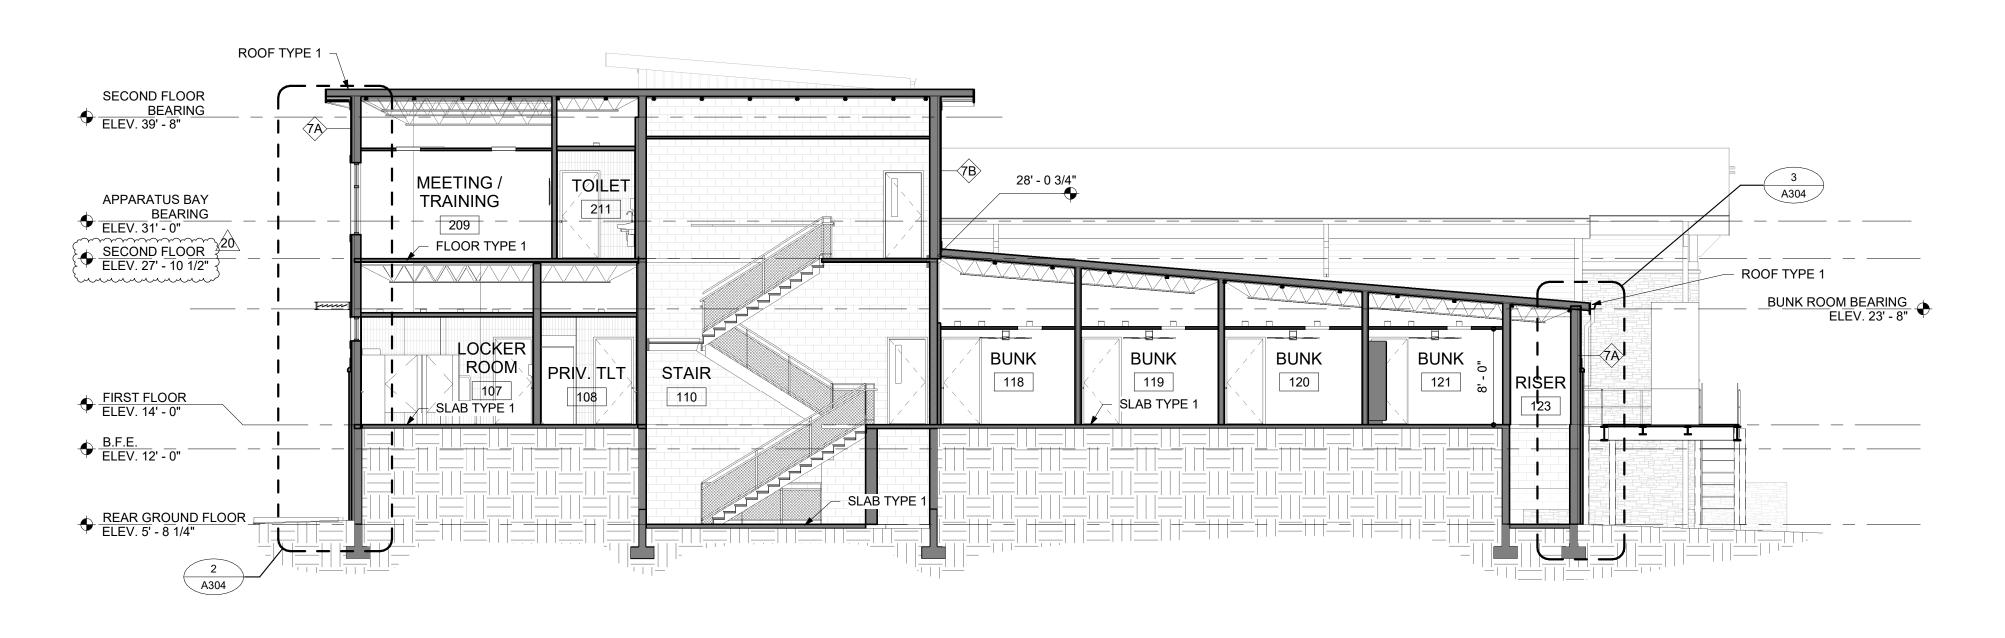



BUILDING SECTION

SCALE: 1/8" = 1'-0"



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PROJECT TITL

NORTH TOPSAIL BEACH FIRE STATION #2

3304 GRAY STREET NORTH TOPSAIL BEACH, NC 28460

> ISSUED FOR PERMIT 03.08.2024

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BUILDING SECTIONS

ISSUE BLOCK

20 04.02.2025 RFI 100
Mark Date De

PROJECT NO:
DATE:


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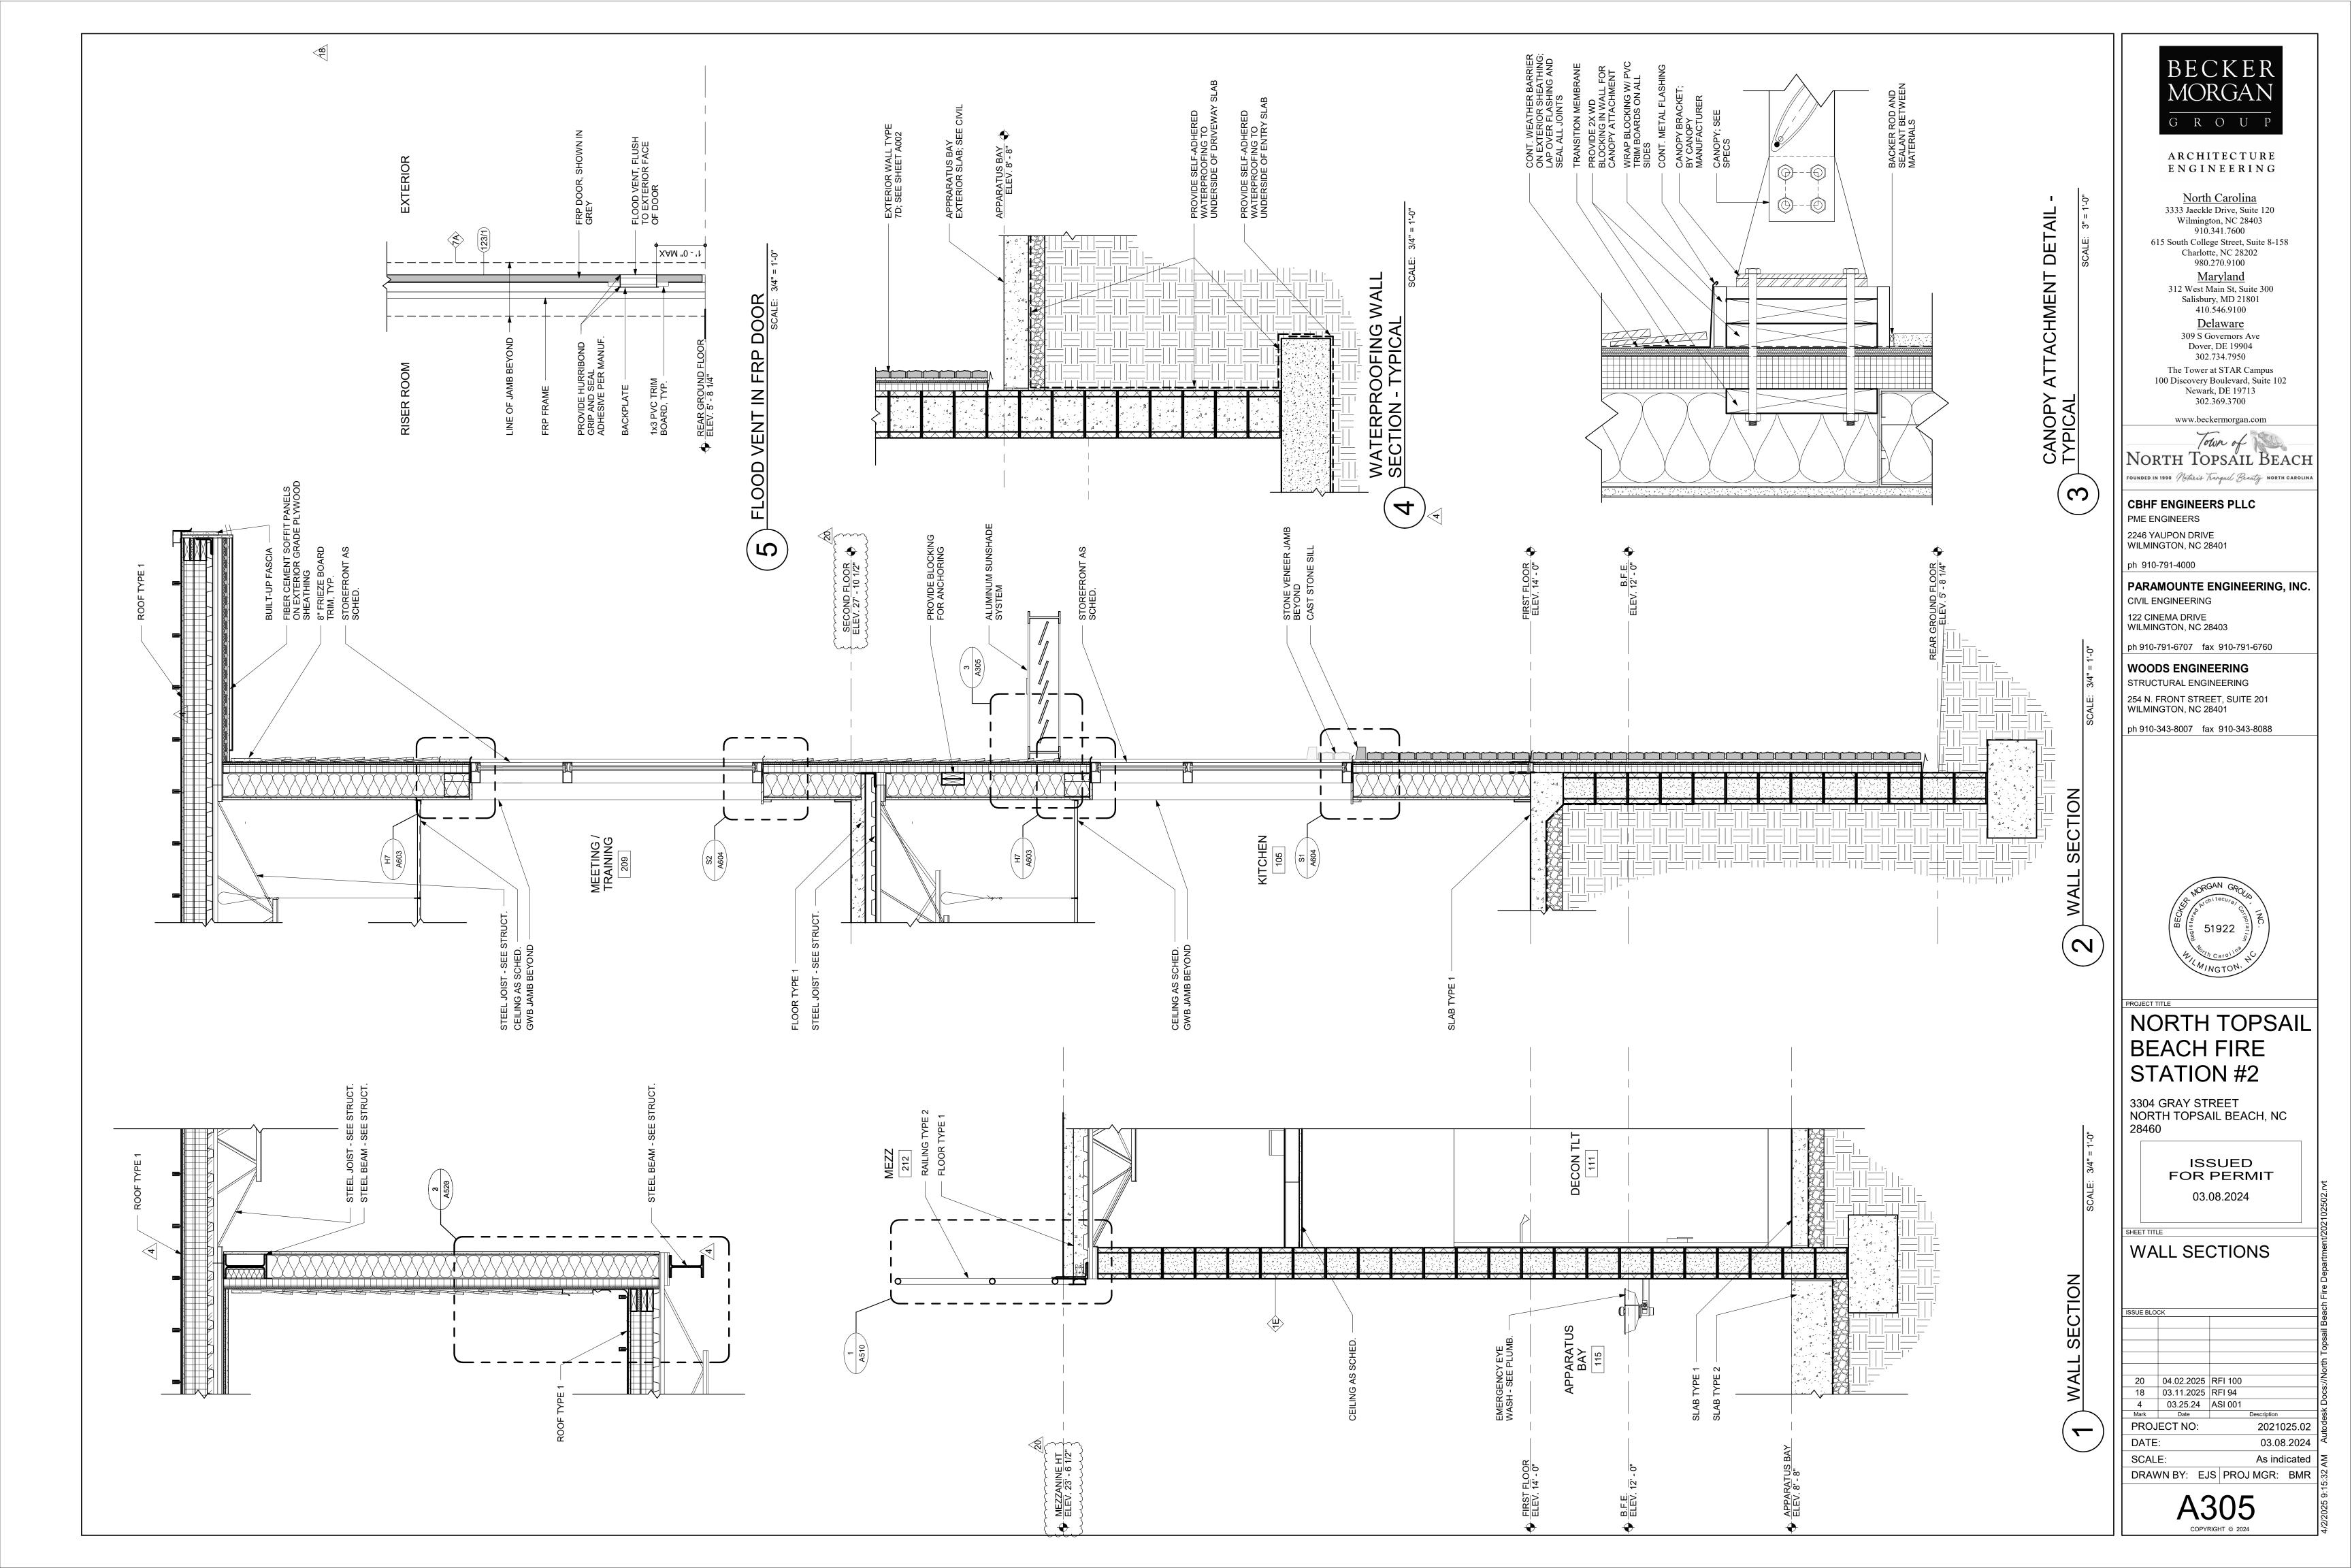
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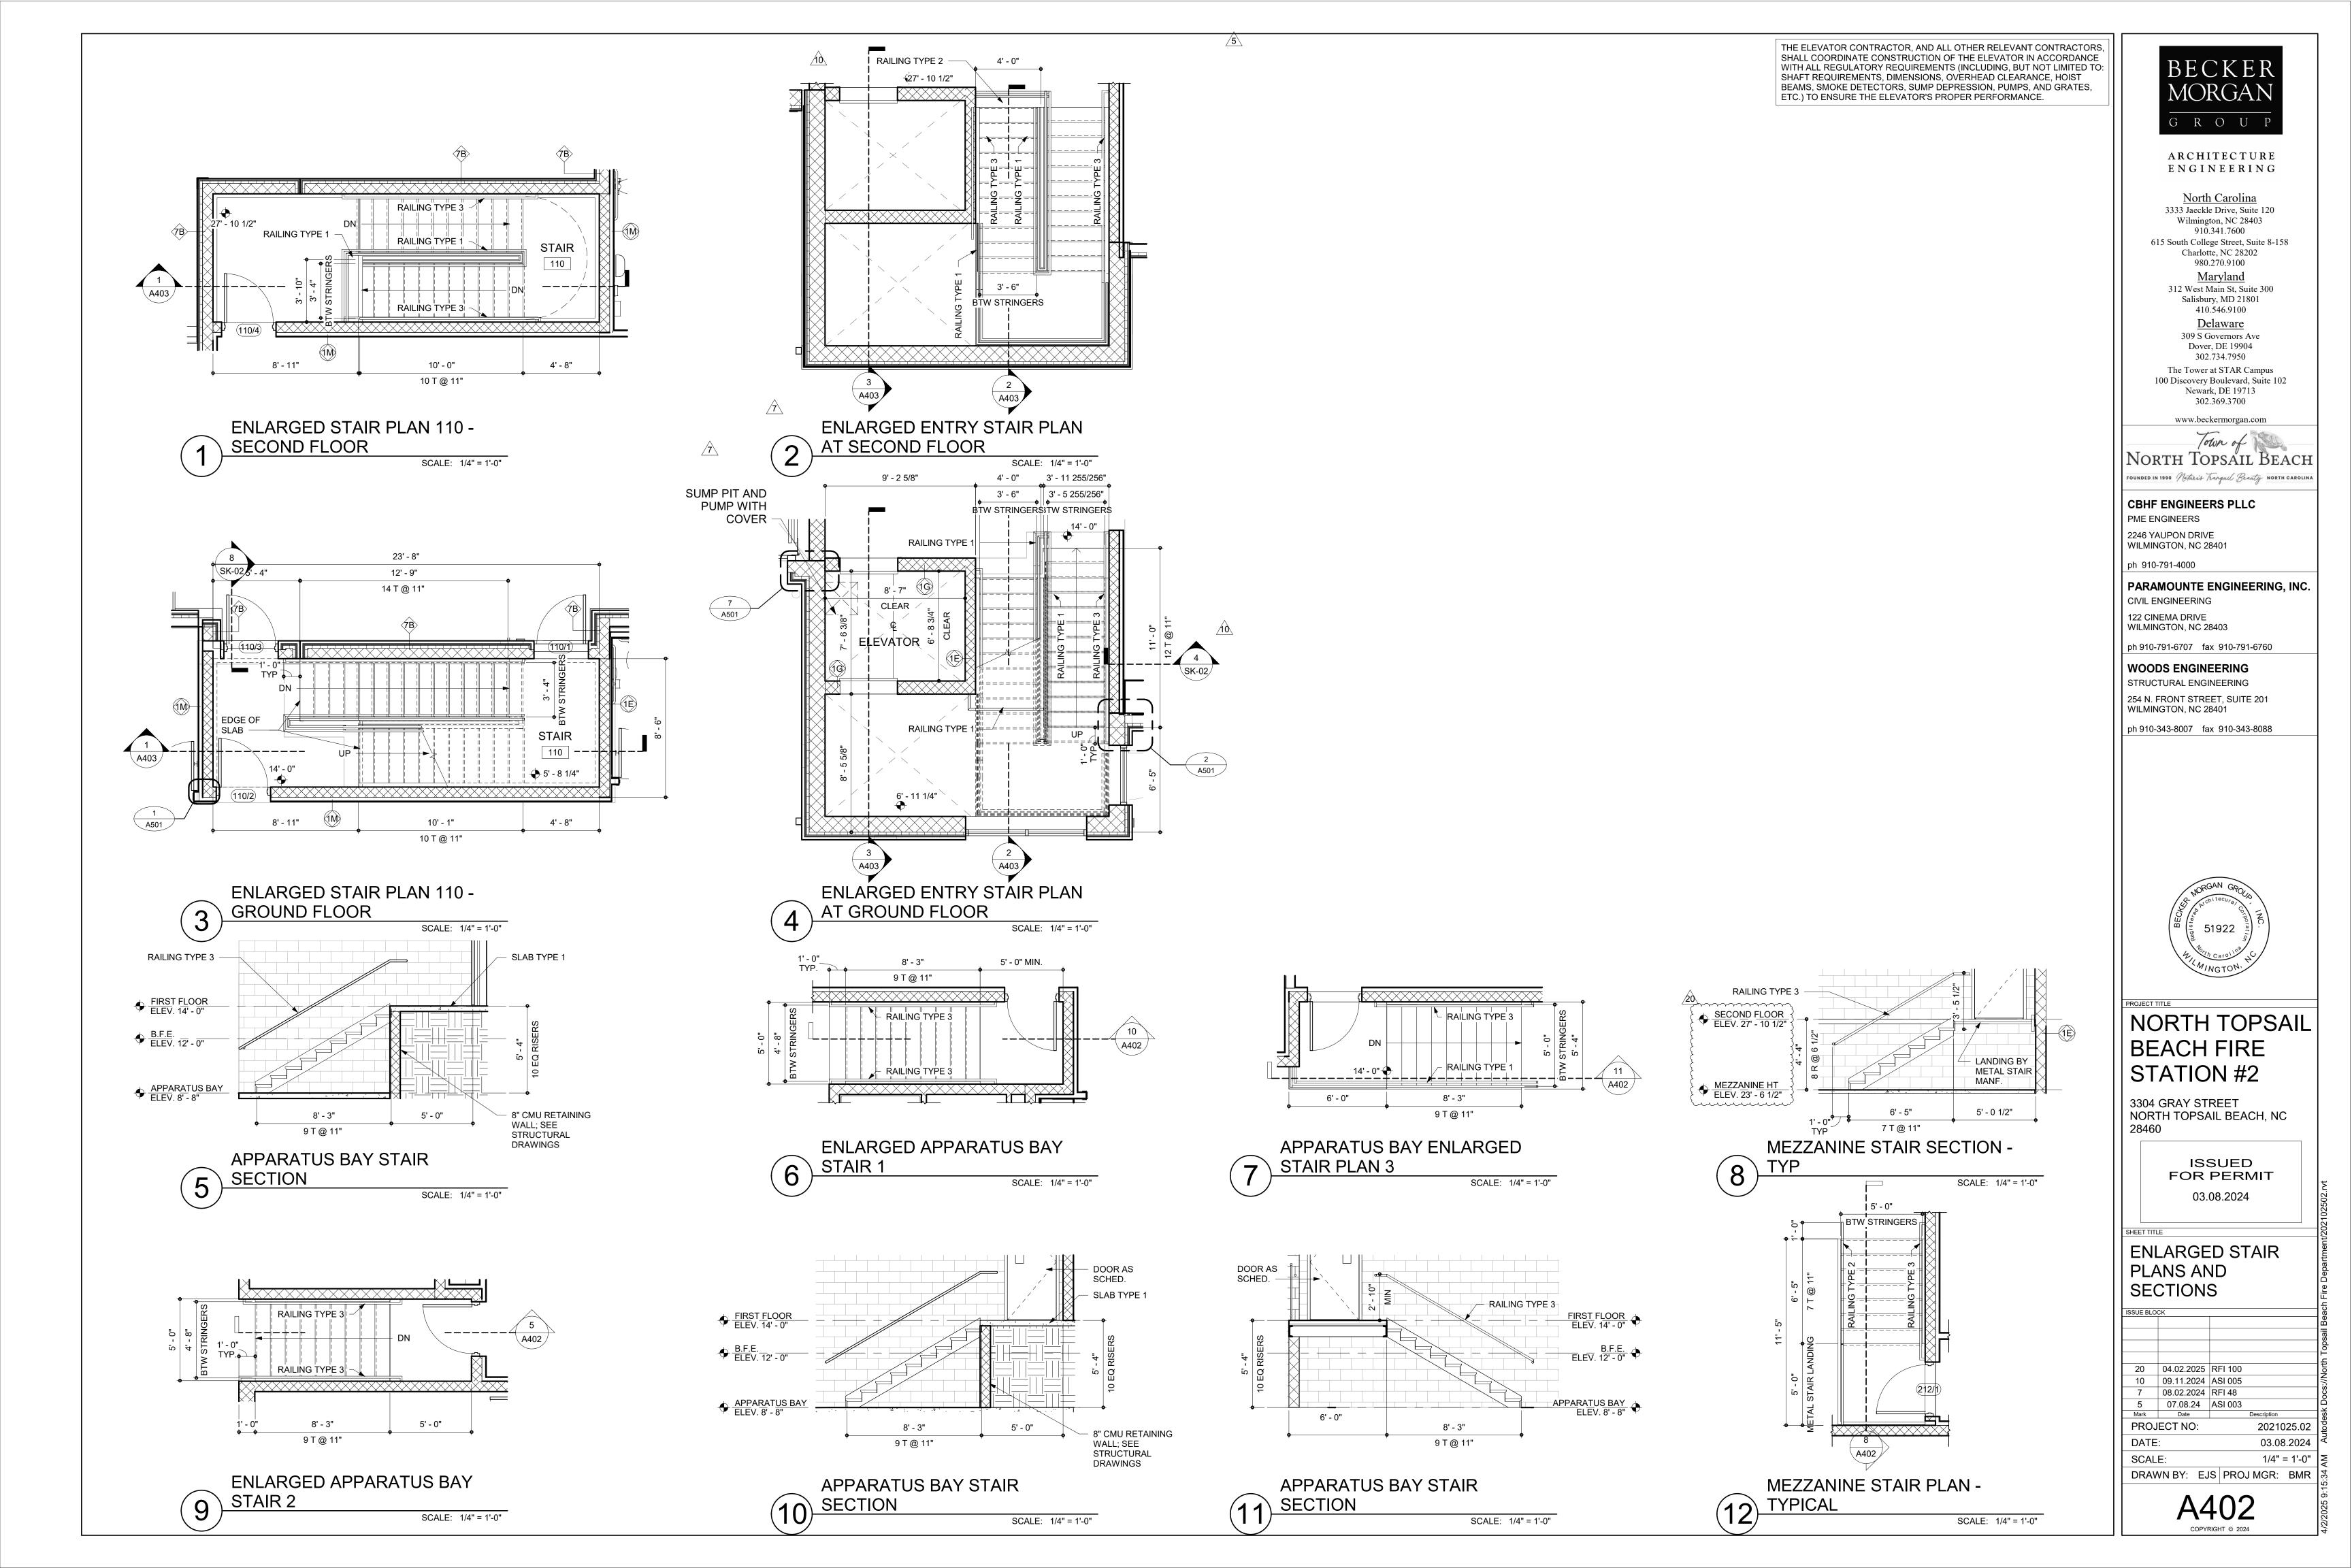
A302


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03.08.2024







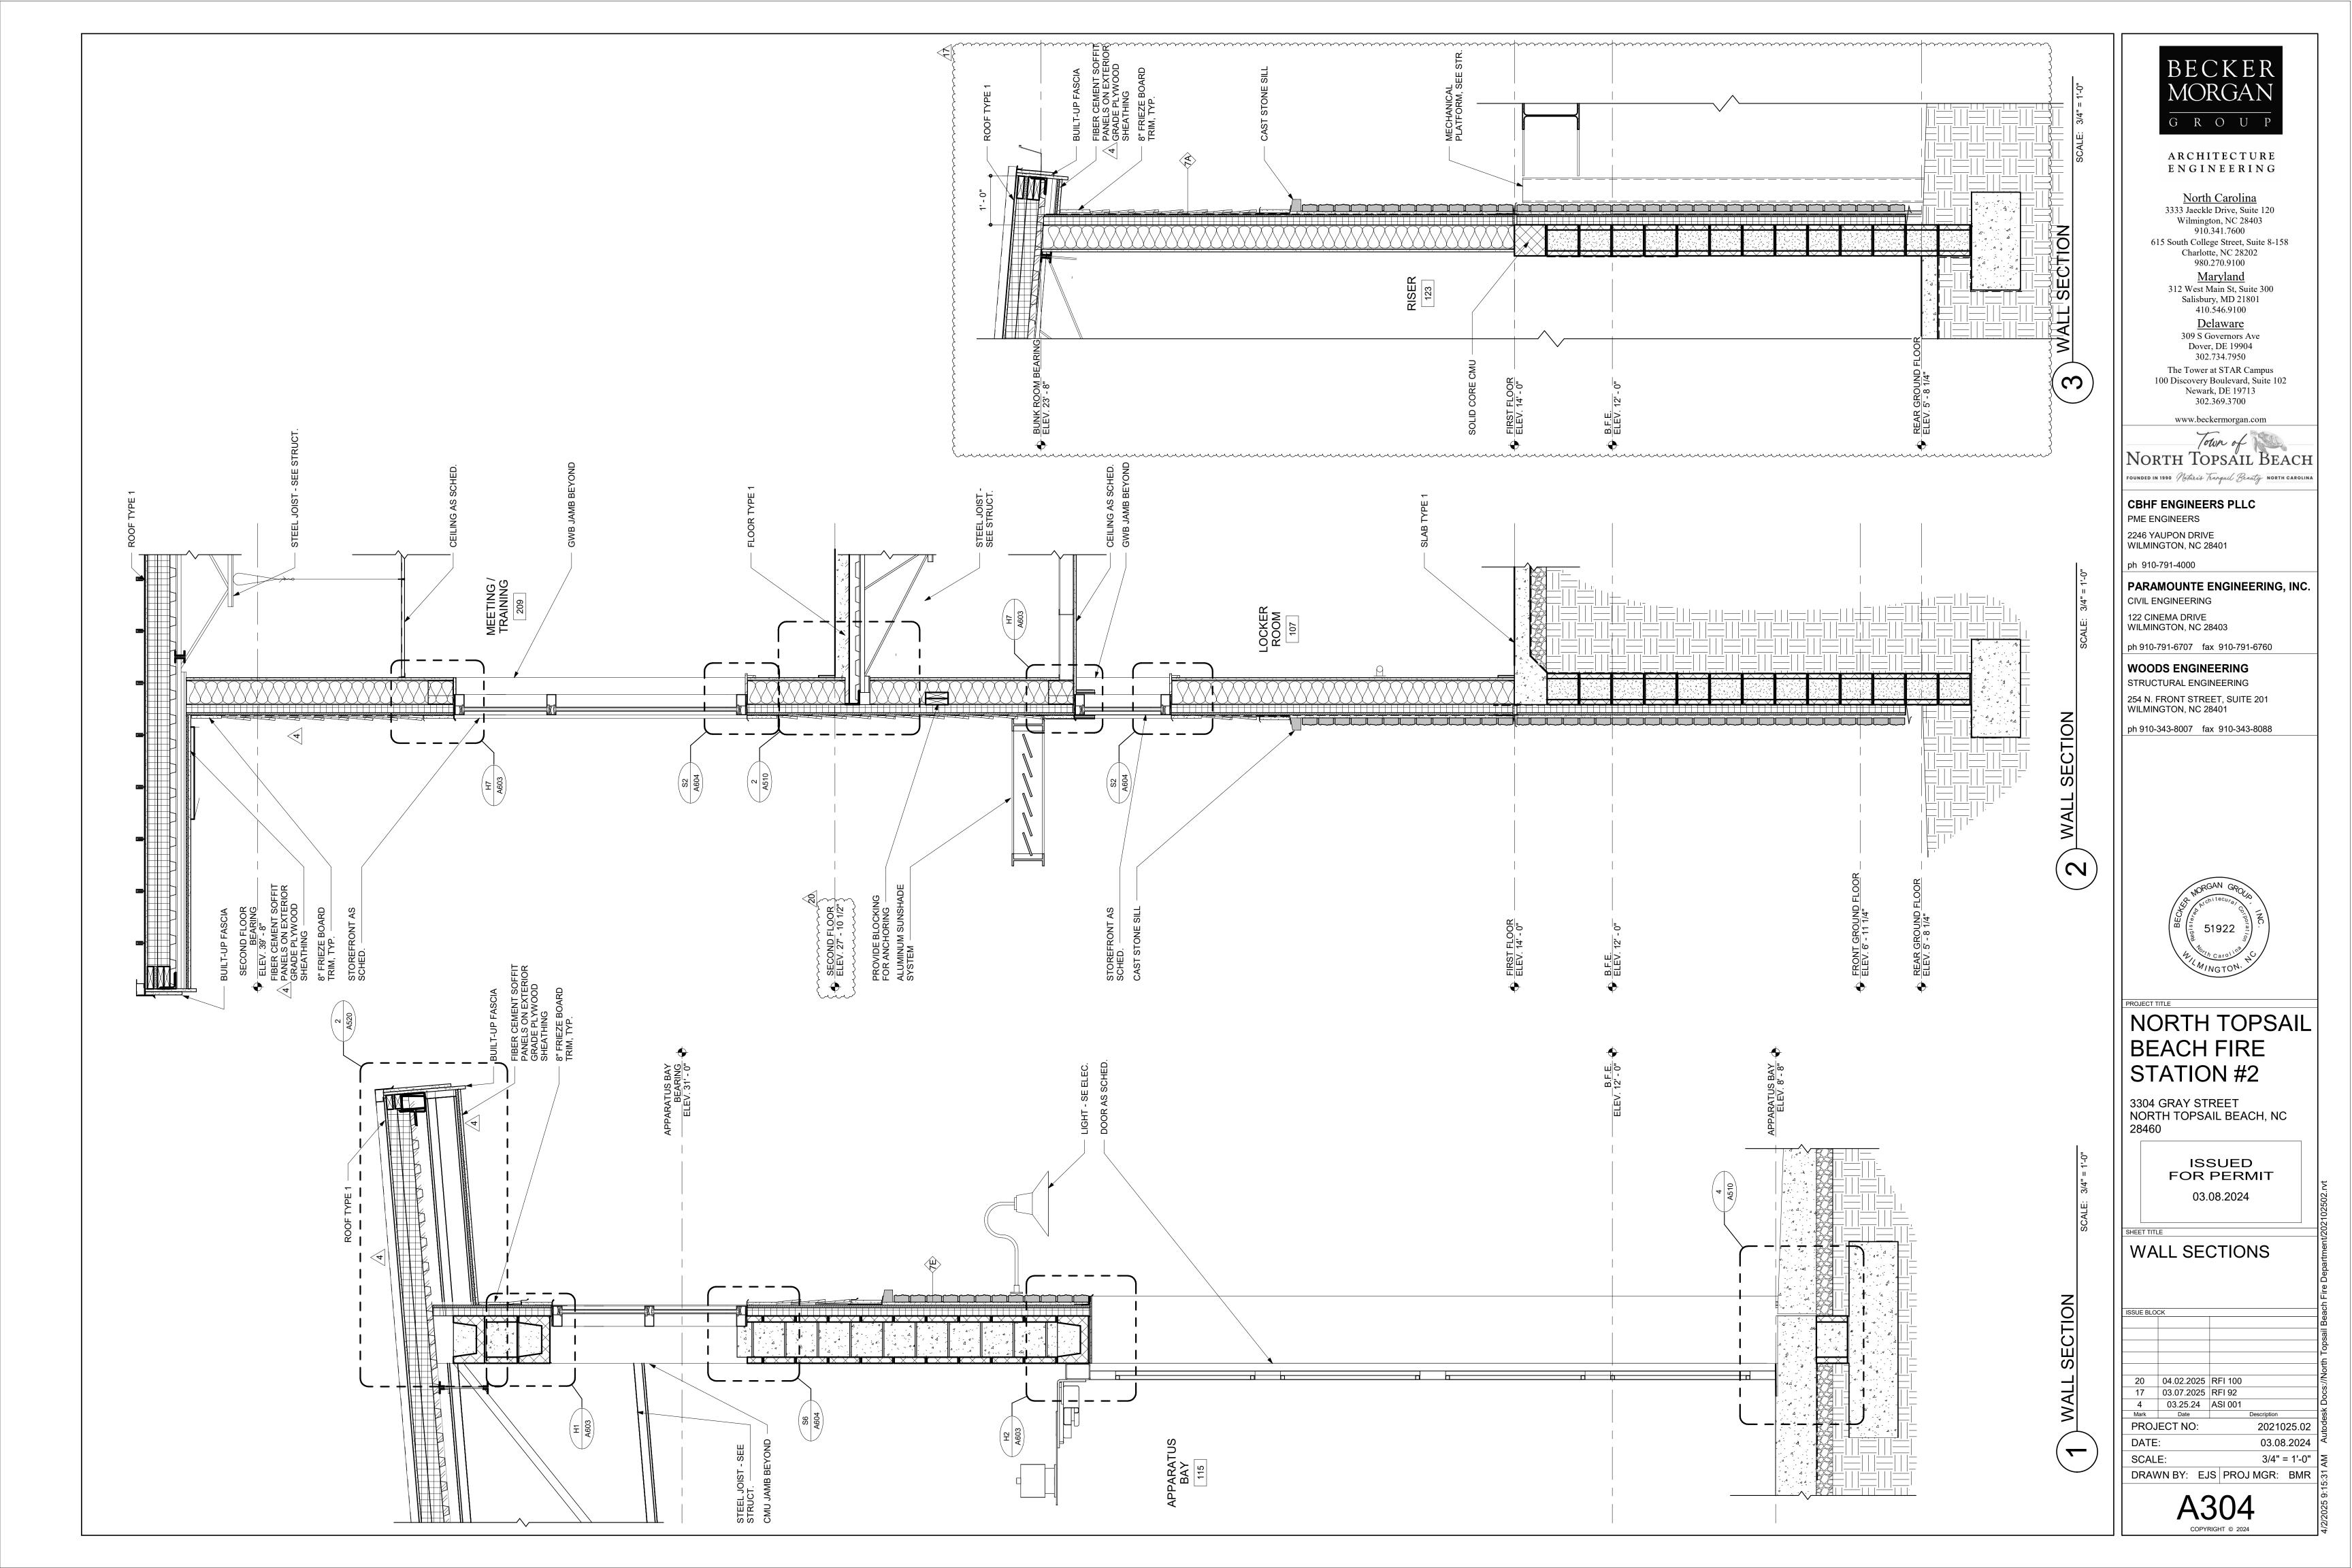

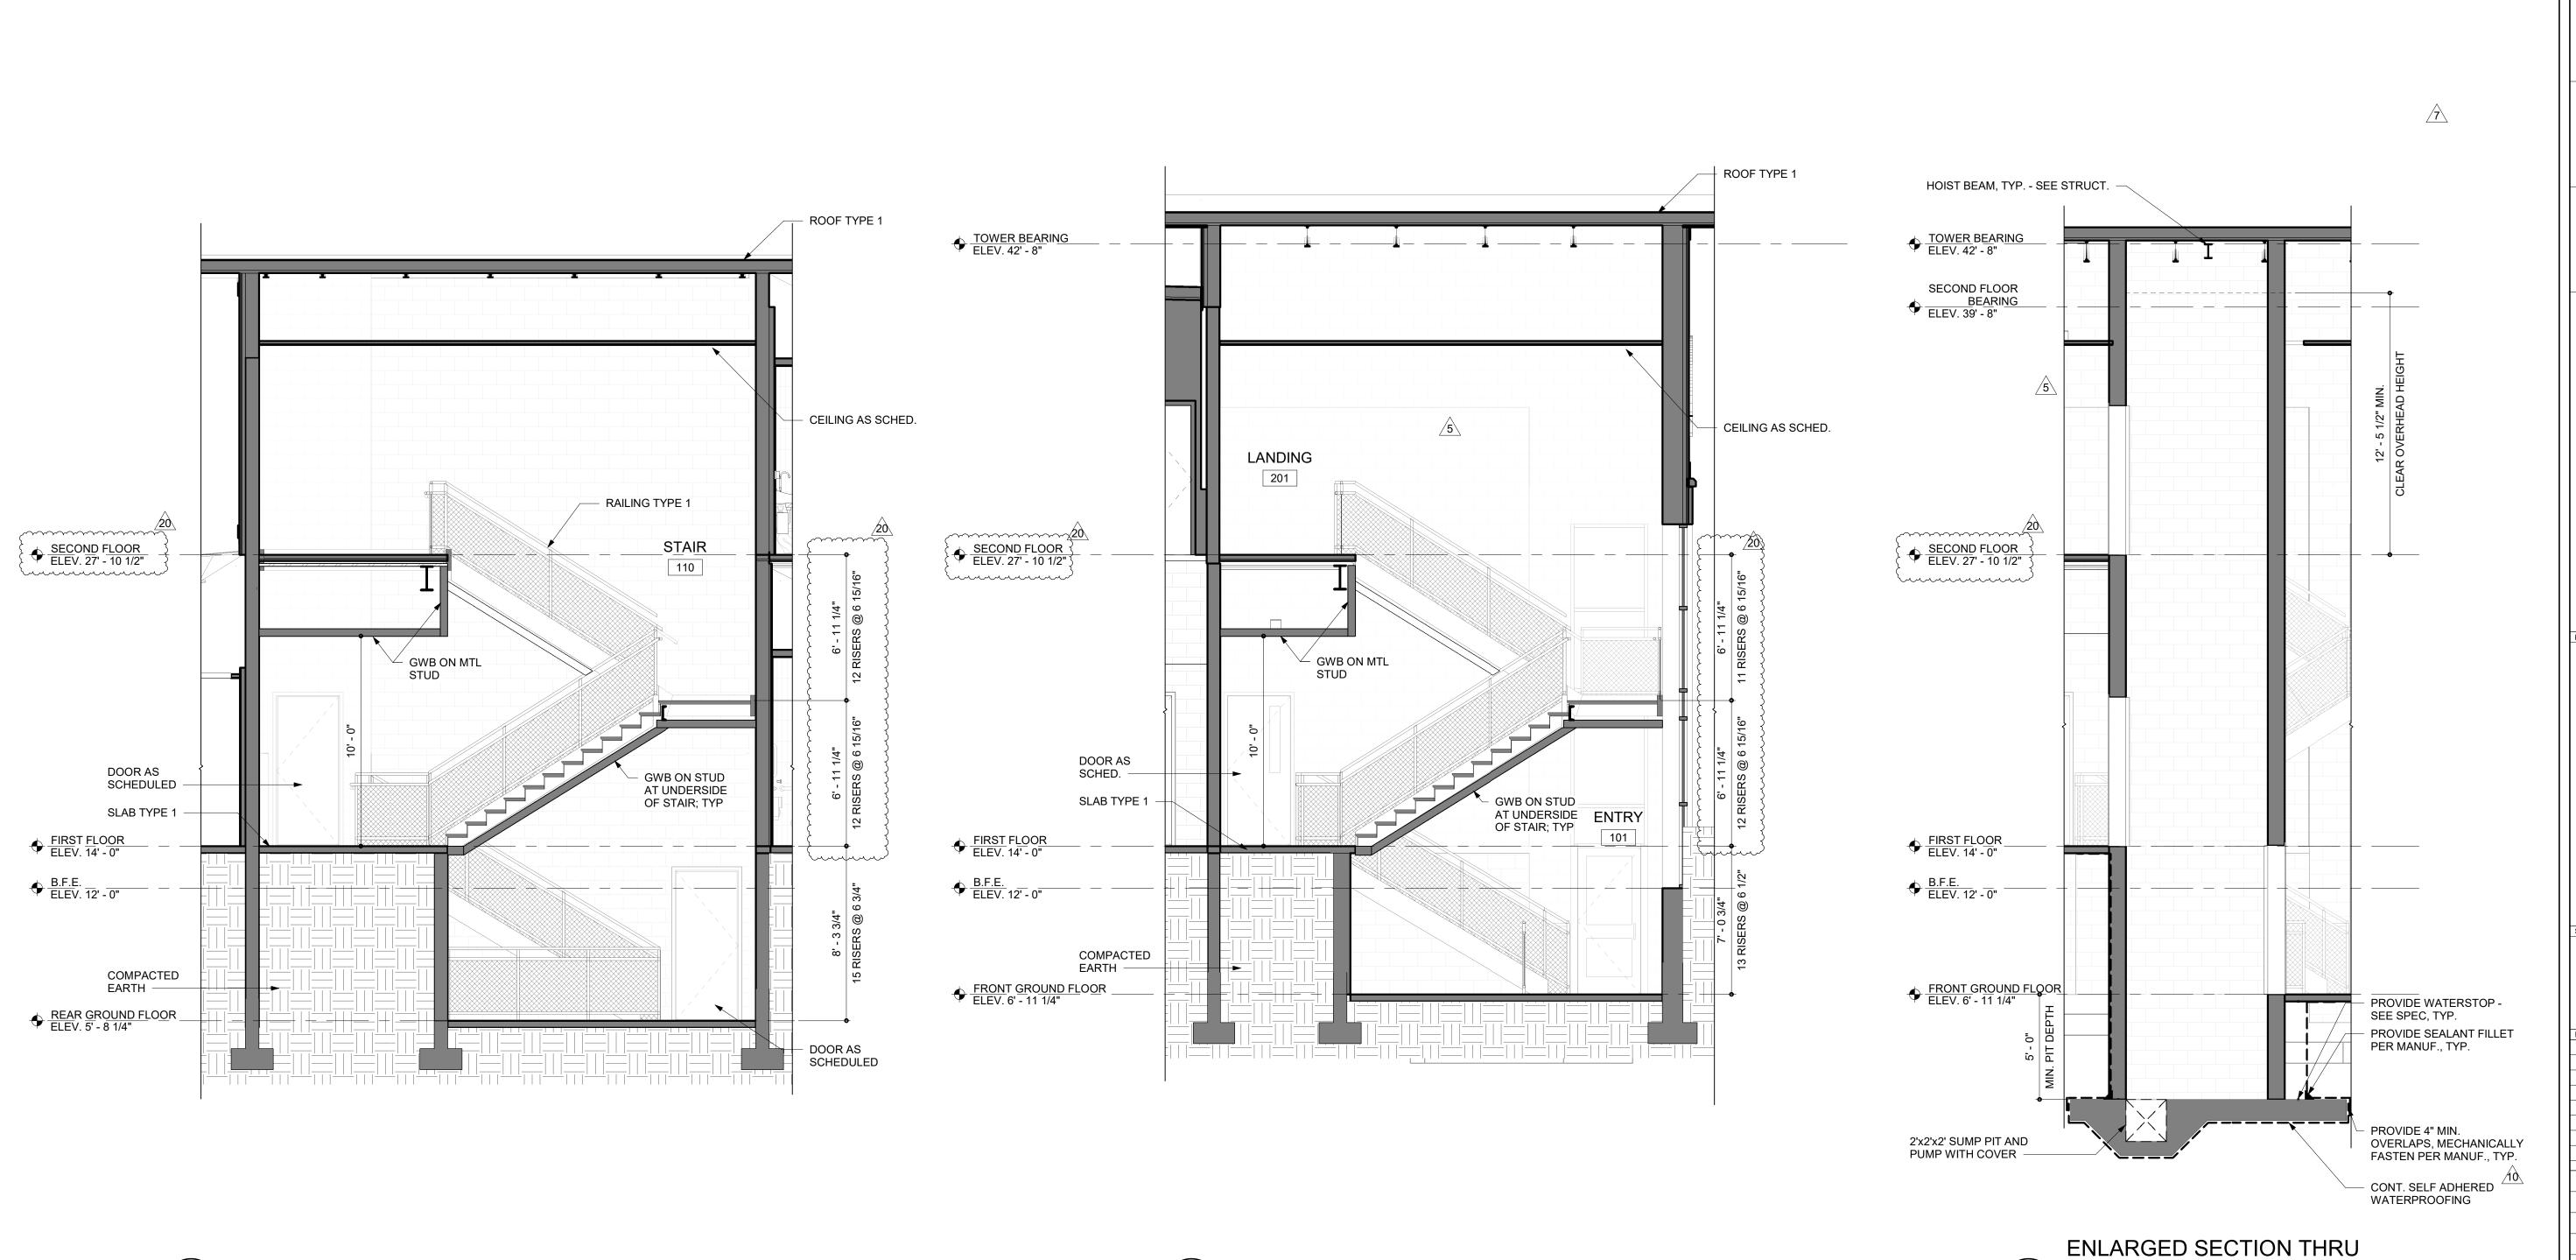G R O U P

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NORTH TOPSAIL BEACH FIRE STATION #2

3304 GRAY STREET NORTH TOPSAIL BEACH, NC 28460

ISSUED FOR PERMIT 03.08.2024

ENLARGED STAIR AND ELEVATOR SECTIONS

20 04.02.2025 RFI 100 10 09.11.2024 ASI 005 7 08.02.2024 RFI 48 5 07.08.24 ASI 003 4 03.25.24 ASI 001 Mark Date

PROJECT NO:

DATE:

\ ELEVATOR

SCALE: 1/4" = 1'-0"

1/4" = 1'-0" DRAWN BY: BMR PROJ MGR: BMR

A403


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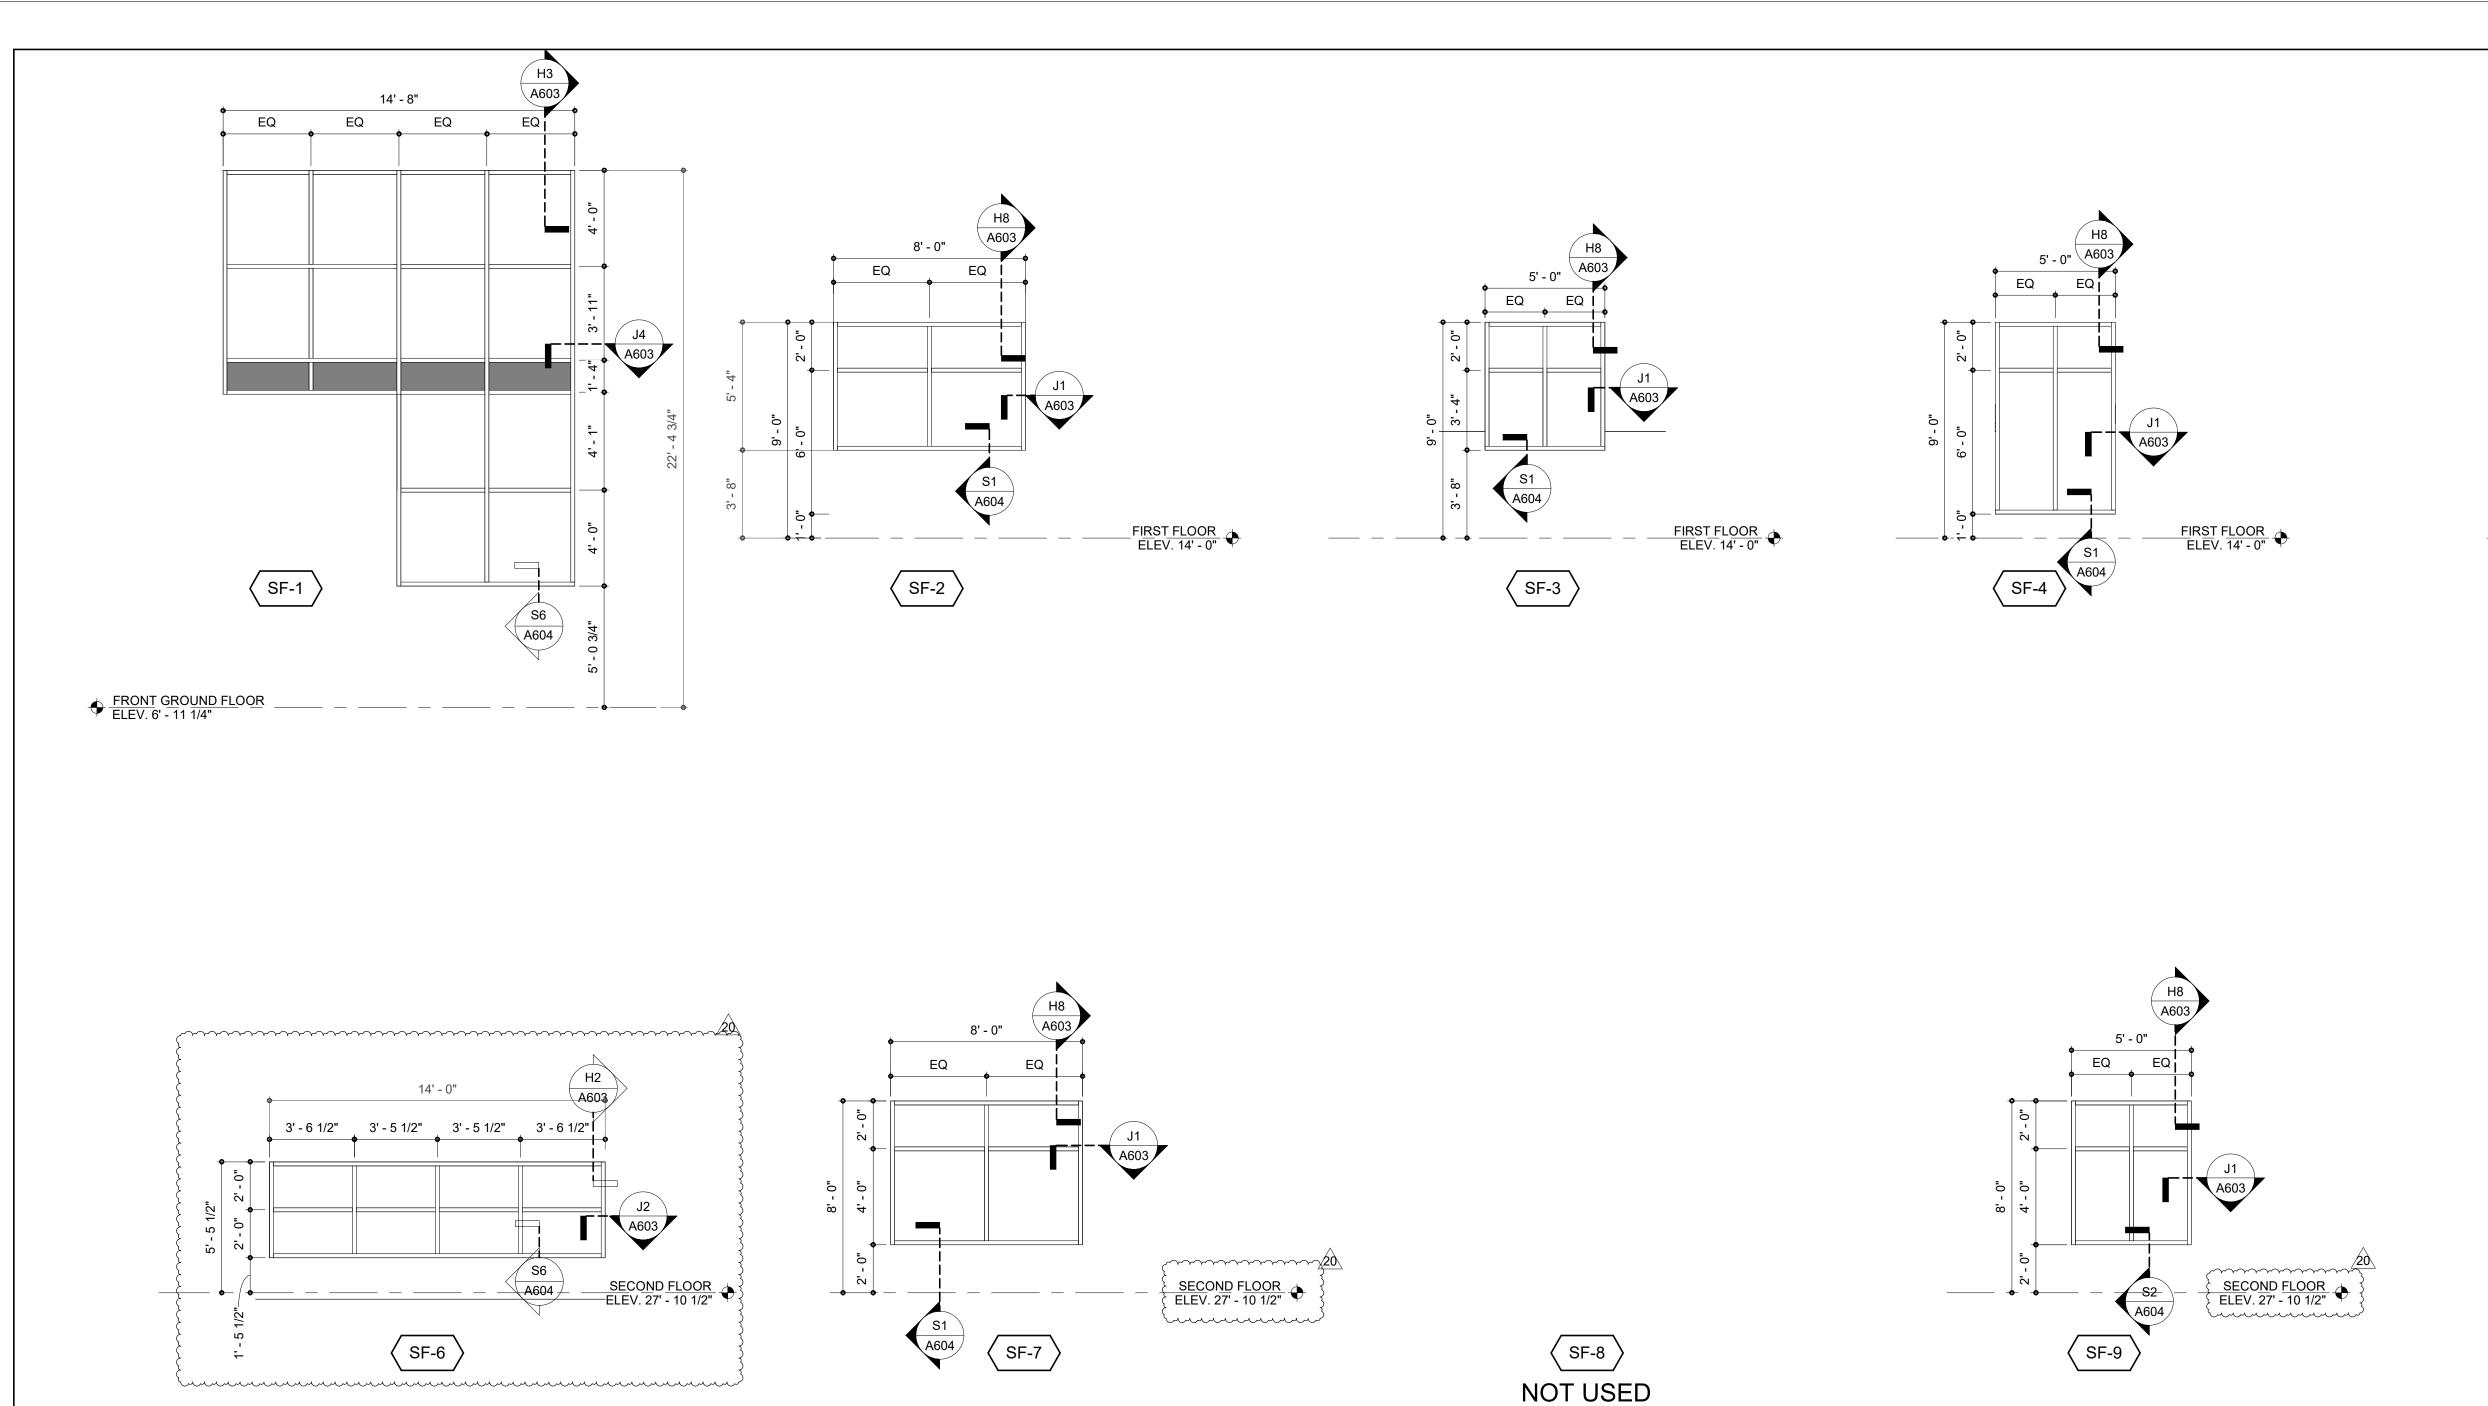
03.08.2024


ENTRY 101 STAIR SECTION


STAIR 110 SECTION

SCALE: 1/4" = 1'-0"



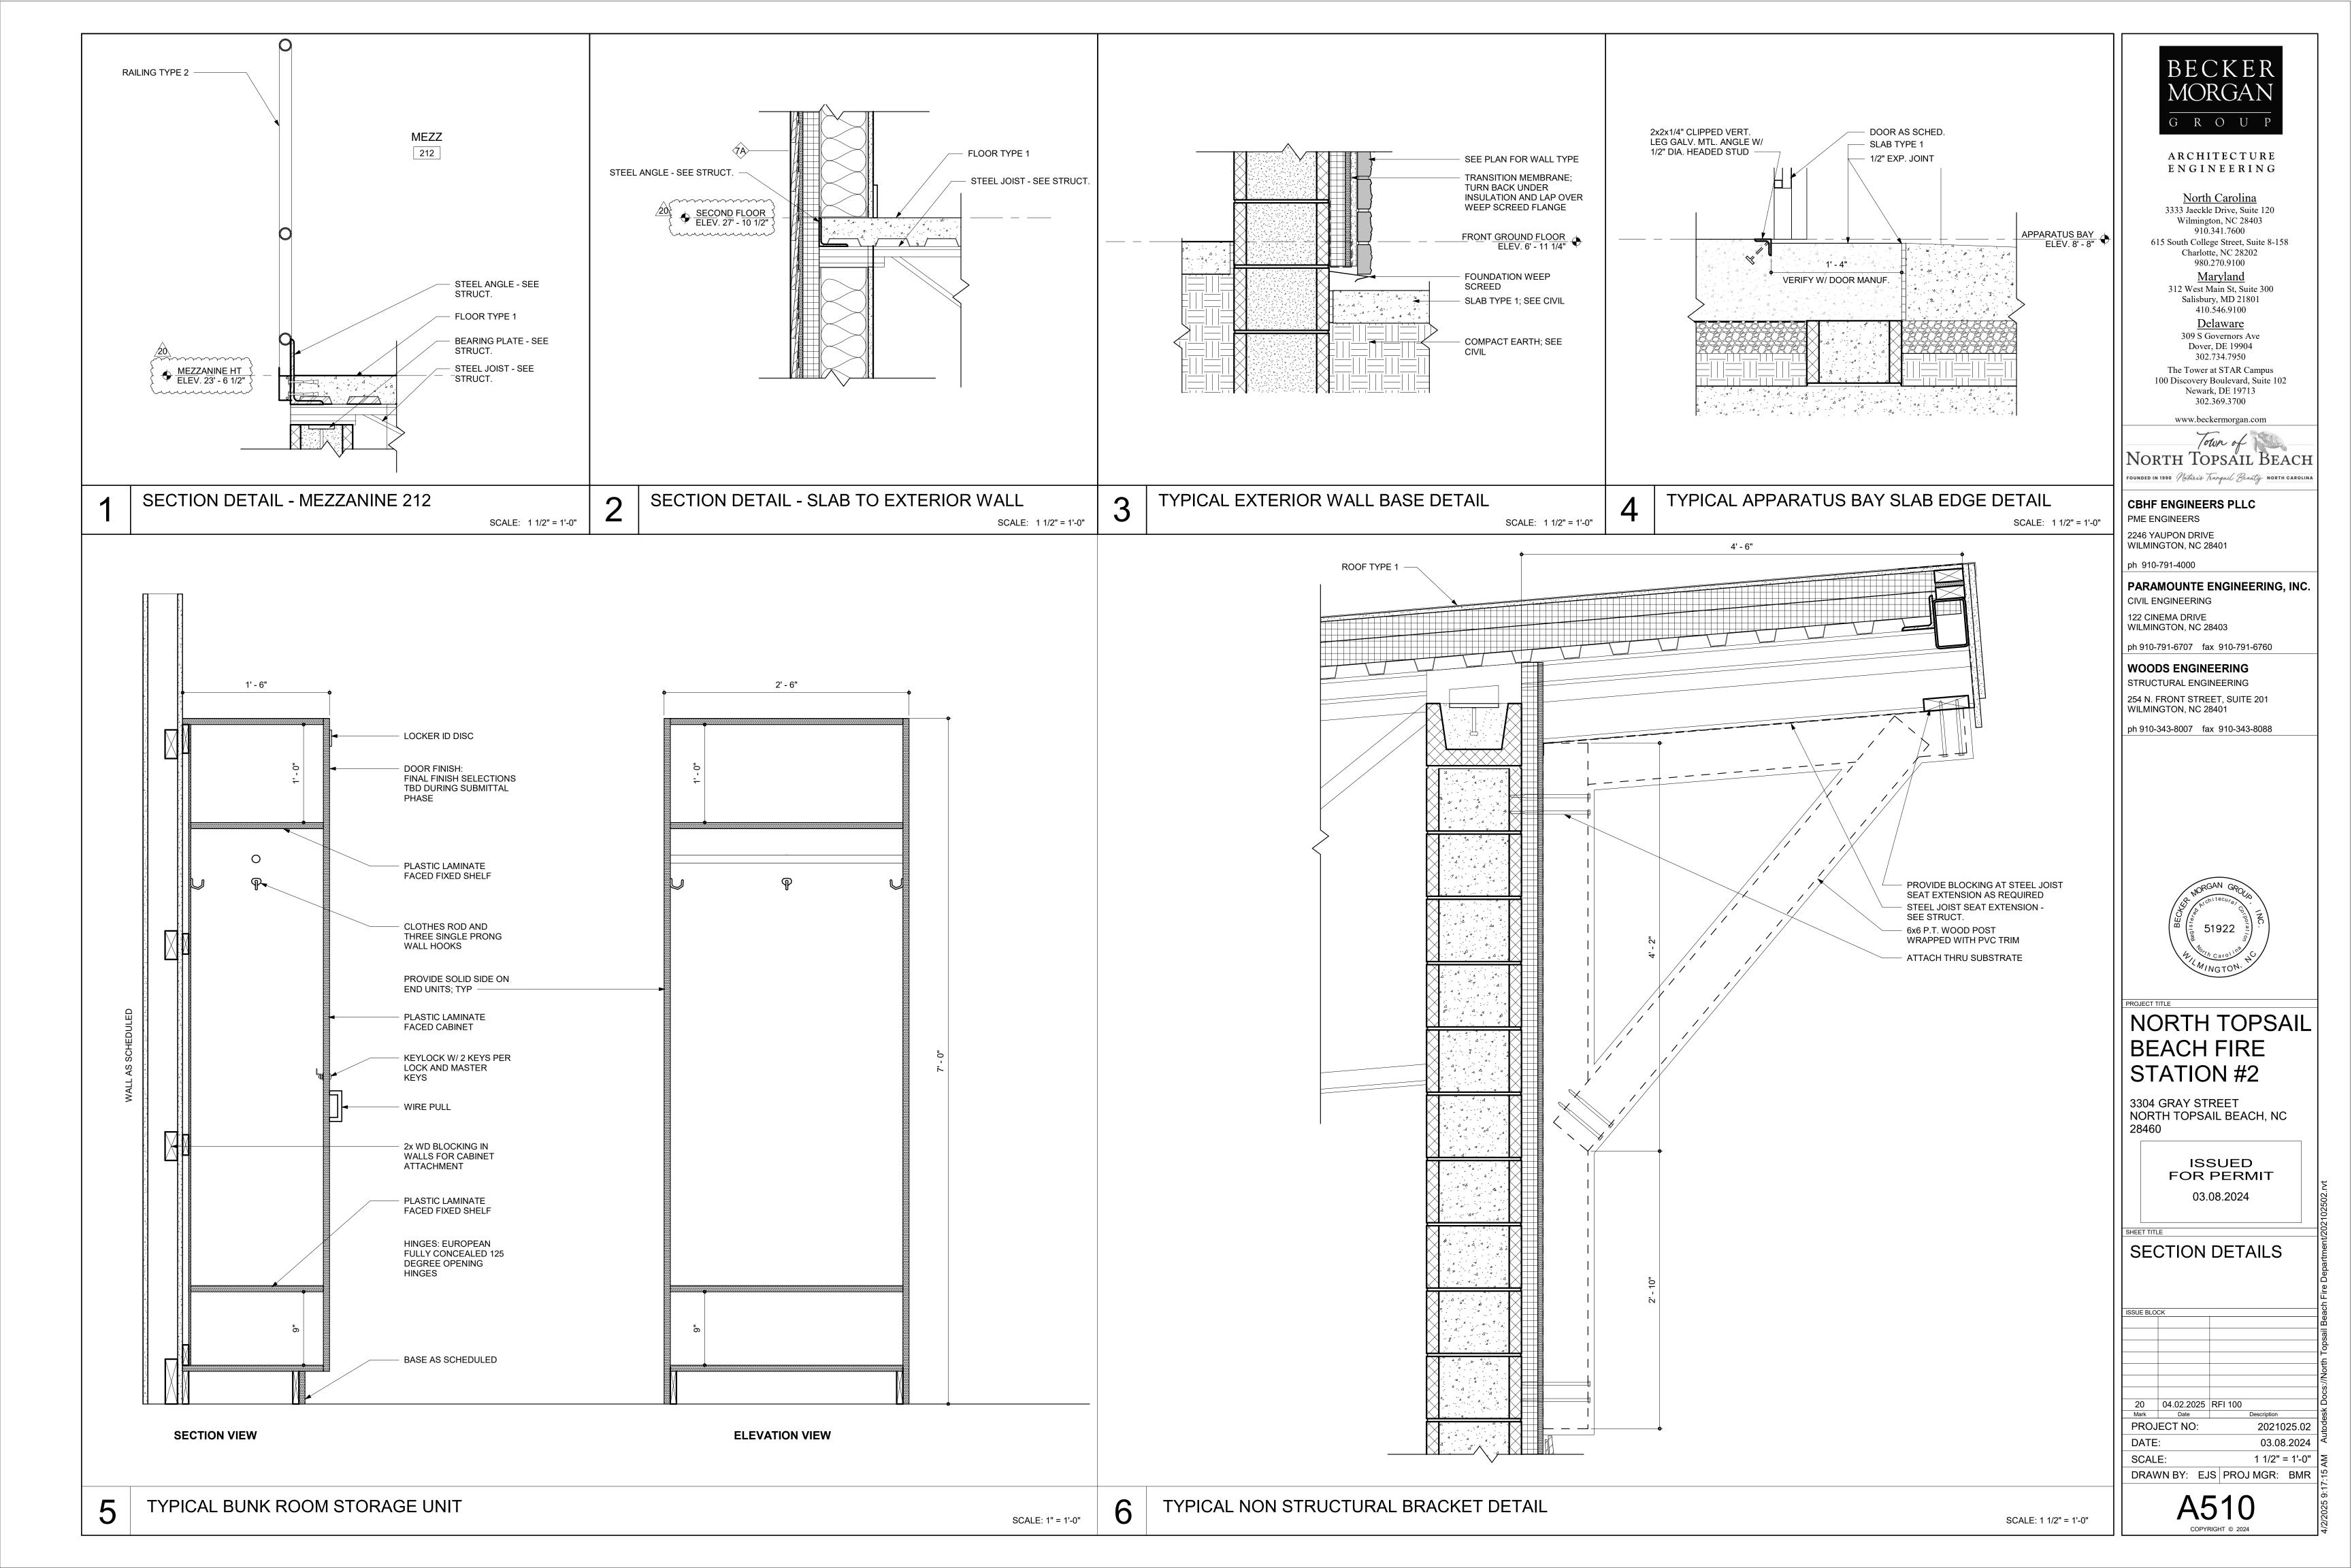

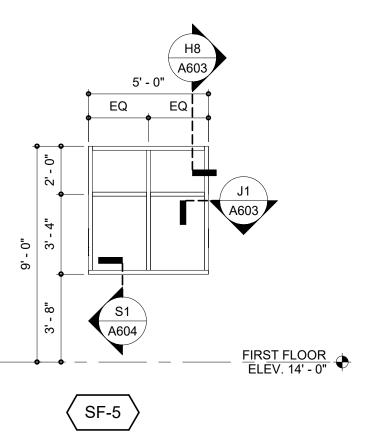

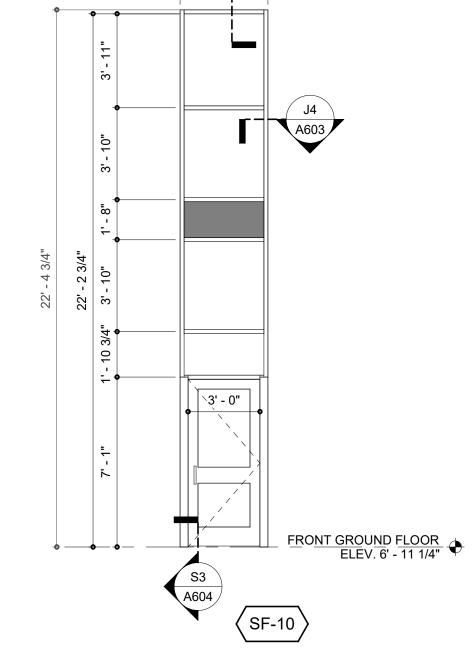

GLAZING LEGEND

- GLAZING SHALL BE TEMPERED IN DOORS, BORROW LIGHTS, SIDE LIGHTS, AND AS REQUIRED BY CODE, AND AS INDICATED GLAZING SHALL BE SAFETY LAMINATED AS REQUIRED BY CODE, AND AS INDICATED.
- CODE, AND AS INDICATED.

 3. PROVIDE FIRE-PROTECTION AND FIRE-RESISTANCE RATED GLAZING AS REQUIRED BY CODE.

 4. EXTERIOR GLAZING SHALL BE INSULATED.
 - LAMINATED GLAZING





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NORTH TOPSAIL BEACH FIRE STATION #2

3304 GRAY STREET NORTH TOPSAIL BEACH, NC

> ISSUED FOR PERMIT 03.08.2024

STOREFRONT ELEVATIONS

ISSUE BLOCK

20 04.02.2025 RFI 100
Mark Date Description

 PROJECT NO:
 2021025.02

 DATE:
 03.08.2024


 SCALE:
 As indicated

SCALE: As indicated

DRAWN BY: EJS PROJ MGR: BMR

A602


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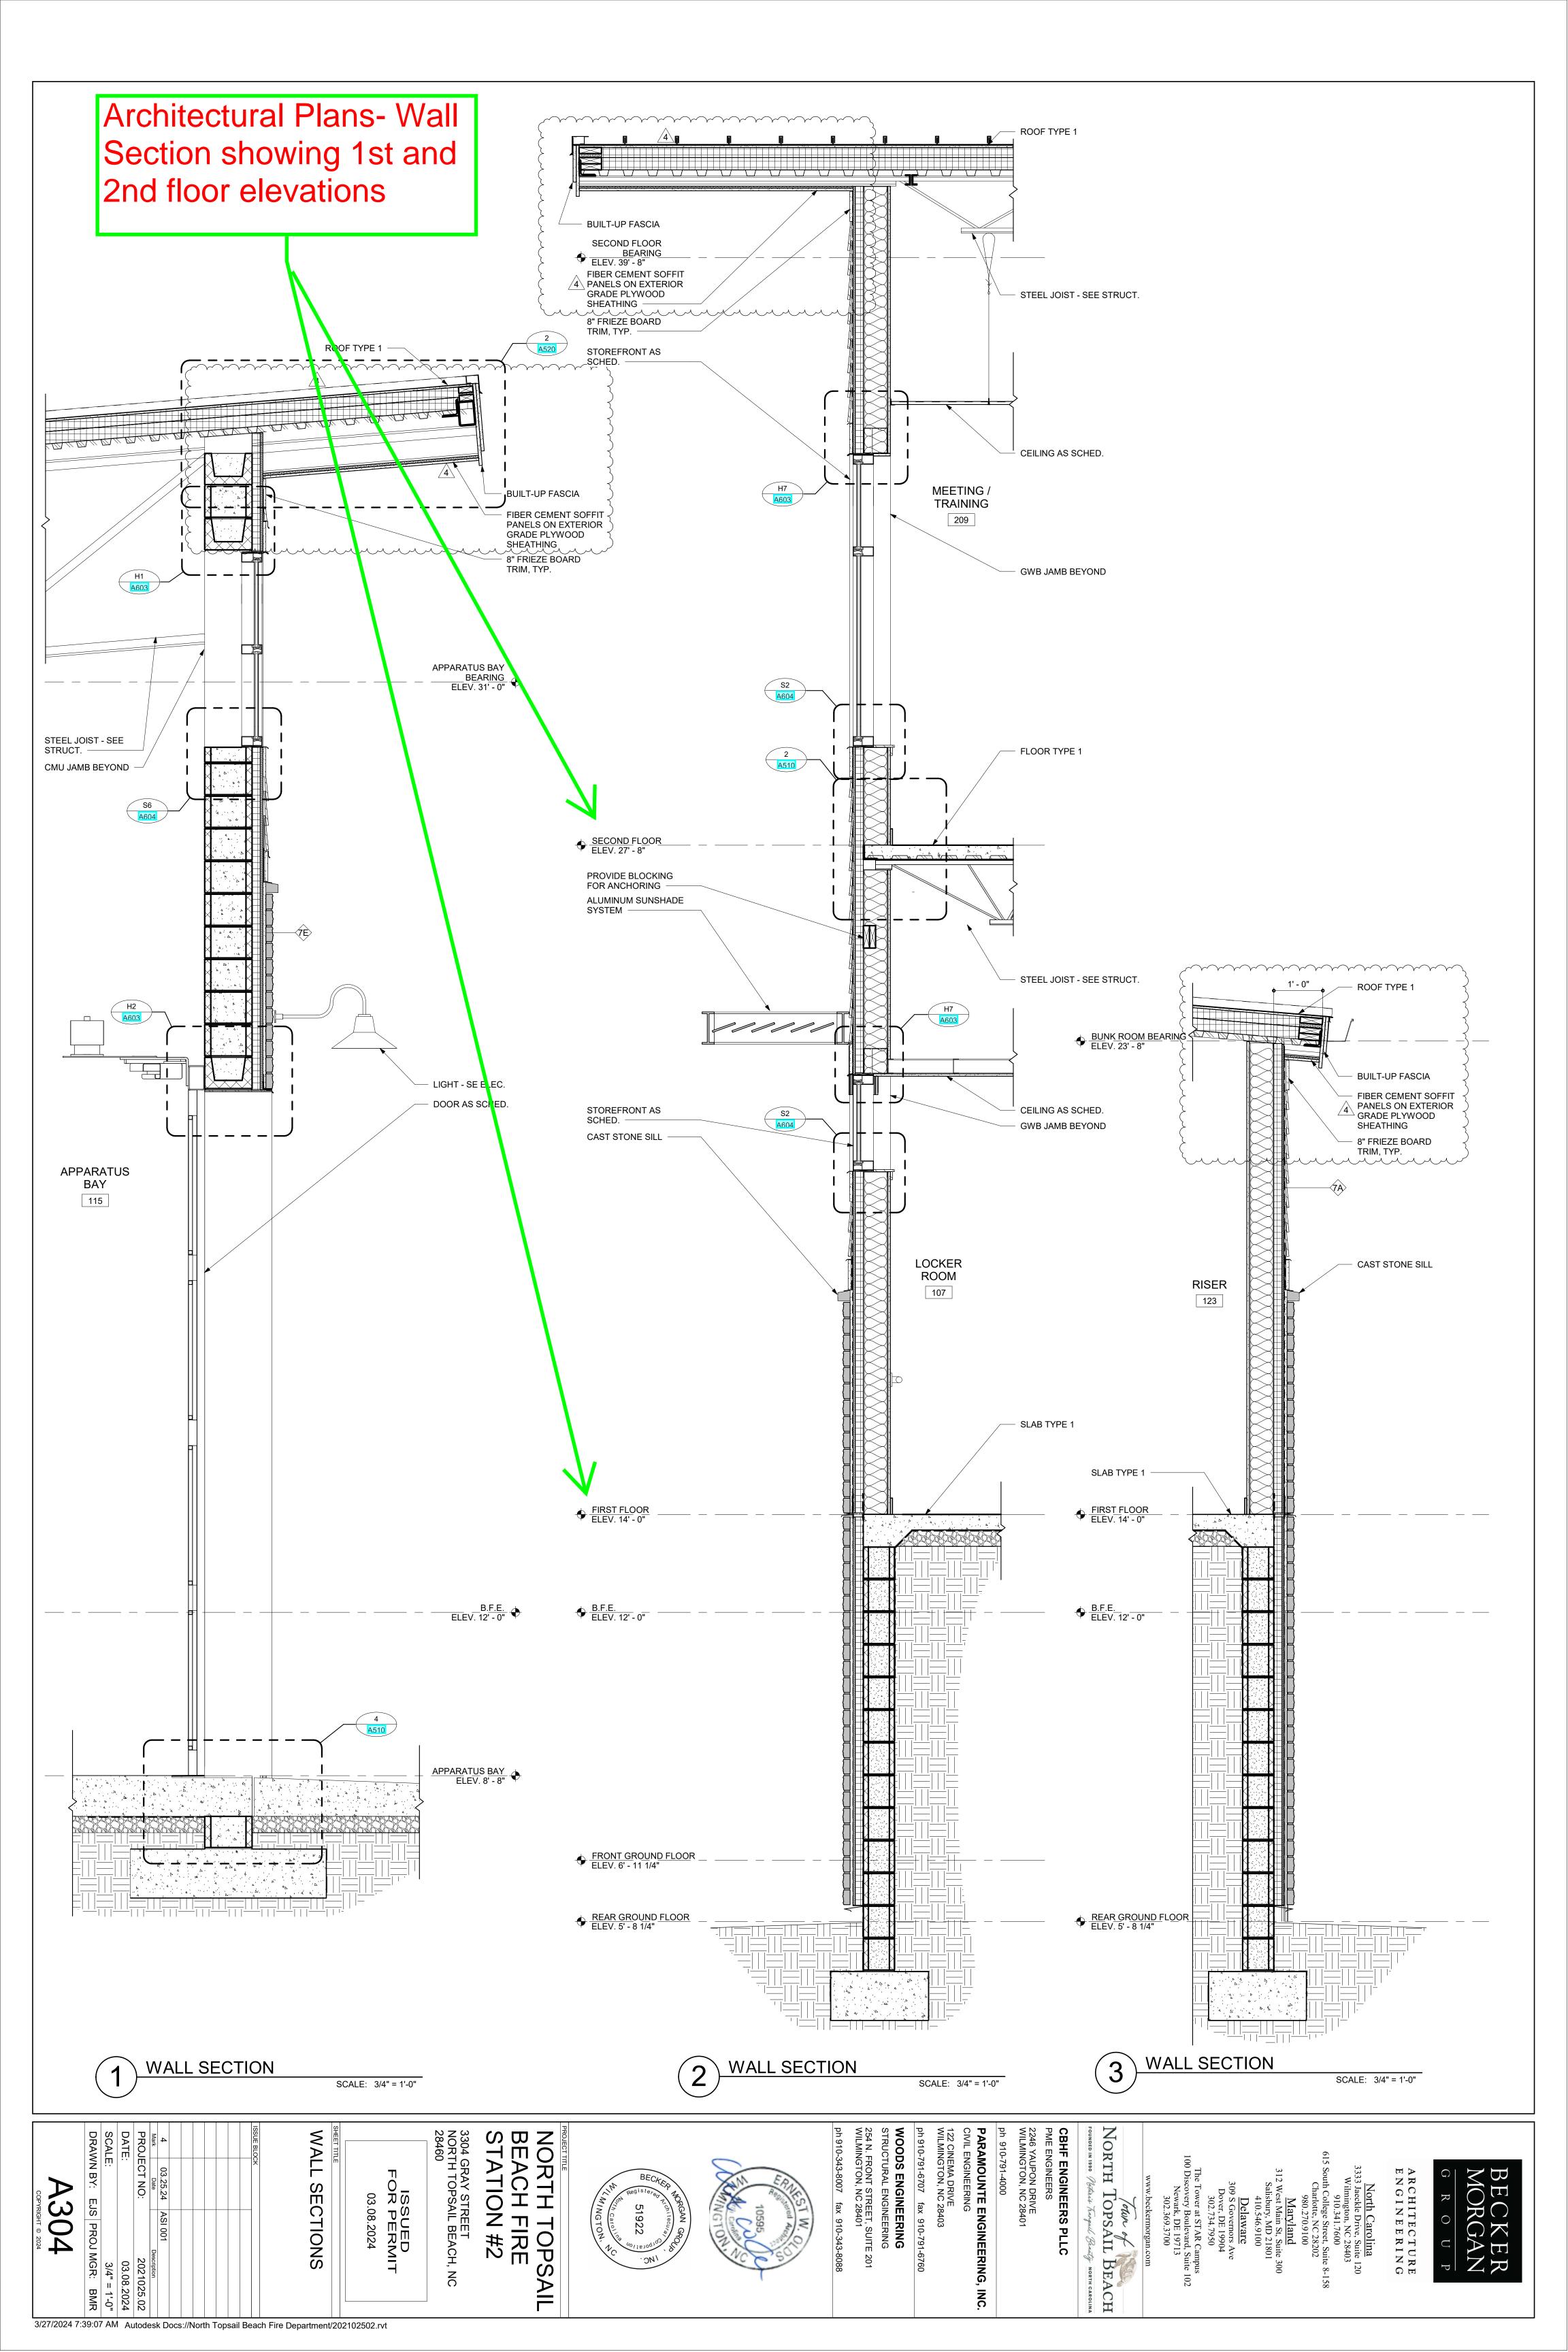


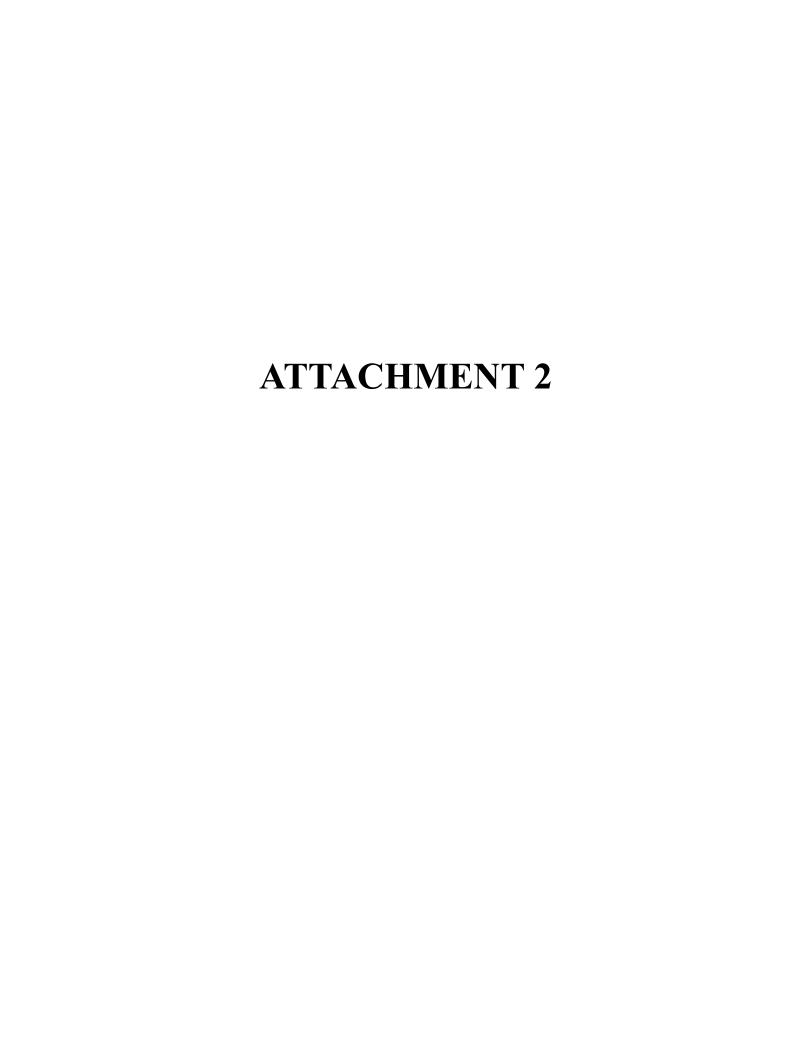REQUEST FOR INFORMATION



CONTRACT NUMBER: 2021025.02 NTBFS				RFI NUMBER:	101
CONTRACT TITLE:				KI I NOMBLIK.	101
North Topsail Beach Fire Station	າ #2				
PRIME CONTRACTOR:		CLIENT:			
WB Brawley Company					
Matt Ribakow			kwilson@becker		
mribakow@brawley.net SUBJECT/TITLE OF RFI: URG	ENT_ 1et Floor Structure		reid@beckermo	rgan.com	
30B3ECT/TITLE OF KITE ONG	LIVIT- ISCI 1001 SCIUCTUR	ii Stuu Leiigt	"		
DRAWING(S): A304	DETAIL(S) A304-2	SPECIF 054000	FICATION:	CPM ACTIVITY	NUMBER:
Cost Effect: ☐ Incre Schedule Impact: ☐ Incre			BD BD		
INFORMATION REQUESTE	D & RECOMMENDED	SOLUTION:			
5 6	5 G. (20011111211525	0020110111			
Per direction to raise the 2 nd Florapproved shop drawings (attach attached) showing the finished florapproved showing the finished florapproxed showing the finished florapproved showing the finished florapproxed showing the finished florapproved showing the florapproxed showing the finished florapproxed showing the finished florapproxed showing the fl	ed for reference) for the s	0.5", the struc tructural stud	tural studs for th design was base	e 1 st floor are 2.5" ed on detail 2 on <i>l</i>	short. The A304 (also
We are currently waiting to proce	eed with 1st floor structura	l steel framing	g and need direc	tion as soon as po	ossible.
Date Response Required By:	URGENT 4/12/25 Da	ite: 4/2/25	Signature	: Matt Ribakov	ı
RESPONSE:					
PLEASE SEE DIRECTION					
From: Cait Fitzsimmons The RFI system is intended to provide a authorize the contractor to proceed with changed condition, written notice to the	work - to do so, the contractor p	nding to contractor roceeds at his ov	or's request for inforn or risk. If the contrac		tem DOES NOT
DISTRIBUTION: Original to File via	ROICC□ PL/DM □ F	T \square A/F \square	PC# viz	a ROICC/CONTRACT	ING OFFICER



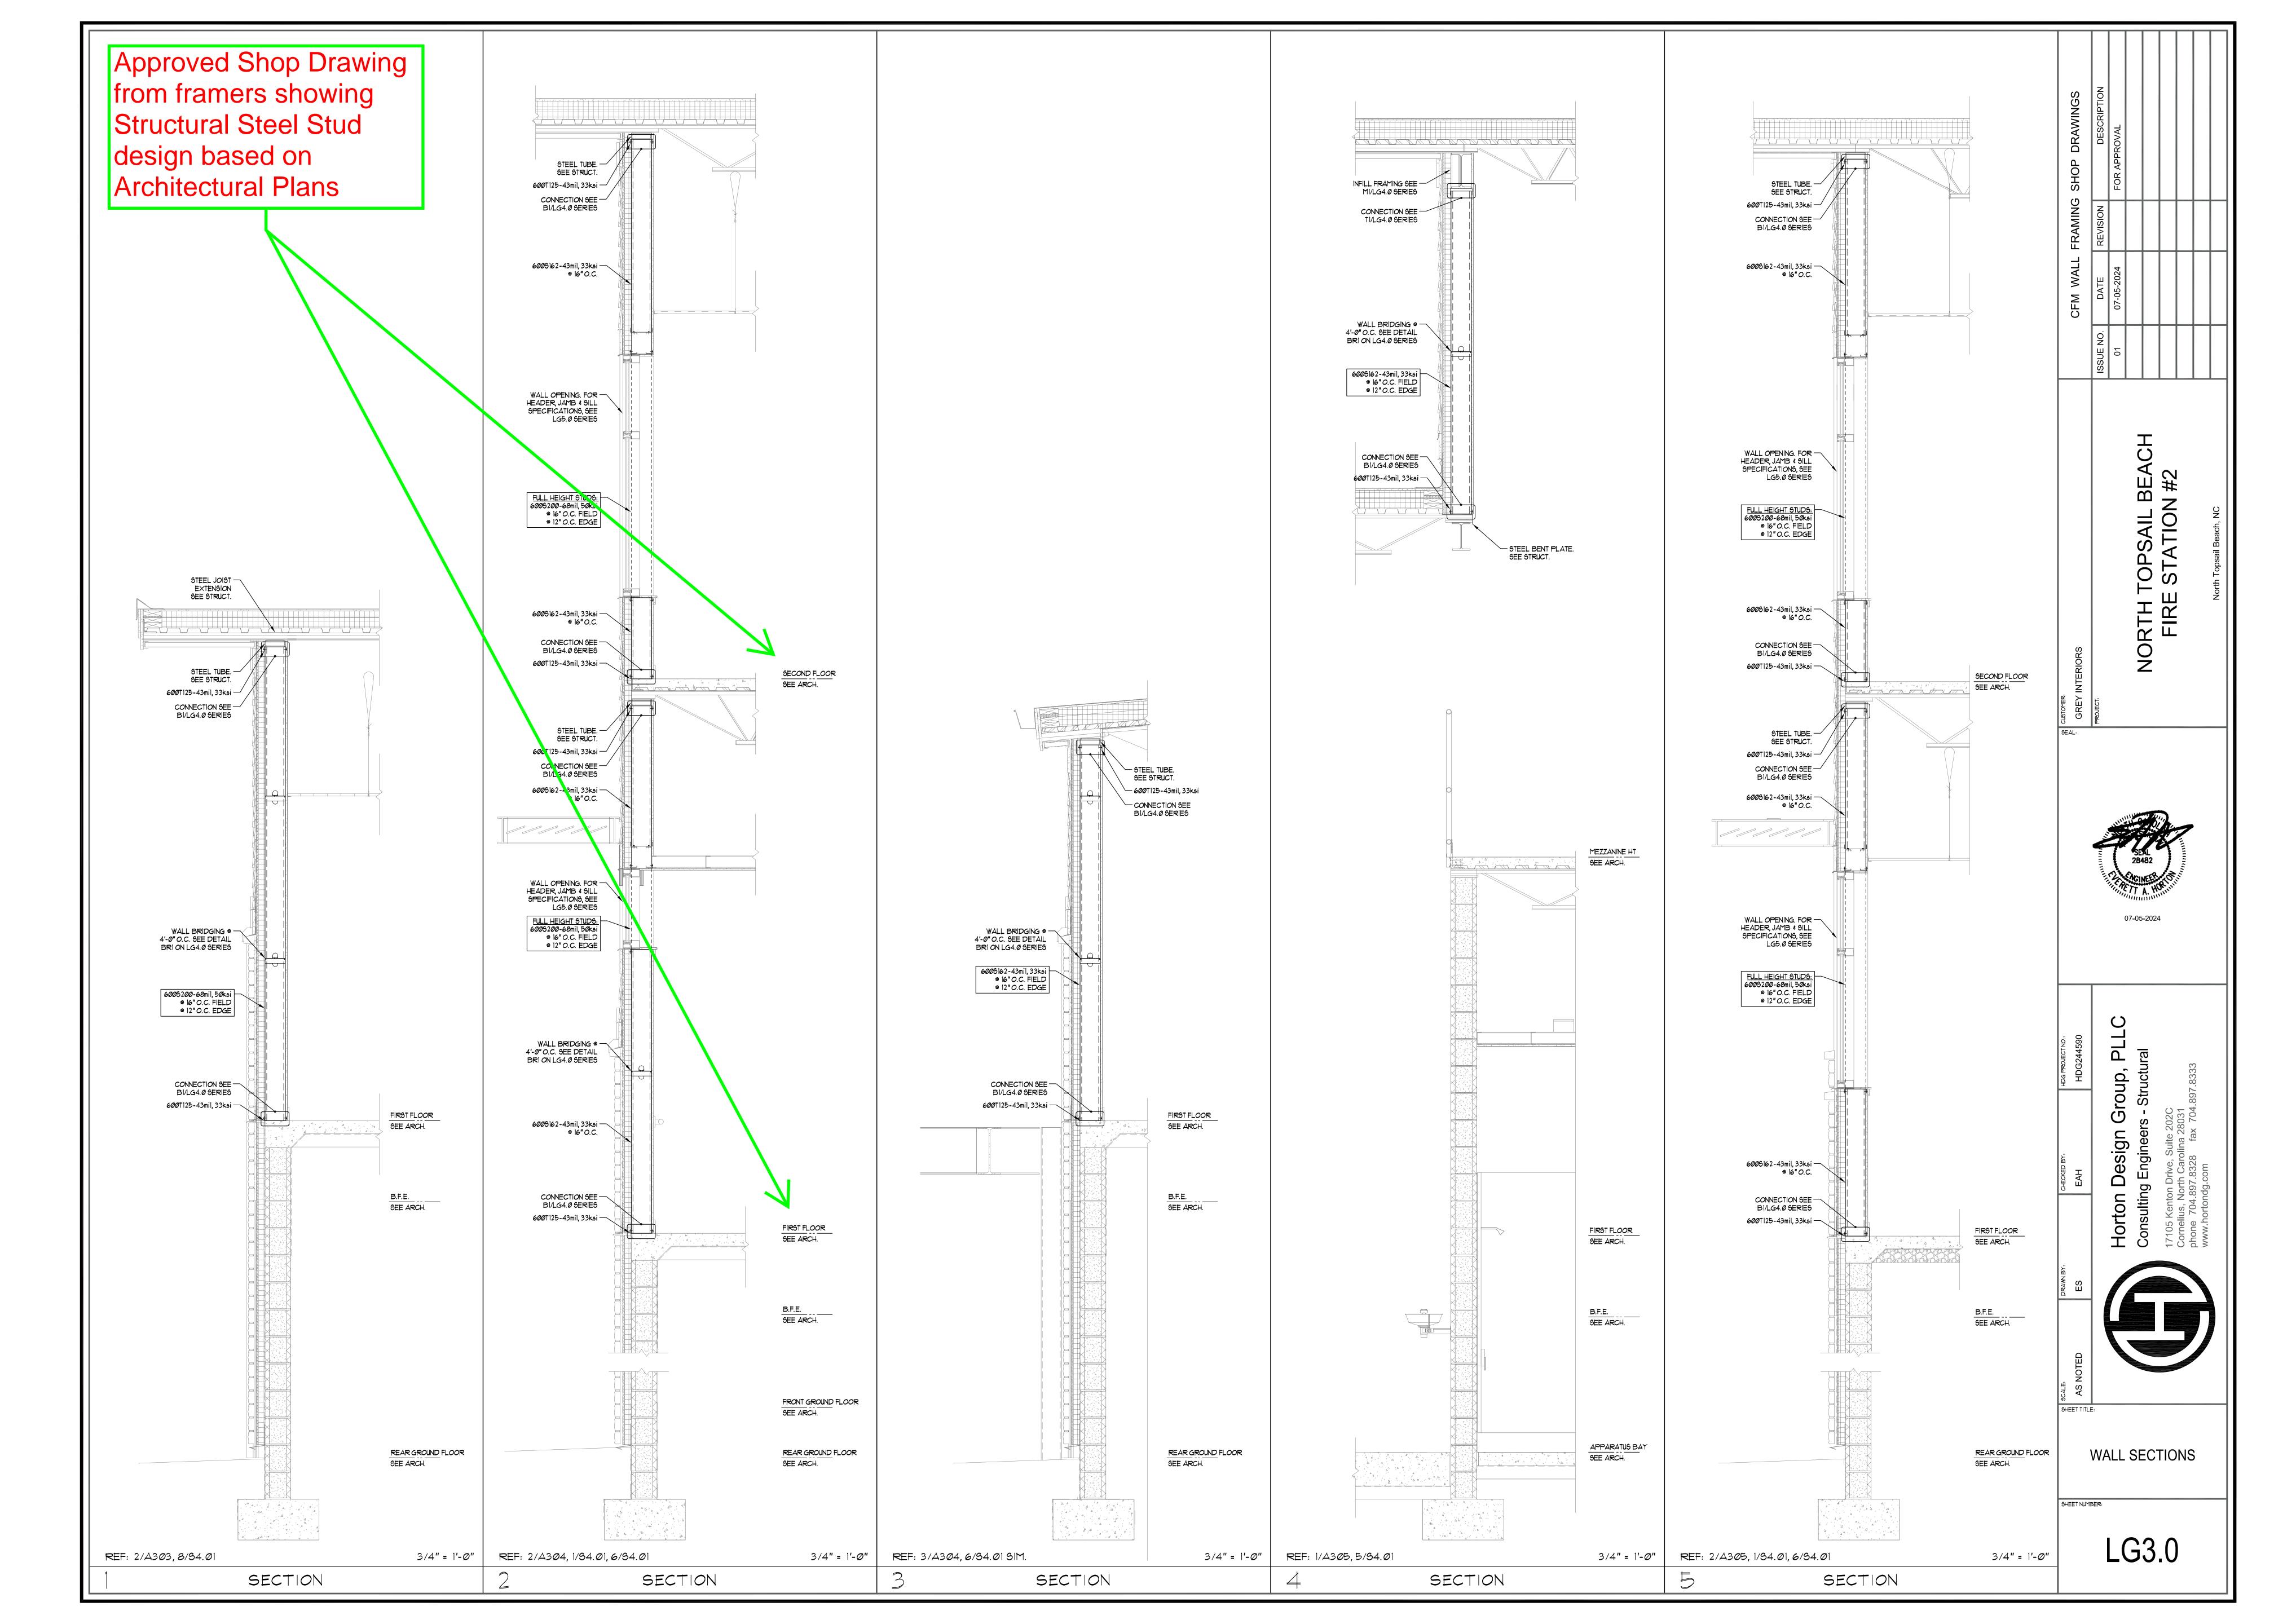

Cait Fitzsimmons

From: Adam Sisk <adam@woodseng.com> Sent: Thursday, April 3, 2025 10:30 AM To: Brice M. Reid; Gregory Trotta

Cc: Cait Fitzsimmons

Subject: RE: 2021025.02 NTB FS2 - RFI 101_1st Floor Structural Stud Length - Urgent

Follow Up Flag: Follow up Flag Status: Flagged

Brice,

We recommend building up on top of the track with a boxed track to make up the 2-1/2". Please have the CFS designer propose a solution.

Regards,

Adam Sisk, PE, SE

Principal

Creative Solutions

254 N. Front St. Suite 201 Wilmington, NC 28401 (p) 910.343.8007 xt 103 (f) 910.343.8088

www.woodseng.com



Please consider the environment before printing this email

From: Brice M. Reid

breid@beckermorgan.com>

Sent: Thursday, April 3, 2025 9:16 AM

To: Adam Sisk <adam@woodseng.com>; Gregory Trotta <greg@woodseng.com>

Cc: Cait Fitzsimmons <cfitzsimmons@beckermorgan.com>

Subject: 2021025.02 NTB FS2 - RFI 101_1st Floor Structural Stud Length - Urgent

Importance: High

Good Morning Adam/Greg – I just sent over via newforma (also attached) the structural stud RFI. As discussed in the meeting, confirmation came back that the studs on site are 2.5" short. Can you provide a response the RFI as soon as possible?

Thank you,

Brice M. Reid, AIA, NCARB

Senior Associate | Architect

BECKER MORGAN GROUP, INC.

North Carolina | Maryland | Delaware

910.341.7600x407 o

breid@beckermorgan.com

www.beckermorgan.com

From: Brice M. Reid

Sent: Wednesday, April 2, 2025 1:06 PM **To:** Matt Ribakow < mribakow@brawley.net>

Cc: Kimberly L. Wilson < kwilson@beckermorgan.com; Cait Fitzsimmons < critzsimmons@beckermorgan.com; Scott Kisthardt kwilson@beckermorgan.com; Adrian Rowe < arowe@brawley.net; Scott Kisthardt

<scott@brawlev.net>

Subject: RE: 2021025.02 NTB FS2 - RFI 100 Joist Bearing Elevations

Matt – please send us an RFI to track the question.

Thank you,
Brice M. Reid, AIA, NCARB
Senior Associate | Architect
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breid@beckermorgan.com
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Facebook | LinkedIn | Instagram

From: Matt Ribakow < mribakow@brawley.net Sent: Wednesday, April 2, 2025 1:02 PM

To Daise M. Daid densid Charles are a se

To: Brice M. Reid breid@beckermorgan.com

Cc: Kimberly L. Wilson < kwilson@beckermorgan.com; Cait Fitzsimmons < crittzsimmons@beckermorgan.com; adam@woodseng.com; Gregory Trotta < greg@woodseng.com; Adrian Rowe < arowe@brawley.net; Scott Kisthardt < scott@brawley.net)

Subject: Re: 2021025.02 NTB FS2 - RFI 100 Joist Bearing Elevations

Thanks Brice-

The 1st floor structural studs are 2.5" short for the new 2nd floor height. Their shop drawings were based on the architectural plans with the 27'-8" 2nd floor elevation. Please advise how to proceed, as we are currently waiting to proceed with the 1st floor framing.

Also, we will need to adjust the 2 door frames that have been set with their frame bottom at 27-8". We probably will need to replace the door frames if they are damaged being removed.

Thanks, Matt

Matt Ribakow

Assistant Project Manager

C: 910.530.4657

MRibakow@BRAWLEY.NET

3314 Jaeckle Drive Unit 120

Wilmington, NC 28403



From: Brice M. Reid < breid@beckermorgan.com >

Sent: Wednesday, April 2, 2025 12:53 PM
To: Matt Ribakow mribakow@brawley.net>

Cc: Kimberly L. Wilson kwilson@beckermorgan.com; Cait Fitzsimmons critzsimmons@beckermorgan.com;

adam@woodseng.com <adam@woodseng.com>; Gregory Trotta <agree@woodseng.com>

Subject: 2021025.02 NTB FS2 - RFI 100 Joist Bearing Elevations

CAUTION: This email originated from outside of the organization. Do not click links or open attachments unless you recognize the sender and know the content is safe.

Matt – please see attached RFI response. Kim is out of the office today, but we wanted to get this over to your team.

Let us know if you have any questions.

Thank you,

Brice M. Reid, AIA, NCARB

Senior Associate | Architect

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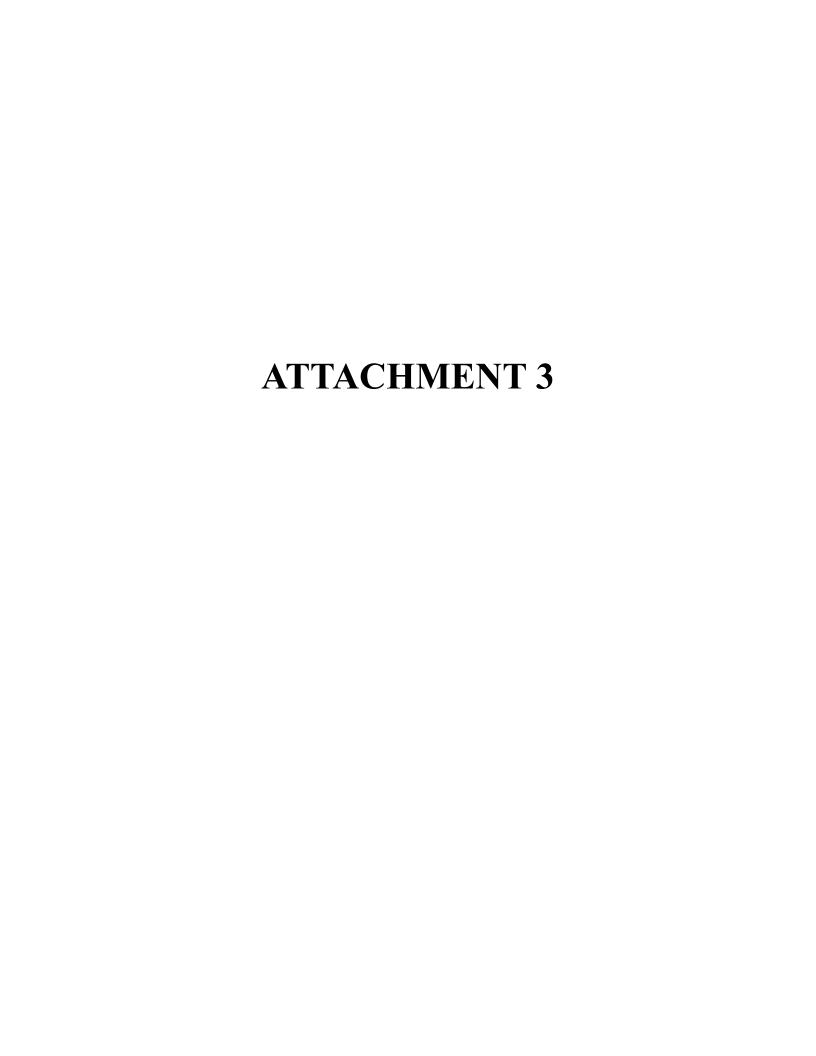
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REQUEST FOR INFORMATION



CONTRACT NUMBER: 2021025.02 NTBFS					RFI NUMBER:	107	
CONTRACT TITLE:					KI I HOMBEK.	101	
North Topsail Beach Fire Station #2 PRIME CONTRACTOR:		CLIENT:					
WB Brawley Company Matt Ribakow		Vin	Mileon lavile	on @bookorr	margan aam l		
mribakow@brawley.net			e Reid <mark>breid</mark>		norgan.com / gan.com		
SUBJECT/TITLE OF RFI: URGENT - Drawing Changes in RFI 100							
DRAWING(S): RFI 100	DETAIL(S)		SPECIFICA	TION:	CPM ACTIVITY	NUMBER:	
Cost Effect:	= =	None None	=				
INFORMATION REQUESTED &	RECOMMENDED :	SOL	UTION:				
For tracking purposes, please provio reference.	de a detailed explanati	on o	f all changes	made in RFI	100. Drawings a	attached for	
1	URGENT						
Date Response Required By: SESPONSE:	5/1/25 Da	te:	4/22/25	Signature:	Matt Ribakov	1	
Please reference the narrative	on the following p	age) <u>.</u>				
	01	Ü					
From: Cait Fitzsimmons	Date: 04/2	4/20	25	Signature:	C.R.Fitzsimmo	ons	
The RFI system is intended to provide an effi authorize the contractor to proceed with work changed condition, written notice to the Contractor	cient mechanism for respor - to do so, the contractor p	nding t	o contractor's re	quest for inform k. If the contract	ation ONLY. This sys	tem DOES NOT	
DISTRIBUTION: Original to File via RO	OICC PL/DM E	т_ 🗆	A/E PC#	# via	ROICC/CONTRACT	ING OFFICER	

STRUCTURAL DRAWING UPDATES:

Second Floor Framing Plan/S2.02:

- Joist bearing elevation heights added.

Roof Framing Plan/S2.03:

- Joist bearing elevation heights updated.

ARCHITECTURE DRAWING UPDATES:

1/A201:

Second floor elevation height updated.

2/A201:

- Second floor elevation height updated.

1/A202:

- Second floor elevation height updated.
- First floor to second floor dimension updated to reflect the revised second floor elevation height.

2/A202:

- Second floor elevation height updated.

1/A301:

- Second floor elevation height updated.
- Mezzanine floor elevation height updated.

2/A301:

- Mezzanine floor elevation height updated.

1/A302:

- Second floor elevation height updated.

2/A302:

- Second floor elevation height updated.
- Mezzanine floor elevation height updated.

2/A304:

- Second floor elevation height updated.

1/A305:

- Mezzanine floor elevation height updated.

2/A305:

- Second floor elevation height updated.

8/A402:

- Second floor elevation height updated.
- Mezzanine floor elevation height updated.

1/A403:

- Second floor elevation height updated.
- Riser height dimensions updated to reflect the revised second floor elevation height 2/A403:
 - Second floor elevation height updated.

3/A403:

Second floor elevation height updated.

1/A510:

Mezzanine floor elevation height updated.

2/A510:

- Second floor elevation height updated.

SF-6/A602:

- Second floor elevation height updated.
- Height of storefront above second floor elevation updated to maintain alignment with the curtain wall system.

SF-7/602:


- Second floor elevation height updated.

SF-9/A602:

Second floor elevation height updated.

SF-10/A602:

- Second floor elevation height updated.

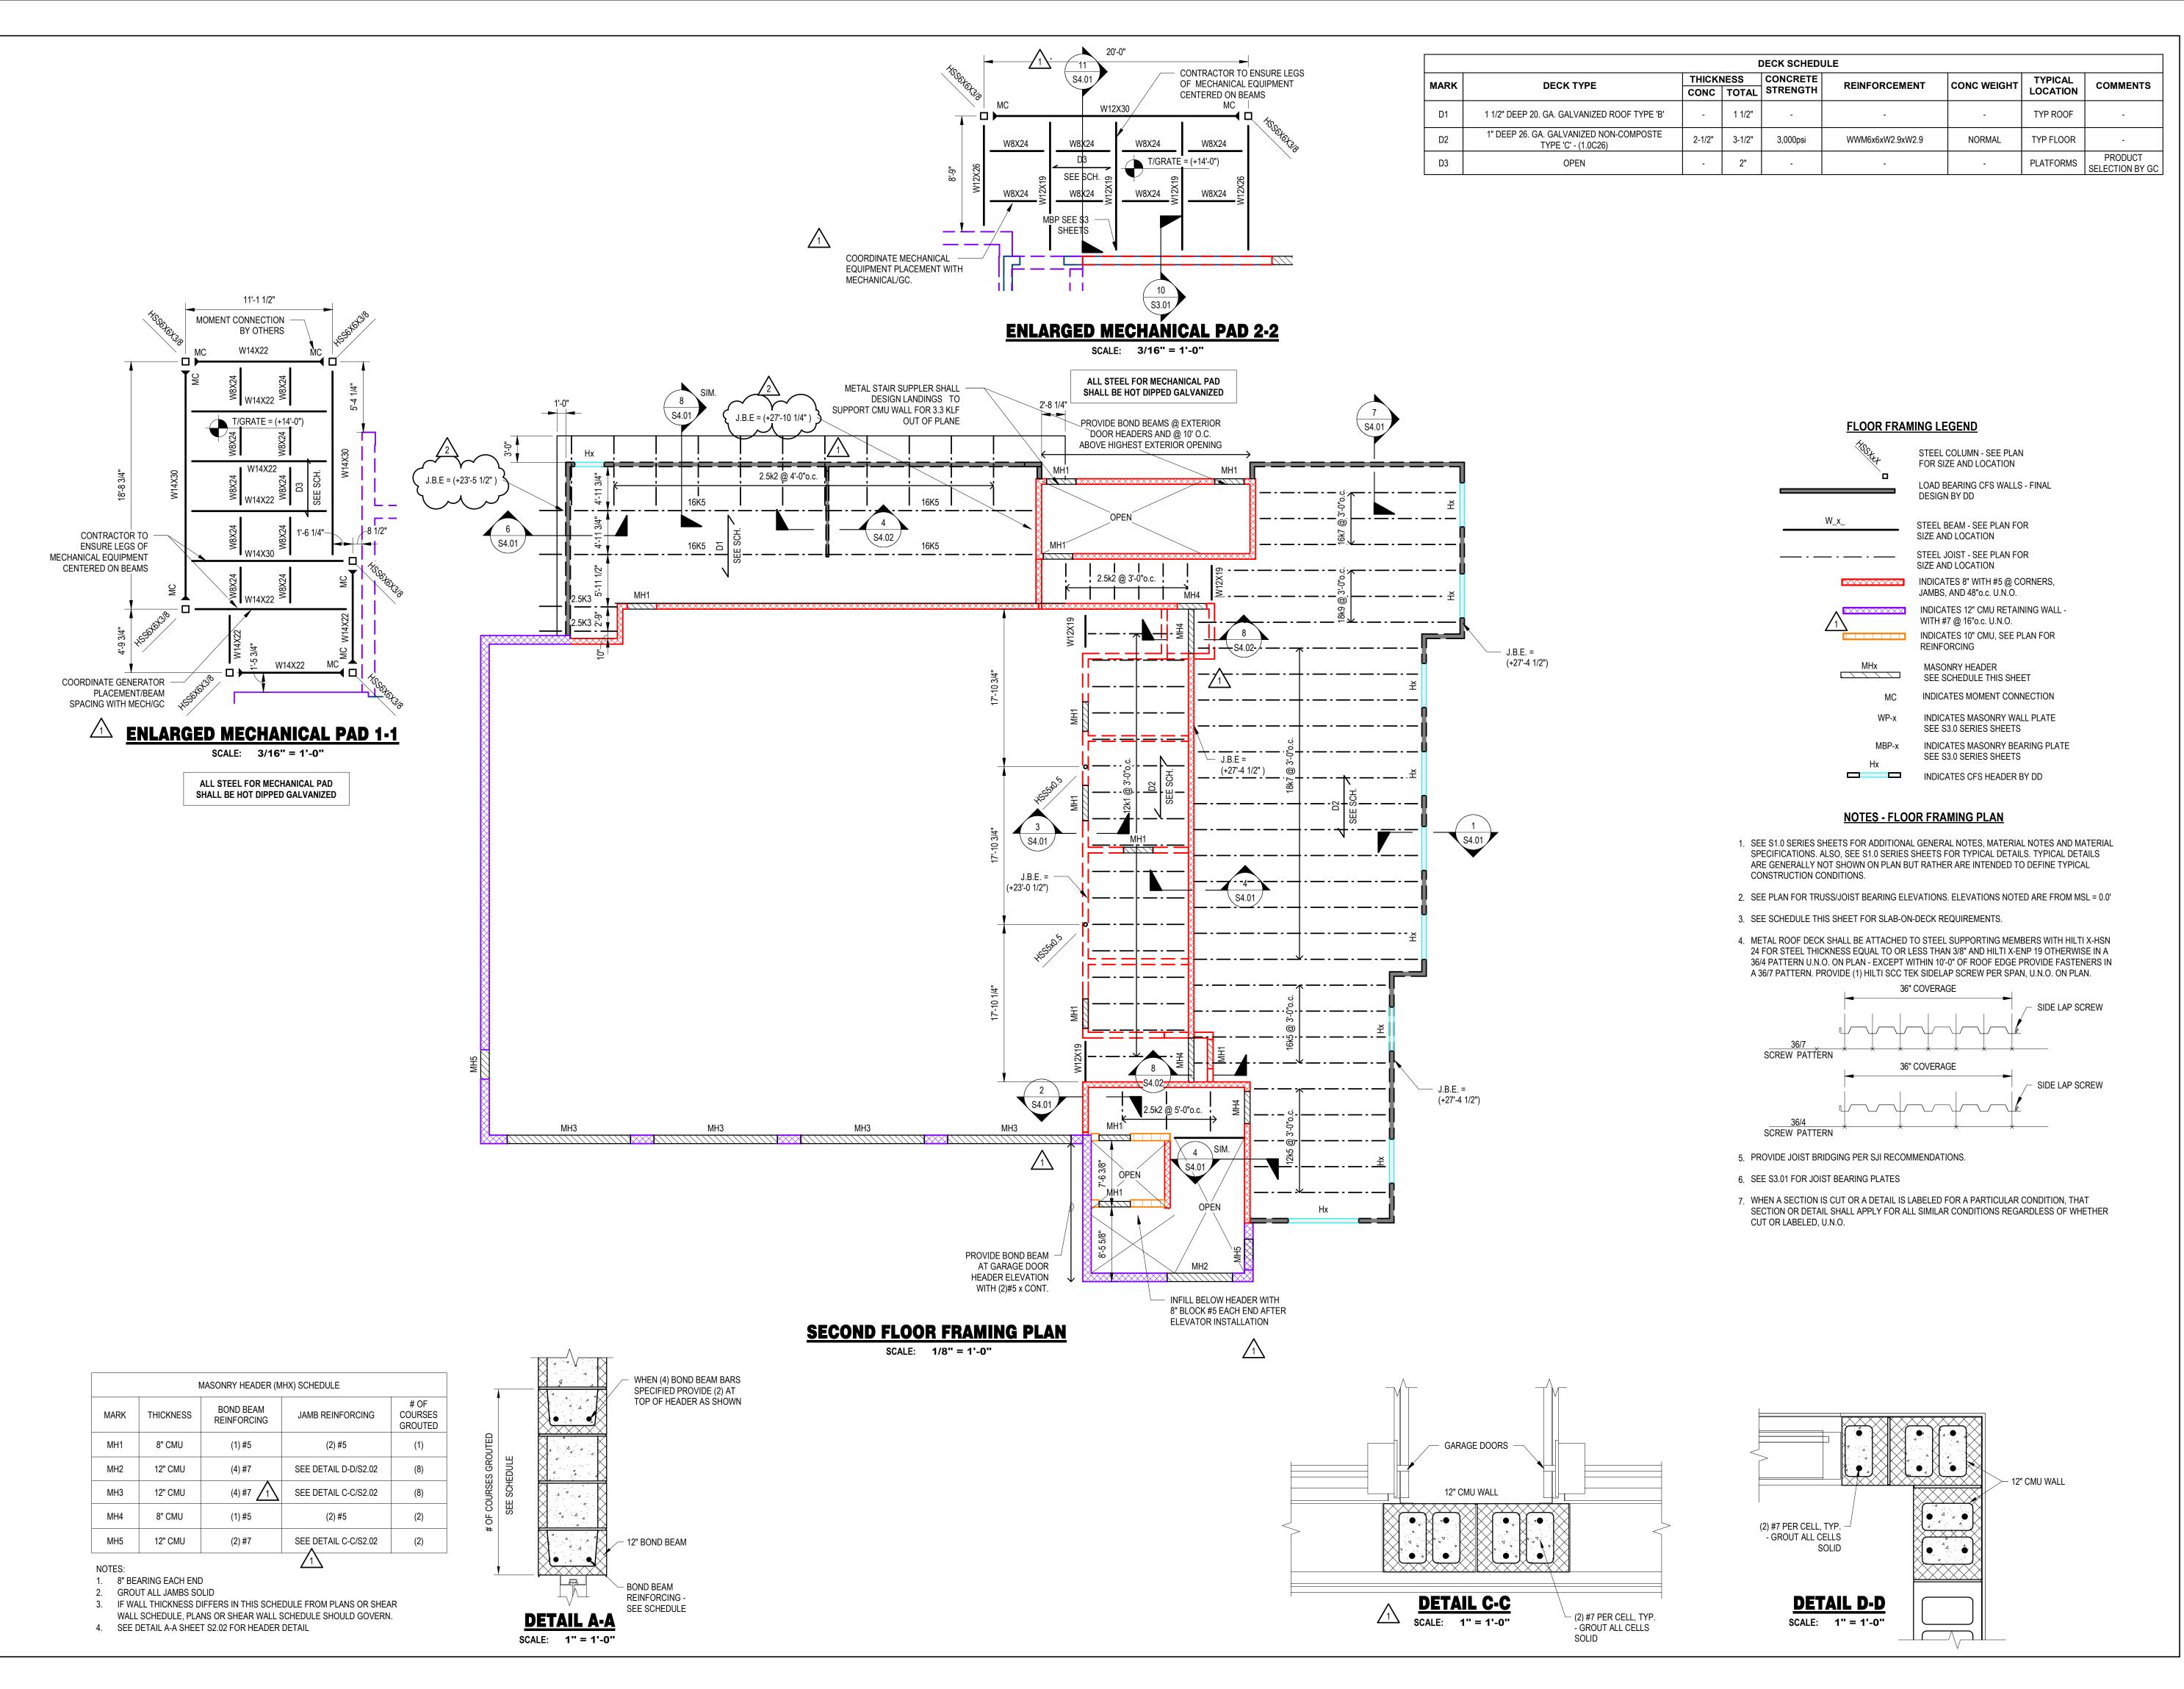



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OJECT TITLE

NORTH TOPSAIL BEACH FIRE STATION #2

3304 GRAY STREET NORTH TOPSAIL BEACH, NC 28460

> ISSUED FOR PERMIT

> > 03.08.2024

SECOND FLOOR FRAMING PLAN

SUE BLO	CK		
2	04/02/2025	RFI100	
1	03/25/2025	ASI-008	
Mark	Date		Description
PROJ	ECT NO:		2021025.02


DATE: 03.08.2024

SCALE: As indicated


DRAWN BY:Author PROJ MGRChecker

S2.02

	DECK SCHEDULE								
MARK	DECK TYPE	THICK		CONCRETE STRENGTH	REINFORCEMENT	CONC WEIGHT	TYPICAL LOCATION	COMMENTS	
D1	1 1/2" DEEP 20. GA. GALVANIZED ROOF TYPE 'B'	-	1 1/2"	-	-	-	TYP ROOF	-	
D2	1" DEEP 26. GA. GALVANIZED NON-COMPOSTE TYPE 'C' - (1.0C26)	2-1/2"	3-1/2"	3,000psi	WWM6x6xW2.9xW2.9	NORMAL	TYP FLOOR	-	
D3	OPEN	-	2"	-	-	-	PLATFORMS	PRODUCT SELECTION BY GC	

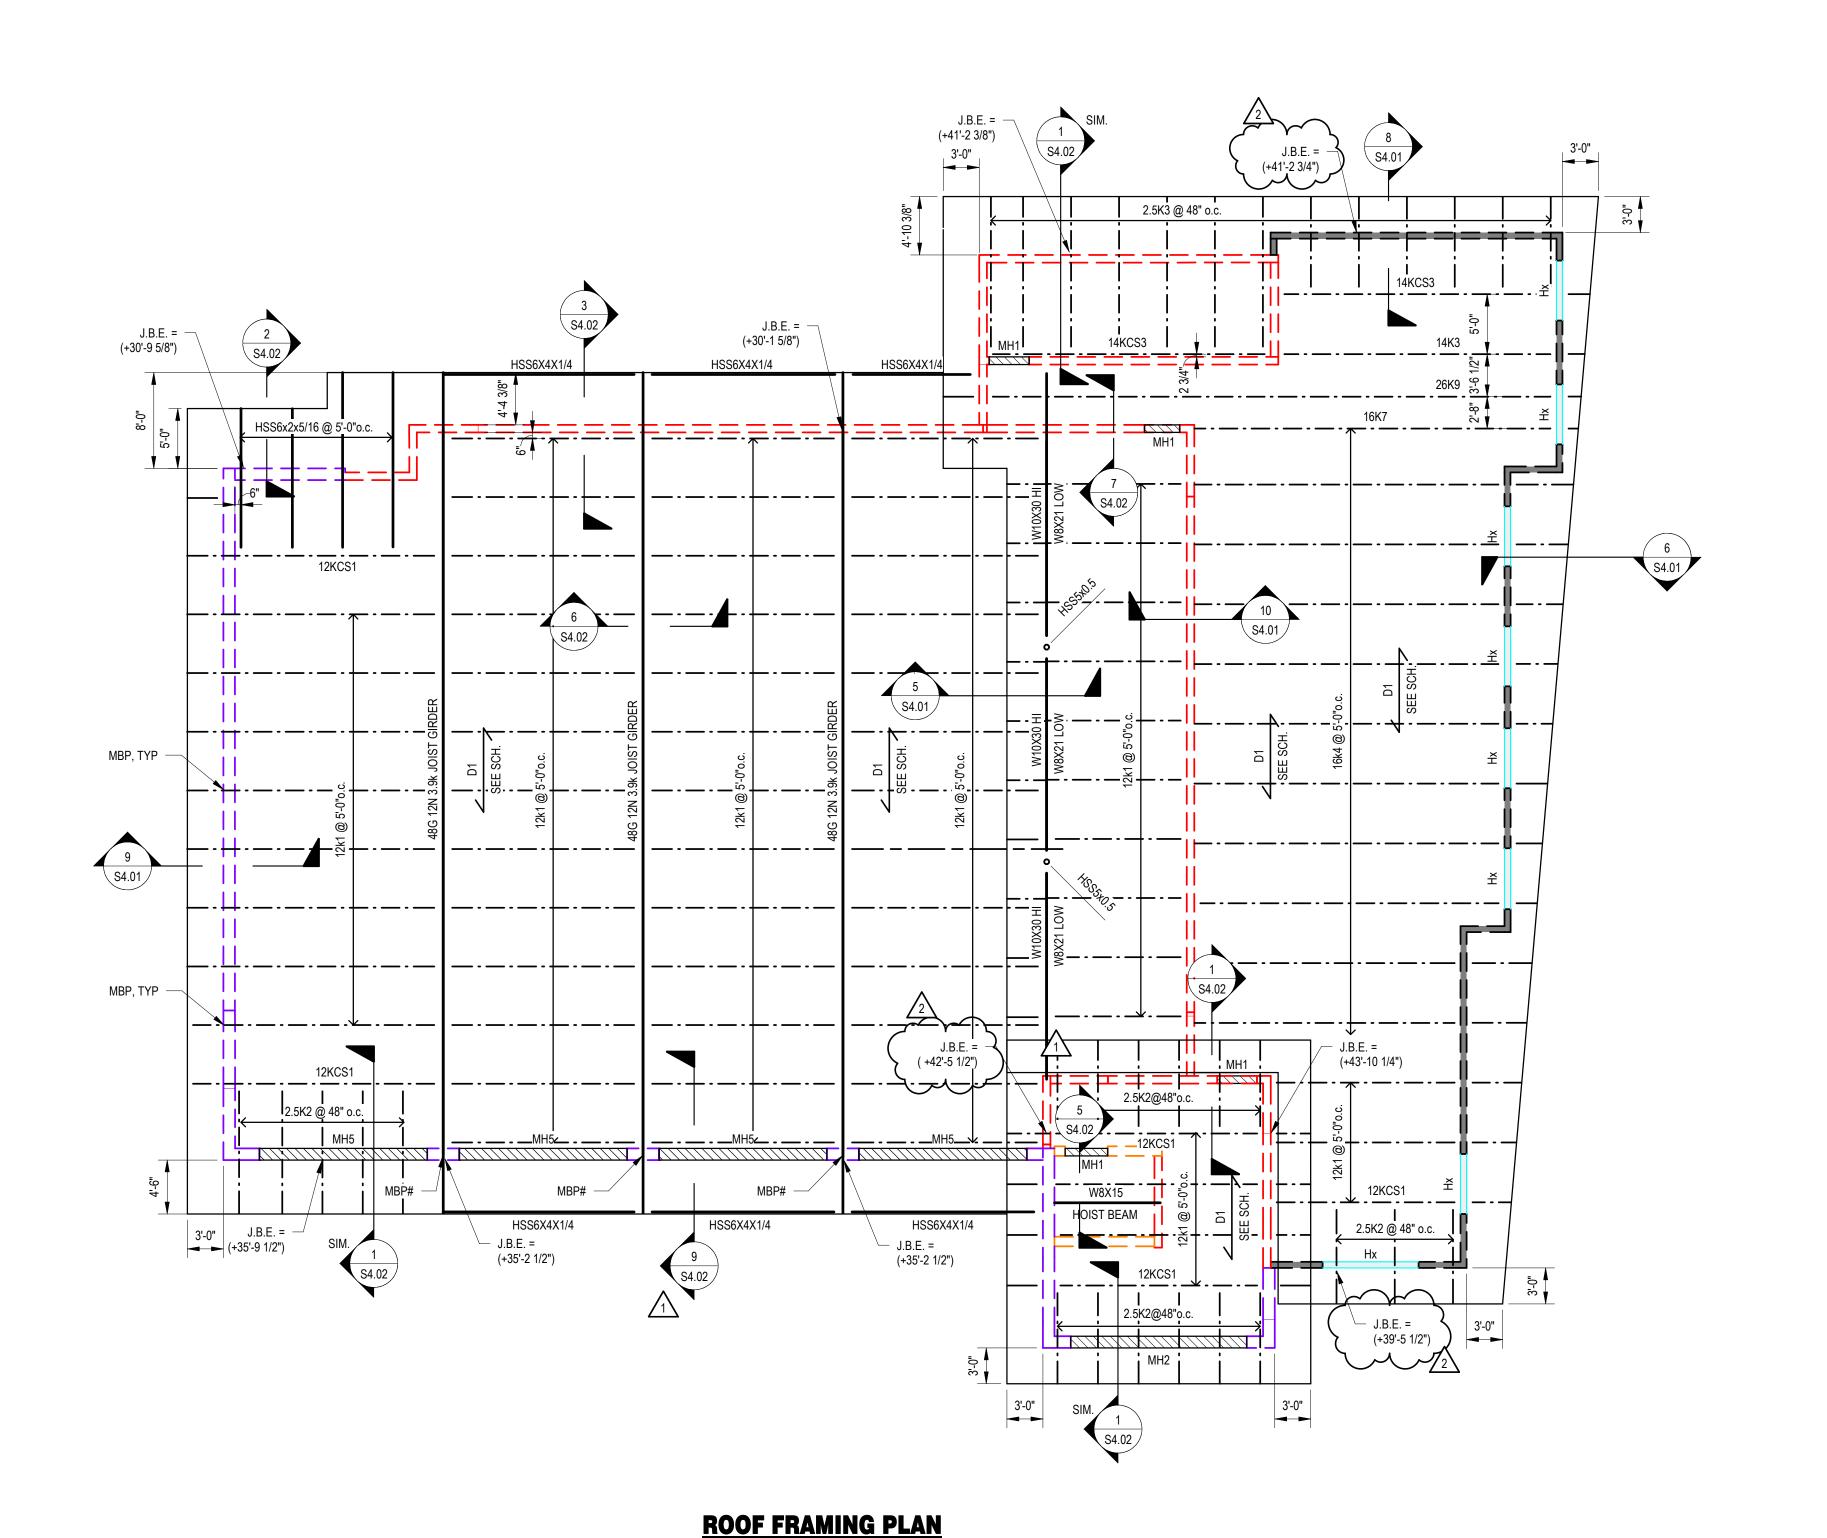

ROOF FRAMING LEGEND

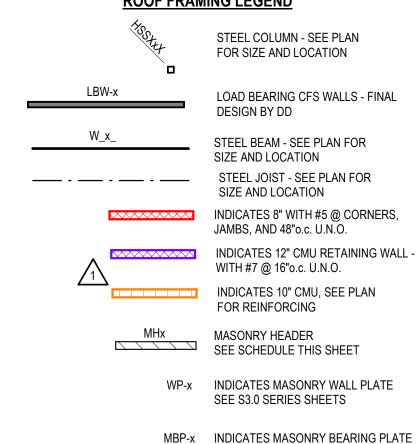


NOTES - ROOF FRAMING

1. SEE SHEET S1.0 SERIES SHEETS FOR GENERAL STEEL, JOIST, DECK, LIGHT GAUGE FRAMING NOTES AND TYPICAL DETAILS NOT SHOWN ON PLAN.

SEE S3.0 SERIES SHEETS

2. METAL ROOF DECK SHALL BE ATTACHED TO STEEL SUPPORTING MEMBERS WITH HILTI X-HSN 24 FOR STEEL THICKNESS EQUAL TO OR LESS THAN 3/8" AND HILTI X-ENP 19 OTHERWISE IN A 36/4 PATTERN EXCEPT IN CORNER ZONES (ZONE 3 - SEE S1.0 SERIES SHEETS) - PROVIDE

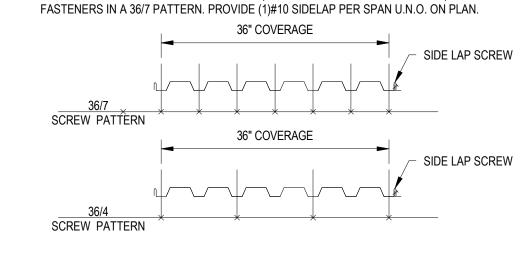

- 3. ALL JOISTS SHALL BE DESIGNED FOR A NET UPLIFT PRESSURE OF 30 psf.
- 4. PROVIDE JOIST BRIDGING PER SJI RECOMMENDATIONS.
- 5. ALL BEAMS, GIRDERS AND COLUMNS SHALL BE ASTM A992, GRADE 50.



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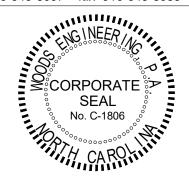
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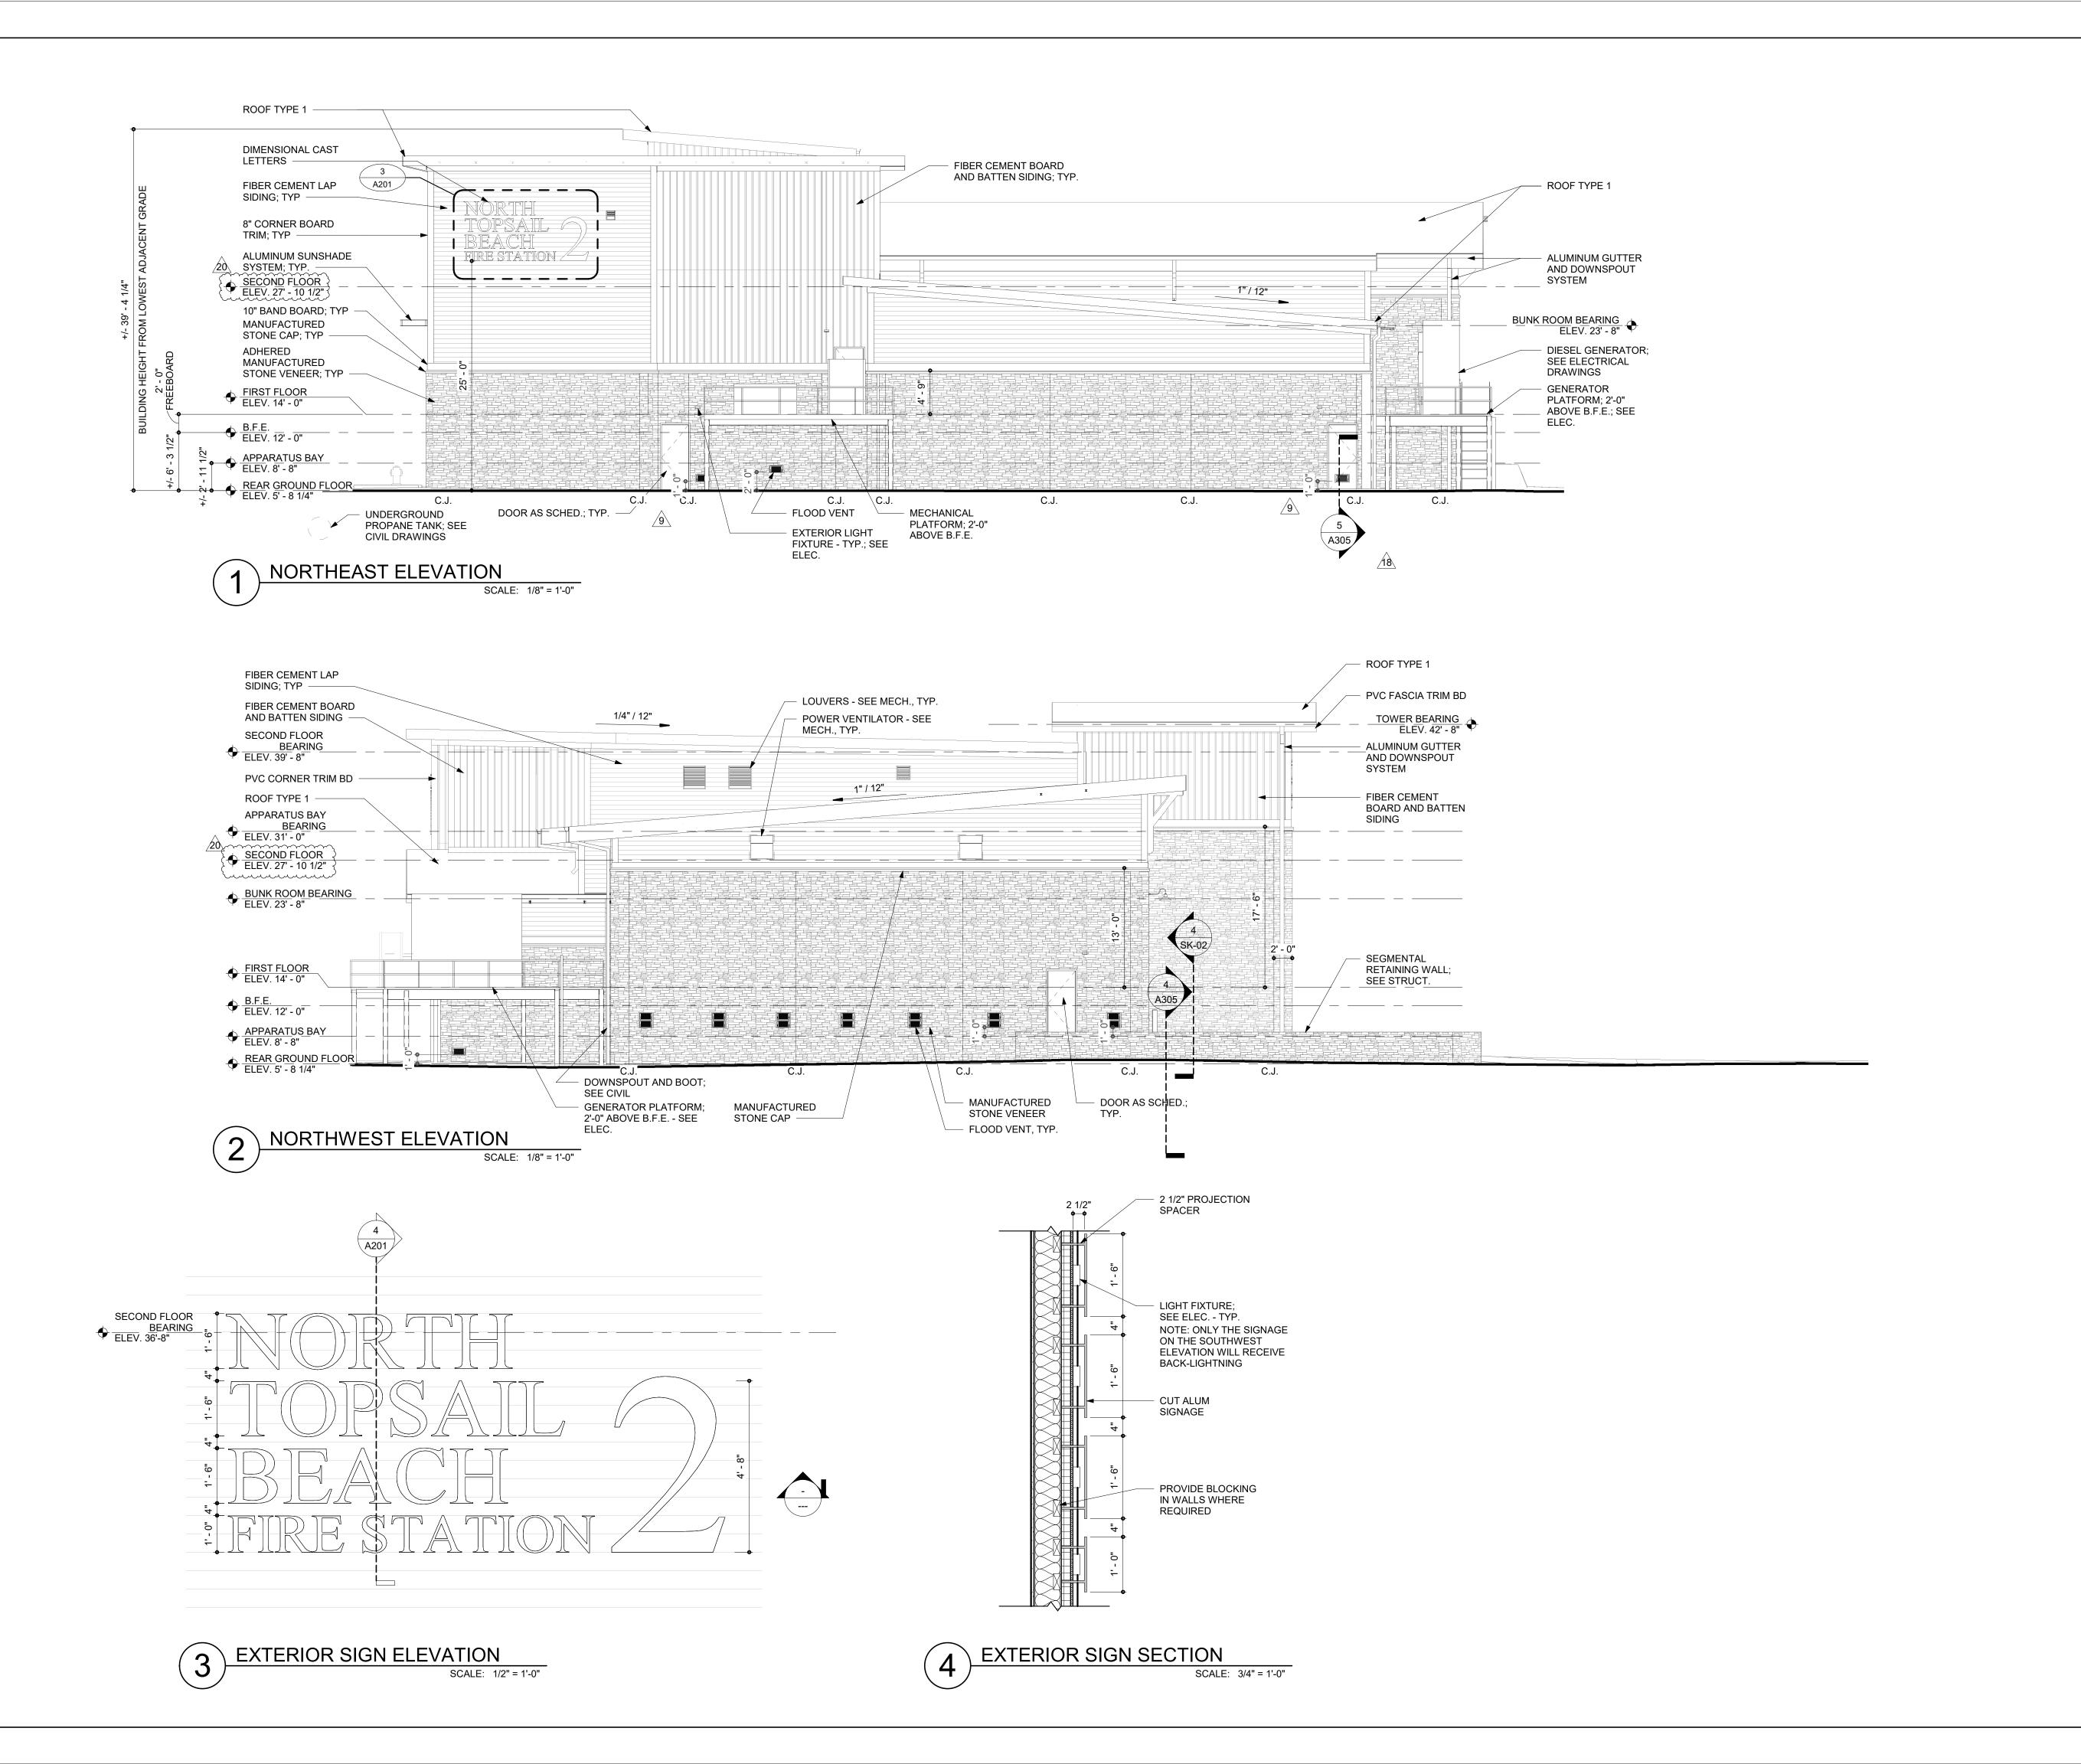
03.08.2024

ROOF FRAMING PLAN

ISSUE BLOCK

2 04/02/2025 RFI100 1 03/25/2025 ASI-008 PROJECT NO: 2021025.02 DATE:

03.08.2024 SCALE: As indicated DRAWN BY:Author PROJ MGRChecker





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EXTERIOR ELEVATIONS



Mark Date PROJECT NO:

ISSUE BLOCK


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A201

2021025.02

03.08.2024





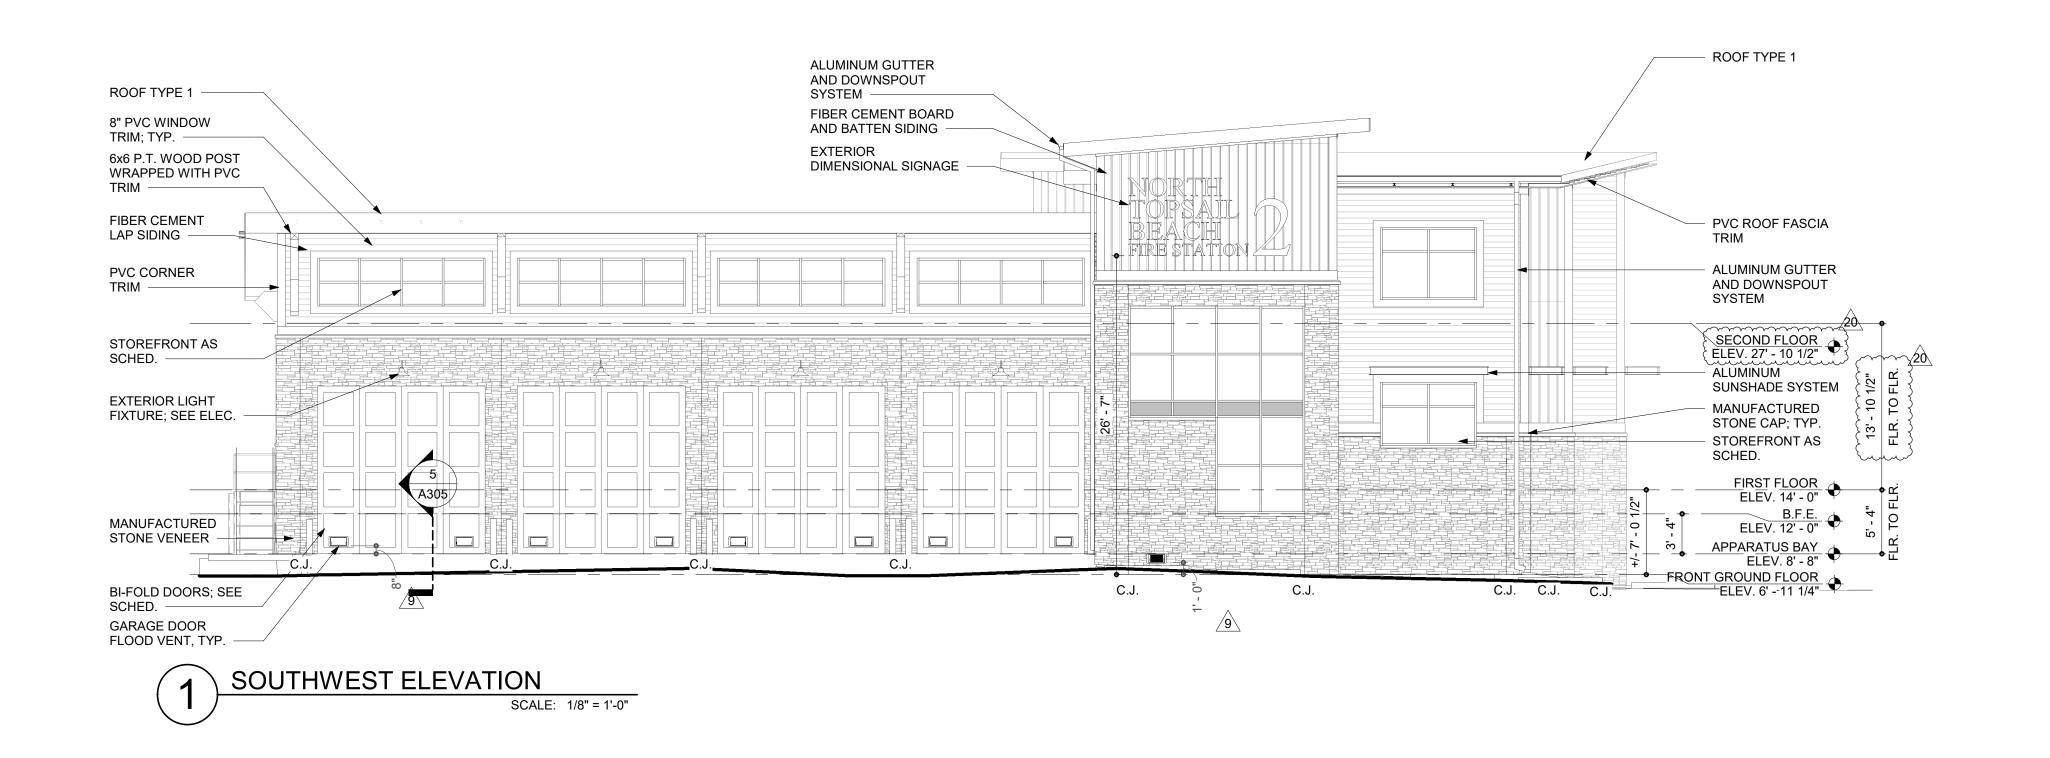

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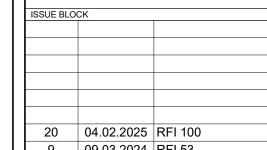


NORTH TOPSAIL BEACH FIRE STATION #2

3304 GRAY STREET NORTH TOPSAIL BEACH, NC

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EXTERIOR ELEVATIONS



9 09.03.2024 RFI 53 Mark Date


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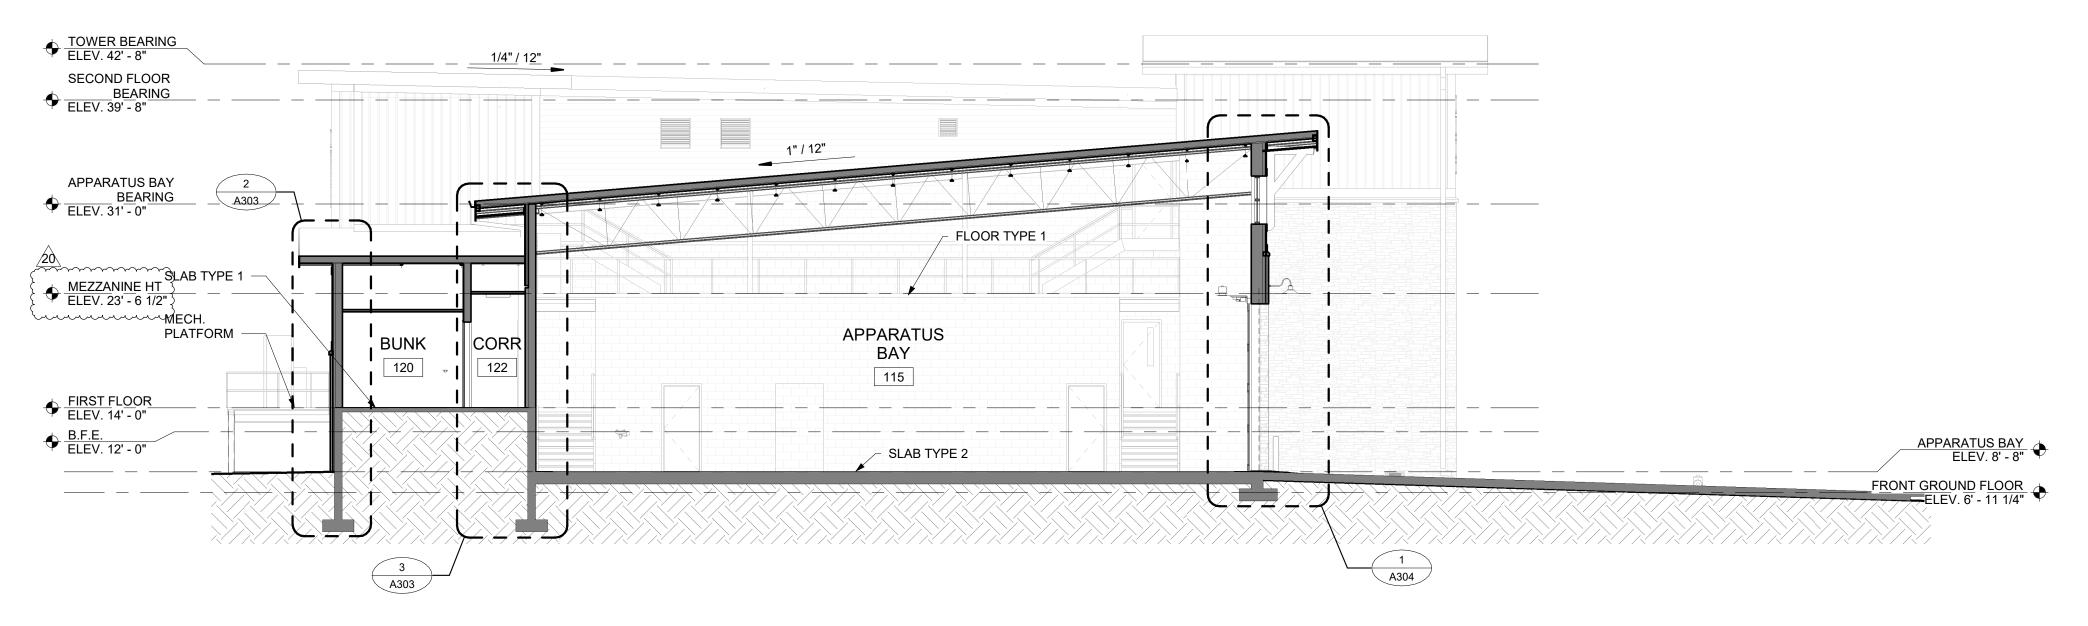
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2021025.02

03.08.2024

A202



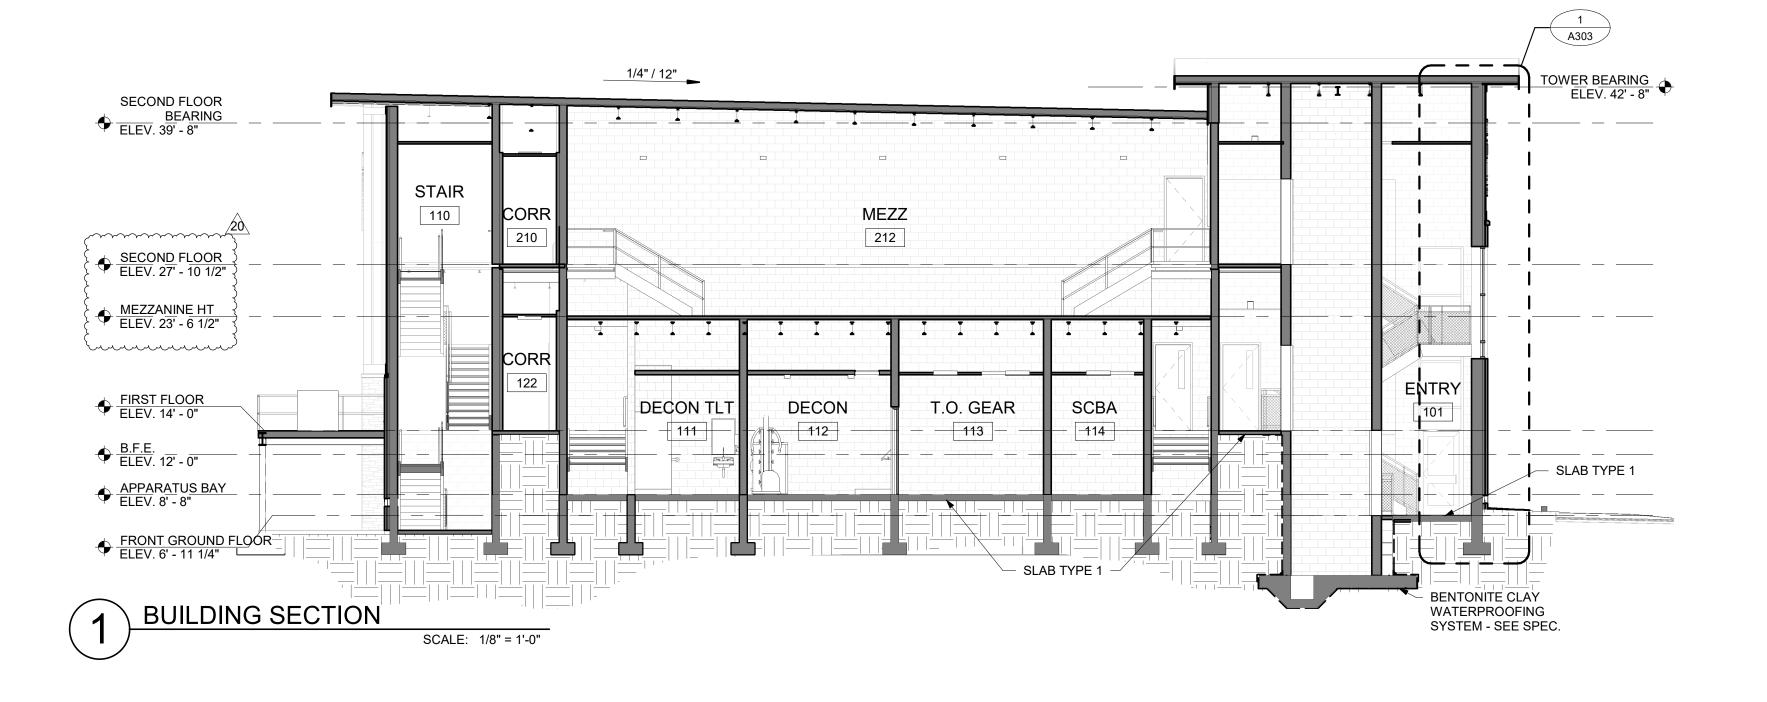

BUILDING SECTION

SCALE: 1/8" = 1'-0"



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NORTH TOPSAIL
BEACH FIRE
STATION #2

3304 GRAY STREET NORTH TOPSAIL BEACH, NC 28460

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BUILDING SECTIONS

ISSUE BLOCK

 20
 04.02.2025
 RFI 100


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 Date
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 PROJECT NO:
 2021025.02


DATE: 03.08.2024 SCALE: 1/8" = 1'-0"

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A301





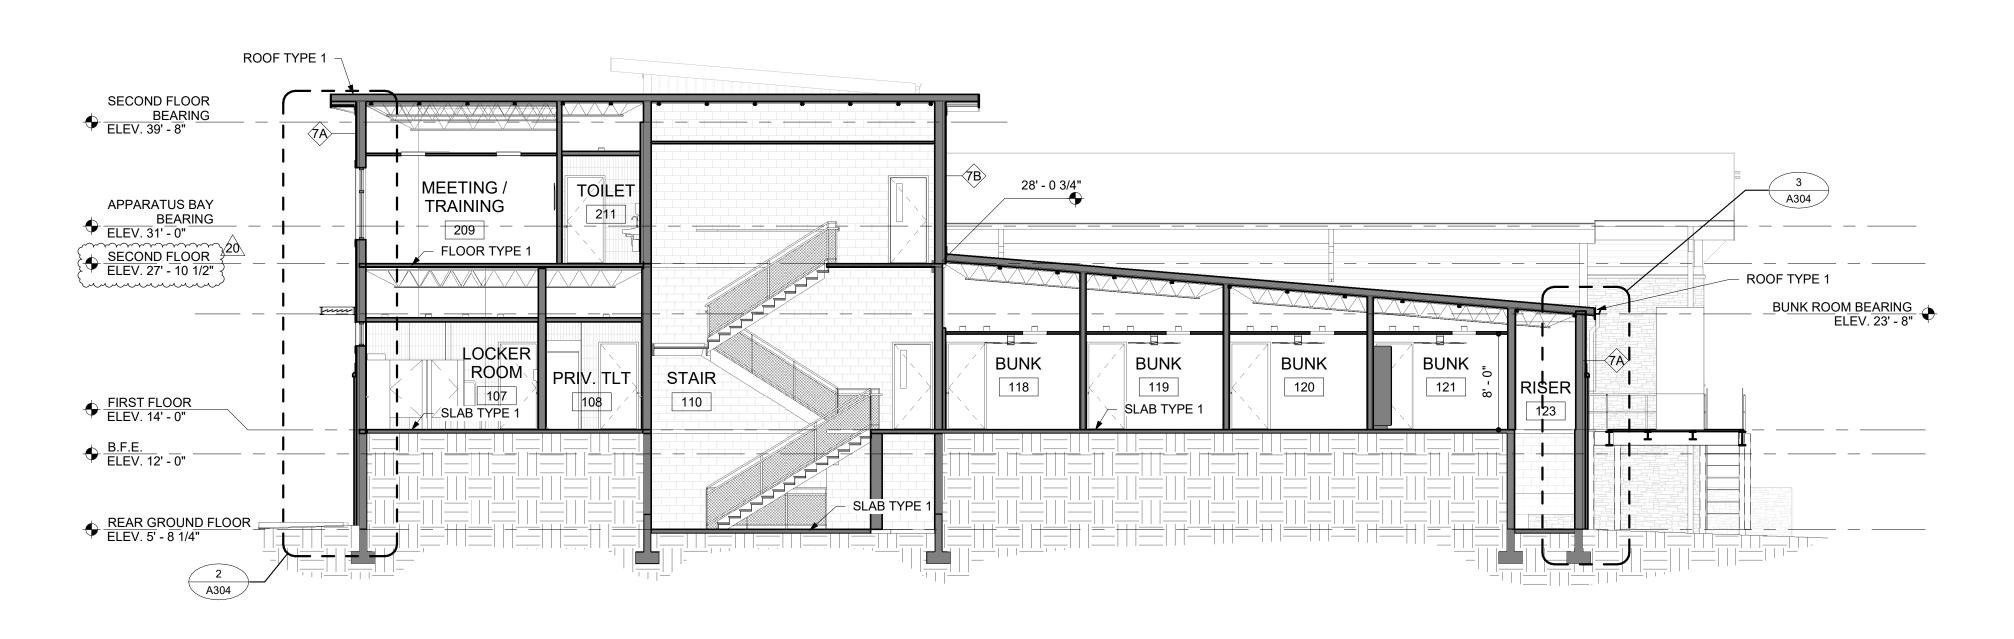

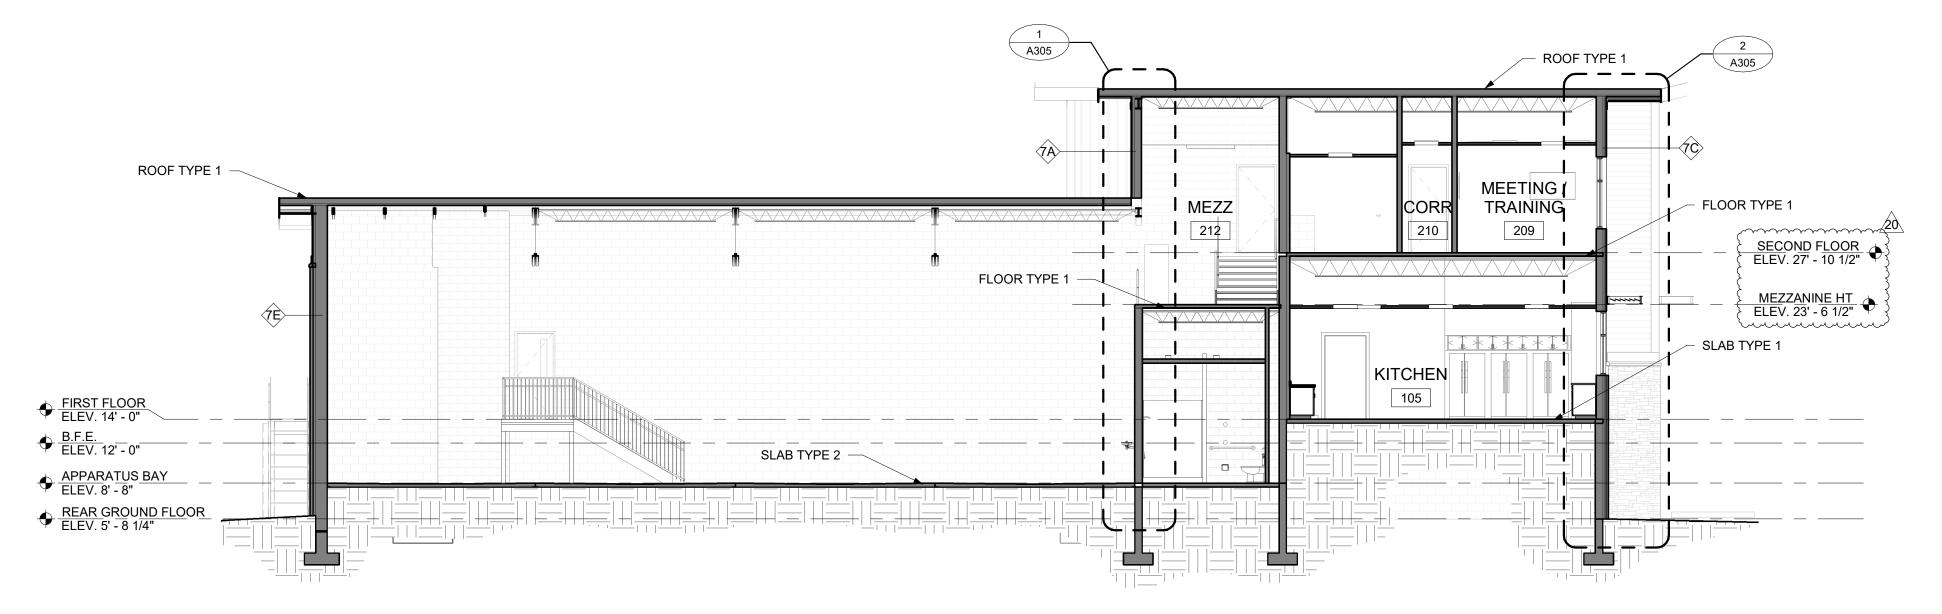BUILDING SECTION SCALE: 1/8" = 1'-0"



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NORTH TOPSAIL BEACH FIRE STATION #2

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BUILDING SECTIONS

20 04.02.2025 RFI 100 Mark Date


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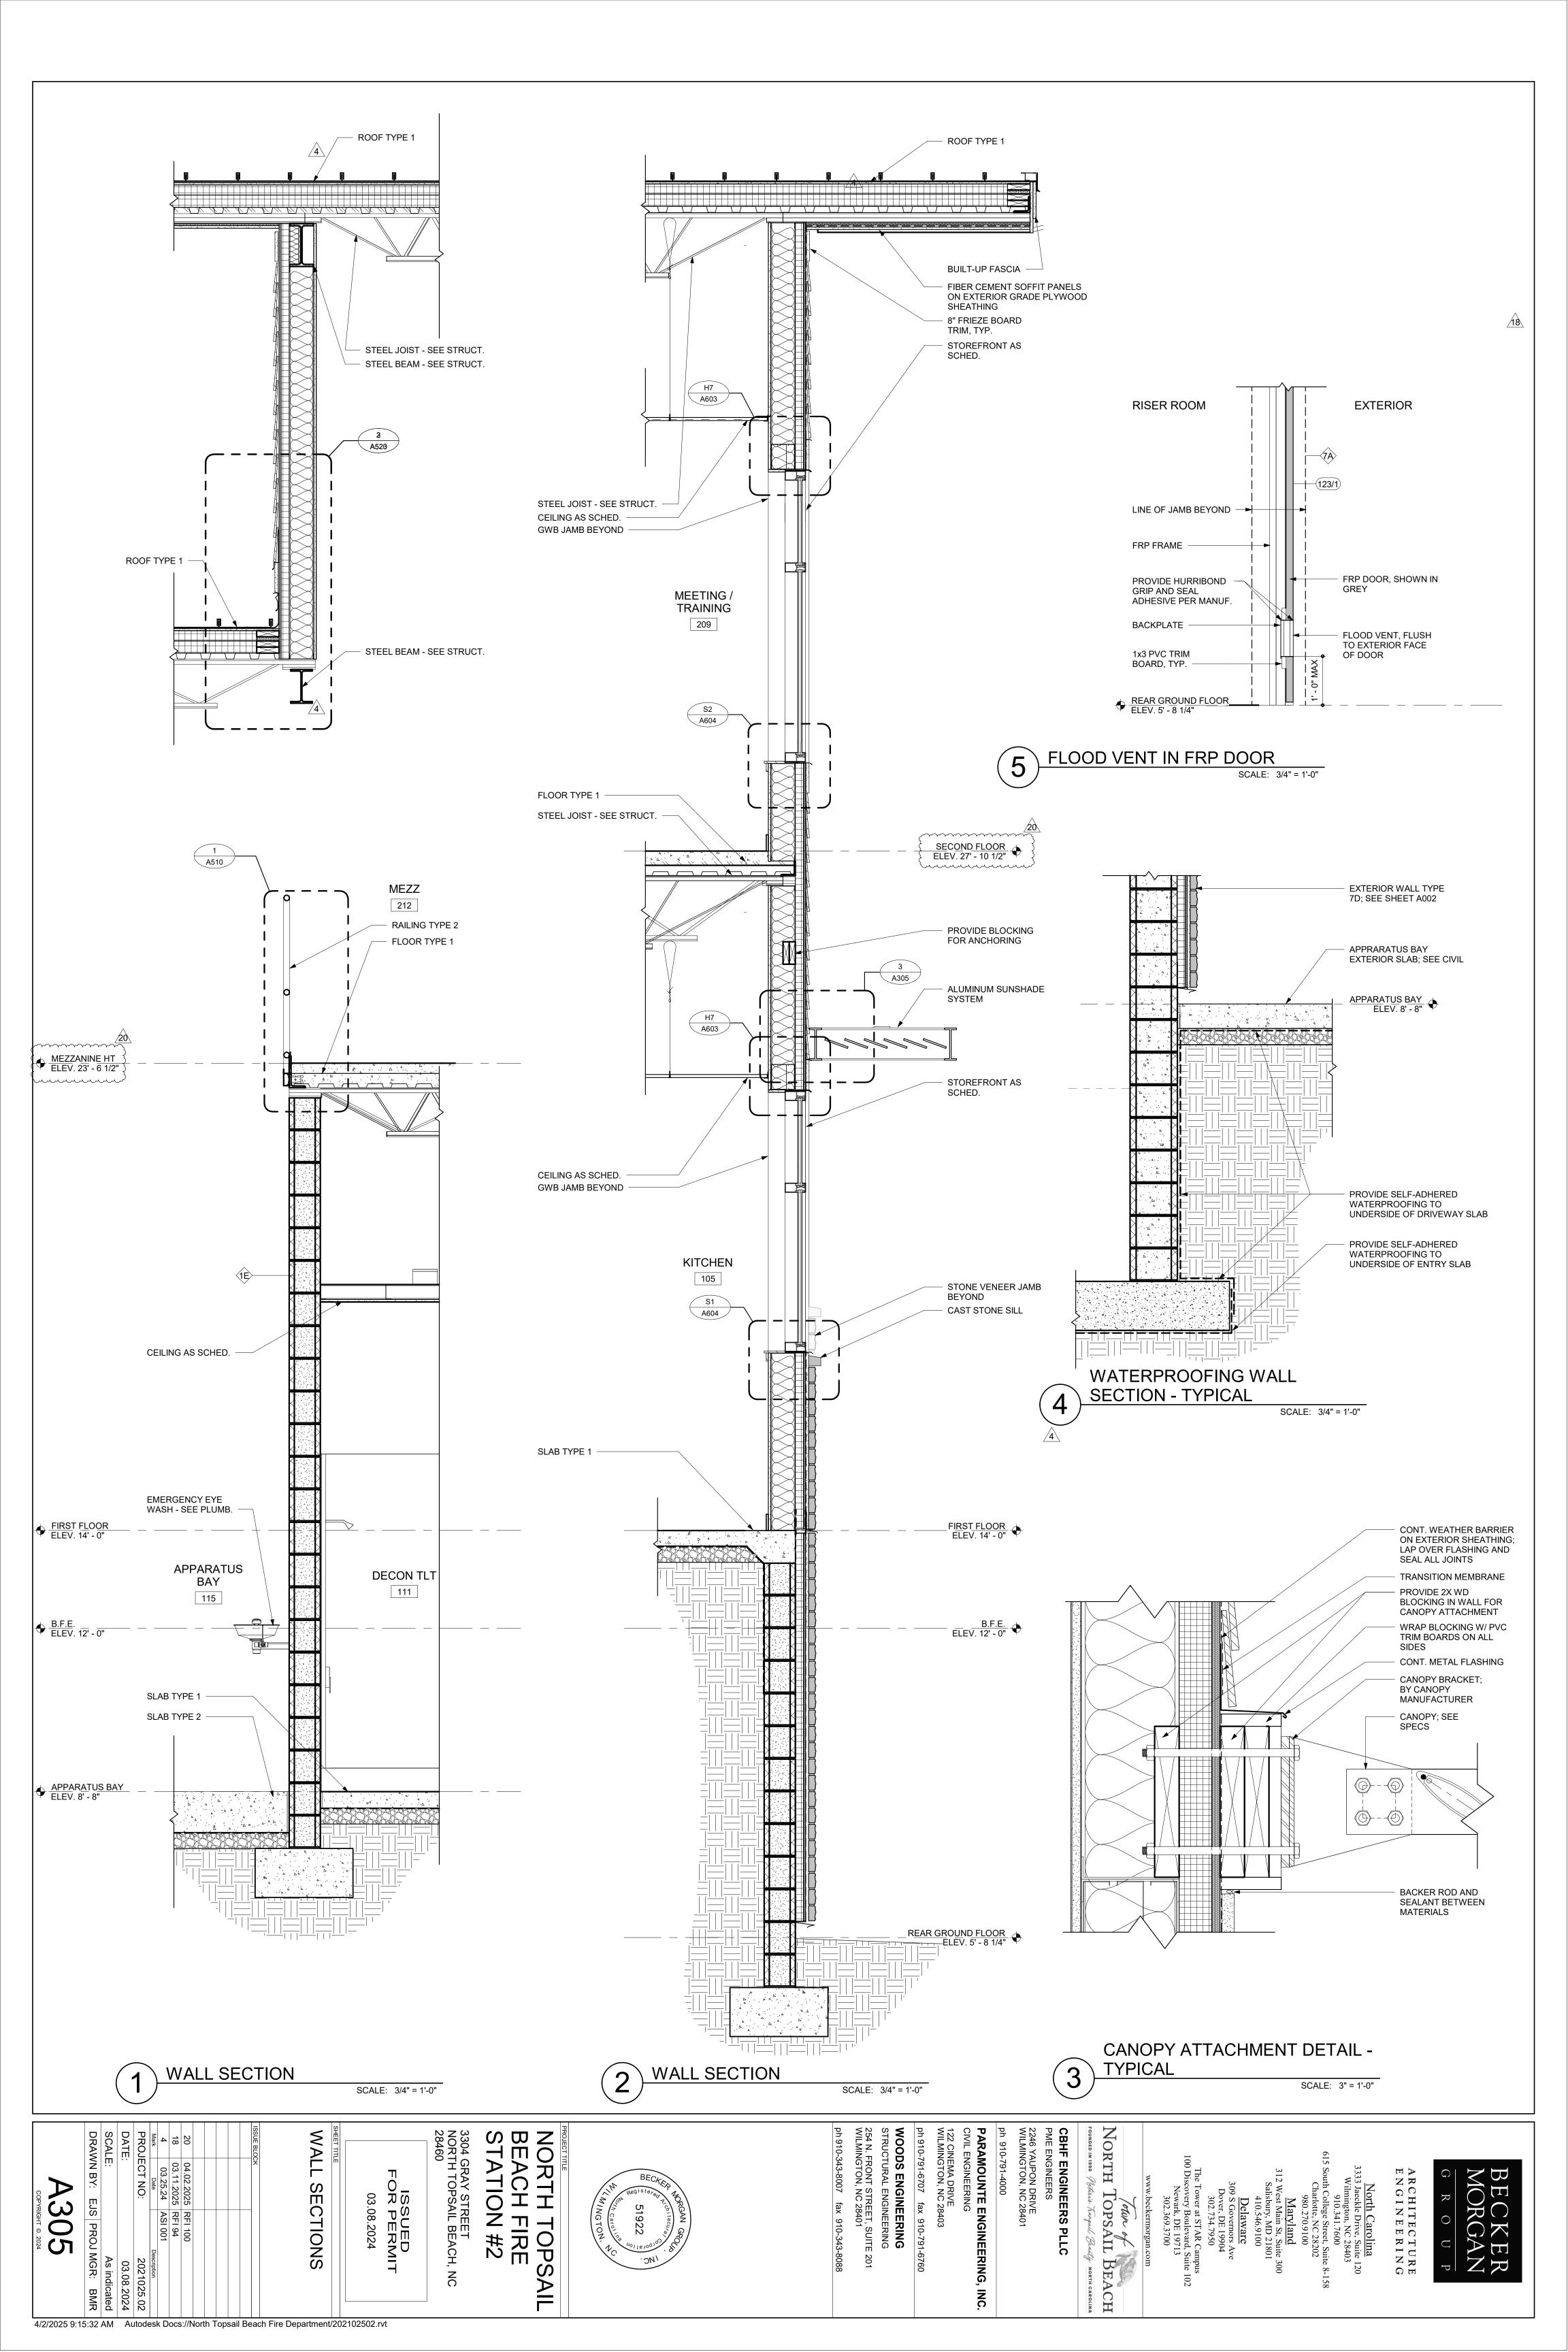
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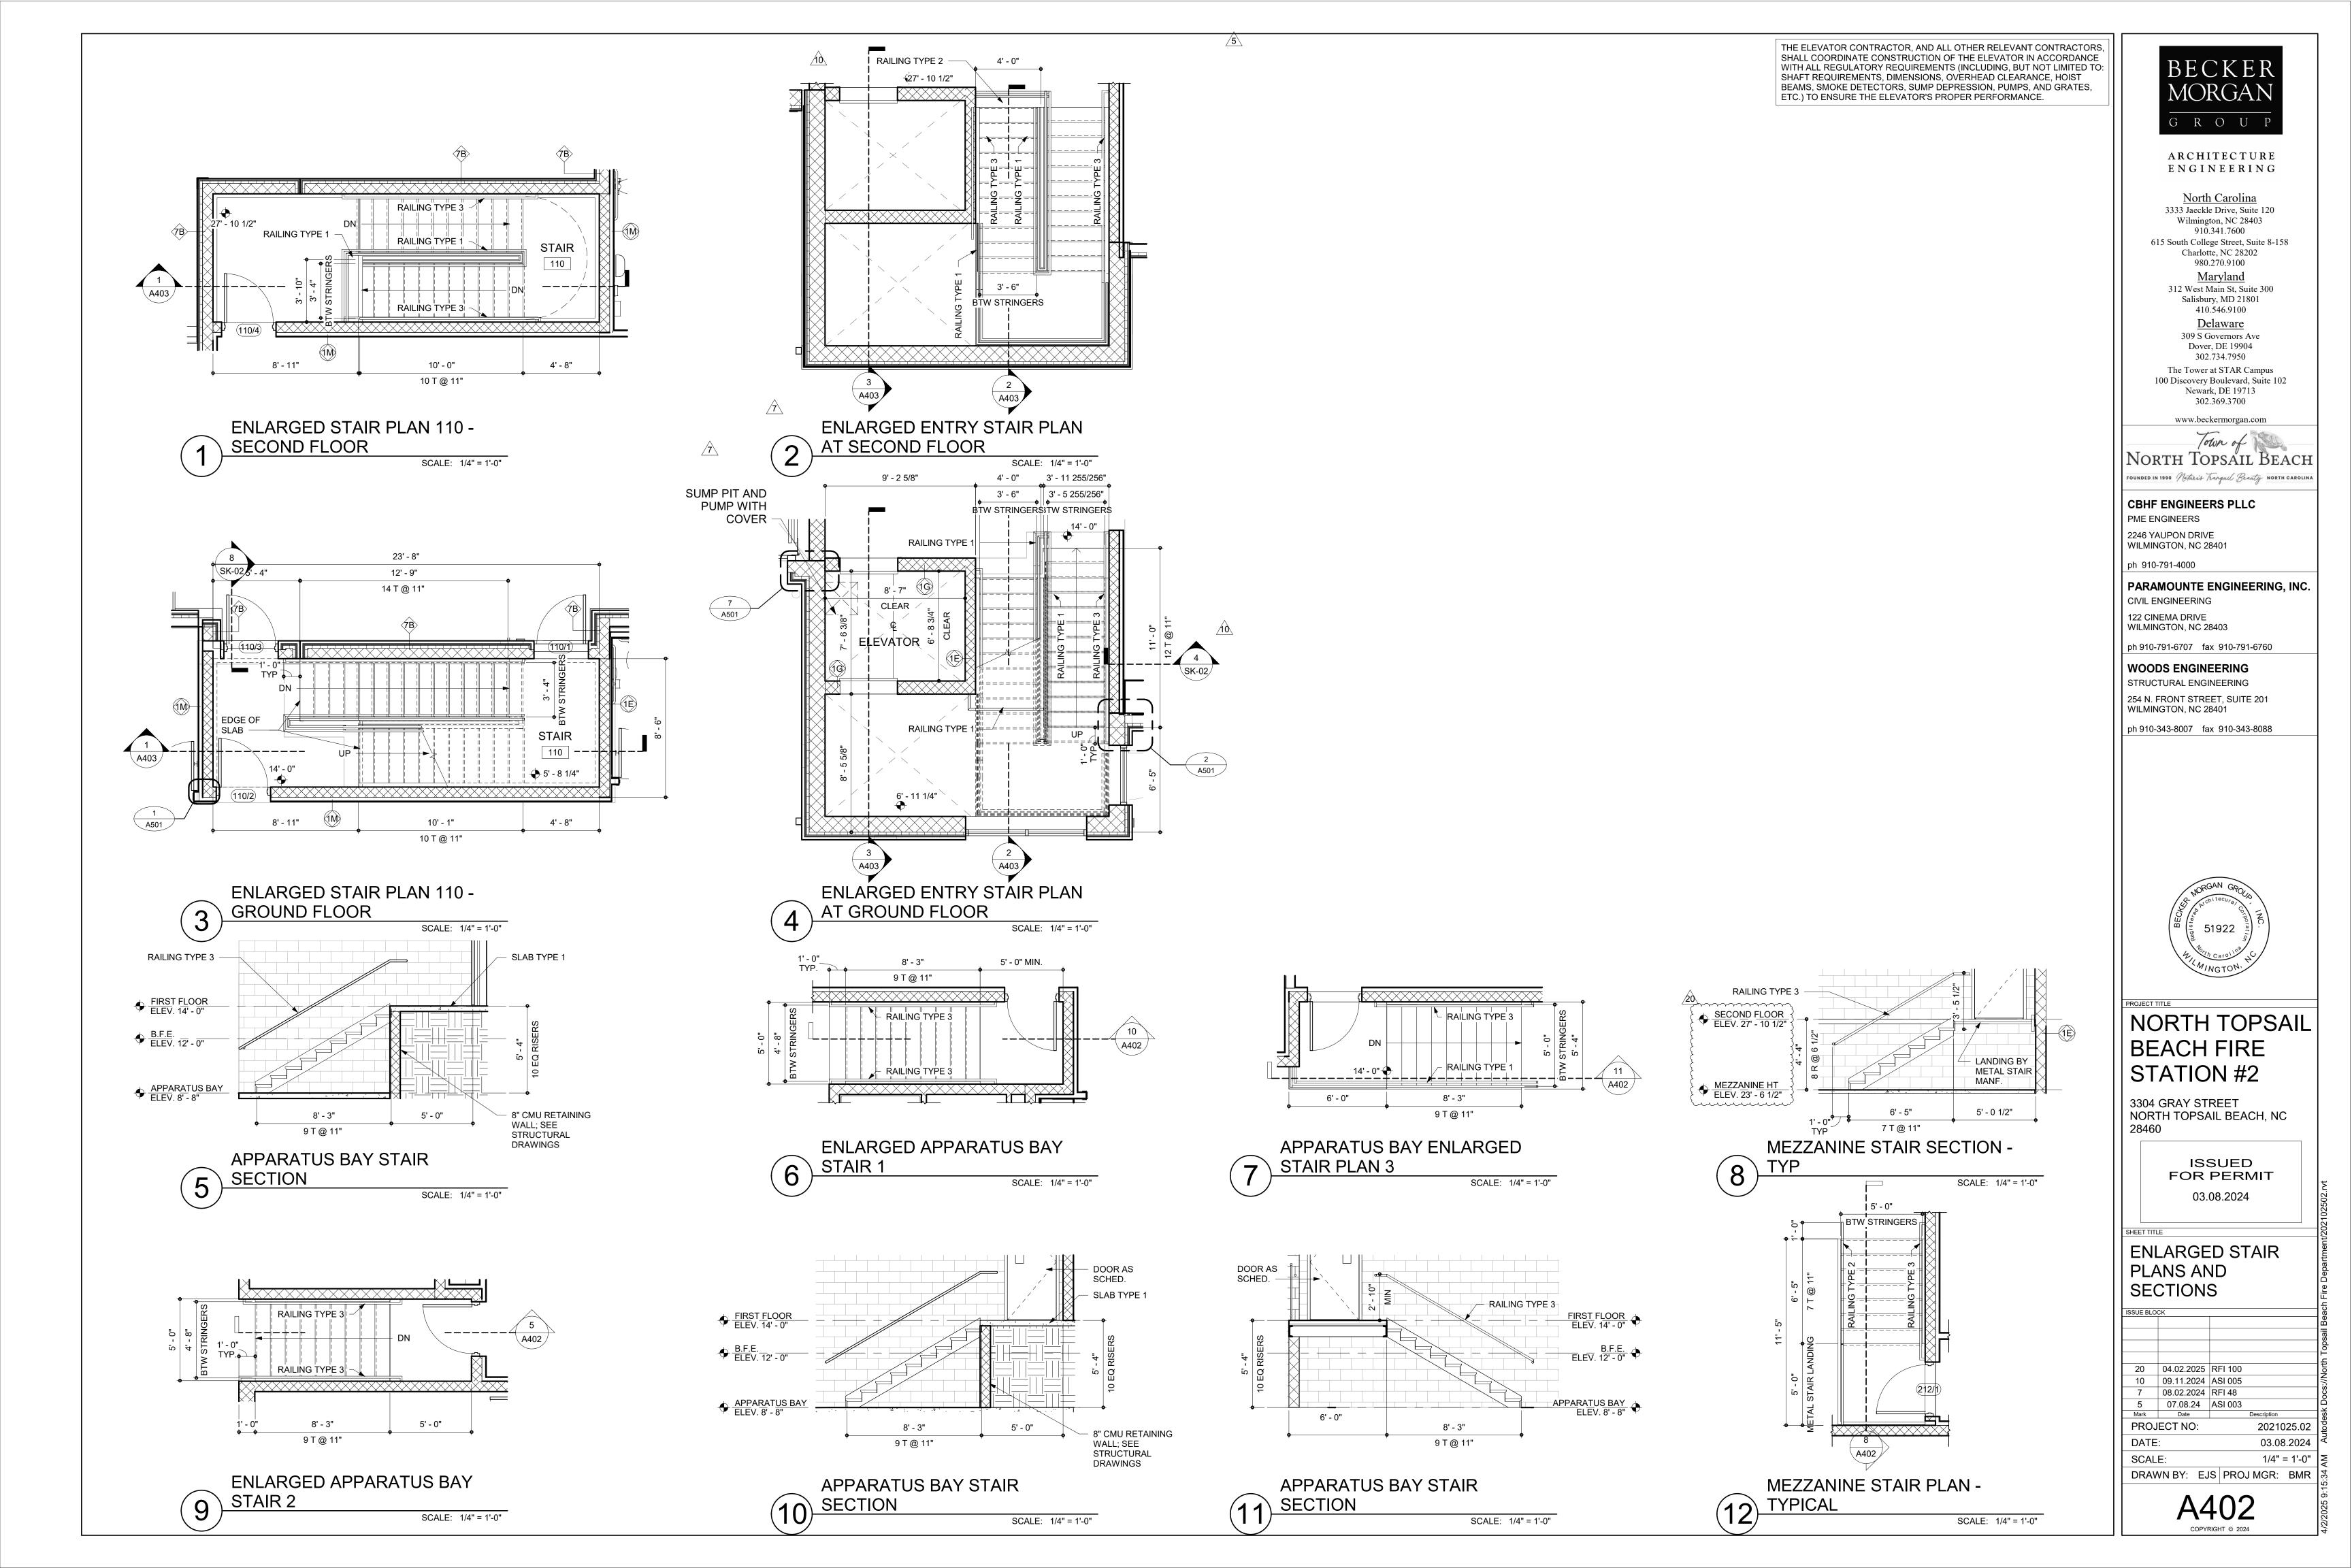
A302


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03.08.2024







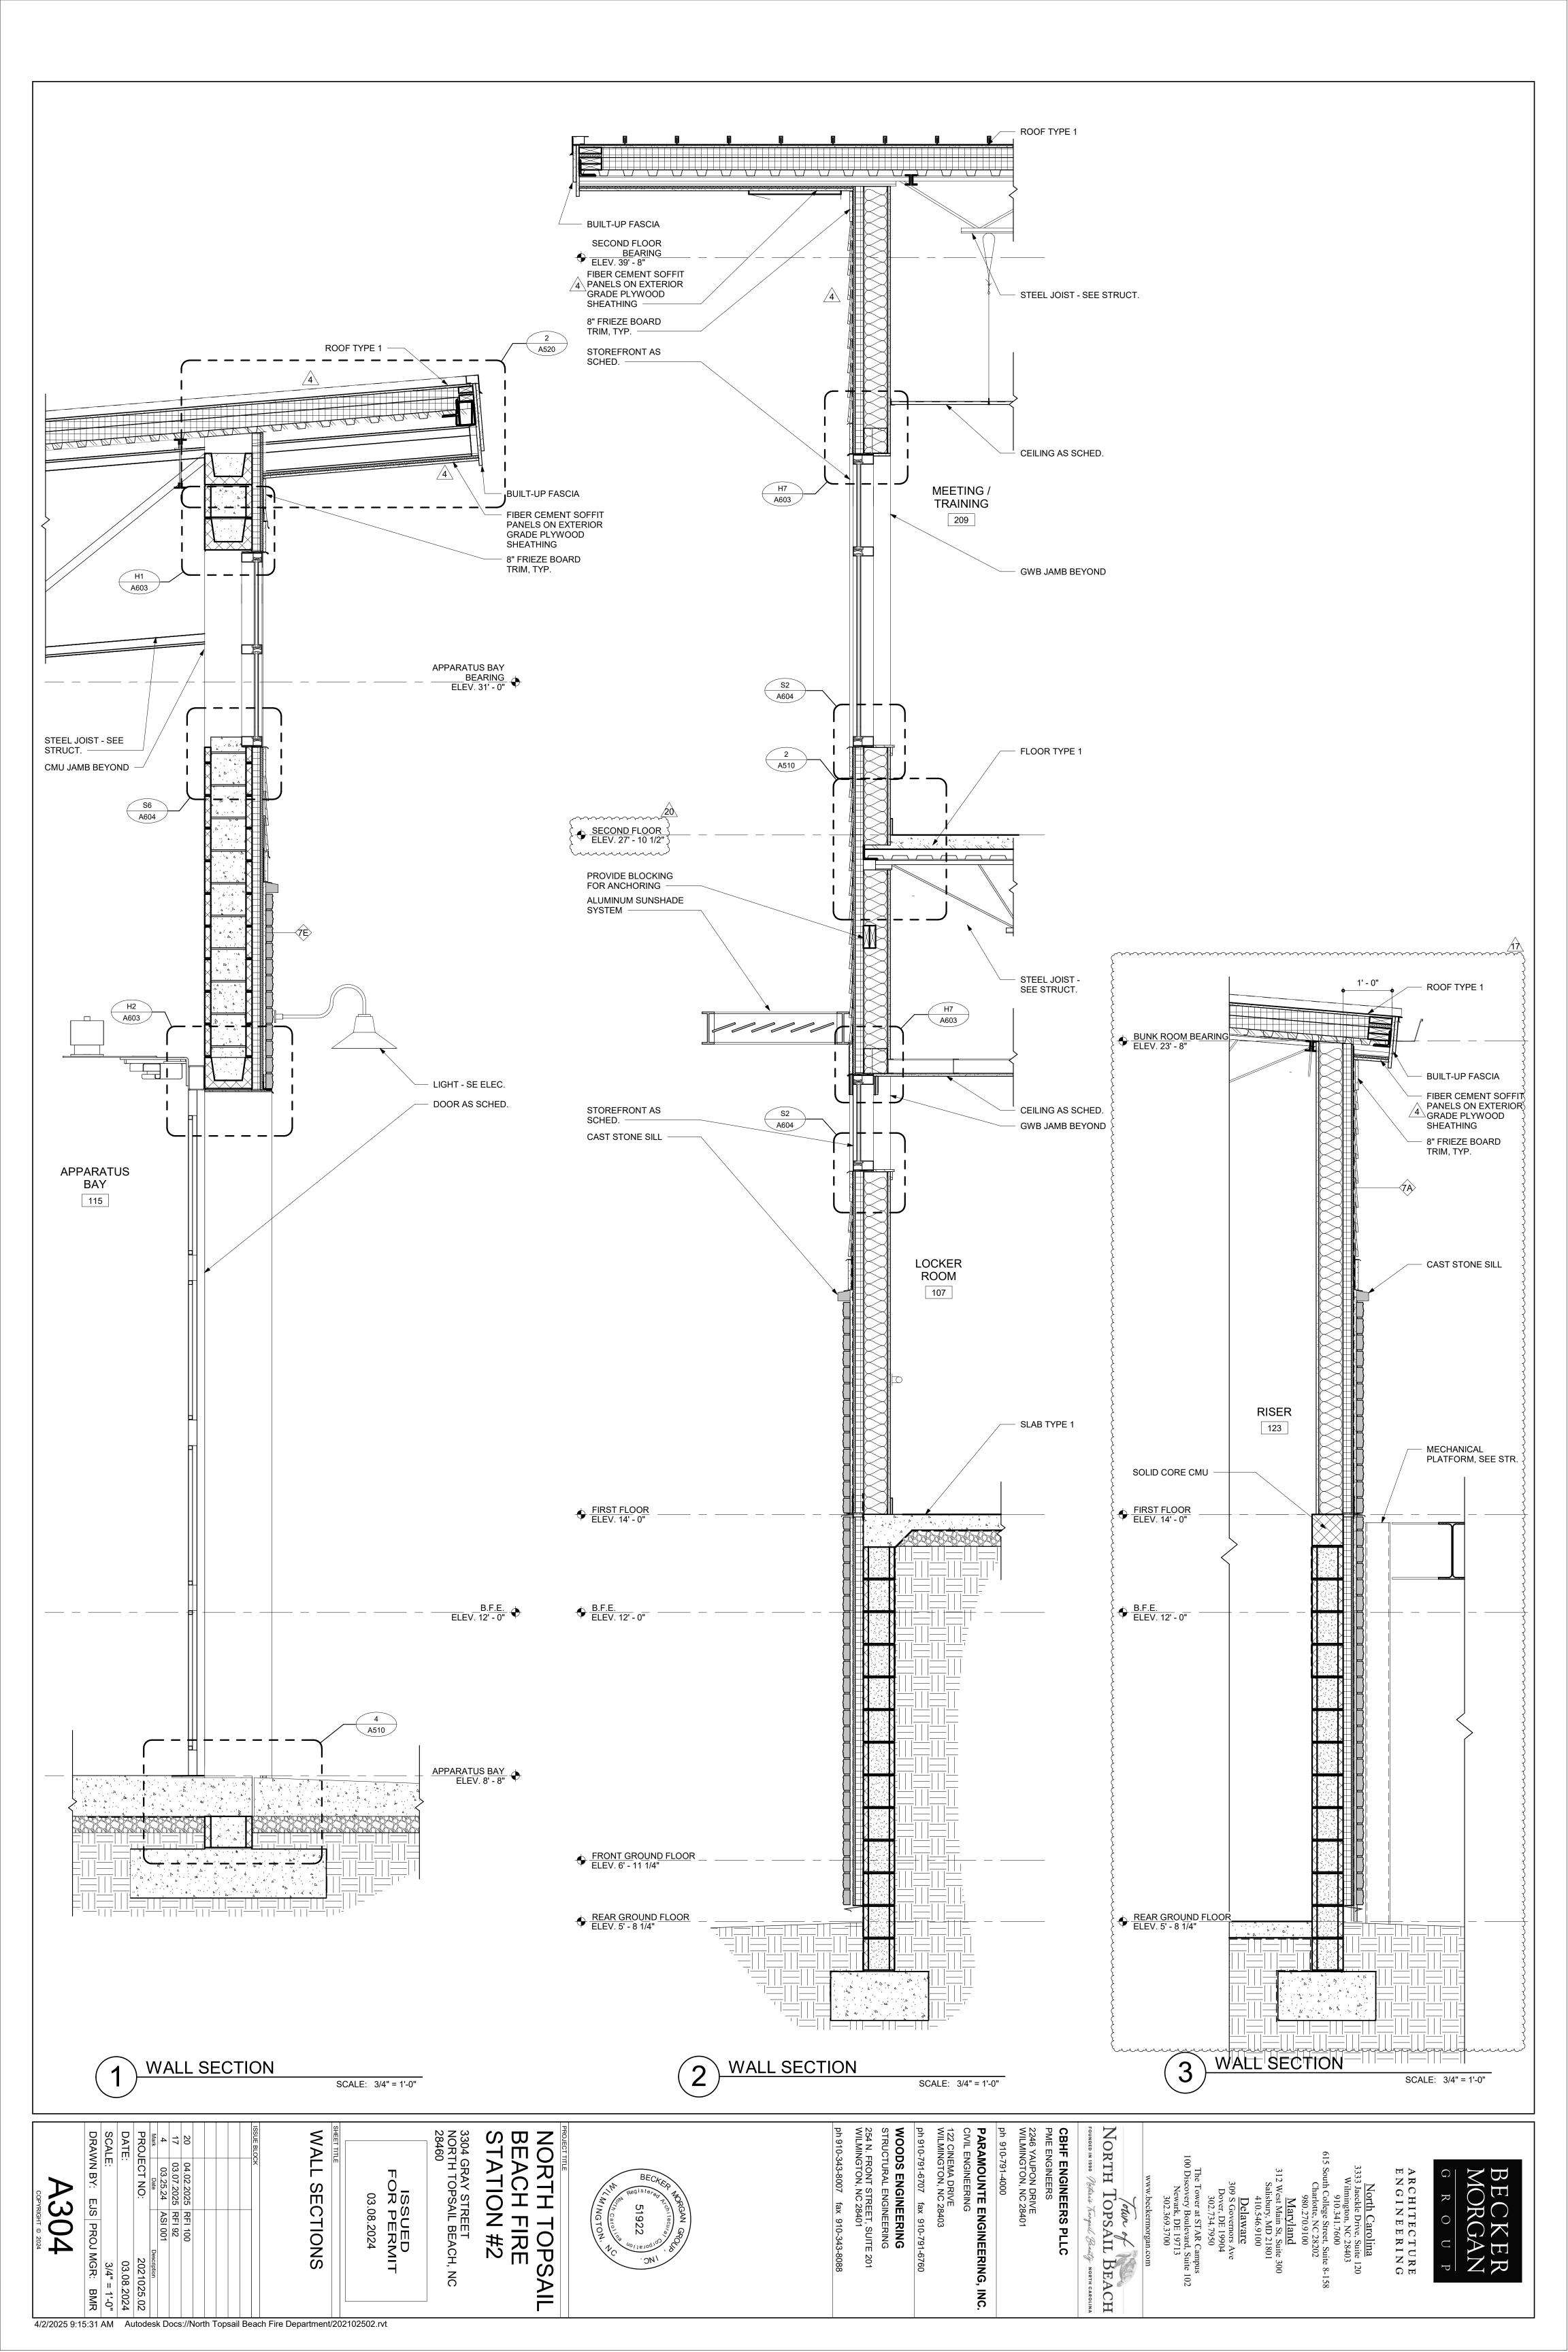
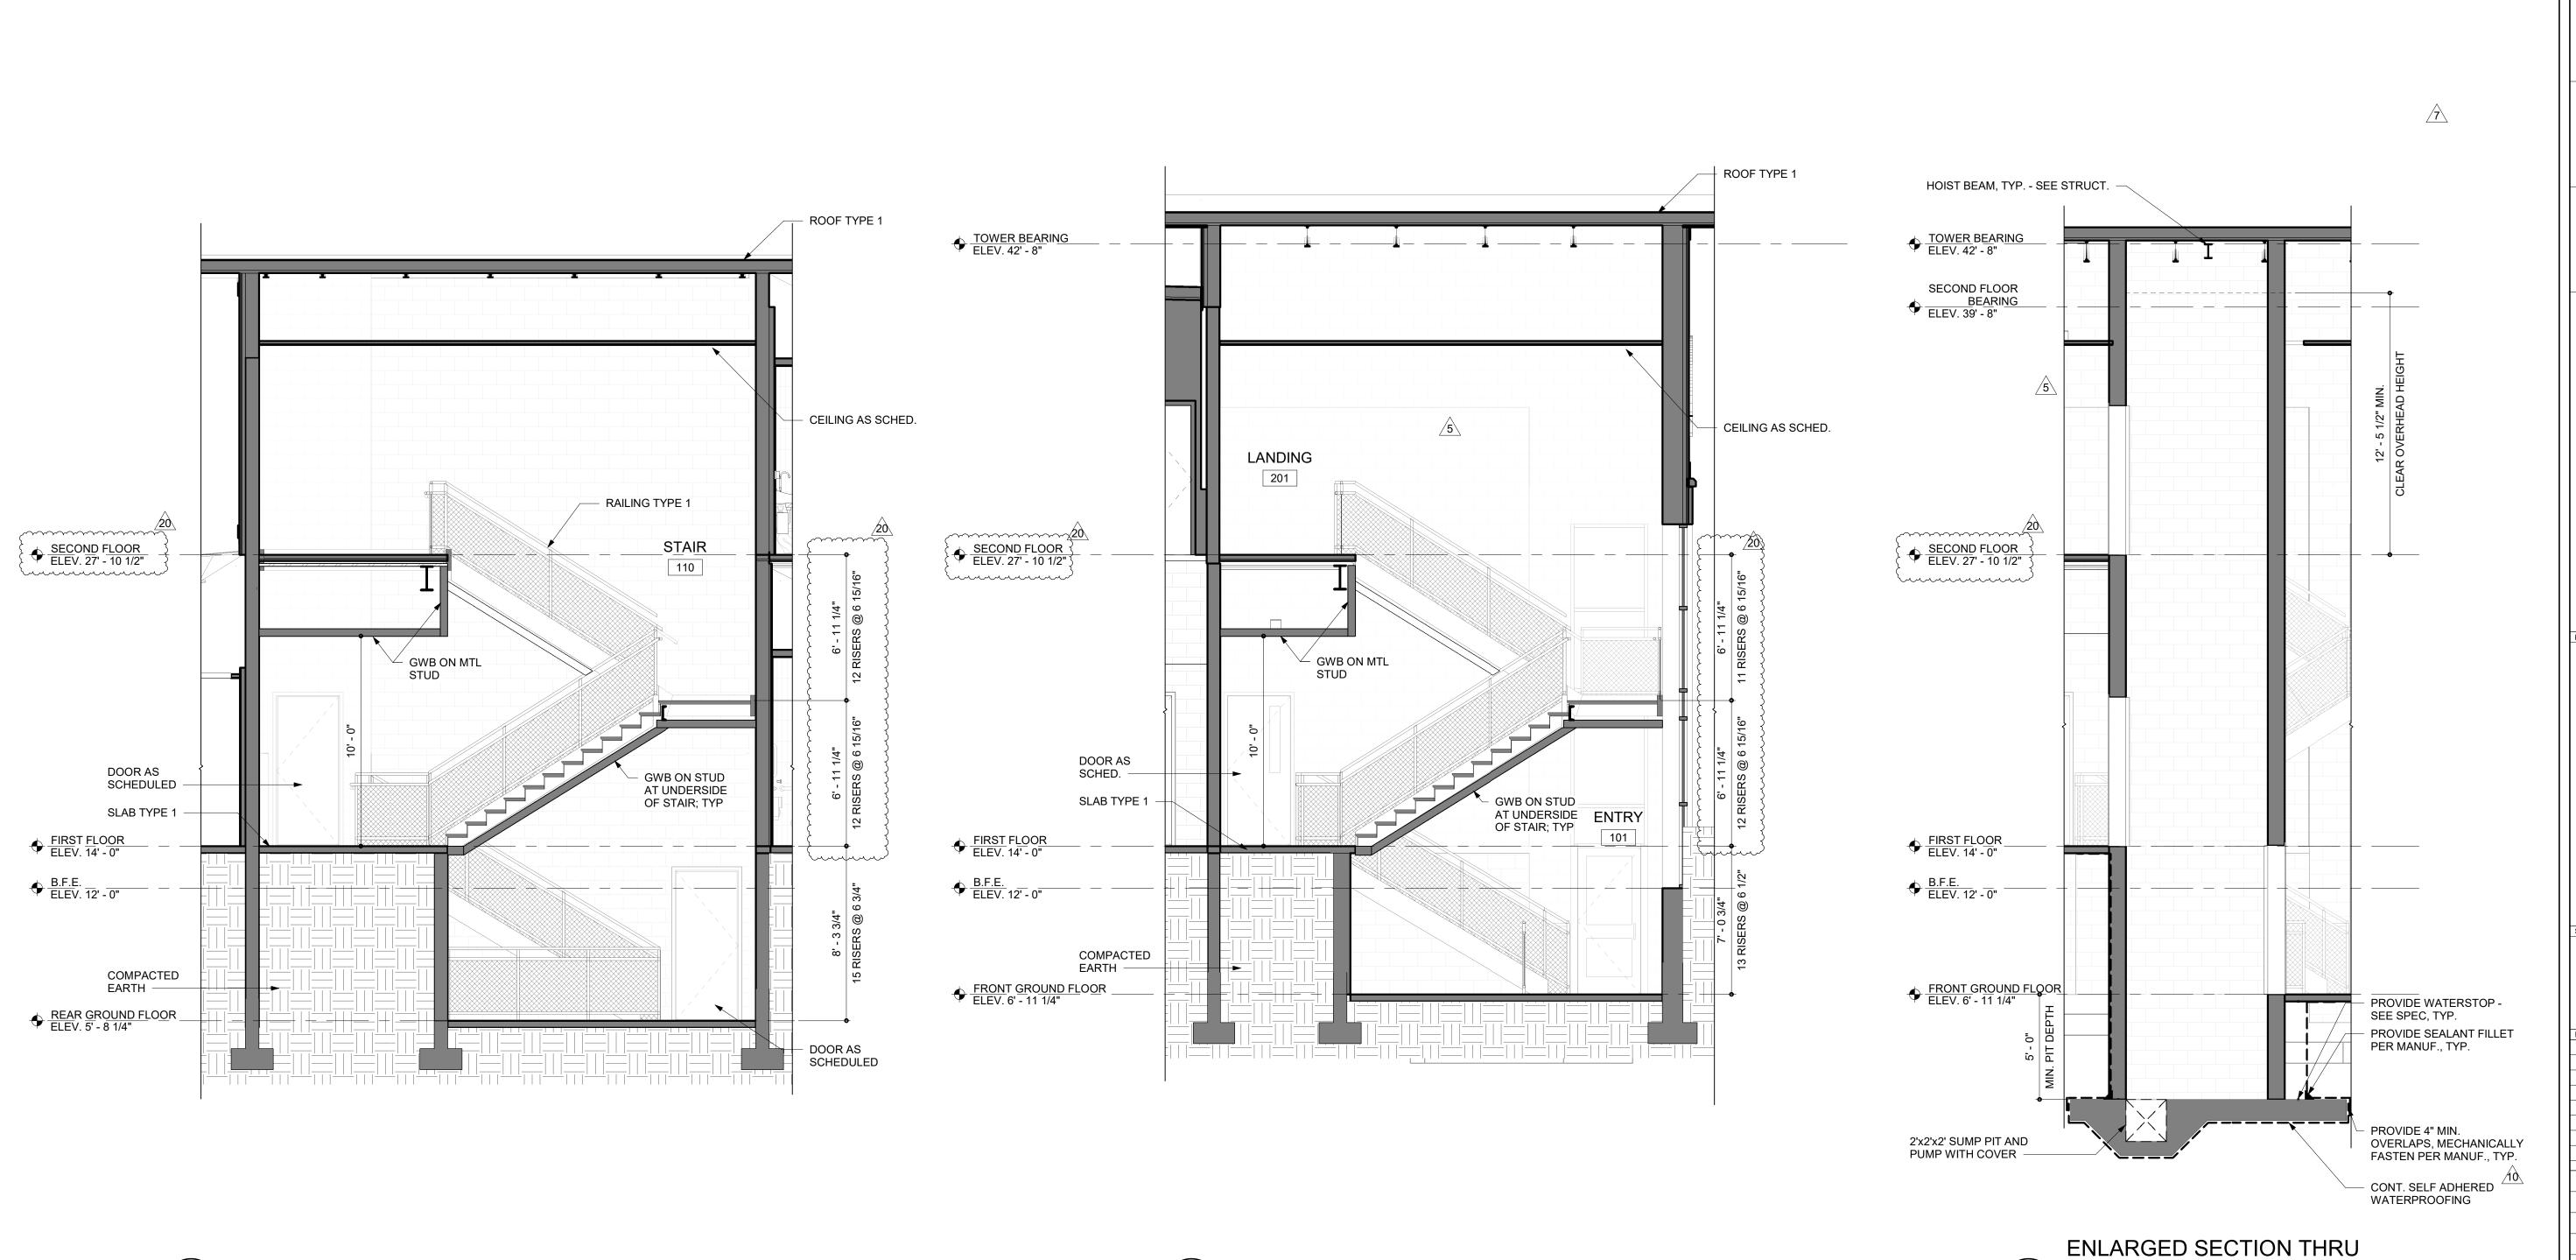
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NORTH TOPSAIL BEACH FIRE STATION #2

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ISSUED FOR PERMIT 03.08.2024

ENLARGED STAIR AND ELEVATOR SECTIONS

20 04.02.2025 RFI 100 10 09.11.2024 ASI 005 7 08.02.2024 RFI 48 5 07.08.24 ASI 003 4 03.25.24 ASI 001 Mark Date

PROJECT NO:

DATE:

\ ELEVATOR

SCALE: 1/4" = 1'-0"

1/4" = 1'-0" DRAWN BY: BMR PROJ MGR: BMR

A403


2021025.02


03.08.2024


ENTRY 101 STAIR SECTION


STAIR 110 SECTION

SCALE: 1/4" = 1'-0"

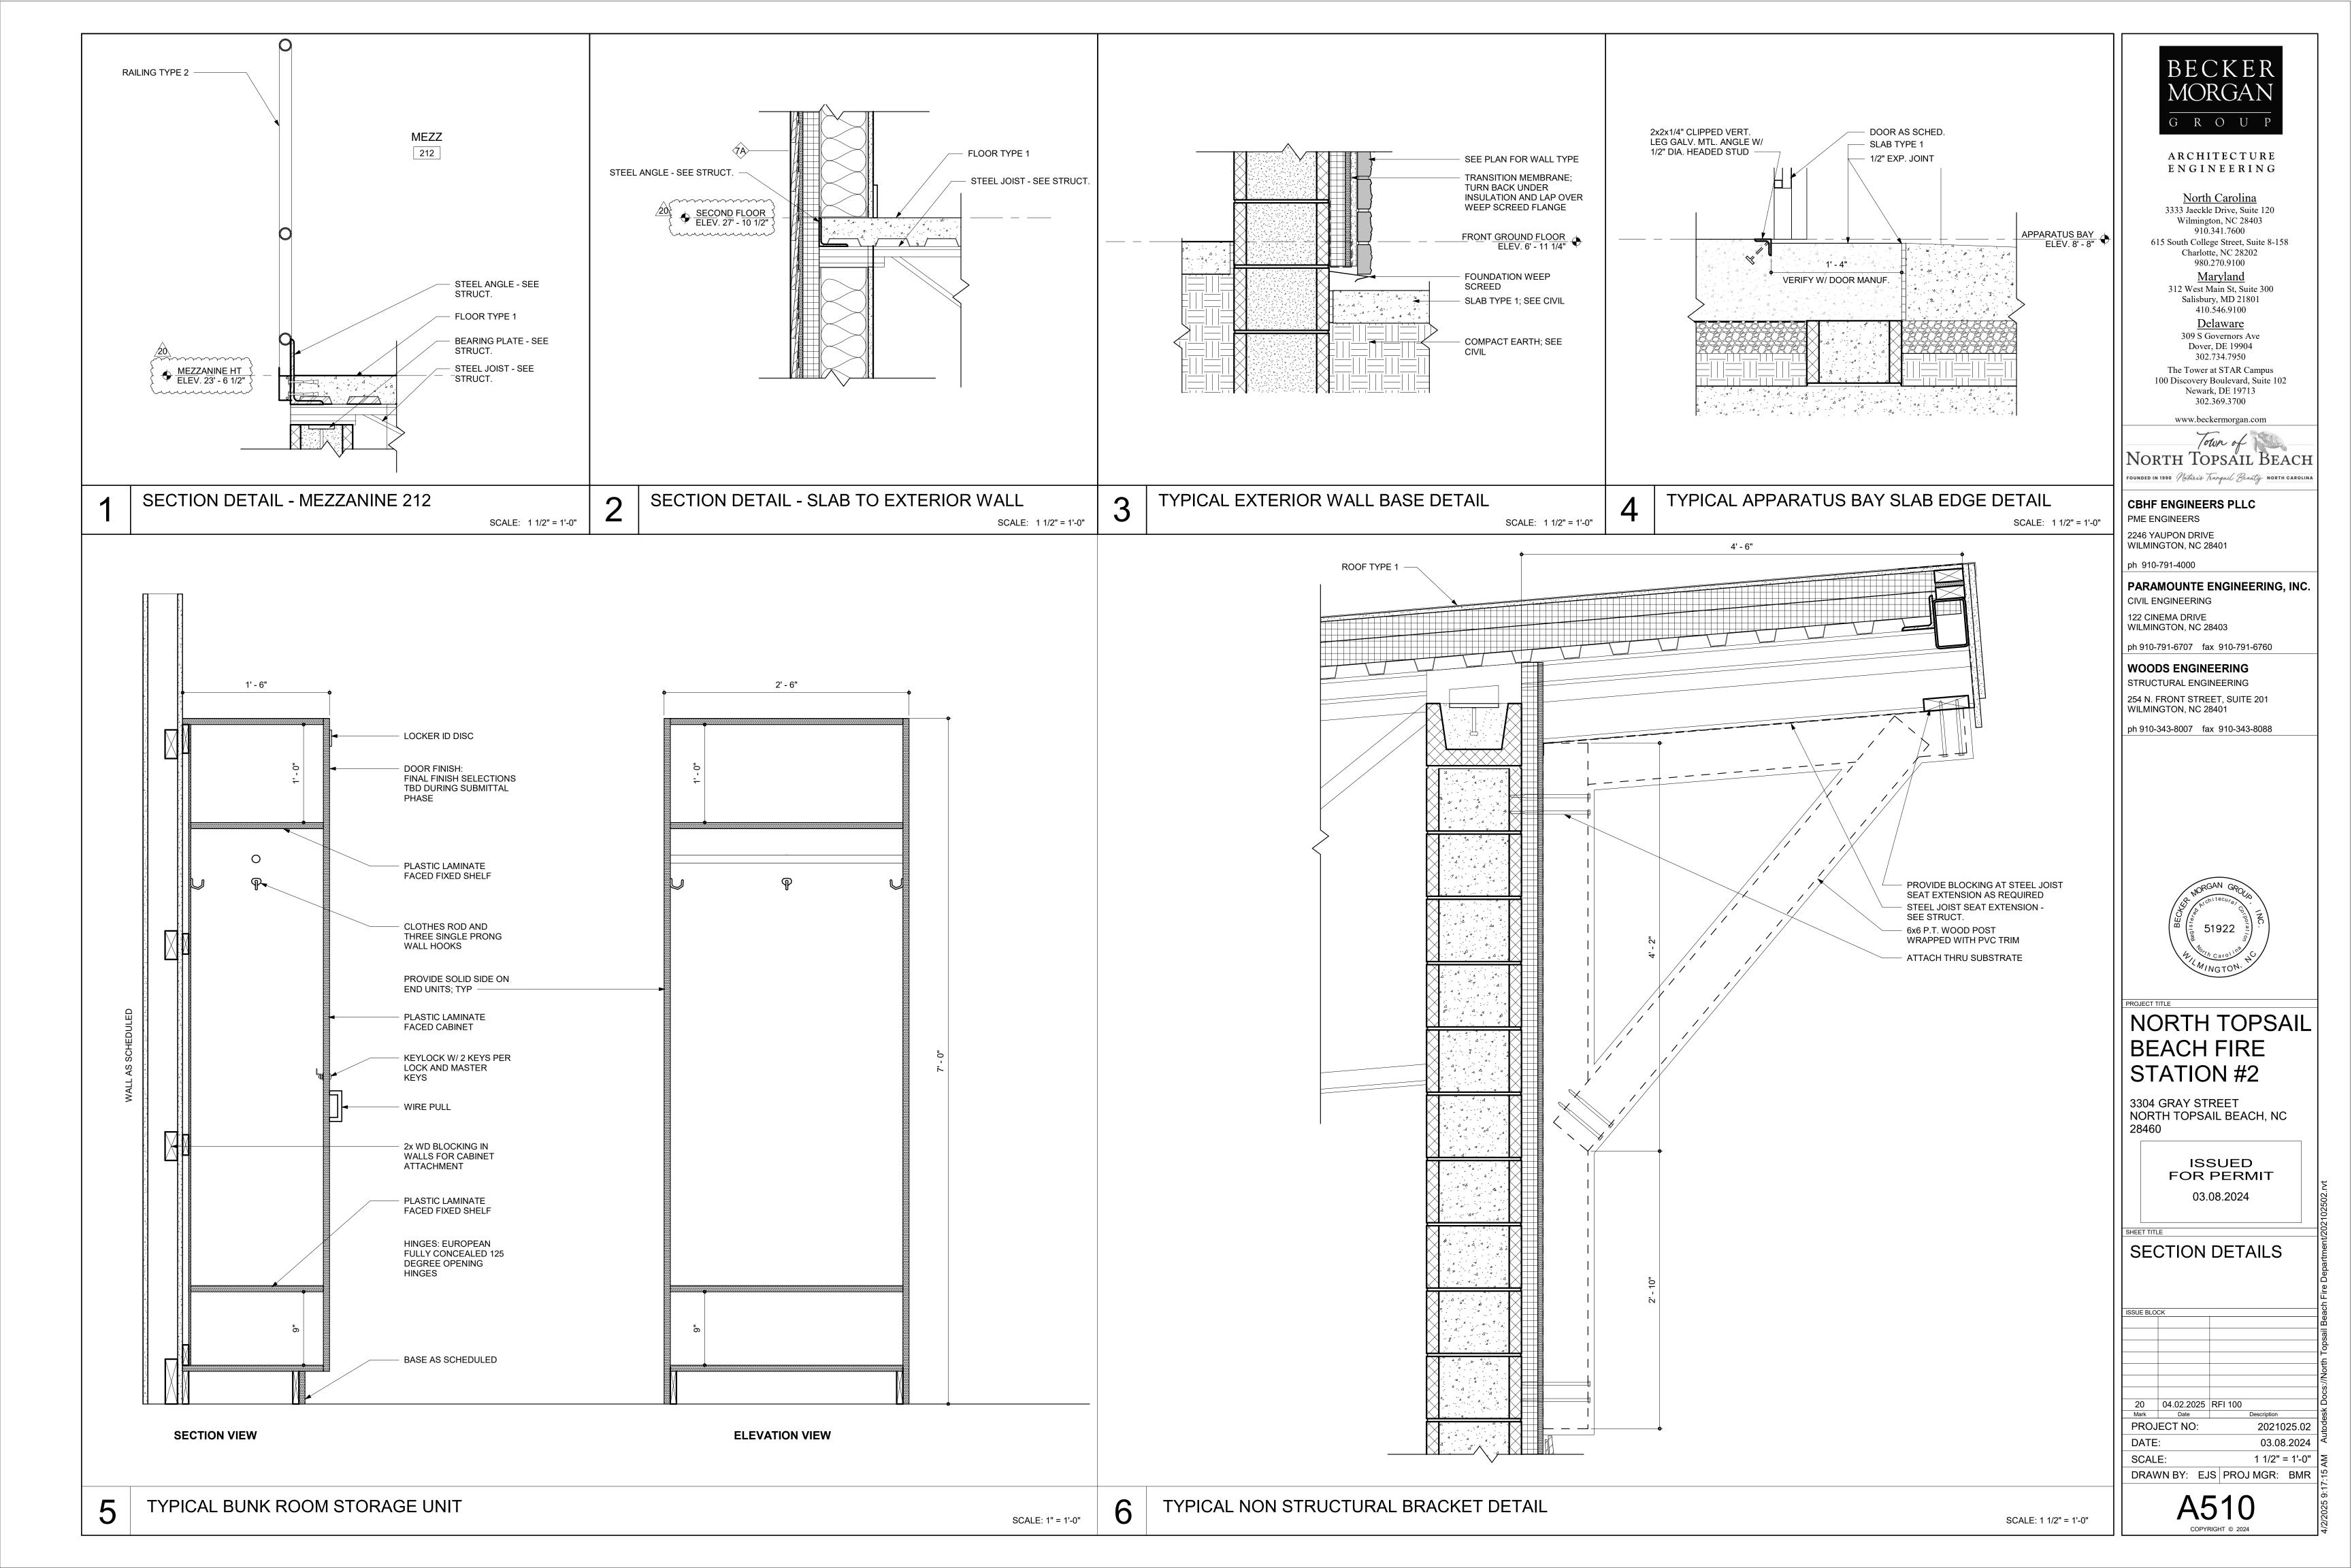

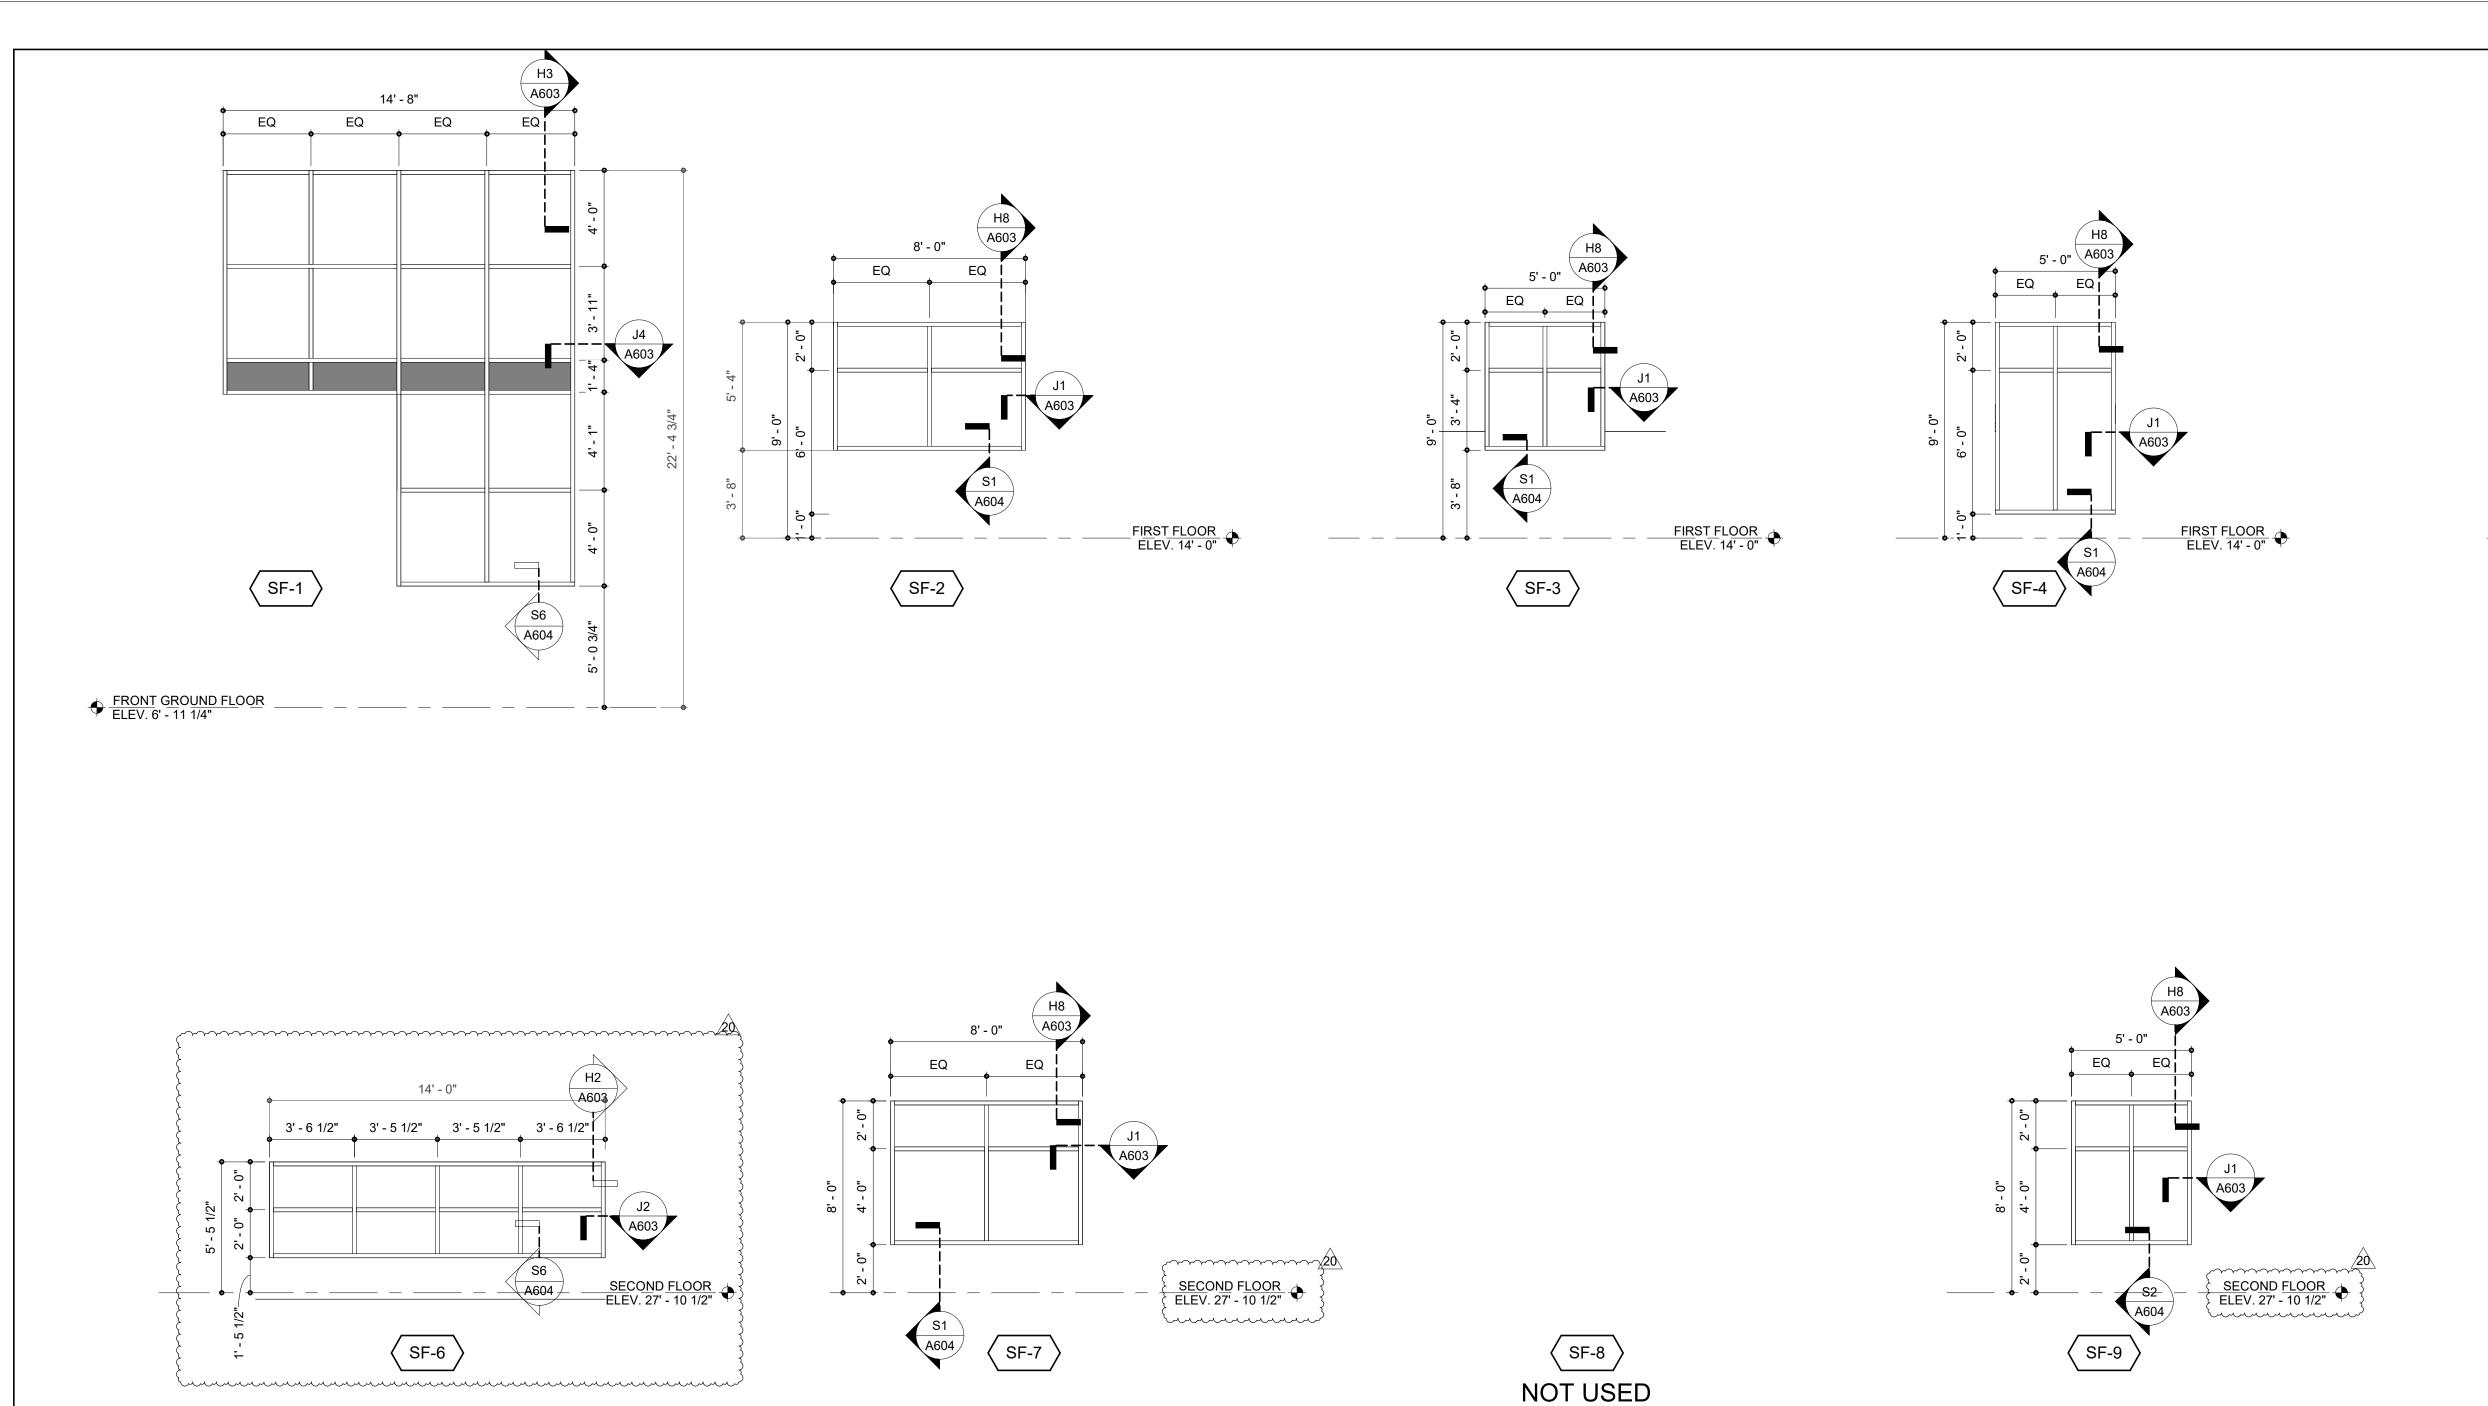

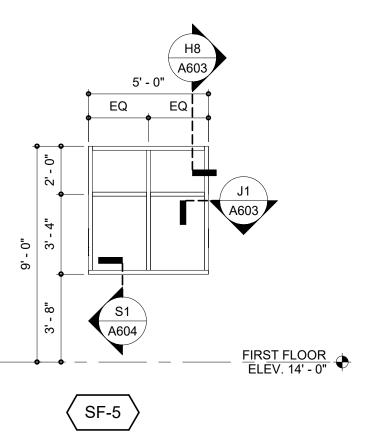

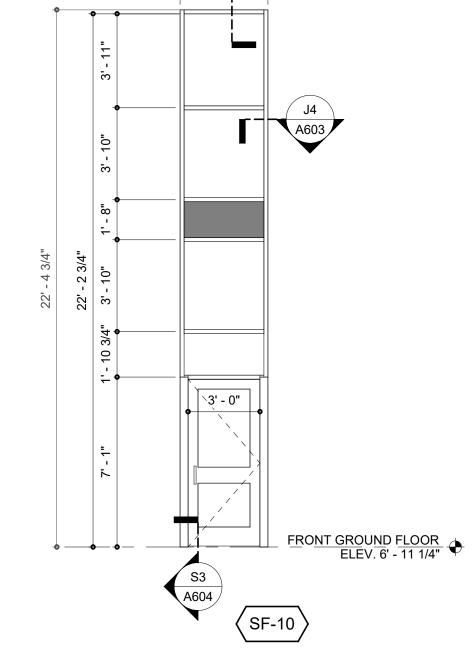

GLAZING LEGEND

- GLAZING SHALL BE TEMPERED IN DOORS, BORROW LIGHTS, SIDE LIGHTS, AND AS REQUIRED BY CODE, AND AS INDICATED GLAZING SHALL BE SAFETY LAMINATED AS REQUIRED BY CODE, AND AS INDICATED.
- CODE, AND AS INDICATED.

 3. PROVIDE FIRE-PROTECTION AND FIRE-RESISTANCE RATED GLAZING AS REQUIRED BY CODE.

 4. EXTERIOR GLAZING SHALL BE INSULATED.
 - LAMINATED GLAZING





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615 South College Street, Suite 8-158
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Town of

NORTH TOPSAIL BEACH
FOUNDED IN 1990 Nature's Tranquil Beauty NORTH CAROLINA

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NORTH TOPSAIL BEACH FIRE STATION #2

3304 GRAY STREET NORTH TOPSAIL BEACH, NC

> ISSUED FOR PERMIT 03.08.2024

STOREFRONT ELEVATIONS

ISSUE BLOCK

20 04.02.2025 RFI 100
Mark Date Description

 PROJECT NO:
 2021025.02

 DATE:
 03.08.2024

 SCALE:
 As indicated

SCALE: As indicated

DRAWN BY: EJS PROJ MGR: BMR

A602

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EXHIBIT B (Construction Change Directive Number 01)

The proposed basis of adjustment to the Contract Sum is as follows:

Increase the Contract Sum by \$26,590.01 as follows:

• Subcontractors + Contractor Profit & Overhead thereon totaling \$20,545.85.\textsup The Subcontractor work is summarized in the following table. Note that in some instances, the amount listed in the following table differs from the amount set forth in a Subcontractor Proposal. The table amounts reflect the amounts deemed proper for use in adjusting the Contract Sum.

Subcontractor	<u>Description</u>	<u>Amount</u>
Grey Interiors, LLC	Material, labor and equipment to add a 2.5" distribution header on top of the track on the exterior wall to compensate for the inbed locations. Reference Grey Interiors Proposal dated April 21, 2025, RFC Number 2R1. Of the total Proposal of amount of \$5,442.68, the sum of \$976.43 was approved as Change Order Number 04 dated April 24, 2025, resulting in the adjusted amount of \$4,466.25. The \$4,466.25 includes 40 hours of labor to provide the new track and drywall, at a cost of \$1,120. That appears excessive, but for purposes of this CCD, is included in the proposed increase in the Contract Sum.	\$4,466.25
E.L. Jones Development, LLC	Replace two hollow metal doors and frames. Reference E.L. Jones Proposal dated April 21, 2025.	\$1,652.00
Citadel Masonry, LLC	Remove two hollow metal door frames and raise masonry openings at three openings on the second floor. Reference Citadel Masonry Proposal dated April 21, 2025, RFC Number 4.	\$2,029.51
Independent Services	Revise stairwell shop drawings and offsite delivery and unloading of mechanical platform(s) for temporary storage. Reference Independent Services Proposal dated April 11, 2025. The Proposal included \$4,200 for revising shop drawings for Stairwell 101 and Stairwell 110. However, Stairwell 110 has yet to be submitted or approved and, as such, at most half of the \$4,200 for revised shop drawings is appropriate.	\$5,850.00

¹ Contractor has provided a proposal from TK Elevator for \$6,694.00 to add 2.5" to the total travel for the elevator. However, the total travel for the elevator was not increased. Rather, only the second floor stop location was adjusted. Accordingly, no amount is due for the TK Elevator proposal.

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Nationwide Electrical Services, Inc.	Generator platform extra off-loading, storage, and delivery. Reference Nationwide Electrical Proposal #4 dated April 21, 2025. The Proposal was in the total amount of \$42,294.80, of which \$426.60 was to raise devices boxes by 2.5". Because there does not appear to be a need to raise device boxes, this amount is not included in the amount of the proposed increase in the Contract Sum.	\$3,868.20
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Subcontractor Subtotal: \$17,865.96

Contractor Profit & Overhead (15%): \$2,679.89

Total Subcontractor Costs:

\$20,545.85

• Contractor Direct Costs (Labor):

Contractor Direct Costs (Labor) totaling: \$5,625.42. The compensable Contractor Direct Costs (Labor) are summarized in the following table. Contractor has requested an increase in the Contract Sum for Contractor Labor and Equipment. The majority of the requested increase for Contractor Labor and Equipment appears based on the Contractor's assertion that the need to perform, and the performance of, the Work directed by this Construction Change Directive entitles the Contractor to a 55 day increase in the Contract Time. At this time, the Contractor has not demonstrated that the need for, and performance of, the Work that is the subject of this Construction Change Directive impacts the critical path, nor the extent of any such impact. Similarly, the Contractor has not demonstrated the causes of alleged delays to the critical path for the Project, nor apportioned the total delay to the responsible parties. Absent the Contractor establishing these matters, the Contractor is not entitled to an increase in the Contract Time, nor to an increase in the Contract Sum for extended duration charges for Contractor Labor and Equipment. Unless and until any increase in the Contract Time is properly substantiated, the Contract Sum cannot be increased for alleged extended duration Contractor Labor and Contractor Equipment. The items of Contractor Labor for which an increase in the Contract Sum is proposed represents Contractor Labor that appears reasonably necessary because of the need for, and performance of, the Work that is the subject of this Construction Change Directive.

Category	Hours	Hourly Rate	Amount
Project Management	10	\$56.50	\$565.00
Project Superintendent	15	\$52.88	\$793.20
Estimator + Admin	12	\$45.67	\$548.04

Scheduler ²	12.5	\$120.00	\$1,500.00
Contracts	12	\$36.07	\$432.84
Administrator			
Contractor Direct Costs Subtotal:			\$3,839.08
Payroll Taxes & Insurance (Burden Rate) (45%) ³ :			\$1,052.59
Contractor Profit & Overhead (15%):			\$733.75
Total Contractor Direct Costs (Labor):			\$5,625.42
• Subtotal Before Bonds and Insurance:			\$26,171.27
• Bonds and Insurance ⁴ :			
General Liability Insurance (0.50%):			\$130.86
Payment & Performance Bonds (1.10%)			\$287.88

TOTAL PROPOSED INCREASE IN CONTRACT SUM:

Total Bonds and Insurance:

\$26,590.01

\$418.74

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² It appears that Contractor uses a third-party scheduler rather than an employee scheduler.

³ Because it appears that Contractor's Scheduler is a third-party consultant rather than an employee, the \$1,500 for Scheduler is not included in computation of the Burden Rate.

⁴ The Contractor requests an increase in Builders Risk Insurance Policy based on the Contractor's contention that the Work that is the subject of this Construction Change Directive entitles it to a 55 day increase in the Contract Time. Because the Contractor has not substantiated any right to an increase in the Contract Time for the Work in question, no increase in the Contract Sum is due for Builders Risk Insurance Policy.