
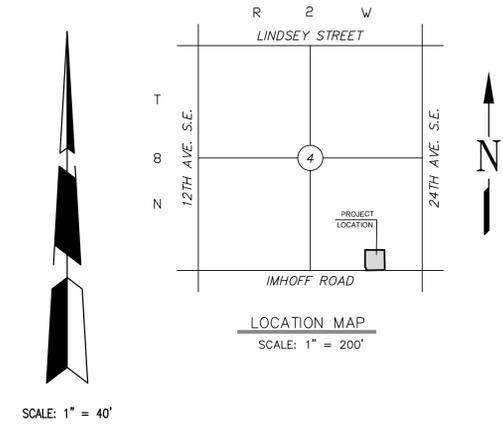


PRELIMINARY PLAT
CRIMSON FLATS

A SIMPLE PLANNED UNIT DEVELOPMENT
A PART OF THE S.E. 1/4 OF SECTION 4, T8N, R2W, I.M.
NORMAN, CLEVELAND COUNTY, OKLAHOMA

OAKHURST ADDITION SECTION 10
BOOK 11 OF PLATS, PAGE 188

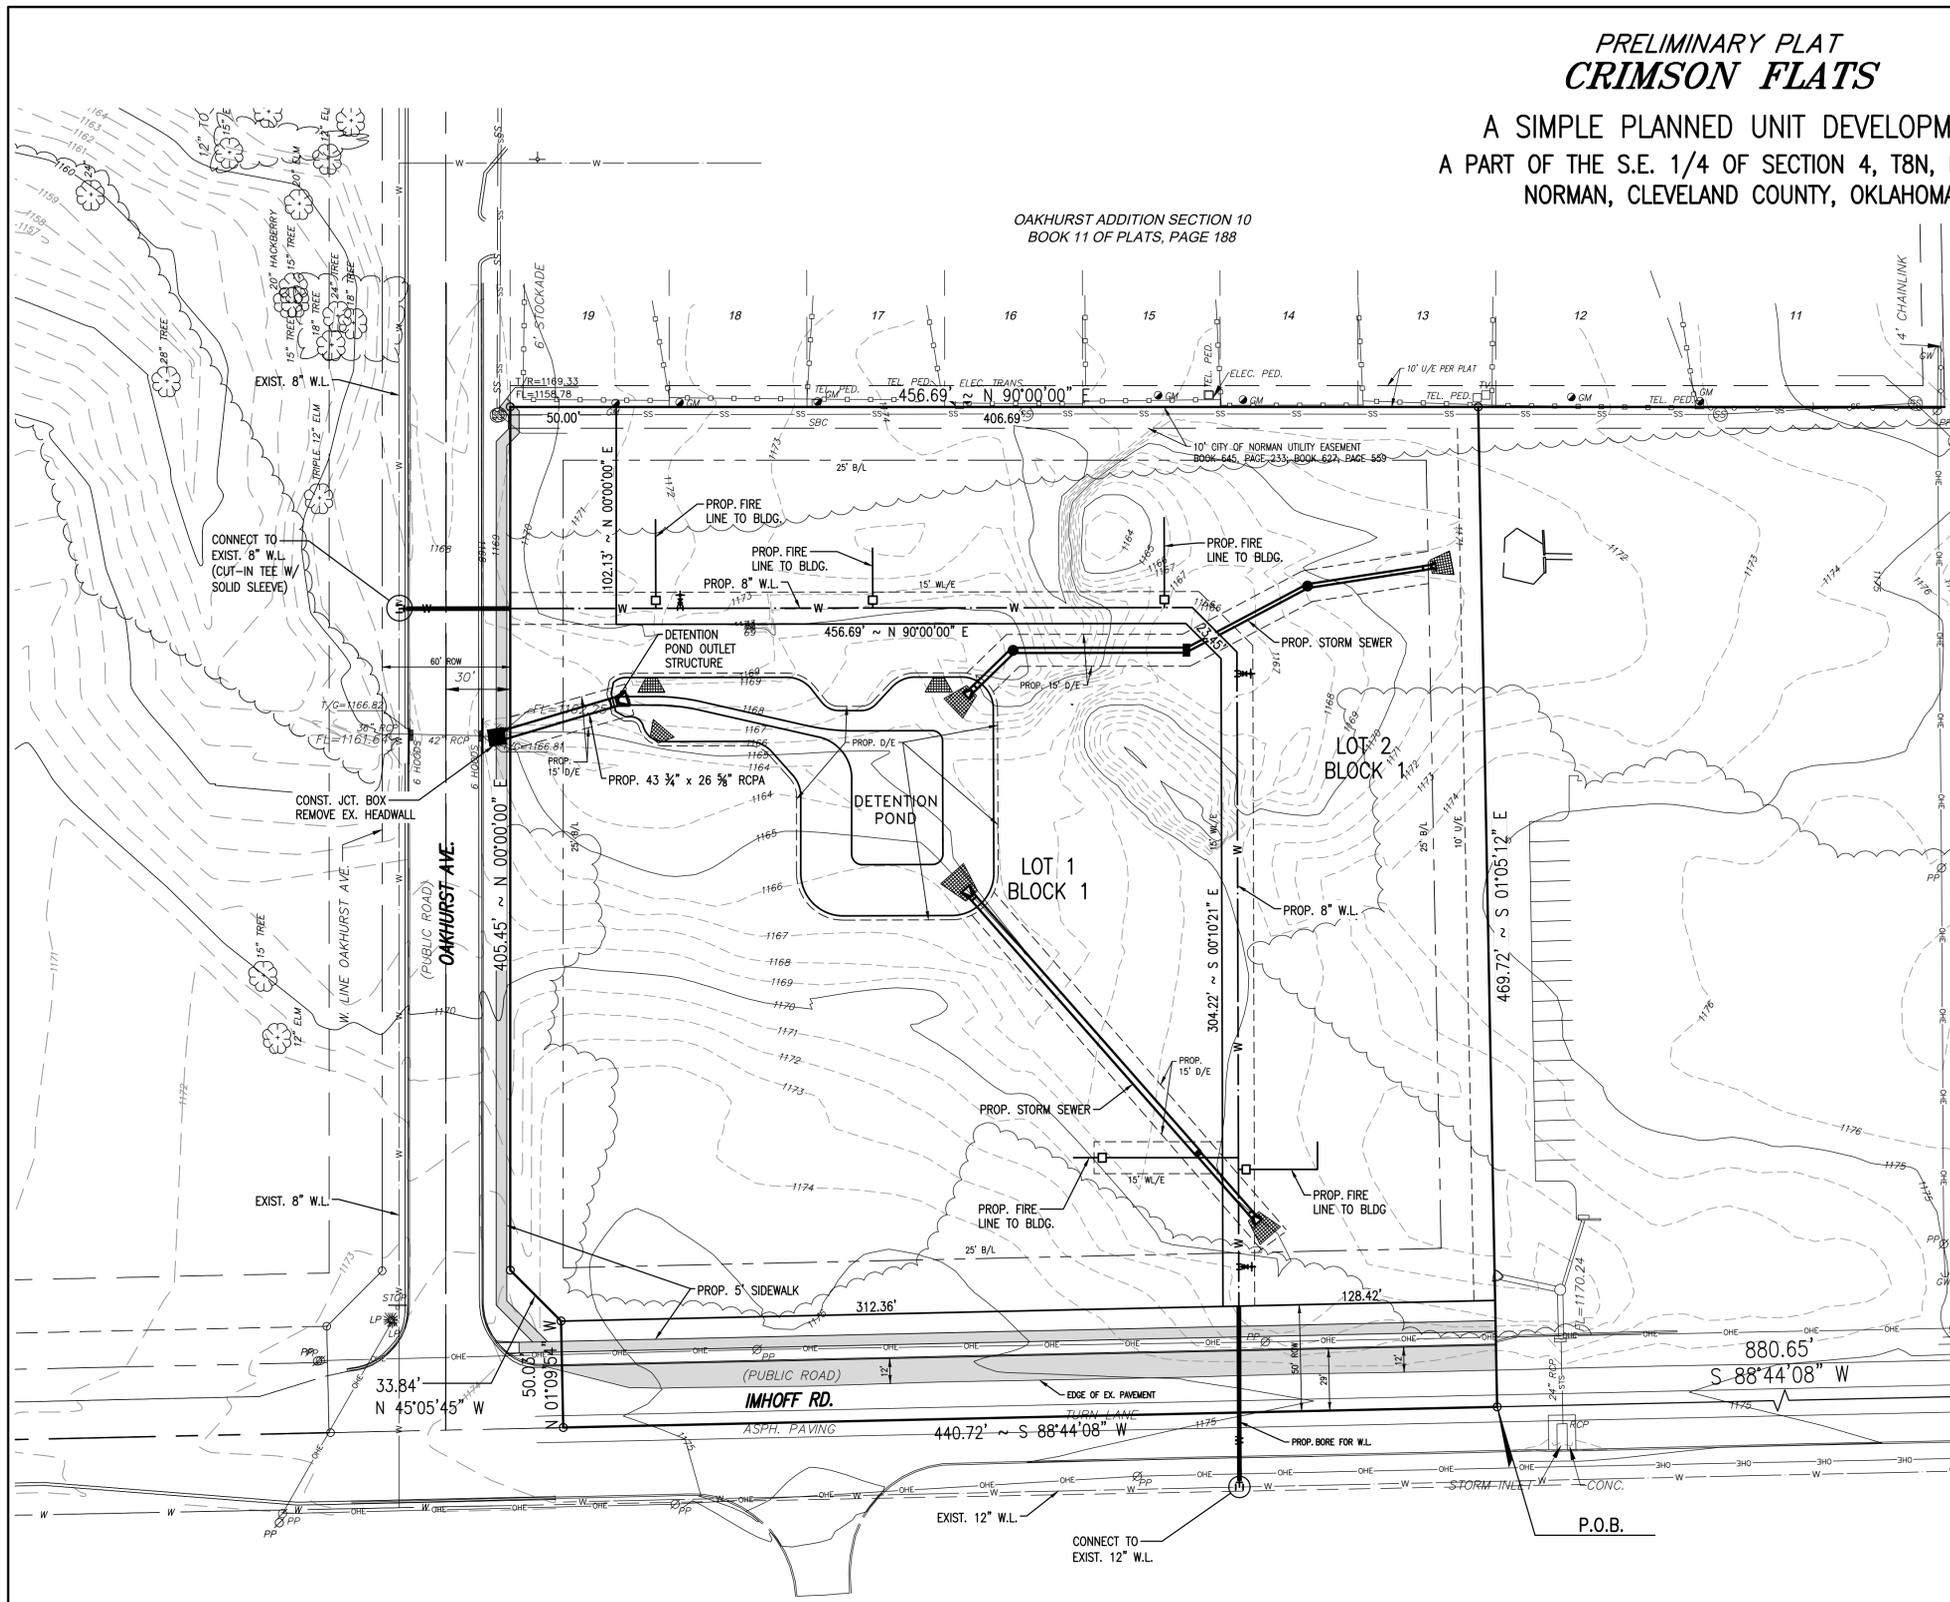

SCALE: 1" = 40'

LEGAL DESCRIPTION

A tract of land lying in the Southeast Quarter (SE/4) of Section Four (4), Township Eight (8) North, Range Two (2) West of the Indian Meridian, Cleveland County, Oklahoma and being more particularly described as follows:

COMMENCING at the Southeast corner of said SE/4; THENCE South 88°44'08" West along the South line of said SE/4 a distance of 880.65 feet to the POINT OF BEGINNING;

THENCE continuing South 88°44'08" West along said South line a distance of 440.72 feet; THENCE North 01°09'54" West a distance of 50.03 feet; THENCE North 45°05'45" West a distance of 33.84 feet to a point on the East right-of-way line of Oakhurst Drive; THENCE North 00°00'00" East along said East right-of-way line a distance of 405.45 feet; THENCE North 90°00'00" East a distance of 456.69 feet; THENCE South 01°05'12" East a distance of 469.72 feet to the POINT OF BEGINNING.

Said tract of land contains an area of 217,421 square feet or 4.99 acres, more or less.

© SMC CONSULTING ENGINEERS, P.C. ALL RIGHTS RESERVED THESE DOCUMENTS MAY NOT BE USED FOR ANY PURPOSES WITHOUT PRIOR WRITTEN PERMISSION FROM SMC CONSULTING ENGINEERS, P.C.



CRIMSON FLATS
IMHOFF RD. & 24th AVE. SE
NORMAN, OKLAHOMA

PROJECT NO.:	6555.00
DATE:	8/30/23
SCALE:	1" = 40'
DRAWN BY:	D.G.
ENGINEER:	Christopher D. Anderson
P.E. NUMBER:	18288
NO.	
REVISION	
1	Revised per Staff comments
DATE	09/20/23

PRELIMINARY PLAT

SHEET NO.
1

STORM DRAINAGE DETENTION FACILITY EASEMENT

DRAINAGE DETENTION FACILITY EASEMENTS ARE HEREBY ESTABLISHED AS SHOWN TO PROVIDE FOR DETENTION OF STORM SURFACE WATER AND CONSTRUCTED AS APPROVED BY THE CITY ENGINEER. ALL MAINTENANCE WITHIN THE DRAINAGE DETENTION FACILITY EASEMENT SHALL BE THE RIGHT, DUTY AND RESPONSIBILITY OF THE PROPERTY OWNERS ASSOCIATION IN THE PLAT OF CRIMSON FLATS; HOWEVER, IF MAINTENANCE IS NEGLECTED OR SUBJECT TO OTHER UNUSUAL CIRCUMSTANCES AND IS DETERMINED TO BE A HAZARD OR THREAT TO PUBLIC SAFETY BY THE CITY, CORRECTIVE MAINTENANCE MAY BE PERFORMED BY THE GOVERNING JURISDICTION WITH COSTS ASSESSED TO AND BORN UPON SAID PROPERTY OWNERS ASSOCIATION. OFFICIALS REPRESENTING THE PUBLIC WORKS DEPARTMENT, SHALL HAVE THE RIGHT TO ENTER UPON THE EASEMENT FOR PURPOSES OF PERIODIC INSPECTION AND/OR CORRECTIVE MAINTENANCE OF THE FACILITY. UPON RECEIVING WRITTEN APPROVAL FROM THE PUBLIC WORKS DEPARTMENT, PROPERTY OWNERS ASSOCIATION MAY CONSTRUCT IMPROVEMENTS WITHIN THE EASEMENT, PROVIDED THE IMPROVEMENT DOES NOT INTERFERE WITH THE FUNCTION OF THE DETENTION FACILITY.

NOTES:

- FIRE HYDRANTS WILL BE LOCATED AND INSTALLED IN ACCORDANCE WITH THE FINAL PLANS AND THE CITY OF NORMAN STANDARDS AND SPECIFICATIONS. FIRE HYDRANTS WILL BE LOCATED WITHIN 3 TO 6 FEET OF CURB.
- ALL SIDEWALKS WILL BE CONSTRUCTED IN ACCORDANCE WITH THE FINAL PLANS AND THE CITY OF NORMAN STANDARDS AND SPECIFICATIONS.
- ALL WATER LINES TO BE 8" DIA. UNLESS NOTED OTHERWISE.
- EXISTING ZONING IS CO.
- STORMWATER DETENTION FOR THIS PROJECT MAY BE COORDINATED WITH AND CONSTRUCTED WITH THE CRIMSON CREEK PROJECT ON THE WEST SIDE OF OAKHURST ROAD.
- BUILDINGS WILL BE REQUIRED TO BE PROTECTED WITH AN AUTOMATIC SPRINKLER SYSTEM. THE FIRE VAULT WILL BE SHOWN ON FINAL PLAT SITE PLAN AND CONSTRUCTION PLANS.
- THE FIRE DEPARTMENT CONNECTION (FDC) SHALL BE LOCATED ON THE STREET SIDE OF ANY STRUCTURE. THE FDC SHALL BE LOCATED AND ARRANGED SO THAT THE HOSE LINES CAN BE READILY ATTACHED TO THE INLETS WITHOUT INTERFERENCE FROM OBJECTS. WHERE MOUNTED ON THE STRUCTURE'S FACADE, A DISTANCE NO GREATER THAN 100' SHALL BE BETWEEN THE FDC AND A FIRE HYDRANT. WHERE THEY ARE REMOTE FROM THE STRUCTURE SERVED, A DISTANCE NO GREATER THAN 50'. THIS WILL BE DESIGNED AT THE FINAL PLAT STAGE.
- ACCESS FOR EMERGENCY VEHICLES WILL BE CONSTRUCTED ON OAKHURST AVENUE PER FIRE MARSHALL'S REQUEST. DRIVE SHALL BE CONSTRUCTED WITH GRASS PAVERS AND IS SHOWN ON THE PRELIMINARY SITE DEVELOPMENT PLAN.