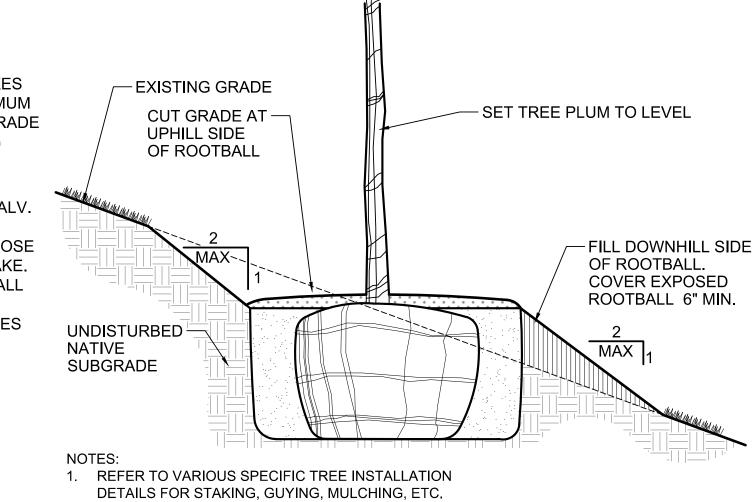


DCS-PL-01

- DO NOT CUT LEADER-PRUNE - ONLY TRIM DAMAGED OR DEAD WOOD - SPECIFIED TRUNK ATTACHMENT - DOUBLE STRAND GALVANIZED WIRE PROVIDE 3 GUY SYSTEMS EQUALLY SPACED AROUND TREE, AS PER DIAGRAM PLACE 3/4 "Ø WHITE PVC, 36" LENGTH, ON ALL GUYING — PLANT TREE W/ TOP OF ROOT BALL 3" ABOVE FINAL GRADE - 4" DEPTH MULCH RING UNLESS IN TURF AREAS  $\,\,$  PULL BACK MULCH -(SEE BELOW) AFTER TREE IS SET IN PLANTING PIT, REMOVE ALL TWINE & WIRE FROM TOP & SIDES OF ROOT BALL PULL BURLAP BACK 1/3 (MIN.) - SPECIFIED STAKES DRIVEN AT AN ANGLE, FLUSH WITH GRADE 2"-3" - 4" HEIGHT WATER SAUCER IN NON-TURF AREAS BACK FILL MIXTURE AS PER 2x DIAMETER OF SPECIFICATIONS ROOT BALL, MIN. -UNDISTURBED SUBGRADE SET ROOT BALL ON EXISTING UNDISTURBED SUBGRADE-DO NOT OVER-EXCAVATE **EVERGREEN TREE PLANTING** 

1. STAKE TO FIRST BRANCHES AS NECESSARY FOR SUPPORT. 2. WIRE SHALL NOT TOUCH — 2"x2" HARDWOOD STAKES DRIVEN FIRMLY A MINIMUM OR RUB ADJACENT TRUNKS > OR BRANCHES. **/OF 18" INTO THE SUBGRADE** PRIOR TO BACKFILLING FROM STEM 2"-3" - 2 STRAND 12 GAUGE GALV. WIRE TWISTED AND **ENCASED IN RUBBER HOSE** 4" MULCH — 6"-9" FROM TOP OF STAKE. FORM SAUCER WITH-2 WIRE SUPPORTS SHALL 3" CONTINUOUS RIM BE USED ON MAIN STRUCTURAL BRANCHES SPECIFIED -PLANTING MIX. WATER & TAMP TO REMOVE AIR 2 x BALL DIA POCKETS



2. THIS INSTALLATION SHALL APPLY TO ALL TREE TYPES

TREE PLANTING ON SLOPE

AND SIZES PLANTED ON SLOPES LESS THAN 2:1.

TREE LOCATION PER

LANDSCAPE PLANS

-ROOT BARRIER, SEE

Land+Shelter


ARCHITECTURE AND PLANNING

(ma) design

SOPRIS ENGINEERING LLC

## **NOTES**

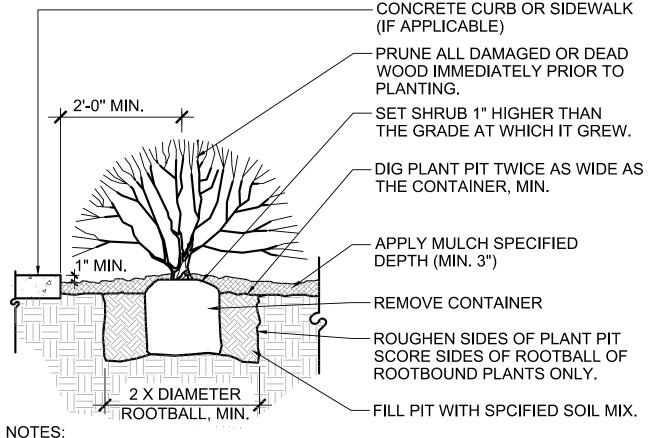- 1. LANDSCAPING WITHIN THE PUBLIC RIGHT-OF-WAY AND ALL REVEGETATION SHALL CONFORM TO THE TOWN OF NEW CASTLE PUBLIC WORKS MANUAL, SPECIFICALLY SECTIONS 2710 - FINISH GRADING AND RESTORATION, 2720 - SEEDING, SODDING AND TOPSOIL, 2730 REVEGETATION-SEEDING, SODDING, HYDROSEEDING, AND 2740 - TREES, PLANTS AND GROUND COVER, SEE EXCEPTION, BELOW.
- 2. ALL SEED MIXES AND APPLICATION RATES WITHIN THE PUBLIC WORKS MANUAL ARE HEREBY REPLACED WITH THOSE LISTED ON THESE LANDSCAPE PLANS.



- 1. ANY BROKEN OR CRUMBLING ROOTBALLS WILL BE REJECTED.
- 2. REMOVING THE CONTAINERS WILL NOT BE AN EXCUSE FOR DAMAGED
- 3. HOLD GRADE 1" BELOW EDGE OF WALK OR CURB

SHRUB PLANTING

 — APPLY SPECIFIED MULCH 1½" - 3" DEEP. SEE
 SPECIFICATIONS. MULCH DEPTH AROUND PLANT BASE MAY BE THINNER. DO NOT BURY PLANTS WITH MULCH. PLANT SPACING AS SPECIFIED -PLANTING PIT PER SPECIFICATIONS AMENDED BACKFILL PER SPECIFICATIONS

MULTI-TRUNK TREE STAKING

DCS-PL-02

DCS-PL-05

1. REMOVE PLANT FROM CONTAINER PRIOR TO INSTALLATION. 2. SEE ALSO TRIANGULAR SPACING DETAIL FOR MASSING PLANTING AS REQUIRED.

GROUNDCOVER AND PERENNIAL PLANTING

NOTES THIS DETAIL CONCRETE SIDEWALK / CURB / EDGER PER PLANS TREE BACKFILL

1. ALL TREES WITHIN 10'-0" OF PROPOSED HARDSCAPE AND WHERE INDICATED

ON PLANS SHALL RECEIVE ROOT BARRIER 2. ROOT BARRIER TO BE 18" UNIVERSAL GUIDE, MODEL UB 18-2 BY DEEP ROOT PARTNERS, PH: 800-458-7668, BISHOP COMPANY, WHITTIER, CALIFORNIA, 1-800-421-4833; OR APPROVED EQUAL

3. INSTALL AND STAKE ROOT BARRIER PER MANUFACTURER'S DIRECTIONS AND RECOMMENDATIONS.

4. INSTALL ROOT BARRIER 10'-0" MINIMUM IN EACH DIRECTION FROM CENTER OF TREE TRUNK (20'-0" TOTAL LENGTH MIN.) ALONG EDGE OF HARDSCAPE. 5. TOP OF ROOT BARRIER SHALL BE 1" BELOW TOP OF ADJACENT HARDSCAPE

FINISH SURFACE, TYPICAL 6. SEE ALSO TREE PLANTING DETAILS.

NOT TO SCALE

ROOT BARRIER INSTALLATION

DCS-PL-11

HOR

WILD

9 NORTH New Castle, C

PROJECT NUMBER:

**DESIGNED:** 

DRAWN:

**CHECKED:** 

Project #23100 09/09/2024

Revision 12/20/2024

JOB DESCRIPTION:

SHEET TITLE:

LANDSCAPE

DCS-PL-03

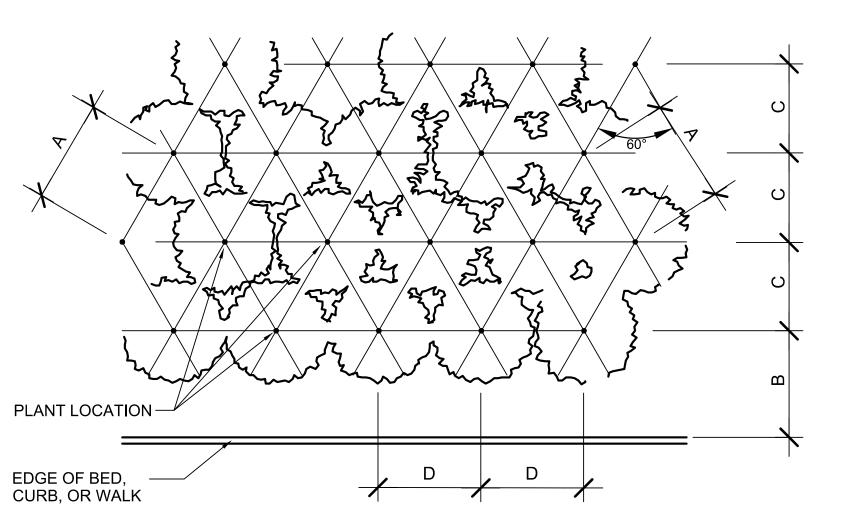
-WRAP ENTIRE SURFACE OF TRUNK UP TO SECOND BRANCH WITH TWO LAYER CREPE TREE WRAP SECURED AT TOP AND

**BOTTOM & TWO FOOT INTERVALS** 



DCS-PL-06

- 1. CONTRACTOR WILL PRESERVE & PROTECT EXISTING TREES ON SITE, DURING DEMOLITION AND CONSTRUCTION OPERATIONS AS NECESSARY, INCLUDING CANOPIES, TRUNKS, AND ROOT SYSTEMS.
- 2. TREES THAT ARE IN PERIL OF DAMAGE, OR TREES WITHIN 10' OF DEMOLITION OF CONSTRUCTION ACTIVITIES, OR TREES IDENTIFIED SPECIFICALLY BY OWNER, SHALL RECEIVE TREE PROTECTION.
- 3. CONTRACTOR SHALL CONTACT OWNER IF FIELD CONDITIONS ARE SIGNIFICANTLY DIFFERENT THAT WHAT IS SHOWN ON THE PLANS.
- 4. IT IS ACKNOWLEDGED THAT CONSTRUCTION AND DEMOLITION ACTIVITIES WILL OCCUR CLOSE TO TRUNKS AND OVER CRITICAL ROOT ZONES. HOWEVER, THE CONTRACTOR WILL AVOID ALL UNNECESSARY DAMAGE TO TREES.
- 5. IN AREAS WHERE FENCING WILL INTERFERE WITH TRAIL CONSTRUCTION, OR WHERE FENCING CANNOT BE INSTALLED, WRAP TRUNK WITH BURLAP AS PER DETAIL. CONSULT WITH OWNER PRIOR TO APPLYING PROTECTIVE WRAP TO VERIFY CONDITIONS.
- ALL DISTURBED ROOTS SHALL BE TRIMMED TO BE CLEAN CUTS. DO NOT LEAVE BARE ROOTS EXPOSED. COVER WITH A BREATHABLE TEMPORARY COVER SUCH AS GEOTECH FABRIC AND A 1" LAYER OF SOIL IF ROOTS ARE TO BE UNCOVERED FOR MORE THAN ONE DAY. WATER AS NECESSARY TO KEEP ROOTS ALIVE.
- TREES TO BE REMOVED WITHIN EXISTING GROUPS OF TREES IDENTIFIED AS TO REMAIN ARE TO BE REMOVED BY HAND EQUIPMENT ONLY. FOOT TRAFFIC ONLY ALLOWED IN ROOT PROTECTION ZONE, AND ONLY DURING THE TREE REMOVAL PHASE. FELL TREES DIRECTLY TO AVOID DAMAGE TO EXISTING TREES TO REMAIN. IRRIGATION OF EXISTING TREES IS REQUIRED THROUGHOUT THE ENTIRE LENGTH



PLANT SPACING	Α	В	С	D	
6"	6"	6"	5"	6"	
8"	8"	6"	7"	8"	
12"	12"	8"	10"	12"	
18"	18"	9"	15 <del>1</del> "	18"	
24"	24"	18"	21"	24"	
30"	30"	15"	26"	30"	
36"	36"	30"	31"	36"	
48"	48"	30"	42"	48"	
60"	60"	36"	52"	60"	
	•	-	-		

NOTE: ALIGN FRONT ROW PARALLEL TO BED LINE

-PROTECTION FENCING TO BE PROVIDED AND MAINTAINED AT TREE INVOLVED WITHIN 10' OR DRIP LINE. MATERIAL TO BE 6' HIGH WELDED WIRE FABRIC (WWF) LESS FOR INDIVIDUAL TREES, OR PLASTIC FOR LARGE GROUPS OF TREES. EXTENT OF TREE DRIPLINE TREE PROTECTION DETAIL NOT TO SCALE

DCS-PL-08

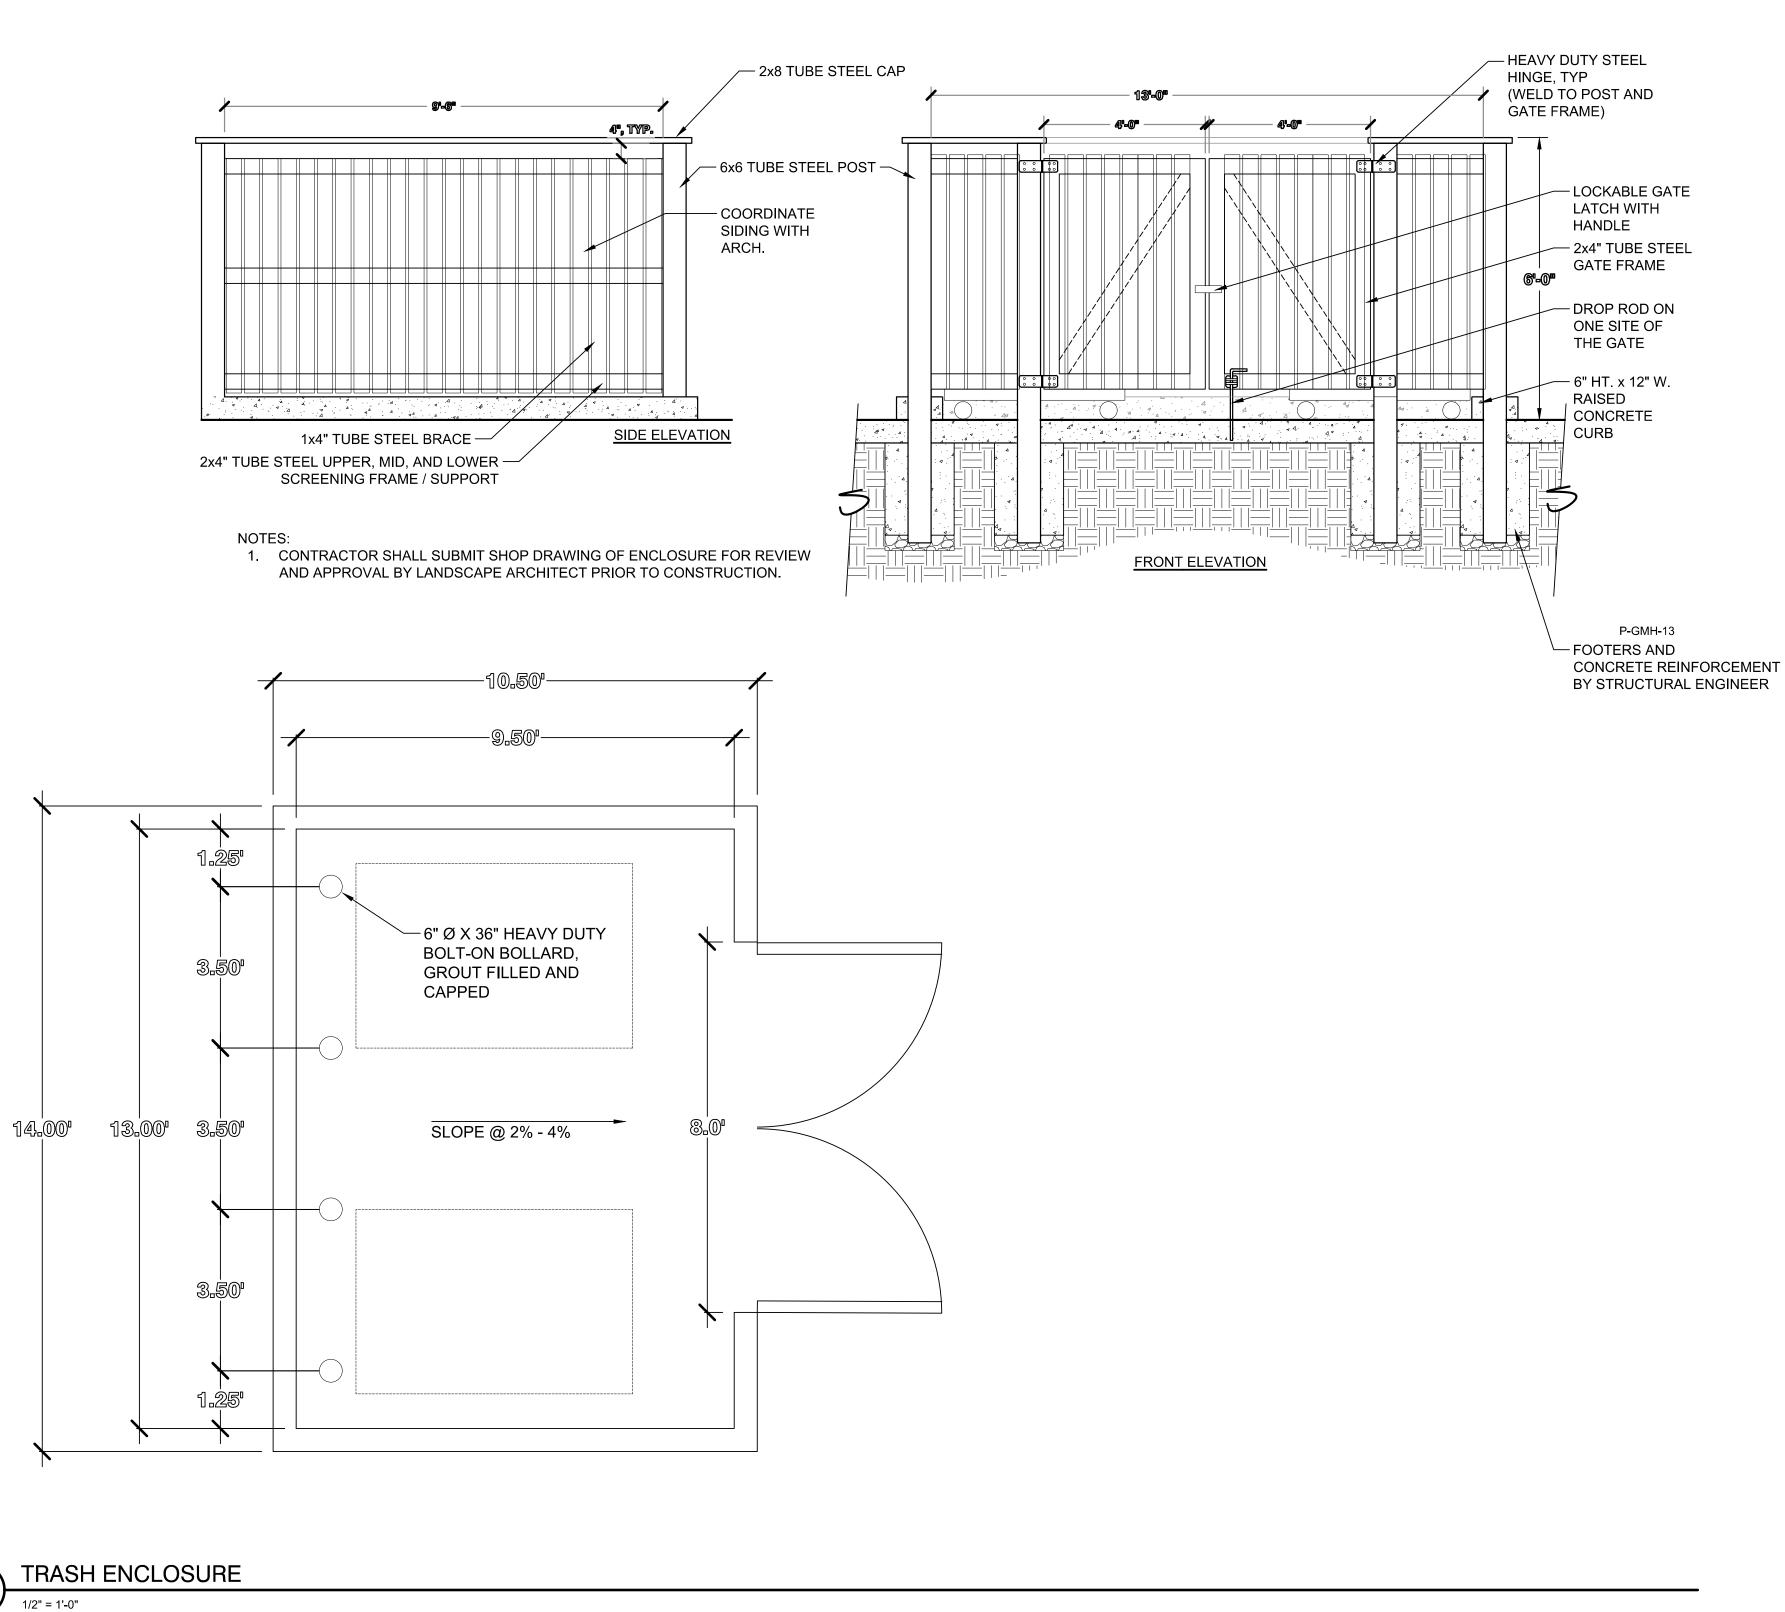
BRANCH PROTECTION REQUIRED IF WHEELED

CONSTRUCTION EQUIPMENT

TRIANGULAR SPACING LAYOUT FOR SHRUBS / GROUNDCOVER / FLOWERS NOT TO SCALE

OF THE PROJECT.

DETAILS SHEET NUMBER: L-2.0 88





Land+Shelter







9 NORTH WILD HORSE
New Castle, Colorado

PROJECT NUMBER: DATE
Project #23100 09/09/2024 DESIGNED: DRAWN: CHECKED:

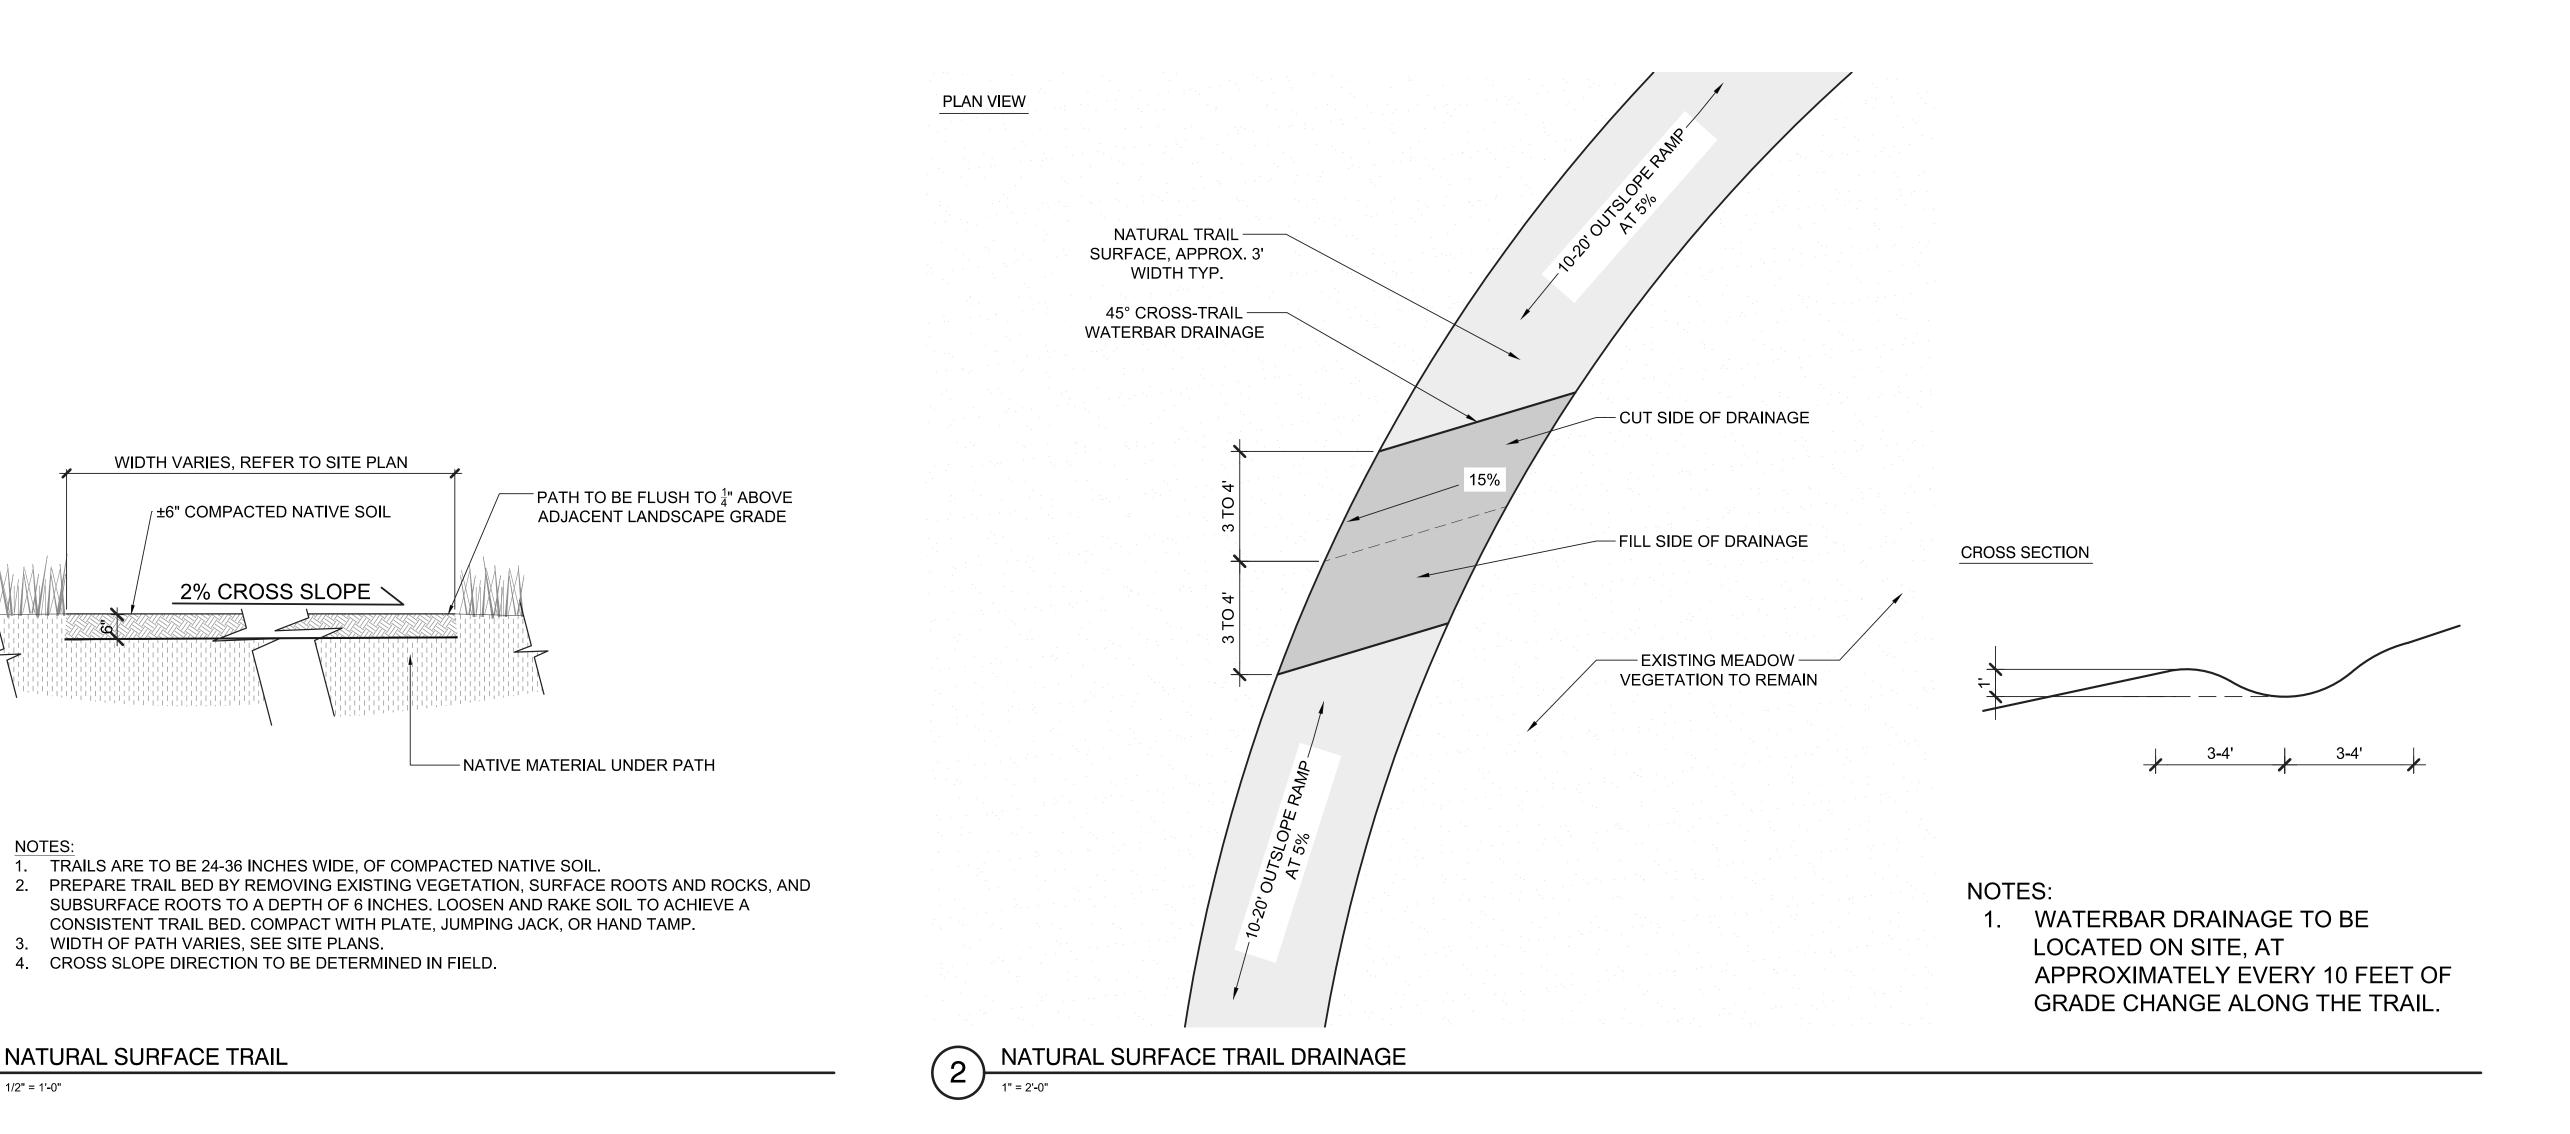
REVISIONS: Revision 12/20/2024

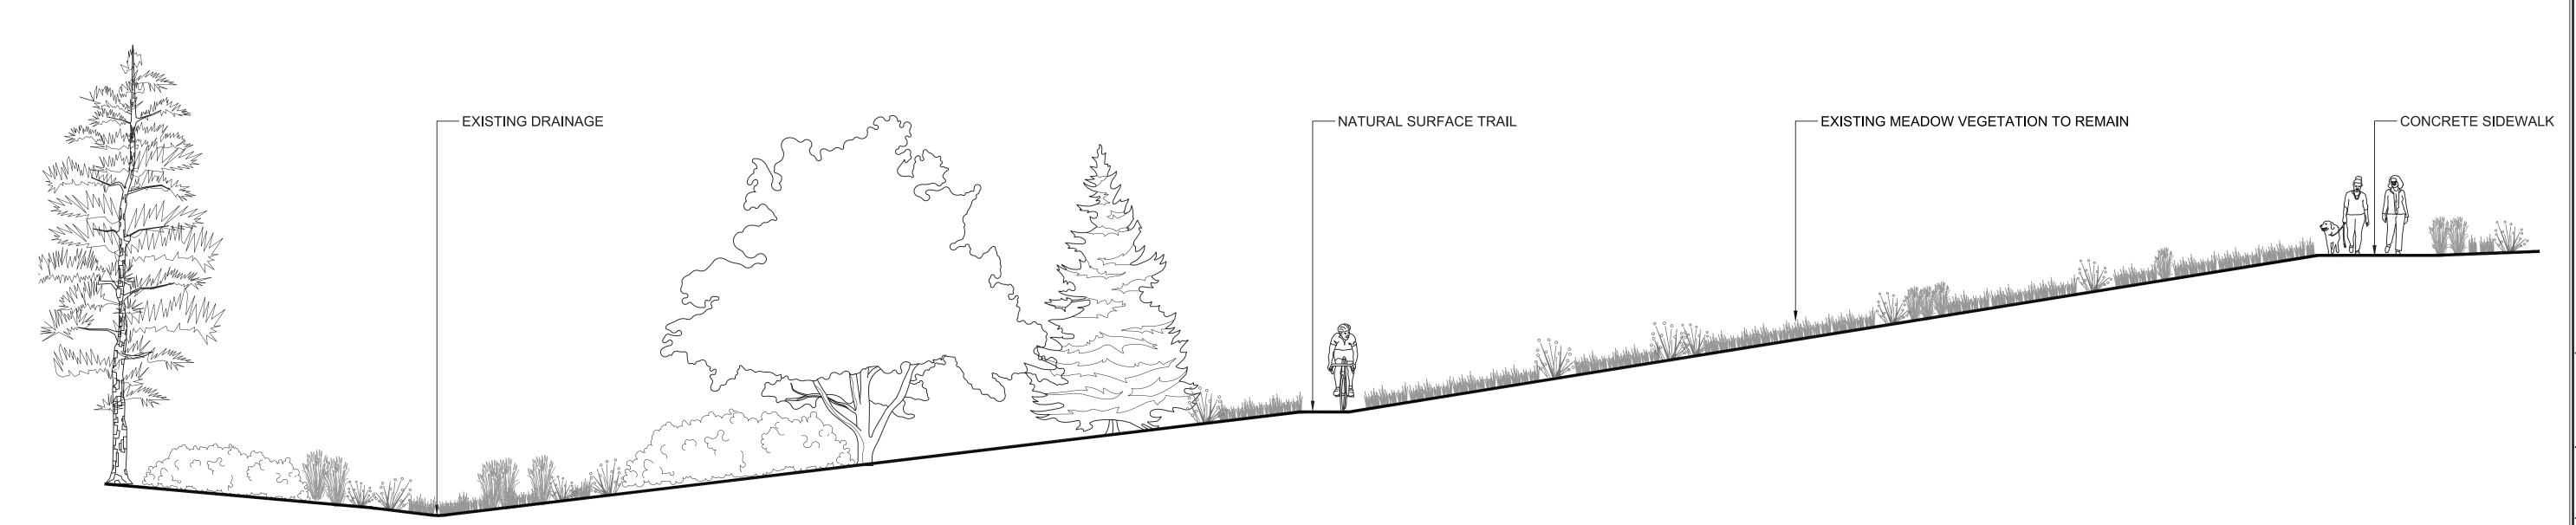
JOB DESCRIPTION:

SHEET TITLE: TRASH ENCLOSURE

SHEET NUMBER:

L-2.1





NATURAL SURFACE TRAIL SECTION

WIDTH VARIES, REFER TO SITE PLAN

/ ±6" COMPACTED NATIVE SOIL

2% CROSS SLOPE \

1. TRAILS ARE TO BE 24-36 INCHES WIDE, OF COMPACTED NATIVE SOIL.

3. WIDTH OF PATH VARIES, SEE SITE PLANS.

NATURAL SURFACE TRAIL

1/2" = 1'-0"

4. CROSS SLOPE DIRECTION TO BE DETERMINED IN FIELD.

SOPRIS ENGINEERING LLC 9 NORTH WILD HORSE
New Castle, Colorado PROJECT NUMBER: DATE
Project #23100 09/09/2024 DESIGNED: DRAWN: CHECKED: REVISIONS: Revision 12/20/2024 JOB DESCRIPTION: SHEET TITLE:
TRAIL DETAILS SHEET NUMBER: L-2.2

DHW DESIGN


Land+Shelter


GENERAL NOTES		LIGHTING		SWITCHING & CONTROLS			
1. THE CONTRACTOR SHALL PROVIDE ALL LABOR AND MATERIAL NECESSARY FOR A COMPLETE AND		MINIMUM OF EIGHT HOURS. SUCH PAYMENT DOES NOT GUARANTEE 30 DAYS, A MINIMUM OF EIGHT HOURS OF PROFESSIONAL TIME TO CONSIDER	SYMBOL	DESCRIPTION	SYMBOL	DESCRIPTION	
FUNCTIONING LIGHTING SYSTEM.  2. THE GENERAL CONTRACTOR, ELECTRICAL CONTRACTOR(S), AND LOW VOLTAGE CONTRACTOR(S) SHALL REFER TO THE LIGHTING PLANS, SCHEDULES, AND DETAILS HEREIN, INCLUDING ANY ATTACHED LIGHTING SPECIFICATIONS AND PRODUCT CUTSHEETS FOR ADDITIONAL INFORMATION.	ANY SUCH REQUEST SHALL BE PAID FOR BY THE CONTRACTOR. SUBMITTAL OF ANY SUBSTITUTION REQUEST OR VALUE ENGINEERING RECOMMENDATION SHALL NOT BE CONSTRUED AS APPROVAL IN ANY WAY. THE OWNER, ARCHITECT AND LIGHTING DESIGNER RESERVE THE RIGHT TO REJECT ANY SUBSTITUTION OR VALUE ENGINEERING RECOMMENDATION WITHOUT EXPLANATION.			RECESSED LENSED TROFFER (SIZE/SHAPE VARIES)	S <sub>a</sub>	SINGLE POLE SWITCH (SUPERSCRIPT DENOTES SIMILARLY MARKED LUMINAIRES CONTROLLED TOGETHER. NO SUBSCRIPT INDICATES SWITCH	
3. THE CONTRACTOR SHALL LAY OUT ALL LIGHT FIXTURE LOCATIONS AND TRANSFORMER LOCATIONS PRIOR TO INSTALLATION FOR APPROVAL BY ALPENGLOW LIGHTING DESIGN, INC., ARCHITECT, INTERIOR DESIGNER, ENGINEER(S), AND OWNER.	31. CONTRACTOR MAY BE REQUIRED TO PROVIDE TABLE TOP SAMPLES AND/OR A FAIR MOCKUP O SPECIFIED FIXTURE AND PROPOSED ALTERNATE. THIS REQUIREMENT SHALL BE EXERCISED AT TOPTION OF OWNER, ARCHITECT, OR LIGHTING DESIGNER. CONTRACTOR SHALL BE SOLELY			RECESSED PARABOLIC TROFFER (SIZE/SHAPE VARIES)	s²	TO CONTROL ALL LIGHTING WITHIN ROOM, U.O.N.). TWO POLE SWITCH	
4. MATERIALS AND INSTALLATION SHALL COMPLY WITH CODES, LAWS, AND ORDINANCES OF	RESPONSIBLE FOR	ALL COSTS INCURRED BY SUBSTITUTION REQUEST SAMPLE AND/OR MOCKUP REVIEW INCLUDING PROFESSIONAL TIME AND TRAVEL EXPENSES.		SURFACE LENSED LUMINAIRE (SIZE/SHAPE VARIES)	s <sup>3</sup>	THREE WAY SWITCH	
FEDERAL, STATE AND LOCAL GOVERNING BODIES HAVING JURISDICTION.  5. MATERIALS AND EQUIPMENT SHALL BE LISTED AND/OR LABELED BY UL., ETL, GSA OR ANOTHER		VALUE ENGINEERING RECOMMENDATIONS SHALL ACCOMMODATE THE IMPACT ED SYSTEMS OR PRODUCTS, SUCH AS BALLASTS, DRIVERS, AND DIMMING		SURFACE PARABOLIC TROFFER (SIZE/SHAPE	$s^4$	FOUR WAY SWITCH	
RECOGNIZED TESTING LAB.	SYSTEMS. THE LIG RESPONSIBILITY FO	HTING SYSTEMS ARE DESIGNED AS COMPLETE AND IT IS THE CONTRACTOR'S R ANY IMPACTS OF ANY CHANGE RECOMMENDED. CONTRACTOR SHALL WHICH RESULT IN A FULLY FUNCTIONING LIGHTING SYSTEM WHICH OPERATES	[ <del>]]]]</del>	VARIES)	s <sup>K</sup>	KEY OPERATED SWITCH	
6. THE CONTRACTOR SHALL SECURE AND PAY FOR ALL PERMITS, GOVERNMENTAL FEES, TAXES AND LICENSES NECESSARY FOR THE PROPER EXECUTION AND COMPLETION OF THE ELECTRICAL WORK.  7. THE CONTRACTOR SHALL PREPARE AND SUBMIT TO GOVERNMENTAL AGENCIES AND UTILITY COMPANIES ANY SHOP DRAWINGS AS REQUIRED BY THESE AGENCIES FOR THEIR APPROVAL.	AS ORIGINALLY DESIGNED.  33. SUBSTITUTION REQUESTS AND VALUE ENGINEERING RECOMMENDATIONS SHALL BE DESCRIBED ON CSI STANDARD FORMS AND SHALL INCLUDE PRODUCT CUTSHEET. PRODUCTS SUBMITTED			SHADING OF ANY LUMINAIRE INDICATES CONNECTION TO ALTERNATE POWER SOURCE (EMERGENCY, UPS, STANDBY, ETC.) PER CIRCUITING INDICATED	D	DIMMER SWITCH. NUMBER INDICATES WATTAGE RATING. IF NOT SHOWN THEN EQUAL TO LOAD.	
8. THE CONTRACTOR SHALL NOTIFY THE ARCHITECT, OWNER, AND LIGHTING DESIGNER OF ANY MATERIALS OR APPARATUS BELIEVED TO BE INADEQUATE, UNSUITABLE, IN VIOLATION OF LAWS,	WITHOUT PROPER CSI FORMS SHALL NOT BE APPROVED.  34. WHEN REQUESTING A SUBSTITUTION, CONTRACTOR SHALL PROVIDE UNIT AND EXTENDED PRICING		• •	SUSPENDED LINEAR PENDANT (SIZE/SHAPE VARIES)	S <sub>JAMB</sub>	JAMB SWITCH	
ORDINANCES, RULES OR REGULATIONS OF AUTHORITIES HAVING JURISDICTION.  9. THE CONTRACTOR SHALL CAREFULLY EXAMINE THE CONTRACT DOCUMENTS, VISIT THE SITE, AND	FOR SPECIFIED LIGHT FIXTURE, UNIT AND EXTENDED PRICING FOR PROPOSED ALTERNATE, AND UNIT AND EXTENDED DELTA SAVINGS TO OWNER TO BE REALIZED BY USING PROPOSED ALTERNATE. CONTRACTOR SHALL PROVIDE UNIT PRICING FOR EACH FIXTURE TYPE SPECIFIED TO PROVIDE BASELINE COMPARISON FOR SUBSTITUTION REQUEST. CONTRACTOR SHALL GUARANTEE		•	NON LINEAR PENDANT (SIZE, SHAPE VARIES)	S <sup>TS</sup>	TIMER SWITCH	
THOROUGHLY BECOME FAMILIAR WITH THE BUILDING AND STANDARDS AND LOCAL CONDITIONS RELATING TO THE WORK. FAILURE TO DO SO WILL NOT RELIEVE THE CONTRACTOR OF THE OBLIGATIONS OF THE CONTRACT.	THIS PRICE GUARA CONSTRUCTION RE	XTURE TYPES FOR WHICH A SUBSTITUTION REQUEST HAS BEEN GRANTED.  NTEE SHALL BE PER UNIT AND SHALL BE MAINTAINED THROUGH THE END OF  BARDLESS OF QUANTITY PURCHASED. LIGHTING FIXTURE SUBSTITUTION		DOWNLIGHT OR POINT SOURCE -	S <sup>XP</sup>	EXPLOSION PROOF SWITCH	
10. ALL MATERIALS, AND EQUIPMENT SHALL BE ERECTED, INSTALLED, CONNECTED, CLEANED, ADJUSTED, TESTED, CONDITIONED, AND PLACED IN SERVICE IN ACCORDANCE WITH THE	REQUESTS FOR PRODUCTS USED AS EGRESS OR EMERGENCY LIGHTING SYSTEMS OR EXTERIOR SITE AND ROADWAY LIGHTING SHALL INCLUDE LIGHTING CALCULATION DATA DEMONSTRATING			SURFACE, RECESSED CEILING MTD.	SWP	WEATHERPROOF SWITCH	
MANUFACTURER'S DIRECTIONS AND RECOMMENDATIONS.  11. ALL CUTTING, DRILLING, AND PATCHING OF MASONRY, STEEL OR IRON WORK BELONGING TO THE	COMPLIANCE WITH RELEVANT CODES AND ORDINANCES. PROVIDE HARDCOPY CALCULATIONS AND DATAFILE IN DIALUX (.evo) FORMAT. SUBSTITUTION REQUESTS WITHOUT SUCH DATA WILL BE REJECTED WITHOUT CONSIDERATION. VE REVIEW TIME SHALL BE PAID FOR BY THE CONTRACTOR.			DIRECTIONAL OR WALLWASH - SURFACE, RECESSED CEILING MTD.  RECESSED BATH FAN OR FAN/LIGHT	SFAN	LINE VOLTAGE, VARIABLE SPEED FAN CONTROL LOCATE ADJACENT TO ADJACENT TO LIGHT SWITCHES	
BUILDING MUST BE DONE BY THIS CONTRACTOR IN ORDER THAT HIS WORK MAY BE PROPERLY INSTALLED, BUT UNDER NO CONDITIONS MAY STRUCTURAL WORK BE CUT, EXCEPT AT THE DIRECTION OF THE ARCHITECT, ENGINEER, OR THEIR REPRESENTATIVE.	FIXTURE SUBSTITUTEXCESS OF 14 WE	RY LEAD-TIME SHALL NOT BE HELD AS A VALID REASON FOR REQUESTING ION UNLESS FIXTURE LEAD-TIME FROM SPECIFIED MANUFACTURER IS IN EKS. IT SHALL BE THE SOLE RESPONSIBILITY OF THE CONTRACTOR TO			S	MULTI-BUTTON LIGHTING CONTROL SWITCH	
12. ALL MATERIAL, EQUIPMENT, WIRING DEVICES, ETC. SHALL BE NEW UNLESS SPECIFICALLY INDICATED AS EXISTING TO BE REUSED.	FASHION, AND PLA	CE ORDERS ACCORDINGLY TO ENSURE TIMELY DELIVERY.	X	SURFACE OR PENDANT CEILING FAN - PROVIDE APPROPRIATE BRACED JUNCTION BOX	S <sub>#</sub>	INDIVIDUAL SWITCH CONFIGURATION VARIES.	
13. EXCEPT AS NOTED OTHERWISE, ALL WORK REQUIRED FOR THE INSTALLATION AS SHOWN ON DRAWINGS INCLUDING LABOR, EQUIPMENT, AND MATERIALS SHALL BE IN STRICT COMPLIANCE WITH THE BUILDING STANDARDS.	36. CONTRACTOR SHALL ADJUST AIMABLE LUMINARIES AS DIRECTED BY LIGHTING DESIGNER. CONTRACTOR SHALL PROVIDE MANPOWER AND EQUIPMENT, INCLUDING LADDERS, LIFTS, TOOLS, ETC., AND ALLOW FOR THIS ACTIVITY TO OCCUR DURING PREMIUM NIGHT AND/OR WEEKEND TIME. CONTRACTOR SHALL INCLUDE A MINIMUM OF 20 HOURS IN HIS BID FOR THIS EFFORT.			LINEAR LOW VOLTAGE COVE OR UNDERCABINET	PC	PHOTOCELL	
14. COMMERCIAL APPLICATIONS: THE CONTRACTOR MAY PROVIDE COMPLETE METAL RACEWAY  37. THE GENERAL CO SHALL ASK QUES		TRACTOR, ELECTRICAL CONTRACTOR(S), AND LOW VOLTAGE CONTRACTOR(S) ONS VIA TELEPHONE, EMAIL, OR WRITTEN CORRESPONDENCE PRIOR TO MAKING OF THINGS. CONTRACTORS WHO FAIL TO ASK QUESTIONS SHALL BE FED TO	-8-8-	TRACK OR LOW VOLTAGE LIGHTING WITH HEADS	TC	TIME CLOCK	
SYSTEM. RESIDENTIAL APPLICATIONS MAY USE NON METALLIC WIRE (ROMEX).	THE RAVENOUS BUGBLATTER BEAST OF TRAAL.		<b>—</b>	STRIPLIGHT	Hos	OCCUPANCY SENSOR - WALL MOUNTED	
15. MC CABLE MAY BE USED FOR ALL BRANCH CIRCUITING. MC CABLE SHALL NOT ENTER INTO PANELBOARDS. ELECTRICAL CONTRACTOR SHALL UTILIZE EMT OUT OF THE PANELBOARD INTO A FULL BOX, GUTTER, OR SIMILAR DEVICE, AND THEN RUN MC CABLE FOR THE REMAINDER OF BRANCH CIRCUITING RUN. MINIMUM RACEWAY SIZE SHALL BE 1/2" UNLESS OTHERWISE INDICATED. MC CABLE MAY ONLY BE USED IN CONCEALED LOCATIONS.	38. THE GENERAL CONTRACTOR SHALL CONFIRM THAT ALL BIDDERS AND SUBCONTRACTORS HAVE READ THE PRECEDING THIRTY-EIGHT NOTES BY SUBMITTING A SCAN OR PHOTOGRAPH OF THIS NOTE, SIGNED BY THE BIDDER(S). BIDDERS WHO FAIL TO SUBMIT THIS NOTE SHALL HAVE THEIR BIDS REJECTED WITHOUT CONSIDERATION.			STRIPLIGHT WITH REFLECTOR OR LENS	os	360 DEGREE OCCUPANCY SENSOR - CEILING MTD.	
16. FLEXIBLE CONDUIT CONNECTIONS TO RECESSED LIGHTING FIXTURES SHALL BE MADE WITH FLEXIBLE STEEL CONDUIT, 3/4" MINIMUM.	39. THE GENERAL CONTRACTOR SHALL PROVIDE A MINIMUM OF TWELVE (12) PERFORATED PASTRY UNITS AND COFFEE AT ALL CONSTRUCTION MEETINGS. DECAFFEINATED COFFEE SHALL BE REJECTED WITHOUT CONSIDERATION. THE CONTRACTOR SHALL PROTECT THE CONSTRUCTION DOCUMENTS FROM DIRECT CONTACT WITH THE PERFORATED PASTRY UNITS.		Q	SCONCE, "FOOT" INDICATES WALL MOUNTING. VERIFY HEIGHT WITH ARCHITECT, INTERIOR DESIGNER.	os→	180 DEGREE OCCUPANCY SENSOR - CEILING MTD.	
17. ALL NEW CIRCUITS SHALL HAVE A GROUND WIRE INSTALLED.			WALL MOUNTED LINEAR (SIZES VARY)	←os→	CORRIDOR/AISLE OCCUPANCY SENSOR - CEILING MOUNTED		
18. ALL WIRE NOT INSTALLED IN CONDUIT AND IN THE CEILING SHALL BE PLENUM RATED.		POWER DEVICES		RECESSED STEPLIGHT	hook	OCCUPANCY SENSOR & SWITCH GANGED UNDER A	
19. REMOTE POWER SUPPLIES AND TRANSFORMERS SHALL BE CONCEALED IN ATTICS, CRAWL SPACES, OR SIMILAR ACCESSIBLE LOCATIONS. MAXIMUM WIRE RUN TO THE END OF THE FIXTURE SHALL NOT EXCEED 75 FEET.	SYMBOL	DESCRIPTION		REGEOGED OTEL FIGHT	Shosh	COMMON COVER PLATE. OCCUPANY SENSOR TO CONTROL ALL LIGHT FIXTURES IN ROOM WITH	
20. IN SUSPENDED CEILINGS, SUPPORT CONDUIT AND JUNCTION BOXES DIRECTLY FROM THE STRUCTURAL SLAB, DECK, OR FRAMING PROVIDED FOR THAT PURPOSE. LIGHTING BRANCH CIRCUIT CONDUITS SHALL NOT BE CLIPPED TO THE CEILING SUPPORT WIRES OR SPLINE UNLESS.		SIMPLEX RECEPTACLE - WALL, CEILING, ON ALT.  DUPLEX RECEPTACLE - WALL, CEILING, ON ALT.		BATTERY POWER EMERGENCY UNIT EQUIPMENT (SEE LUMINARE SCHEDULE FOR QUANTITY OF HEADS) - WALL, CEILING MOUNTED.		1/2 LIGHT REDUCTION CONTROLLED BY SWITCH, DESIGNATED BY LETTER.	
THE CEILING HAS BEEN SPECIFICALLY DESIGNED FOR THAT PURPOSE.		DOUBLE DUPLEX RECEPTACLE - WALL, CLG, ON ALT.	€	ILLUMINATED EXIT SIGN. SHADED QUADRANT	100#	LIGHTING CONTROL PANEL AND ASSOCIATED COMPONENTS. PROVIDE 120V OR 277V CONTROL	
21. SHOULD ACTUAL FIELD CONDITIONS REQUIRE INDICATED CIRCUIT DESIGNATIONS TO VARY, INDICATE THE CIRCUIT NUMBER USED ON THE AS-BUILT DRAWINGS.	<b>⊕</b> АВ	RECEPTACLE TYPE SHOWN -WALL -ABOVE COUNTER BACKSPLASH, SEE ARCHITECTURAL DRAWINGS.	7	INDICATES FACES, ARROWS AS SHOWN	LCP#	POWER AS REQUIRED OR AS INDICATED.	
22. ALL FACE PLATE AND DEVICE COLORS SHALL BE APPROVED BY ARCHITECT, INTERIOR DESIGNER, AND OWNER.	"ON ALT."	SHADED RECEPTACLES NOTED "ON ALT." ABOVE ARE		FLOOR OR GRADE MOUNTED BOLLARD	T	REMOTE MOUNTED LINE TO LOW-VOLTAGE FUSED TRANSFORMER OR POWER SUPPLY. CONCEAL FROM	
23. ALL BATTERY BACKUP EMERGENCY LIGHTING AND EXIT LIGHTS SHALL BE WIRED AHEAD OF ANY LOCAL SWITCHING, UNLESS OTHERWISE NOTED.		CONNECTED TO ALTERNATE POWER SOURCE (EMERG., STANDBY, UPS, ETC.) PER CIRCUITING INDICATED	ô	FLUSH GRADE POINT SOURCE		VIEW.	
24. THE CONTRACTOR SHALL VERIFY THE CEILING TYPE BEFORE ORDERING LIGHTING FIXTURES.		DUPLEX RECEPTACLE - WALL - HALF SWITCHED		TEGGIT GRADE FOIRT SCORCE			
25. THE CONTRACTOR IS TO REFER TO ARCHITECTURAL PLANS AND SPECIFICATIONS FOR ALL FIRE—RATED PENETRATION INSTALLATION REQUIREMENTS.  26. THE CONTRACTOR IS TO NOTIFY THE ARCHITECT PRIOR TO INSTALLING ANY FIXTURES WITHIN A	⊕ \$	COMBINATION SWITCH/DUPLEX RECEPTACLE		ARROW INDICATES OF TICAL ORIENTATION		LIGHTING REFERENCES	
FIRE RATED CEILING OR WALL. FIRE RATING MUST BE MAINTAINED FOR THIS TYPE OF INSTALLATION WITH DRYWALL TENTING OR LISTED FIREBOX ASSEMBLY.	⊕GFCI	DUPLEX RECEPTACLE - WALL - WITH INTEGRAL GROUND FAULT CIRCUIT INTERRUPTER			1. IESNA HANDBOOK 9TH EDITION, 2010		
27. BIDS SHALL HAVE LINE—ITEM PRICING. BIDS WHICH SHOW LOT PRICING FOR LIGHTING FIXTURES AND/OR LIGHTING CONTROLS SHALL BE REJECTED WITHOUT CONSIDERATION. BIDDER SHALL HAVE FIVE (5) BUSINESS DAYS TO RESUBMIT LINE—ITEM PRICING. AFTER FIVE (5) BUSINESS DAYS, BID SHALL BE CONSIDERED TO BE NULL AND VOID AND WILL BE REJECTED. BIDDERS WARRANT THEIR COMPLIANCE WITH THE ROBINSON—PATMAN AND CLAYTON ACTS.	⇒WP ⇒+42"	RECEPT. TYPE SHOWN W/ WEATHERPROOF COVER RECEPT. TYPE SHOWN AT SPECIAL HEIGHT			2. NATIONAL ELECTRIC CODE VERSION 2023 3. IECC 2021 4.		
28. SUBMIT PRODUCT DATA DESCRIBING FIXTURES, LAMPS, BALLASTS, AND EMERGENCY LIGHTING		CLOCK HANGER RECEPTACLE			110	CHINC SHEET INDEX	
UNITS WITHIN 30 DAYS OF DIRECTION TO PROCEED FROM THE OWNER. ALL NOTATIONS SHALL BE .PDF FORMAT OR LASER PRINTED. ARRANGE PRODUCT DATA FOR FIXTURES IN ORDER OF FIXTURE DESIGNATION. AFTER 30 DAYS, A MINIMUM OF EIGHT HOURS OF PROFESSIONAL TIME TO CONSIDER ANY SUBMITTAL SHALL BE PAID FOR BY THE CONTRACTOR. SUCH PAYMENT DOES NOT	MOTORIZED SHADE. VERIFY MOTOR LOCATIONS WITH SHADE VENDOR AND INSTALLER.			LUMINAIRE MARKING CONVENTIONS: LETTER DESIGNATION FOLLOWED BY SEQUENTIAL NUMBER  L# = LED D# = DECORATIVE S# = SITE SPECIFIC X# = EXIT SIGN E# = EMERGENCY SPECIFIC	LIGHT-000 LIGHTING LEGEND LIGHT-100 SITE LIGHTING LIGHT-101 SITE LIGHTING CALCULATIONS LIGHT-102 SITE LIGHTING CUTSHEETS		
GUARANTEE APPROVAL. COSTS INCURRED TO THE PROJECT DUE TO PROBLEMS ARISING FROM							
PROBLEMS ARISING FROM MULTIPLE RESUBMITTALS ARE TO BE PAID FOR BY THE CONTRACTOR.  29. THE EXPRESSION "OR AS APPROVED" OR "OR APPROVED EQUAL" OR "OR EQUAL" MEANS THAT COMPETING PRODUCTS OF A SIMILAR NATURE ARE THOUGHT TO EXIST. THE CONTRACTOR IS ENCOURAGED TO PROPOSE SUBSTITUTION REQUESTS OF SUCH EQUIVALENT PRODUCTS AS		PEDESTAL FLOOR DEVICE - DEVICE TYPE PER SYMBOLS ABOVE					
LONG AS THE PRODUCT CONFORMS TO ALL PARTS OF THIS SPECIFICATION. WHERE THE ABOVE NOTED EXPRESSIONS ARE OMITTED OR EXPRESSION SUCH AS "NO SUBSTITUTIONS" APPEARS THE CONTRACTOR SHALL PROVIDE ONLY THE PRODUCT INDICATED.		IN RAISED FLOOR - SEE ARCH DWGS; WITH MULTI-SERVICE FLOOR BOX CAST IN CONC. OR RECEPTACLES & SIGNAL OUTLETS AS NOTED.	1071 1071DC	CIRCUITING CONVENTION:			
30. SUBSTITUTION REQUESTS AND VALUE ENGINEERING RECOMMENDATIONS FROM THE CONTRACTOR WILL BE CONSIDERED IF SUBMITTED WITHIN 30 DAYS OF DIRECTION TO PROCEED FROM THE OWNER. EACH LUMINAIRE SUBSTITUTION REQUEST SHALL INDICATE THE ESTIMATED OR POTENTIAL SAVINGS TO THE OWNER FOR THAT LUMINAIRE FROM THE SPECIFIED DESIGN. THE PROFESSIONAL TIME TO CONSIDER ANY SUBSTITUTION REQUEST OR V.E. REQUEST SHALL BE PAID FOR BY THE		JUNCTION BOX PROVIDE BLANK COVER U.N.O.	¥ X# 1071	107# = ARCHITECTURAL ROOM NUMBER ###1 = SEQUENTIAL CIRCUIT IN ROOM. ####DC = 0-10VDC CONTROL CIRCUIT			

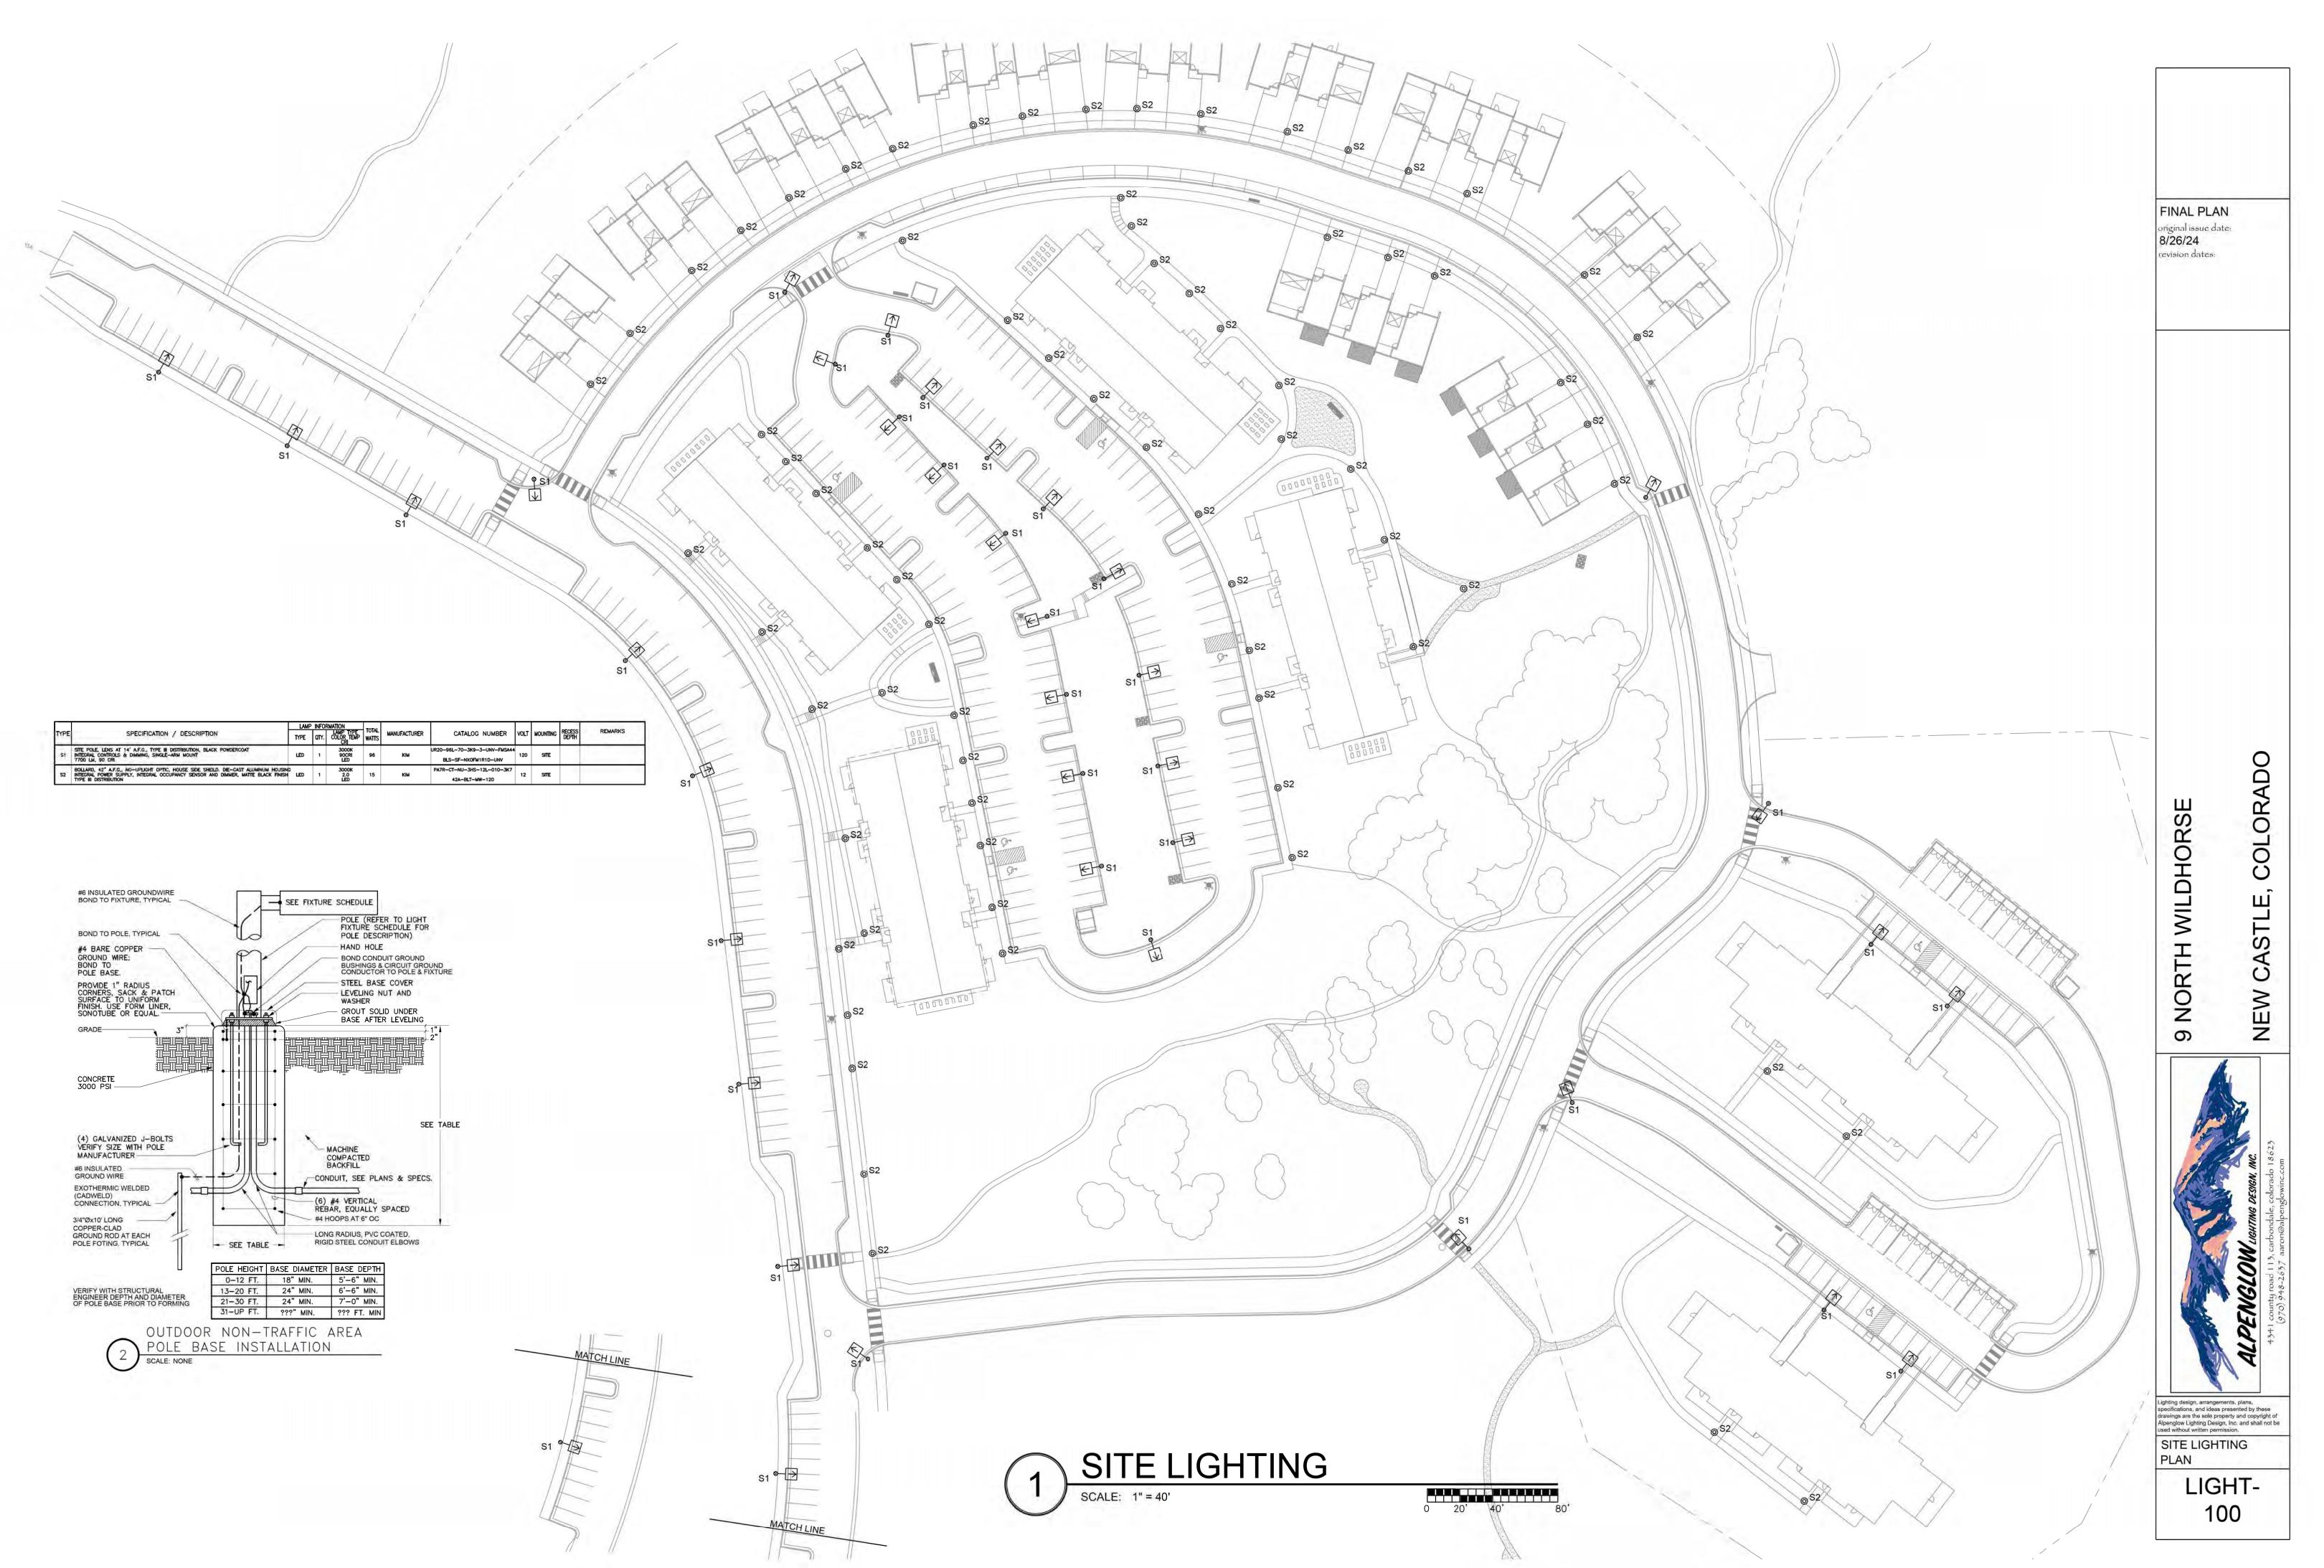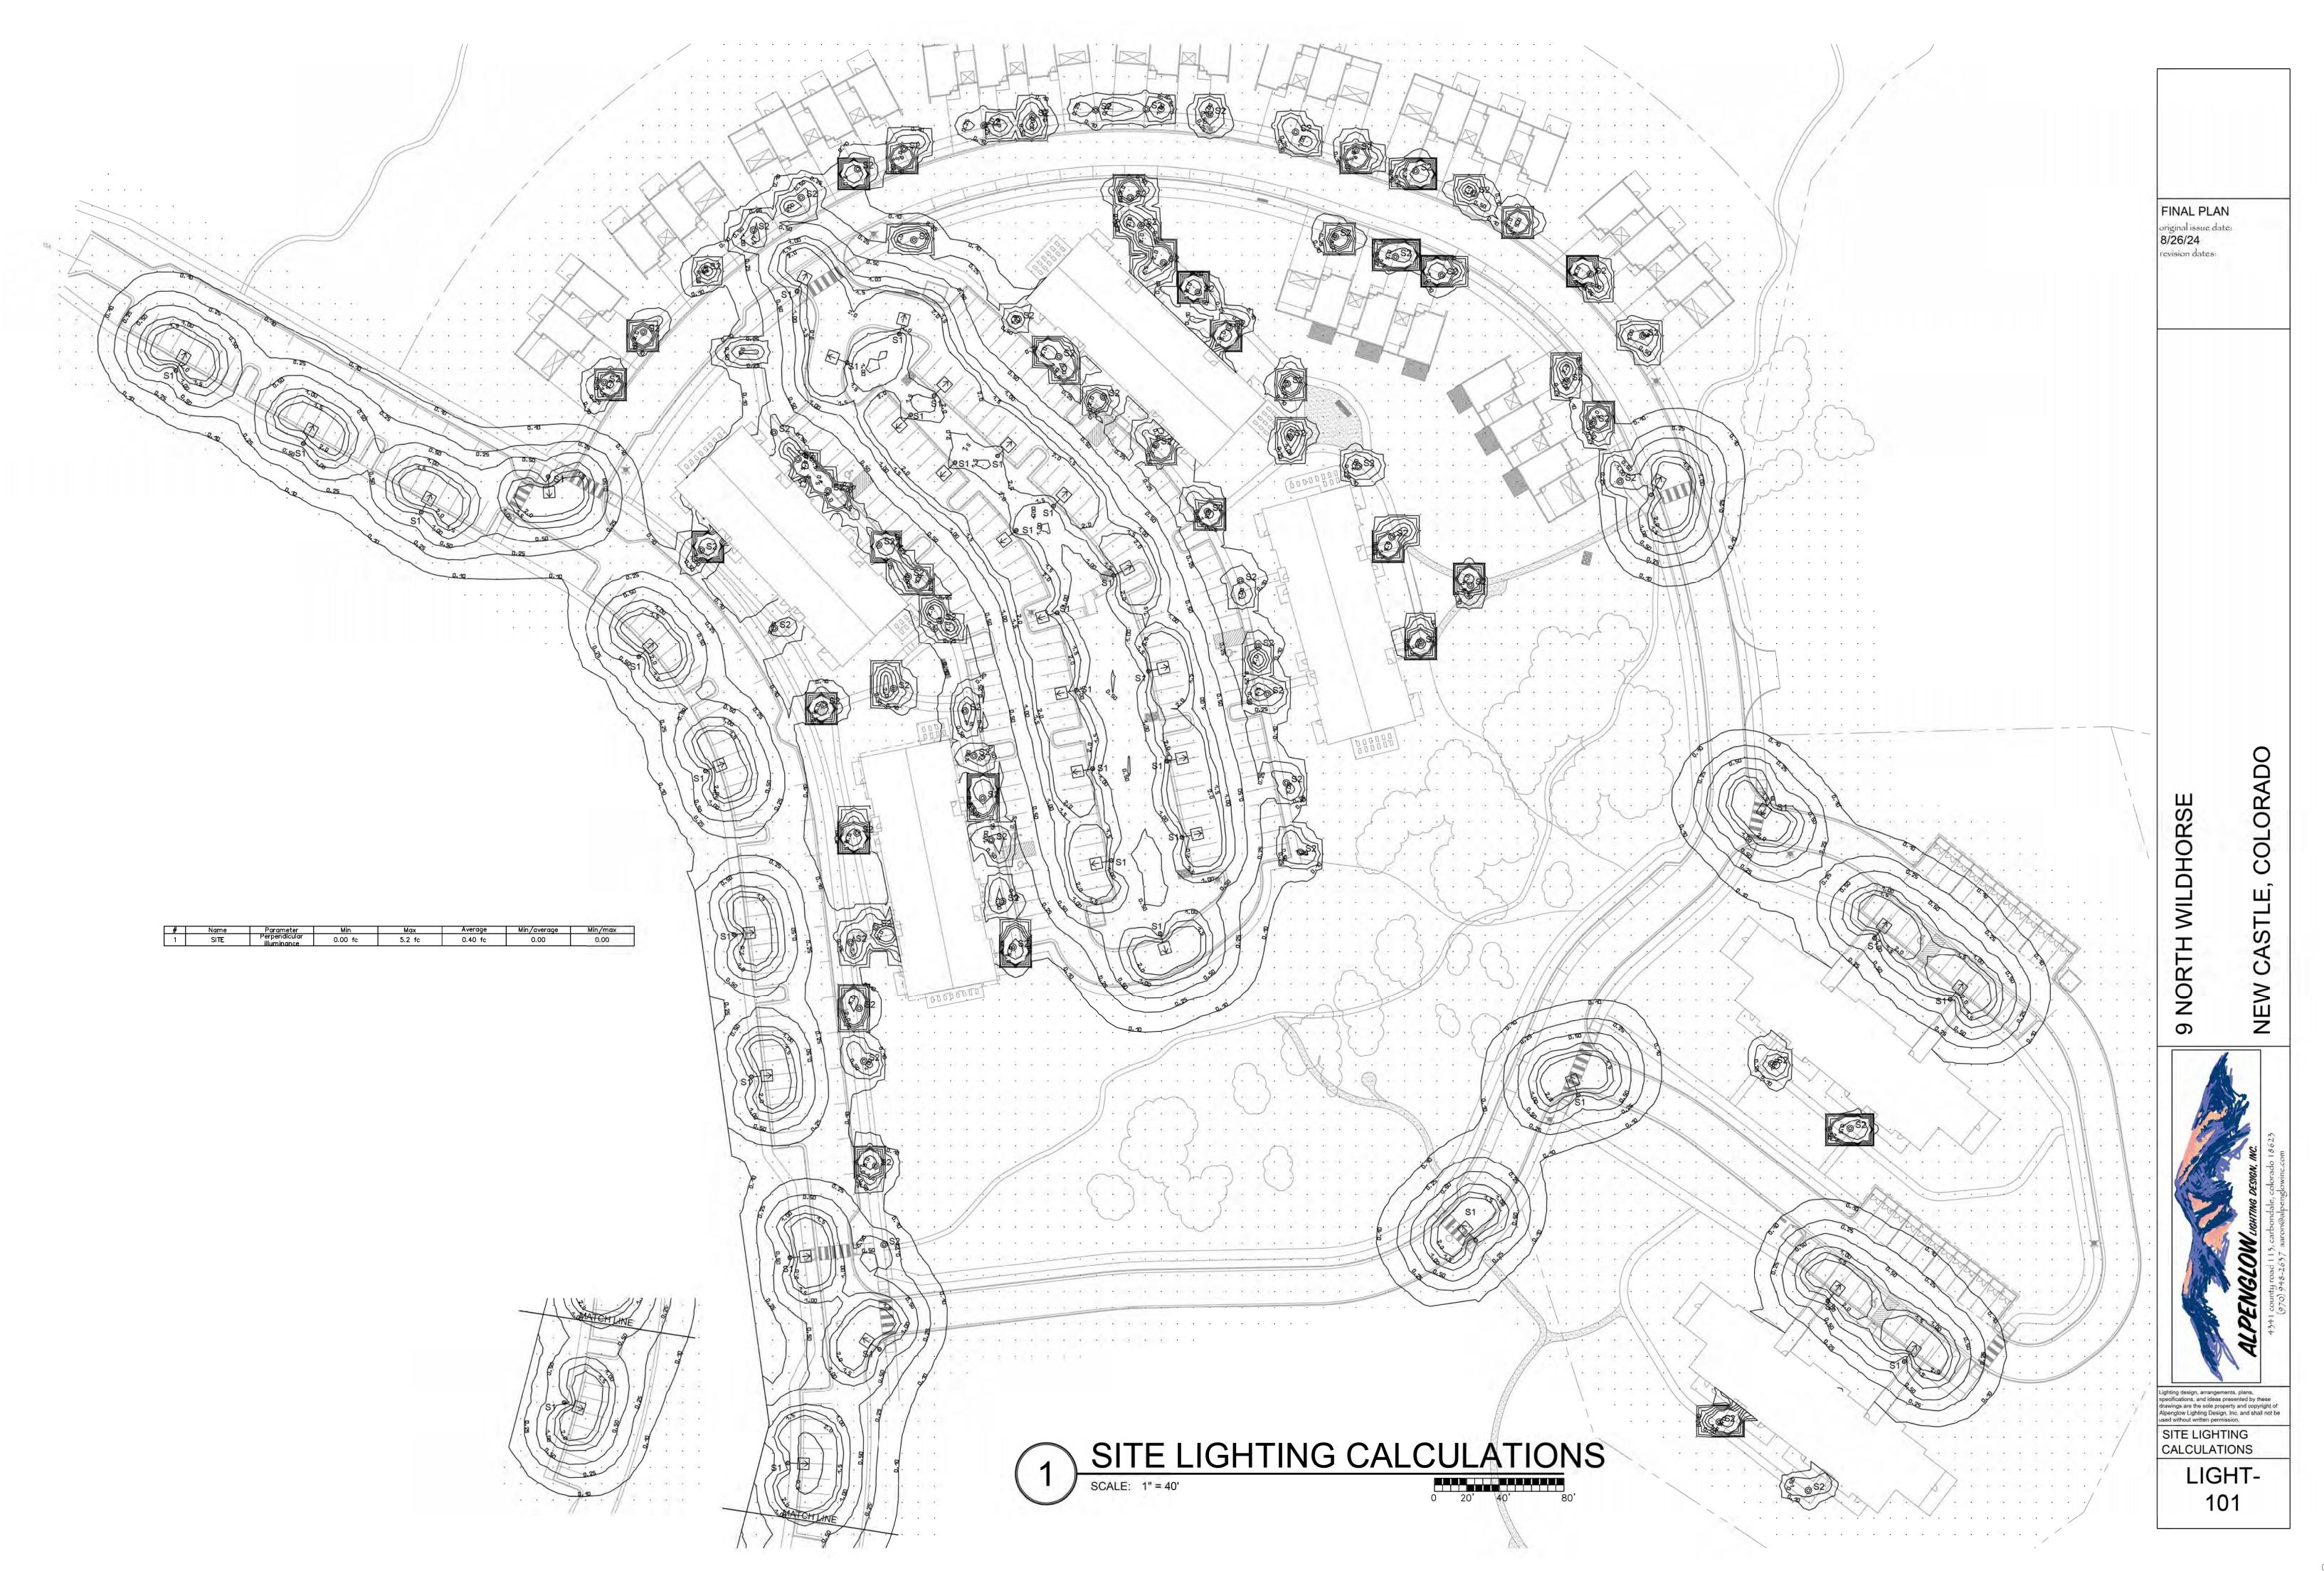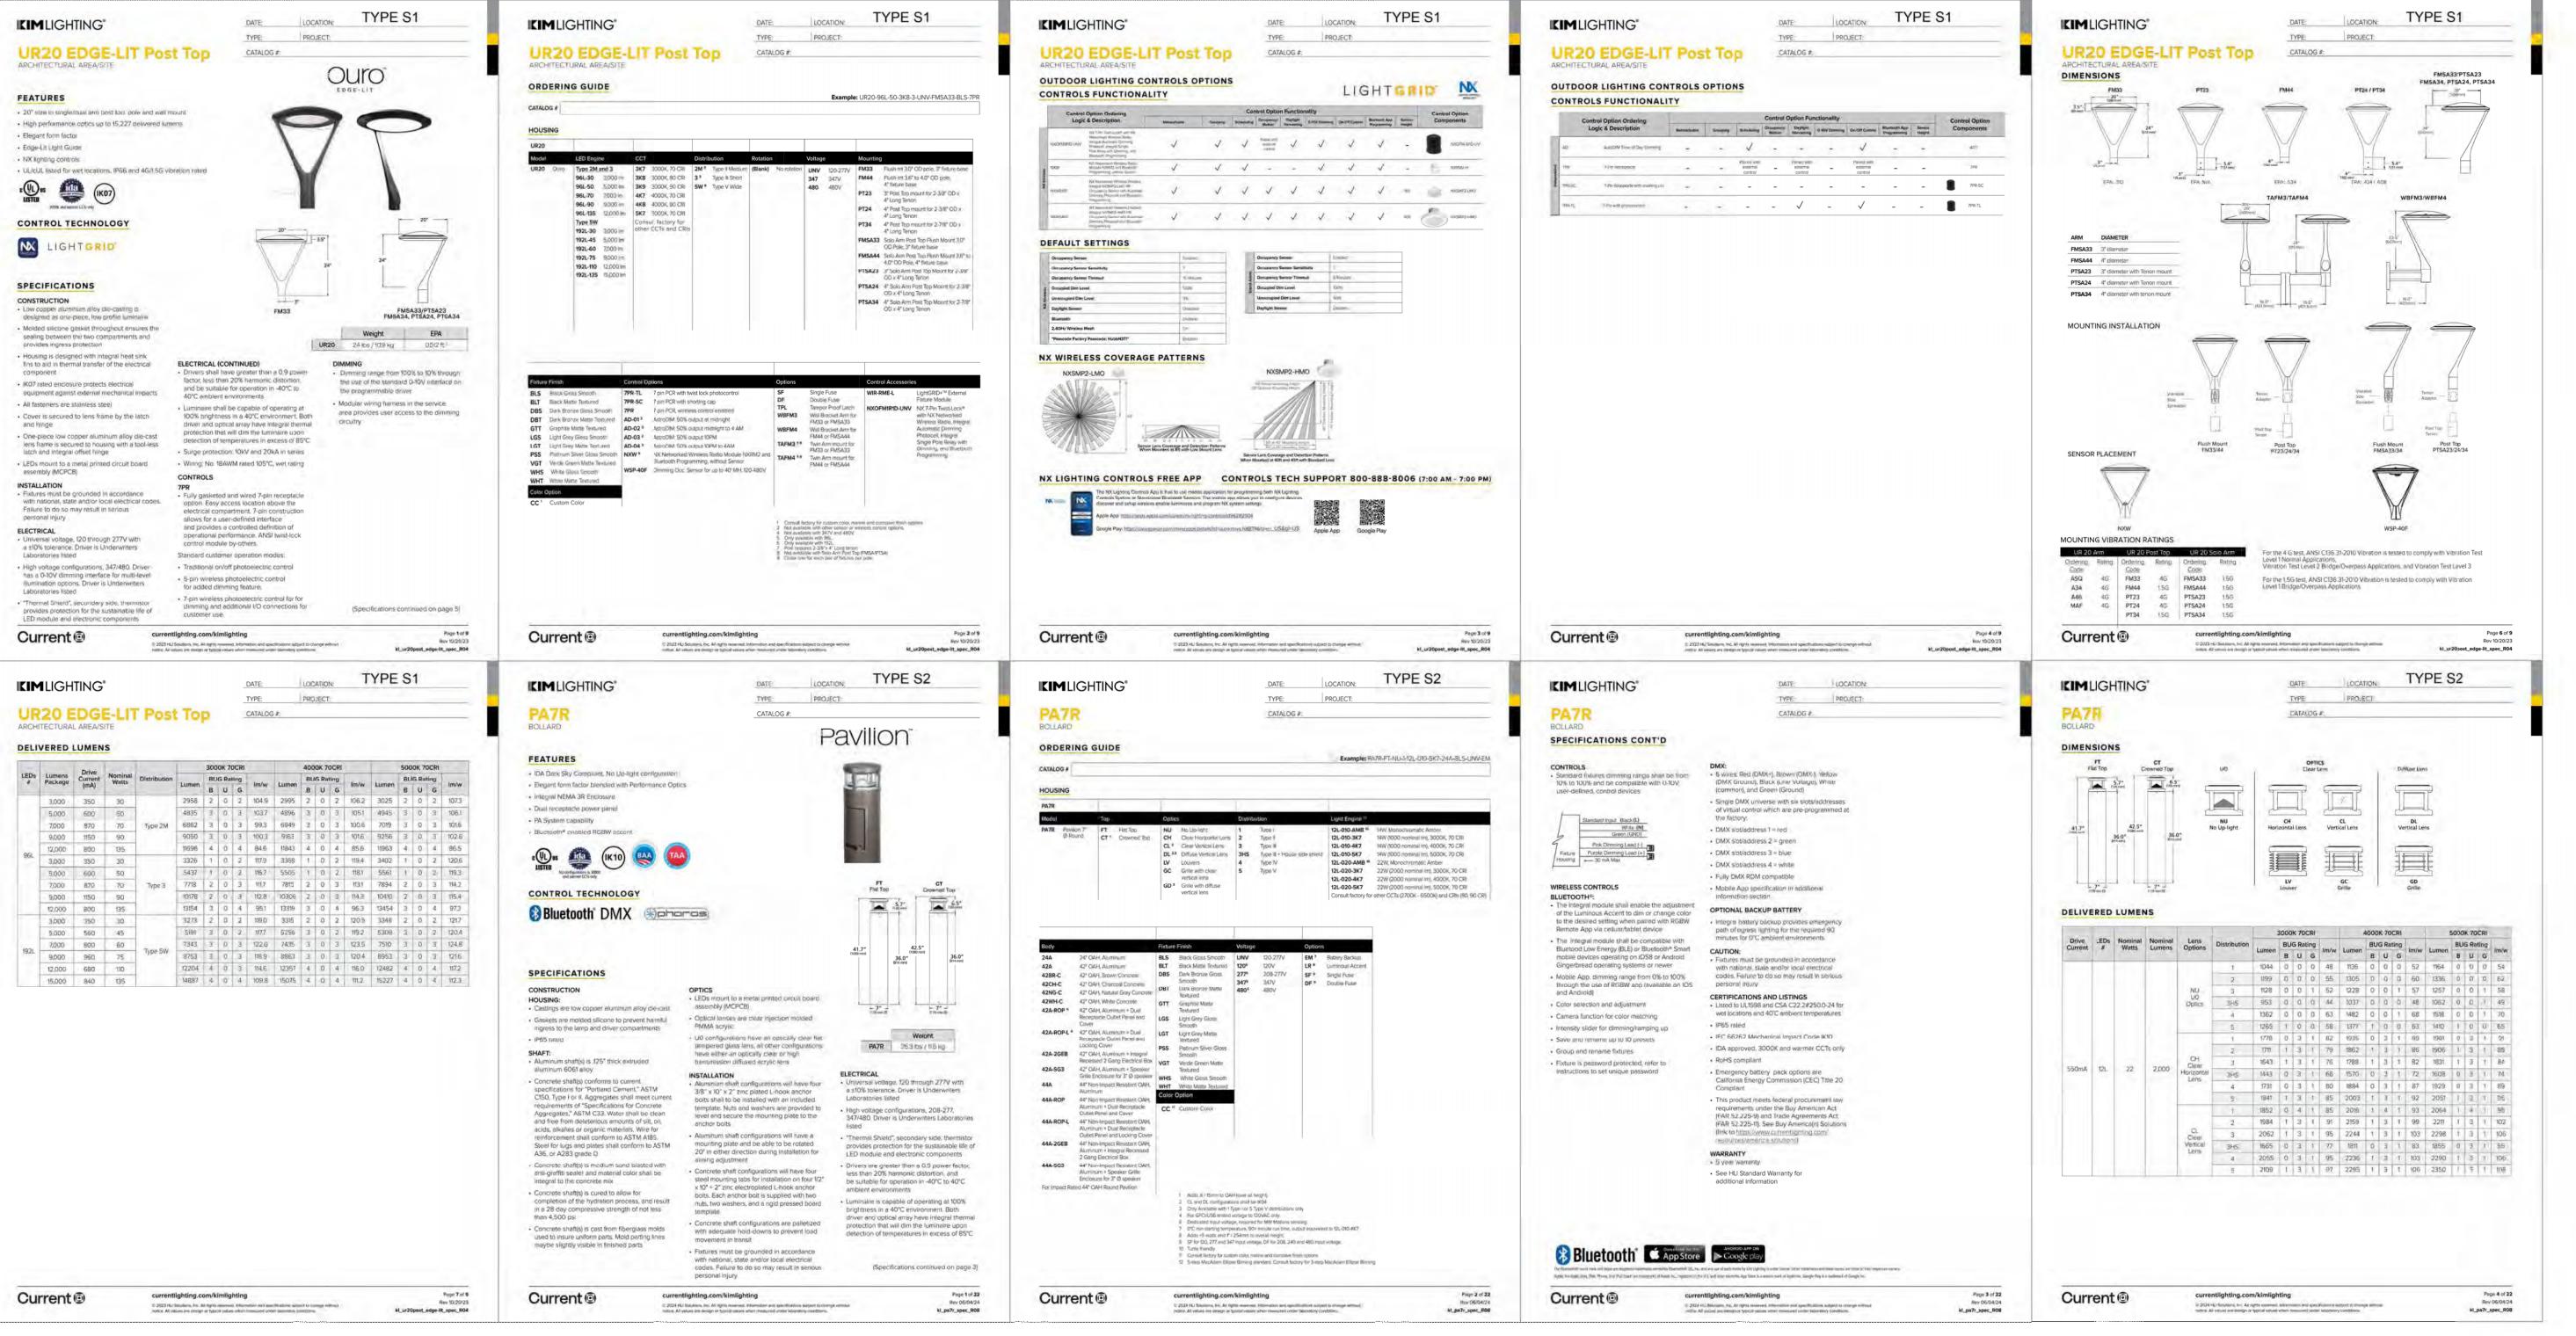
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